HDC ADMINISTRATIVE APPROVALS

December 02, 2020

1.	292 State Street (LUHD-228)	-Recommended Approval
2.	111/145 Maplewood Avenue (LUHD-229)-Recommended Approval

- 3. 209 Marcy Street (LUHD-230) -TBD
- 4. 37 South Street (LUHD-238) -Recommended Approval

1. 292 State Street

- Recommended Approval

<u>Background</u>: The applicant is seeking approval for the replacement of the existing slate roof and copper flat seam; both to be replaced with new slate and copper as well as the repointing of the granite cornice, steps, and walls as needed.

<u>Staff Comment</u>: Recommended Approval

Sti	n	ш		ti.	\cap	n	c	•
3 11	Μ	U	I		J	•	J	•

1	 	
2		
3		

Historic District Commission Work Session or Administrative Approval Application

LUHD-228

Status: Active

Submitted: Nov 12, 2020

Applicant

Alyssa Murphy

603-319-8199 ext. 101

alyssa@manypennymurphy.com

Location

292 STATE ST Portsmouth, NH 03801

Application Type

Please select application type from the drop down menu below

Administrative Approval

Project Information

Brief Description of Proposed Work

The existing slate roof is to be replaced with a new slate roof. The existing flat seam copper roof on the steeple will also be replaced in kind. Work will include repointing of the existing granite cornice, the granite steps, and some wall repointing as required.

Description of Proposed Work (Planning Staff)

Project Representatives

State City/Town NH Portsmouth

Phone Business Name (if applicable)

9178263996

Email Address Relationship to Project

alyssa@placework.studio Other

If you selected "Other", please state relationship to project. **Mailing Address (Street)** Volunteer - Chair of the Planning + Implementation Committee 334 Lincoln Avenue

Full Name (First and Last) Zip Code

03801 Alyssa Murphy

Email Address Zip Code 03036 tim@armroofs.com

Full Name (First and Last) **Mailing Address (Street)**

Tim Archer P.O. Box 4


If you selected "Other", please state relationship to project. City/Town Chester


Roofing Design Consultant



SOUTH CHURCH

292 STATE ST. PORTSMOUTH, NH 03801

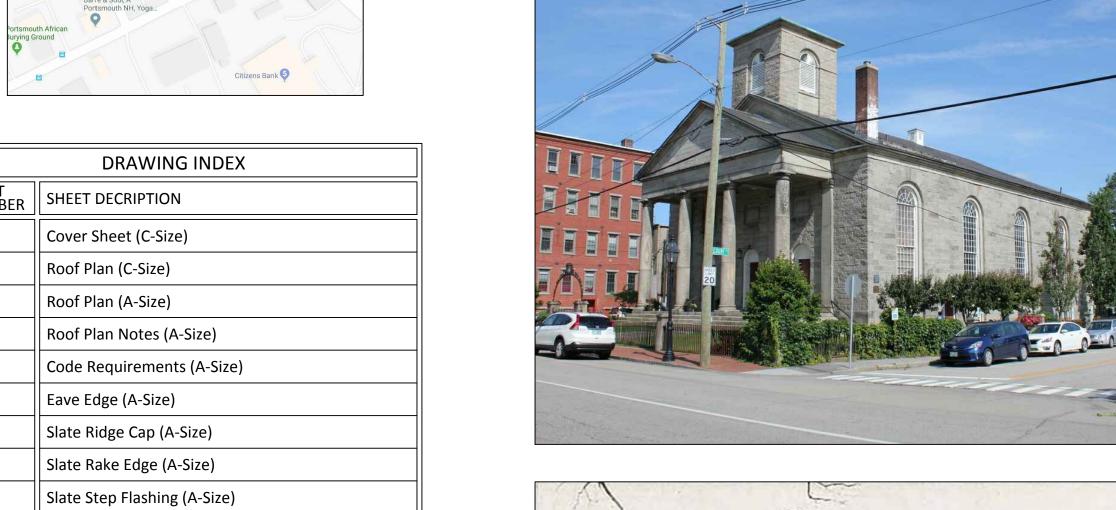

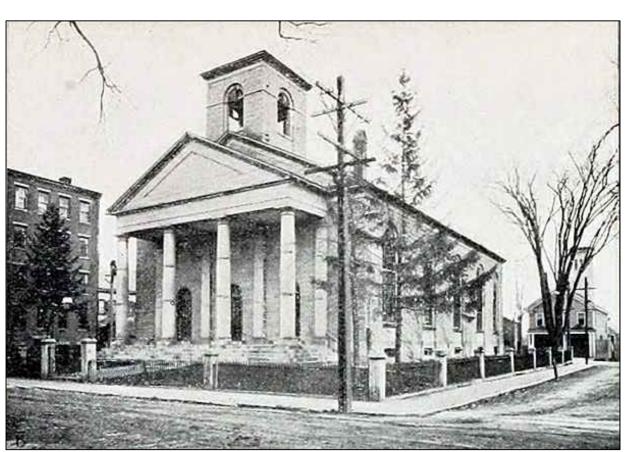

BUILDING CODE REFERENCES

1) 2009 INTERNATIONAL BUILDING CODE

A) THE STATE OF NEW HAMPSHIRE HAS ADOPTED THE 2009 INTERNATIONAL BUILDING CODE B) CHAPTER 34 OF THE 2009 IBC TITLED EXISTING BUILDING AND STRUCTURES HAS BEEN DELETED IN ITS ENTIRETY. THE PROVISIONS OF THE INTERNATIONAL EXISTING BUILDING CODE PROVISIONS SHALL CONTROL THE ALTERATION REPAIR AND ADDITION TO AN EXISTING BUILDING. C) IEBC DEFINITIONS: CHAPTER 5 REPAIRS:

EXISTING MATERIALS (502.1): MATERIALS ALREADY IN USE IN A BUILDING IN COMPLIANCE WITH REQUIREMENTS OR APPROVALS IN EFFECT AT THE TIME OF THEIR ERECTION OR INSTALLATION SHALL BE PERMITTED TO REMAIN IN USE UNLESS DETERMINED BY THE BUILDING OFFICIAL TO BE **UNSAFE PER SECTION 115.**

NEW AND REPLACEMENT MATERIALS (502.2): EXCEPT AS OTHERWISE REQUIRED OR PERMITTED BY THIS CODE, MATERIALS PERMITTED BY THE APPLICABLE CODE FOR NEW CONSTRUCTION SHALL BE USED. LIKE MATERIALS SHALL BE PERMITTED FOR REPAIRS AND ALTERATIONS, PROVIDED NO HAZARD TO LIFE, HEALTH OR PROPERTY IS CREATED. HAZARDOUS MATERIALS SHALL NOT BE USED WHERE THE CODE FOR NEW CONSTRUCTION WOULD NOT PERMIT THEIR USE IN BUILDINGS OF SIMILAR OCCUPANCY, PURPOSE AND LOCATION.

DANGEROUS (SECTION 202 GENERAL DEFINITIONS): ANY BUILDING, STRUCTURE OR PORTION THEREOF THAT MEETS ANY OF THE CONDITIONS DESCRIBED BELOW SHALL BE DEEMED DANGEROUS:

OFF ITS FOUNDATION, OR LACKS THE NECESSARY SUPPORT OF THE GROUND. 2.) THERE EXISTS A SIGNIFICANT RISK OF COLLAPSE, DETACHMENT, OR DISLODGEMENT OF ANY PORTION, MEMBER, APPURTENANCE OR ORNAMENTATION OF THE BUILDING OR STRUCTURE UNDER SERVICE LOADS.

ROOF WIND UPLIFT DESIGN PRESSURE

1) METHOD A - 2009 IEBC & ASCE-7-05

A) CLASSIFICATION: ALTERATION B) OCCUPANCY CLASS: TYPE II

C) SECTION 6.5.1 ASCE 7-05 (METHOD 2) ::

1) BASIC WIND SPEED: 105 MPH

2) BUILDING HEIGHT (h): 20'-0" 3) EXPOSURE CATEGORY: C EXPOSURE FACTOR (Kz): 0.90

4) DIRECTIONALITY FACTOR (Kd): 0.85

5) IMPORTANCE FACTOR (I): 1.15

6) TOPOGRAPHIC FACTOR (Kzt): 1.00 7) VELOCITY CONSTANT: 0.00256

8) VELOCITY PRESSURE EQUATION: Qz=0.00256(Kz)(Kzt)(Kd)(V)^2(I)

Qz=0.00256(0.90)(1.00)(0.85)(105)^2(1.15)=24.83 PSF

D) UPLIFT DESIGN WIND PRESSURE

1) BUILDING WIDTH (w): 106'-6"

2) BUILDING HEIGHT (h): 20'-0"

3) ASPECT RATIO h/w<1: 20/106.5=0.19 (USE EQUATION 6-22 PER SECTION 6.5.12.4.3)

4) EQUATION 6-22: p=qz[(GCp)-q(GCpi)] VALUES FROM FIGURE 6-5 AND 6-11B

a) INTERNAL PRESSURE COEFFICIENT (GCpi): 0.18 (FULLY ENCLOSED)

b) ZONE 1 (FIELD) (GCp 1= -1.00-0.18):.... ...24.83 PSF (-1.18) = -29.30 PSF

c) ZONE 2 (PERIMETER) (GCp 2= -1.80-0.18):.....24.83 PSF (-1.98) = -49.16 PSF

d) ZONE 3 (SALIENT CORNERS) (GCp 3= -2.80-0.18)...24.83 PSF (-2.98)= -74.00 PSF

CHURCH SHEET SOUTH COVER : DRAWN. BY: TEA CHECKED BY: SMB DATE ISSUED:

3-29-19 SCALE: N.T.S.



	DRAWING INDEX
SHEET NUMBER	SHEET DECRIPTION
RP-1	Cover Sheet (C-Size)
RP-2	Roof Plan (C-Size)
RP-3	Roof Plan (A-Size)
RP-4	Roof Plan Notes (A-Size)
RP-5	Code Requirements (A-Size)
D-1	Eave Edge (A-Size)
D-2	Slate Ridge Cap (A-Size)
D-3	Slate Rake Edge (A-Size)
D-4	Slate Step Flashing (A-Size)
D-5	Front Pan (A-Size)
D-6	Chimney Flashing (A-Size)
D-7	Snow Fence Detail (A-Size)
D-8	Snow Fence Cut Sheet (A-Size)
D-9	Slate Penetration (A-Size)
D-10	Standing Seam Eave (A-Size)
D-11	Standing Seam Bends (A-Size)
D-12	Copper Ridge (A-Size)
D-13	Standing Seam Rake (A-Size)
D-14	Flat Seam Bends (A-Size)
D-15	Flat Seam Cleat (A-Size)
D-16	Flat Seam Edge Detail (A-Size)



P1: FLAT SEAM STEEPLE ROOF WITH ROOF



P2: EXISTING RAKE DETAIL SHOWING THE



MATCHED.



P5: EXISTING SLATE IN THE ATTIC TO BE

REMOVED DURING THE PROJECT



P4: EXISTING SHINGLE CRICKET TO BE REPLACED WITH A NEW FLAT SEAM COPPER CRICKET.



P6: EXISTING CANOPY TO BE RECREATED.



OF THE EXISTING FACADE TO BE RE-POINTED BY A MASON CARRIED BY THE ROOFING CONTRACTOR.

BY HAND OR MECHANICAL MEANS, DEMOLISH AND REMOVE ANY DESIGNATED SLATE ROOFING MATERIALS, LOOSE UNDERLAYMENTS, OR OTHER MATERIALS DOWN TO THE EXISTING DECKING AS DIRECTED IN THE SPECIFICATIONS

2 BY HAND OR MECHANICAL MEANS, DEMOLISH AND REMOVE ANY DESIGNATED COPPER ROOFING MATERIALS, LOOSE UNDERLAYMENTS, OR OTHER MATERIALS DOWN TO THE EXISTING DECKING AS DIRECTED IN THE SPECIFICATIONS.

3 DO NOT OVERLOAD STRUCTURE BY STORING DEMOLITION MATERIALS AND ROOFING. DISPERSE WEIGHT ON ROOF DECK.

4 REMOVE STORE AND REINSTALL THE EXISTING VENTILATION CUPOLA.

5 ALL SHINGLES AND RIDGES BEHIND THE EXISTING CHIMNEY.

6 REMOVE ALL SNOW GUARDS AND ASSOCIATED BRACKETS.

DRAWING NOTES:

A. CERTAIN DETAILS MAY REQUIRE FIELD ADJUSTMENT OR MODIFICATIONS TO FIT IN A GIVEN SITUATION. AT SOME LOCATIONS A COMBINATION OF TWO OR MORE DETAILS ASSEMBLED TOGETHER OR RELATED SEPARATELY MAY BE REQUIRED.

B. CONTRACTOR ACCESS WILL BE VIA A CONTRACTOR SUPPLIED EXTERIOR STAGING. **NO** INTERIOR ACCESS WILL BE ALLOWED.

C. THE EXISTING SLATE SHALL BE REMOVED IN THEIR ENTIRETY DOWN TO THE 1" TONGUE AND GROOVE WOOD DECK. THE NEW INSTALLATION SHALL HAVE 100% HIGH TEMP ICE AND WATER SHIELD TO BE APPLIED TO THE EXISTING DECKING AND NEW 100% COVERAGE 15# FELT UNDERLAYMENT UNDER THE NEW SLATE INSTALLED WITH SMOOTH SHANK COPPER NAILS.


D. THE EXISTING FLAT SEAM SOLDERED COPPER ROOF SHALL BE REMOVED IN ITS ENTIRETY DOWN TO THE 1" TONGUE AND GROOVE WOOD DECK. THE NEW INSTALLATION SHALL HAVE 100% HIGH TEMP ICE AND WATER SHIELD TO BE APPLIED TO THE EXISTING DECKING AND NEW 100% COVERAGE 15# FELT UNDERLAYMENT UNDER THE NEW COPPER INSTALLED WITH SMOOTH SHANK COPPER NAILS.

E. PROVIDE PD10 HALF ROUND PAD STYLE SNOW GUARDS BY ALPINE SNOW GUARD OR APPROVED EQUAL. THE MANUFACTURER SHALL CONFIRM THE LAYOUT BEFORE THE CONTRACTOR ORDERS ANY OF THE MATERIALS. COLOR AND MATERIALS AS SELECTED BY THE BUILDING COMMITTEE.

F. PROVIDE NEW COPPER AND BRASS SNOW FENCE AS SHOWN ON THE DRAWINGS AND AS SPECIFIED.

G. PROVIDE "IN-PLACE MOCKUP" OF ALL METAL FLASHING AND TERMINATIONS. PROVIDE AT LEAST ONE CORNER AND ONE JOINT FOR ALL CONDITIONS FOR APPROVAL. APPROVED MOCKUPS IN AN UNDISTURBED CONDITION AT THE TIME OF SUBSTANTIAL COMPLETION MAY BECOME PART OF THE COMPLETED WORK. ALL SHEET METAL EDGES TO BE HEMMED.

H. COMPLETELY CLAD THE EXTERIOR OF THE EXISTING CUPOLA WITH 200z STANDING SEAM COPPER PANELS.

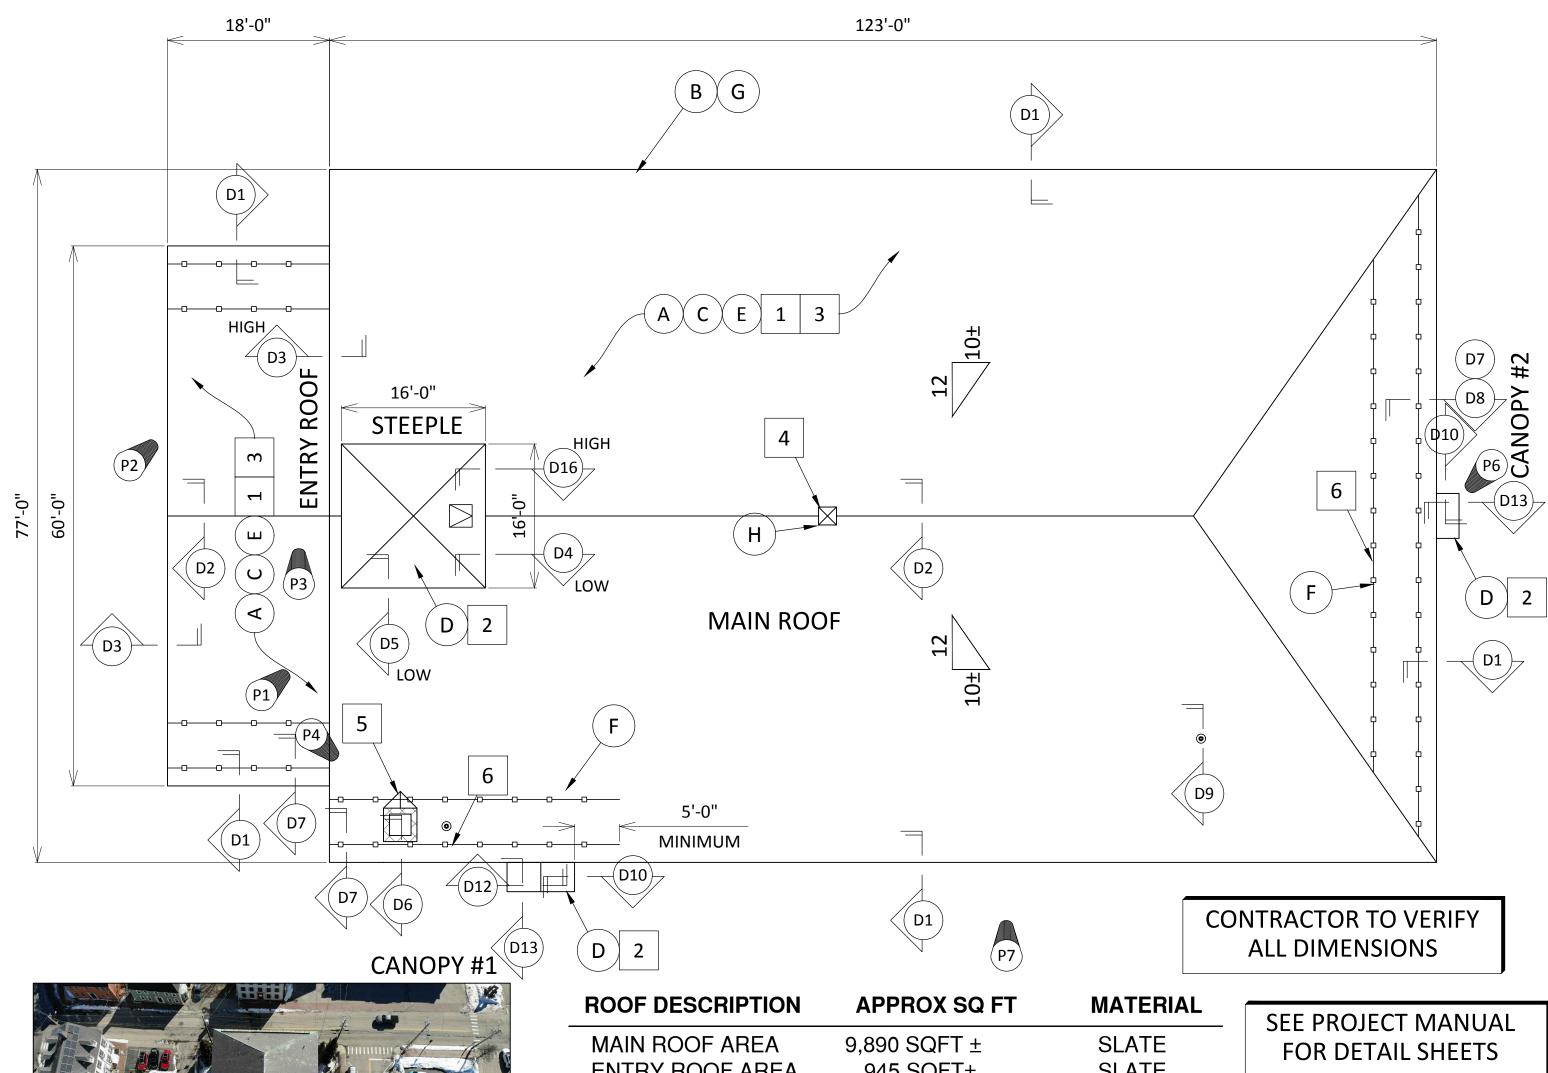




P8: DRONE OVERVIEW OF THE PROJECT.




P9: DRONE OVERVIEW OF THE PROJECT.

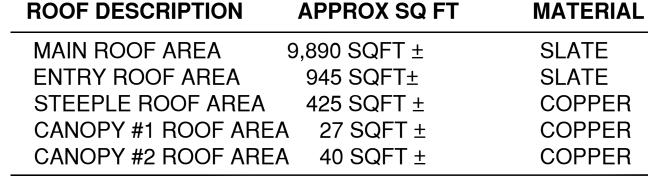

TOTAL ROOF AREA 11,327 SQFT ±

THE SQUARE FOOTAGES ARE BASED ON THE ACTUAL SQUARE FOOTAGE OF THE ROOF AREAS TAKING INTO ACCOUNT FOR ROOF SLOPE. THE CONTRACTOR SHALL VERIFY THESE

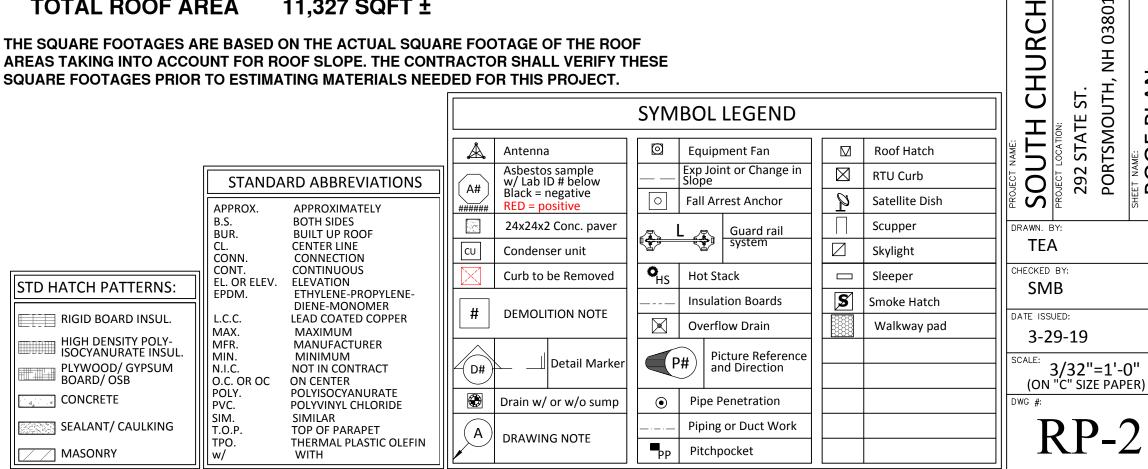


292 STATE ST. PORTSMOUTH, N

3/32"=1'-0"

PLAN

ROOF

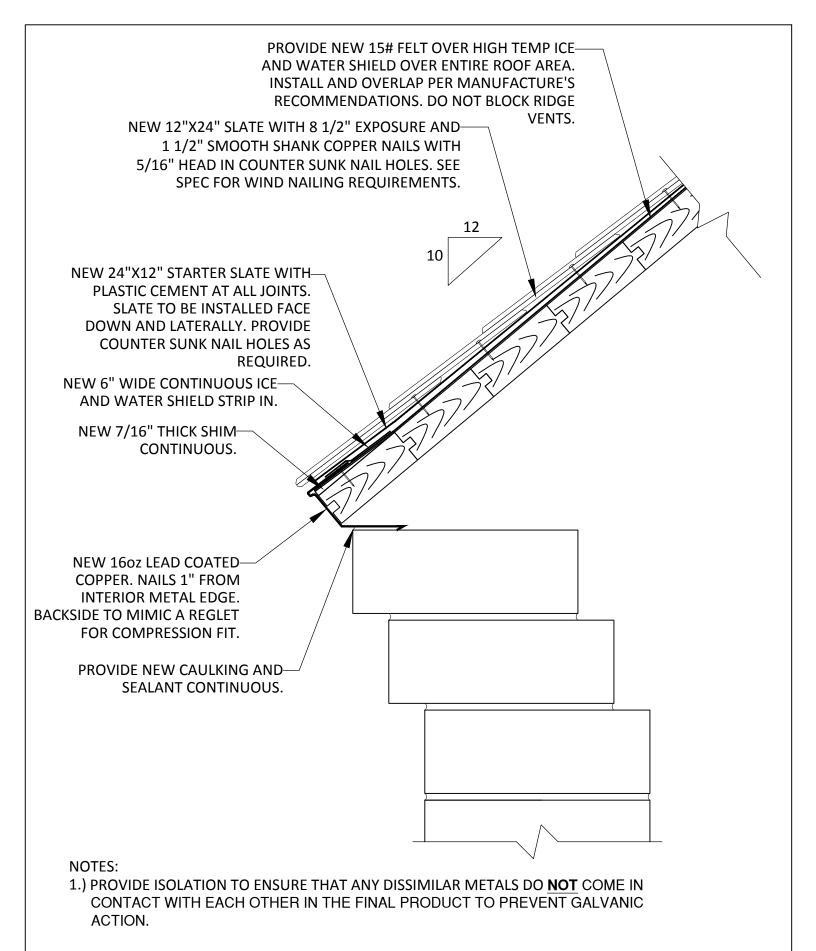



PO Box 628

North Hampton, NH 03862 (603) 964-1335

SOUTH CHURCH 292 STATE ST. PORTSMOUTH, NH 03801

DRAWN BY:	CHECKED BY:	#	DATE	вү і	ESCRIPTION	DWG. NUMBER:
TEA	SMB	\vdash				
DATE:	SCALE:]
3-29-19	³ / ₈ "=1'-0"					D-1
DRAWING NAME:	•	_		<u> </u>		- -
EAVE EDGE		\vdash				-

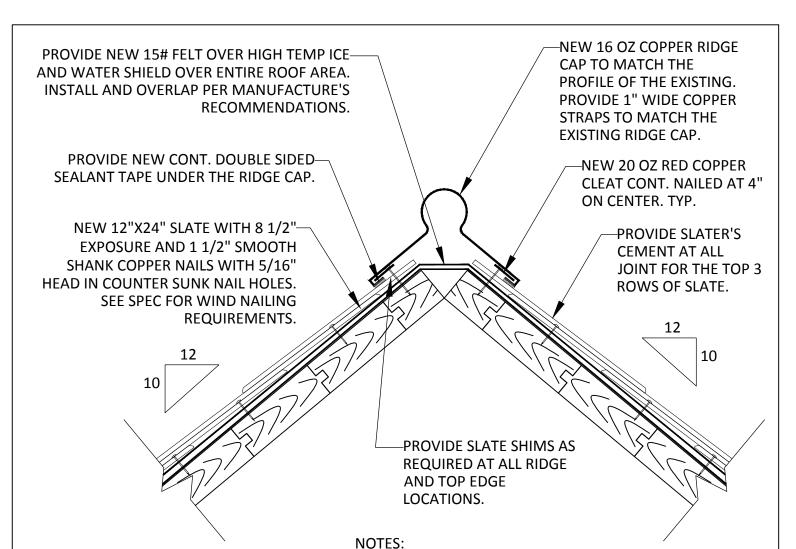

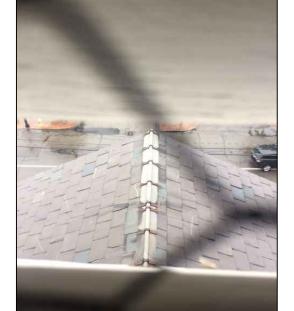

EXISTING RIDGE LAYOUT


1.) PROVIDE ISOLATION TO ENSURE THAT ANY DISSIMILAR METALS DO **NOT** COME IN CONTACT WITH EACH OTHER IN THE FINAL PRODUCT TO

PREVENT GALVANIC ACTION.

RIDGE NAILING EXPECTATION



DRAWN BY:	CHECKED BY:	#	DATE	ВΥ	DESCRIPTION	DWG. NUMBER:
TEA	SMB					1
DATE:	SCALE:	1				
3-29-19	³ / ₈ "=1'-0"					D-2
DRAWING NAME:		⊢		-	-	
SLATE RIDGE CAP		$ldsymbol{ldsymbol{eta}}$				
SLATE KIDGE CAP		l	I		1	1

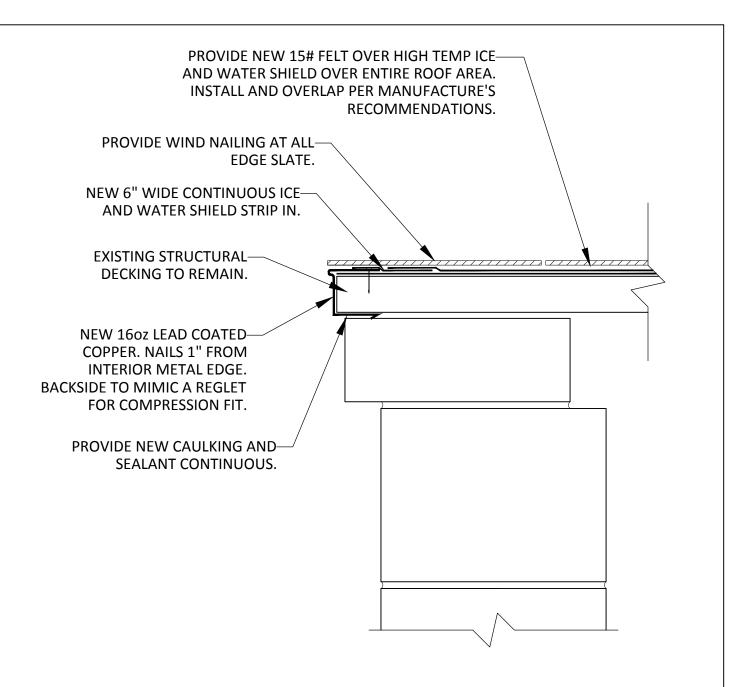


NOTES:

- 1.) PROVIDE UNDERLAYMENT OVER ENTIRE ROOF AREA INCLUDING ALL ICE AND WATER SHIELD LOCATIONS. INSTALL AND OVERLAP PER MANUFACTURE'S RECOMMENDATIONS.
- 2.) PROVIDE ISOLATION TO ENSURE THAT ANY DISSIMILAR METALS DO **NOT** COME IN CONTACT WITH EACH OTHER IN THE FINAL PRODUCT TO PREVENT GALVANIC ACTION.
- 3.) STRIP IN THE ENTIRE LENGTH OF THE DRIP EDGE TO THE ICE AND WATER SHIELD WITH 6" WIDE ICE AND WATER SHIELD.



DRAWN BY:	CHECKED BY:	#	DATE	BY I	ESCRIPTION	DWG. NUMBER:
TEA	SMB					
DATE:	SCALE:]
3-29-19	³ / ₈ "=1'-0"					D-3
DRAWING NAME:				-		, ,
SLATE RAKE E	DGF	\vdash				-

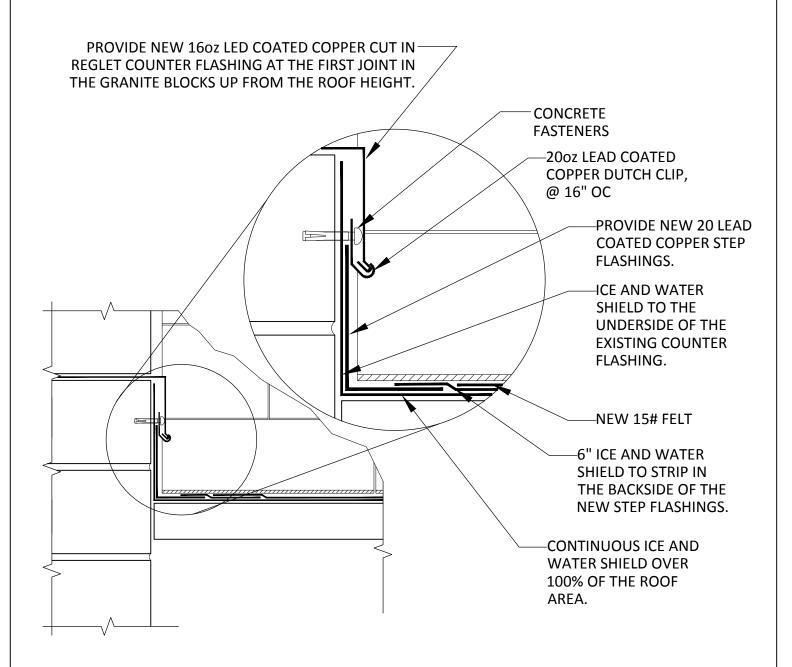


NOTE:

- 1. PROVIDE ISOLATION TO ENSURE THAT ANY DISSIMILAR METALS DO **NOT** COME IN CONTACT WITH EACH OTHER IN THE FINAL PRODUCT TO PREVENT GALVANIC ACTION.
- 2. ENSURE THAT THE EXISTING CUT IN WALL FLASHING IS PROPERLY "DRESSES DOWN" TO PROVIDE POSITIVE WATER RUN OFF.




DRAWN BY:	CHECKED BY:	#	DATE	вү і	ESCRIPTION	DWG. NUMBER:
TEA	SMB	F				
DATE:	SCALE:]
3-29-19	³ / ₈ "=1'-0"					D-4
DRAWING NAME:		⊢		<u> </u>		
SLATE STEP FLASHING		\vdash		-		

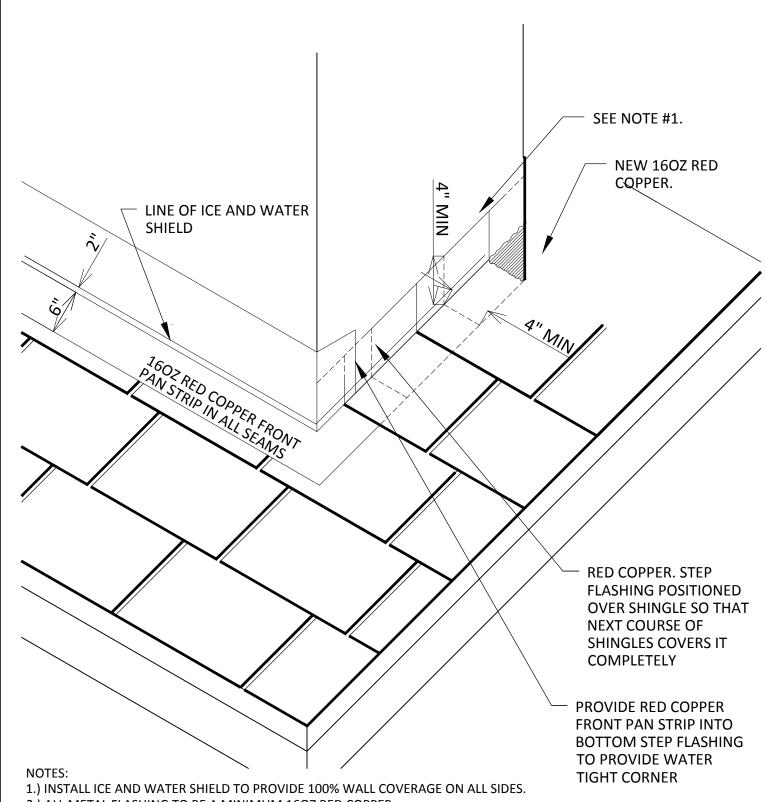

- 2.) ALL METAL FLASHING TO BE A MINIMUM 16OZ RED COPPER.
- 3.) EXTEND FLASHING A MINIMUM OF 4" BEYOND THE DORMER ON THE FRONT AND SIDES AND A MINIMUM OF 16" BEHIND THE CHEEK WALLS.
- 4.) THE EXISTING SIDING SHALL BE REMOVED, MODIFIED AND REINSTALLED TO ALLOW FOR A MINIMUM OF 1" CLEARANCE FROM THE NEW ROOF SYSTEM AND TO ALLOW FOR THE NEW STEP FLASHINGS TO BE INSTALLED.
- 5.) STRIP IN THE TOPS OF ALL STEP FLASHINGS WITH CERTAINTEED'S DETAIL TAPE OR A MINIMUM WIDTH OF 6" ICE AND WATER SHIELD.



DRAWN BY:	CHECKED BY:	#	DATE	ВΥ	ESCRIPTION	DWG. NUMBER:
TEA	SMB					
DATE:	SCALE:	1				
3-29-19	³ / ₈ "=1'-0"		-	-		∃ D-5
DRAWING NAME:	•) —		₩		1 2
FRONT PAN		╙				_
FRONT PAN		ı			1	

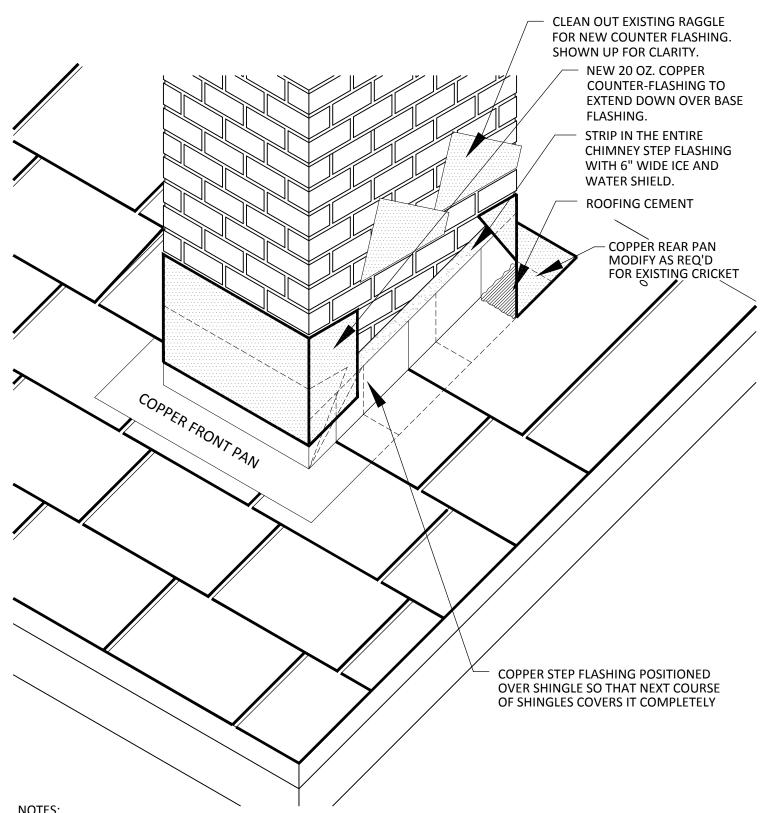


NOTES:

- 1.) INSTALL ICE AND WATER SHIELD AT LEAST 16" ON ALL SIDES.
- 2.) ALL METAL FLASHING TO BE A MINIMUM 16 OZ. COPPER.
- 3.) EXTEND FLASHING A MINIMUM OF 4" BEYOND THE CHIMNEY ON THE FRONT AND SIDES AND A MINIMUM OF 16" BEHIND THE CHIMNEY.
- 4.) A CRICKET IS REQUIRED BEHIND ALL CHIMNEYS WIDER THAN 24 INCHES OR LOCATED ON ROOFS STEEPER THAN 6 INCHES PER FOOT. CRICKET HERE SHOULD BE FLAT SEAM SOLDERED COPPER.



DRAWN BY:	CHECKED BY:	#	DATE	BY I	PESCRIPTION	DWG. NUMBER:
TEA	SMB					_
DATE:	SCALE:	⊢				┥ !
		\vdash				$+$ D ϵ
3-29-19	³ / ₈ "=1'-0"	\vdash				ן ש-ס
DRAWING NAME:	DRAWING NAME:		 	 	 	'
CHIMNEY EL ACHING		\vdash	ļ	<u> </u>		
CHIMNEY FLASHING		L				

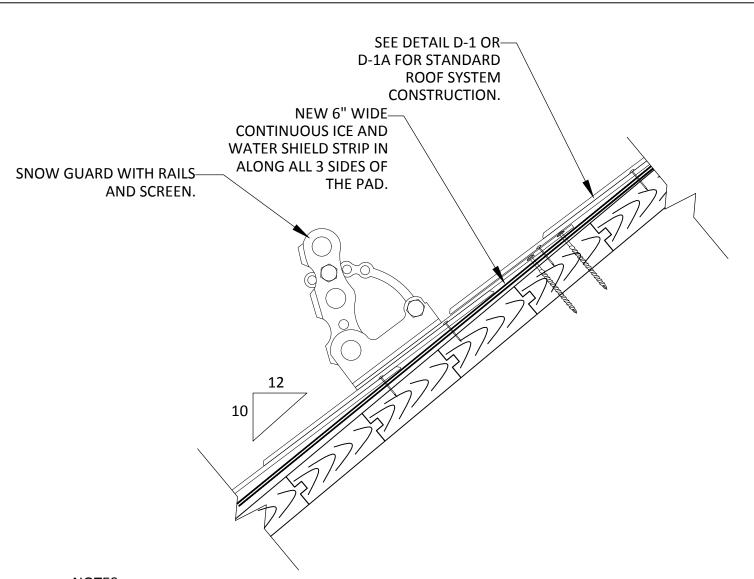

NOTES:

1.) PROVIDE ISOLATION TO ENSURE THAT ANY DISSIMILAR METALS DO <u>NOT</u> COME IN CONTACT WITH EACH OTHER IN THE FINAL PRODUCT TO PREVENT GALVANIC ACTION.



EXAMPLE OF SNOW RAILS, SCREENS AND SNOW CLIPS INSTALLED.




DRAWN BY:	CHECKED BY:	#	DATE	вү і	ESCRIPTION	DWG. NUMBER:
TEA	SMB					
DATE:	SCALE:]
3-29-19	³ / ₈ "=1'-0"					D-7
DRAWING NAME:	•			-		, ,
SNOW FENCE	DETAIL	\vdash		\vdash		



289 Harrel Street Morrisville, VT 05661 Toll Free Phone 1.888.766.4273 Toll Free Fax 1.888.766.9994 Web www.alpinesnowguards.com E-mail info@alpinesnowguards.com

07 52 53 Snow Guards

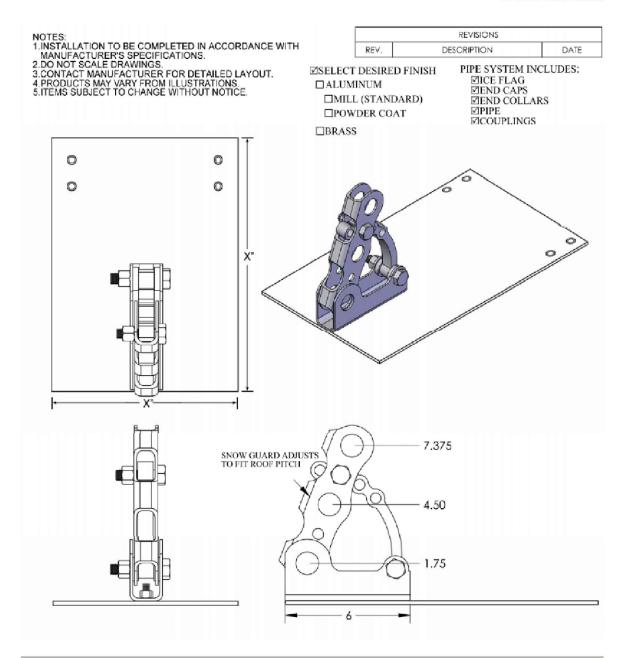


#225 Pipe-Style Snow Guard for Tile/Shingle/Shake Roofs

© Copyright 2007, 2008 Alpine SnowGuards, Vermont Slate & Copper Services, Inc.

Document version 06.07.2007



DRAWN BY:	CHECKED BY:	#	DATE	ВΥ	DESCRIPTION	DWG. NUMBER
TEA	SMB					_
DATE:	SCALE:	1				
3-29-19	³ / ₈ "=1'-0"] D-
DRAWING NAME:				-		→
SNOW FENCE	CUT SHEET	\vdash		-		-

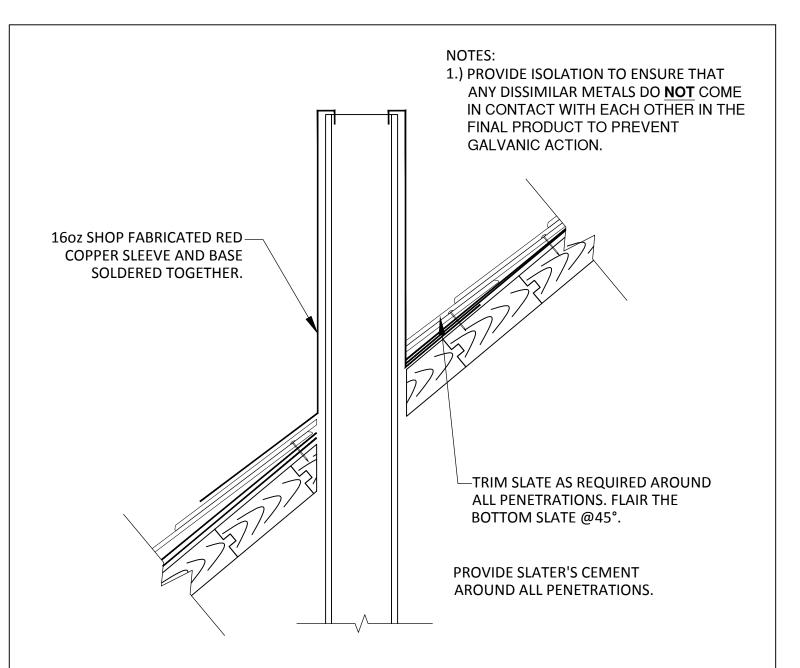





EXAMPLE OF FLAIRED TRIMMED SLATE AT PENETRATIONS



DRAWN BY:	CHECKED BY:	#	DATE	BY [ESCRIPTION	DWG. NUMBER:
TEA	SMB					
DATE:	SCALE:					
3-29-19	³ ⁄ ₈ "=1'-0"					D-9
DRAWING NAME:		⊢		-		
SLATE PENET	RATION	\vdash		-		

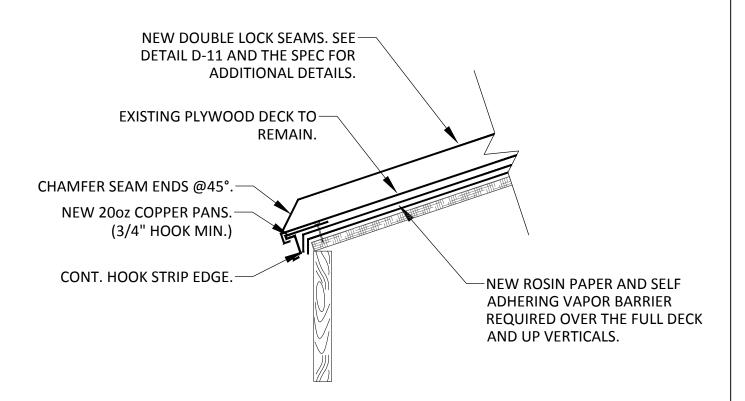

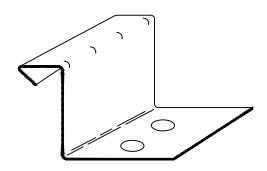


FIXED CLEAT FOR STANDING SEAM




ARM ROOF CONSULTANTS
Advanced Roof Management Associates, Inc.
PO Box 628
North Hampton, NH 03862
(603) 964-1335


DRAWN BY:	CHECKED BY:	#	DATE	BY	DESCRIPTION	DWG. NUMBER:
TEA	CMD					
TEA	SMB			<u> </u>		
DATE:	SCALE:					
3-29-19	³ / ₈ "=1'-0"					□ D-10
DRAWING NAME:		_		<u> </u>		\longrightarrow D 10
STANDING S	EAM EAVE					
ISTAILUINUS	CAM CAVE		1	1	1	

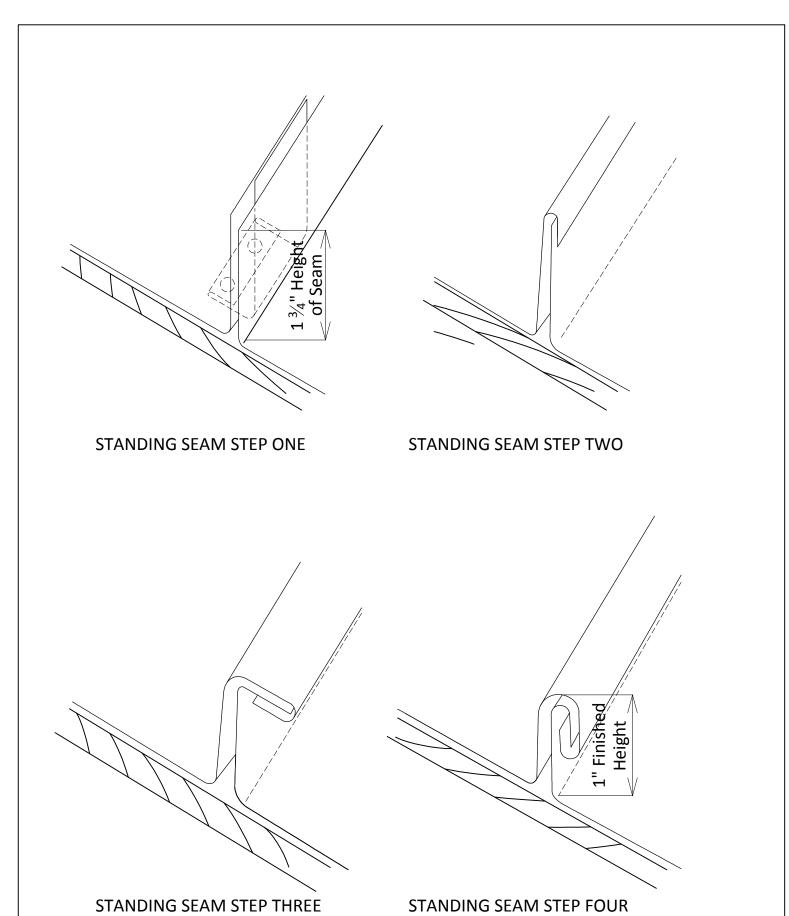

ARMA
ROOF CONSULTANTS
Advanced Roof Management Associates, Inc.
PO Box 628
North Hampton, NH 0.3862
(603) 964-1335


DRAWN BY:	CHECKED BY:	#	DATE	ВΥ	DESCRIPTION	DWG. NUMBER:
TEA	SMB					
DATE:	SCALE:					1
3-29-19	³ / ₈ "=1'-0"					D-11
DRAWING NAME:		⊢		-		-
STANDING SE	AM BENDS	\vdash				1

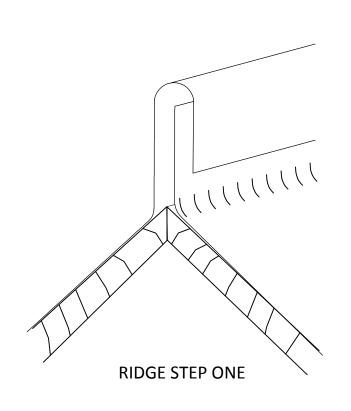

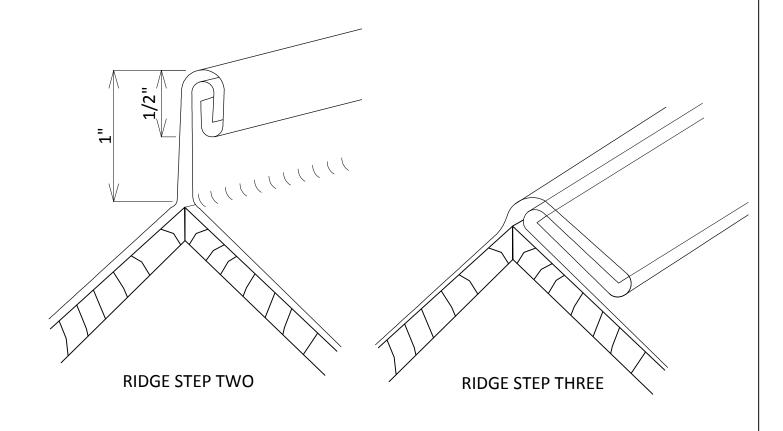




DRAWN BY:	CHECKED BY:	#	DATE	вү і	ESCRIPTION	DWG. NUMBER:
TEA	SMB	H				
DATE:	SCALE:	Г				
3-29-19	³ / ₈ "=1'-0"					D-12
DRAWING NAME:	•	⊢		-		12
COPPER RIDG	ìΕ	⊢				

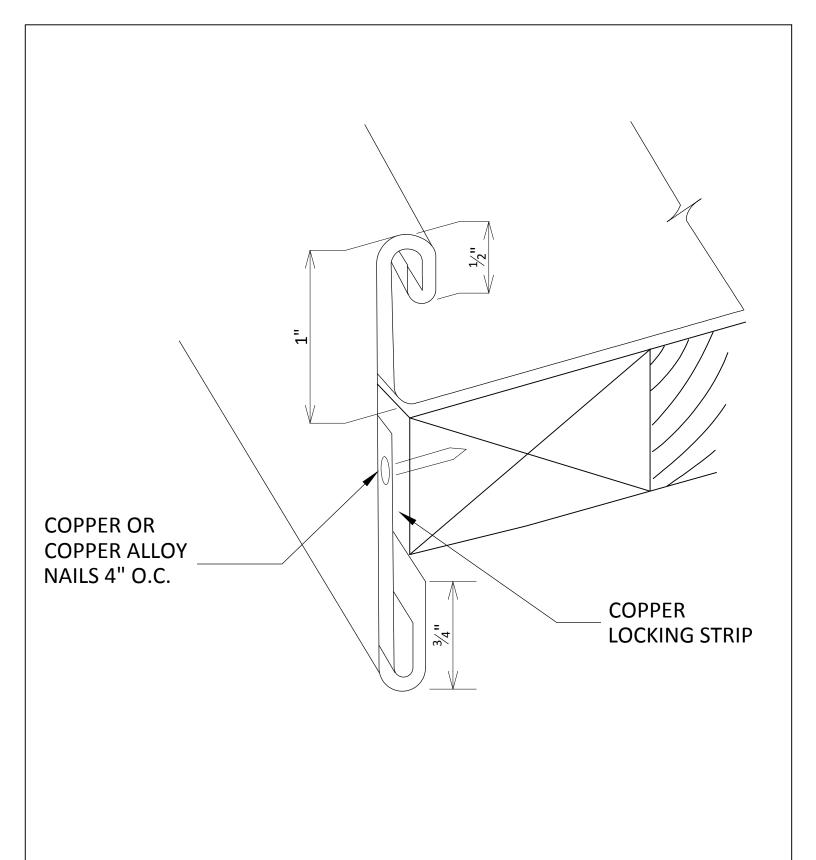




DRAWN BY:	CHECKED BY:	#	DATE	ВҮ	ESCRIPTION	DWG. NUMBER:
TEA	SMB	\vdash				
DATE:	SCALE:					
3-29-19	³ / ₈ "=1'-0"					\square D-13
DRAWING NAME:		ightharpoonup	-	+		\longrightarrow D 13
STANDING 9	SEAM RAKE	\vdash		-		

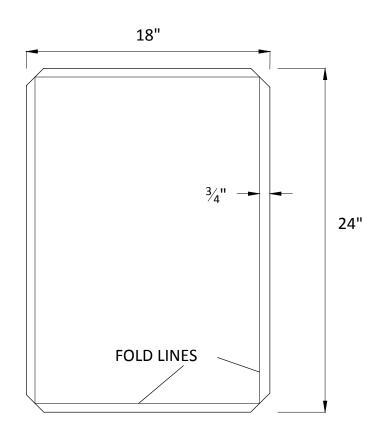



INSTALLED FLAT SEAM COPPER EXPECTATION


FOLDING OF SHEETS-FLAT SHEET

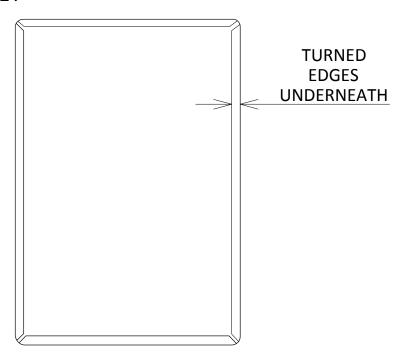

FOLDED SHEET




DRAWN BY:	CHECKED BY:	#	DATE	BY I	ESCRIPTION	DWG. NUMBER:
TEA	SMB					
DATE:	SCALE:					l
3-29-19	³ / ₈ "=1'-0"					D-14
DRAWING NAME:		⊢		-		
FLAT SEAM BE	NDS	\vdash		-		

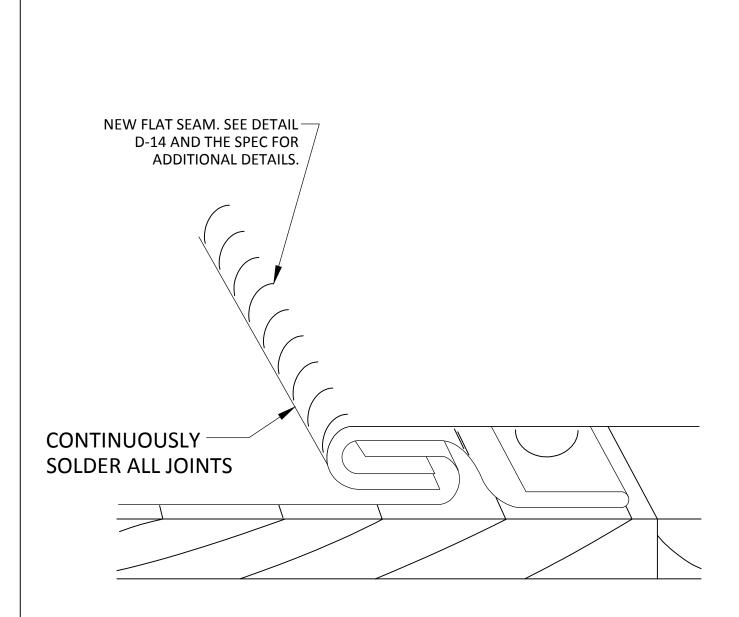



DRAWN BY:	CHECKED BY:	#	DATE	BY	ESCRIPTION	DWG. NUMBER:
TEA	SMB					
DATE:	SCALE:	1_				
3-29-19	³ / ₈ "=1'-0"			-		∃ D-15
DRAWING NAME:	-			₩		10
FLAT SEAM CI	EAT	⊢		-		_

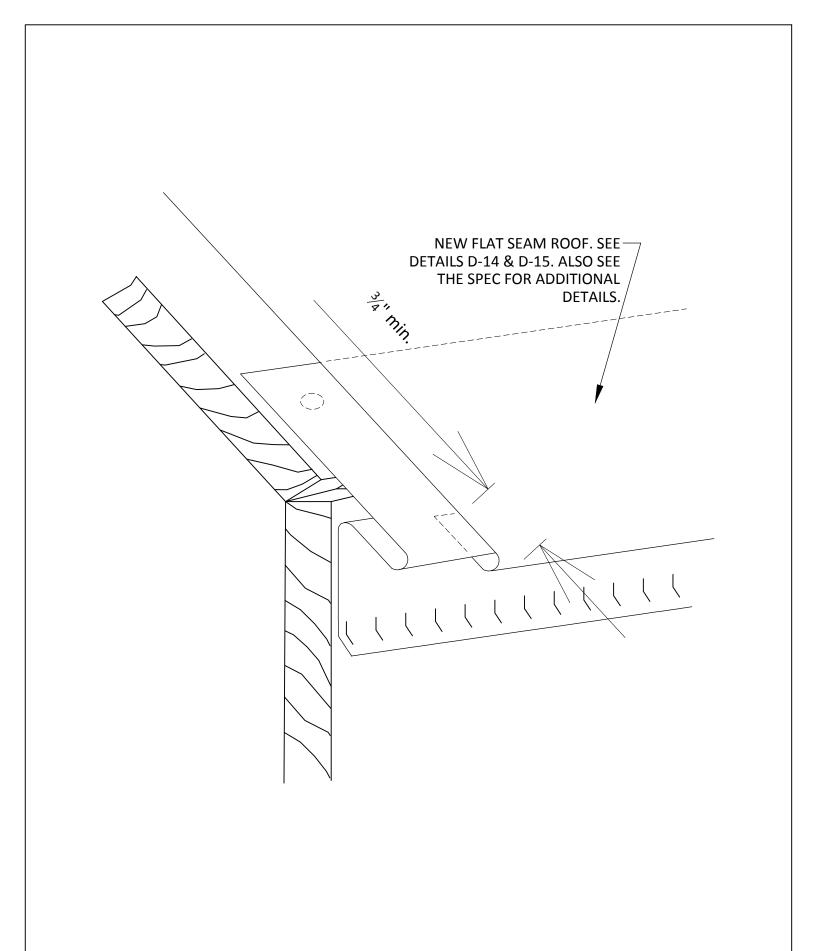



DRAWN BY:	CHECKED BY:	#	DATE	ВΥ	DESCRIPTION	DWG. NUMBER:
TEA	SMB	Е				
DATE:	SCALE:					
3-29-19	³ / ₈ "=1'-0"					□ D-1
DRAWING NAME:	•	╌	-	₩		
FLAT SEAM	EDGE DETAIL	\vdash	+	\vdash		_

2. 111/145 Maplewood Avenue - Recommended Approval

<u>Background</u>: The applicant is seeking approval for a chance to a previously approved design (add north and south roof decks with glass railings, add (4) doors to access proposed decks, and add (4) light fixtures to the proposed roof decks.

Staff Comment: Recommended Approval

	Sti	pυ	lat	ior	is:
--	-----	----	-----	-----	-----

1		
2.		
3		

Historic District Commission Work Session or Administrative Approval Application

LUHD-229

Status: Active

Submitted: Nov 12, 2020

Applicant

R

Neil Hansen

6034338818

@ nahansen@tighebond.com

Location

145 MAPLEWOOD AVE Portsmouth, NH 03801

Application Type

Please select application type from the drop down menu below

Administrative Approval

Project Information

Brief Description of Proposed Work

REVISED DESIGN 12-02-2020 AGENDA

- 1. Add North and South roof decks with glass railings.
- 2. Add 4 doors to access new roof decks.
- 3. Add 4 WP2 light fixture at new roof decks.

Description of Proposed Work (Planning Staff)

--

Project Representatives

Phone

603-518-2279

Business Name (if applicable)

Procon Inc.

City/Town

Manchester

Zip Code

03108

State

NH

Email Address

clizotte@proconinc.com

Mailing Address (Street)

PO Box 4430

Full Name (First and Last)

Chris Lizotte

Relationship to Project

Architect

If you selected "Other", please state relationship to project.

--


Acknowledgement

I certify that the information given is true and correct to the best of my knowledge.

true

By checking this box, I agree that this is equivalent to a handwritten signature and is binding for all purposes related to this transaction

true

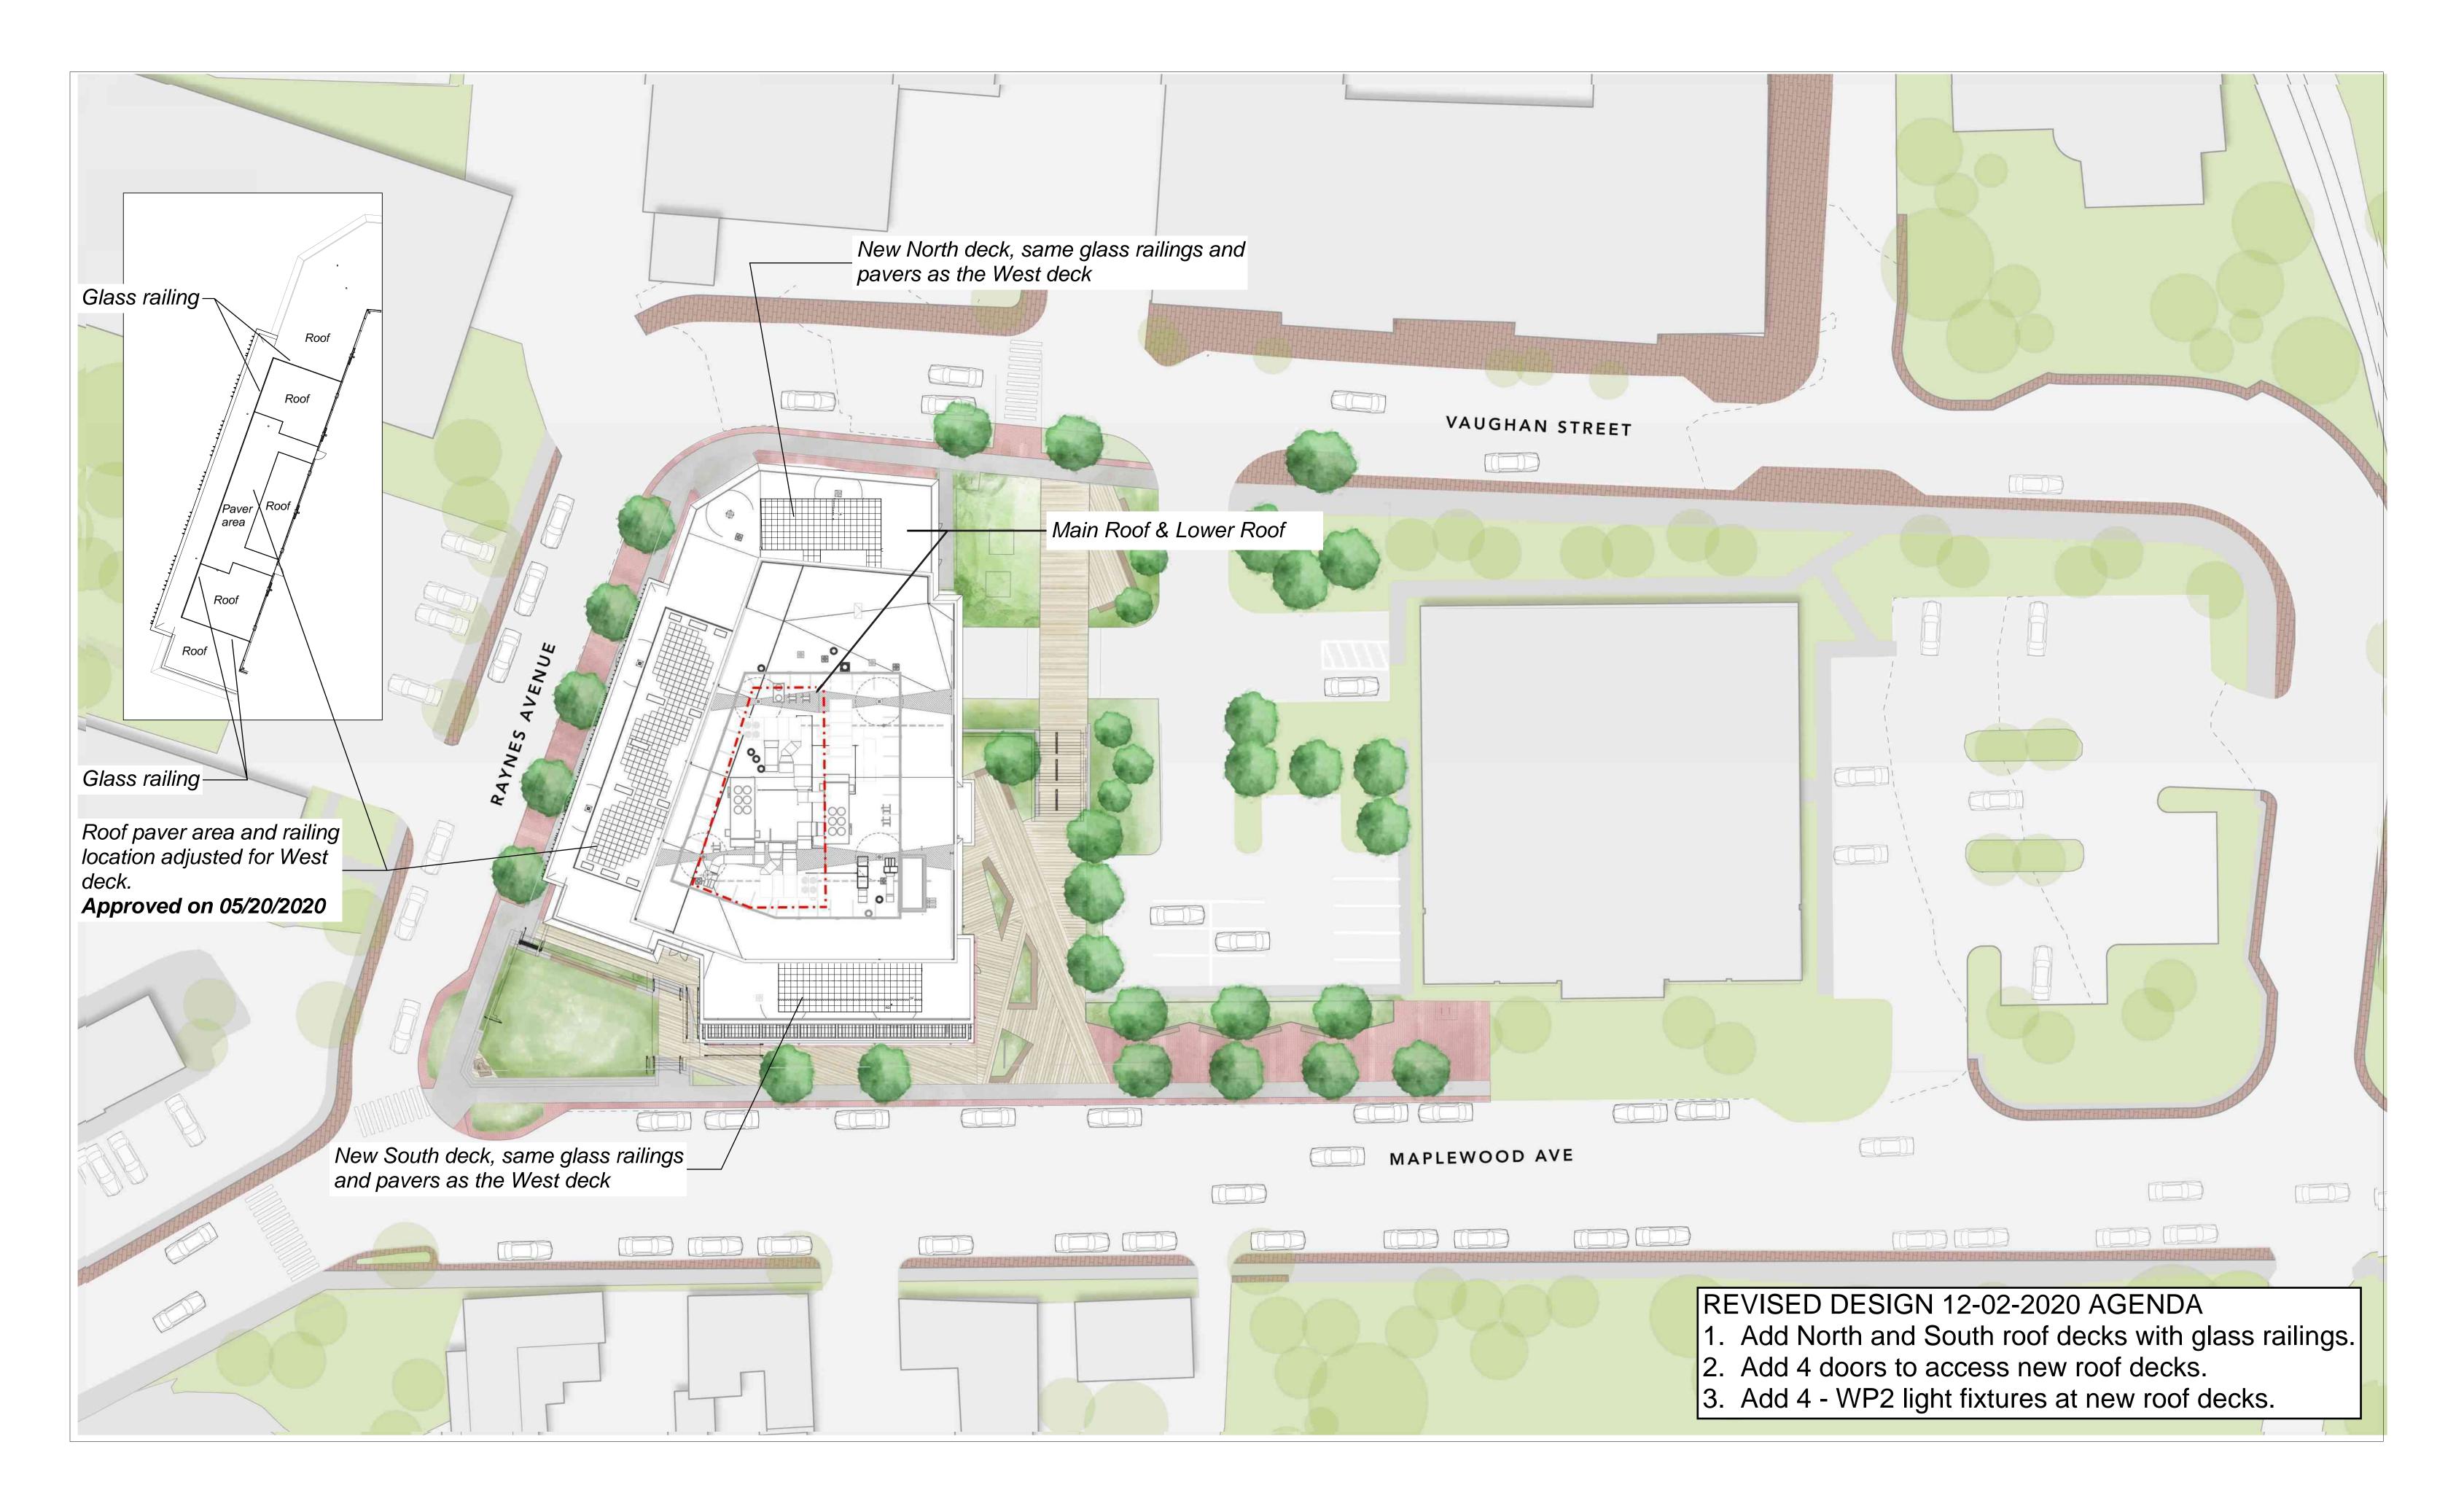





Maplewood Ave


New South deck, same glass railings as the West deck

New North deck, same glass railings __as the West deck



Vaughan Street



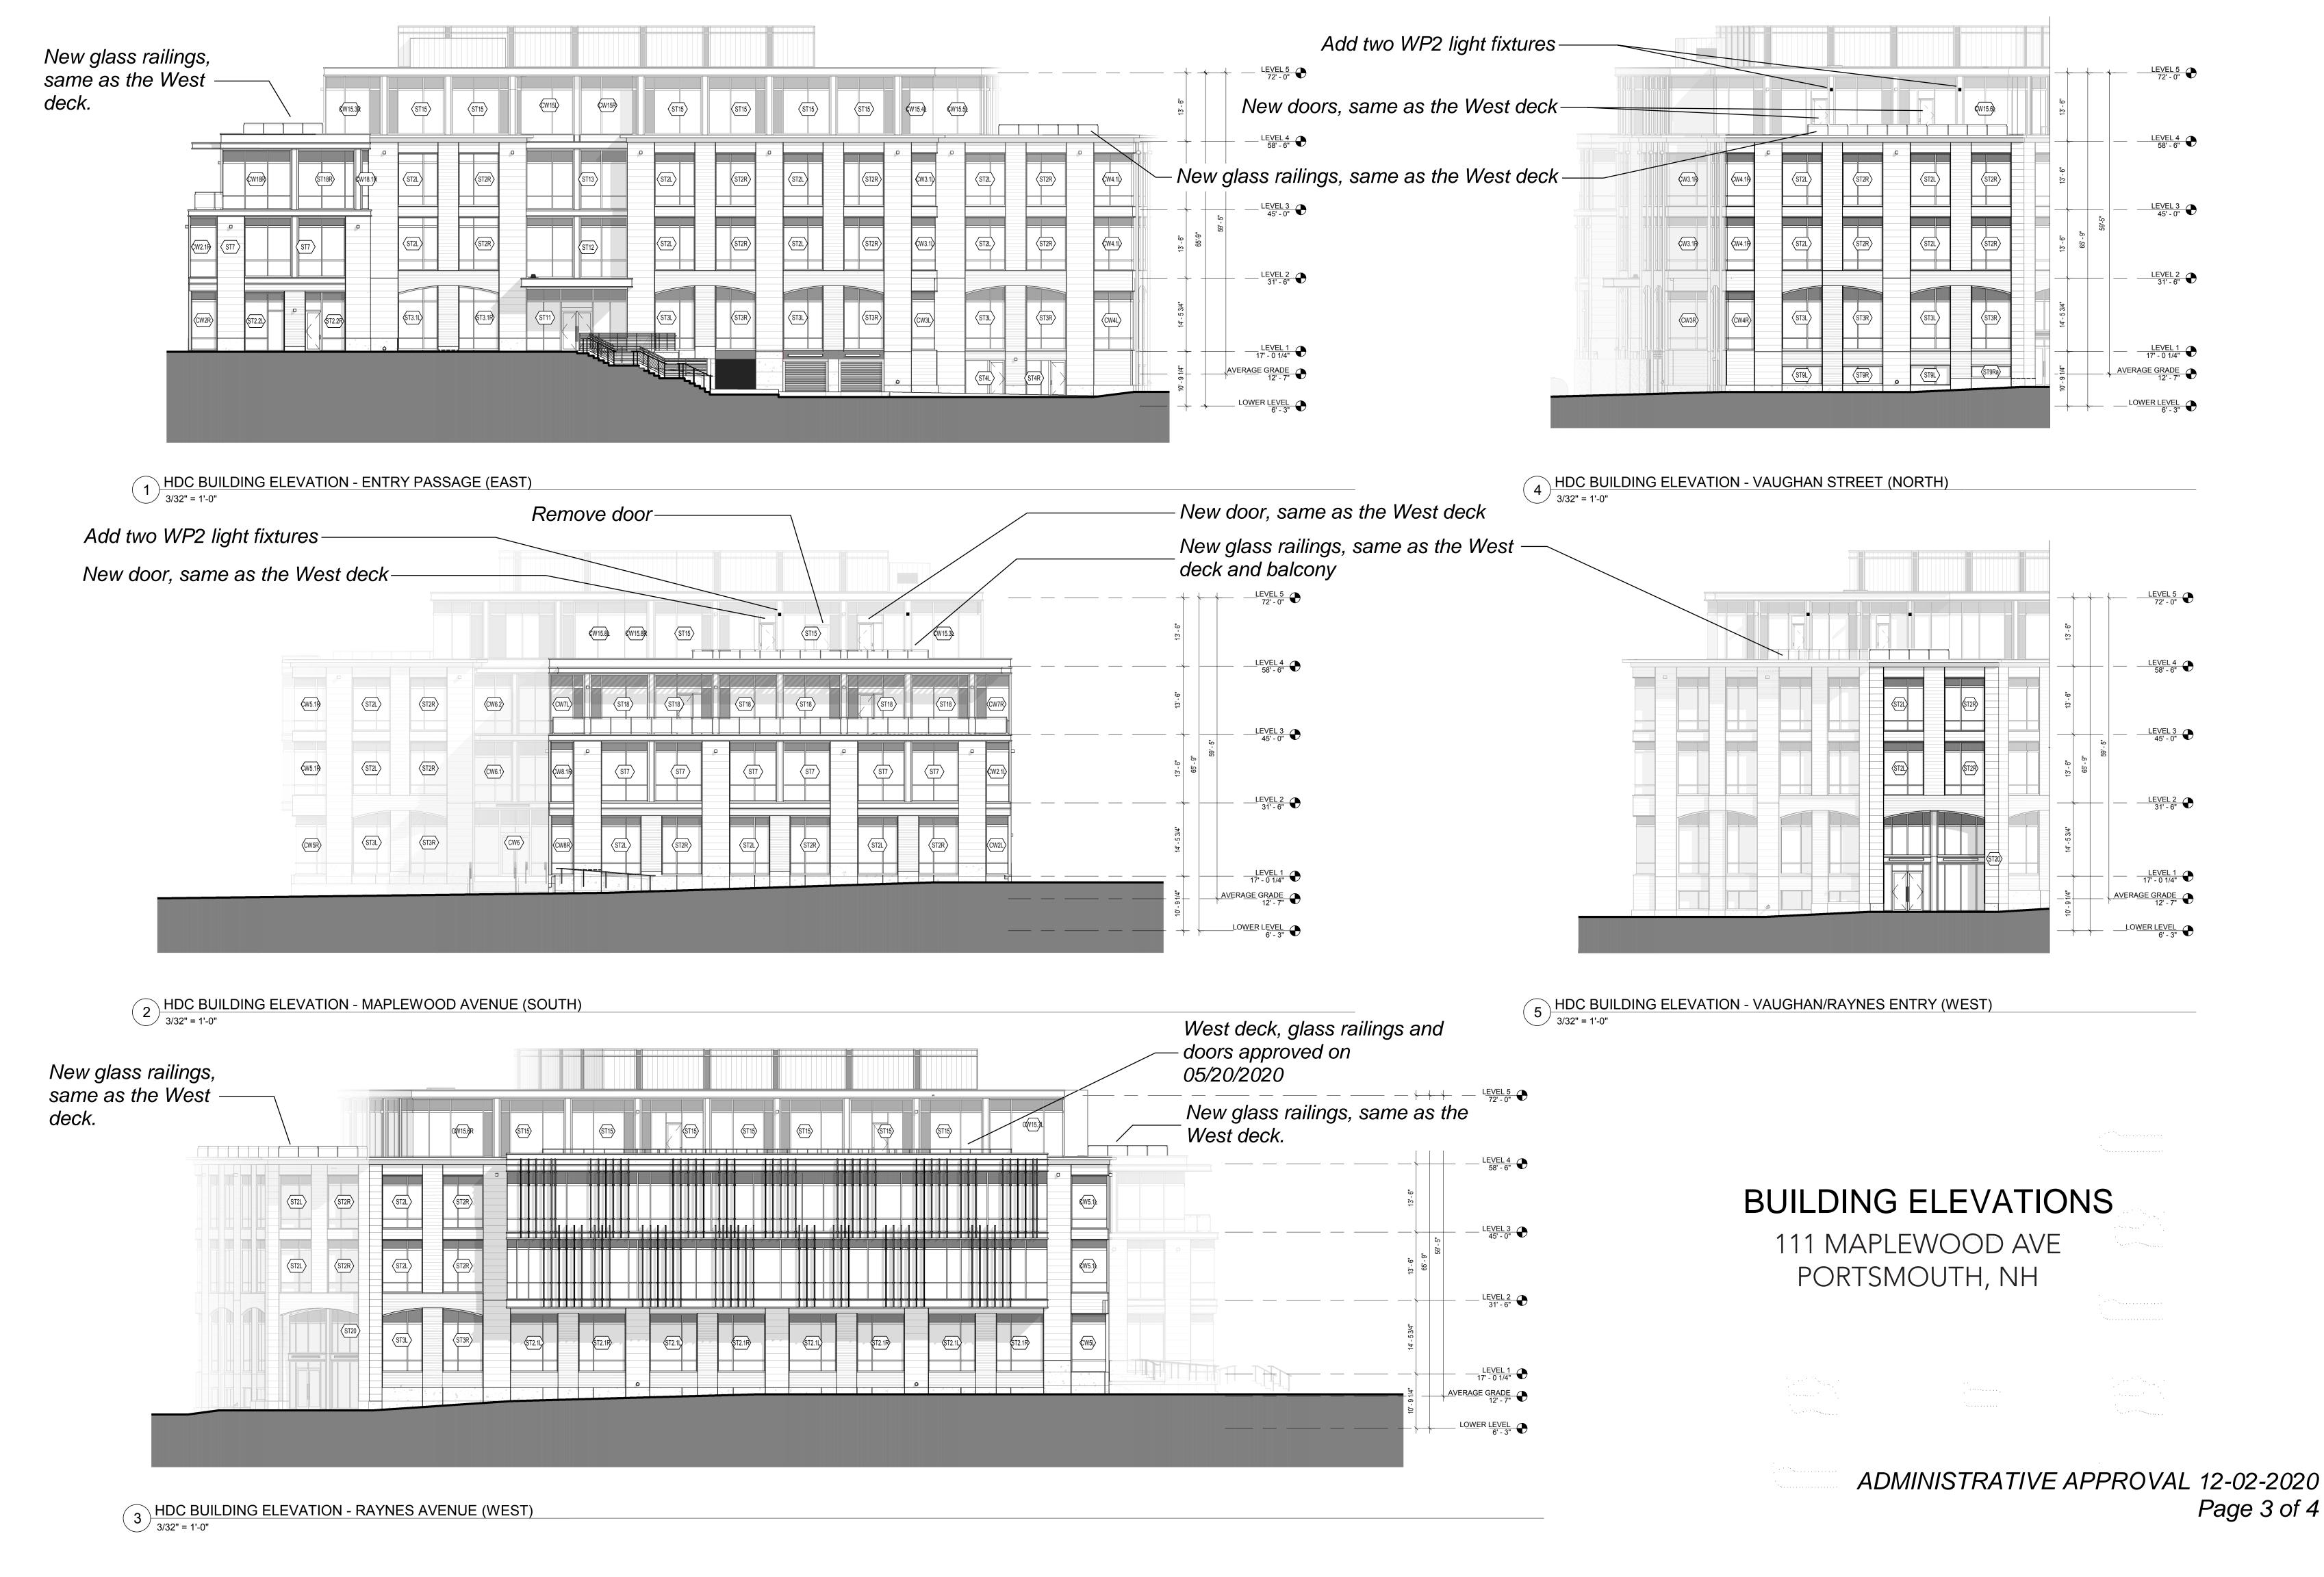


SQUARE – model: WS-W386

LED Interior & Exterior Sconce

Low wall areas, balcony and roof terrace



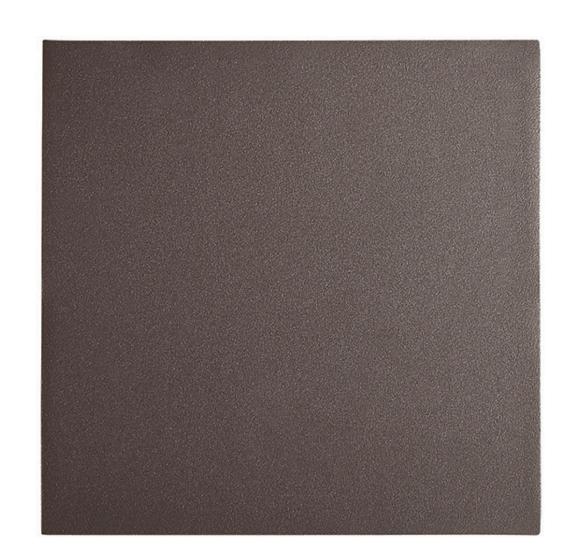

PRODUCT DESCRIPTION

Four equal sides and a stream of light. Square artfully provides geometry to wall surfaces in the daytime when mounted in multiples while providing safe illumination of pathways and dramatic visual intrigue in the evening. Perfect for wall grazing surfaces.

FEATURES


- Dark Sky friendly
- ADA compliant, low profile design
- ETL & cETL, wet location listed, IP65 rated
- Aluminum construction
- Full range dimming when used with compatible dimmers
- No transformer or driver required
- 277V option available (special order)
- 50,000 hour rated life
- Color Temp: 3000K


• CRI: 90

Fixture Type: WP2 Catalog Number:

Project: 145 Maplewood, Portsmouth NH

Location: Exterior Wall

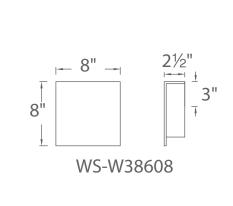

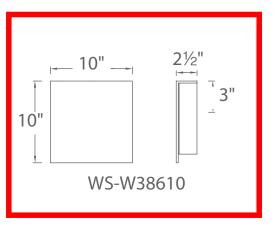

SPECIFICATIONS

Construction: Aluminum construction.

Light Source: High output LED.

Finish: Titanium (TT), Bronze (BZ).

Standards: ETL & cETL damp location listed. IP65 rated.

ADA compliant. Dark Sky friendly.

ORDER NUMBER

Model	Width	Wattage	Voltage	LED Lumens	Delivered Lumens	Finish	
WS-W38608	8"	9W	1201/	486	398	BZ Bronze	
WS-W38610	10"	15W	1207	836	720	TT Titanium	

Example: WS-W38608-BZ

For 277V special order, add an "F" before the finish: WS-W38608F-BZ

modernforms.com Phone (800) 526.2588 Fax (800) 526.2585

Headquarters/Eastern Distribution Center 44 Harbor Park Drive Port Washington, NY 11050 Central Distribution Center 1600 Distribution Ct Lithia Springs, GA 30122

Western Distribution Center 1750 Archibald Avenue Ontario, CA 91760 Light type

Approved on 05/20/2020

BUILDING LIGHTING

3. 209 Marcy Street

- TBD

<u>Background</u>: The applicant is seeking approval for the installation of a Mitsubishi A/C condenser.

<u>Staff Comment</u>: Additional screening may be required.

Stipulations:

Historic District Commission Work Session or Administrative Approval Application

LUHD-230

Status: Active

Submitted: Nov 12, 2020

Project: 209 Marcy Street - Install mini-split.

Applicant

Harold Lorencic 978-697-5884

harry.lorencic@gmail.com

Location

209 MARCY ST Portsmouth, NH 03801

Application Type

Please select application type from the drop down menu below

Administrative Approval

Project Information

Brief Description of Proposed Work

Install a Mitsubishi Ductless Air Conditioner

Description of Proposed Work (Planning Staff)

Project Representatives

Acknowledgement

I certify that the information given is true and correct to the best of my knowledge.

true

By checking this box, I agree that this is equivalent to a handwritten signature and is binding for all purposes related to this transaction

true

I hereby certify that as the applicant for permit, I am

Owner of this property

If you selected "Other" above, please explain your relationship to this project. Owner authorization is required.

INTERNAL USE ONLY -- Historic District Commission Review and Approval

HDC Certificate of Approval Granted

HDC Approval Date


Planning Staff Comments

INTERNAL USE ONLY -- Letter of Decision Information

Owner Addressee Full Name and Title

Owner Addressee Prefix and Last Name

Portsmouth Historic District Commission 209 Marcy Street Administrative Approval December 2, 2020

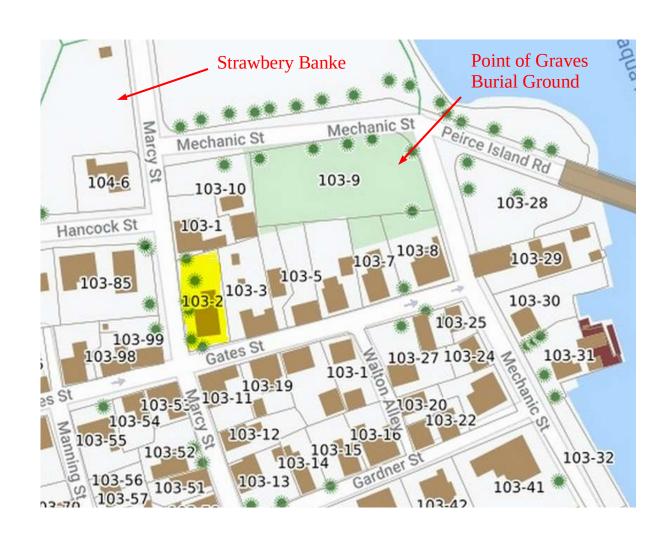

Map Lot: 103-2

Address: 209 Marcy Street Owners: Harold & Kimberly

Lorencic

Existing View West Side, Marcy St



Existing Partial View North Side



Existing View South Side, Gates St



Existing Partial View North Side



Scope of Work:

Install a Mitsubishi ductless mini split air conditioner system consisting of three indoor units and one outdoor compressor. Units will be installed as follows;

- 1. 1st floor dining room
- 2. 1st floor great room
- 3. 2nd floor bedroom.

Work to be done by East Coast HVAC: 436 Shattuck Way #5, Newington NH

Compressor: Model MXZ-3C30NAHZ Dimensions: 41 3/8" Wide x 41 5/16" High (59" w/ Stand) x 13" Deep

Freon and drain lines run to the outside of the house and are covered with a Fortress Line Cover that can be painted to match the exterior finish.

Compressor



Examples of the Fortress Line Cover









Proposed Location for Fortress Line Cover Run & Compressor

2nd Floor Bedroom Fortress Run



Alternate Dining Room Fortress Run

Preferred Dining Room Fortress Run.



Compressor Location

Great Room Fortess Run & Compressor



4. 37 South Street

- Recommended Approval

<u>Background</u>: The applicant is seeking approval for the installation of deck skirting on the lower portion of the rear deck. The skirting will be a combination of vertical composite board and lattice.

Staff Comment: Recommended Approval

Stipu	lations:		
1.			
2.			

Historic District Commission Work Session or Administrative Approval Application

LUHD-238

Status: Active

Submitted: Nov 24, 2020

Applicant

R

kevin charette

8607127136

ktc@comcast.net

Location

37 SOUTH ST Portsmouth, NH 03801

Application Type

Please select application type from the drop down menu below

Administrative Approval

Project Information

Brief Description of Proposed Work

Install deck skirting on rear of house, approximately 18 feet length by 7 feet wide and 6.5 feet high. Under deck entry door installed on west side. Lower 4.5 feet of skirt to be 4 inch vertical white composite board spaced approximately 1/4 - 1/2 inch. Top 2 feet of skirt to be small square vinyl lattice. Door to be constructed of vertical board. Material consistent with recently remodeled upper deck.

Description of Proposed Work (Planning Staff)

Project Representatives

Email Address Full Name (First and Last)

lori charette Ichar@comcast.net

Mailing Address (Street) State 37 south street

Phone Relationship to Project

8606900743 Owner

City/Town **Business Name (if applicable)**

portsmouth

If you selected "Other", please state relationship to project. Zip Code

03801

Acknowledgement

I certify that the information given is true and correct to the best of my knowledge.

true

By checking this box, I agree that this is equivalent to a handwritten signature and is binding for all purposes related to this transaction

true

nh

