
# THE GETTY

361 ISLINGTON STREET HISTORIC DISTRICT COMMISSION PUBLIC HEARING - 10/05/2022

PREVIOUS SUBMISSIONS: WORK SESSION - 09/07/2022

# SITE LOCATION MAP:

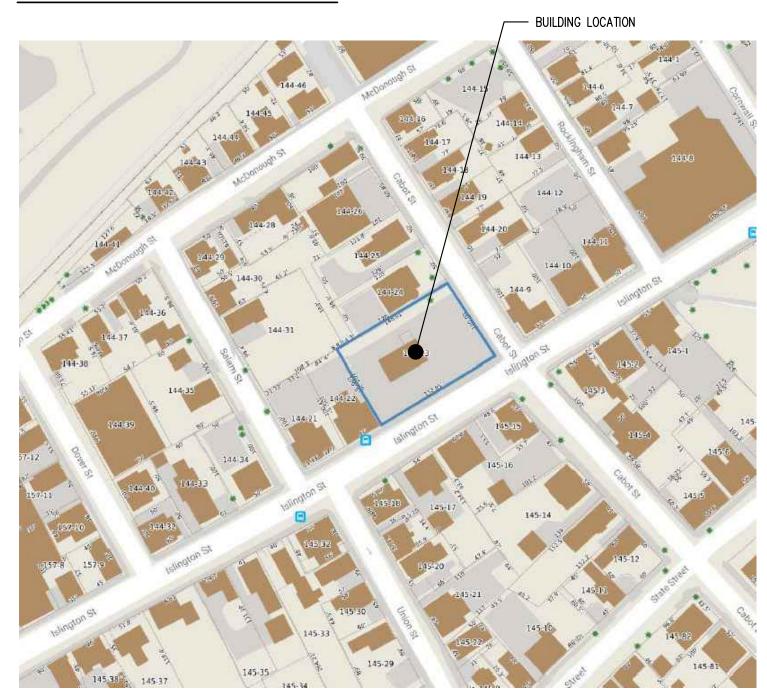

# **DESIGN INTENT:**

- TRANSFORM THE FORMER GAS STATION / FORMER OUTDOOR FOOD TRUCK COURT INTO A FULL SERVICE RESTAURANT WITH INDOOR AND OUTDOOR SEATING.
- ADD TO THE VITALITY OF ISLINGTON STREET WITH THE ADDITION OF A PUBLIC GATHERING SPACE.
- CONSTRUCT A SMALL ADDITION TO THE WEST OF THE EXISTING STRUCTURE TO REPLACE A LARGE GLAZED GARAGE DOOR TO CREATE A BUFFER TO THE NEIGHBORING PROPERTY.
- CONSTRUCT AN ADDITION TO THE NORTH OF THE EXISTING STRUCTURE TO PROVIDE SPACE FOR KITCHEN, COOLING EQUIPMENT, AND NEW RESTROOMS FOR THE RESTAURANT.
- ALTER THE EXISTING CANOPY TO CREATE OUTDOOR SEATING AREAS THAT ARE BOTH FULLY COVERED AND PARTIALLY COVERED.
- LANDSCAPING AND PLANTERS WILL BE CONSTRUCTED TO CREATE A BUFFER BETWEEN THE SEATING AND STREETSCAPE AREAS.
- EXISTING WINDOWS AND DOORS WILL BE REPAIRED AND/OR REPLACED. NEW WOOD AND METAL CLADDING WILL BE INSTALLED OVER PORTIONS OF THE EXISTING CONCRETE BLOCK. OTHER AREAS OF CONCRETE BLOCK SHALL BE PAINTED.
- A FENCE WILL BE PROVIDED ALONG THE NORTH RETAINING WALL AS A BUFFER BETWEEN THE PARKING AND THE NEIGHBORING PROPERTY.

## **DRAWING INDEX:**

## **GENERAL**

TO.1 TITLE SHEET

T1.0 EXISTING SITE PHOTOS

## **EXISTING DRAWINGS**

AE1.0 EXISTING SITE PLAN AE1.1 EXISTING FLOOR PLAN AE2.0 EXISTING ELEVATIONS

AE2.1 EXISTING ELEVATIONS

## ARCHITECTURAL DRAWINGS

A1.0 PROPOSED SITE PLAN

1.1 PROPOSED FLOOR PLAN

A2.0 PROPOSED ELEVATIONS

A2.1 PROPOSED ELEVATIONS

A5.0 SECTIONS AND DETAILS

A7.0 DOOR AND WINDOW TYPES

A8.0 PERSPECTIVE IMAGES

A8.1 BEFORE/AFTER IMAGES

49.0 MATERIÁL INSPIRATION

A9.1 PRODUCT DATA

THE GETTY

361 ISLINGTON STREET PORTSMOUTH, NEW HAMPSHIRE 03801

JECT:

# WINTER HOLBEN

7 WALLINGFORD SQ UNIT 209-9 KITTERY, MAINE 03904 207.994.3104

THE GETTY
361 ISLINGTON ST.

PORTSMOUTH, NH 0380
PROJECT NO.: 2206
PRAWN BY: BH, R\

APPROVED BY:
ISSUE DATE:
DRAWING NAME:

Cover

2022/09/16

SCALE:

T0.1

THE GETTY 361 ISLINGTON ST.

2022/09/16 EXISTING PHOTOS

T1.0





EXISTING NORTH EAST BUILDING CORNER



EXISTING NORTH WEST BUILDING CORNER




EXISTING WEST ELEVATION








EXISTING SOUTH ELEVATION EXISTING SOUTH ELEVATION

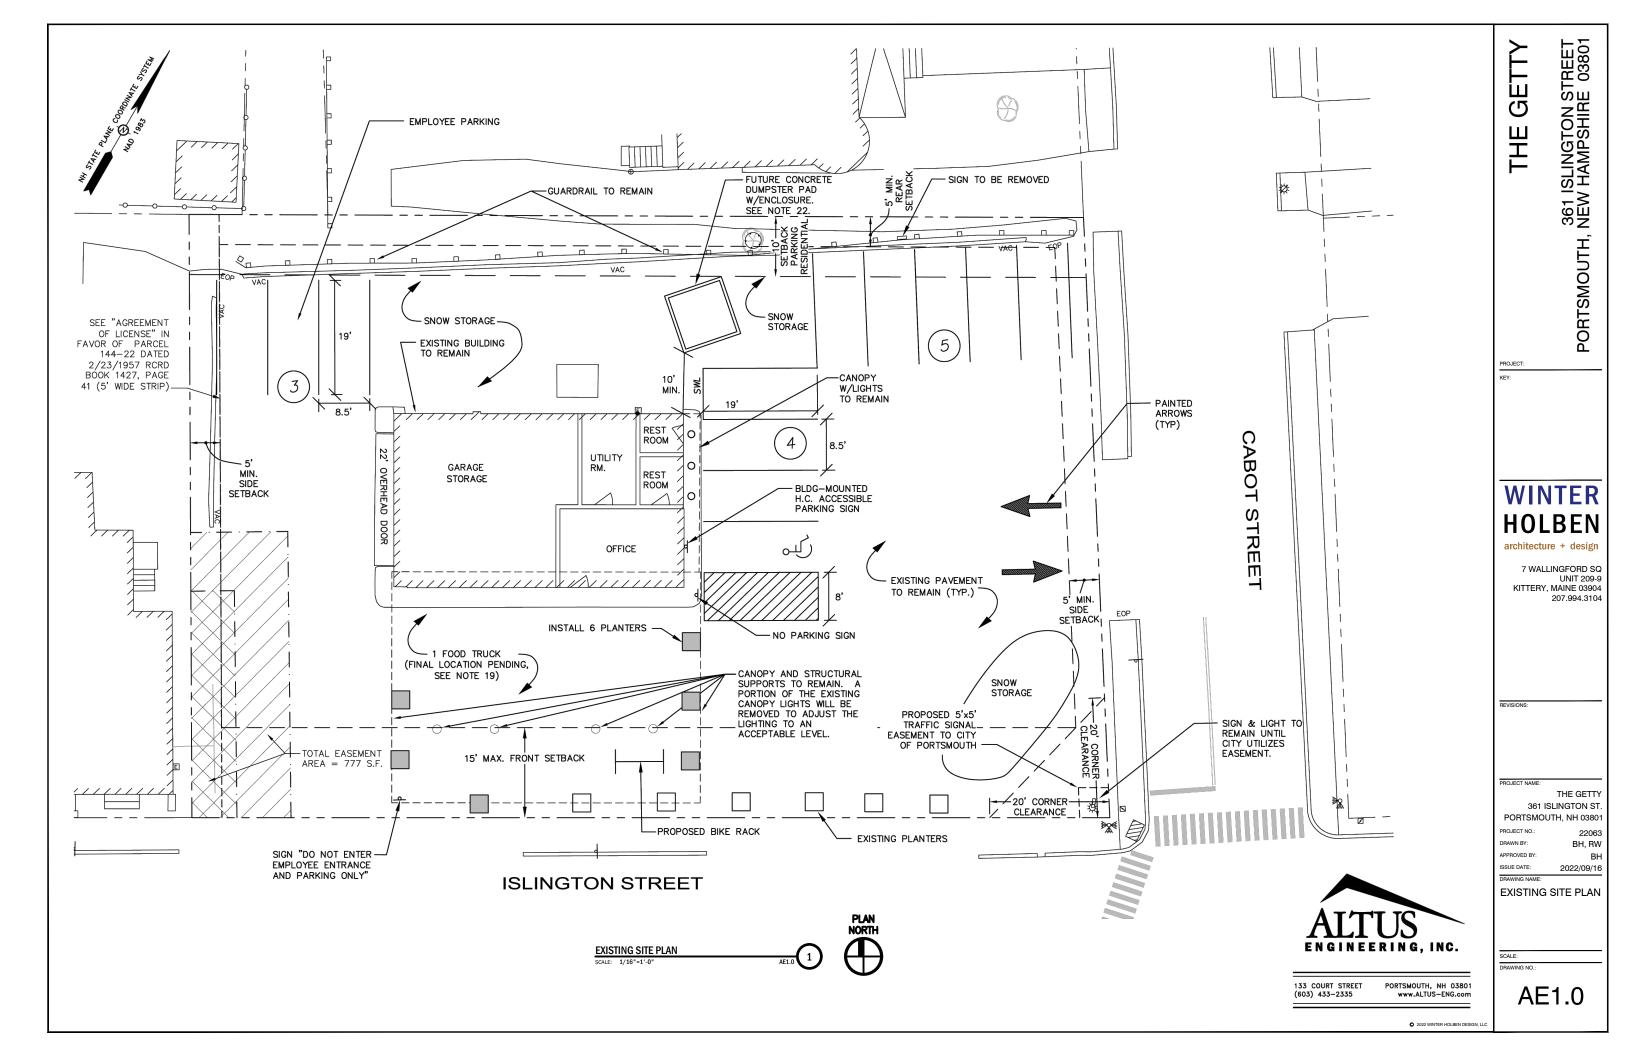

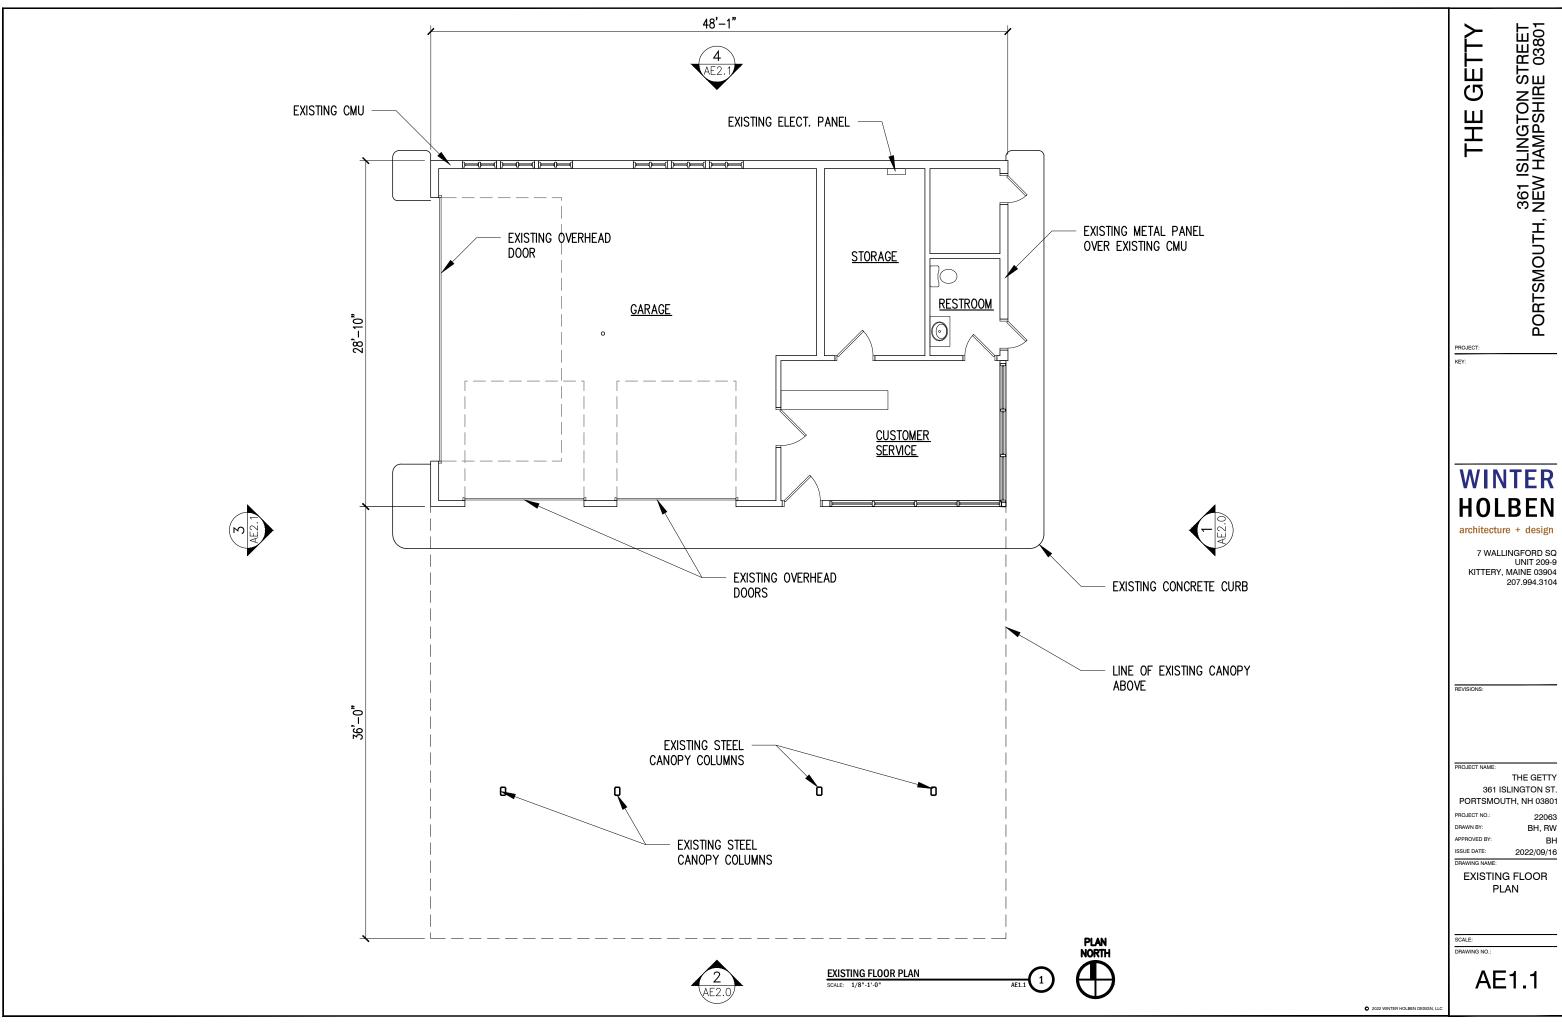

361 ISLINGTON STREET PORTSMOUTH, NEW HAMPSHIRE 03801


THE GETTY


22063 BH, RW APPROVED BY: 2022/09/16


ISSUE DATE:


**EXISTING ELEVATIONS** 

AE2.0

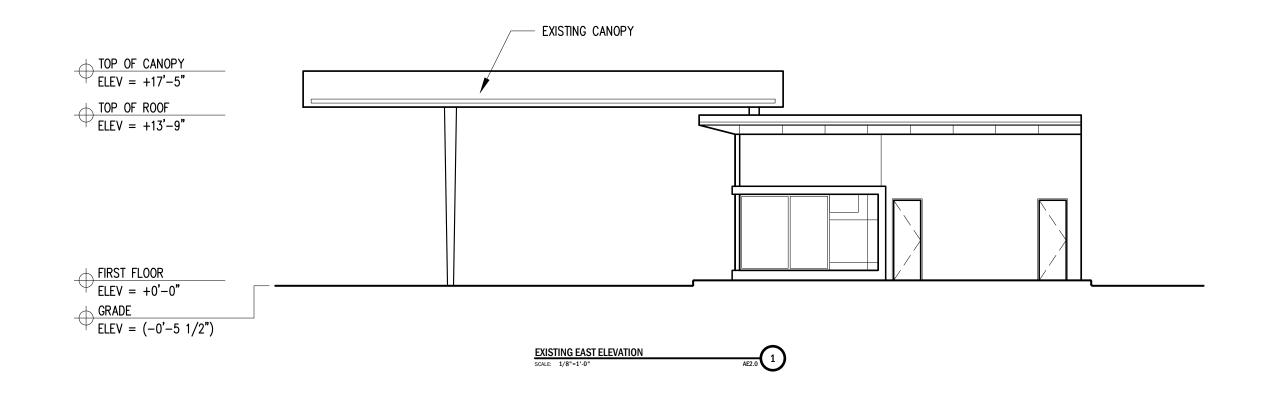

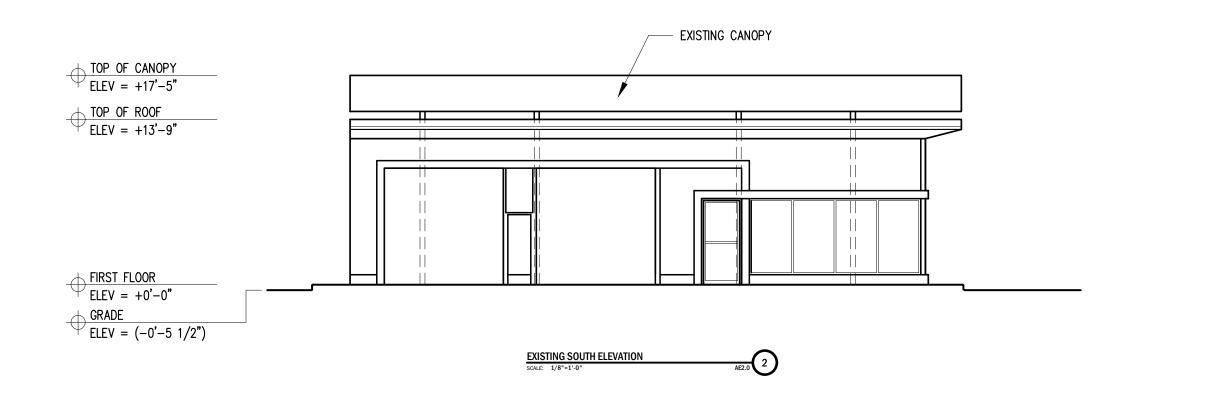

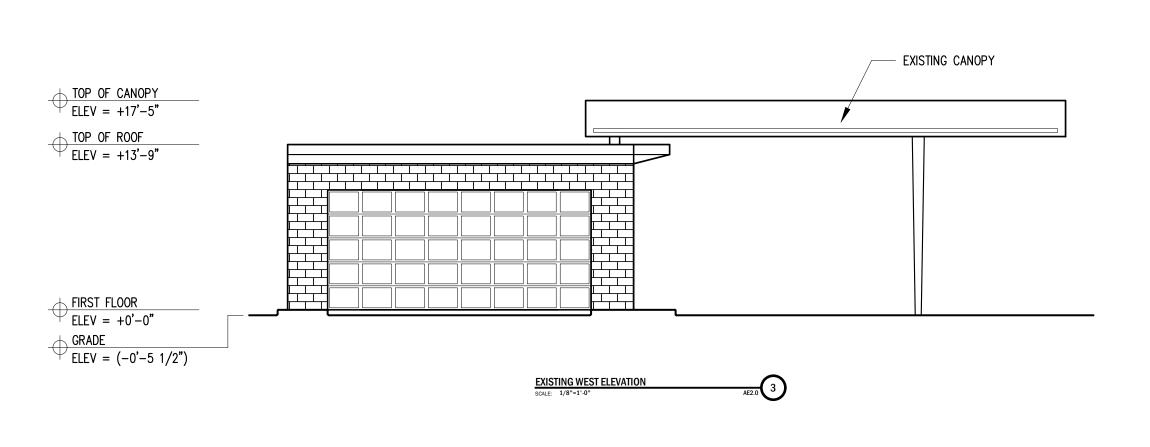

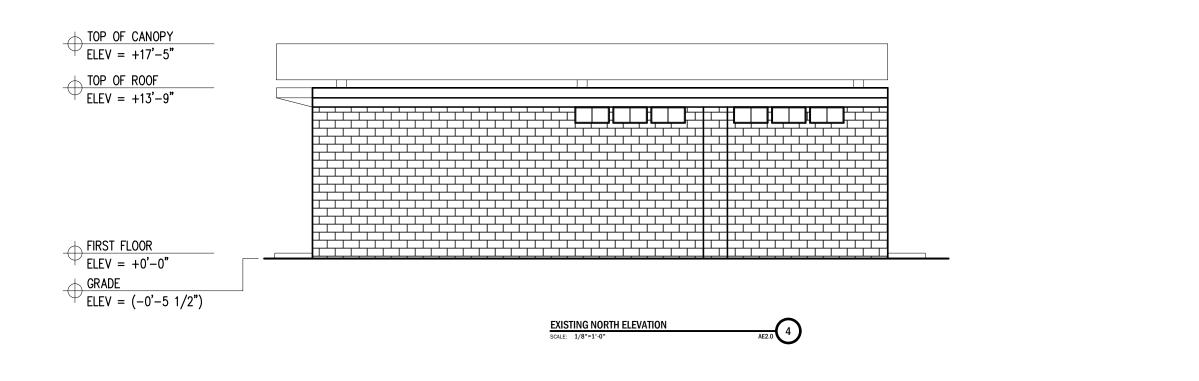

THE GETTY

361 ISLINGTON STREET PORTSMOUTH, NEW HAMPSHIRE 03801

PROJECT

WINTER HOLBEN

architecture + design

7 WALLINGFORD SQ UNIT 209-9 KITTERY, MAINE 03904 207.994.3104

REVISIONS

ROJECT NAME:

361 ISLINGTON ST. PORTSMOUTH, NH 03801

THE GETTY

 PROJECT NO.:
 22063

 DRAWN BY:
 BH, RW

 APPROVED BY:
 BH


 ISSUE DATE:
 2022/09/16


EXISTING
ELEVATIONS


SCALE: DRAWING

AE2.1



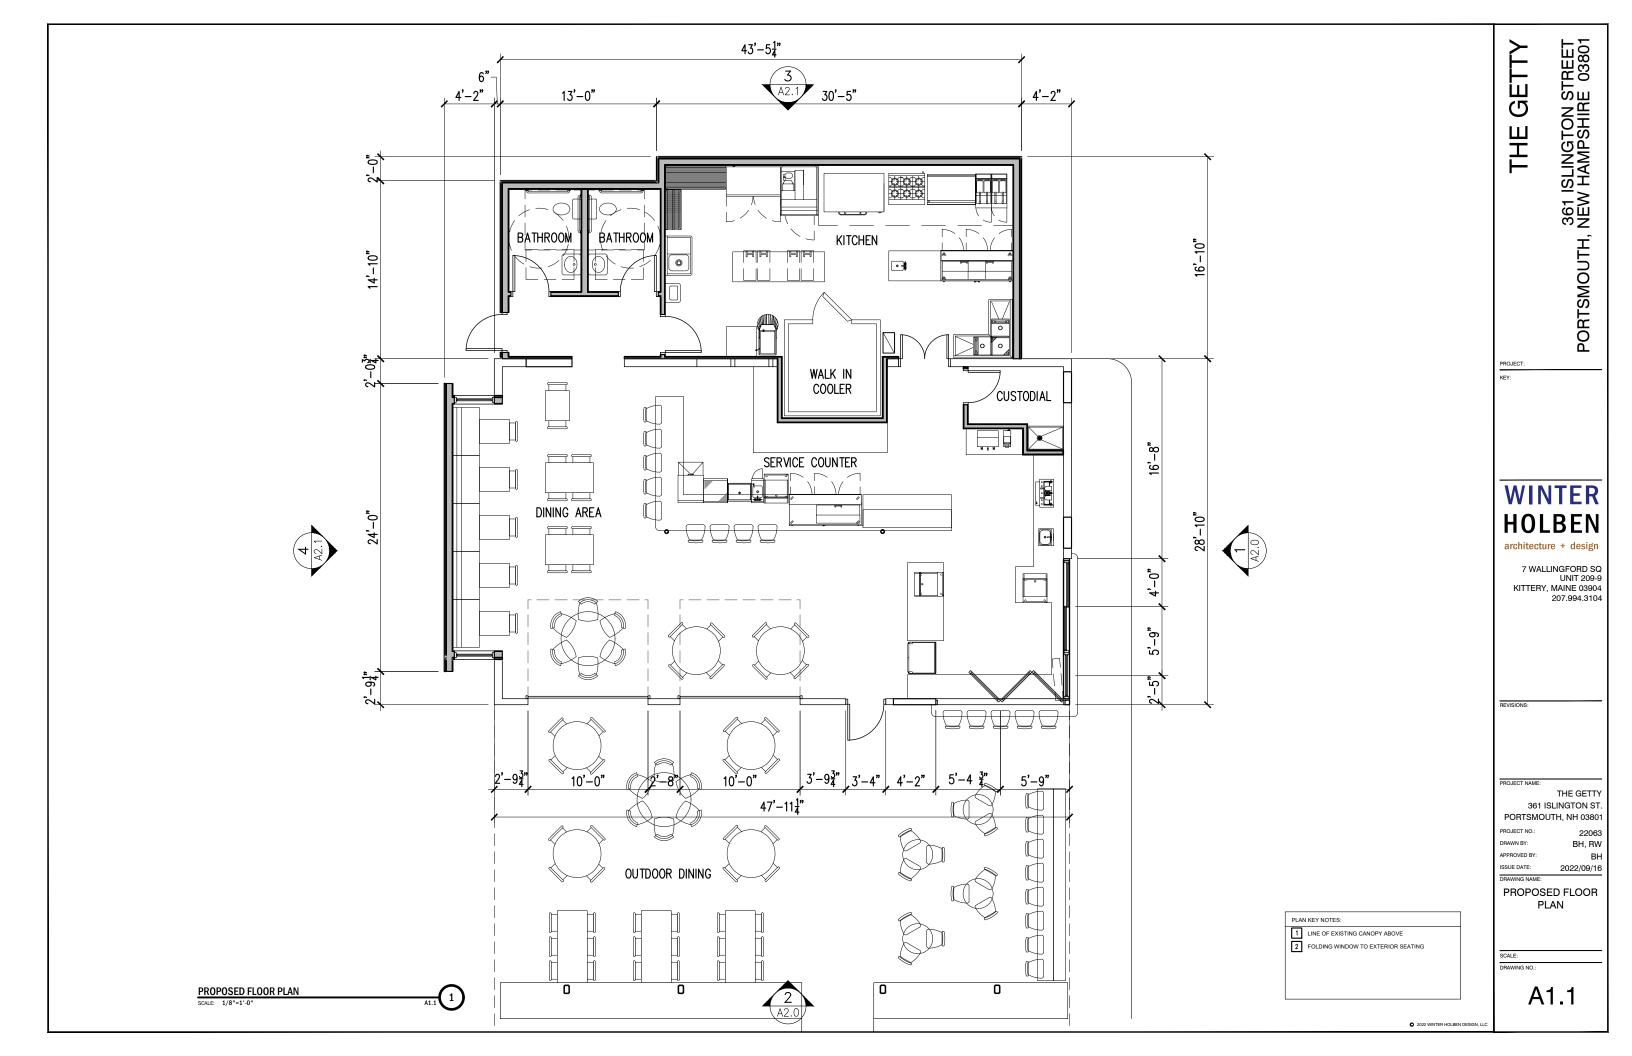

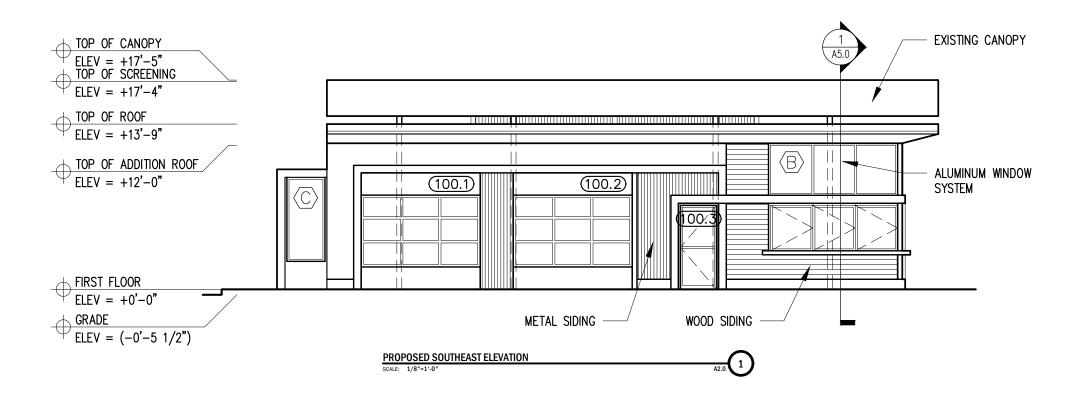

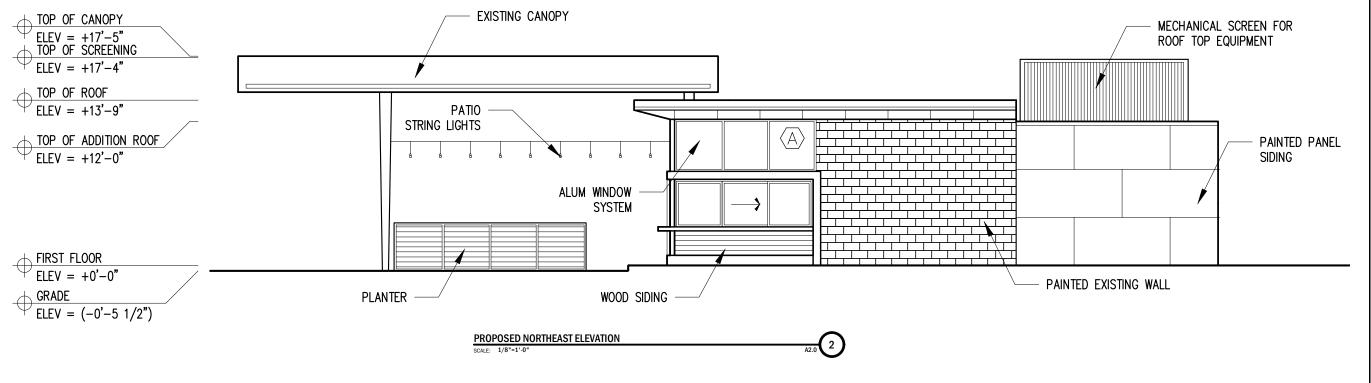

THE GETTY
361 ISLINGTON STREET
PORTSMOUTH, NEW HAMPSHIRE 03801

PROJECT:

## WINTER HOLBEN

architecture + design

7 WALLINGFORD SQ UNIT 209-9 KITTERY, MAINE 03904 207.994.3104

EVISIONS:

JECT NAME:

THE GETTY 361 ISLINGTON ST. PORTSMOUTH, NH 03801

 PROJECT NO.:
 22063

 DRAWN BY:
 BH, RW

 APPROVED BY:
 BH


 ISSUE DATE:
 2022/09/16


PROPOSED ELEVATIONS

SCALE: DRAWING NO.:

A2.0

022 WINTER HOLBEN DESIGN, LLC

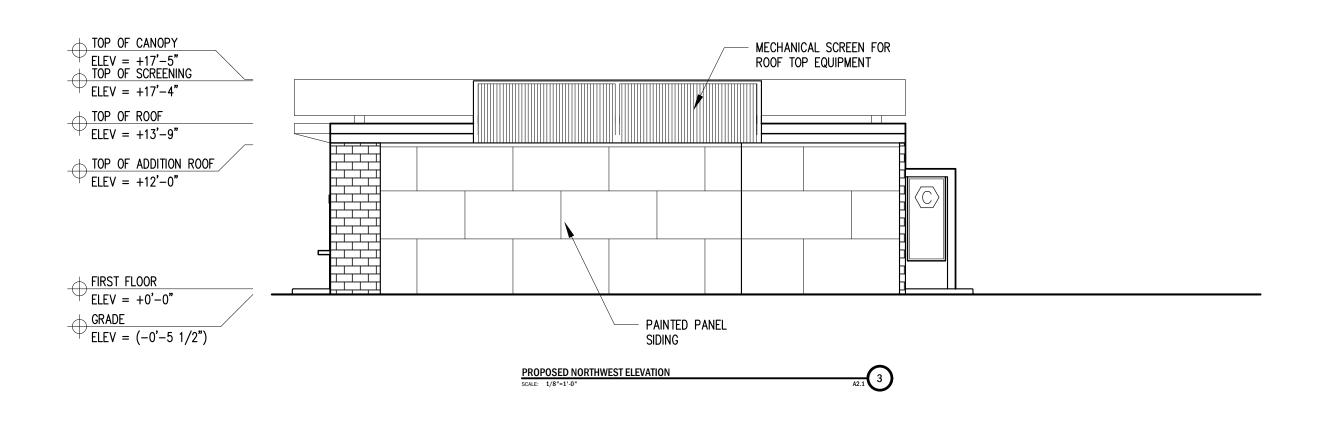

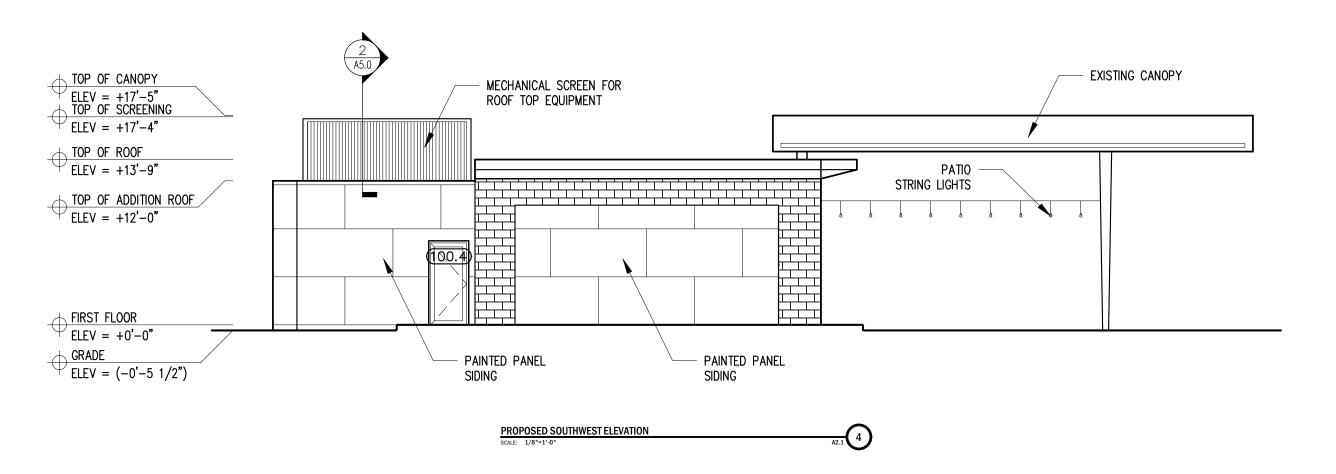

OJECT NAME:

THE GETTY 361 ISLINGTON ST. PORTSMOUTH, NH 03801

 PROJECT NO.:
 22063

 DRAWN BY:
 BH, RW


 APPROVED BY:
 BH

 ISSUE DATE:
 2022/09/16

PROPOSED ELEVATIONS

SCALE: DRAWING NO.

A2.1

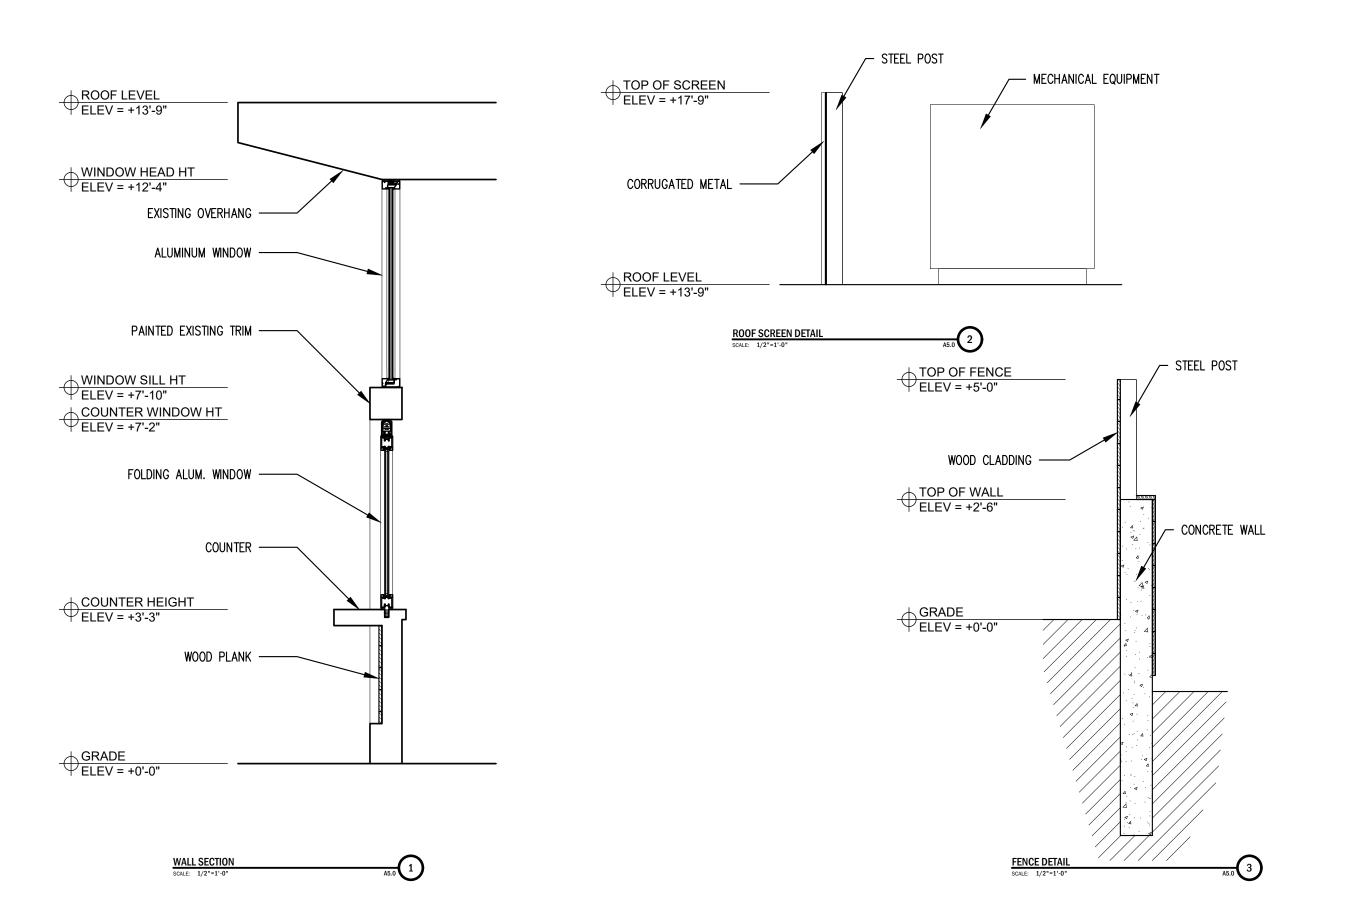

THE GETTY
361 ISLINGTON STREET
PORTSMOUTH, NEW HAMPSHIRE 03801

PROJECT:

WINTER HOLBEN

architecture + design

7 WALLINGFORD SQ UNIT 209-9 KITTERY, MAINE 03904 207.994.3104

THE GETTY 361 ISLINGTON ST. PORTSMOUTH, NH 03801

 PROJECT NO.:
 22063

 DRAWN BY:
 BH, RW

 APPROVED BY:
 BH

 ISSUE DATE:
 2022/09/16


RAWING NAME: SECTIONS AND


DETAILS


SCALE: DRAWING NO.:

A5.0

WINTER HOLBEN DESIGN, LLC

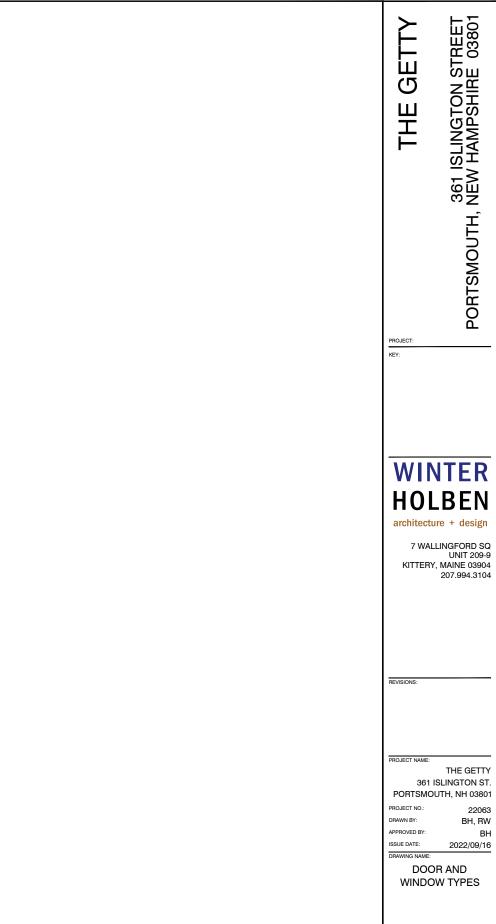

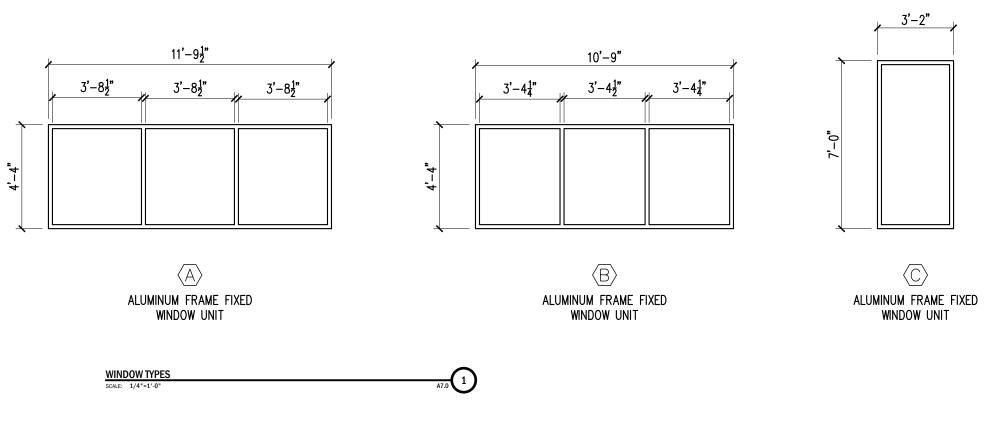

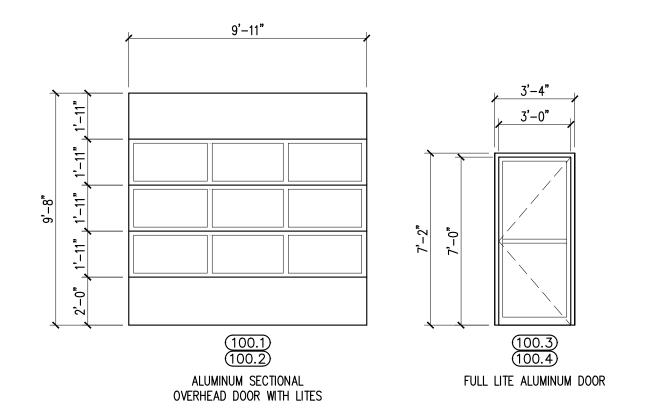

DOOR TYPES
SCALE: 1/4"=1'-0"

22063

BH, RW

A7.0

THE GETTY 361 ISLINGTON ST. PORTSMOUTH, NH 03801

 PROJECT NO.:
 22063

 DRAWN BY:
 BH, RW

 APPROVED BY:
 BH

 ISSUE DATE:
 2022/09/16

PERSPECTIVE
IMAGES

SCALE:

A8.0



PROPOSED SOUTH EAST PERSPECTIVE



PROPOSED EAST PERSPECTIVE




PROPOSED AERIAL PERSPECTIVE



PROPOSED NORTH EAST PERSPECTIVE

## BEFORE (EXISTING):



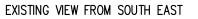

PROPOSED VIEW FROM SOUTH EAST



EXISTING VIEW FROM SOUTH WEST



EXISTING VIEW FROM EAST

## AFTER (PROPOSED):





PROPOSED VIEW FROM SOUTH WEST



PROPOSED VIEW FROM EAST

THE GETTY

361 ISLINGTON STREET PORTSMOUTH, NEW HAMPSHIRE 03801

PROJECT:

WINTER HOLBEN architecture + design

7 WALLINGFORD SQ UNIT 209-9 KITTERY, MAINE 03904 207.994.3104

BEVISIONS

JECT NAME:

THE GETTY
361 ISLINGTON ST.
PORTSMOUTH, NH 03801

 PROJECT NO.:
 22063

 DRAWN BY:
 BH, RW

 APPROVED BY:
 BH

 ISSUE DATE:
 2022/09/16

BEFORE AND AFTER IMAGES

SCALE:

A8.1

022 WINTER HOLBEN DESIGN, LLC

2022/09/16

MATERIAL INSPIRATION CUT SHEETS

A9.0



**DINING CANOPY - OPEN TRELLIS** 



**DINING CANOPY - OPEN TRELLIS** 



INDOOR / OUTDOOR DINING EXPERIENCE





INDOOR / OUTDOOR DINING EXPERIENCE





**CORRUGATED METAL** 




PATIO LIGHTING

**GLAZED OVERHEAD DOOR** 

FOLDING COUNTER WINDOW



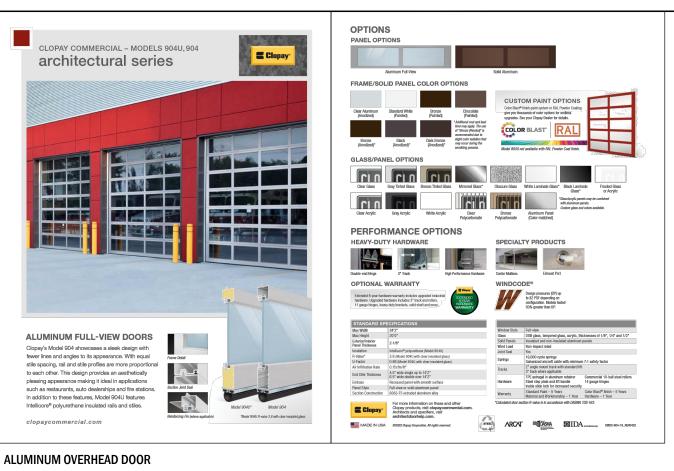



## ALUMINUM SLIDING WINDOW (PICK UP WINDOW)

## **G2 FOLDING GLASS WALLS**

ALUMINUM WINDOW



#### G2 Thermal System

G2.Aluminum Folding Glass Wall Systems are a great way to open your environment to the outdoors. The frame uses a thermal strut system that separates the interior metal from the exterior metal. By including a thermal break, the temperature transfer between the outdoors and indoors is minimized.

The frames are available in two vertical stile widths: narrow and standard. The widths can be combined over multiple units for a unique style or kept consistent throughout. This flexibility allows multiple sightline and bottom rail configurations that can be retrofitted to match an existing opening or accommodate specific

#### Panels

- Minimum panel size: 18" wide; smaller panels may be available upon request
   Panel size up to 3' x 10"; larger panel options may be available depending on application

# G2 Nonthermal System

G2 Nonthermal Aluminum Folding Glass Wall Systems are ideal for mild climates and indoor uses. This system is popular for conference rooms, interior commercial entryways, and classrooms, as well as residential and commercial room dividers. Frames are available in two vertical stills widths: narrow and standard. These can be combined over multiple units for a unique style or kept consistent throughout.

ALUMINUM FOLDING WINDOW

#### Glazing

- Performance Designed to accommodate almost any monolithic, insulated, laminated, decorative, polycarbonate, or solid painfill from 3/16\* to 114"
  - Water performance up to 12psf, depending on sill choice and configuration
     Structurally tested up to a design pressure of 80psf
     Higher design pressure ratings available with engineering approval
     Test results available upon request
  - ntions.com | 800 618 0669 | 31 Roberts Road, Pine Grove, PA 17963 | Rev 8,17.22

JAMB DETAILS **₹ ₹ ₹ ₹ ₹ 2**× Narrow G2 Jamb & Standard G2 Frame Standard G2 Jamb & Frame कुट चिक् चिक् Narrow G2 Jamb & Frame

# ColorPlus® Technology Plank, Panel, Shingle and Batten Color Offering with our Statement Collection" products. Carefully curated by our design experts specifically for your market, the collection brings together the most popular James Hardie ColorPlus® siding and trim styles, textures, and colors. This stunning Trim Color Offering GOBBLE KHAKI MONTEREY BROWN TAUPE TIMBER BARK



FIBER CEMENT SIDING

# **WINTER HOLBEN**

361 ISLINGTON STREET NEW HAMPSHIRE 03801

PORTSMOUTH,

ETTY

Q

里

PROJECT:

architecture + design

7 WALLINGFORD SQ UNIT 209-9 KITTERY, MAINE 03904 207.994.3104

PROJECT NAME:

THE GETTY 361 ISLINGTON ST. PORTSMOUTH, NH 03801

PROJECT NO.: 22063 DRAWN BY: BH, RW APPROVED BY: BH ISSUE DATE: 2022/09/16

PRODUCT DATA

SCALE:

DRAWING NAME

A9.1