


### STORMWATER MANANGEMENT NOTES


- 1. DO NOT BEGIN CONSTRUCTION UNTIL ALL STATE AND LOCAL PERMITS HAVE BEEN APPLIED FOR AND RECEIVED.
- 2. CONTRACTOR SHALL OBTAIN A "DIGSAFE" NUMBER AT LEAST 72 HOURS PRIOR TO COMMENCING CONSTRUCTION.
- 3. ALL CONSTRUCTION SHALL MEET THE MINIMUM CONSTRUCTION STANDARDS OF THE CITY OF PORTSMOUTH AND NHDOT STANDARD SPECIFICATIONS FOR ROAD AND BRIDGE CONSTRUCTION, LATEST EDITION. THE MORE STRINGENT SPECIFICATION SHALL GOVERN.
- 4. ALL BENCHMARKS AND TOPOGRAPHY SHALL BE FIELD VERIFIED BY THE CONTRACTOR PRIOR TO INITIATING CONSTRUCTION.
- 5. UNLESS OTHERWISE AGREED IN WRITING, THE CONTRACTOR SHALL BE RESPONSIBLE FOR ESTABLISHING AND MAINTAINING TEMPORARY BENCHMARKS (TBM) AND PERFORMING ALL CONSTRUCTION SURVEY LAYOUT.
- 6. PRIOR TO CONSTRUCTION, FIELD VERIFY JUNCTIONS, LOCATIONS AND ELEVATIONS/INVERTS OF ALL EXISTING STORMWATER AND UTILITY LINES. PRESERVE AND PROTECT LINES TO BE RETAINED.
- 7. TEMPORARY INLET PROTECTION MEASURES SHALL BE INSTALLED IN ALL EXISTING AND PROPOSED CATCH BASINS WITHIN 100' OF THE PROJECT SITE WHEN SITE WORK WITHIN CONTRIBUTING AREAS IS ACTIVE OR SAID AREAS HAVE NOT BEEN STABILIZED.
- 8. PROTECTION OF SUBGRADE: THE CONTRACTOR SHALL BE REQUIRED TO MAINTAIN STABLE, DEWATERED SUBGRADES FOR FOUNDATIONS, PAVEMENT AREAS, UTILITY TRENCHES, AND OTHER AREAS DURING CONSTRUCTION. SUBGRADE DISTURBANCE MAY BE INFLUENCED BY EXCAVATION METHODS, MOISTURE, PRECIPITATION, GROUNDWATER CONTROL, AND CONSTRUCTION ACTIVITIES. THE CONTRACTOR SHALL TAKE PRECAUTIONS TO PREVENT SUBGRADE DISTURBANCE. SUCH PRECAUTIONS MAY INCLUDE DIVERTING STORMWATER RUNOFF AWAY FROM CONSTRUCTION AREAS, REDUCING TRAFFIC IN SENSITIVE AREAS, AND MAINTAINING AN EFFECTIVE DEWATERING PROGRAM. SOILS EXHIBITING HEAVING OR INSTABILITY SHALL BE OVER EXCAVATED TO MORE COMPETENT BEARING SOIL AND REPLACED WITH FREE DRAINING STRUCTURAL FILL. IF THE EARTHWORK IS PERFORMED DURING FREEZING WEATHER, EXPOSED SUBGRADES ARE SUSCEPTIBLE TO FROST. NO FILL OR UTILITIES SHALL BE PLACED ON FROZEN GROUND. THIS WILL LIKELY REQUIRE REMOVAL OF A FROZEN SOIL CRUST AT THE COMMENCEMENT OF EACH DAY'S OPERATIONS. THE FINAL SUBGRADE ELEVATION WOULD ALSO REQUIRE AN APPROPRIATE DEGREE OF INSULATION AGAINST FREEZING.
- 9. IF SUITABLE, EXCAVATED MATERIALS SHALL BE PLACED AS FILL WITHIN UPLAND AREAS ONLY AND SHALL NOT BE PLACED WITHIN WETLANDS. PLACEMENT OF BORROW MATERIALS SHALL BE PERFORMED IN A MANNER THAT PREVENTS LONG TERM DIFFERENTIAL SETTLEMENT. EXCESSIVELY WET MATERIALS SHALL BE STOCKPILED AND ALLOWED TO DRAIN BEFORE PLACEMENT. FROZEN MATERIAL SHALL NOT BE USED FOR CONSTRUCTION.
- 10. ALL CATCH BASIN, MANHOLE AND OTHER DRAINAGE RIMS SHALL BE SET FLUSH WITH OR NO LESS THAN 0.1' BELOW FINISH GRADE. ANY RIM ABOVE SURROUNDING FINISH GRADE SHALL NOT BE ACCEPTED.
- 11. IN ORDER TO PROVIDE VISUAL CLARITY ON THE PLANS, DRAINAGE AND OTHER UTILITY STRUCTURES MAY NOT BE DRAWN TO SCALE. THE CONTRACTOR SHALL BE RESPONSIBLE FOR THE PROPER SIZING AND LOCATION OF ALL STRUCTURES AND IS DIRECTED TO RESOLVE ANY POTENTIAL DISCREPANCY WITH THE ENGINEER PRIOR TO CONSTRUCTION.
- 12. ALL CPP PIPE SHALL BE ADS N-12 OR APPROVED EQUAL.
- 13. TOTAL AREA OF PROJECT DISTURBANCE IS ±30,000 S.F. (<1 ACRE THEREFORE NOT SUBJECT TO EPA NPDES PHASE II. CONTRACTOR SHALL BE RESPONSIBLE FOR REQUIRED INSPECTIONS.
- 14. NO EARTHWORK, STUMPING OR GRUBBING SHALL COMMENCE UNTIL ALL APPROPRIATE SEDIMENT AND EROSION CONTROL MEASURES HAVE BEEN INSTALLED. ALL SEDIMENT AND EROSION CONTROL MEASURES SHALL BE PROPERLY MAINTAINED IN GOOD WORKING ORDER FOR THE DURATION OF CONSTRUCTION AND THE SITE IS STABILIZED.
- 16. ALL EROSION AND SEDIMENT CONTROL MEASURES SHALL BE INSTALLED IN ACCORDANCE WITH THE DESIGN STANDARDS AND SPECIFICATIONS SET FORTH IN THE NHDES NH STORMWATER MANUALS, VOL. 1—3, DATED DECEMBER 2008 AS AMENDED.
- 17. CONTRACTOR SHALL CONTROL DUST BY SPRAYING WATER, SWEEPING PAVED SURFACES, PROVIDING TEMPORARY VEGETATION, AND/OR MULCHING EXPOSED AREAS AND STOCKPILES.
- 18. THE CONTRACTOR SHALL TAKE WHATEVER MEANS NECESSARY TO PREVENT EROSION, PREVENT SEDIMENT FROM LEAVING THE SITE AND/OR ENTERING WETLANDS AND ENSURE PERMANENT SOIL STABILIZATION.
- 19. ALL EROSION CONTROL BLANKETS AND FASTENERS SHALL BE BIODEGRADEABLE.
- 20. ALL SWALES SHALL BE STABILIZED PRIOR TO DIRECTING RUNOFF TO THEM.
- 21. ALL DISTURBED AREAS NOT TO BE PAVED OR OTHERWISE TREATED SHALL RECEIVE SIX (6") INCHES OF COMPACTED LOAM, LIMESTONE, ORGANIC FERTILIZER, SEED, AND MULCH USING APPROPRIATE SOIL STABILIZATION TECHNIQUES OR AS INDICATED ON THE LANDSCAPE ARCHITURAL PLANS.
- 22. UPON COMPLETION OF CONSTRUCTION, ALL DRAINAGE INFRASTRUCTURE SHALL BE CLEANED OF ALL DEBRIS AND SEDIMENT AND ALL TEMPORARY EROSION AND SEDIMENT CONTROLS REMOVED AND ANY AREAS DISTURBED BY THE REMOVAL SMOOTHED AND REVEGETATED.
- 23. THE ENGINEER OF RECORD SHALL SUBMIT A WRITTEN REPORT WITH PHOTOGRAPHS AND ENGINEERS STAMP CERTIFYING THAT THE STORMWATER INFRASTRUCTURE WAS CONSTRUCTED TO THE APPROVED PLANS AND WILL MEET THE DESIGN PERFORMANCE.
- 24. THE RESIDENCE SHALL BE CONSTRUCTED WITH STONE DRIP EDGES, WHERE APPROPRIATE. DRIP EDGE UNDERDRAINS SHALL BE DIRECTED TO A STORMWATER PIPE OR DAYLIGHT IN AN AREA OUTSIDE THE CITY 100 FOOT WETLANDS BUFFER.

GRAPHIC SCALE

( IN FEET )

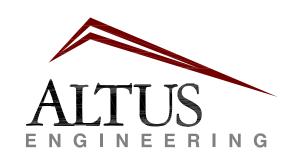

133 Court Street Portsmouth, NH 03801 www.altus-eng.com

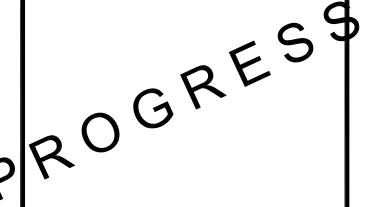

NOT FOR CONSTRUCTION

SSUED FOR:

REVIEW

ISSUE DATE:

MAY 17, 2023

REVISIONS
NO. DESCRIPTION

NO. DESCRIPTIONBY DATE0 INITIAL SUBMISSIONEDW 05/17/23

DRAWN BY: RLH

APPROVED BY: EDW

DRAWING FILE: 5138SITE.dwg

SCALE:

(22"x34") 1" = 20' (11"x17") 1" = 40'

OWNER:

120-0 WILD ROSE LANE, LLC
209 WATER STREET
NEWBURYPORT, MA 01950

APPLICANT:

120-0 WILD ROSE LANE, LLC 209 WATER STREET

NEWBURYPORT, MA 01950

PROJECT:

JOHN & MICHELLE

MORRIS

RESIDENCE

TAX MAP 207, LOT 13


60 PLEASANT POINT DRIVE PORTSMOUTH, NH

TITLE:

PRELIMINARY GRADING PLAN

SHEET NUMBER:

C - 3

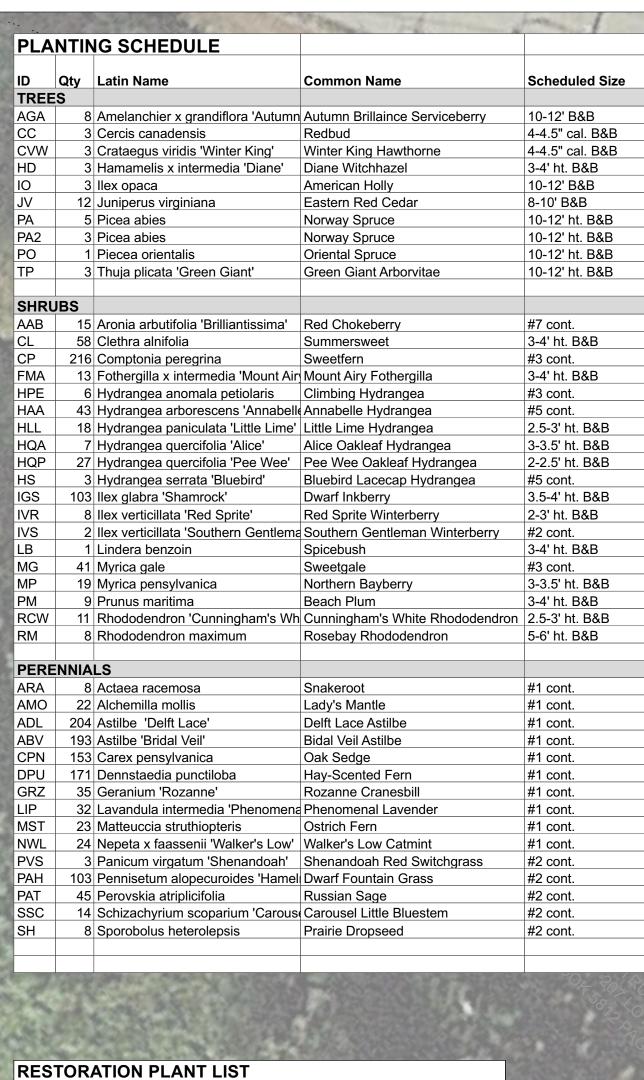

SHRUBS	
Scientific Name	Common Name
Coloniano Hanno	- Common Humo
Rosa virginiana	Virginia Rose
Prunus maritima	Beach Plum
llex glabra	Inkberry
Myrica pensylvanica	Bayberry
Viburnum dentatum	Arrowwood Viburnum
Comptonia peregrina	Sweetfern
Arctosaphylos uva-ursi	Bearberry
Grasses (Seed)	
Scientific Name	Common Name
Panicum amarum	Atlantic Coastal Panic Grass
Panicum virgatum	Switch Grass
Eragrostis spectabilis	Purple Love Grass
Juncus gerardii	Salt Meadow Rush
Sporobolus heterolepis	Prarie Dropseed
Ammophila breviligulata	American Beachgrass
Bouteloua gracilis	Blue Gramma
Schizachyrium scoparium	Little bluestem
Festuca rubra	Red Fescue
Plugs and Containers	<u> </u>
Scientific Name	Common Name
Amorpha canescens	Lead Plant
Amsonia Spp.	Blue Star
Aquilegia candensis	Eastern Columbine
Asclepias tuberosa	Butterfly Milkweed
Baptisia australis	Blue False Inidgo
Eurybia spectabilis	Eastern Showy Aster
Heuchera americana	American Alumroot
Liatris aspera	Button Blazing Star
Penstemon digitalis	Bear-Tongue
Solidago sempervirens	Seaside Goldenrod
Waldsteinia fragarioides	Barren Strawberry
- <u> </u>	

NOTE:
RESTORATION PLANT PALETTE IS NOT
FINALIZED BUT WILL ONLY INCLUDE
PLANTS FROM THIS LIST.



### Morris Residence

60 Pleasant Point Drive Portsmouth, NH

General Notes:

1. Existing conditions and topographic data are from a site plan of land dated 8 February 2021; prepared by Altus Engineering, INC., 133 Court Street, Portsmouth, NH 03801 - Tel: (603) 433.2335

2. Existing conditions supplemented from data collected by: Matthew Cunningham Landscape Design LLC, 411 Main Street, Stoneham, MA 02108 / 366 Fore Street, Portland, ME 04101 - Tel: (617) 905.2246

Planting Notes:

1. The contractor shall supply all plant material in quantities sufficient to complete the planting shown on all drawings.

2. All plant material shall conform to the guidelines established by "The American Standard for Nursery Stock" published by *The American Association of Nurserymen*, latest edition.

3. All plant material shall be warrantied for 1 year after substantial completion.

4. All plants shall be balled and burlap unless otherwise noted on the plant list/ schedule.

5. All plants shall be approved by Landscape Designer prior to their installation at the site.

6. Contractor shall stake all plant locations in the field. Obtain approval of Landscape Designer before starting plant installations.

7. Plants to be transplanted shall be flagged and exact planting locations staked in the field.

8. All areas disturbed by construction shall be restored to a pre-construction state unless otherwise noted by landscape architect or plans.

M A T T H E W
CUNNINGHAM
L A N D S C A P E
D E S I G N L L C

411 Main Street, Stoneham, MA 02180 366 Fore Street, Portland, ME 04101 617.905.2246 p | 617.321.4014 f

matthew-cunningham.com

617.905.2246 p | 617.321.4014 f

REVISIONS:
#: DATE: DESCRIPTION:

SCALE: 1/16"= 1'-0" DATE: 11 May 2023

Planting Plan

SHEET NUMBER:

L3.0



60 Pleasant Point Drive Portsmouth, NH

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#### Grading Notes:

The contractor shall verify all existing grades in the field and report any discrepancies immediately to the Landscape Designer.

Grade surfaces to assure positive drainage from all structures and to prevent ponding of surface drainage.

Provide vertical curves or roundings at abrupt changes in grade unless otherwise noted. Blend new earthwork smoothly into existing.

4. Maintain existing grades at existing plant

5. All fill material is subject to approval by Landscape Designer.

6. Ptch evenly between spot grades. All paved areas must pitch to drain at a minimum of 1/8" per foot. Any discrepancies not allowing this to occur shall be reported to the Landscape Designer prior to continuing work.

7. Once grading operations are completed, all disturbed areas within or outside of the limits of work shall be stabilized by fine grading and seeding or mulching as directed by Landscape Designer.

8. All erosion control measures are to be constructed to meet field conditions at the time of construction and prior to any grading or disturbance of existing material on balance of site.

Slopes 3:1 and greater shall be stabilized with biodegradable erosion control netting.

Drain locations are diagrammatic. Adjust final layout of drains in field with Landscape Designer.

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DESIGN LLC

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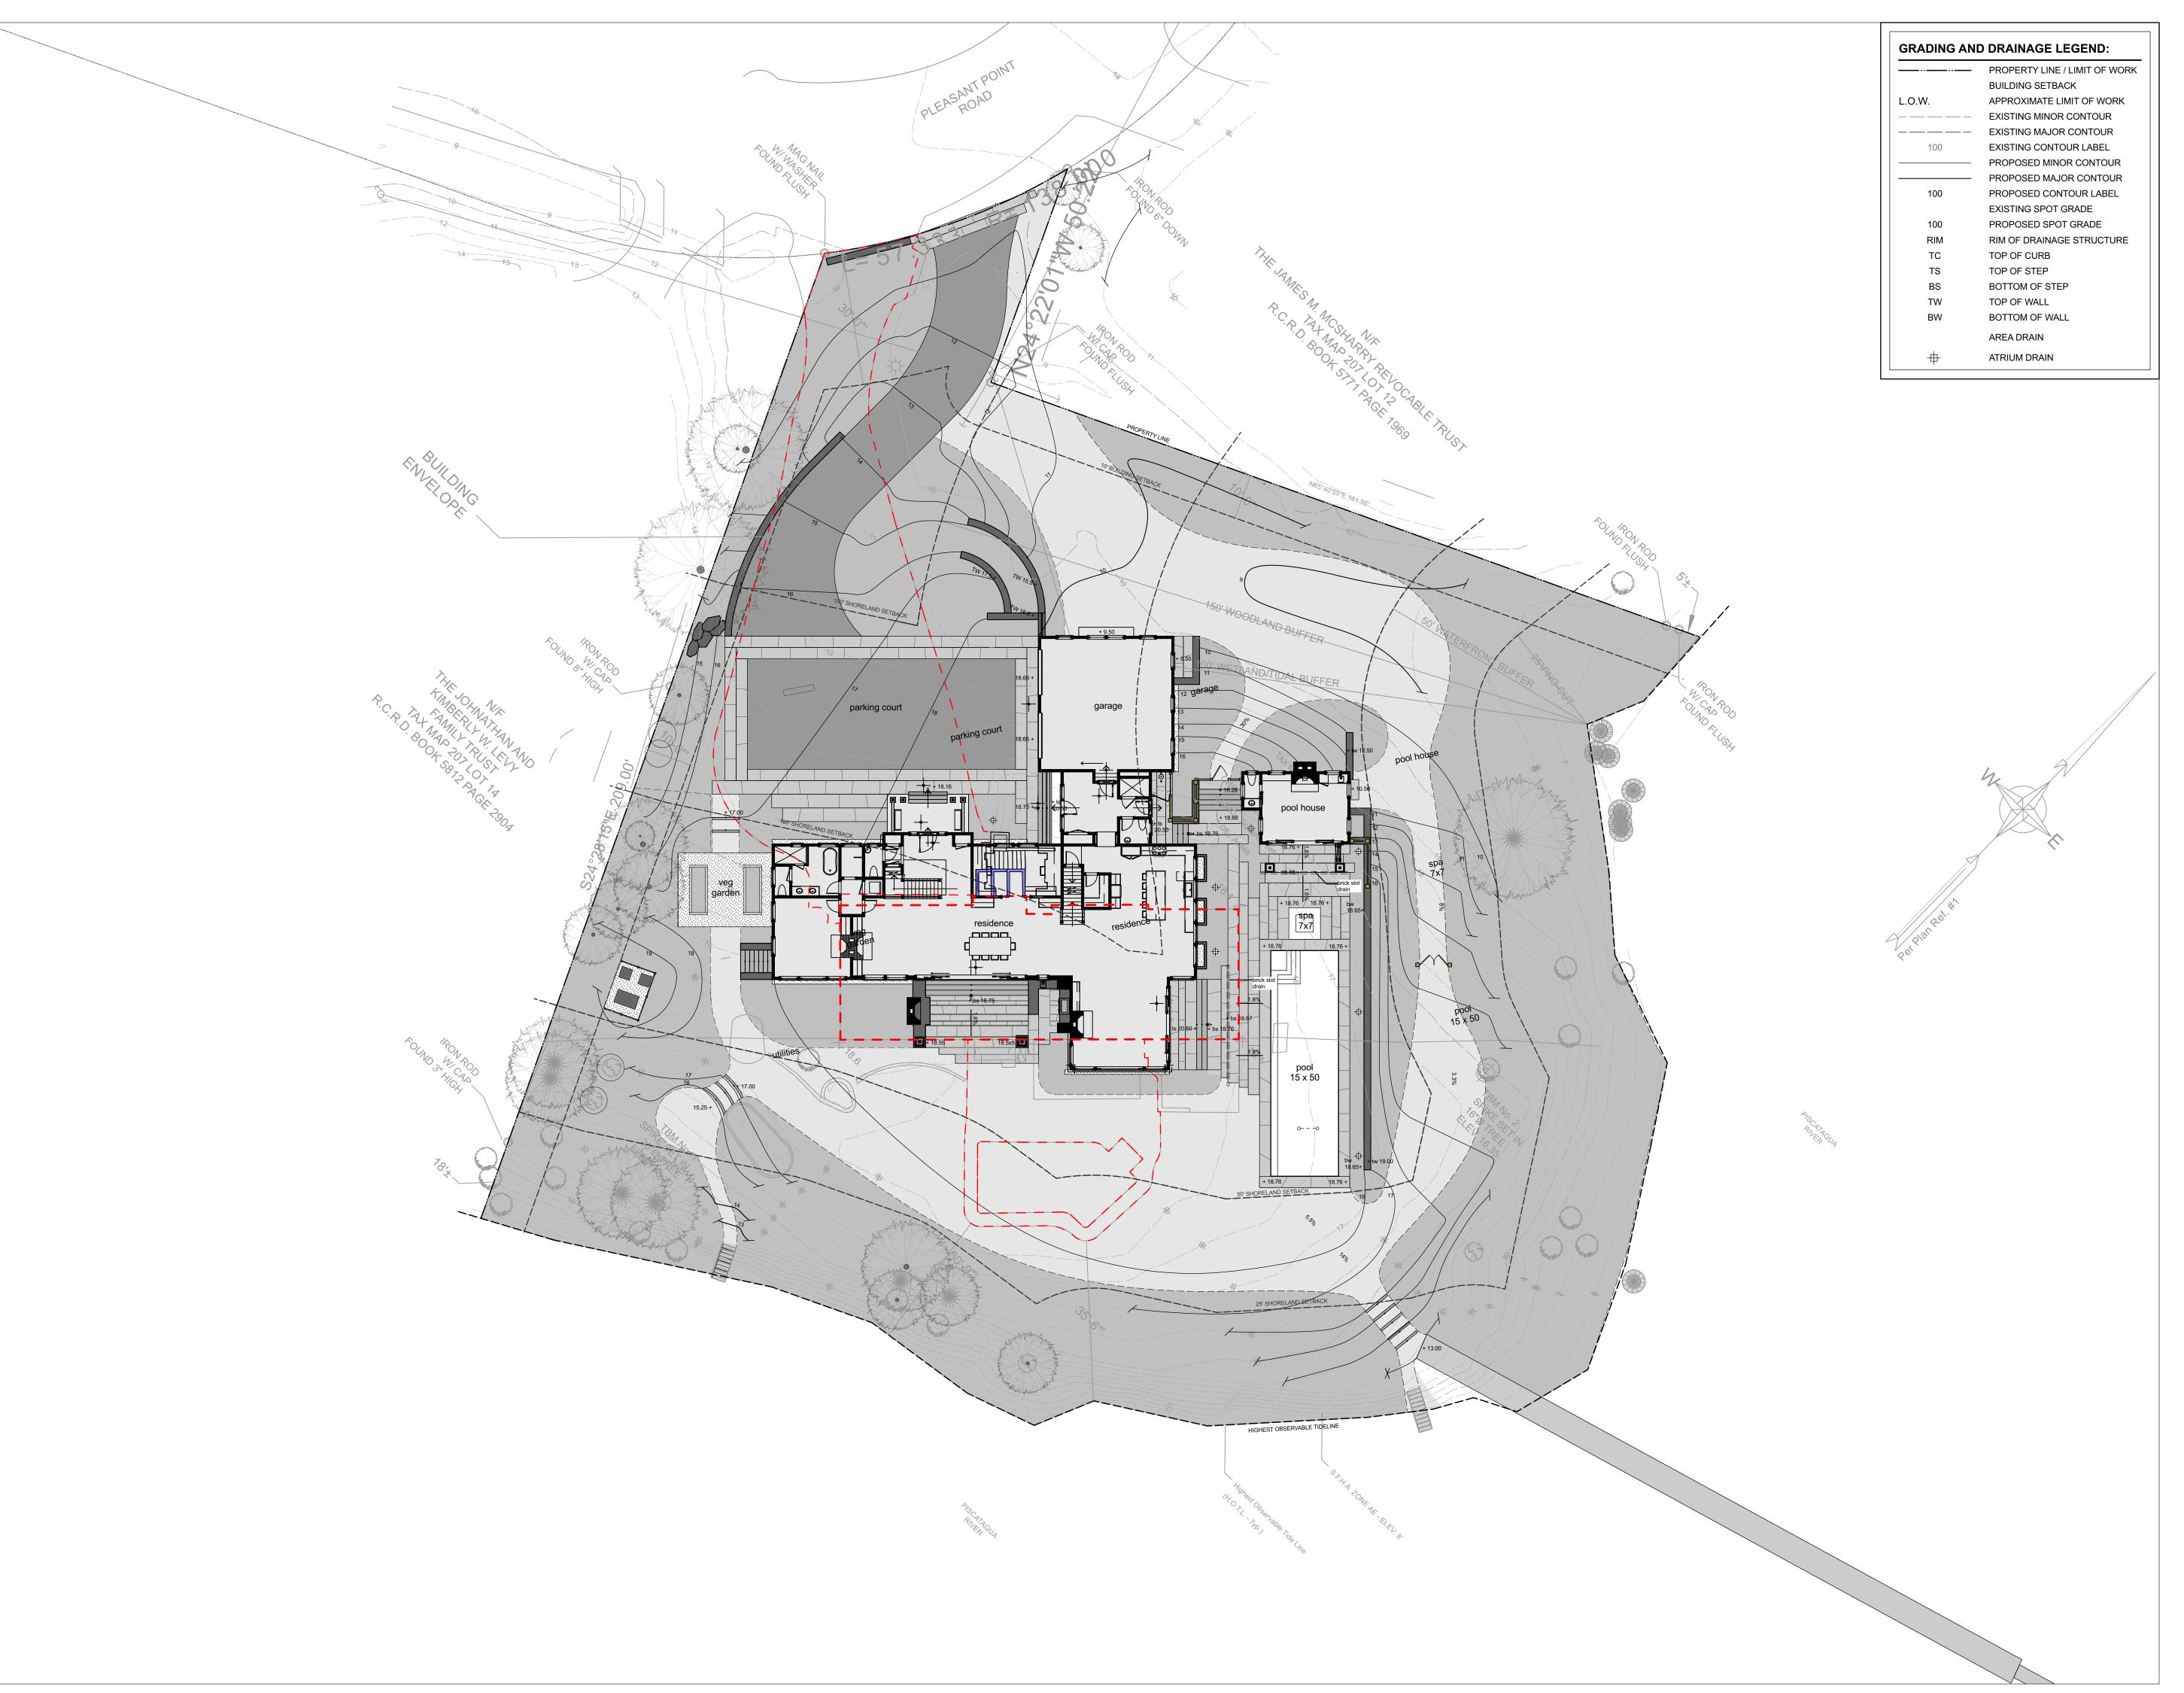
LANDSCAPE

411 Main Street, Stoneham, MA 02180 366 Fore Street, Portland, ME 04101

	017.8	905.2246 p   617.321.401
RE	VISIONS:	
#:	DATE:	DESCRIPTION:
	A.F. 4/40"	11 01 DATE 0 1 0000
SC	ALE: 1/16":	= 1'-0" DATE: 6 June 2023

Existing Conditions Overlay Plan

SHEET NUMBER:



60 Pleasant Point Drive Portsmouth, NH

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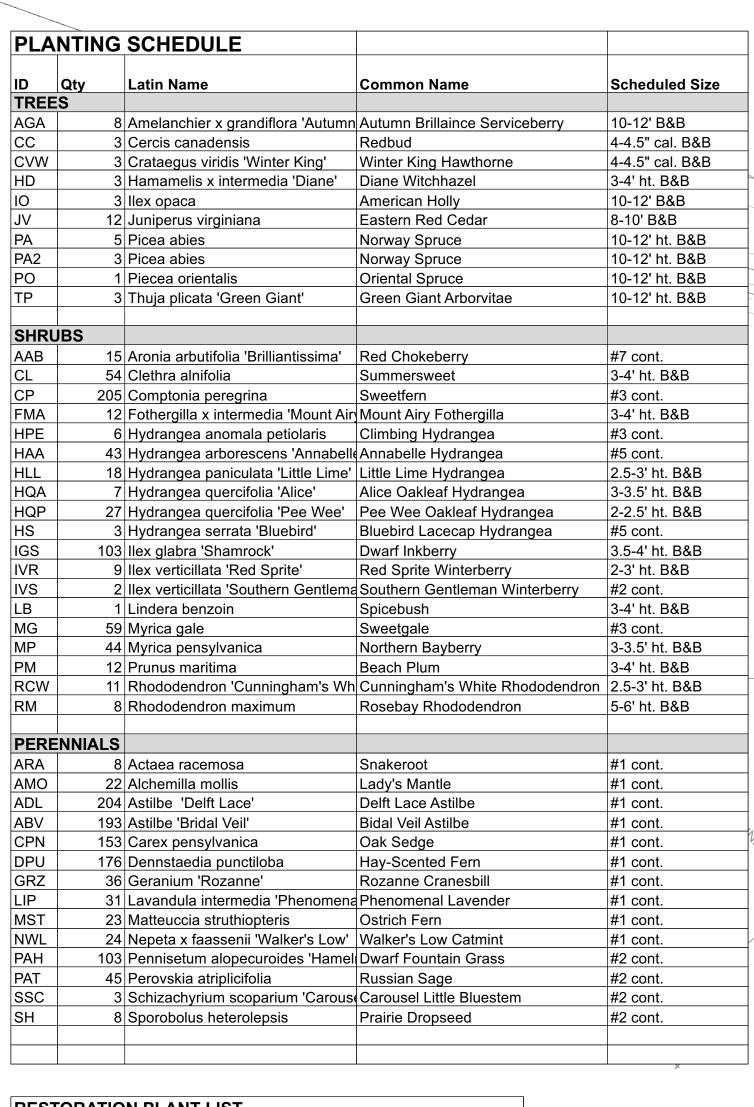
REVISIONS:
#: DATE: DESCRIPTION:

SCALE: 1/16"= 1'-0" DATE: 6 June 2023

Grading Plan

SHEET NUMBER

L0.2



<u>RESTORATION PLANT LIS</u>	SŢ
SHRUBS	
Scientific Name	Common Name
Rosa virginiana	Virginia Rose
Prunus maritima	Beach Plum
llex glabra	Inkberry
Myrica pensylvanica	Bayberry
Viburnum dentatum	Arrowwood Viburnum
	Sweetfern
Comptonia peregrina	Bearberry
Arctosaphylos uva-ursi	Беагрепу
GRASSES (SEED)	
Scientific Name	Common Name
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Panicum virgatum	Switch Grass
Eragrostis spectabilis	Purple Love Grass
	•
Juncus gerardii	Salt Meadow Rush
Sporobolus heterolepis	Prarie Dropseed
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Schizachyrium scoparium	Little Bluestem
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PLUGS AND CONTAINERS	<u> </u>
Scientific Name	Common Name
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Asclepias tuberosa	Butterfly Milkweed
Baptisia australis	Blue False Indigo
Eurybia spectabilis	Eastern Showy Aster
Heuchera americana	American Alumroot
_iatris aspera	Button Blazing Star
Penstemon digitalis	Bear-Tongue
Solidago sempervirens	Seaside Goldenrod
Waldsteinia fragarioides	Barren Strawberry

### NOTE

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# Morris Residence

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411 Main Street, Stoneham, MA 02180 366 Fore Street, Portland, ME 04101

DESIGN LLC

matthew-cunningham.com

617.905.2246 p | 617.321.4014 f

REVISIONS:
#: DATE: DESCRIPTION:

SCALE: 1/16"= 1'-0" DATE: 6 June 2023

0' 8' 16'
HEET TITLE:

Planting Plan

SHEET NUMBER

L0.3



60 Pleasant Point Drive Portsmouth, NH

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3. True and current conditions may differ from those indicated on the plan. Contractor shall verify true conditions in the field prior to construction and notify landscape designer of significant discrepancies.

4. Contractor shall verify location of any existing utilities and services and provide protection during construction. Contractor shall directly coordinate with DIG Safe. Utilities damaged during construction shall be repaired at contractor's expense.

5. Contractor shall contact and inform client and landscape designer to any unforeseen conditions which may affect the intended design as set forth in the drawings.

 Contractor shall secure any necessary permits required for the work from any state or local agencies, departments, utility companies or other authorities having jurisdiction and affected by the work

7. All work shall be in in accordance with the New Hampshire State Building Code.

8. Contractor shall leave site clean and orderly during all phases of the construction process. Remove from the site all excess materials, soils, debris, and equipment. Store materials only in an approved location.

9. Do not scale drawings.

10. All angles are assumed to be 90 degrees unless otherwise stated.

MATTHEW
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LANDSCAPE

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DESIGN LLC

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REVISION S:
#: DATE: DESCRIPTION:

SCALE: 1/16"= 1'-0" DATE: 6 June 2023

0' 8' 16'

Existing Conditions Plan

SHEET NUMBER:

L0.0



60 Pleasant Point Drive Portsmouth, NH

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M A T T H E W

CUNNINGHAM

L A N D S C A P E

411 Main Street, Stoneham, MA 02180 366 Fore Street, Portland, ME 04101 617.905.2246 p | 617.321.4014 f

DESIGN LLC

matthew-cunningham.com

REVISION S:
#: DATE: DESCRIPTION:

SCALE: 1/16"= 1'-0" DATE: 6 June 2023

Illustrative
Master Plan -1

SHEET N UM BER

L0.1



60 Pleasant Point Drive Portsmouth, NH

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MATTHEW
CUNNINGHAM
LANDSCAPE
DESIGN LLC

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matthew-cunningham.com

617.905.2246 p | 617.321.4014 f

REVISIONS:
#: DATE: DESCRIPTION:

SCALE: 1/16"= 1'-0" DATE: 6 June 2023

0' 8' 16'

Illustrative Master Plan - 2

SHEET NUMBER

L0.1