Historic District Commission Staff Report

Wednesday, December 03, 2025

Project Address: 86 South School Street

Permit Requested: Certificate of Approval

Application: Public Hearing #1

A. Property Information - General:

Existing Conditions:

• Zoning District: General Residence B (GRB)

Land Use: <u>Residential</u>Land Area: 3,803 SF +/-

• Estimated Age of Structure: c.1860

• Building Style: <u>Late Greek</u>

• Number of Stories: 2.5

• Historical Significance: Contributing

• Public View of Proposed Work: <u>South School Street</u>

• Unique Features: <u>N/A</u>

• Neighborhood Association: The South End

B. Proposed Work: Construct a side entry to connect to rear sunroom and install new fencing.

C. Staff Comments and/ or Suggestions for Consideration:

The project proposal includes the following:

- Construct a side entry to connect with rear sunroom
- Installation of new fencing








D. Purpose and Intent:

- 1. Preserve the integrity of the District
- 2. Assessment of the Historical Significance
- 3. Conservation and enhancement of property values
- 4. Maintain the special character of the District
- 5. Complement and enhance the architectural and historic character
- 6. Promote the education, pleasure and welfare of the District and the city residents and visitors

E. Review Criteria/Findings of Fact:

- 1. Consistent with special and defining character of surrounding properties
- 2. Compatibility of design with surrounding properties
- 3. Relation to historic and architectural value of existing structures
- 4. Compatibility of innovative technologies with surrounding properties

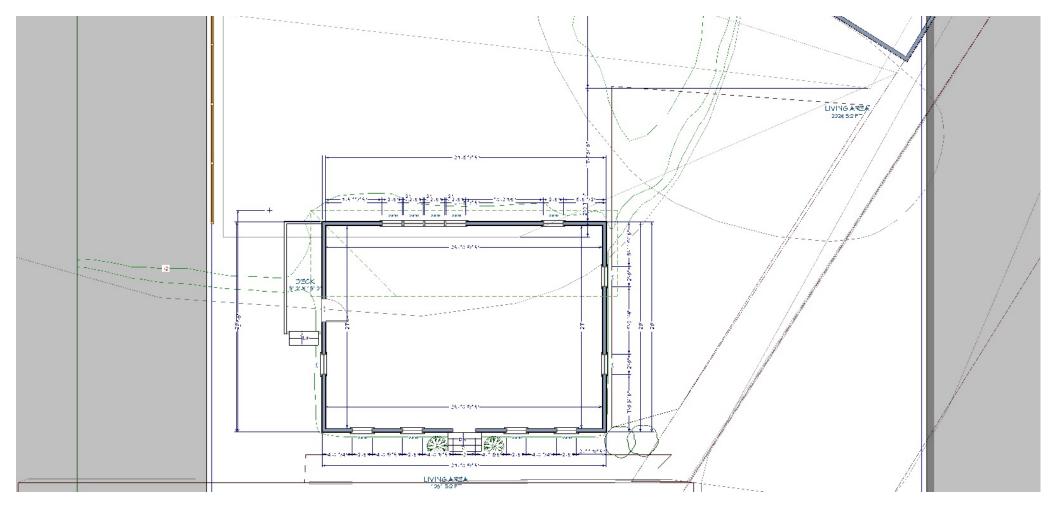


As is plan







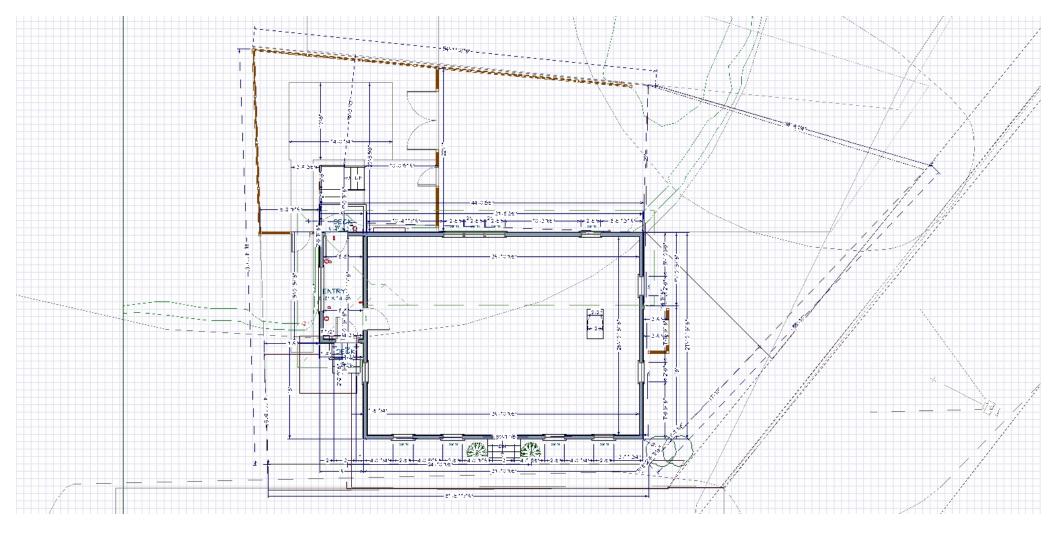

Proposed Renovation Plan



Red shows location of proposed gutters Gutters will be white or cream to match trim







Red shows location of proposed gutters Gutters will be white or off white to match trim




Red shows location of proposed gutters Gutters will be white or cream to match trim

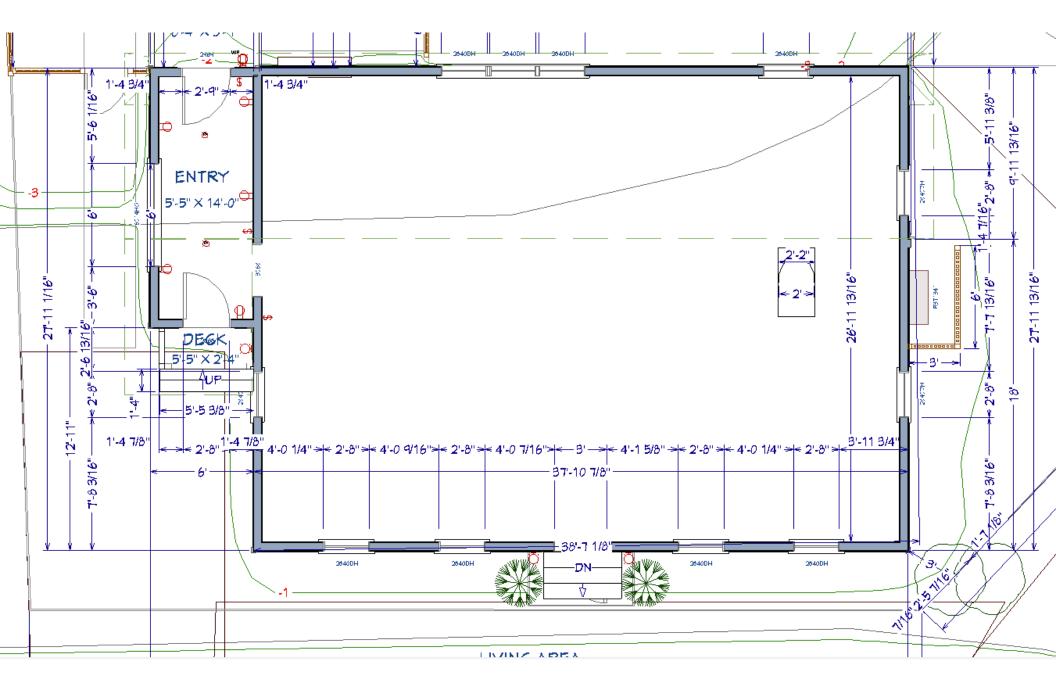

House Dimensions

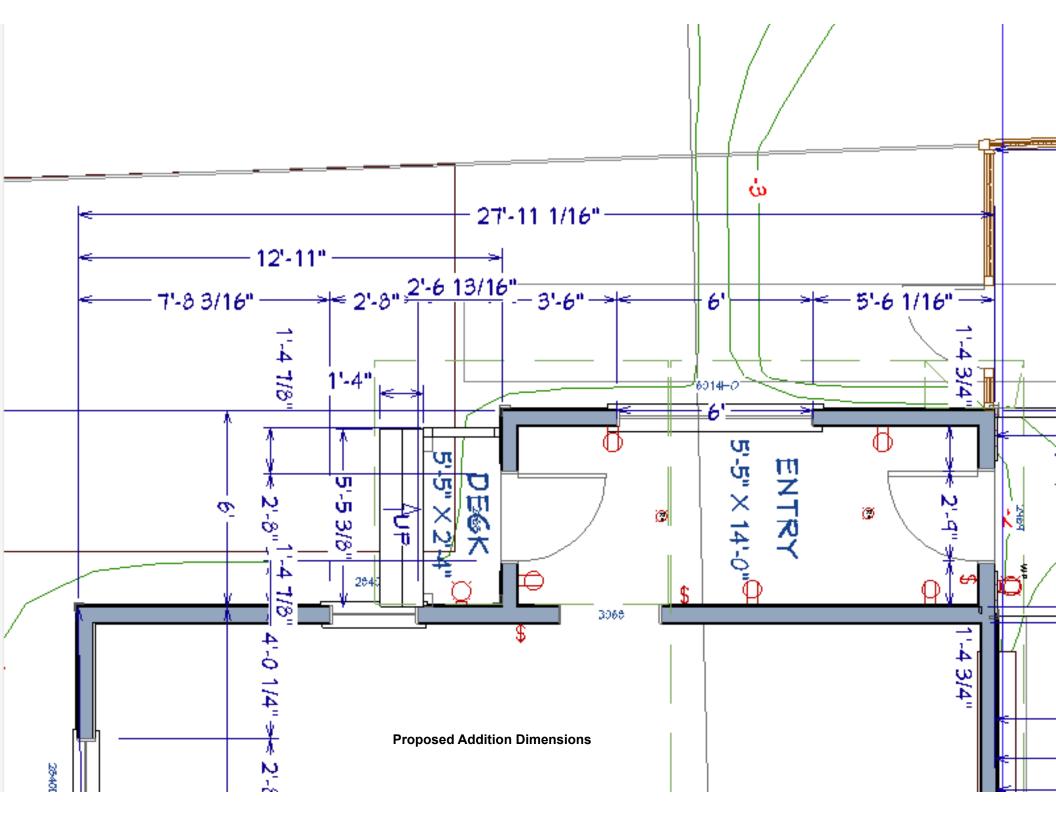

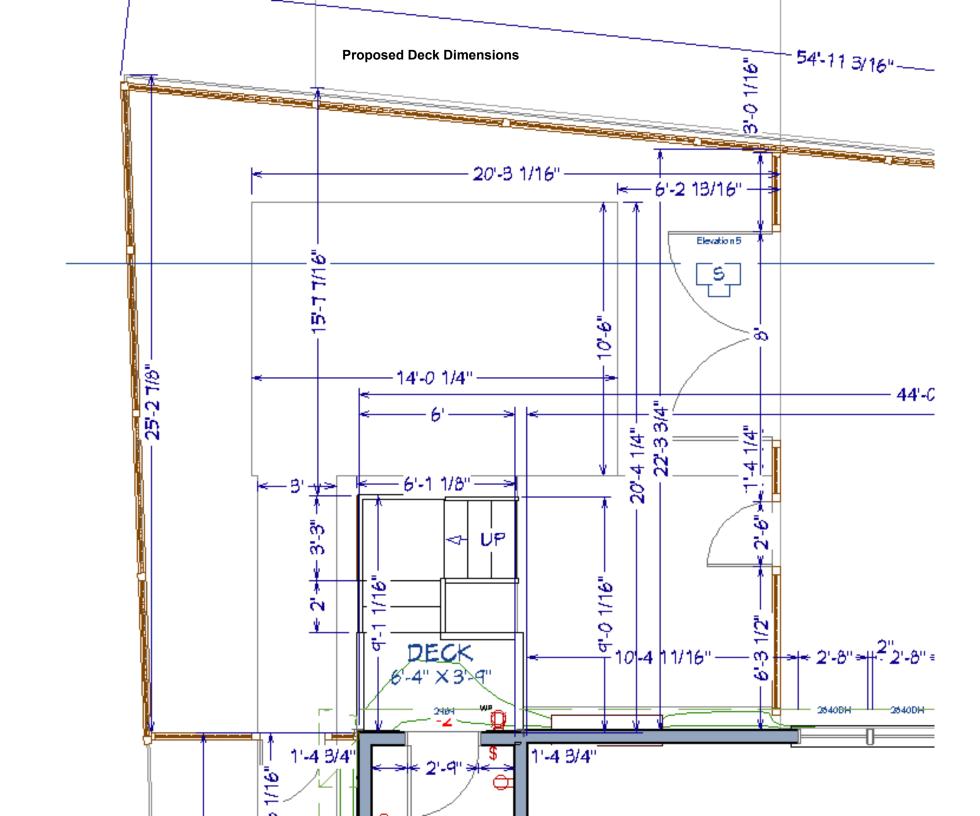



Front porch entry door Inside

Oak exterior door.

Details

Condition

Used - Good

It's 32". by 80" with two vertical lites . One side painted.



Front Porch Entry
Door Outside View
Trim similar to inside
will be added to
provide similar look
to outside of the door



Inside View of Rear Entry Door

Unusual solid wood antique door.

Details
Condition
Used - Good
It's 33" by 81".
The window
part swings out
and there is a
screen in it.



Rear Door Outside view

Screen and square wood screen mount will be replaced with trim to try and match other trim on the door





147mm

Wall Lamp Lighting Outdoor Wall Lantern
Patio Light Fixture Wall Lights Fixtures Style
Waterproof Exterior Wall Sconce Lights
Fixtures Outside Wall Lamp for House Garden
Driveway Patio

Brand: HDXJIZCQ

Brand HDXJIZCQ
Color One Color

Room Type Normal

Product 3"L x 2"W x 1"H

Dimensions

Specific Uses For Home


Product

About this item

- Enhanced Security Feature: The Outdoor Wall Lantern not only adds aesthetic
 appeal but also improves the security of your property by providing well-lit
 areas around your home. It's a practical addition that ensures safety and
 peace of mind.
- style outdoor wall lamp: This outdoor wall lamp is made of high-quality iron metal. The table can ensure durability and reliability. The transparent glass can create a lighting effect. Ideal for terraces, gardens, porches, garages, sidewalks and driveways.
- Weather resistance: waterproof grade IP54, weather-resistant metal structure with transparent glass, multi-layer paint process, this outdoor wall lamp is suitable for wet places, you don't have to worry about being damaged by rain, snow or frost.
- Compatible with various bulbs: use an E27 bulb. Fully compatible with lamps, LED, CFL, bulbs .

Roofing Specifications to match existing roofing

| Item | Description | Amount |
|-------------|---|--------|
| Removal | Removed all layers of roofing down to wood deck on entire house and back shingled | 0.00 |
| | bump-out roofs, protecting the grounds, landscaping, decks, and house bodies with | |
| | heavy duty tarps as stripping is being done. | |
| Watershield | Install 6' GAF Storm Guard ice/water shield underlayment across all eaves, around all | 0.00 |
| | protrusions, in all valleys, and 3' up all rakes at all roof to wall locations | |
| IN1005 | Installed GAF Tigerpaw felt paper over remaining exposed roof. | 0.00 |
| DripEdge | Installed 8" .025 gauge heavy duty aluminum dripedge on entire roof perimeters. | 0.00 |
| Install | Installed GAF Prostart Starter strips across all eaves and up all rakes | 0.00 |
| SH1001 | Installed GAF Timberline HDZ Lifetime Architectural Shingles with Timbertex caps on | 0.00 |
| | roof (color: Pewter Grey) | |
| Ridgevent | Installed new GAF Snow Country ridgevent on all main ridges. | 0.00 |
| CH1001 | Installed new lead flashing on existing chimney. | 0.00 |
| IN1003 | Installed new stack pipe boot on plumbing pipes | 0.00 |
| RM1002 | Removed all job related debris from property at job completion. | 0.00 |
| | | |

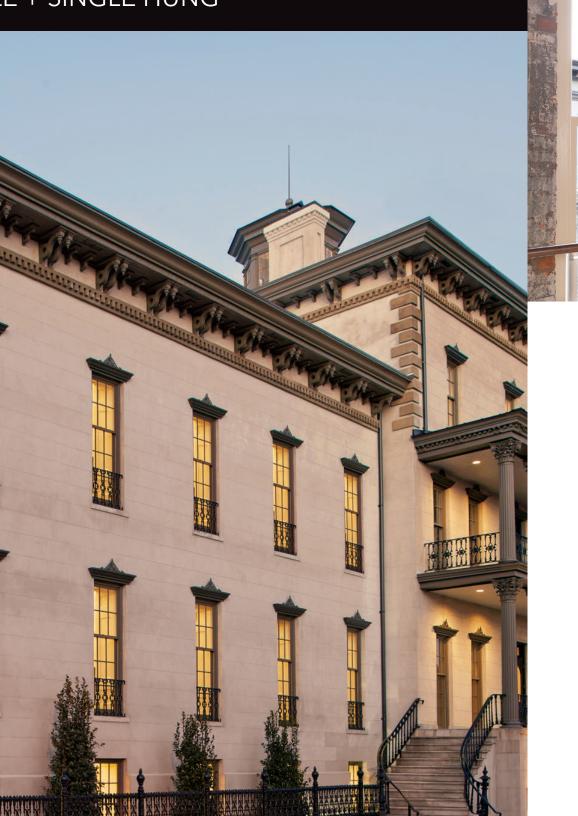



WOOD DOUBLE AND SINGLE HUNG WINDOWS

The Ultimate Wood Double/Single Hung and Ultimate Wood Double Hung Magnum are q traditional windows designed to fit seamlessly into the historic fabric of your home, neighb or community. With residential and commercial applications, these windows are perfect for historic building.



WOOD DOUBLE/SINGLE HUNG EXTERIOR



WOOD DOUBLE HUNG MAGNUM INTERIOR

Divided Lites

Types


The look of multiple, individual panes of glass in a window sash is popular in a wide range of architectural styles - from historic replications to modern farmhouses. Simulated divided lites, available in a number of different styles, mimic the look of individual panes of glass in a window sash without sacrificing the energy efficiency of a single pane of glass. For true historical accuracy, authentic divided lites utilize individual glass panes, and are available as a custom order on select all-wood windows.

Authentic Divided Lite (ADL) - Separate pieces of glass are glazed between muntin bars - the way windows have been made since the beginning but with Marvin's updated design to increase energy efficiency.



Authentic Divided Lite (ADL)



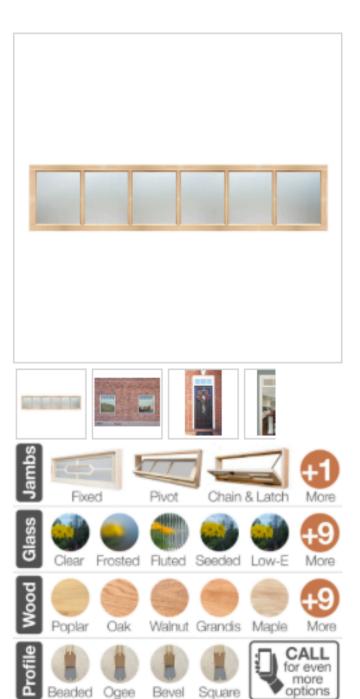

Complete Explanations Below

Customize Transom Model TR-1-6016

* * * * * 432 reviews (Show Reviews)

\$1,044.00

Exterior Construction

>> Designed for exterior wall on one side.

Transom Unit with Jamb

>> Window comes pre-installed in a jamb.

Unit Width: Unit Height: Unit Depth: 73-1/2" 17-1/2" Wall Thickness

CHANGE SIZE - INTERIOR/EXTERIOR...

SASH INSTALLATION OPTIONS

| RTI Ext Operating Transom - Chain & Latch with Weather Sill (+\$320.00) \$ | | | | |
|--|--|--|--|--|
| Wall Thickness: | | | | |
| 6-9/16 in. (2x6 Wall with 1/2 in. Drywall) (+\$135.00) | | | | |
| Hardware Finish: | | | | |
| Oll-Rubbed Bronze | | | | |
| Window Screen: | | | | |
| White-Framed Screen (for Paint-Grade) (+\$50.00) \$ | | | | |

| SASH UPGRADE OPTIONS |
|--|
| Muntin Bars: 🔗 |
| Keep Number of Glass Panes and Bars As Shown |
| Specialty Glass: 🔗 |
| × Clear IG (Insulated Glass) (Standard) |
| Stain Grade Wood: 🔗 |
| × Cypress/Red Grandis - Ext Paint Grade (Standard) ‡ |
| Stain Grade Jamb: |
| × Paint Grade Cypress/Red Grandis Jamb (Standard) 💠 |
| Custom Sticking: Ø |
| × Beaded Profile (Standard) 💠 |
| Other Instructions: |
| × No Special Instructions 💠 |

Material: 0.027 - 0.032 inches aluminum

Profile: 5 or 6 inch K Style Gutter

Finish: White or off white baked on enamel

Hangers: Hidden hangers spaced every 24 - 30 inches

Downspouts: 2x3 or 3x4 depending on gutter size choose





PROPOSED DECK MATERIAL



FIND A CONTRACTOR

REQUEST A QUOTE


Home > Products > Decking > TimberTech Composite™ > Legacy Collection









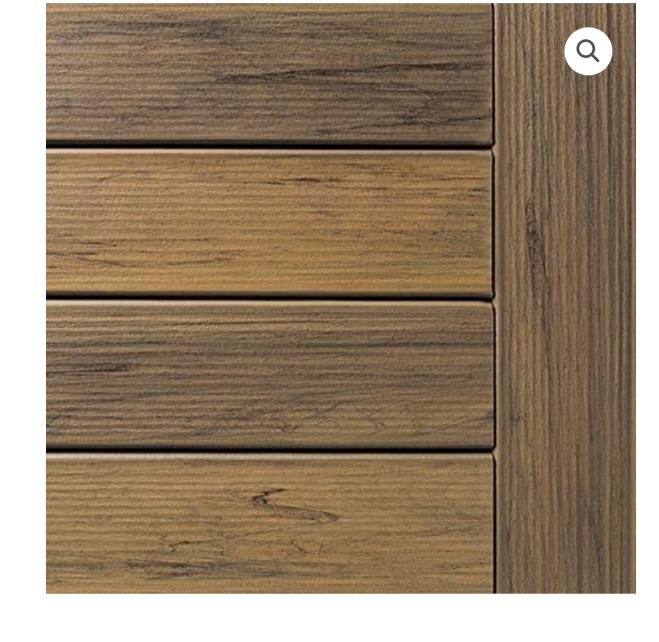







TIMBERTECH COMPOSITE

Legacy Collection

Hand-Scraped Finish

Capture the essence of nature with unique board-to-board variation (no two are exactly alike), without the rigorous maintenance of wood. Featuring a character-rich hand-scraped texture and dynamic blend of hues, our premium polymer capped composite boards deliver real wood aesthetics you'll never have to sand, stain, or seal.

COLOR TIGERWOOD



SAMPLE SIZE

| 1' Sample | FREE | \$0.00 | |
|-----------|------|--------|--|
| | | | |

\$0.00



DETAILS

OPTIONS & DIMENSIONS

INSTALLATION & WARRANTY

FAQS

DURABLE

Made of a mix of high-performance and recycled polymers and reclaimed wood fibers, our Composite Decking is made to last and won't splinter, crack, cup, or peel.

FADE & STAIN RESISTANT

Enjoy a richly hued deck for decades with protective capping that resists UV rays and staining.

PROTECTIVE WARRANTIES

Rest easy knowing your investment is protected with Product and Fade & Stain Limited Warranties.

MOLD GUARD® TECHNOLOGY

Our boards are shielded from mold and organic growth even on the bottom of the board.

LOW MAINTENANCE

Never sand, stain, or seal your deck ever again. An occasional scrub and rinse are all that's needed.

MOISTURE RESISTANT

With a protected polymer cap with no wood fibers, our boards are protected from moisture damage like mold, mildew, and rot.

SUSTAINABLE

Made in the USA from approximately 85% recycled material including plastic bags, milk jugs, and other discarded plastics for an eco-friendly choice.

AUTHENTIC AESTHETICS

TimberTech Composite™ Decking features some of the most realistic wood looks in the marketplace. With advanced color blending and textured grains and finishes pulled directly from nature, you get the beauty of wood without the drawbacks.

Timber Tech

Products

Inspiration

Why TimberTech

Resources

Get Started

Home > Products > Railing > Classic Composite Series













COMPOSITE RAILING

Classic Composite Series

High Performance & Design Versatility

Made from a mix of recycled wood and plastic fibers, TimberTech composite railing boasts superior durability to wood, while being extremely low maintenance. With the most customization options, from traditional milled-wood-inspired looks to sleek, contemporary designs, mixing and matching components is a breeze.

Choose from multiple top rail design, infill options, and other accessories to customize your railing. See options.

TOP RAIL SHAPE Premier Rail










COLOR White



CAMBLE CIZE

Drink Cap proposed for rear deck railing

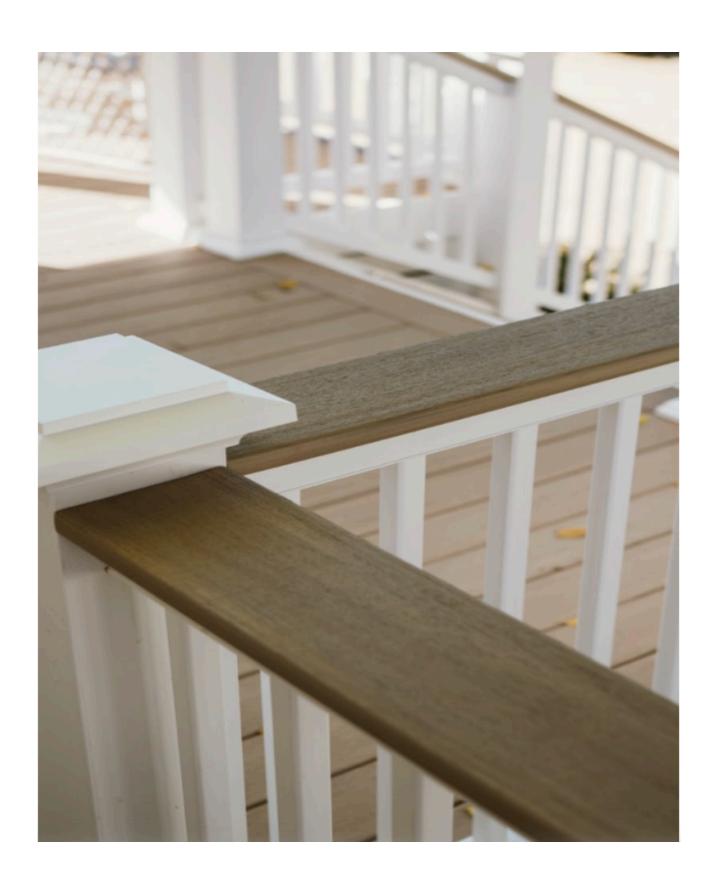




Cedar Clapboards

Description:

1/2"X6" CEDAR CVG FJ PRIMED GREY REVERSIBLE CLAPBOARD

Heat Pump decorative enclosure

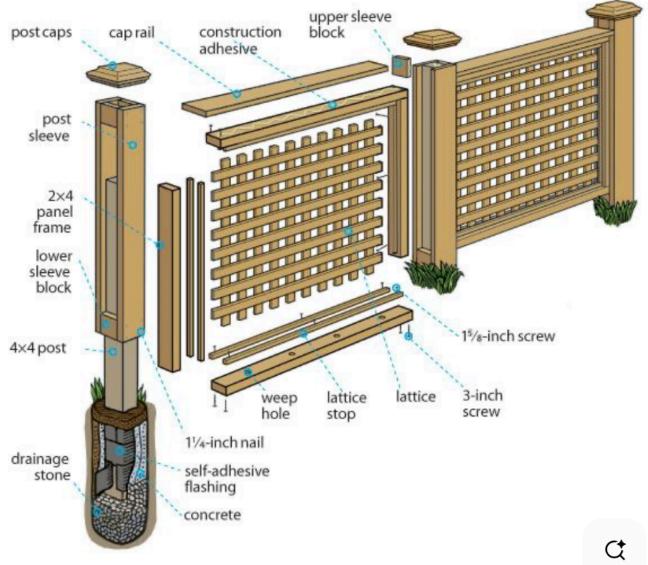



Specifications:

- Posts, pressure treat wood
- Lattice, Pressure Treated Spruce Pine Fir Wood Square Lattice Panel
- Screws, Stainless Steel
- All other material Pressure Treated Pine

The MXZ model has 3 size variations across 16 unit options.

Variation 1

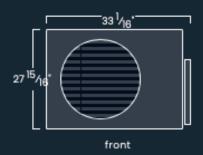


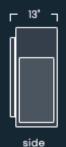


2 Units with these dimensions:

- MXZ-2C20NA3-UI (20000k BTU/H)
- MXZ-2C20NA4-U1 (20000k BTU/H)

Variation 2

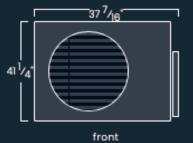

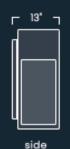


8 Units with these dimensions:

- MXZ-2C20NAHZ3-U1 (20000k BTU/H)
- MXZ-2C20NAHZ4-U1 (20000k BTU/H)
- MXZ-3C24NAHZ3-U1 (24000k BTU/H)
- MXZ-3C24NAHZ4-UI (24000k BTU/H)
- MXZ-3C30NAHZ3-U1 (30000k BTU/H)
- MXZ-3C30NAHZ4-U1 (30000k BTU/H)
- MXZ-5C42NA3-U1 (42000k BTU/H)
- MXZ-5C42NA4-U1 (42000k BTU/H)

31 3/8

front

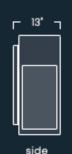

6 Units with these dimensions:

- MXZ-3C24NA3-UI (24000k BTU/H)
- MXZ-3C30NA3-U1 (30000k BTU/H)
- MXZ-3C30NA4-U1 (30000k BTU/H)
- MXZ-4C36NA3-U1 (36000k BTU/H)
- MXZ-3C24NA4-U1 (24000k BTU/H)
- MXZ-4C36NA4-U1 (36000k BTU/H)

6 ft. H x 8 ft. W Cedar Doweled Flat Top Fence Panel



About This Product

This 6 ft. x 8 ft. W Cedar Doweled Flat Top Fence Panel is made from naturally durable Eastern White Cedar. The panel comes with doweled backer rails and is pre-assembled for ease of installation. Environmentally conscious, this panel is made from renewable resources and is ideal for any project where privacy is desired. Its natural brown color is perfect for decorative landscaping and enhances any outdoor project.

Highlights

- Cedar fence is naturally durable and resistant to moisture and decay
- Eastern white cedar offers an attractive natural choice while enhancing any outdoor project
- Doweled backer rail provides unique method for fastening to post
- Decorative cap is included and adds style to the top of the panel
- Solid picket design offers ideal privacy around your home or landscaping
- Panel is pre-assembled to make sure that it installs quickly and easily
- Return Policy

Product Information

Internet # 206758694 Model # FBDCD6434HD Store SKU # 1001684251

Additional Resources

From the Manufacturer

- Instructions / Assembly
- Return Policy

6 ft. H x 8 ft. W Cedar Doweled Flat Top Fence Panel

Dimensions

Actual backer rail length (in.) 95.875 in Actual backer rail thickness (in.) 1.75 in Actual backer rail width (in.) 2.75 in Actual panel height (in.) 72 in 2.4375 in Actual panel thickness (in.) Actual panel width (in.) 95.875 in Actual Picket Length (in.) 72 in Actual picket thickness (in.) 0.6875 in Actual picket width (in.) 3.5 in 96 Nominal backer rail length (in.) Nominal backer rail thickness (in.) 2 3 Nominal backer rail width (in.) 6 Nominal panel height (ft.) 8 Nominal panel width (ft.) Nominal picket length (ft.) 6 ft Nominal picket thickness (in.) 1 in Nominal picket width (in.) 4 in

Details

Color Family White Color/Finish Cedar

Contact Type Allowed Above Ground

Features Paintable, Stainable Fencing Product Type Wood Fence Panels

Material Wood
Nominal panel thickness (in.) 2.5
Number of pickets for panel 26
Number of rails for panels 2

Panel Assembly Assembled Panel

Panel Design Privacy
Panel Top Shape Flat
Picket Top Style Framed
Product Weight (lb.) 82 lb

Project Address: <u>175 Fleet Street</u>

Permit Requested: Certificate of Approval

Application: Public Hearing #4

A. Property Information - General:

Existing Conditions:

• Zoning District: <u>Character District 5 (CD5) and</u> Downtown Overlay

Land Use: <u>Commercial</u>Land Area: 4,037 SF +/-

• Estimated Age of Structure: c.1940

• Building Style: Vernacular

• Number of Stories: 1

• Historical Significance: Contributing

• Public View of Proposed Work: Fleet Street and Hanover Street

• Unique Features: Original Diner

• Neighborhood Association: <u>Downtown</u>

B. Proposed Work: Construct rear addition, add fencing and landscaping, and the installation of (2) food kiosks.

C. Staff Comments and/ or Suggestions for Consideration:

The project proposal includes the following:

- Construct rear addition (to include bathrooms)
- Install fencing and landscaping
- Construct and install (2) food kiosks on site





HISTORIC SURVEY RATING

D. Purpose and Intent:

- 1. Preserve the integrity of the District
- 2. Assessment of the Historical Significance
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- 2. Compatibility of design with surrounding properties
- 3. Relation to historic and architectural value of existing structures
- 4. Compatibility of innovative technologies with surrounding properties

PROJECT NARRATIVE

- BUILD A NEW ADDITION TO THE REAR OF GILLEY'S KITCHEN STRUCTURE, FOR PUBLIC BATHROOMS & CUSTODIAL.
- BUILD 2 NEW FOOD KIOSKS
- INSTALL NEW CEDAR FENCE TO CONCEAL TRASH RECEPTACLES.
- INSTALL NEW LANDSCAPING AND HARDSCAPE TO COORDINATE WITH PREVIOUSLY APPROVED IMPROVEMENTS TO NEWBERRY WAY (aka Haven Court).

| SHEET LIST -HDC | | | | | |
|-----------------|--------------------------------------|--|--|--|--|
| SHEET NO. | NAME | | | | |
| G0.1 | COVER | | | | |
| G1.1 | SITE PLAN | | | | |
| G1.2 | LANDSCAPE PLAN | | | | |
| G1.3 | ROOF PLAN | | | | |
| G2.1 | ELEVATION, WEST | | | | |
| G2.2 | ELEVATION, SOUTH | | | | |
| G2.3 | ELEVATION, EAST | | | | |
| G2.4 | ELEVATION, NORTH | | | | |
| G2.5 | FOOD KIOSKS ELEVATIONS | | | | |
| G3.1 | 3D BIRDSEYE AXONOMENTRIC | | | | |
| G3.2 | PERSEPECTIVE from EAST, NEWBERRY WAY | | | | |
| G3.3 | PERSEPECTIVE from WEST, FLEET STREET | | | | |
| G7.0 | MILLWORK DETAILS | | | | |

MATERIALS PACKAGE





GILLEY'S FOOD COURT

HISTORIC DISTRICT COMMISSION
PUBLIC HEARING
DECEMBER 2025





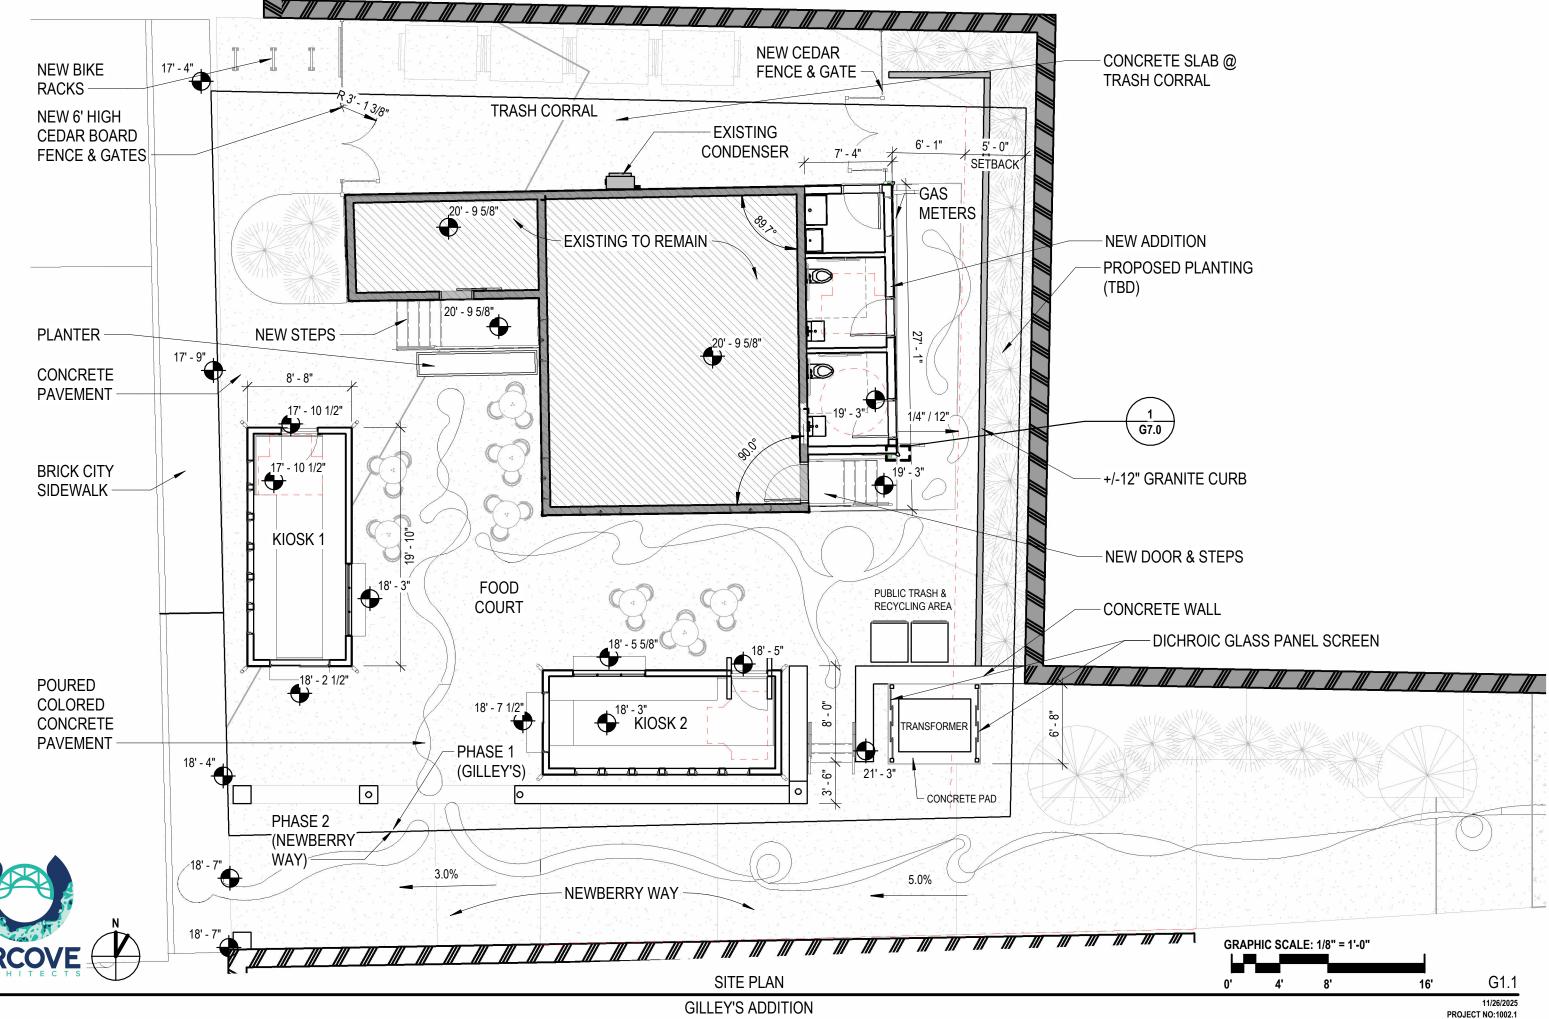

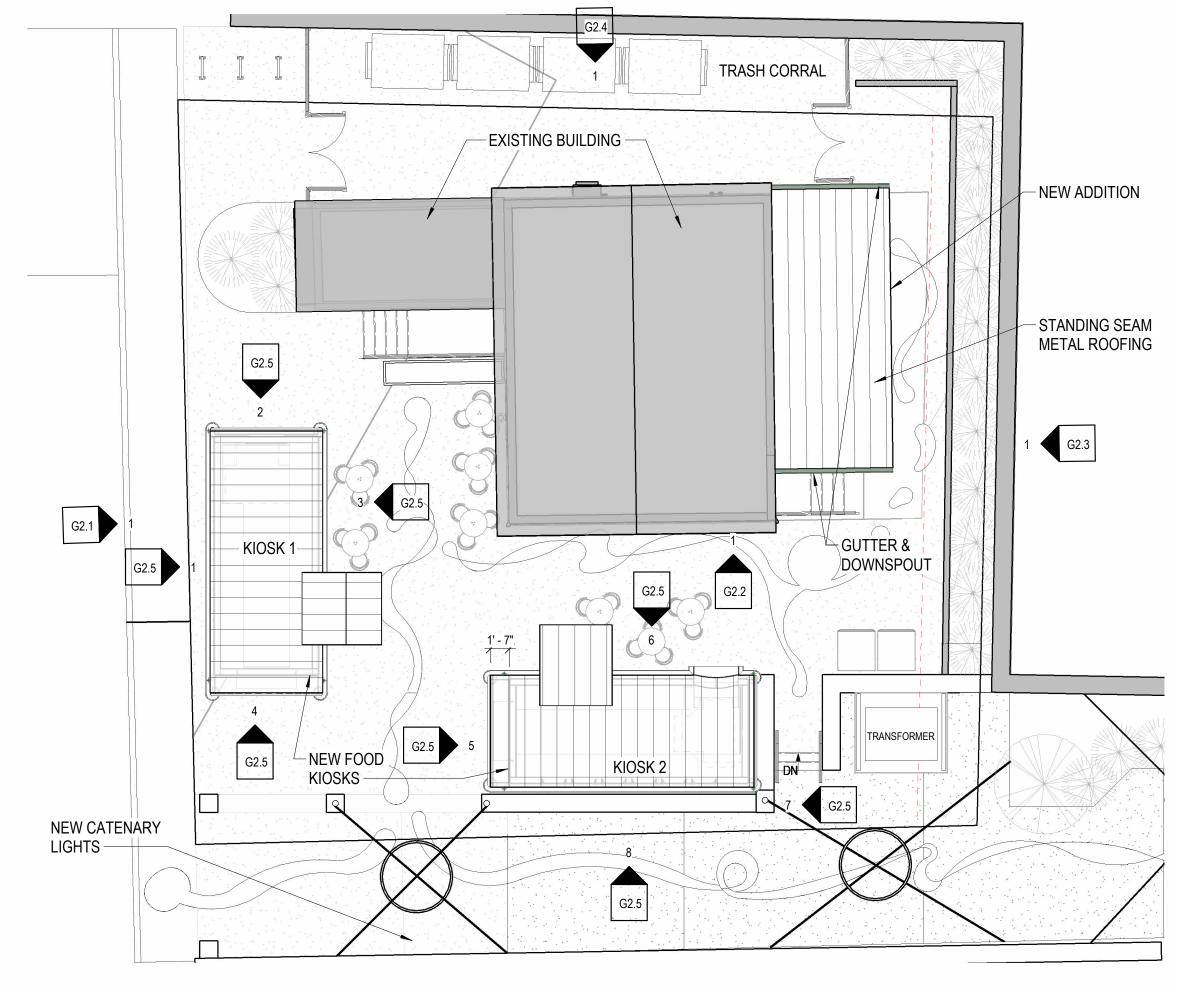

ARCOVE ARCHITECTS

ROOF PLAN









ELEVATION, WEST

G2.1

11/26/2025 PROJECT NO:1002.1

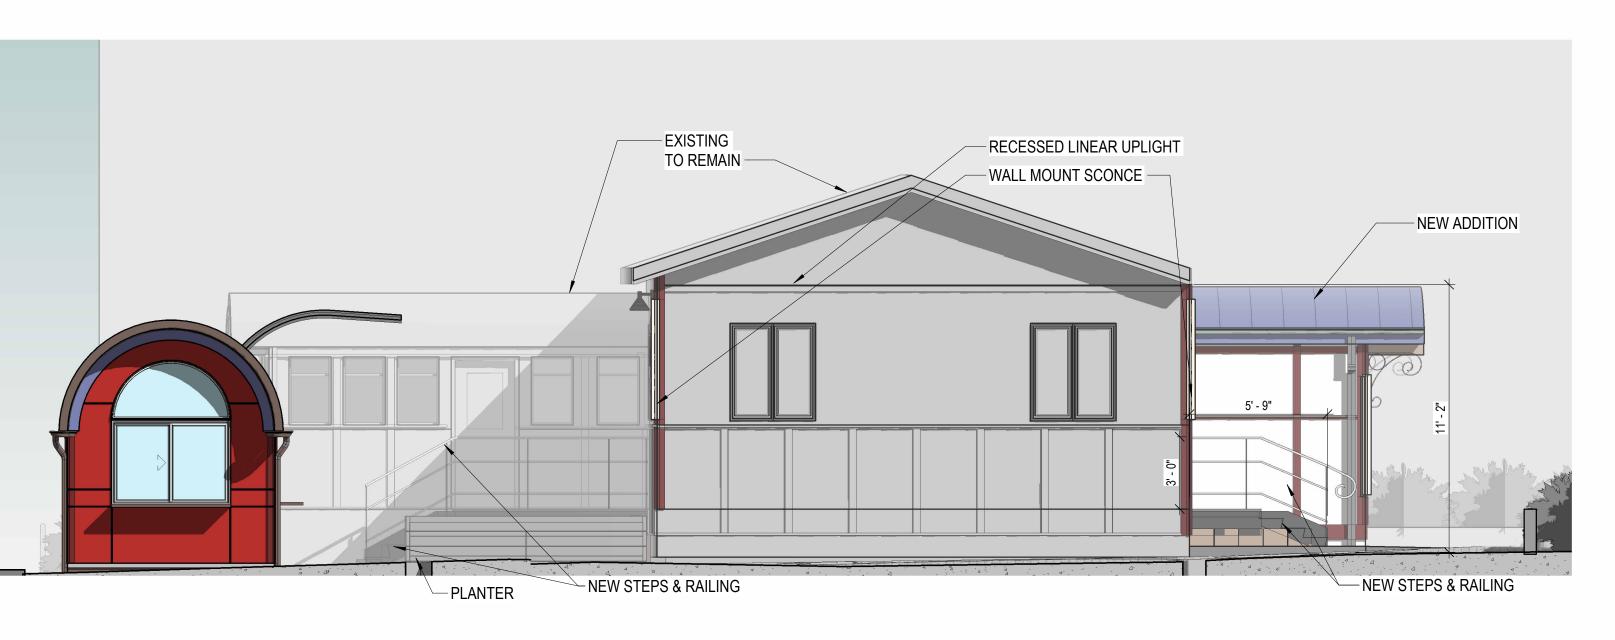


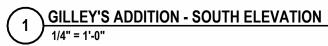




ELEVATION, SOUTH


G2.2

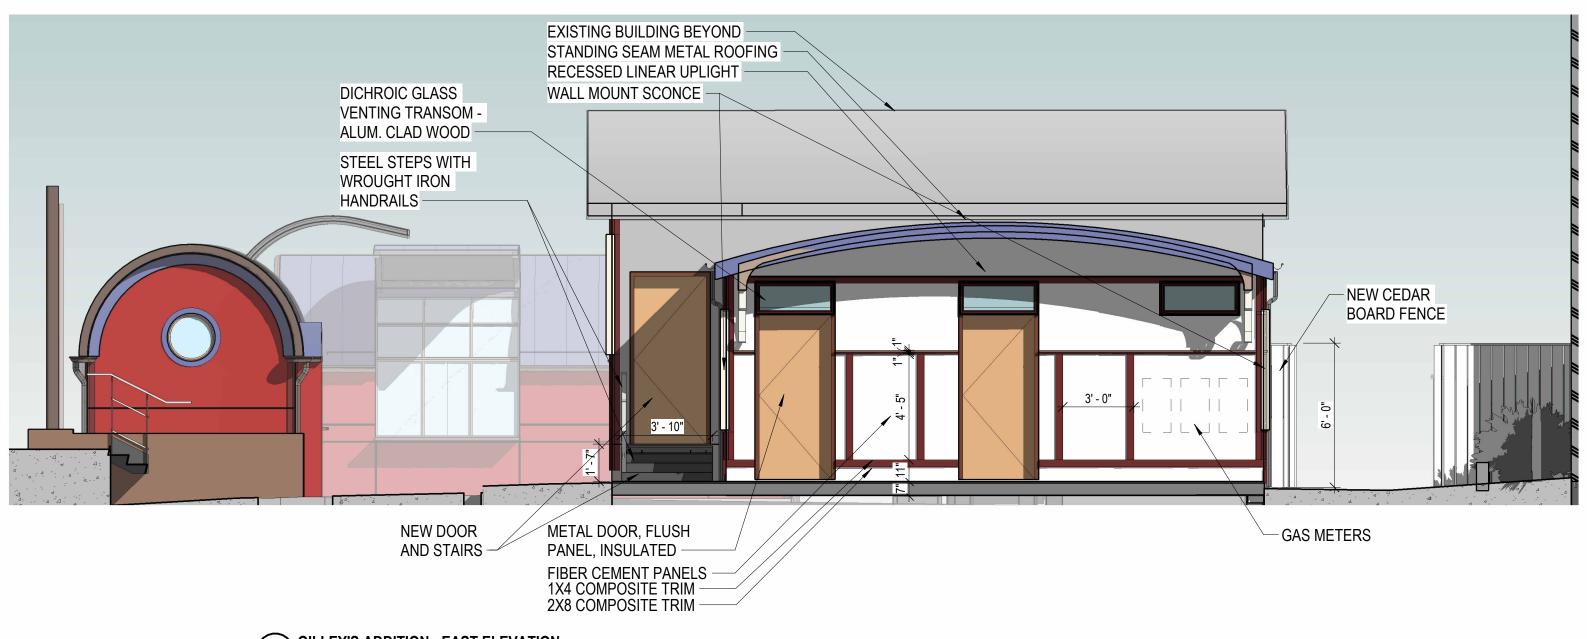

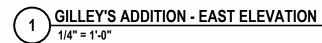




ELEVATION, EAST G2.3

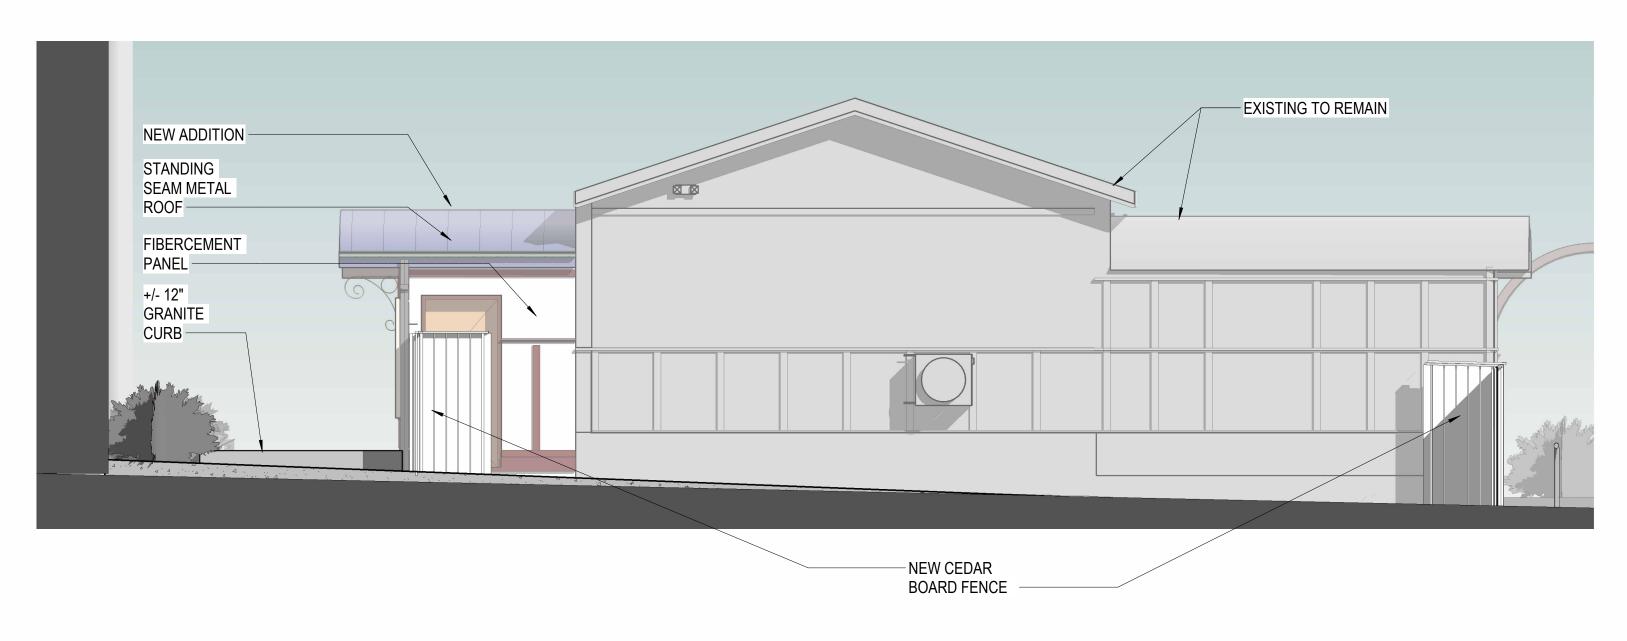








ELEVATION, NORTH

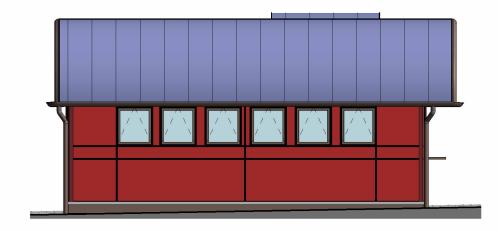

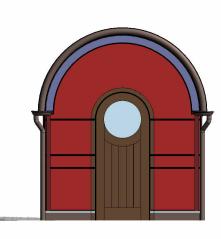

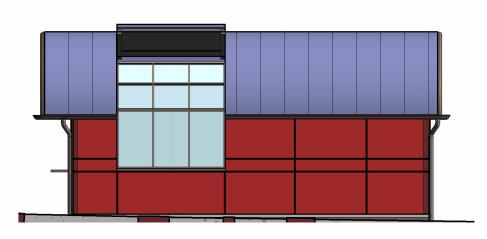

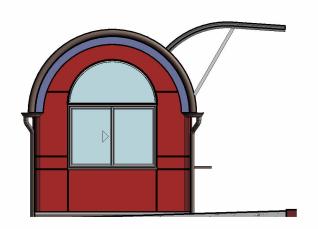



KIOSK 1 WEST
3/16" = 1'-0"


KIOSK 1 NORTH
3/16" = 1'-0"


KIOSK 1 EAST
3/16" = 1'-0"

)KIOSK 1 SOUTH
3/16" = 1'-0"

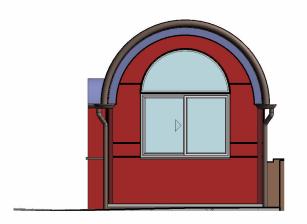

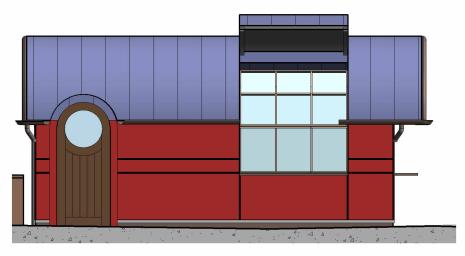

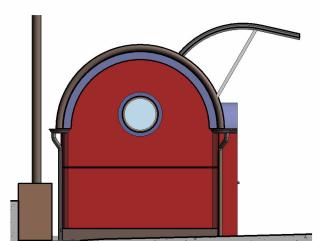

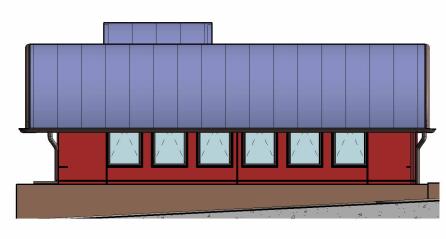

KIOSK 2 WEST
3/16" = 1'-0"

KIOSK 2 NORTH
3/16" = 1'-0"

KIOSK 2 EAST
3/16" = 1'-0"

KIOSK 2 SOUTH
3/16" = 1'-0"







3D BIRDSEYE AXONOMENTRIC G3.1







AT THE BACK OF GILLEY'S LOOKING TOWARD FLEET STREET





AT THE FRONT OF GILLEY'S LOOKING TOWARD NEWBERRY WAY

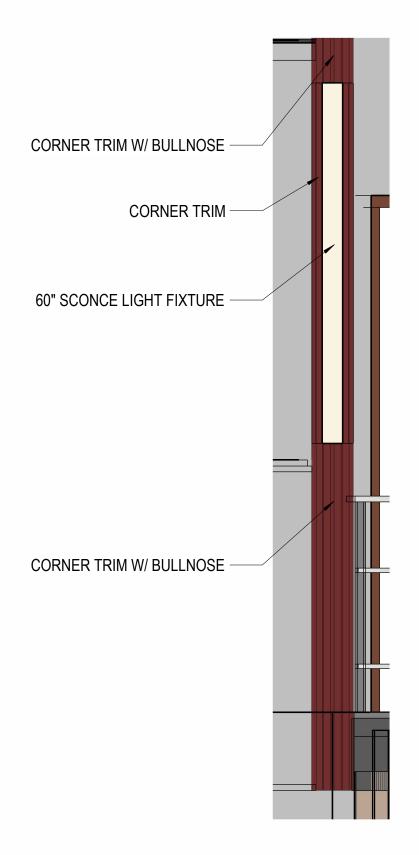

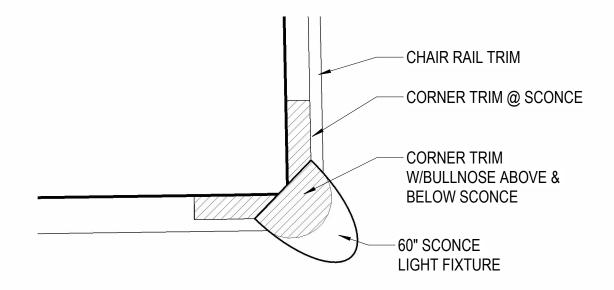

WALL CORNER TRIM AND SCONCE DETAIL - PLAN VIEW @ EXISTING BUILDING ADDITION

3" = 1'-0"



CORNER TRIM AND SCONCE ELEVATION - @ EXISTING BUILDING ADDITION

3/4" = 1'-0"

MILLWORK DETAILS

| Materials Schedule | | | | | | | |
|--------------------|----------------------------------|-----------------------------|----------------------------|------------------------------------|--|--|--|
| Sheet | Material Manufacturer Model/Make | | Model/Make | Finish/Color | | | |
| Bathrooms Ad | ldition | | | | | | |
| 1 | Fiber Cement Panels | American Fiber Cement Corp. | Solid | Luna | | | |
| 2 | Trim/Beadboard | Boral, TruExterior | Cove/Dutch Lap | Painted, to match existing trim | | | |
| 3 | Metal Roofing | ATAS International Inc. | PC System | Regal Blue panel w/ standing steam | | | |
| 4 | Gutter | K&M Sheet Metal | K Style 'Ogee' Gutter | Copper | | | |
| 5 | Doors | TruDoor | Transom, dichroic glass | Steel, painted | | | |
| 6 | Granite Benches | Swenson Granite | Benches | Carolina Coral & Autumn Pink | | | |
| 7 | Lighting | Sternberg Lighting | Cambridge Series | Black | | | |
| 8 | Railing | Custom | Wrought iron | Black | | | |
| 9 | Pavers | Swenson Granite | Pavers | Grey | | | |
| Food Kiosks | | | | | | | |
| 10 | Metal Composite Panels | Aluca Bond | Plus | Red Fire | | | |
| 11 | Windows | Pella | Reserve Contemporary | Alum Clad, aged copper | | | |
| 12 | Doors | Custom | Wood, Arch Top, round lite | Clear finish, Walnut | | | |
| 13 | Gutter | Riverside Sheet metal | Round, Radius | Copper, aged | | | |
| 14 | Metal Roofing | ATAS International Inc. | PC System | Regal Blue panel w/ standing steam | | | |




Cembrit Solid

Cembrit Solid is a through-colored panel with an acrylic paint surface. It's designed this way so it closely




matches the surface's acrylic paint

layer. This means if you choose the Solid product line for your façade, every edge of the board will feature the same hue as the surface color, giving the wall an unblemished appearance.

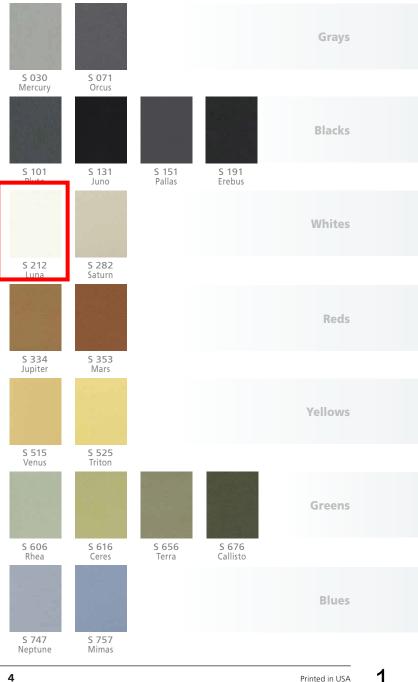

Printed in USA

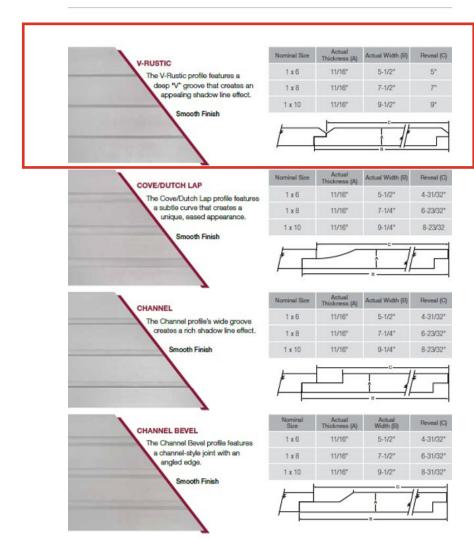

TruExterior Siding comes pre-primed and does require paint.

10

Accessories

TruExterior® Siding & Trim Accessories make it easy to create polished. professional-looking siding and trim installations. Decorative yet functional, the poly-ash accessories are designed to go where other materials can't, making them the perfect complement to cedar, fiber cement and other traditional siding products, as they are suitable for ground and masonry contact.




SKIRT BOARD

Provides a decorative yet functional way to create the required clearance between siding and grade.

Available Finishes: • Smooth

- Woodgrain

| Nominal Size | Actual Thickness (A) | Actual Width (B) |
|-----------------|-------------------------|---------------------|
| 1 x 6 | 3/4" | 5-1/2" |
| 1 x 8 | 3/4" | 7-1/4* |
| 5/4 x 6 | 1" | 5-1/2" |
| 5/4 x 8 | 1* | 7-1/4" |

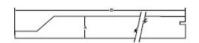




WINDOW POCKET RABBETED TRIM

The rabbeted groove helps trim to sit flush over the window's nailing flange, eliminating the need for cuts or shims.


Available Finishes: Smooth

Woodgrain

| Nominal Size | Actual Thickness (A) | Actual Width (B) | Window Pocker (W' x W") |
|-----------------|-------------------------|---------------------|----------------------------|
| 5/4 x 4 | 1" | 3-1/2" | 3/16" x 1-7/8" |
| 5/4 x 6 | 1" | 5-1/2" | 3/16" x 1-7/8" |
| 5/4 x 8 | 1" | 7-1/4" | 3/16" x 1-7/8" |

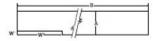

16

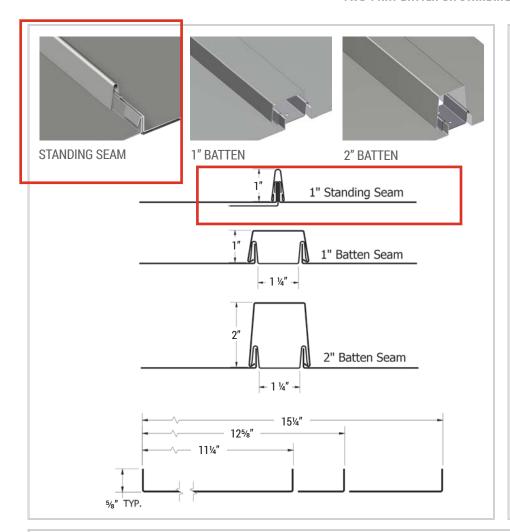

SKU:

Panel: PCP110, PCP120, PCP150, PCP999

Seam: PCS114

Batten: PCB001, PCB002

Copper: PCP147

Material:

.032. .040 aluminum:

22*, 24 ga. metallic coated steel; 16 oz. copper* (PCP147 only)

Panel Coverage:

11¼", 125½", 145/3" †, 15¼" Custom widths available †Copper and Dark Bronze Anodized only

Minimum Panel Length:

2'-0" for straight, 3'-0" for curved

Seam Height:

Standing Seam: 1"

Batten Seam: 1" x 1½" or 2" x 1½"

Available:

Straight, Tapered, Curved[‡] (Concave, Convex)
[‡]Available in standing seam only

Texture:

Smooth or Embossed

Minimum Slope:

3:12

*Subject to minimum quantities and longer lead time. Inquire for availability.

Application:

- Two-part system that consists of the flat panel, and a separate seam or batten
- · Seam is snapped over the clips, concealing the fastening system
- PC[™] System panels are not structural and must be applied to a solid substrate
- Precision leveling prior to forming
- Fasteners and clips allow panels to float without causing stress
- · Crating for job site handling/staging

Performance Standards:


- Tested in accordance with UL 790/ASTM E 108, UL 580, ASTM E 283, ASTM E 331, UL 2218, ASTM E 84 Flame Spread
- High reflectivity of panels which increases energy efficiency





Mix and match colors of the flat panel and standing seam or batten seam for a unique aesthetic.



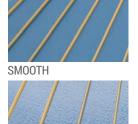

EMBOSSED



For more information: Visit www.atas.com/pc



Allentown, PA | Mesa, AZ 800.468.1441 610.395.8445 info@atas.com www.atas.com






STOCK COLORS (PVDF Finish)

PVDF resin based coatings provide high-performance durability for exterior and interior applications. These coatings are designed to resist fading, chalking, and abrasion. Meets the requirement of AAMA 2605-13 and AAMA 620-02.



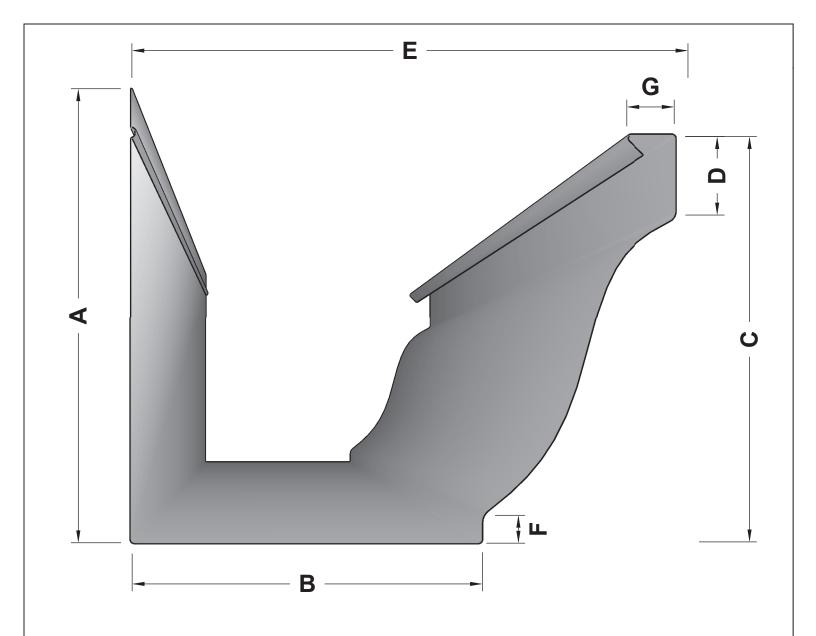

Dimensions for Standard Gutter Sizes

| SIZE LOC. | Α | В | С | D | Е | F | G |
|-----------|--------|--------|--------|-------|----|-------|-------|
| 4K | 3 1/8" | 2 3/4" | 2 7/8" | 9/16" | 4" | 7/16" | 1/2" |
| 5K | 3 5/8" | 3 3/8" | 3 3/8" | 9/16" | 5" | 9/16" | 1/2" |
| 6K | 4 7/8" | 3 7/8" | 4 5/8" | 1" | 6" | 5/8" | 9/16" |
| 7K | 5 7/8" | 4 5/8" | 5 5/8" | 1" | 7" | 5/8" | 5/8" |
| 8K | 7 1/4" | 5 3/8" | 7" | 1" | 8" | 5/8" | 5/8" |

Notes

4" 5" & 6" K Style Gutter is Roll - Formed and available in any length up to 40' 7" & 8" K Style Gutter is Brake Formed and available in lengths up to 20'


4



| K Style | 'Ogee' | Gutter |
|---------|--------|--------|
|---------|--------|--------|

| REVISIONS | | | | | | | |
|------------------|-----|---------------------------|--|--|--|--|--|
| MM/DD/YY REMARKS | | | | | | | |
| 1 | | ORIGINAL DRAFT OF DRAWING | | | | | |
| 2 | // | | | | | | |
| 3 | // | | | | | | |
| 4 | // | | | | | | |
| 5 | / / | | | | | | |



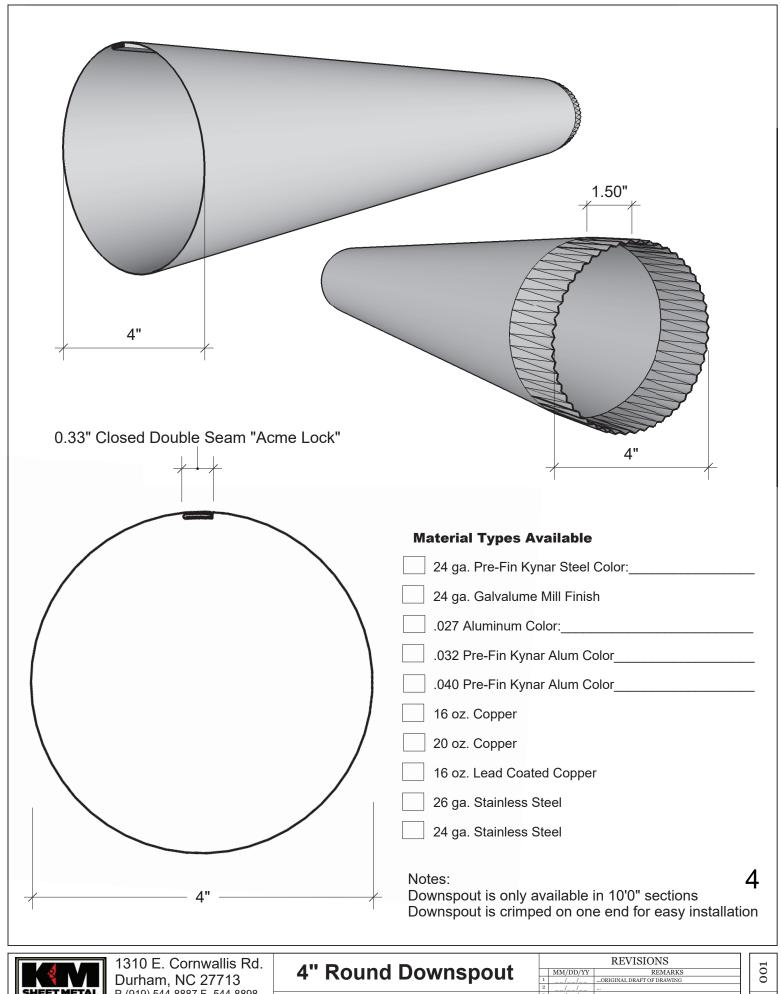


P-(919) 544-8887 F- 544-8898 info@kmsheetmetal.com - www.kmsheetmetal.com

| REVISIONS | | | | | | | |
|------------------|-----|---------------------------|--|--|--|--|--|
| MM/DD/YY REMARKS | | | | | | | |
| 1 | // | ORIGINAL DRAFT OF DRAWING | | | | | |
| 2 | // | | | | | | |
| 3 | // | | | | | | |
| 4 | // | | | | | | |
| 5 | / / | | | | | | |

Featuring Doors and Frames Made in the USA!

Hollow Metal Door Frames (https://www.trudoor.com/commercial-hollow-metal-door-frames/) > Transom Frame

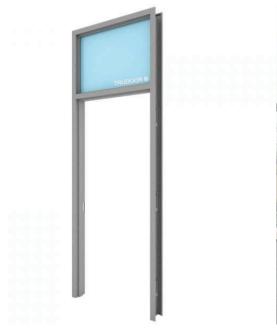

(https://prod-trudoor-media.s3.us-west-2.amazonaws.com/wpcontent/uploads/2019/05/21112044/commercial-hollow-metaltransom-frame-e1593364728903.jpg)









Hollow Metal Transom Frame

Starting at Inquire

Rationwide Delivery

A hollow metal transom frame is a door frame with a fixed horizontal transom bar and glass above the door. A steel panel made from a hollow metal door can be used in lieu of glass.

- 16-Gauge Steel Cold Rolled or Galvanized
- · Available Welded or Knocked Down
- Includes Anchors for Any Wall Condition

CONFIGURE & GET PRICE(/QUOTE-REQUEST/)

Commercial Hollow Metal Doors (https://www.trudoor.com/commercial-hollow-metal-doors/) > Flush Metal Door



(https://prod-trudoor-media.s3.us-west-2.amazonaws.com/wp-content/uploads/2019/04/21112338/flush-hollow-metal-door-2.jpg).





Flush Commercial Hollow Metal Doors

The flush hollow metal door, or *steel slab door,* is the most common commercial steel door and can be used for virtually any application, including industrial and commercial buildings. Flush doors have no cut-outs for anything other than locksets and hinges but can be prepped for other hardware, glass kits, and louvers.

- · Heavy-Duty 18-Gauge Steel
- Rigid Honeycomb or Polystyrene Core
- Ideal for Exterior and Interior Applications

CONFIGURE & GET PRICE(/QUOTE-REQUEST/)

Product Overview

Heavy-duty steel door for commercial, industrial, and institutional applications

Our stock hollow metal door is an affordable non-handed, square-edge door solution designed to meet your requirements for quality full flush steel doors. These doors are designed to satisfy your requirements for durability, security, aesthetics, or fire protection. Replacement doors and doors with new frames available.

Features

- 1-3/4" Thick, non-handed design with reversible hinge plates
- · Inverted top and bottom channels for additional stability and protection
- · Interlocking seam enhances structural rigidity and durability
- Available with a wide range of glass lites, louvers, and hardware preps
- Factory-applied rust-inhibiting primer (no special color options)
- Fire-rated doors up to 3 hours (https://www.trudoor.com/commercial-hollow-metal-doors/fire-rated-metal-door/) with WHI / ITS mylar label applied (optional)



Specifications -

| Level | Heavy Duty, SDI Level 2 – 18-Gauge Steel Face Sheets – (16 Ga. Available) | Core | Rigid Honeycomb Core or Polystyrene Core |
|--------------------------------|---|------------------------------|--|
| Door Thickness | 1-3/4" Standard | Handing | Non-Handed Design; Reversible Hinge Plates |
| Sizes | Standard Widths up to 4'0", Heights to 8'0" (Custom Sizes Available) | Edges | Square Hinge and Lock Edges (Beveled Edges Available) – Full Height, Epoxy Filled Mechanical Interlock Edges |
| Reinforcements | Heavy Gauge Door Closer and Hinge Reinforcements | Channels | 14-Gauge Inverted Top and Bottom Channels, Optional Flush Top Cap |
| Door Finish | Factory-Applied, Baked-On, Rust Inhibiting Gray Primer (No Special Color Options) – Not intended to be a finish coat. It is recommended that finish paint (topcoat) be applied after installation | Standard Preps | 161 (cylindrical lock), 86 Edge (mortise lock), Deadbolt, RPD (blank edge, panic reinforced) |
| Optional Preps | Continuous Hinge Application (Undersized Width), Exit Device Trim, Deadbolts, Lite and Louver Cutouts | ANSI Standards | Meets or Exceeds Standards for ANSI 250.4 and ANSI 250.8 |
| Fire-Rating | Optional – WHI / ITS up to 3-hour Fire-Rating, Positive Pressure and "S" Smoke included | Approvals | Optional – Florida Product Approved FL-13884 or FL-14237 |
| Buy American Act Compliance | Meets Buy American Act – Made in USA | Mfg. Hinge/Lock Locations | Steelcraft, Baron, Ceco, Curries, Mesker, Republic, Pioneer, Deansteel, Custom Locations |

Steel Door Frame with Transom for Commercial Applications

Transoms are door frames having a transom bar and glass or steel panel above the door opening. The transom bar separates the door opening from the transom opening. The frame height will vary but normally extends to the ceiling above. Glazing bead (glass stops) are provided with all sidelite frames. Stops install on the inside of the frame to hold the glass or panel in place. Transom frames can also include attached sidelites.

Features

- 16-Gauge cold rolled steel (galvanized available)
- Includes 5/8" glass stops, screws and glazing tape
- 5 glass type options (optional steel panel in lieu of glass)
- Anchors available for any wall condition
- Available KD (knocked down) or welded
- Fire-rated up to 45-Minutes with WHI / ITS mylar label applied (optional in limited sizes)



Specifications

| Construction | Heavy duty; 16-gauge cold rolled steel (galvanized and stainless steel available) | Corners | Exact fit die-mitered corner connections |
|--------------|---|--------------------------------|---|
| Anchors | Anchors provided for new or existing walls | Glass Stops | 5/8" glass stops, cut to size (screws included) |
| Glazing | 1/4" clear tempered glass, 1/4" wire glass, 3/16" Pyran Platinum F glass ceramic, 3/16" Firelite NT glass ceramic, 1" insulated glass | Fire-Rating | Fire-rated up to 45-Minutes with WHI / ITS mylar label applied (optional – in limited sizes). Fire-rated glazing must be used. Fire-rated assemblies must be in accordance with NFPA 80 |
| Finish | Factory-Applied, Baked-On, Rust Inhibiting Primer (No Special Color Options) – Not intended to be a finish coat. It is recommended that finish paint (top coat) be applied after installation | Buy American Act Compliance | Meets Buy American Act – Made in USA |

Glass Types











3M™ Dichroic Film for Laminated Glass

Compatible with EVA, SentryGlas® or PVB interlayer adhesives. Available in gold-blue or copper-bronze colors.

Flexible

Film can be printed, cut, patterned, bent, or combined with different glass types or interlayer adhesives.

Versatile

Applications include shading fins, balustrades, exterior glass, partition walls, shower doors, artistic glass and furniture.

Gold-Blue Dichroic Film



In Transmission (Shown)

In Reflection

Yellow ► Magenta ► Blue

Gold (straight) Blue (angle)

Copper-Bronze Dichroic Film



In Transmission (Shown)


In Reflection

Magenta ► Blue ► Aqua

Copper (straight) Bronze (angle)

How is it made?

3M™ Dichroic Film is easily laminated between sheets of adhesive interlayers. It's conformable for bent glass applications and works with different glass and PVB

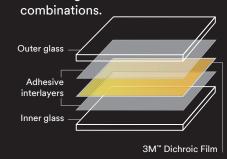



Solar performance of clear laminated glass

| | Reflection Visible | Transmission Visible | Transmitted Energy | Reflected Energy | Absorbed Energy | TSER | SHGC |
|------------------------------|-----------------------|-------------------------|-----------------------|---------------------|--------------------|------|------|
| Gold-Blue Dichroic Glass | 89% | 11% | 56% | 29% | 15% | 39% | 0.61 |
| Copper-Bronze Dichroic Glass | 29% | 71% | 55% | 29% | 17% | 41% | 0.59 |

Make an impression at 3M.com/Glass.

Technical Information: The technical information, recommendations and other statements contained in this document are based upon tests or experience that 3M believes are reliable, but the accuracy or completeness of such information is not guaranteed.

Product Use: Many factors beyond 3M's control and uniquely within user's knowledge and control can affect the use and performance of a 3M product in a particular application. Given the variety of factors that can affect the use and performance of a 3M product, user is solely responsible for evaluating the 3M product and determining whether it is fit for a particular purpose and suitable for user's method of application.

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Limitation of Liability: Except where prohibited by law, 3M will not be liable for any loss or damage arising from the 3M product, whether direct, indirect, special, incidental or consequential, regardless of the legal theory asserted, including warranty, contract, negligence or strict liability.



GRANITE BENCHES



Autumn Pink




Carolina Coral

A78LED CAMBRIDGE SERIES



Fixtures

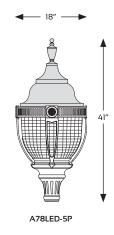

Fitters

10-1/8" W 10-3/8" H



Fits 3" OD x 3" tall tenon/pole

10-1/8" W 10-1/8" H



BD4 Fits 4" OD x 5" tall tenon/pole

10-1/8" W 10-1/4" H



BD5 Fits 5" OD x 6" tall tenon/pole

10-1/8" W 11-3/4" H



BD7 Fits 7" OD x l" tall tenon/pole

10-1/2" W 15-3/4" H



Fits 3" OD x 3" tall tenon/pole **994** Fits 4" OD tenon/pole

10-1/2" W 13-1/8" H



991 Fits 3" OD x 3" tall tenon/pole

10-1/2" W 13-1/8" H



992 Fits 3" OD x 3" tall tenon/pole

10-1/2" W 15-3/4" H



Fits 3" OD x 3" tall tenon/pole **995** Fits 4" OD x 3" tall tenon/pole

10-1/2" W 11-3/8" H



OL3 Fits 3" OD x 3" tall tenon/pole OL4 Fits 4" OD x 3" tall tenon/pole


10" W 3-1/4" H



C2097 Fits 7" OD x 1" tall tenon/pole Project Name _ Qty ___

Catalog / Part Number



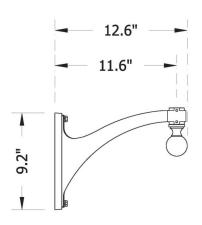

5 Year Warranty

Description



Finish



Textured









Textured



Bronze

Tex



Dark

Bronze Textured

The 80 arm is part of a diverse family of sizes and orientations that allow for many mounting configurations that meet almost any project design requirements. These cast aluminum arms offer strength and durability while maintaining a classic design aesthetic. Matching well with traditional luminaires these arms can be pole or wall mounted in single or multiple head configurations.

EPA: .41 (ft²) WEIGHT: 5.1 LBS

MAX FIXTURE WEIGHT: 50 LBS

Green

Brown



















Tex

Iron













Physical

| riiysicui | | | | | |
|---------------------|-------------------------------------|----------------------------------|--|--|--|
| Arm | 80: Sweeping Arm, Medium | | | | |
| Arm Orientation | U: Up Sweeping | D: Down Sweeping | | | |
| Fixture Orientation | T: Top Mount | H: Hanging | | | |
| Finial/Font | N: None | B: Ball | | | |
| | C: Chime | L: Long Font | | | |
| Mounting Styles | PMR: Post Side Mount, Round Pole | | | | |
| | PMF: Post Side Mount, Square | e Pole | | | |
| | WB: Wall Bracket | | | | |
| | WBBB: Wall Bracket With Ballast Box | | | | |
| Finish | BKT: Black Textured | WHT: White Textured | | | |
| | PGT: Park Green Textured | ABZT: Arch Med Bronze Tex | | | |
| | DBT: Dark Bronze Textured | VG: Verde Green | | | |

SI: Swedish Iron OI: Old Iron WBR: Weathered Brown


WBK: Weathered Black CM: Custom Match

VG: Verde Green **OWGT:** Old World Gray Tex

RT: Rust CD: Cedar TT: Two Tone




HDC 05-08-2020 Catalog #

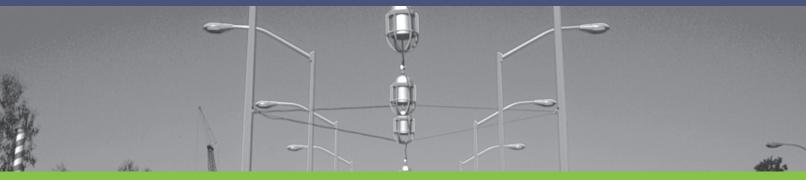

Round Tapered Aluminum Light Poles, Anchor Base

Product Overview

- Pole Shaft The pole shaft is extruded and spun from seamless 6063-T6 aluminum.
- Pole Top A removable top cap is provided for poles receiving drilling patterns for side-mount luminaire arm assemblies. Other pole top options include Tenon Top, Top Cap Only or Open Top which is typical when the pole top diameter matches the necessary slip-fit dimensions.
- Hand Hole A covered hand hole with hardware and grounding provision are provided.
- Anchor Base & Cover The anchor base is cast from 356 alloy aluminum and supplied with nut covers. The completed pole assembly is heat-treated to a T6 temper. Optional spun collar, square cast and decorative base covers available as special order.
- Anchor Bolts Anchor bolts conform to ASTM F1554 Grade 55 and are provided with two hex nuts and two flat washers. Bolts have an "L" bend on one end and are galvanized a minimum of 12" on the threaded end.
- Hardware All structural fasteners are galvanized high strength carbon steel. All non-structural fasteners are galvanized or zinc-plated carbon steel or stainless steel.
- Finish Finishes include anodized or painted. Please consult factory for special finishing colors and fixture matching options. When storing light poles outside, remove all protective wrapping immediately upon delivery to prevent finish damage.
- Design Criteria Standard EPA (Effective Projected Area) and weight values are based on Standard Commercial Criteria (with 1.3 gust factor) for side and top mounted fixtures only. Satisfactory performance of light poles is dependent upon the pole being properly attached to a supporting foundation of adequate design.

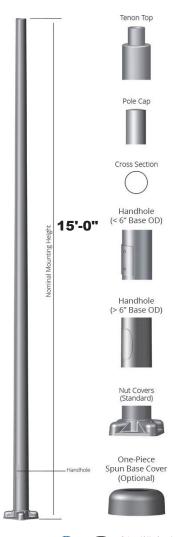










lightpoles PLUS.com

Light Poles Finish Colors (VA)

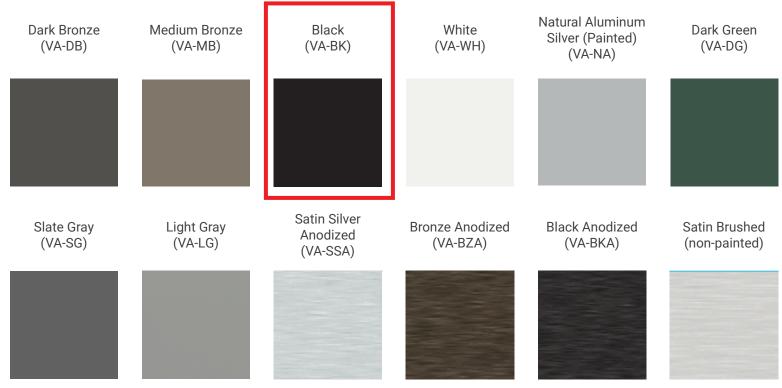





*Contact your sales representative for physical color chips.

Note: Actual colors may vary. This is due to the fact that every computer monitor has a different capability to display colors and that everyone sees these colors differently. We try to edit our photos to show the samples as life-like as possible, but please understand the actual color may vary slightly from your monitor. We cannot guarantee that the color you see accurately portrays the true color of the product.



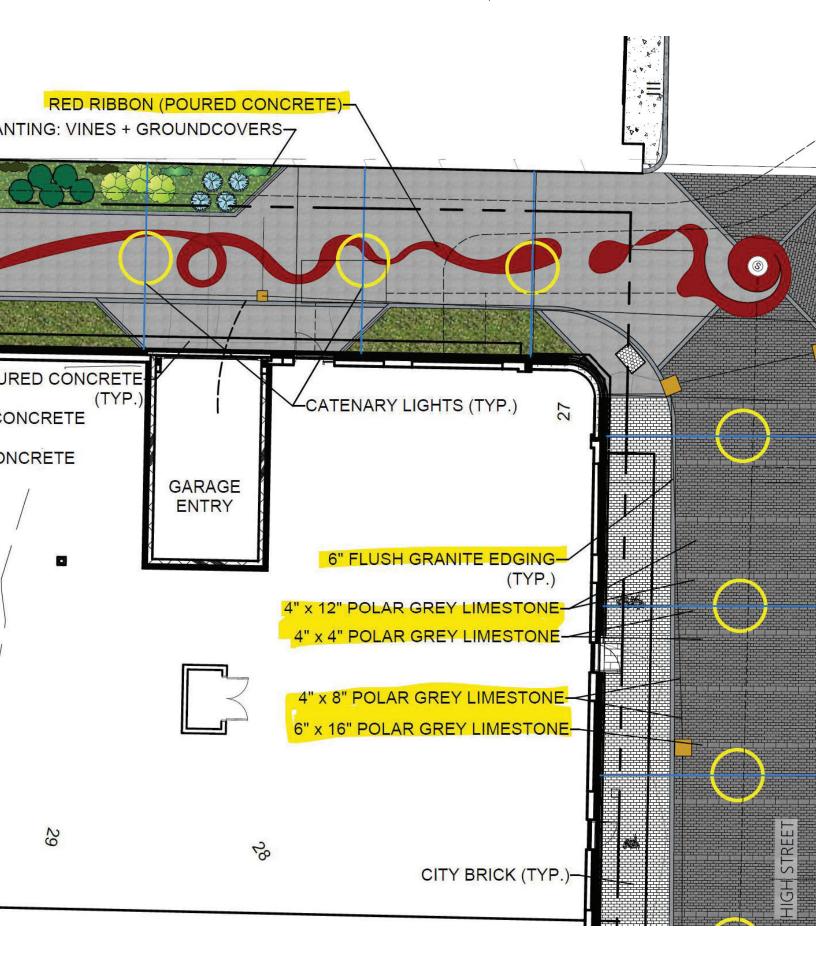

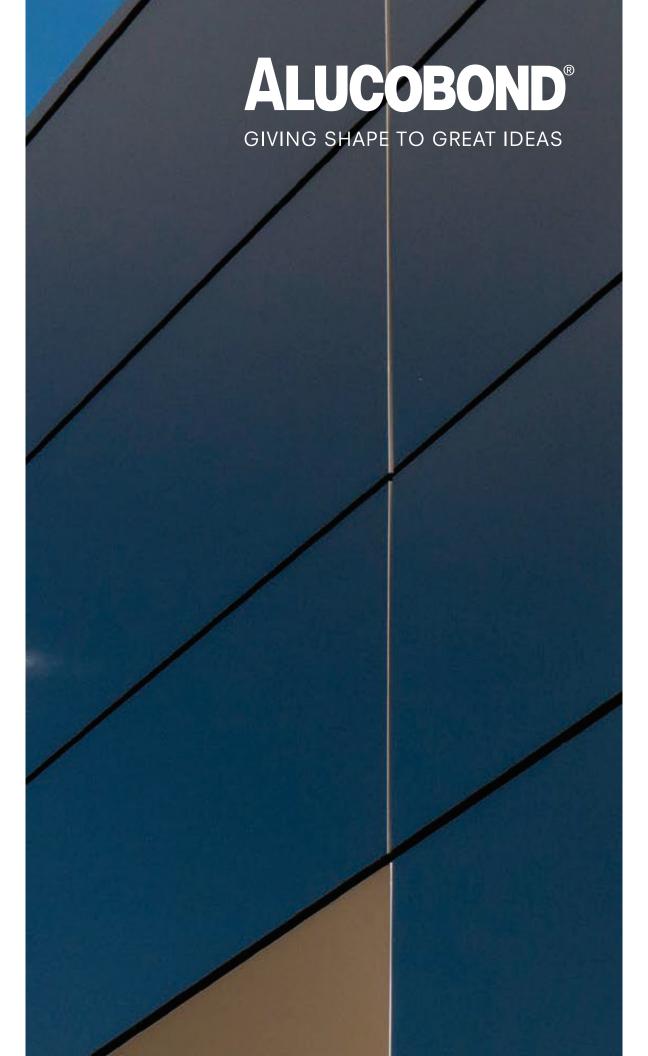

The Classic Collection

Legend

All finishes are stocked in ALUCOBOND PLUS and ALUCOBOND AXCENT, except those noted \Diamond or Ω

> ALUCOBOND AXCENT Made to Order Ω Not Available in ALUCOBOND AXCENT

The Classic Collection (continued)

Legend

All finishes are **stocked** in ALUCOBOND PLUS and ALUCOBOND AXCENT, except those noted \Diamond or Ω

> ALUCOBOND AXCENT Made to Order Ω Not Available in ALUCOBOND AXCENT



New-Age Dark

Bronze Mica PVDF 2

Gloss 20-30

Driftwood Mica






PVDF 2









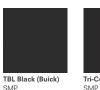



Gloss 25-35



Tuscan Sun PVDF/FEVE PVDF 2 Gloss 75-85 Gloss 25-35



Gloss 25-35





















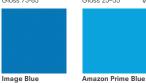

PVDF 2 Gloss 35-45

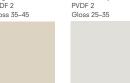

Alabaster

Metallic PVDF 2 Gloss 20-30

Anodic Satin Mica PVDF 2 Gloss 20-30

Metallic PVDF 3 Gloss 25-35

Harvest Gold Mica PVDF 2 Gloss 20-30












Oyster PVDF 2 Gloss 20-30

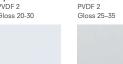

Cadillac White III PVDF 2 Gloss 30-40

Pure White (RVW) PVDF 2 Gloss 45-55

HWH Bio White PVDF 2



The Spectra Collection

Gloss 45-55

Carb Red SMP Gloss 75-85

Botanical PVDF 2 Gloss 25-35

Krispy Green PVDF 2 Gloss 25-35



Market Pearl White Mica PVDF 2 Gloss 15-25



Gloss 25-35

Cadet Gray

PVDF 2

Bone White

Gloss 25-35

PVDF 2

Brilliant Silver

Gloss 25-35

Metallic PVDF 3



PVDF 3

Gloss 25



Champagne Metallic

PVDF 3 Gloss 25-35















West Pewter Mica II

Beachstone Gray Metallic PVDF 2 Gloss 15-25



Ocean Galaxy Blue PVDF/FFVF PVDF/FFVF Gloss 70-80 Gloss 70-80

White Gold Cupral PVDF/FEVE PVDF/FEVE Gloss 70-80 Gloss 70-80

Gloss 70-80

The Anodized Collection*

*Natural variations in shade and color will occur with anodized finished metals. This variation is part of the natural beauty brought out by the anodizing process and often sought after for this aesthetic quality. Visual look of variation may also be effected by finit as well as size of panel.





Ω

Anodized

Gloss 15-25



Ω

Gloss 15-25



Ω

Gloss 15-25



Black Anodized Anodized Gloss 15-25 Ω

Steel City Silver Mica PVDF 2 Gloss 15-25





Gloss 5-15

Anthracite Silver Metallic PVDF/FEVE Gloss 70-80



Graphite Mica PVDF 2

Gloss 20-30



Clear Anodized Anodized Gloss 45-55 Gloss 15-25

ALUCOBOND Products



PROPERTIES AND BENEFITS

- Flatness and Rigidity
- Lightweight
- Durability
- Custom color expertise
- Formability

- Ease of fabrication
- Perforation capabilities
- 89 stocked ACM colors
- Complementary flat aluminum sheet colors
- Can contribute toward LEED points
- 100% recyclable
- Zero VOC's emitted in use
- EPD in compliance with International ISO Standards

ALUCOBOND® PLUS

4mm ACM comprised of two sheets of smooth .020" aluminum thermobonded to a solid, fire retardant core. Developed exclusively to meet fire performance requirements while providing the benefits & versatility of ACM.

ALUCOBOND® AXCENT™

A solid .040" flat aluminum sheet that offers the perfect complement to ALUCOBOND PLUS. AXCENT is excellent for columns, parapet caps, canopies, soffits, and trim.



Product Properties

Fire Retardant (FR) core

| Thickness of aluminum skin | 0.020" (nominal) |
|----------------------------|-------------------------|
| Product thickness | 0.157" (4mm nominal) |
| Weight | 1.56 lb/ft² |
| Standard panel dimension* | 62" x 196" |
| Maximum width** | 62" |
| Maximum length** | 400" |

^{*} Exceptions to standard dimensions include mirror, print, and others. Refer to product range table on next page. ** Sheets will be fabricated to meet custom panel sizes within product range above.

Product Properties

| Product thickness | 0.040" (nominal) |
|-------------------|---------------------|
| Weight | 0.56 lb/ft² |
| Standard width | 48" |
| Standard length | 120" |

ALUCOBOND® EasyFix™

ALUCOBOND EasyFix is a cost-effective installation method for wood-frame construction in multifamily and mixed-use sectors. The simple installation method utilizes an innovative design for attachment of ALUCOBOND PLUS panels. The design provides an aesthetic solution similar to traditional ACM systems.

ALUCOBOND EasyFix must be used with:

- ALUCOBOND PLUS
- ALUCOBOND EasyFix: Clips or Rails



Product Properties

| Weight | 1.9 lb/ft² |
|----------------------------|-------------|
| Weight | 1.56 lb/ft² |
| Standard panel dimension* | 40" x 196" |
| Maximum panel width/length | 62"/400" |
| Clip length | 3" |
| Rail length | 12′ |

^{**} Sheets may be fabricated to meet custom panel sizes within maximum product range above.

Pella® Reserve™

Contemporary Clad/Wood



Simple and sophisticated designs that embody the tenets of pure, contemporary style.

Interior



Exterior



• Easy-to-learn Pella Steady Set™ interior installation system

Pella Steady Set Interior Installation System is a revolutionary, award-winning and safer way to install new construction windows.¹ The simple system is the fastest, most labor efficient wood window installation system with uncompromising quality.² Available on select windows.

· Clean lines

Bring your vision to life with expansive glass options combined with some of the narrowest sightlines in the industry.

· Modern hardware

Our renowned, exclusive hardware has set the bar for the industry. Featuring sleek lines, the Saldo foldaway crank adds the perfect finishing touch.

Architectural interest

Our industry-leading modern designs with through-stile construction deliver a clean sash joint with pure, 90-degree exteriors. Square grille profiles provide another layer of design flexibility.

· Virtually unlimited customization

If you can dream it, we can build it with our most customizable product line. From extra tall to extra wide, Pella can craft unique windows that complement your aesthetic. Custom sizes, grille patterns and designs, finishes, wood types and glass options are available.

• Tailor-made solutions

From preliminary drawings to installation, Pella's expert team of architects, engineers, drafters and consultants can work to deliver custom window and door solutions for your project. Partner with Pella to achieve your unique vision without concessions.

Cutting-edge innovation

Our intentional innovations solve modern-day inconveniences without compromising on design. Preserve the beauty of Pella Reserve windows and doors while protecting what matters most with integrated security sensors.

• Durable interiors and extruded aluminum exteriors

To help save you time on the jobsite, interior finish options are available in a variety of paints, stains and primed and ready to paint. To complement your exterior aesthetic, choose from our carefully curated color palette or define your own custom color for your project.

ENERGY STAR® certified¹

Pella wood products offer energy-efficient options that will meet or exceed ENERGY STAR guidelines in all 50 states.

• Testing beyond requirements

At Pella, our products are tested beyond requirements to help ensure they have long-lasting performance and reduce call-backs for you.

Best limited lifetime warranty²

Pella Reserve products are covered by the best limited lifetime warranty in the business for wood windows and patio doors.²

Available in these window and patio door styles:



Special shape windows also available.

12 See back cover for disclosures

Product Specifications

| | | | | | | Per | rformance Val | ues | |
|--------------------------------------|---------------|----------------|---------------|----------------|------------------------------|-----------|---------------|-----------|---|
| Window & Patio Door Styles | Min. Width | Min. Height | Max. Width | Max. Height | Performance Class & Grade | U-Factor | SHGC | STC | Frame / Install |
| Awning | 13-3/4" | 13-3/4" | 73" | 73" | LC30-CW50 | 0.19-0.48 | 0.15-0.55 | 26-34 | |
| Casement | 13-3/4" | 13-3/4" | 47" | 108" | R30-CW50 | 0.19-0.48 | 0.15-0.54 | 26-34 | Pella Steady Set™, Fold-out Fin, Block Frame, EnduraClad Exterior Trim / Brickmould |
| Fixed Casement/Fixed Awning | 10" | 13-3/4" | 144" | 144" | CW30-CW50 | 0.16-0.50 | 0.16-0.50 | 28-33 | |
| In-Swing Hinged Patio Door (Single) | 24" | 48" | 48" | 119-1/2" | LC40-LC55 | 0.25-0.29 | 0.14-0.40 | 31-35 | |
| In-Swing Hinged Patio Door (Double) | 48" | 79-1/2" | 96" | 119-1/2" | LC40-LC55 | 0.25-0.29 | 0.14-0.40 | 31-35 | |
| Out-Swing Hinged Patio Door (Single) | 24" | 48" | 48" | 119-1/2" | LC40-LC70 | 0.25-0.30 | 0.14-0.39 | 30-36 | |
| Out-Swing Hinged Patio Door (Double) | 48" | 48" | 96" | 119-1/2" | LC40-LC70 | 0.25-0.30 | 0.14-0.39 | 30-36 | Fold-out Fin, Block Frame, EnduraClad Exterior Trim / Brickmould, |
| Sliding Patio Door (OX, XO) | 60" | 74" | 120" | 120" | R20-LC50 | 0.26-0.31 | 0.20-0.51 | 0.28-0.33 | |
| Sliding Patio Door (OXO) | 90" | 74" | 180" | 120" | R20-LC35 | 0.26-0.31 | 0.20-0.51 | _ | |
| Sliding Patio Door (OXXO) | 117" | 74" | 237" | 120" | R20-LC35 | 0.26-0.31 | 0.20-0.51 | _ | |
| Multi-Slide Patio Door | 41-7/8" | 50-1/2" | 713-5/8" | 119-1/2" | R15-LC25 ³ | 0.30-0.36 | 0.15-0.46 | 31 | For more info visit |
| Bifold Patio Door | 32-1/8" | 41" | 425-7/8" | 119-1/2" | R15-LC25 ³ | 0.26-0.44 | 0.13-0.45 | _ | PellaADM.com |

Window sizes available in 1/8" increments

Grilles

Integral Light Technology^{®4}

Choose the look of true divided light or make cleaning easier by selecting grilles-between-the-glass.









Square 5/8"


Square 7/8"

Square 11/4"

3,4 See back cover for disclosures.

Attention to Detail

Cross Sections The venting casement cross sections provide visual reference to the squared-off profile on both the lock and hinge jamb and the consistent sightline this will provide from interior through to exterior.

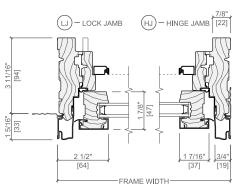

Optional Fold-Out Installation Fin

Window Hardware

Modern Collection

Achieve the ultimate contemporary look with exclusive hardware designed by Pella. Our renowned modern hardware has set the bar for the industry. Featuring sleek lines, the Saldo fold-away crank adds the perfect finishing touch.



Fold-away Crank



Patio Door Hardware

Modern Collection

Select modern hardware created in collaboration with Baldwin® to achieve the ultimate contemporary look with sleek finishes.


BALDWIN



Hinged & Bifold Sliding & Multi-Slide Patio Door Handle



Multi-Slide Patio

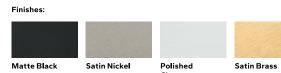

Essential Collection

Elevate your style and transform a home with elegant selections.








Standard

Door Handle^{5, 6}







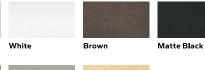



Additional hardware collections available. Visit PellaADM.com for more information

5,6,7 See back cover for disclosures

Colors

Wood Types

Choose the wood species that best complements your project's interior.

Douglas Fir













Pine

Mahogany

White Oak

Red Oak

Cherry

Maple

Prefinished Pine Interior Colors

Custom interior finishes, unfinished or primed and ready-to-paint are also available.















Golden Oak Stain

Early American

Provincial Stain

Dark Mahogany Stain

Charcoal Stain Black Stain

Extruded

Our low-maintenance EnduraClad® exterior finish resists fading. Take durability one step further with EnduraClad Plus which also resists chalking and corrosion.7



Aluminum-Clad **Exterior Colors**



Screens

Rolscreen®

Rolscreen soft-closing retractable screens roll out of sight when not in use. Available on casement windows.

Integrated Rolscreen®

A concealed retractable screen that moves seamlessly with the sash of a single- or double-hung window appearing when you open the window and rolling out of sight when you close it.

TuffScreen® by Phifer*

The TuffScreen® is 2.5x stronger than a standard screen.8 It is tear, puncture and damage resistant, standing up to pets, children and harsh weather. Available on sliding patio doors.

*All trademarks are property of their respective owners

Flat

InView™ screens are clearer than conventional screens and come standard.




The Best Limited Lifetime Warranty in the Industry

We know your reputation matters and you stake your reputation on quality, dependable products. That's why we have the best limited lifetime warranty in the industry for wood windows and patio doors.²

- Some Pella products may not meet ENERGY STAR® guidelines in Canada. For more information, contact your local Pella sales representative or go to energystar.gc.ca.

 Based on comparing written limited warranties of leading national wood window and wood patio door brands. See
- written limited warranty for details, including exceptions and limitations, at pella.com/warranty or contact Pella Customer Service
- Ratings are contingent on product configurations
- Color-matched to your product's interior and exterior color. Offering may vary by product type. See Pella sales representative for details.
- Flush multi-slide handle is a Pella exclusive design.
- Flush multi-slide handle is not available in Champagne
- EnduraClad Plus protective finish is not available with all colors. See your local Pella sales representative
- 8 Based on the composite results of a 5-panel strength analysis comparing TuffScreen and standard screening.

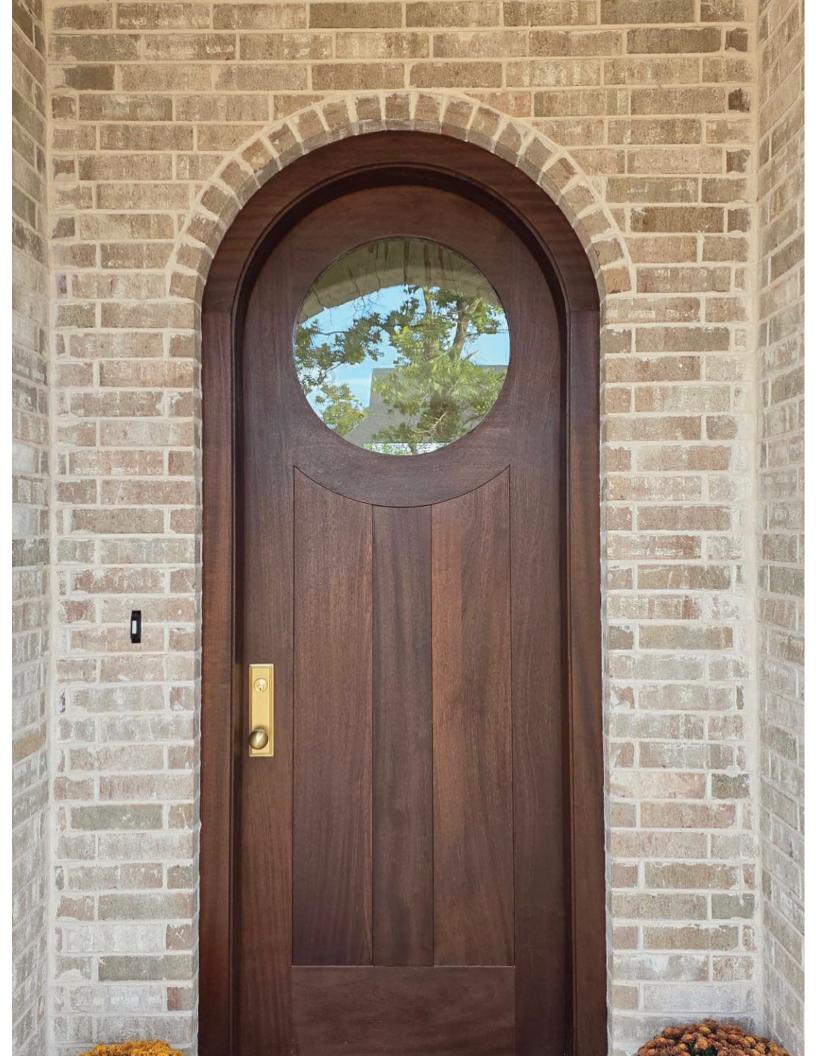



15 Reardon Road - Medford, MA - 02155

Tel.: (781) 396-0070 - Fax: (781) 396-8890



Radius Gutters / Curved Gutters

Custom made to order - Inside and outside curved gutters


Riverside Sheet Metal specializes in the custom fabrication of radius gutters.

The most common profiles are half-round, k-style, box and brownstone gutters, but we can also manufacture custom designed gutter liners and radius gutter liners.


Radius gutters, or curved gutters can most times be manufacture to accommodate regular hangers, or to have custom made hangers installed. Riverside can also pre-install hangers, outlets and end caps.

To have a radius gutter made, we need to know the profile of the curved gutter, the radius of the arc (if not exact, please provide us with a rigid template), if it's an **inside or outside radius** and the material for the gutter (normally copper or aluminum).


Radius gutters are **normally fabricated all in one piece** (5" and 6" k-style, brownstone, box and half round). Additionally, gutters with custom profiles may be manufactured in different lengths. On those, all seams are thoroughly soldered on copper gutters, ensuring a long lasting joint, while the same are riveted on aluminum gutters.

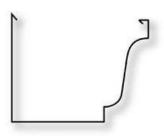


5" & 6" k-style radius gutter Up to 11' lengths

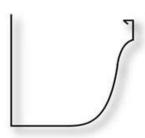


5" & 6" brownstone radius gutter (Example) Up to 11' lengths

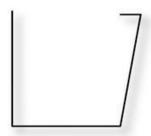

5" & 6" simple box radius gutter (Example) Up to 11' lengths

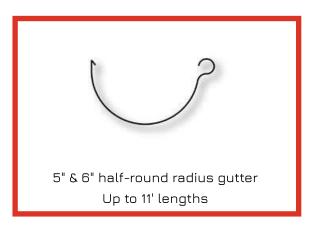

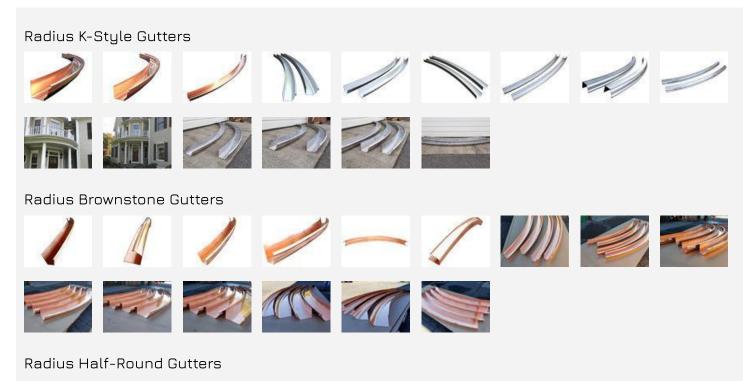

Project Address: 134 Pleasant Street

Permit Requested: Work Session

Application: Work Session A

A. Property Information - General:

Existing Conditions:

• Zoning District: Character District 4 (CD4)

Land Use: <u>Commercial</u>
Land Area: 1.15 Acres +/-

• Estimated Age of Structure: <u>c.1947 rebuilt in</u>

<u> 1978</u>

• Building Style: <u>Modern</u>

• Number of Stories: 1

• Historical Significance: Not Contributing

• Public View of Proposed Work: <u>Pleasant Street</u>

• Unique Features: <u>N/A</u>

• Neighborhood Association: The South End

B. Proposed Work: Exterior renovations and additions

C. Staff Comments and/ or Suggestions for Consideration:

The project proposal includes the following:

• Exterior renovation and additions





HISTORIC SURVEY RATING NC

D. Purpose and Intent:

- 1. Preserve the integrity of the District
- 2. Assessment of the Historical Significance
- 3. Conservation and enhancement of property values
- 4. Maintain the special character of the District
- 5. Complement and enhance the architectural and historic character
- 6. Promote the education, pleasure and welfare of the District and the city residents and visitors

E. Review Criteria/Findings of Fact:

- 1. Consistent with special and defining character of surrounding properties
- 2. Compatibility of design with surrounding properties
- 3. Relation to historic and architectural value of existing structures
- 4. Compatibility of innovative technologies with surrounding properties

PROJECT NARRATIVE

Renovations and additions to the structure on Map 0116 Lot 30, with address 134 Pleasant Street. The first floor will be banking and commercial tenant. The second floor will be residential apartments. The basement will be repurposed from storage, to become an underground parking garage.

Revisions since last work session include:

- The new building is now completely independent and not connected to the existing building.
- Removed the bridge connector between old and new buildings existing drive through canopy will remain.
- Adjusted heights and scale of trim, fenestration
- Details masonry, siding, and window details
- Entries further developed
- Materials preliminary selections
- Existing Building -
- 1. Shifted main entrance to center of facade (in existing location)
- 2. Reconfigure rooftop penthouse Changed lounges with shared green roof, to apartments with private decks.
- New Building -
- 1. Dormers refinement of oculus details
- Hardscape and Landscaping plantings added, retaining wall, railing and steps along Pleasant Street

| | | DRAWING INDEX |
|---------|----------------|---------------|
| Sheet # | | Sheet Name |
| | | |
| H0.0 | COVER SHEET | |
| | CONTENT DI ANI | |

| H0.0 | COVER SHEET |
|--------|---------------------------|
| H0.1.1 | CONTEXT PLAN |
| H1.00 | SITE PLAN EXISTING & DEMO |
| H1.01 | SITE PLAN PROPOSED |
| H2.01 | EXISTING ELEVATIONS |
| H2.02 | EXISTING ELEVATIONS |
| H2.10 | SITE SECTIONS |
| H2.11 | SITE SECTIONS |
| H2.20 | FRONT ELEVATIONS |
| H2.21 | REAR ELEVATIONS |
| H3.01 | RENDERINGS |
| H3.02 | RENDERINGS |
| H3.03 | RENDERINGS |
| H3.04 | VIGNETTE |
| H3.05 | VIGNETTE |
| H3.06 | BIRDSEYE AXONOMETRIC |
| H4.01 | MATERIALS |
| H4.02 | DETAIL |
| | |



134 PLEASANT STREET

RENOVATION AND ADDITION
HISTORIC DISTRICT COMMISSION
WORK SESSION 3 - REVISED

H0.0


COVER SHEET


134 PLEASANT STREET

PORTSMOUTH, NH 03801




11/25/2025

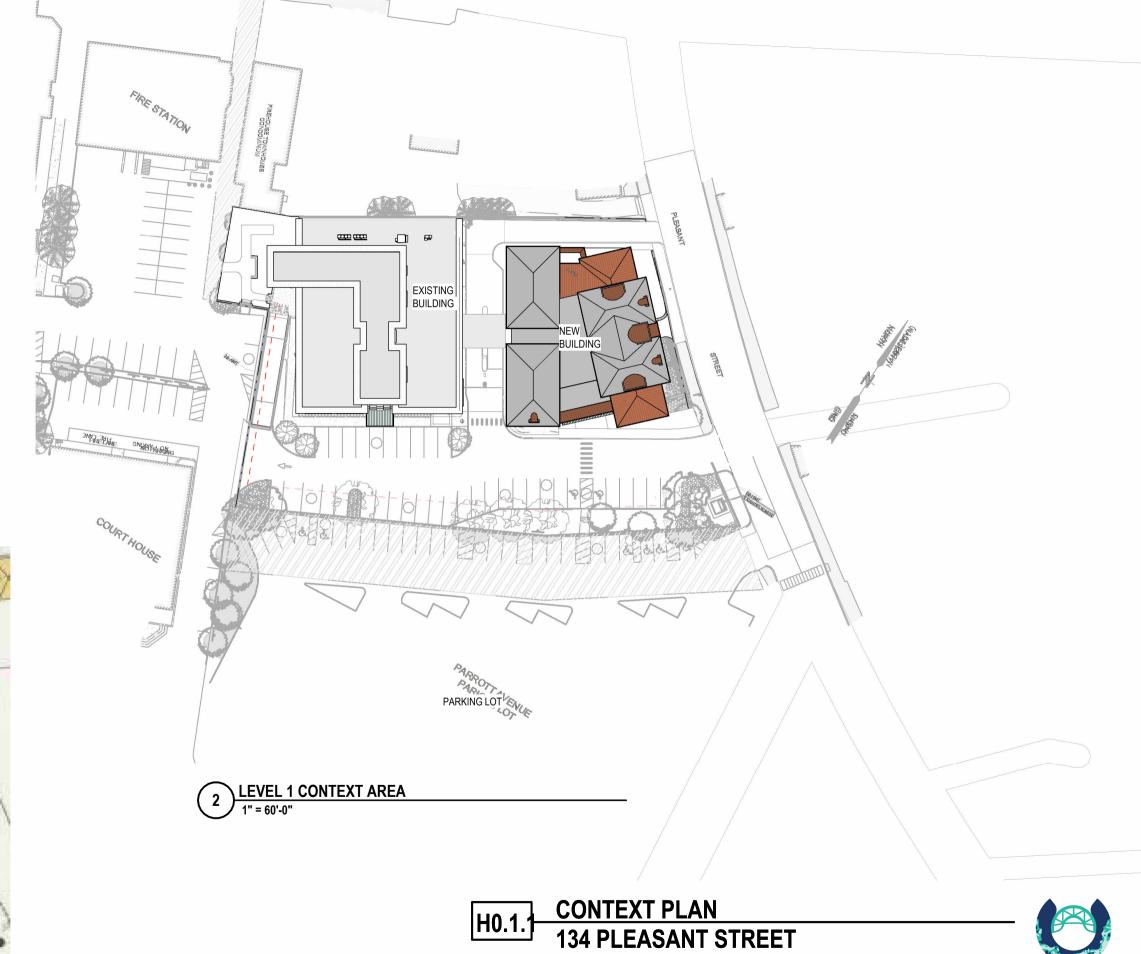

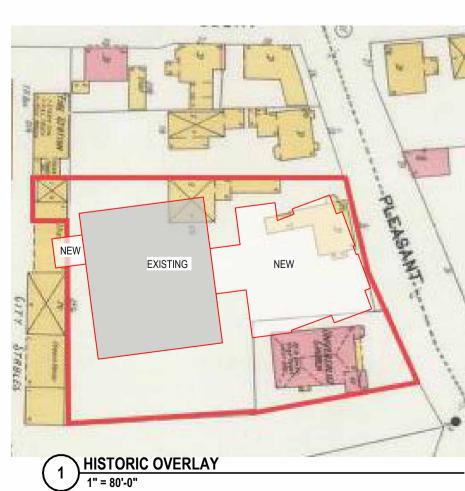

11/25/2025


PORTSMOUTH, NH 03801

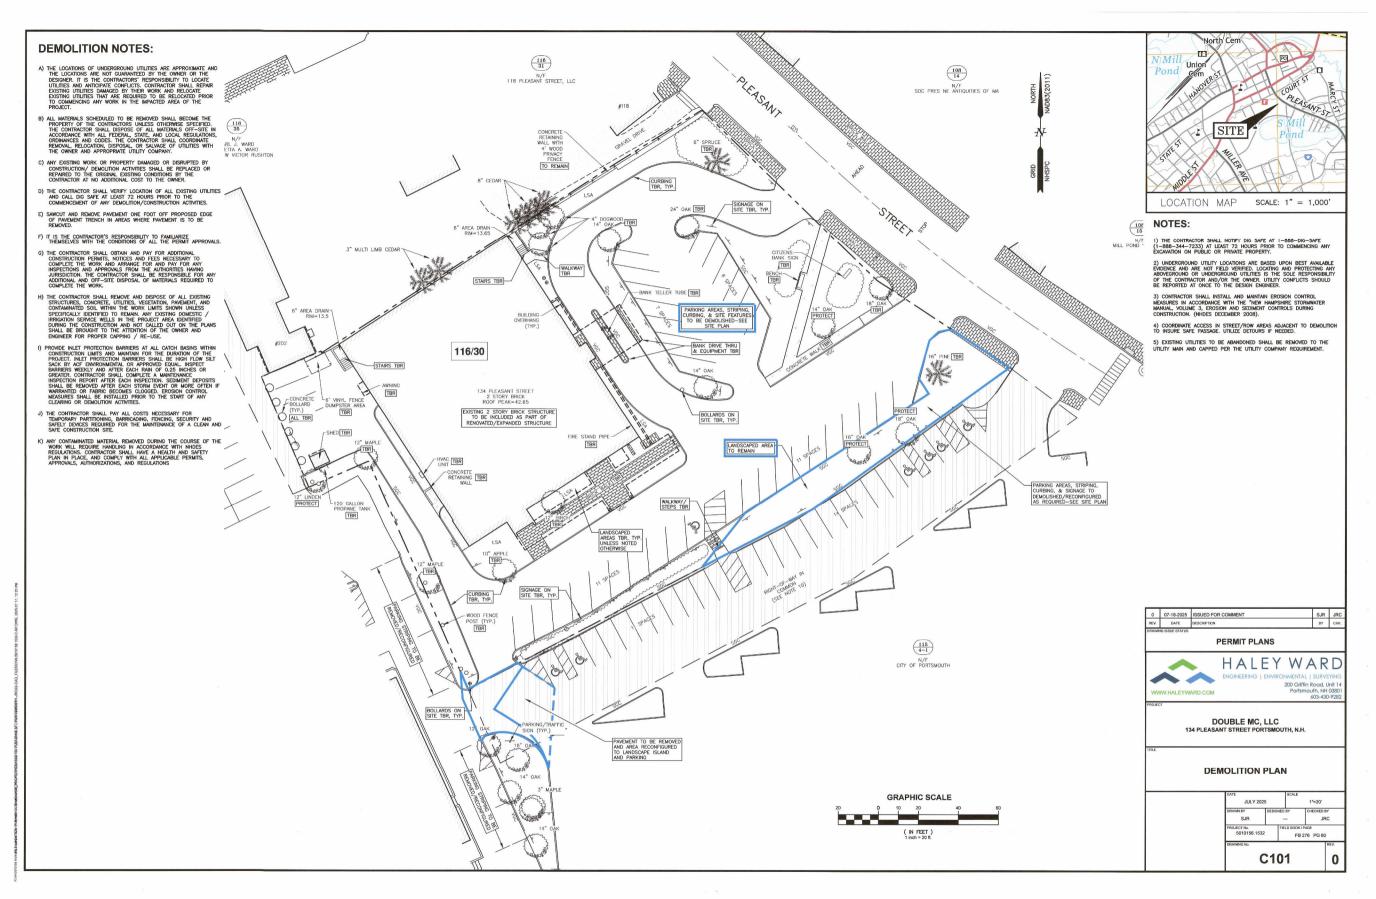


H1.00 SITE PLAN EXISTING & DEMO

134 PLEASANT STREET PORTSMOUTH, NH 03801



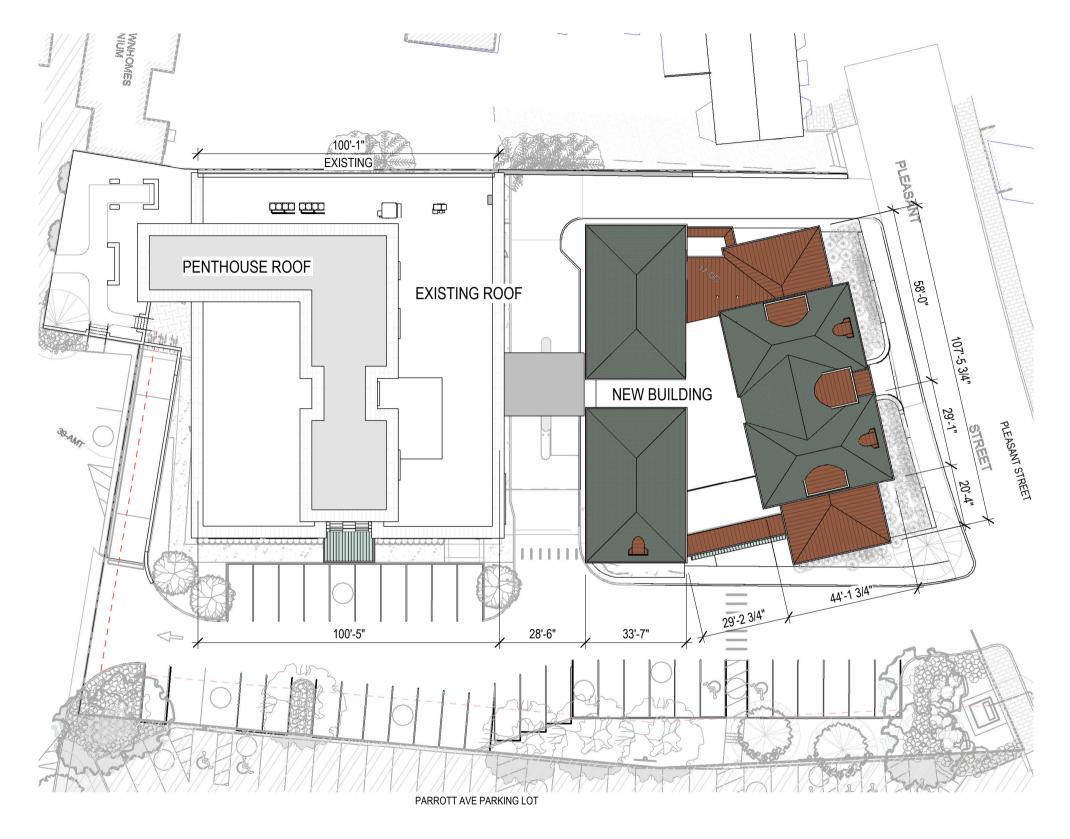



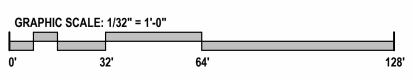





SITE PLAN PROPOSED

134 PLEASANT STREET
PORTSMOUTH, NH 03801



| RECOMMENDATION | | | |
|----------------|---|--|--|
| | Remove chimney | | |
| <u>)</u> | Remove EPDM covered Pyramid. | | |
| 3 | Remove existing canopy at the east south elevation | | |
| 1 | Remove door. | | |
| 5 | Remove window. | | |
| 3 | Remove part of the wall for the new additon. | | |
| 7 | Remove the existing bank teller canopy. Replace with new bridge addition. | | |
| 3 | Remove existing black band at the corner of east south and east north corner. | | |
|) | New Windows | | |
| 10 | Remove existing Cladding and rectad with new materials, refer to the elevation drawings | | |

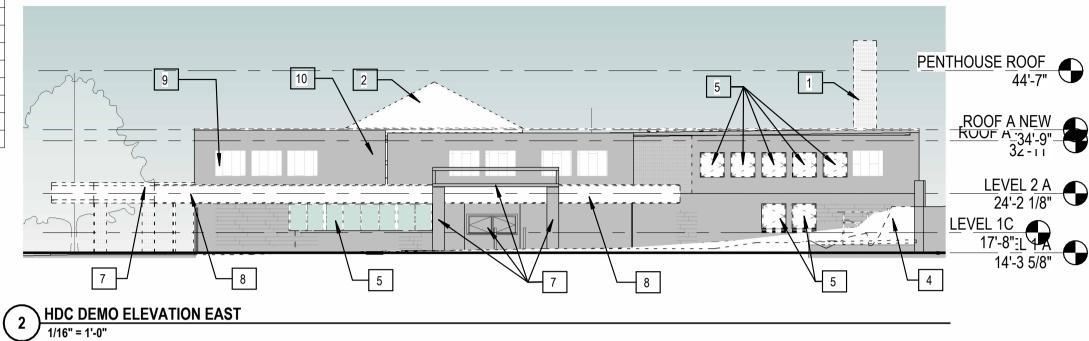

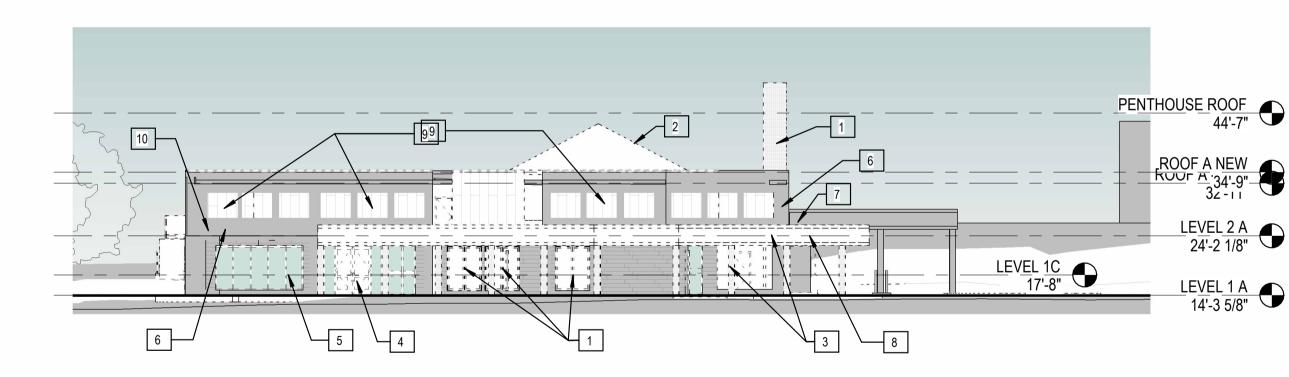


1) HDC DEMO ELEVATION SOUTH


H2.01 EXISTING ELEVATIONS
134 PLEASANT STREET
PORTSMOUTH, NH 03801



| RECOMMENDATION | | | |
|----------------|--|--|--|
| 1 | Remove chimney | | |
| 2 | Remove EPDM covered Pyramid. | | |
| 4 | Remove door. | | |
| 5 | Remove window. | | |
| 6 | Remove part of the wall for the new additon. | | |
| 7 | Remove the existing bank teller canopy. Replace with new bridge addition. | | |
| 9 | New Windows | | |
| 10 | Remove existing Cladding and reclad with new materials, refer to the elevation drawings. | | |

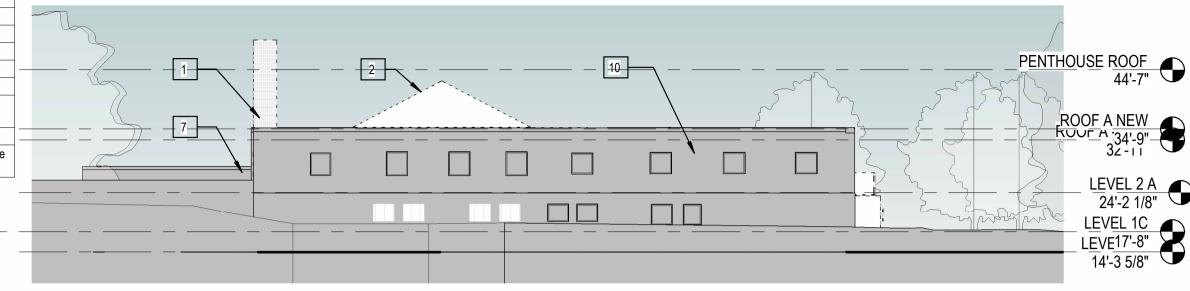

2 HDC DEMO ELECVATION NORTH
1/16" = 1'-0"

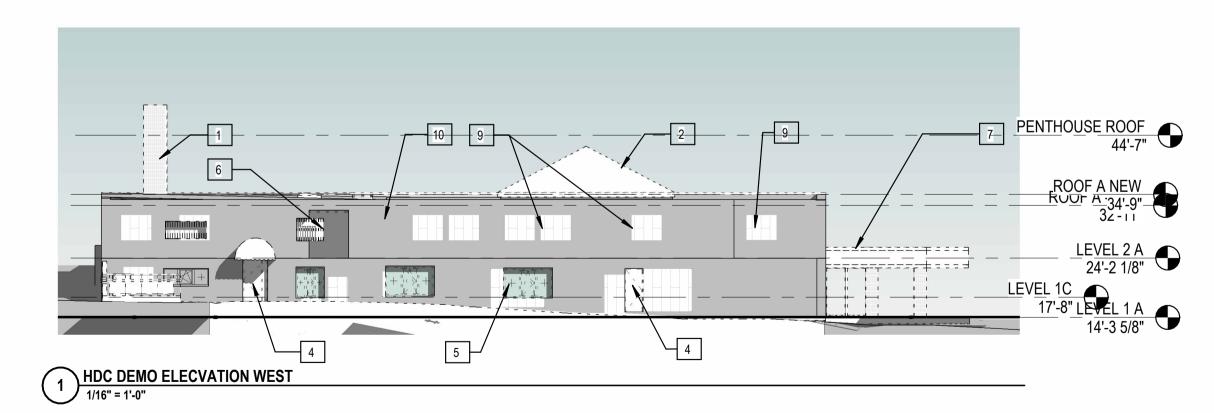

H2.02 EXISTING ELEVATIONS
134 PLEASANT STREET
PORTSMOUTH, NH 03801





SECTION THROUGH PLEASANT STREET (EAST ELEVATION)

1" = 40'-0"



SECTION THROUGH JOHN LANGDON PROPERTY (EAST ELEVATION BEYOND)




SOUTH SITE SECTION

1" = 40'-0"

H2.10 SITE SECTIONS

134 PLEASANT STREET PORTSMOUTH, NH 03801



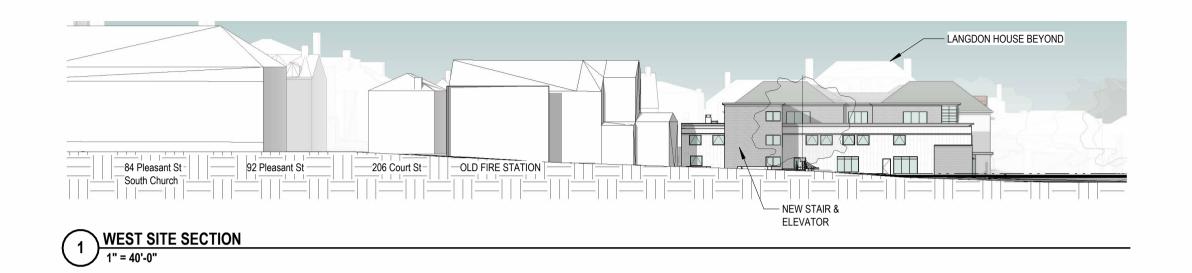



NORTH SITE SECTION

H2.11

SITE SECTIONS

134 PLEASANT STREET PORTSMOUTH, NH 03801









WHITE GRANITE **ZINC PANELS GLAZED BRICK** FIBER CEMENT

H2.20

FRONT ELEVATIONS 134 PLEASANT STREET PORTSMOUTH, NH 03801





) NORTH ELEVATION 1/16" = 1'-0"



NEW **ELEVATION KEY NOTES** WHITE GRANITE **ZINC PANELS GLAZED BRICK** FIBER CEMENT **PANELS**

EXISTING

WEST ELEVATION 1/16" = 1'-0"

REAR ELEVATIONS 134 PLEASANT STREET PORTSMOUTH, NH 03801





VIEW FROM PLEASANT STREET AT TREADWELL HOUSE

H3.01

RENDERINGS 134 PLEASANT STREET PORTSMOUTH, NH 03801





VIEW FROM LANGDON HOUSE



VIEW FROM PLEASANT STREET AT JUNKINS AVENUE

H3.02 RENDERINGS
134 PLEASANT STREET
PORTSMOUTH, NH 03801







VIEWS FROM JUNKINS AVENUE

H3.03

RENDERINGS 134 PLEASANT STREET PORTSMOUTH, NH 03801





VIEW FROM PLEASANT STREET AT TREADWELL HOUSE

H3.04

VIGNETTE 134 PLEASANT STREET PORTSMOUTH, NH 03801





HDC PERSPECTIVE 03




VIEW FROM BEHIND COURT HOUSE hdc

H3.05 VIGNETTE

134 PLEASANT STREET
PORTSMOUTH, NH 03801



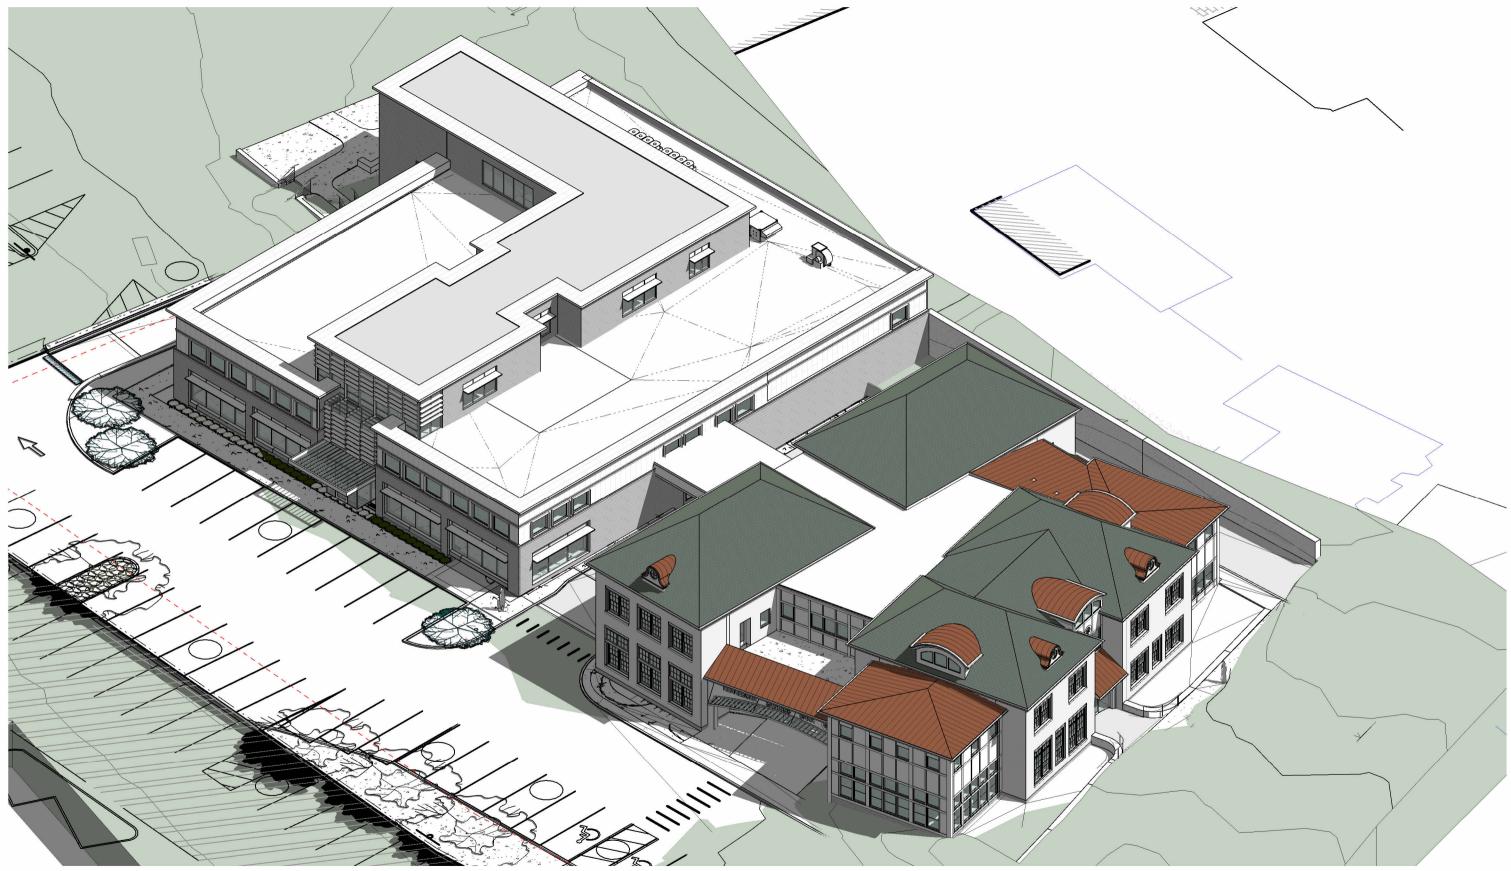

1 HDC BIRDSEYE SE

H3.06 BIRDSEYE AXONOMETRIC
134 PLEASANT STREET
PORTSMOUTH, NH 03801







GLAZED CLAY BRICK GLEN GERY COLOR: APRICOT ROSE STANDARD SIZE 3 5/8"X2 1/4"X8"



ZINC COMPOSITE PANELS RECESSED SEAM



GRANITE BETHEL WHITE THERMAL FINISH



FIBER CEMENT PANELS & TRIM AFC - DECO COLOR: IVORY FINISH: SMOOTH



ROOFING SYNTHETIC SLATE ECOSTAR 12" TRADITIONAL

WINDOWS

AT NEW ADDITION, BRICK AREAS
PELLA RESERVE – TRADITIONAL
ALUMINUM CLAD WOOD
EXTERIOR COLOR: BROWN
SDL - PUTTY PROFILE





AT NEW ADDITION, PANELED AREAS
KOLBE VISTALUXE - ACCENT
ALUMINUM CLAD WOOD
COLOR: ANODIZED-DARKBRONZE







H4.01


MATERIALS

134 PLEASANT STREET PORTSMOUTH, NH 03801



11/25/25



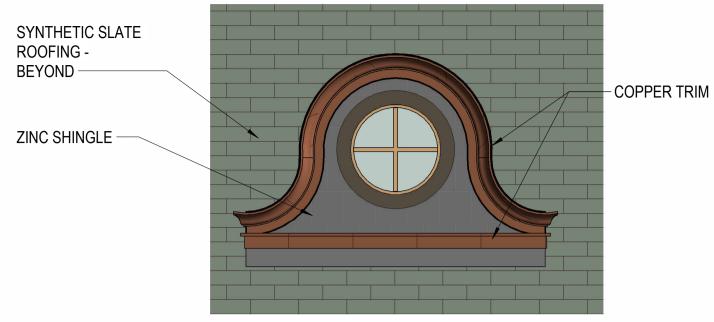

1) ELEVATION OCULUS DORMER
1/2" = 1'-0"



2 ELEVATION DORMER
1/2" = 1'-0"

H4.02

DETAIL

134 PLEASANT STREET PORTSMOUTH, NH 03801



Project Address: 77 State Street, Unit #202

Permit Requested: Work Session

Application: Work Session 1

A. Property Information - General:

Existing Conditions:

• Zoning District: Character District 5 (CD5)

Land Use: <u>Mixed-Use</u>Land Area: 0 SF +/-

• Estimated Age of Structure: <u>c.2015</u>

Building Style: <u>Mansard</u>Number of Stories: 4

• Historical Significance: <u>N/A</u>

• Public View of Proposed Work: <u>State Street</u>

• Unique Features: N/A

• Neighborhood Association: <u>Downtown</u>

B. Proposed Work: Enclose the existing second story outdoor patio space.

C. Staff Comments and/ or Suggestions for Consideration:

The project proposal includes the following:

• Enclose the existing outdoor patio space.







D. Purpose and Intent:

- 1. Preserve the integrity of the District
- 2. Assessment of the Historical Significance
- 3. Conservation and enhancement of property values
- 4. Maintain the special character of the District
- 5. Complement and enhance the architectural and historic character
- 6. Promote the education, pleasure and welfare of the District and the city residents and visitors

E. Review Criteria/Findings of Fact:

- 1. Consistent with special and defining character of surrounding properties
- 2. Compatibility of design with surrounding properties
- 3. Relation to historic and architectural value of existing structures
- 4. Compatibility of innovative technologies with surrounding properties



Bonin Architects
210 Main Street, PO Box 2511,
New London, New Hampshire 03257
603.526.6200

11 STATE STREET, UNIT 202


PORTSMOUTH, NH

Sheet Title: WORK SESSION PG*1 PROJECT LOCATION
Scale: Date: 11.14.2025

PORTSMOUTH, NH

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PORTSMOUTH, NH

Sheet Title: WORK SESSION PG*3 EXISTING/DEMO PLAN
Scale: 3/16"= 1'-0" Date: 11.14.2025
Sketch Number: WSO3

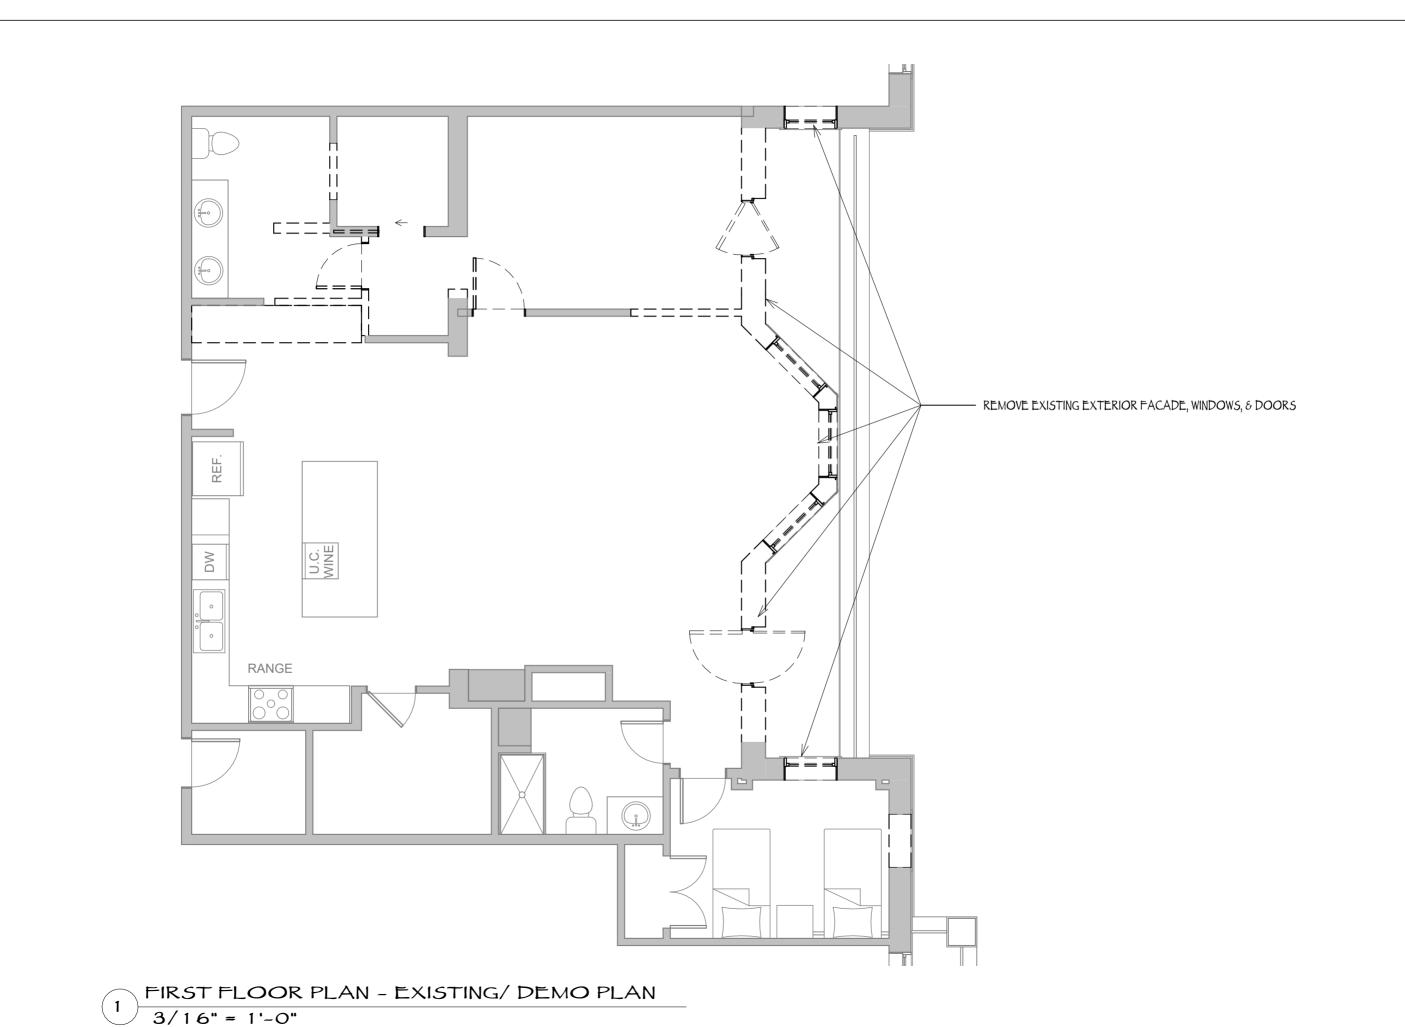202

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STATE STREET, UNIT PORTSMOUTH, NH

202

11.14.2025

Sheet Title: WORK SESSION PG#4 - PLAN
PROPOSED
Scale: 3/16" = 1'-0" Date: 11.14.2025
Sketch Number: WSO4

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Sheet Title: WORK SESSION PG#5 ELEVATION PROPOSED
Scale: 1/8" = 1'-0" Date: 11.14.2025
Sketch Number: WS05

STATE STREET, UNIT

SCOPE OF WORK

EAST ELEVATION - PROPOSED 1/8" = 1'-0"





202 STATE STREET, UNIT

WORK SESSION PG#6 - 3D VIEW PROPOSED Date:

Sheet Title:

PORTSMOUTH, NH

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STATE STREET, UNIT 202

Sheet Title: WORK SESSION PG#1 - 3D VIEW PROPOSED

Date: 11.14.2025

PORTSMOUTH, NH

Bonin Architects
210 Main Street, PO Box 2511,
New London, New Hampshire 03251
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Project Address: 30 Walden Street

Permit Requested: Work Session

Application: Work Session 2

A. Property Information - General:

Existing Conditions:

• Zoning District: Waterfront Business (WB)

Land Use: <u>Residential</u>Land Area: 12,651 SF +/-

• Estimated Age of Structure: c.1880

• Building Style: <u>Vernacular/ Queen Anne</u>

• Number of Stories: <u>1.5</u>

• Historical Significance: Contributing

• Public View of Proposed Work: Walden Street

• Unique Features: <u>N/A</u>


• Neighborhood Association: <u>The South End</u>

B. Proposed Work: Expand existing connector hallway to provide more interior living space.

C. Staff Comments and/ or Suggestions for Consideration:

The project proposal includes the following:

Expand existing connector hallway.

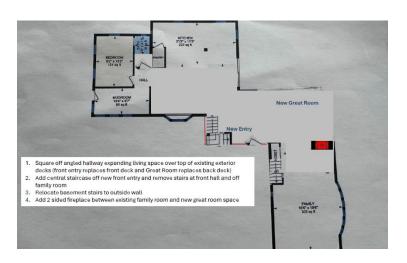



HISTORIC SURVEY RATING

D. Purpose and Intent:

- 1. Preserve the integrity of the District
- 2. Assessment of the Historical Significance
- 3. Conservation and enhancement of property values
- 4. Maintain the special character of the District
- 5. Complement and enhance the architectural and historic character
- 6. Promote the education, pleasure and welfare of the District and the city residents and visitors

E. Review Criteria/Findings of Fact:


- 1. Consistent with special and defining character of surrounding properties
- 2. Compatibility of design with surrounding properties
- 3. Relation to historic and architectural value of existing structures
- 4. Compatibility of innovative technologies with surrounding properties

30 Walden St, Portsmouth, NH

CURRENT LAYOUT

family room

Main Floor Finished Area 1426.05 sq ft

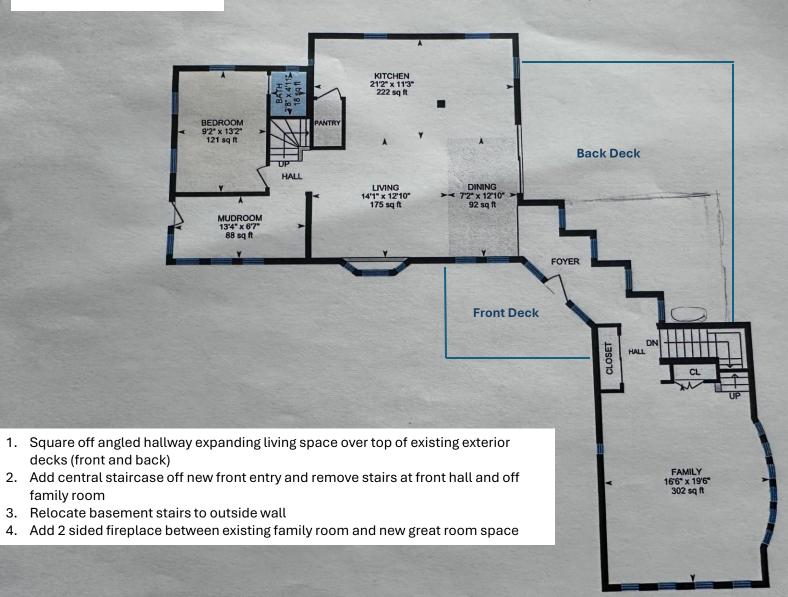


30 Walden St, Portsmouth, NH

PROPOSED CONCEPTUAL LAYOUT

family room

Main Floor Finished Area 1426.05 sq ft

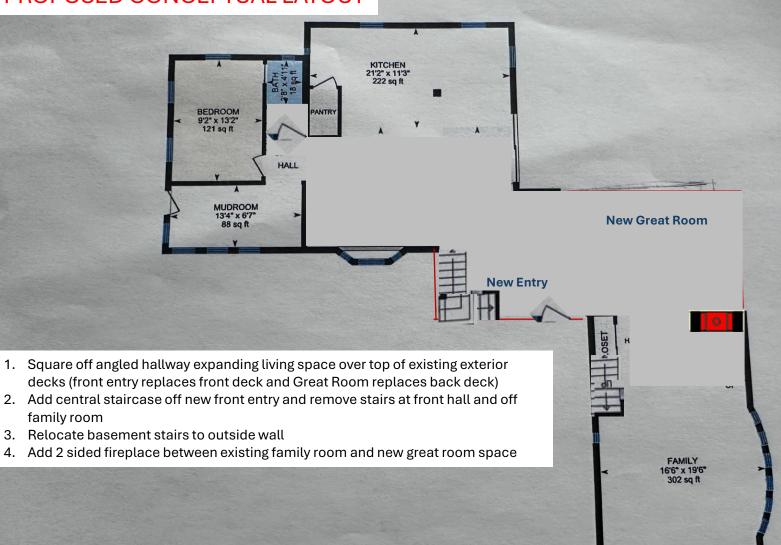

CURRENT LAYOUT

30 Walden St, Portsmouth, NH

Floor Finished Area 711.32 sq ft
Unfinished Area 449.19 sq ft

PROPOSED CONCEPTUAL LAYOUT

