

85 Portsmouth Avenue, PO Box 219, Stratham, NH 03885 603.772.4746 - JonesandBeach.com

June 23, 2021

Portsmouth Planning Board Attn: Dexter Legg 1 Junkins Avenue, Suite 3rd Floor Portsmouth, NH 03801

RE: Response Letter 3 – TAC Comments 375 Banfield Road, Portsmouth, NH Tax Map 266, Lot 7 JBE Project No. 19190.2

Dear Mr. Legg,

We are in receipt of comments from Jillian Harris dated June 1, 2021. Review comments are listed below with our responses in bold.

1. Please provide a green building statement consistent with the requirements of Section 2.5.3.1A of the Site Review Regulations.

RESPONSE: A Green Building Statement is included along with this response letter.

2. On your checklist, you indicate that you are requesting a waiver to a number of the Site Review requirements. Please provide an updated waiver letter along with justification for why the waivers are justified.

RESPONSE: The waiver requested for Section 2.5.4.3(b) for architectural design is no longer needed as we are submitting architectural plans along with this submission.


- 3. Please verify if you will be using irrigation for any of the proposed landscaping areas. RESPONSE: It is possible that irrigation will be used, and Note #18 on Sheet L1 states that an irrigation piping system shall be reviewed and approved by the owner and engineer prior to installation.
- 4. Please provide will-serve letters from utility companies.
 RESPONSE: Commitment to serve letter from Unitil has been received for the gas service. Letters from the City of Portsmouth Water Department and Eversource are pending but correspondence has been initiated.
- 5. Please advise on the status of your state permits.

 RESPONSE: The State permits have been submitted and are pending approval from NHDES.

- 6. Stormwater treatment in the wetland buffer will require a wetland conditional use permit. Given the redesign of the project please explore opportunities to get all of the treatment outside of the wetland buffer as part of the initial site design.
 RESPONSE: The stormwater system is designed as small as it can be and impacts in the buffer are temporary. The Conservation Commission voted to approve the project at the 6/9/21 meeting with the condition that we re-vegetate disturbed areas adjacent to the wetlands with wildflower seed mix.
- 7. Based on a video count conducted at the intersection of Banfield Road and Constitution Ave in December 2020, there was a total of 109 heavy vehicles on the section of Banfield Road north of Constitution Ave between the hours of 6 AM and 6 PM. Heavy vehicles consist of single-unit trucks, articulated trucks, and buses. A review of the video reveals that the vast majority (over 90%) of the heavy vehicles were smaller single unit trucks. It is not clear from the traffic count data provided by the applicant as to the size of the trucks in their counts. Oftentimes any vehicle with more than 4 wheels or 2 axles will be considered a truck, thereby including many smaller single unit trucks, which increases the total number of vehicles classified as trucks. The proposed project is projected to add 50 trucks to Banfield Road north of Constitution Ave. It must be assumed that the proposed 50 trucks will likely be larger articulated trucks, as that is the standard to which the site plans have been designed. It is therefore likely that the number of larger, articulated trucks on this section of Banfield Road will more than double due to the proposed project.

RESPONSE: It is unlikely that all or even a substantial majority of the additional truck traffic from this site will be in the form of larger, articulated trucks like the WB-62 that was used as the design basis for the pavement. The WB-62 model was run as a worst-case scenario to determine the appropriate pavement radii and smaller delivery vehicles will probably be more frequent in traffic coming to and leaving the site.

The following diagram illustrates that the net truck impact on Banfield Road will be approximately +24 truck-trips per day (based on Pernaw & Co., Inc. memorandum dated 12/28/2020 for a warehouse use and an even trip distribution split between points north and south via Banfield Road).

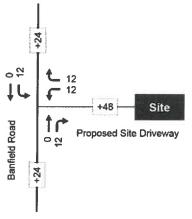



8. Construction of this new facility must be conformance to all State rules regarding the areas previously landfilled. Drainage and site details must be reviewed by third party engineer for accuracy and consistency with DES rules.

RESPONSE: The project has been designed with DES compliance in mind. There are four environmental concerns that will be addressed as follows:

- 1. Contaminants in soil related to historical use of the property as an automobile junkyard and recycling facility. All earth disturbance will be performed under the provisions of a Soil & Groundwater Management Plan (SGMP) that will be developed by Wilcox & Barton, Inc., stamped by a licensed Professional Engineer, and submitted to DES for approval. The plan will specify the proper handling and offsite disposal of contaminated soil and any solid wastes that are encountered during the work. Throughout the work, a Wilcox & Barton, Inc. field scientist will be on site to monitor implementation of the SGMP, assess for environmental conditions, and ensure implementation of an Environmental Health & Safety Plan designed to protect workers from site-related exposures. If required by DES, the SGMP will be incorporated into a Remedial Action Plan (also subject to DES approval) to facilitate the removal of contaminated soil.
- 2. The site is registered as a Closed Pre-1981 Landfill. Landfilled materials are permitted to remain as long as they are not disturbed. If manmade materials are encountered and must be disturbed as part of site grading, the materials will be removed, segregated, and disposed offsite. No other work is anticipated with respect to the closed landfill status.
- 3. Site drainage shall not be allowed to infiltrate through contaminated media. In accordance with Env-Wq 1507.02(c)(2)(b), stormwater shall not be infiltrated in areas that have soil contaminants at concentrations exceeding applicable soil quality standards. Site drainage has been designed to eliminate infiltration. This is a provision of the Alteration of Terrain Permit. No further DES involvement will be necessary on this matter.

Stormwater management during construction. The project will require coverage under the EPA NPDES Construction General Permit for the management of stormwater. A Stormwater Pollution Prevention Plan (SWPPP) will be prepared and implemented on the project to ensure that contaminated stormwater and sediment do not run off from the site while the permanent stormwater management system is being constructed.

9. As the City will have already reconstructed the road base and pavements, construction of shoulders on Banfield Road based on data and details to be provided by CMA will be the responsibility of the applicant prior to authorization of a CO. This includes all permitting and construction.

RESPONSE: The applicant is working with the City on the design of the shoulders of the road. The cost sharing portion still needs to be worked out based on the projected increase in truck traffic from our site.

10. All burlap and cages should be removed for landscape plants.

RESPONSE: See Note #22 on Sheet L1.



11. Can the right turn exit area be textured in a different material than pavement to diminish the visual impacts of the painted asphalt?

RESPONSE: We have modified the right turn exit area to be textured with pavers to differentiate with the standard asphalt.

12. Consideration should be given to add an outdoor seating area for employees either between the parking and the building or between the 100-foot buffer zones adjacent the proposed parking lot.

RESPONSE: Note #20 has been added to Sheet C2 discussing the location of the outdoor seating area if the company decides to have one.

13. Are there multiple loading docks and if so, the turning template should show how each dock would be accessed using the proposed pavement area.

RESPONSE: New truck turning templates have been added to Sheet T3 showing how different potential dock locations would be accessed.

Included with this response letter are the following:

- 1. Two (2) Revised Full Size Plan Set Folded.
- 2. One (1) Revised Half Size Plan Set Folded.
- 3. Elevations & Floor Plans.
- 4. Green Building Statement.
- 5. Commitment to Serve Letters.

Thank you very much for your time.

Very truly yours,

JONES & BEACH ENGINEERS, INC.

Jøseph Coronati Vice President

c: Rob Graham, Banfield Realty, LLC (letter and plans via email)

Jim Gove, Gove Environmental Services (letter and plans via email)

Bill Wilcox (letter and plans via email)

Peter Britz, City of Portsmouth (letter and plans via email)





85 Portsmouth Avenue, PO Box 219, Stratham, NH 03885 603.772.4746 - JonesandBeach.com

June 23, 2021

Portsmouth Planning Board Attn: Dexter Legg 1 Junkins Avenue, Suite 3rd Floor Portsmouth, NH 03801

RE: Green Building Statement 375 Banfield Road, Portsmouth, NH Tax Map 266, Lot 7 JBE Project No. 19190.2

Dear Mr. Legg,

The intent of this proposal is to construct a 75,000 S.F. industrial warehouse building with associated parking, loading, drainage, and utilities. Throughout the design process, low-impact solutions to site issues were considered and implemented. The orientation of the site with parking generally located south of the proposed building and on top of a fill slope ensures that the parking area receives maximum sunlight during the winter months, which will reduce the amount of salt that will need to be used. This being said, robust landscaping trees such as October Glory Red Maple, Pink Flowering Dogwood, and Greenspire Littleleaf Linden will ensure that the periphery of the parking area is shaded during the summer months, reducing the potential for a "heat island" in this area.

This site is already developed. The site has been previously used as a landfill and an auto salvage facility. The proposed design utilizes the minimum amount of new impervious surface practicable for the intended use. In the existing condition, there is significant impervious surface in the 100' wetland buffer which is being removed with this development. Post-construction, there will be almost no impervious surface within the wetland buffer. The temporary stockpile area and the areas adjacent to the wetland buffer will be restored with a wildflower seed mix. The constraints were the size of the building, the necessity for a loading area that can be used by WB-62 trucks for delivery, and the City of Portsmouth's parking requirements. The addition of impervious surface causes the potential for increased rates of off-site runoff, so a stormwater management system was designed for this development to provide for treatment and detention of runoff. We are using low-impact solutions for treatment and detention, including small-footprint "Focal Point" biofiltration areas, PreTx curb inlet units for pre-treatment, a meadow buffer, and underground detention underneath pavement in lieu of a traditional pond. These systems will provide for treatment and detention of stormwater in a small footprint. The minimum amount of ground practicable will be disturbed with this development.

The building will meet or exceed the NH State energy code as amended by the City of Portsmouth that is in effect at the time of building permit application. It is anticipated that LED fixtures will be used for general lighting within the building and a "cool" membrane roof will be used. Limited

fenestration on the exterior walls will improve the performance of the exterior envelope. LEED certification is not anticipated at this time.

Very truly yours,
JONES & BEACH ENGINEERS, INC.

Daniel Meditz, E.I.T. Project Engineer





June 11th, 2021

Dan Meditz
Project Engineer | Jones & Beach Engineering Inc.

Will Serve Letter for 375 Banfield Rd, Portsmouth NH

Hi Dan,


Unitil/Northern Utilities Natural Gas Division has reviewed the requested site for natural gas service:

Unitil hereby confirms that natural gas is available to supply the proposed building located at 375 Banfield Rd in Portsmouth, NH.

Sincerely,

Dave MacLean Senior Business Development Rep

O Unitil

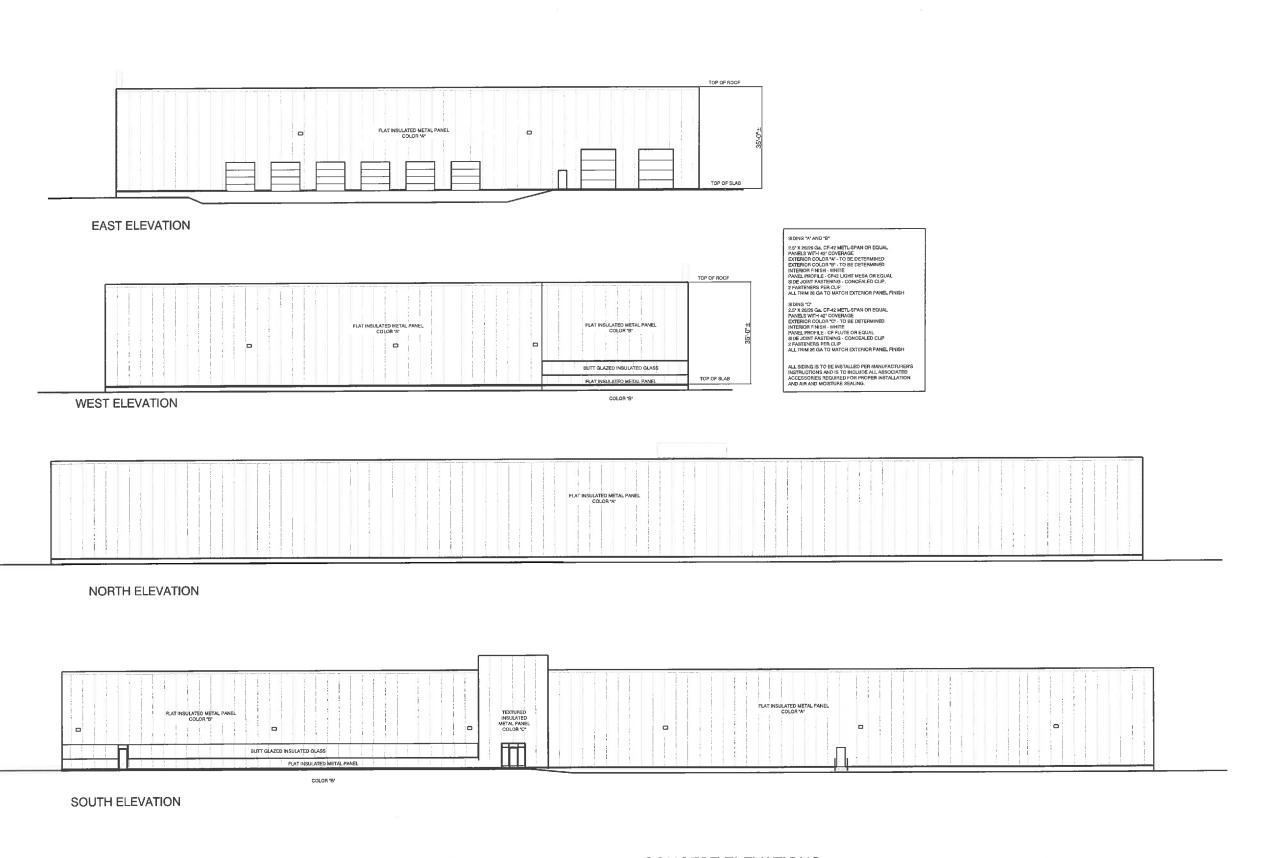

mjk Michael J. Keane

Michael J. Keane Architects, PLLC

ARCHITECTURE
PŁANNING
DESIGN
101 Kent Place
Newmarket, NH
03857

603-292-1400 mjkarchitects.com

All drawings and written materials appearing herein constitute original unpublished work of Michael J. Kaane Architects, PLLC and may not be duplicated, used, or disclosed without the written crossnot of Michael J. Keane Architects, PLLC, Newmarkst, NH. © 2018

CONSULTANTS

REVISIONS

APPROVALS

PLANNING BOARD REVIEW 02.02.21 NOT FOR CONSTRUCTION

Accept only onginal stamp and signature copies may contain unauthorized modifications

PROJECT

INDUSTRIAL WAREHOUSE 375 BANFIELD ROAD TAX MAP 266 LOT 7, PORTSMOUTH NH , NH

BANFIELD REALTY LLC 304 MAPLEWOOD AVE PORTSMOUTH NH 03801,

TITI

PRELIMINARY ELEVATIONS

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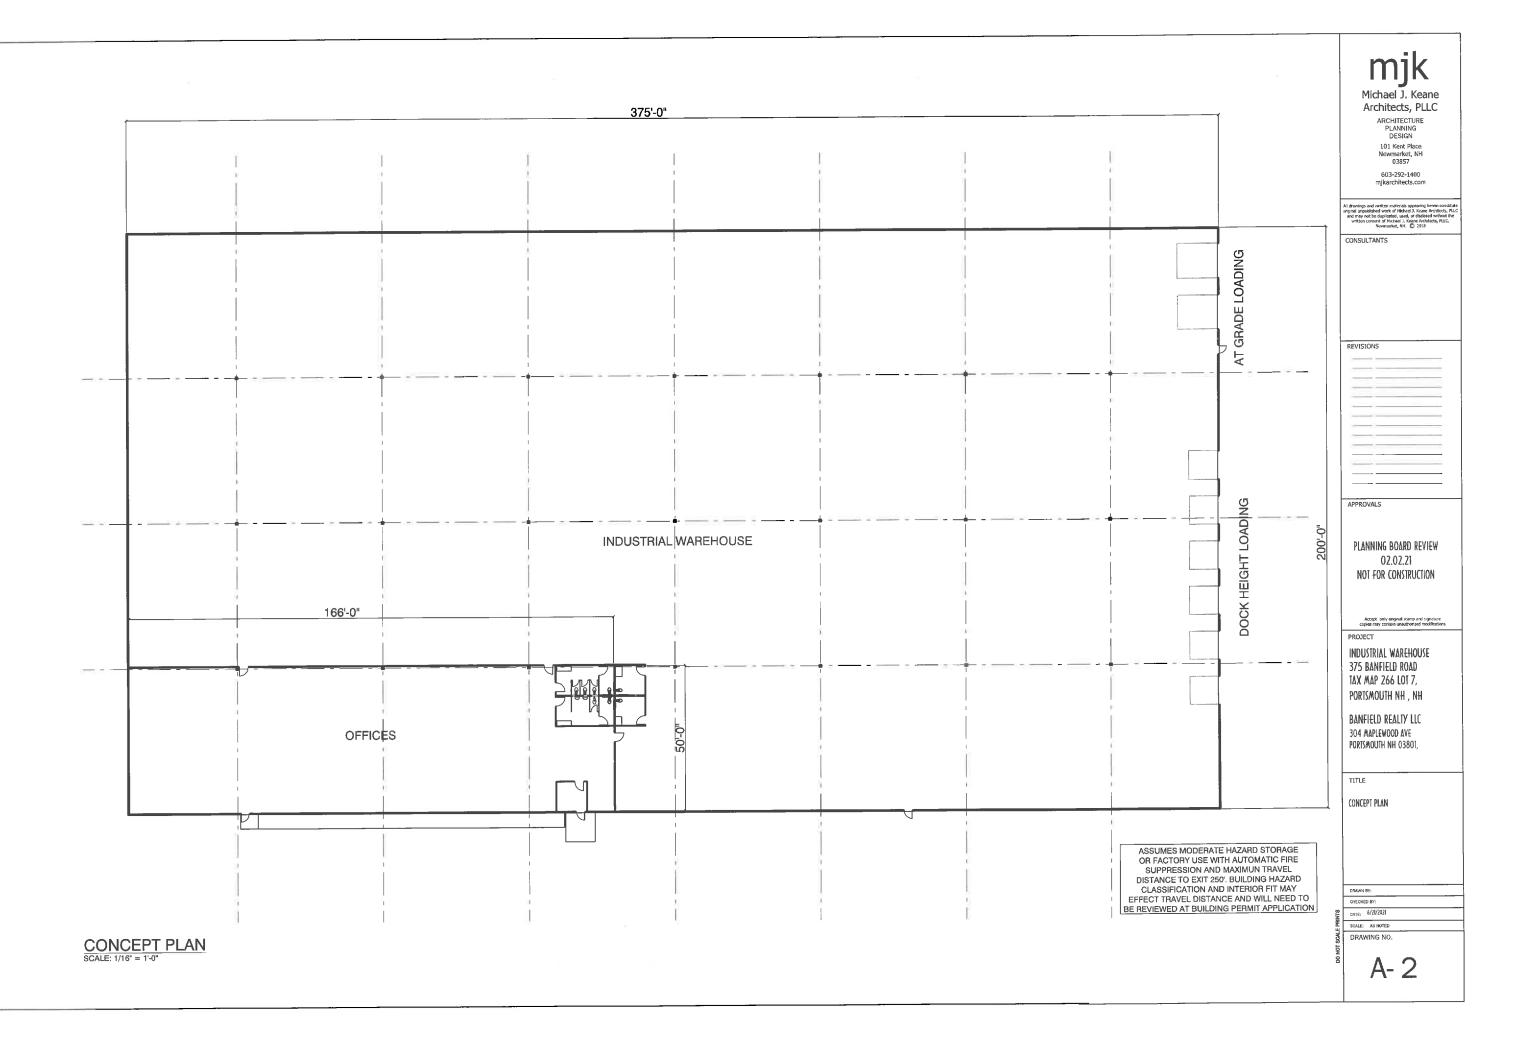
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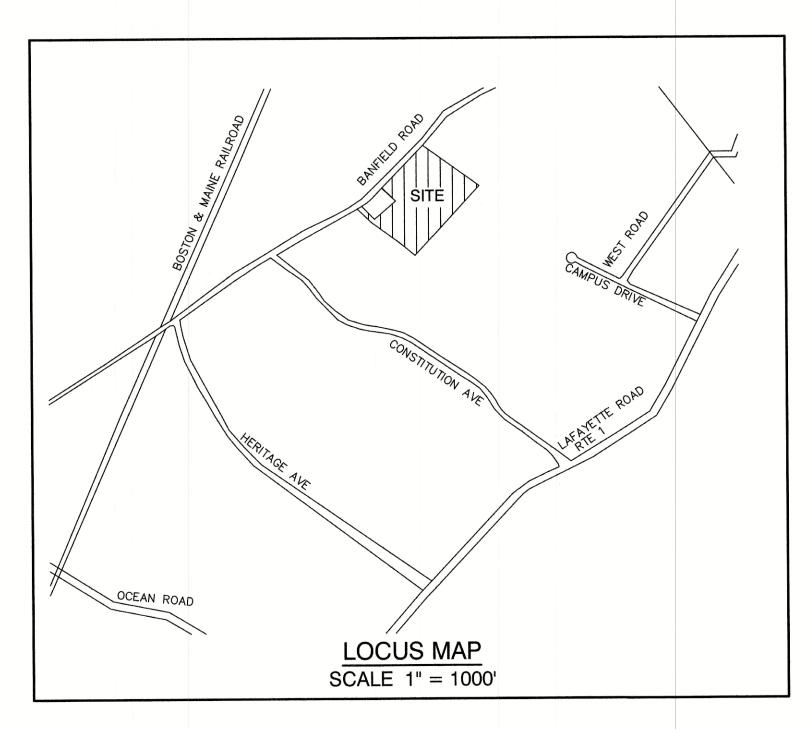
A- 1

CONCEPT ELEVATIONS
SCALE: 1/16" = 1'-0"



GENERAL LEGEND SETBACK LINES FRESHWATER WETLANDS LINE FENCE STOCKADE FENCE FLOOD PLAIN LINE EASEMENT MAJOR CONTOUR MINOR CONTOUR EDGE OF PAVEMENT VERTICAL GRANITE CURB SLOPE GRANITE CURB POURED CONCRETE CURB SILT FENCE / FIBER BERM DRAINAGE LINE SEWER FORCE MAIN UNDERGROUND ELECTRIC UNDERDRAIN FIRE PROTECTION LINE THRUST BLOCK IRON PIPE/IRON ROD DRILL HOLE IRON ROD/DRILL HOLE STONE/GRANITE BOUND SPOT GRADE 100×0 × 100.00 PAVEMENT SPOT GRADE × 100.00 CURB SPOT GRADE BENCHMARK (TBM) DOUBLE POST SIGN SINGLE POST SIGN TEST PIT FAILED TEST PIT MONITORING WELL PERC TEST PHOTO LOCATION TREES AND BUSHES UTILITY POLE LIGHT POLES DRAIN MANHOLE SEWER MANHOLE HYDRANT WATER GATE WATER SHUT OFF REDUCER SINGLE GRATE CATCH BASIN DOUBLE GRATE CATCH BASIN TRANSFORMER CULVERT W/WINGWALLS <u>}____</u> CULVERT W/FLARED END SECTION CULVERT W/STRAIGHT HEADWALL STONE CHECK DAM DRAINAGE FLOW DIRECTION 4K SEPTIC AREA WETLAND IMPACT VEGETATED FILTER STRIP RIPRAP OPEN WATER علله علله FRESHWATER WETLANDS **** TIDAL WETLANDS STABILIZED CONSTRUCTION **ENTRANCE** CONCRETE GRAVEL mm SNOW STORAGE

COMMERCIAL SITE PLAN "INDUSTRIAL WAREHOUSE" TAX MAP 266, LOT 7 375 BANFIELD ROAD, PORTSMOUTH, NH



CIVIL ENGINEER / SURVEYOR JONES & BEACH ENGINEERS, INC. **85 PORTSMOUTH AVENUE** PO BOX 219 STRATHAM, NH 03885 (603) 772-4746 CONTACT: JOSEPH CORONATI JCORONATI@JONESANDBEACH.COM

WETLAND AND SOIL CONSULTANT GOVE ENVIRONMENTAL SERVICES, INC. 8 CONTINENTAL DRIVE BUILDING 2 UNIT H EXETER, NH 03833 (603) 778-0644 CONTACT: JAMES GOVE JGOVE@GESINC.BIZ

Stratham, NH 03885

LANDSCAPE DESIGNER

LM LAND DESIGN 11 SOUTH ROAD BRENTWOOD, NH 03833 CONTACT: LISE MCNAUGHTON (603) 770-7728 LMLANDDESIGN@GMAIL.COM

NATURAL GAS UNITIL SERVICE CORP.

325 WEST ROAD PORTSMOUTH, NH 03801 CONTACT: DAVID MACLEAN (603) 294-5261 MACLEAND@UNITIL.COM

SHEET INDEX

COVER SHEET

EXISTING CONDITIONS PLAN

DEMOLITION PLAN

SITE PLAN

GRADING AND DRAINAGE PLAN

UTILITY PLAN

LANDSCAPE PLAN

LIGHTING PLAN

EFFLUENT DISPOSAL DESIGN

DETAIL SHEETS

EROSION AND SEDIMENT CONTROL DETAILS

H1-H2 HIGHWAY ACCESS PLAN

T1-T5 TRUCK TURNING PLAN

ELECTRIC

EVERSOURCE ENERGY 74 OLD DOVER ROAD ROCHESTER, NH 03867 **CONTACT: MARK BOUCHER** (603) 555-5334

TELEPHONE

CONSOLIDATED COMMUNICATIONS 1575 GREENLAND ROAD GREENLAND, NH 03840 **CONTACT: JOE CONSIDINE** (603) 427-5525

Owner of Record:

CABLE TV

COMCAST COMMUNICATION CORPORATION 334-B CALEF HIGHWAY EPPING. NH 03402-2325 (603) 679-5695

PROJECT PARCEL CITY OF PORTSMOUTH **TAX MAP 266, LOT 7**

> TOTAL LOT AREA 651,747 S.F. 14.96 ACRES

APPROVED - PORTSMOUTH, NH PLANNING BOARD

DATE:

Design: JAC Draft: DJM Checked: JAC | Scale: AS NOTED | Project No.: 19190.2 Drawing Name: 19190-PLAN-NEW-LAYOUT.dwg THIS PLAN SHALL NOT BE MODIFIED WITHOUT WRITTEN PERMISSION FROM JONES & BEACH ENGINEERS, INC. (JBE). ANY ALTERATIONS, AUTHORIZED OR OTHERWISE, SHALL BE AT THE USER'S SOLE RISK AND WITHOUT LIABILITY TO JBE.



RETAINING WALL

13	6/23/21	REVISED PER CITY COMMENTS	DJM
12	5/18/21	REVISED PLANTINGS PER NHB	DJM
11	5/17/21	ISSUED REVISED PLANS TO TAC	DJM
10	5/10/21	ISSUED REVISED PLANS FOR PRELIMINARY PB CONSULTATION	DJM
9	3/9/21	REVISED CONCEPTUAL LAYOUT	DJM
REV.	DATE	REVISION	BY

Designed and Produced in NH Jones & Beach Engineers, Inc. 603-772-4746 85 Portsmouth Ave. Civil Engineering Services FAX: 603-772-0227


E-MAIL: JBE@JONESANDBEACH.COM

COVER SHEET Plan Name: INDUSTRIAL WAREHOUSE Project: 375 BANFIELD ROAD, PORTSMOUTH, NH 03801 BANFIELD REALTY LLC

304 MAPLEWOOD AVENUE, PORTSMOUTH, NH 03801

DRAWING No.

JBE PROJECT NO. **19190.2**

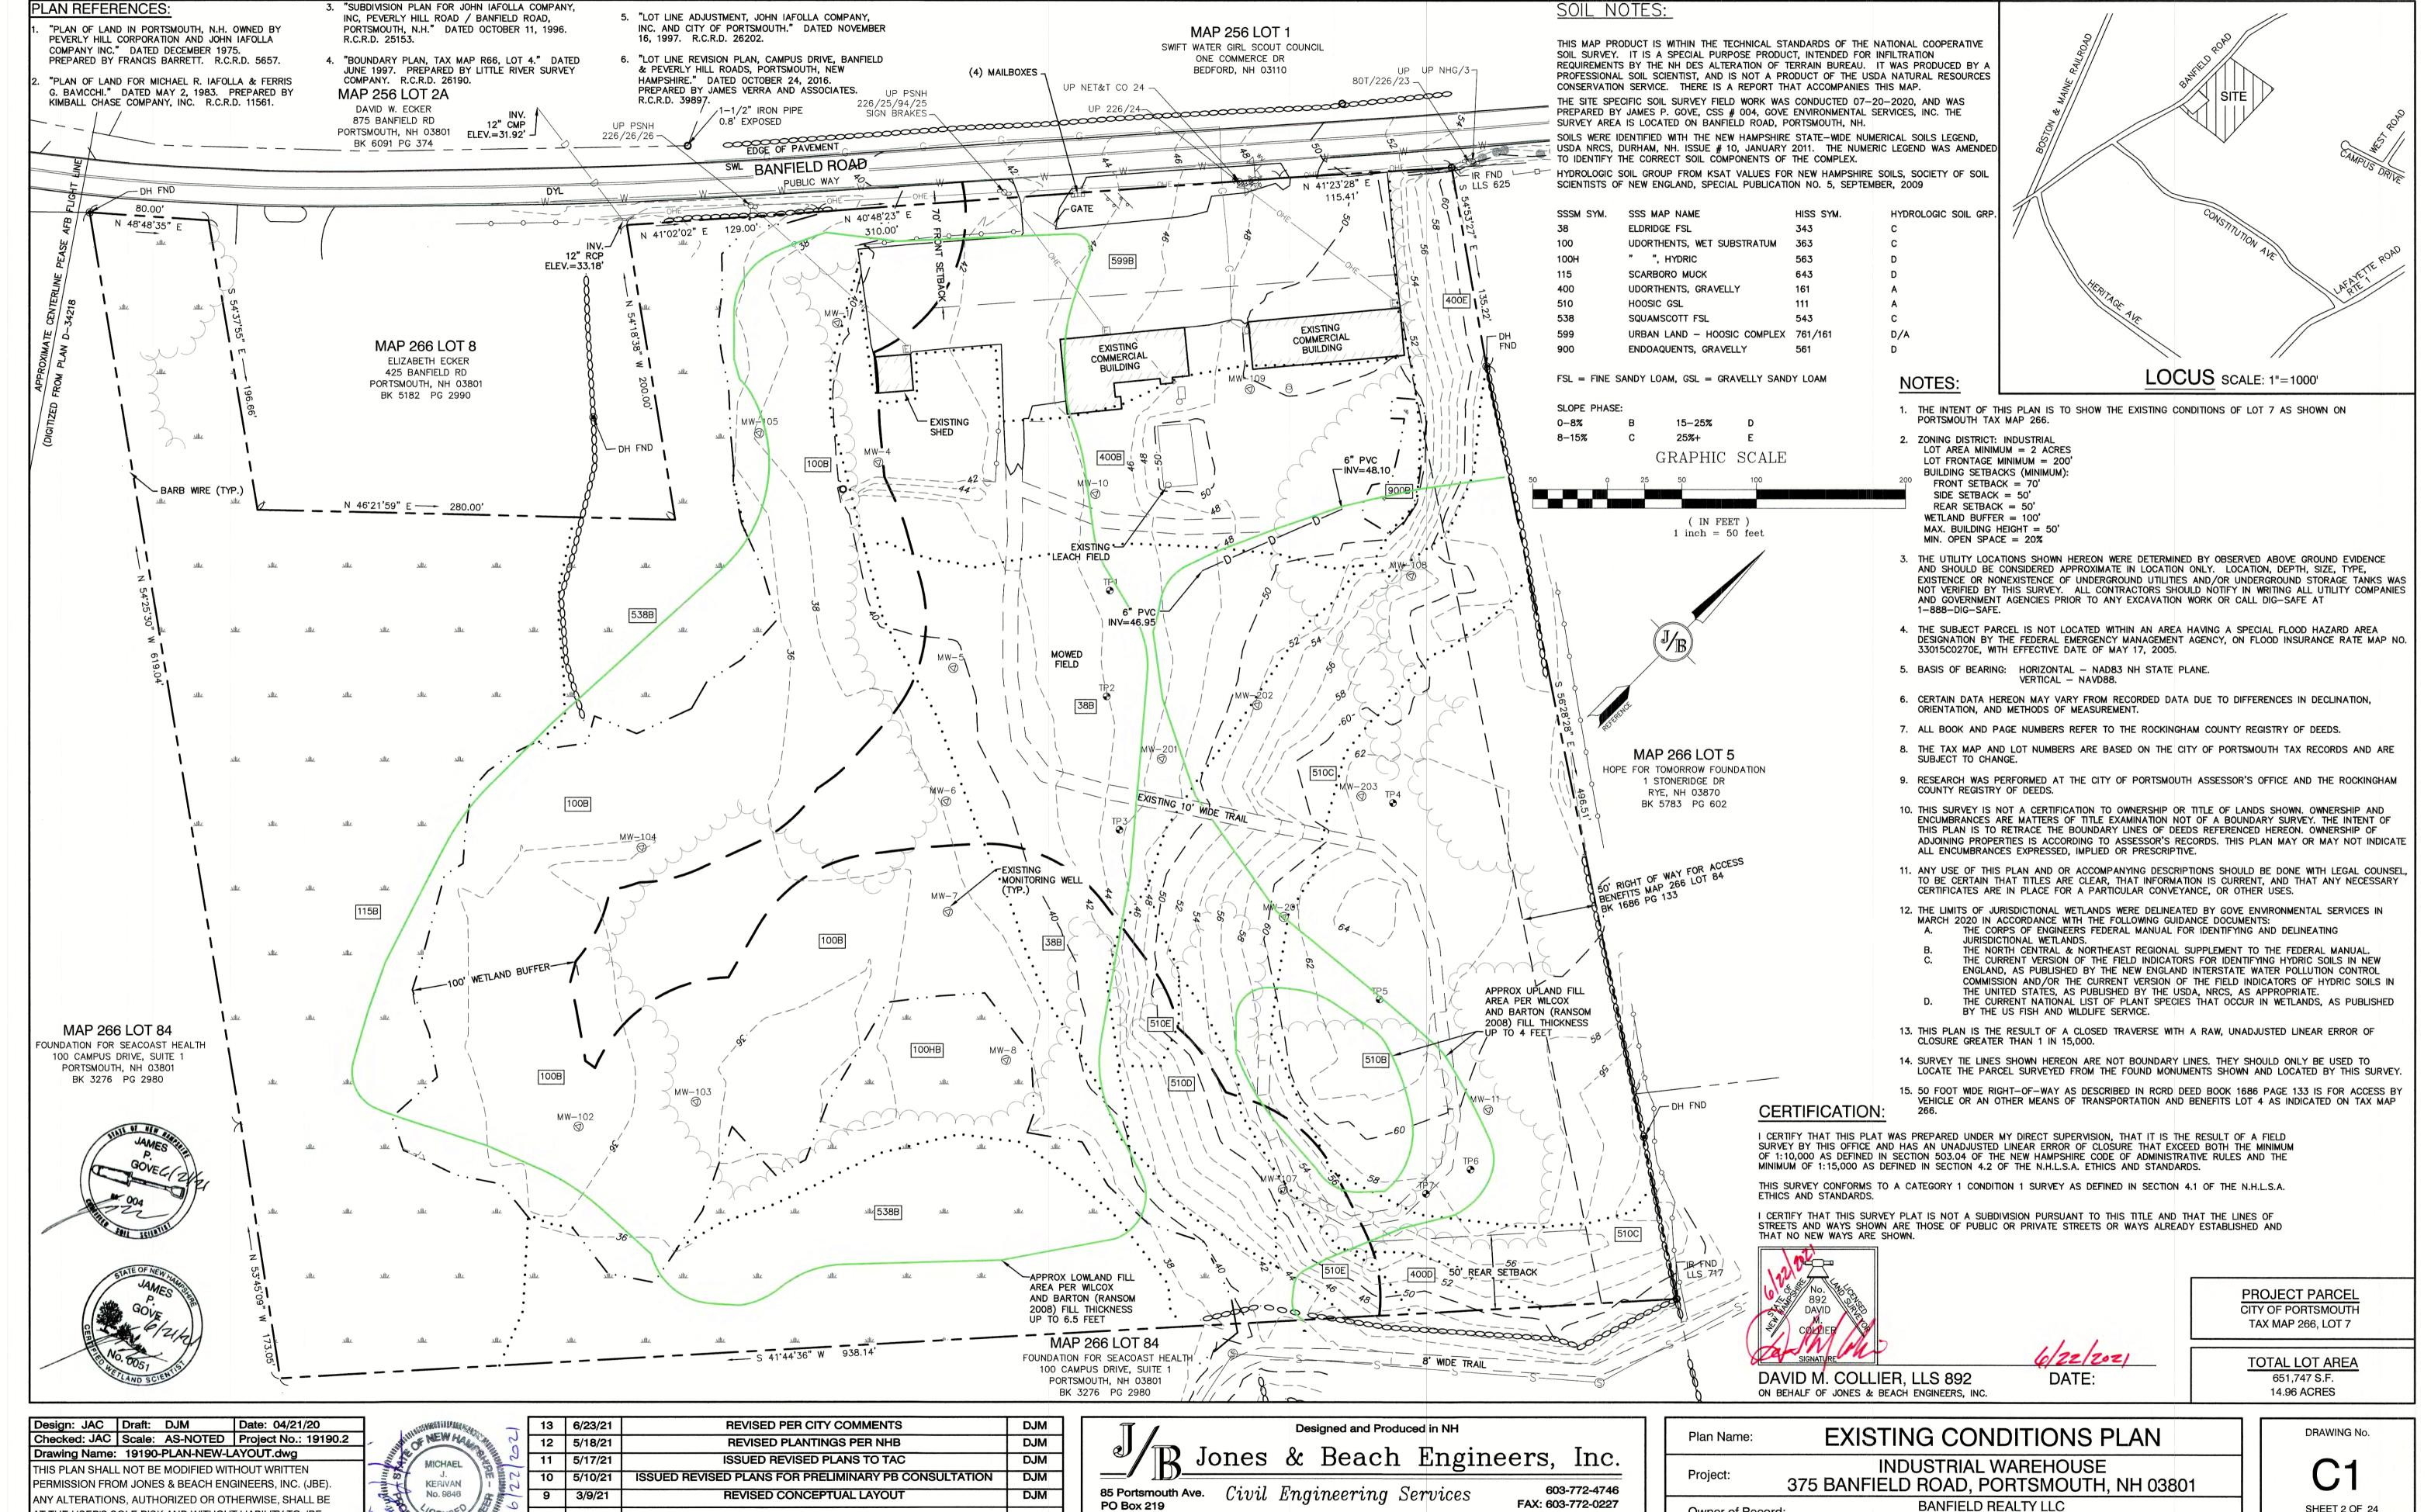

AT THE USER'S SOLE RISK AND WITHOUT LIABILITY TO JBE



DATE **REVISION** BY


FAX: 603-772-0227 E-MAIL: JBE@JONESANDBEACH.COM Stratham, NH 03885

Owner of Record:

304 MAPLEWOOD AVENUE, PORTSMOUTH, NH 03801

SHEET 2 OF 24

JBE PROJECT NO. **19190.2**

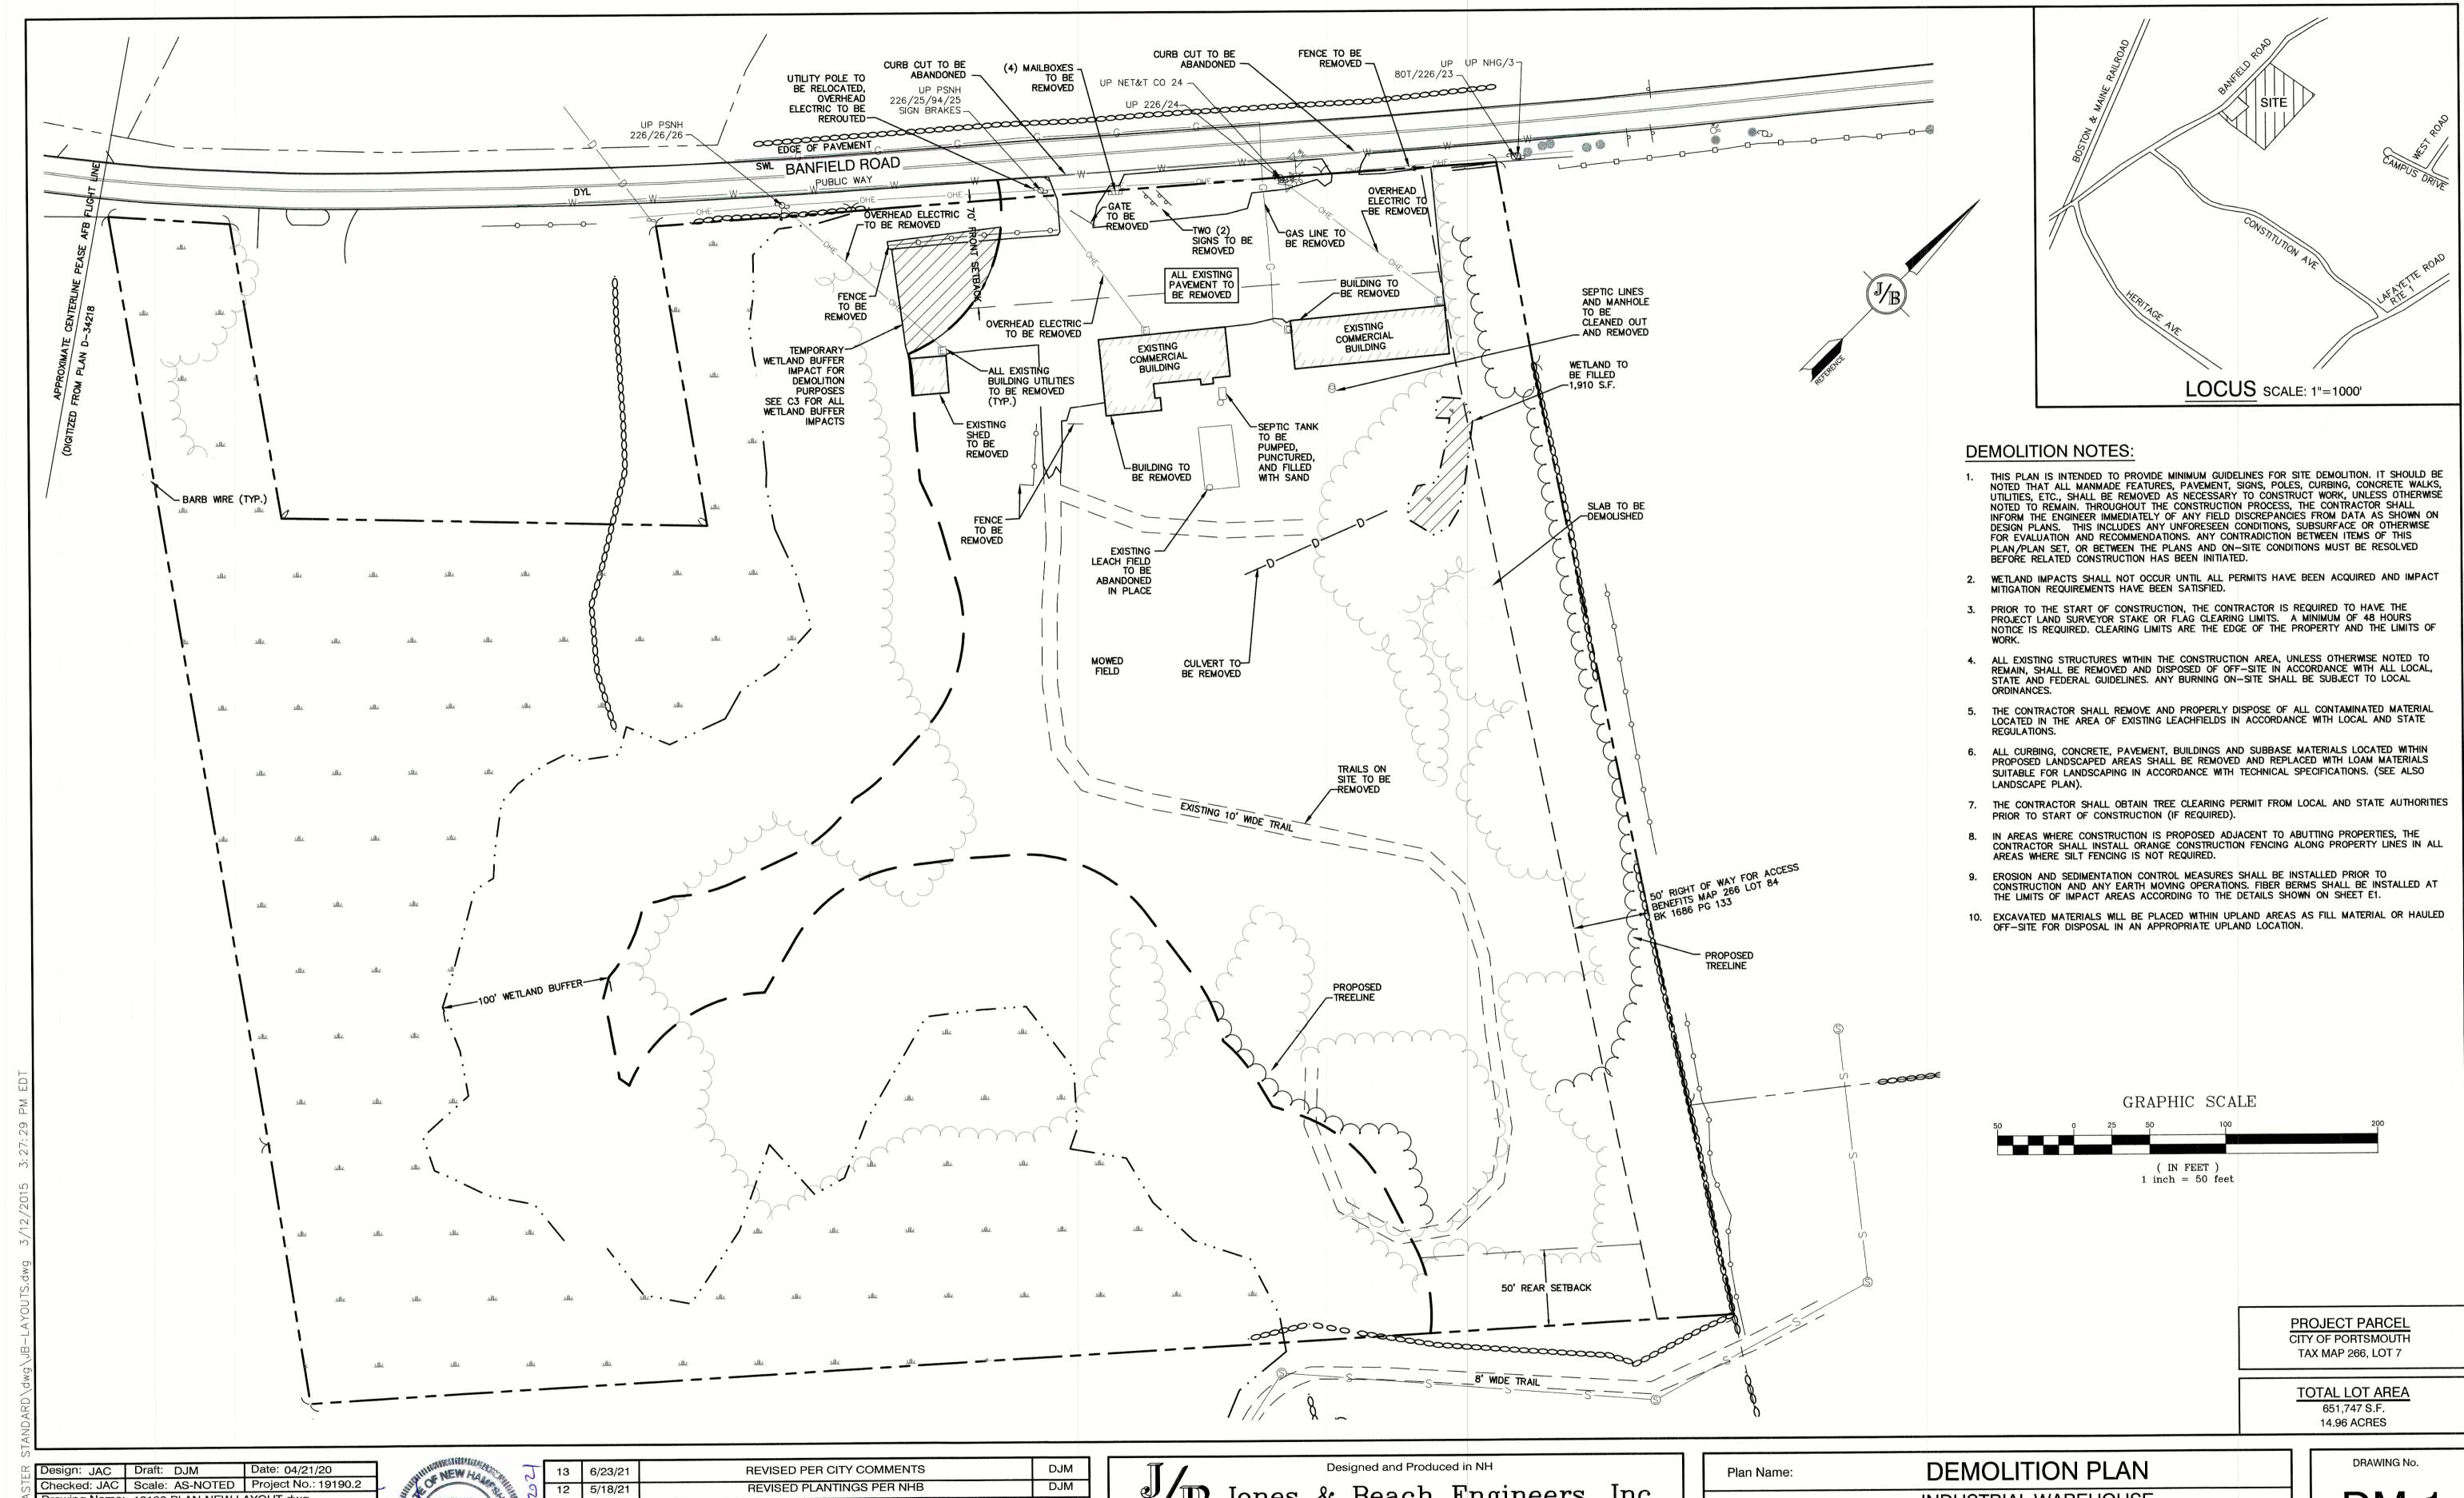

Stratham, NH 03885

Drawing Name: 19190-PLAN-NEW-LAYOUT.dwg THIS PLAN SHALL NOT BE MODIFIED WITHOUT WRITTEN PERMISSION FROM JONES & BEACH ENGINEERS, INC. (JBE). ANY ALTERATIONS, AUTHORIZED OR OTHERWISE, SHALL BE AT THE USER'S SOLE RISK AND WITHOUT LIABILITY TO JBE.

MICHAEL DJM ISSUED REVISED PLANS TO TAC 11 5/17/21 DJM ISSUED REVISED PLANS FOR PRELIMINARY PB CONSULTATION 10 5/10/21 REVISED CONCEPTUAL LAYOUT DJM 9 3/9/21 BY REVISION DATE

Jones & Beach Engineers, Inc. 603-772-4746 85 Portsmouth Ave. Civil Engineering Services FAX: 603-772-0227 PO Box 219


E-MAIL: JBE@JONESANDBEACH.COM

INDUSTRIAL WAREHOUSE 375 BANFIELD ROAD, PORTSMOUTH, NH 03801

Owner of Record:

BANFIELD REALTY LLC 304 MAPLEWOOD AVENUE, PORTSMOUTH, NH 03801 JBE PROJECT NO. 19190.2

SHEET 3 OF 24

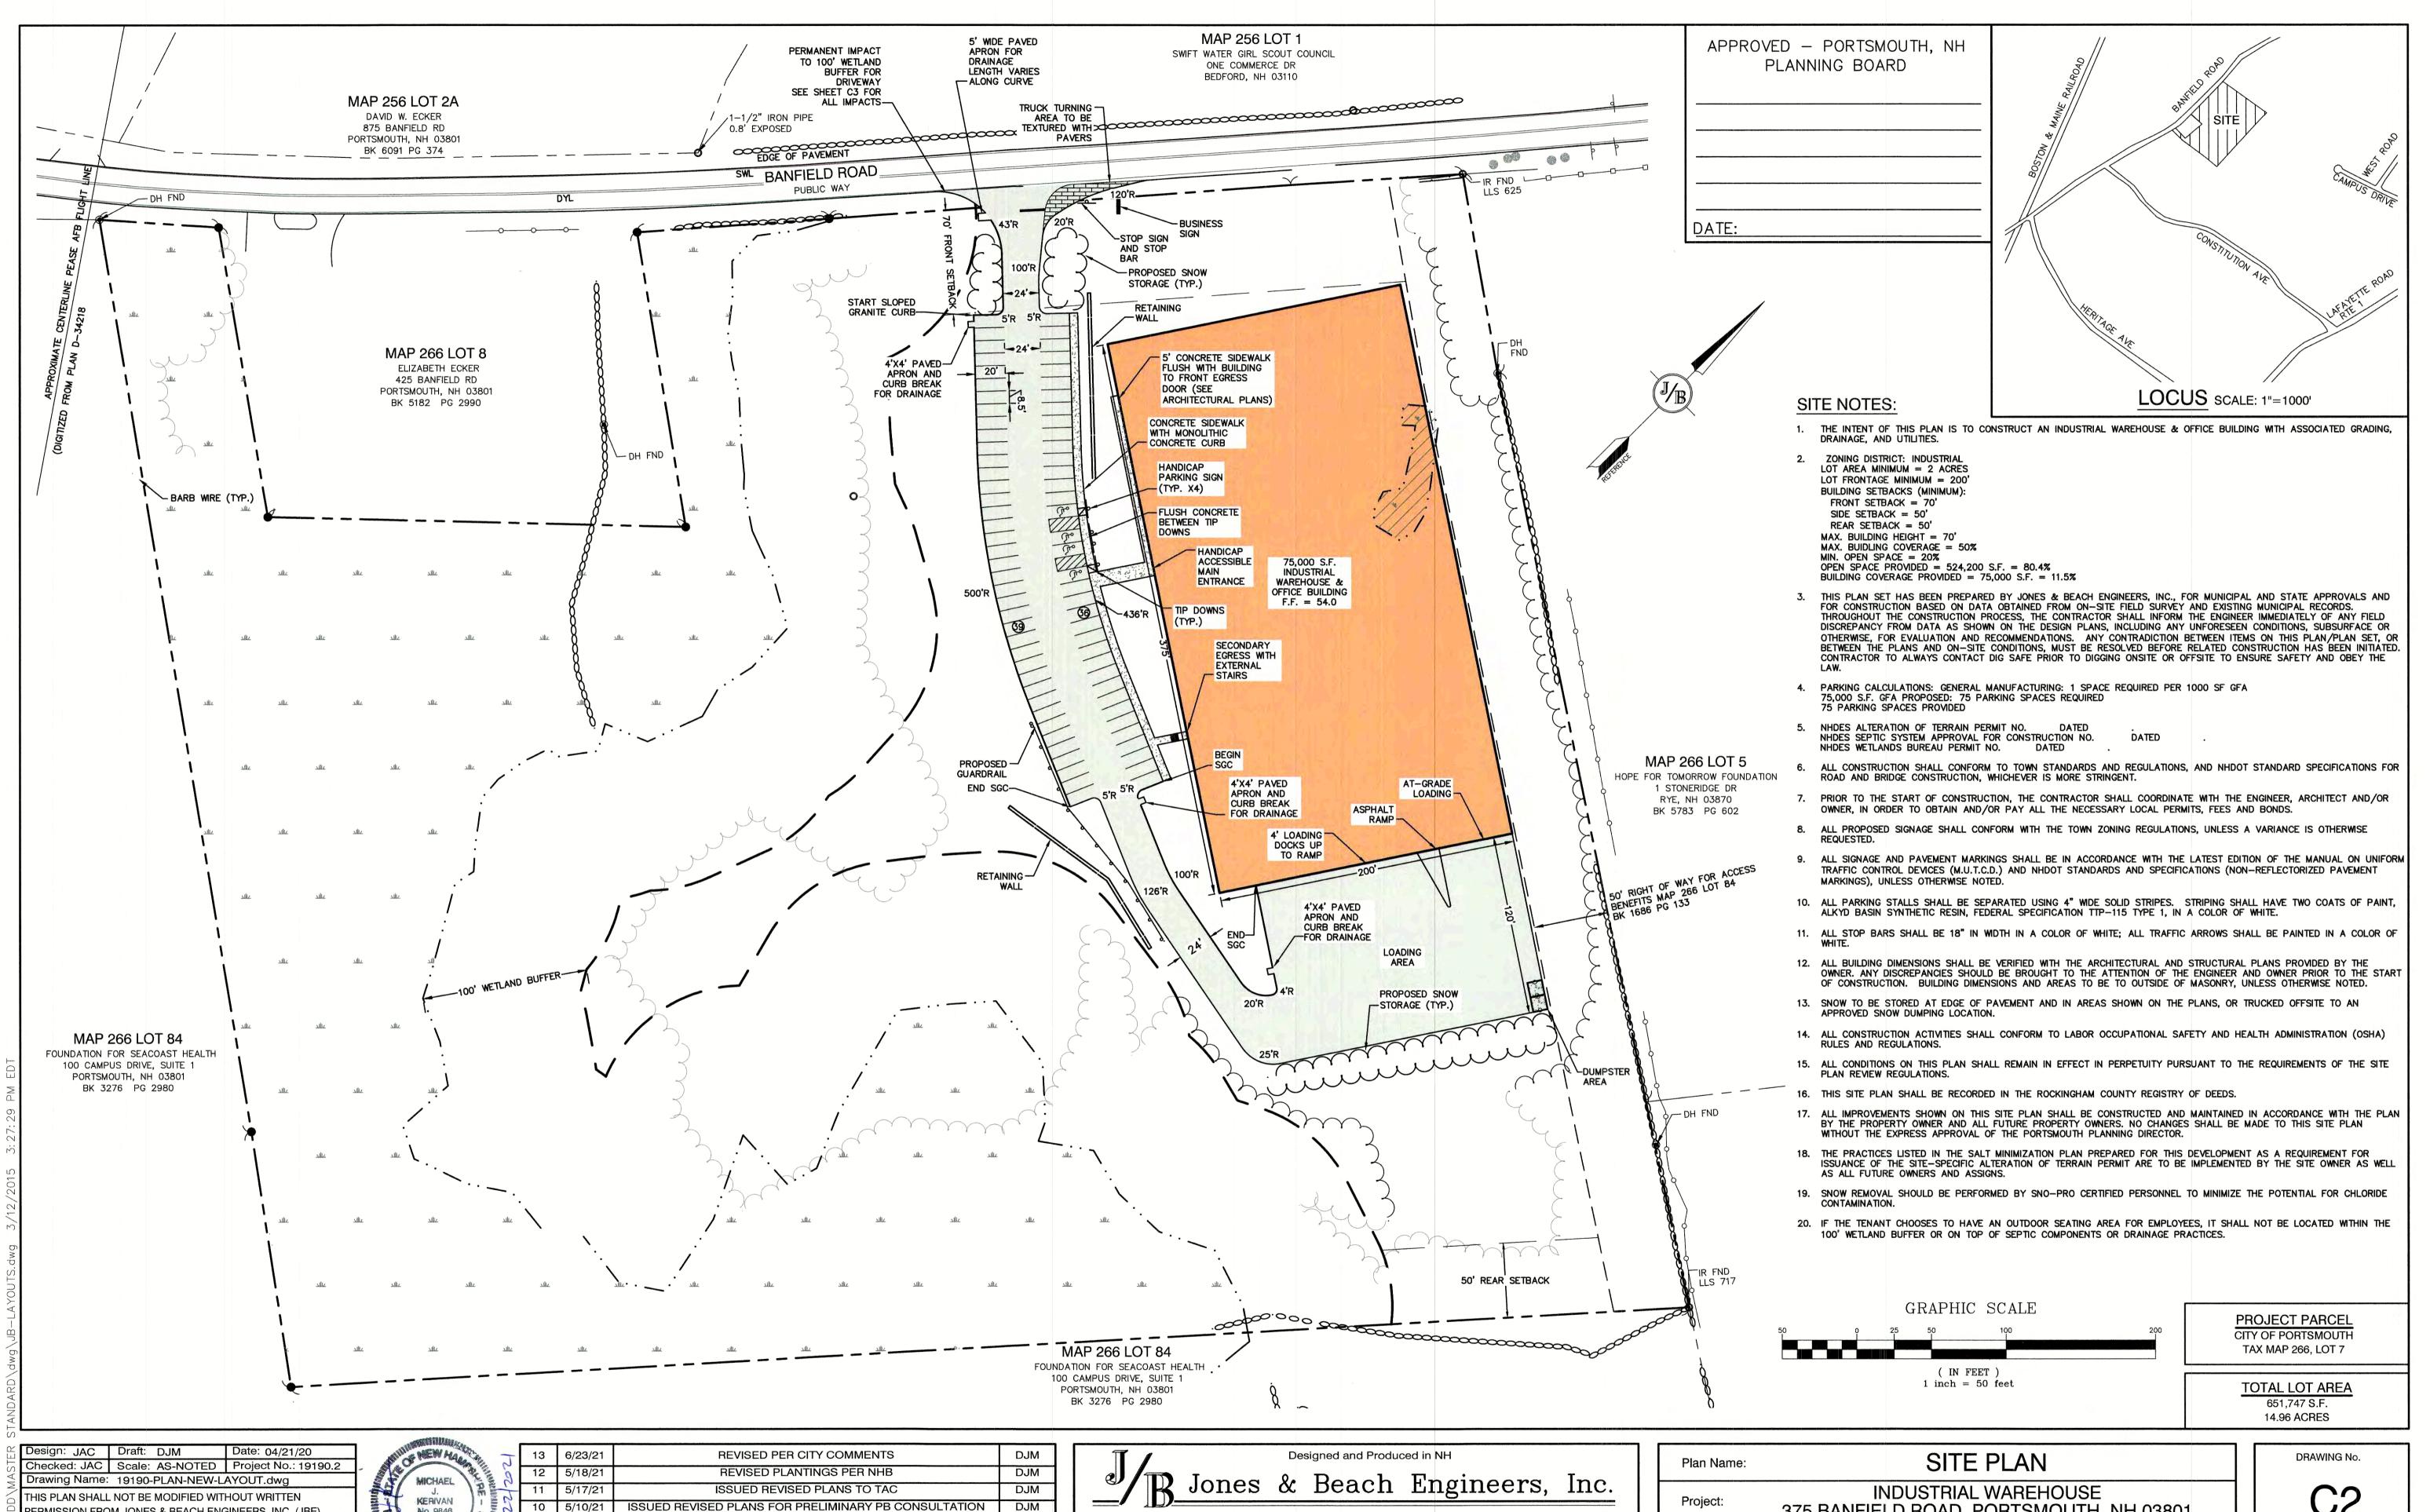

85 Portsmouth Ave. Civil Engineering Services

603-772-4746

Owner of Record:

FAX: 603-772-0227

E-MAIL: JBE@JONESANDBEACH.COM

PERMISSION FROM JONES & BEACH ENGINEERS, INC. (JBE).

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No. 9846

3/9/21

REV. DATE

REVISED CONCEPTUAL LAYOUT


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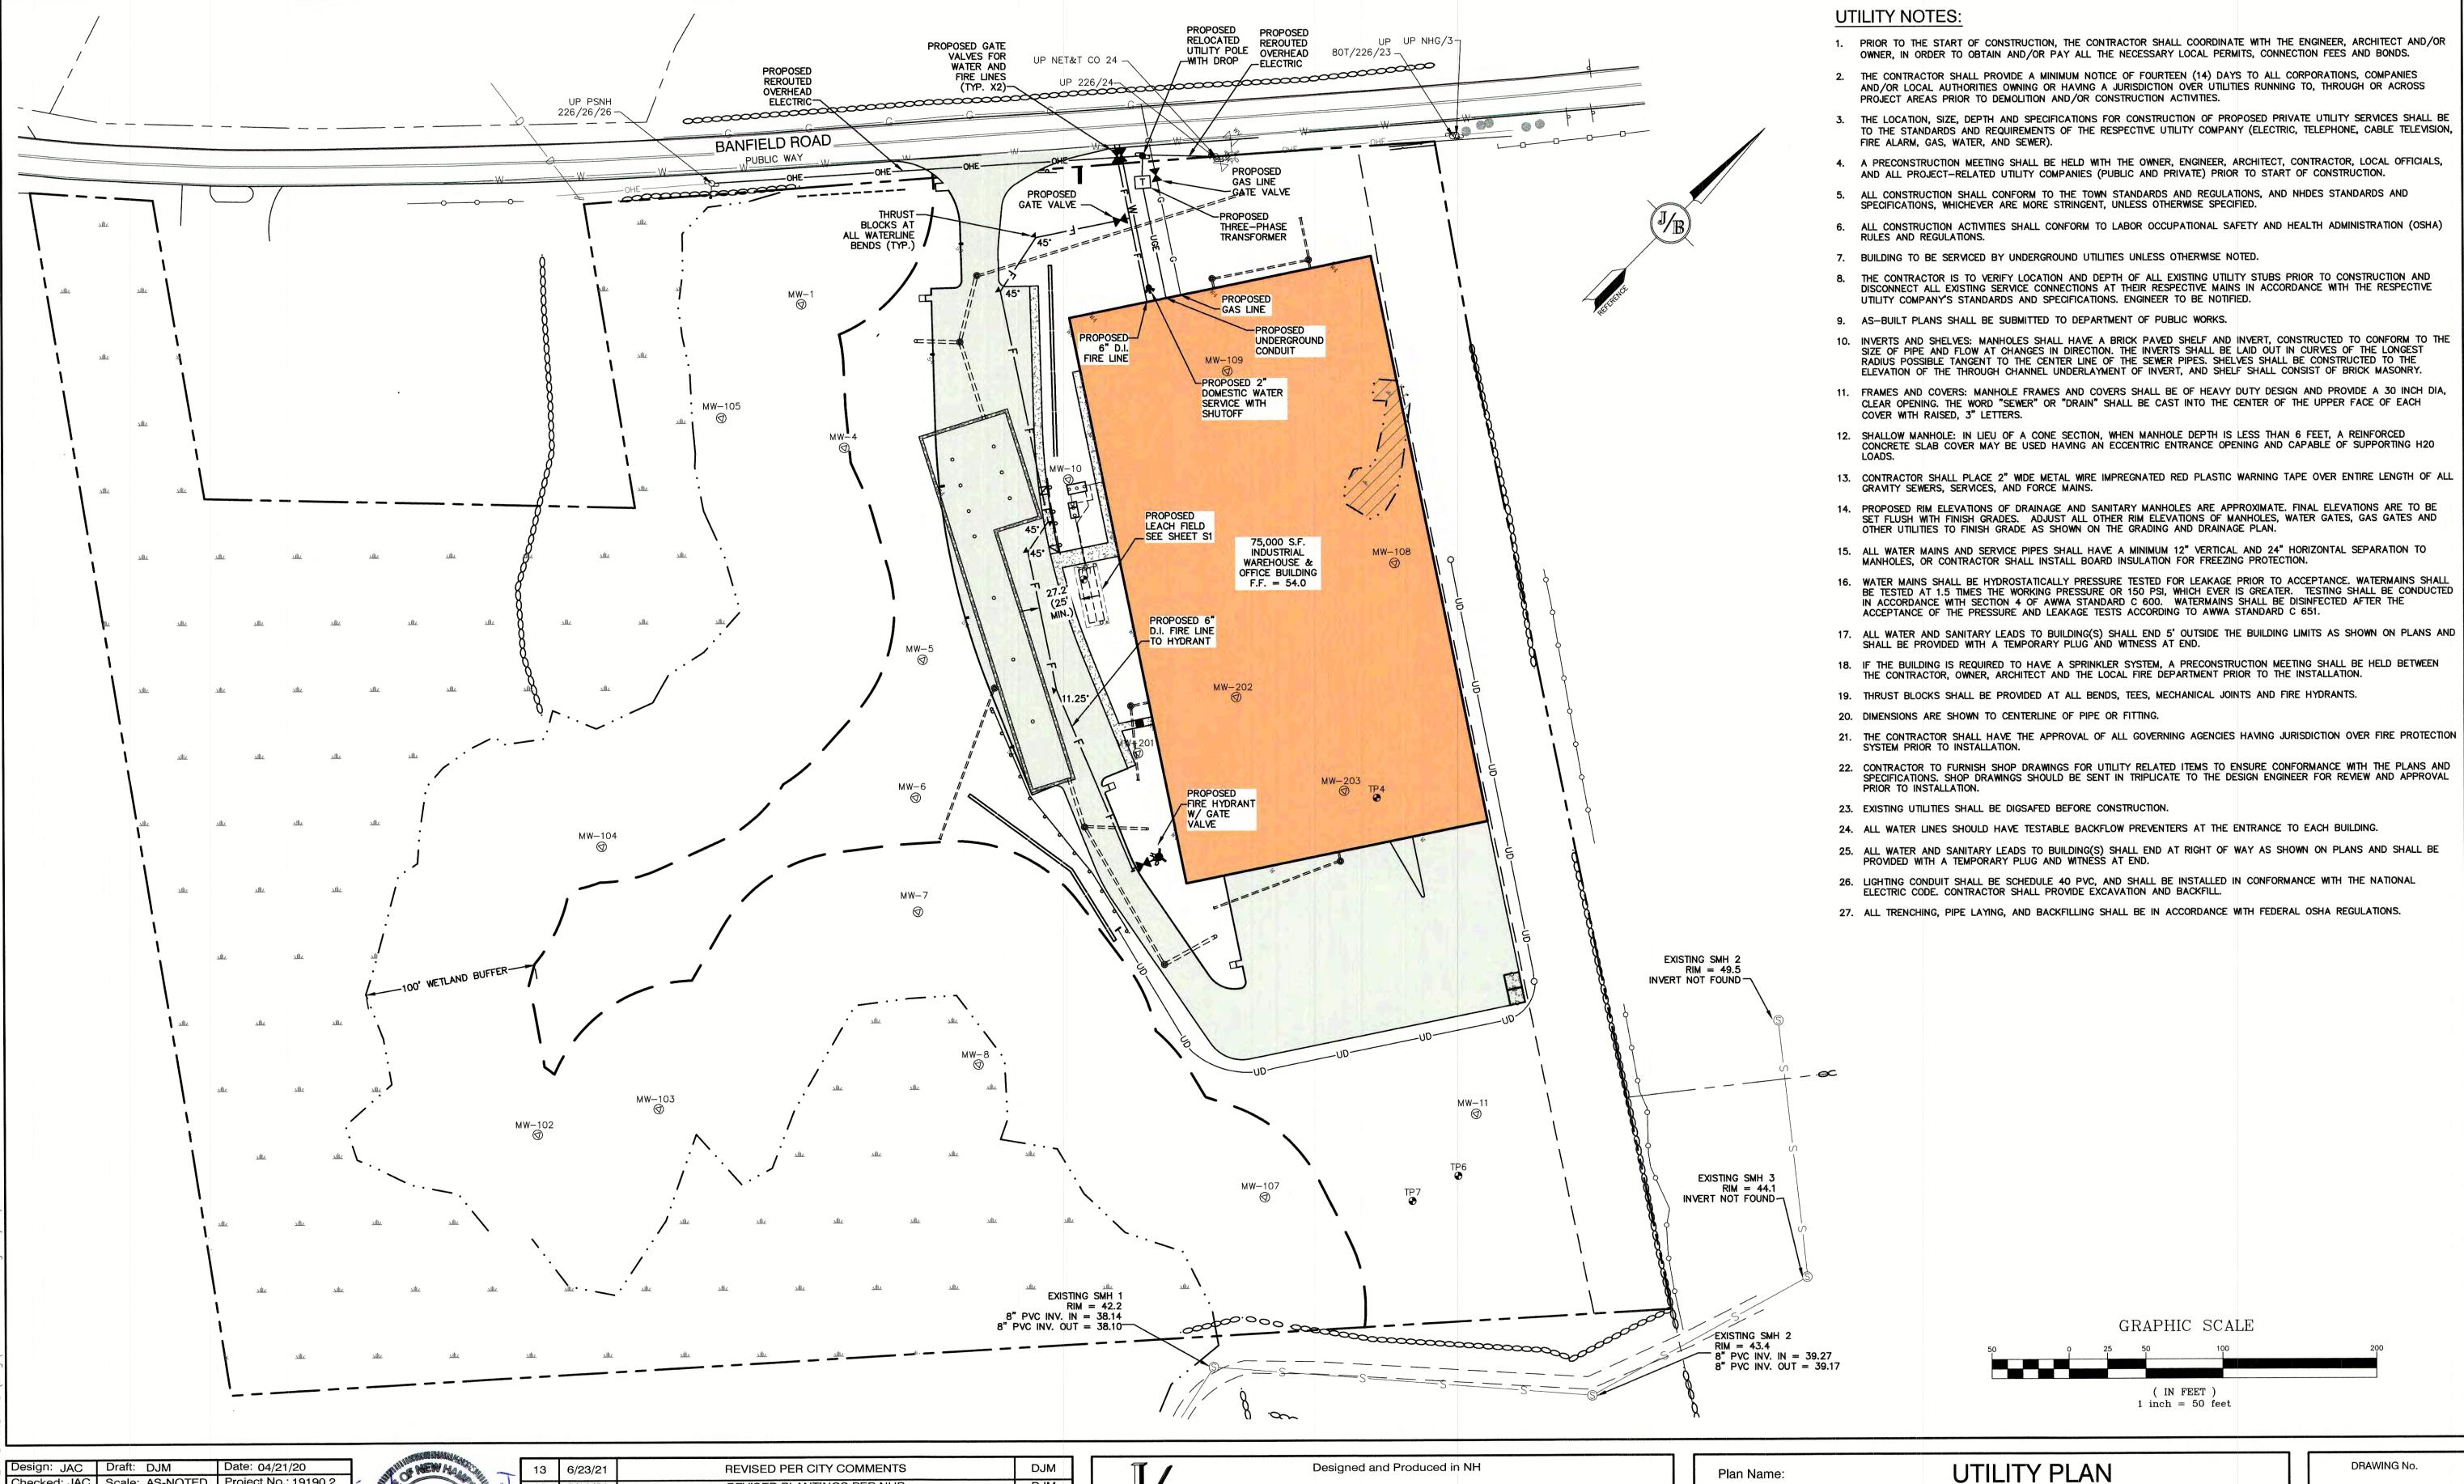
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PO Box 219

Stratham, NH 03885

375 BANFIELD ROAD, PORTSMOUTH, NH 03801 BANFIELD REALTY LLC SHEET 4 OF 24 304 MAPLEWOOD AVENUE, PORTSMOUTH, NH 03801 JBE PROJECT NO. 19190.2



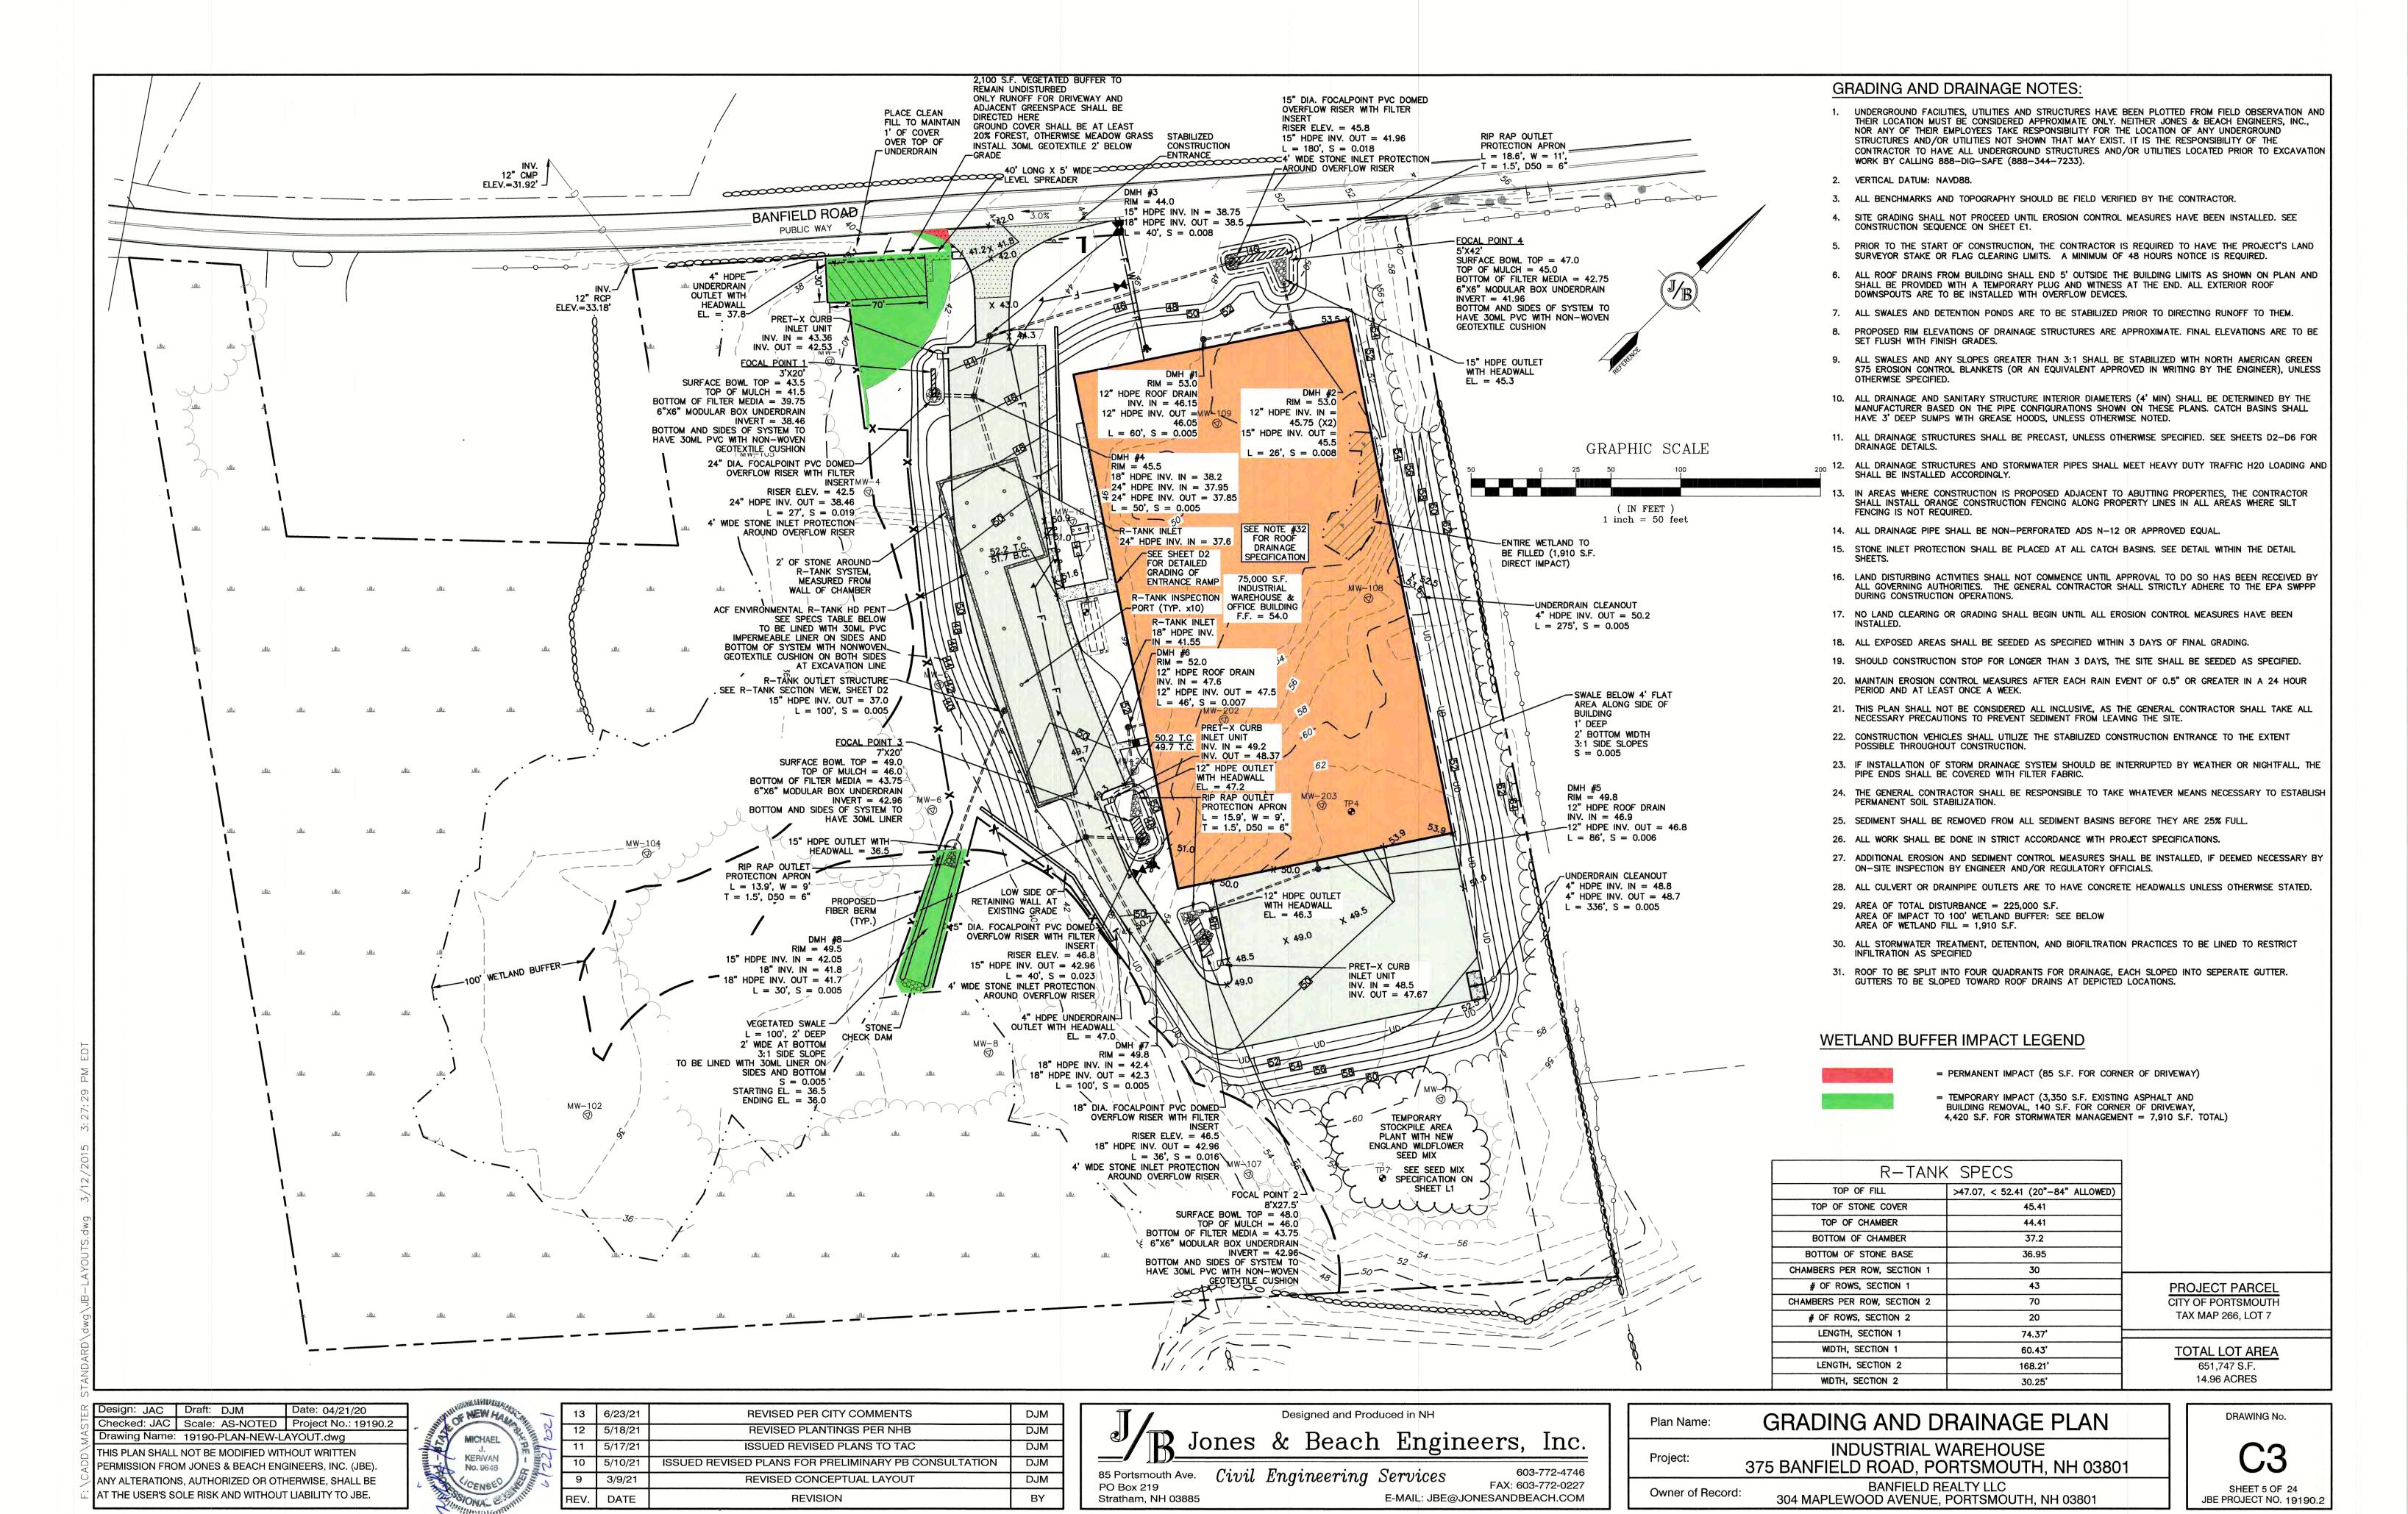

Checked: JAC | Scale: AS-NOTED | Project No.: 19190.2 Drawing Name: 19190-PLAN-NEW-LAYOUT.dwg THIS PLAN SHALL NOT BE MODIFIED WITHOUT WRITTEN PERMISSION FROM JONES & BEACH ENGINEERS, INC. (JBE). ANY ALTERATIONS, AUTHORIZED OR OTHERWISE, SHALL BE AT THE USER'S SOLE RISK AND WITHOUT LIABILITY TO JBE



-	13	6/23/21	REVISED PER CITY COMMENTS	DJM
25	12	5/18/21	REVISED PLANTINGS PER NHB	DJM
200	11	5/17/21	ISSUED REVISED PLANS TO TAC	DJM
2	10	5/10/21	ISSUED REVISED PLANS FOR PRELIMINARY PB CONSULTATION	DJM
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Stratham, NH 03885


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Owner of Record:

INDUSTRIAL WAREHOUSE 375 BANFIELD ROAD, PORTSMOUTH, NH 03801

BANFIELD REALTY LLC SHEET 6 OF 24 304 MAPLEWOOD AVENUE, PORTSMOUTH, NH 03801 JBE PROJECT NO. 19190.2



	PLANT LIST				
QUANTITY	BOTANICAL NAME	COMMON NAME	SIZE	٦.	
5	ABIES BALSAMEA	BALSAM FIR	8-10 FT. HT.	⊣ 3.	
8	ACER RUBRUM 'OCTOBER GLORY'	OCTOBER GLORY RED MAPLE	3.5" CALIPER		
4	AMELANCHIER X GRANDIFLORA 'AUTUMN BRILLIANCE'	AUTUMN BRILLIANCE SERVICEBERRY	15 GALLON	4.	
3	BETULA LENTA	BLACK BIRCH	10 FT. HT. MULTI		
4	CALAMAGROSTIS X ACUTIFLORA 'KARL FOERSTER'	KARL FOERSTER REED GRASS	2 GALLON	5.	
28	CHAMAECYPARIS PISIFERA 'MOP'	MOP GOLD THREAD CYPRESS	3 GALLON		
4	CORNUS FLORIDA F. RUBRA	PINK FLOWERING DOGWOOD	2.5" CALIPER		
85	COTONEASTER HORIZONTALIS 'PERPUSILLUS'	PERPUSILLUS ROCKSPRAY COTONEASTER	2 GALLON	6.	
12	GERANIUM SANGUINEUM 'NH PURPLE'	NH PURPLE CRANESBILL	1 Gallon		
6	HYDRANGEA QUERCIFOLIA 'ALICE'	ALICE OAKLEAF HYDRANGEA	5 GALLON		
9	ILEX VERTICILLATA 'FARROWBPOP'	BERRY POPPINS WINTERBERRY	5 GALLON	— 7.	
6	ILEX VERTICILLATA 'FARROWMRP'	MR. POPPINS WINTERBERRY	5 GALLON	一 ′′	
18	JUNIPERUS VIRGINIANA	EASTERN RED CEDAR	6-7 FT. HT.	8.	
15	KALMIA LATIFOLIA 'PEPPERMINT'	PEPPERMINT MT LAUREL	5 GALLON		
6	MISCANTHUS SINENSIS 'CABARET'	CABARET MAIDEN GRASS	2 GALLON	٦,	
5	NEPETA X FAASSENII 'BLUE WONDER'	BLUE WONDER CATMINT	1 GALLON	9.	
6	RHODODENDRON 'PJM'	PJM RHODODENDRON	5 GALLON		
20	RHUS AROMATICA 'GRO-LOW'	GRO-LOW FRAGRANT SUMAC	3 GALLON	10	
1	TILIA CORDATA 'GREENSPIRE'	GREENSPIRE LITTLELEAF LINDEN	3.5" CALIPER		
12	VIBURNUM DENTATUM 'AUTUMN JAZZ'	AUTUMN JAZZ VIBURNUM	5 GALLON	11	
4	WEIGELA FLORIDA 'ALEXANDRA'	WINE & ROSES WEIGELA	3 GALLON	7	

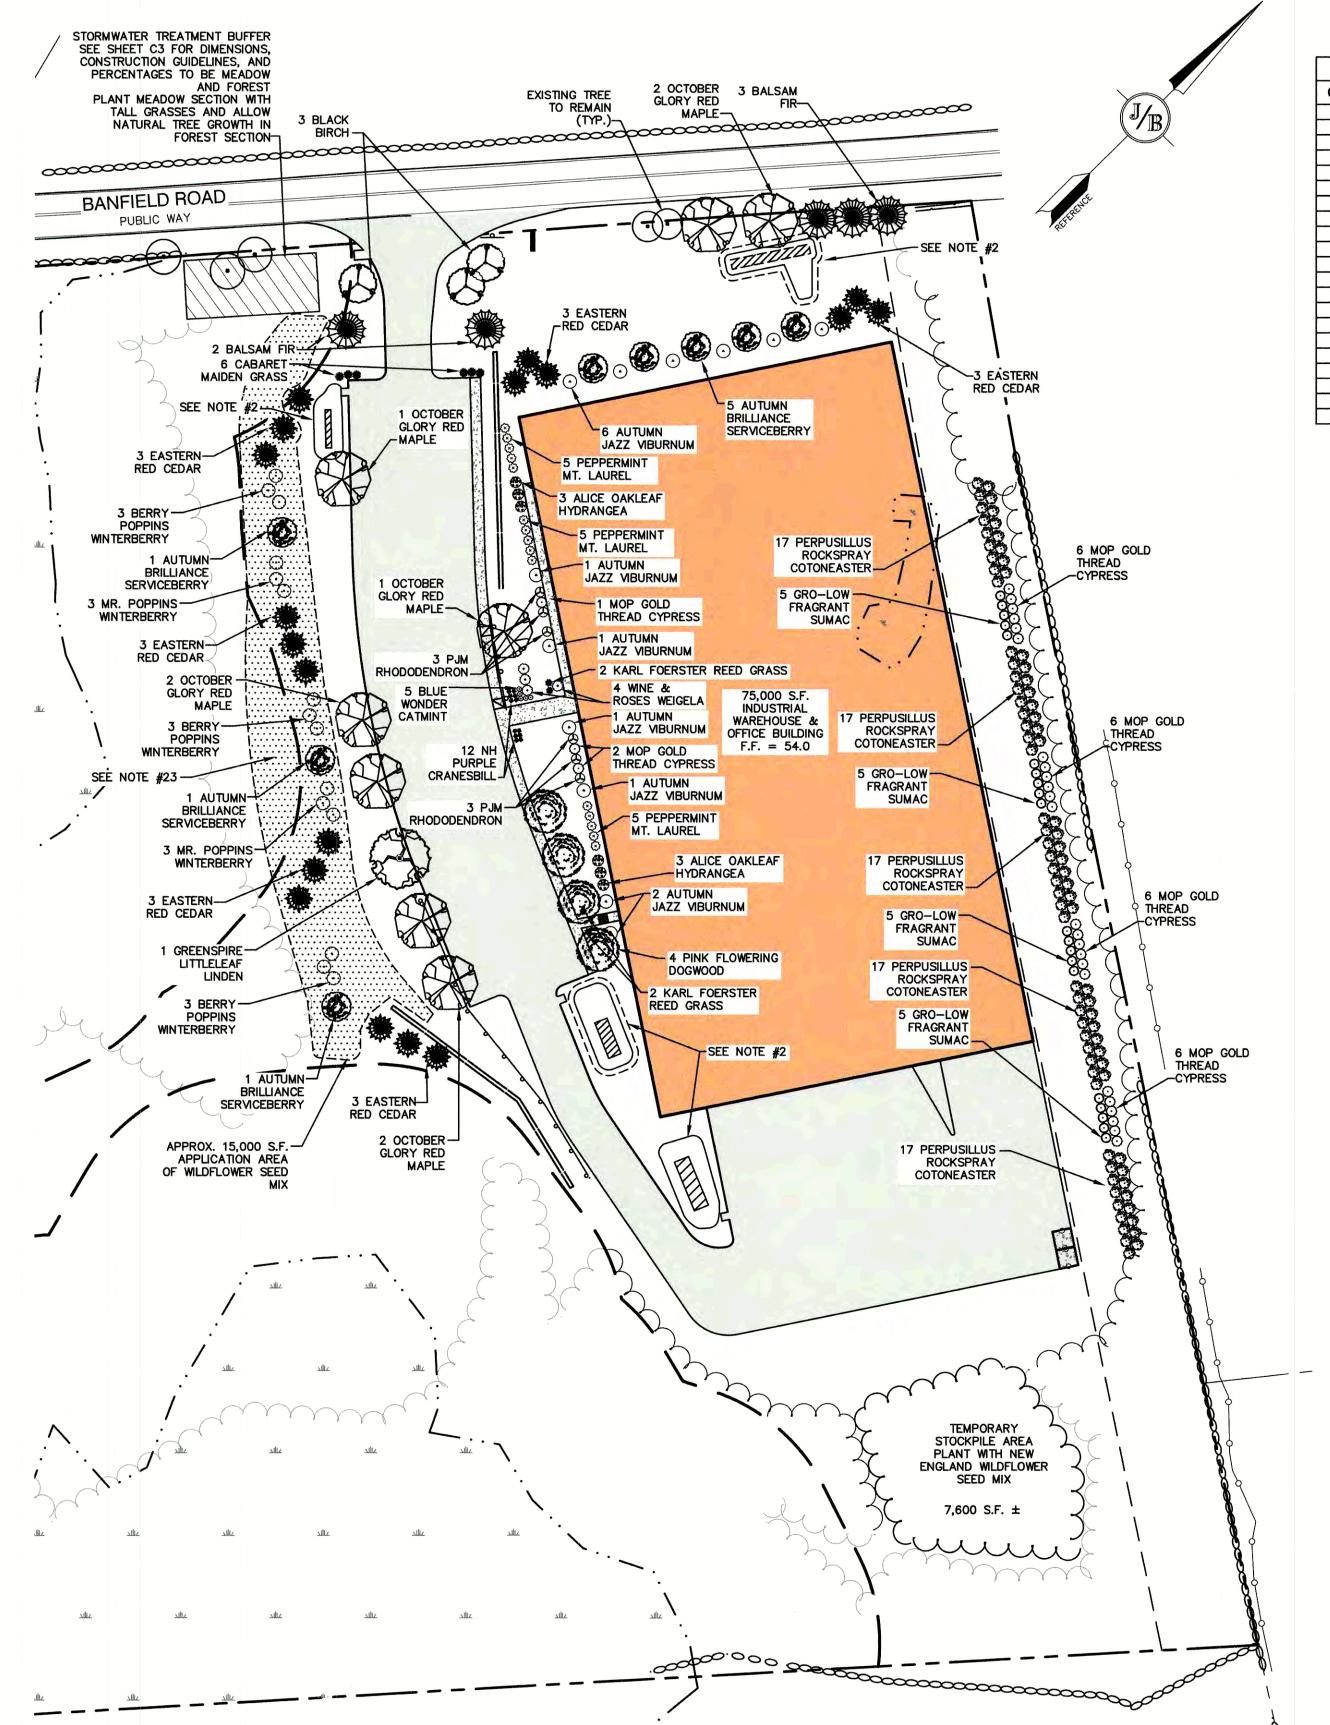NEW ENGLAND WILDFLOWER SEED MIX				
BOTANICAL NAME	COMMON NAME	INDICATOR		
SCHIZACHYRIUM SCOPARIUM	LITTLE BLUESTEM	FACU		
SORGHASTRUM NUTANS	INDIAN GRASS	UPL		
CHAMAECRISTA FASCICULATA	PARTRIDGE PEA	FACU		
ELYMUS VIRGINICUS	VIRGINIA WILD RYE	FACW-		
ELYMUS CANADENSIS	CANADA WILD RYE	FACU+		
FESTUCA RUBRA	RED FESCUE	FACU		
ASCLEPIAS TUBEROSA	BUTTERFLY MILKWEED	NI		
VERNONIA NOVEBORACENSIS	NEW YORK IRONWEED	FACW+		
OENOTHERA BIENNIS	EVENING PRIMROSE	FACU-		
ASTER NOVAE-ANGLIAE (SYMPHYOTRICHUM NOVAE-ANGLIA)	NEW ENGLAND ASTER	FACW-		
RUDBECKIA HIRTA	BLACK EYED SUSAN	FACU-		
SOLIDAGO JUNCEA	EARLY GOLDENROD			
EUPATORIUM FISTULOSUM (EUTROCHIUM FISTULOSUM)	HOLLOW-STEM JOE PYE WEED	FACW		
ASTER LATERIFLORUS (SYMPHYOTRICHUM LATERIFLORUM)	STARVED/CALICO ASTER	FACW		

SEED MIX NOTES:


- 1. APPLICATION RATE: 23 LBS/ACRE, 1900 SQ. FT./LB
- 2. USE THE ABOVE "NEW ENGLAND WILDFLOWER MIX" TO RESTORE THE STOCKPILE AREA AFTER CONSTRUCTION.
- 3. FOR APPROX. 7,600 S.F. STOCKPILE AREA AND 15,000 S.F. PLANTING ALONG WETLAND BUFFER (22,600 S.F. TOTAL), UTILIZE 4 LBS± OF SEED MIX. COST IS APPROX. \$75/LB.
- 4. THIS MIX CAN BE APPLIED BY HYDRO—SEEDING (NO TACKIFIERS), BY MECHANICAL SPREADER, OR BY HAND. LIGHTLY RAKE OR ROLL AFTER SOWING TO INCREASE SEED TO SOIL CONTACT. APPLY ON A CLEAN, WEED FREE SEED BED, BEST RESULTS ARE OBTAINED WITH A SPRING OR LATE FALL DORMANT SEEDING.
- 5. SOURCE: NEW ENGLAND WETLAND PLANTS, INC., 820 WEST STREET, AMHERST, MA 01002. PHONE: 413-548-8000. EMAIL: INFO@NEWP.COM, WEB: WWW.NEWP.COM

GRAPHIC SCALE (IN FEET) 1 inch = 50 feet- PLANT 1 INCH ABOVE SURROUNDING GROUND 3" PINE BARK MULCH ON WEED FABRIC. DO NOT COVER STEMS OR TRUNK. SLOPE SOIL TO FORM SAUCER - PLANT BACK FILL MIXTURE (为 COMPOST, % LOAM) - EXISTING OR COMPACTED SUBGRADE 8"-12" COMPACTED UNSCREENED TOPSOIL REQUIRED WHERE SUBGRADE MATERIALS ARE ROCK AND GRAVEL HOLE - THREE TIMES ROOT BALL DIAMETER LOOSEN ROOTS AT THE OUTER WITH SLOPED SIDES EDGE OF ROOT BALL OF CONTAINER GROWN SHRUBS. SHRUB PLANTING

NOT TO SCALE

LANDSCAPE NOTES:

- 1. THE CONTRACTOR SHALL LOCATE AND VERIFY THE EXISTENCE OF ALL UTILITIES PRIOR TO STARTING WORK.
- FOCAL POINT STORMWATER TREATMENT AREAS TO BE PLANTED WITH PERENNIAL GRASSES, CONEFLOWERS, DAYLILIES, BUTTERFLY MILKWEED, BEE BALM, BLUE FLAG IRIS, AND JOE PYE WEED. PLANT IN RANDOM GROUPINGS OF 10-12 PLANTS APPROXIMATELY 3 FEFT ON CENTER.
- 3. THE CONTRACTOR SHALL SUPPLY ALL PLANT MATERIALS IN QUANTITIES SUFFICIENT TO COMPLETE THE PLANTINGS SHOWN ON THE DRAWINGS.
- ALL MATERIAL SHALL CONFORM TO THE GUIDELINES ESTABLISHED BY THE CURRENT AMERICAN STANDARD FOR NURSERY STOCK PUBLISHED BY THE AMERICAN ASSOCIATION OF NURSERYMEN.
- PLANTS SHALL BE SUBJECT TO INSPECTION AND APPROVAL AT THE PLACE OF GROWTH, UPON DELIVERY OR AT THE JOB SITE WHILE WORK IS ON-GOING FOR CONFORMITY TO SPECIFIED QUALITY, SIZE AND VARIETY.
- PLANTS FURNISHED IN CONTAINERS SHALL HAVE THE ROOTS WELL ESTABLISHED IN THE SOIL MASS AND SHALL HAVE AT LEAST ONE (1) GROWING SEASON. ROOT-BOUND PLANTS OR INADEQUATELY SIZED CONTAINERS TO SUPPORT THE PLANT MAY BE DEEMED UNACCEPTABLE.
- ALL WORK AND PLANTS SHALL BE DONE, INSTALLED AND DETAILED IN STRICT ACCORDANCE WITH PROJECT SPECIFICATIONS.
- ALL PLANTS SHALL BE WATERED THOROUGHLY TWICE DURING THE FIRST 24—HOUR PERIOD AFTER PLANTING. ALL PLANTS SHALL BE WATERED WEEKLY, OR MORE OFTEN IF NECESSARY, DURING THE FIRST GROWING SEASON.
- . ALL LANDSCAPE AREAS TO BE GRASS COMMON TO REGION, EXCEPT FOR INTERIOR LANDSCAPED ISLANDS OR WHERE OTHER PLANT MATERIAL IS SPECIFIED.
- 10. ALL TREES AND SHRUBS SHALL BE PLANTED IN MULCH BEDS WITH EDGE STRIPS TO SEPARATE TURF GRASS AREAS.
- 11. THE CONTRACTOR SHALL REMOVE WEEDS, ROCKS, CONSTRUCTION ITEMS, ETC. FROM ANY LANDSCAPE AREA SO DESIGNATED TO REMAIN, WHETHER ON OR OFF—SITE. GRASS SEED OR PINE BARK MULCH SHALL BE APPLIED AS DEPICTED ON PLANS.
- 12. FINISHED GRADES IN LANDSCAPED ISLANDS SHALL BE INSTALLED SO THAT THEY ARE 1" HIGHER THAN THE TOP OF THE SURROUNDING CURB.
- 13. ALL LANDSCAPING SHALL MEET THE TOWN STANDARDS AND REGULATIONS.
- 14. EXISTING TREES TO REMAIN SHALL BE PROTECTED WITH TEMPORARY SNOW FENCING AT THE DRIPLINE OF THE TREE. THE CONTRACTOR SHALL NOT STORE VEHICLES OR MATERIALS WITHIN THE LANDSCAPED AREAS. ANY DAMAGE TO EXISTING TREES, SHRUBS OR LAWN SHALL BE REPAIRED BY THE CONTRACTOR AT NO ADDITIONAL COST TO THE OWNER.
- 15. ALL MULCH AREAS SHALL RECEIVE A 3" LAYER OF SHREDDED PINE BARK MULCH OVER A 10 MIL WEED MAT EQUAL TO 'WEEDBLOCK' BY EASY GARDENER OR DEWITT WEED BARRIER.
- 16. ALL LANDSCAPED AREAS SHALL HAVE SELECT MATERIALS REMOVED TO A DEPTH OF AT LEAST 9" BELOW FINISH GRADE.
 THE RESULTING VOID IS TO BE FILLED WITH A MINIMUM OF 9" HIGH-QUALITY SCREENED LOAM AMENDED WITH 3" OF AGED
 ORGANIC COMPOST
- 17. THIS PLAN IS INTENDED FOR LANDSCAPING PURPOSES ONLY. REFER TO CIVIL/SITE DRAWINGS FOR OTHER SITE CONSTRUCTION INFORMATION.
- 18. IRRIGATION PIPING SYSTEM SHALL BE REVIEWED AND APPROVED BY OWNER AND ENGINEER PRIOR TO INSTALLATION.
- 19. THE PROPERTY OWNER AND ALL FUTURE PROPERTY OWNERS SHALL BE RESPONSIBLE FOR THE MAINTENANCE, REPAIR, AND REPLACEMENT OF ALL REQUIRED SCREENING AND LANDSCAPE MATERIALS.
- 20. ALL REQUIRED PLANT MATERIALS SHALL BE TENDED AND MAINTAINED IN A HEALTHY GROWING CONDITION, REPLACED WHEN NECESSARY, AND KEPT FREE OF REFUSE AND DEBRIS. ALL REQUIRED FENCES AND WALLS SHALL BE MAINTAINED IN GOOD
- 21. THE PROPERTY OWNER SHALL BE RESPONSIBLE TO REMOVE AND REPLACE DEAD OR DISEASED PLANT MATERIALS IMMEDIATELY WITH THE SAME TYPE, SIZE, AND QUANTITY OF PLANT MATERIALS AS ORIGINALLY INSTALLED, UNLESS ALTERNATIVE PLANTINGS ARE REQUESTED, JUSTIFIED, AND APPROVED BY THE PLANNING BOARD OR PLANNING DIRECTOR.
- 22. ALL BURLAP AND CAGES SHOULD BE REMOVED FOR LANDSCAPE PLANTS.
- 23. PLANTING IN WETLAND BUFFER WITHOUT FILLING OR DREDGING THE SAME AREA IS A PERMITTED USE PER SECTION 10.1016.10(1) OF THE CITY OF PORTSMOUTH ZONING ORDINANCE.

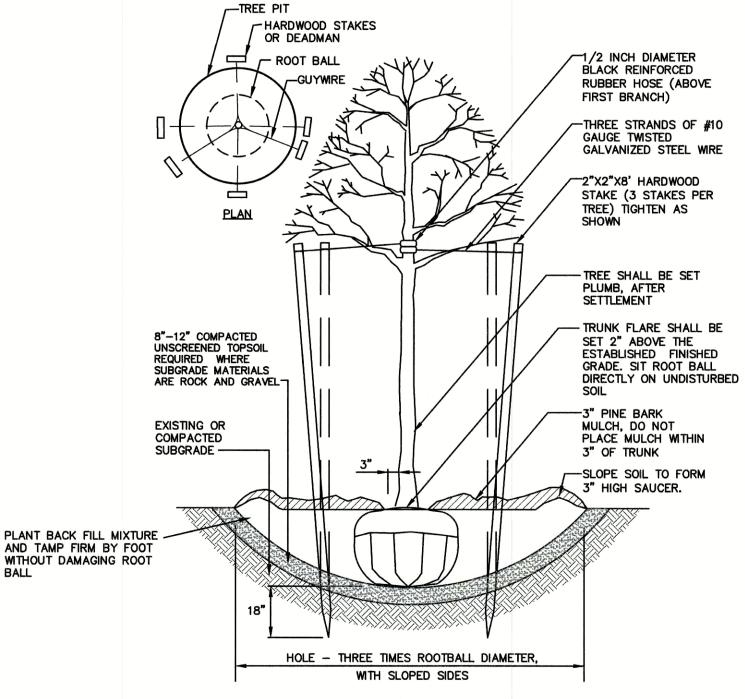

TREE PLANTING (FOR TREES UNDER 4" CALIPER)

NOT TO SCALE

Design: JAC Draft: DJM Date: 04/21/20
Checked: JAC Scale: AS-NOTED Project No.: 19190.2
Drawing Name: 19190-PLAN-NEW-LAYOUT.dwg
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7	13	6/23/21	REVISED PER CITY COMMENTS	DJM
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5	11	5/17/21	ISSUED REVISED PLANS TO TAC	DJM
i	10	5/10/21	ISSUED REVISED PLANS FOR PRELIMINARY PB CONSULTATION	DJM
ebr.la	9	3/9/21	REVISED CONCEPTUAL LAYOUT	DJM
	REV.	DATE	REVISION	BY

Designed and Produced in NH

P Jones & Beach Engineers, Inc.

85 Portsmouth Ave. PO Box 219
Stratham, NH 03885

Civil Engineering Services

603-772-4746
FAX: 603-772-0227
E-MAIL: JBE@JONESANDBEACH.COM

Plan Name:

Project:

LANDSCAPE PLAN

INDUSTRIAL WAREHOUSE 375 BANFIELD ROAD, PORTSMOUTH, NH 03801


Owner of Record:

BANFIELD REALTY LLC
304 MAPLEWOOD AVENUE, PORTSMOUTH, NH 03801

L **1**SHEET 7 OF 24

JBE PROJECT NO. 19190.2



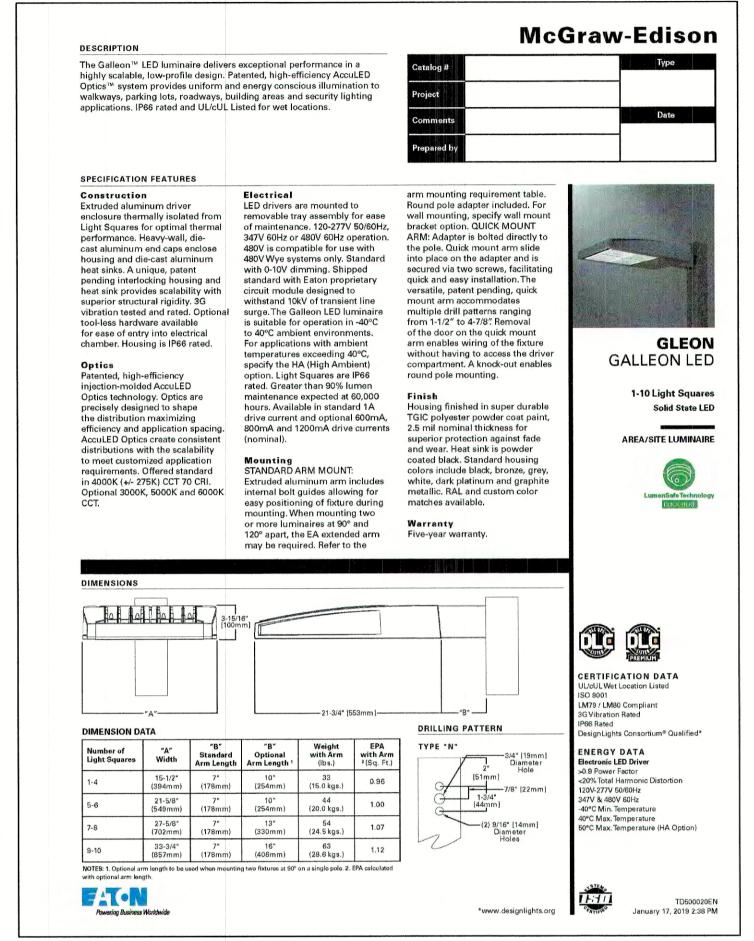



LIGHTING AND ELECTRICAL NOTES:

- 1. SITE ELECTRICAL CONTRACTOR SHALL COORDINATE LOCATION OF EASEMENTS, UNDERGROUND UTILITIES AND DRAINAGE BEFORE DRILLING POLE BASES.
- 2. CONTRACTOR SHALL INSTALL PROPOSED LIGHT POLES ACCORDING TO TOWN REGULATIONS.
- 3. ALL OUTDOOR LIGHTING SYSTEMS SHALL BE EQUIPPED WITH TIMERS TO REDUCE ILLUMINATION LEVELS TO NON-OPERATIONAL VALUES PER TOWN REGULATIONS.
- 4. LIGHTING CONDUIT SHALL BE SCHEDULE 40 PVC, AND SHALL BE INSTALLED IN CONFORMANCE WITH THE NATIONAL ELECTRICAL CODE. CONTRACTOR SHALL PROVIDE EXCAVATION AND BACKFILL.
- 5. ILLUMINATION READINGS SHOWN ARE BASED ON A TOTAL LLF OF 0.75 AT GRADE. ILLUMINATION READINGS SHOWN ARE IN UNITS OF FOOT—CANDLES.
- 6. LIGHTING CALCULATIONS SHOWN ARE NOT A SUBSTITUTE FOR INDEPENDENT ENGINEERING ANALYSIS OF LIGHTING SYSTEM AND SAFETY.
- 7. ALL LIGHTING FIXTURES SHALL BE FULL CUT-OFF DARK-SKY COMPLIANT, UNLESS OTHERWISE
- 8. NL INDICATES THAT THIS LUMINAIRE SHALL BE ON A NIGHT LIGHT CIRCUIT. FL INDICATES THAT THIS LUMINAIRE SHALL BE A FLOOD LIGHT FIXTURE. MOUNTING BRACKET FOR THIS FL FIXTURE SHALL BE MOUNTED 25' ABOVE BOTTOM OF POLE BASE FOR ALL LIGHT POLES. THESE

DESIGNATIONS INDICATE WHAT PHASE LIGHTS ARE WIRED TO (TYP).

9. THE PROPOSED LIGHTING CALCULATIONS AND DESIGN WAS PERFORMED BY CHARRON, INC., P.O. BOX 4550, MANCHESTER, NH 03108, ATTENTION KEN SWEENEY. ALL LIGHTS SHOULD BE PURCHASED FROM THIS COMPANY OR ONE OF THEIR SUPPLIERS, OR AN EQUAL LIGHTING DESIGN SHOULD BE SUBMITTED FOR REVIEW IF EQUAL SUBSTITUTIONS ARE PROPOSED BY THE CONTRACTOR OR OWNER.

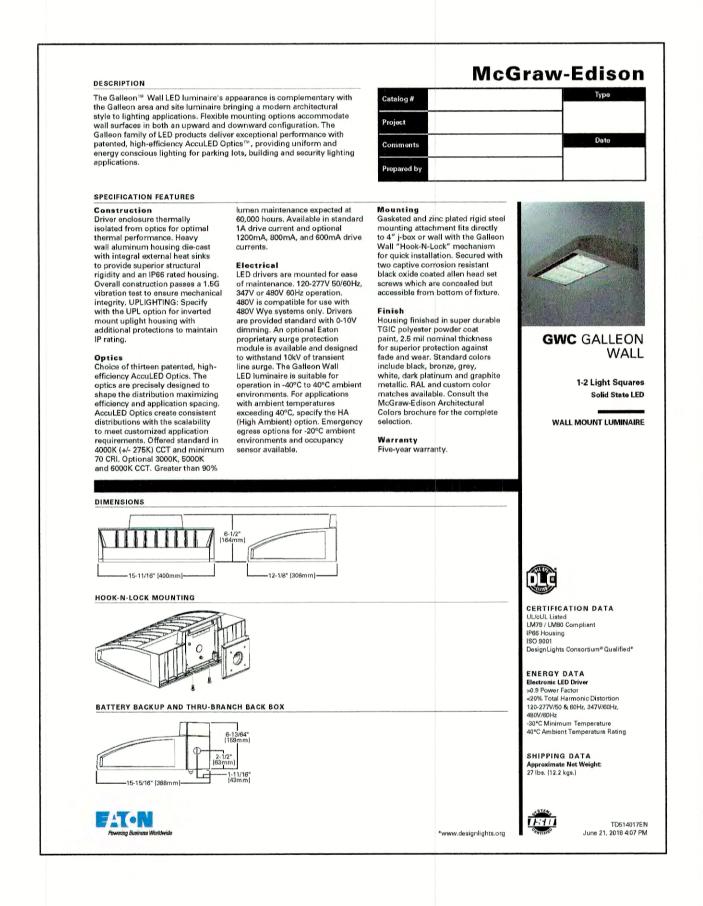

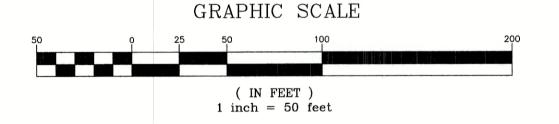

Symbol	Qty	Label	Arrangement	Description
-	1	S3	SINGLE	GLEON-AF-01-LED-E1-SL3-HSS/ SSS4A20SFN1 (20' AFG)
	4	S4	SINGLE	GLEON-AF-01-LED-E1-SL4-HSS/ SSS4A20SFN1 (20' AFG)
<u> </u>	2	W	SINGLE	GWC-AF-02-LED-E1-T4FT/ WALL MTD 20' AFG
T ₁	9	W 4	SINGLE	GWC-AF-01-LED-E1-SL4-600/ WALL MTD 15' AFG

EB	Design: JAC	Draft: DJM	Date: 04/21/20				
SI	Checked: JAC	Scale: AS-NOTED	Project No.: 19190.2				
MA	Drawing Name:	19190-PLAN-NEW-L	Project No.: 19190.2 AYOUT.dwg				
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3	10	5/10/21	ISSUED REVISED PLANS FOR PRELIMINARY PB CONSULTATION	DJM
9	9	3/9/21	REVISED CONCEPTUAL LAYOUT	DJM
	REV.	DATE	REVISION	BY

Designed and Produced in NH

Jones & Beach Engineers, Inc.

85 Portsmouth Ave. PO Box 219
Stratham, NH 03885

Civil Engineering Services

FAX: 603-772-4746
FAX: 603-772-0227
E-MAIL: JBE@JONESANDBEACH.COM

Plan	Name:


Owner of Record:

LIGHTING PLAN

BANFIELD REALTY LLC 304 MAPLEWOOD AVENUE, PORTSMOUTH, NH 03801

INDUSTRIAL WAREHOUSE 375 BANFIELD ROAD, PORTSMOUTH, NH 03801 L2

SHEET 8 OF 24 JBE PROJECT NO. 19190.2

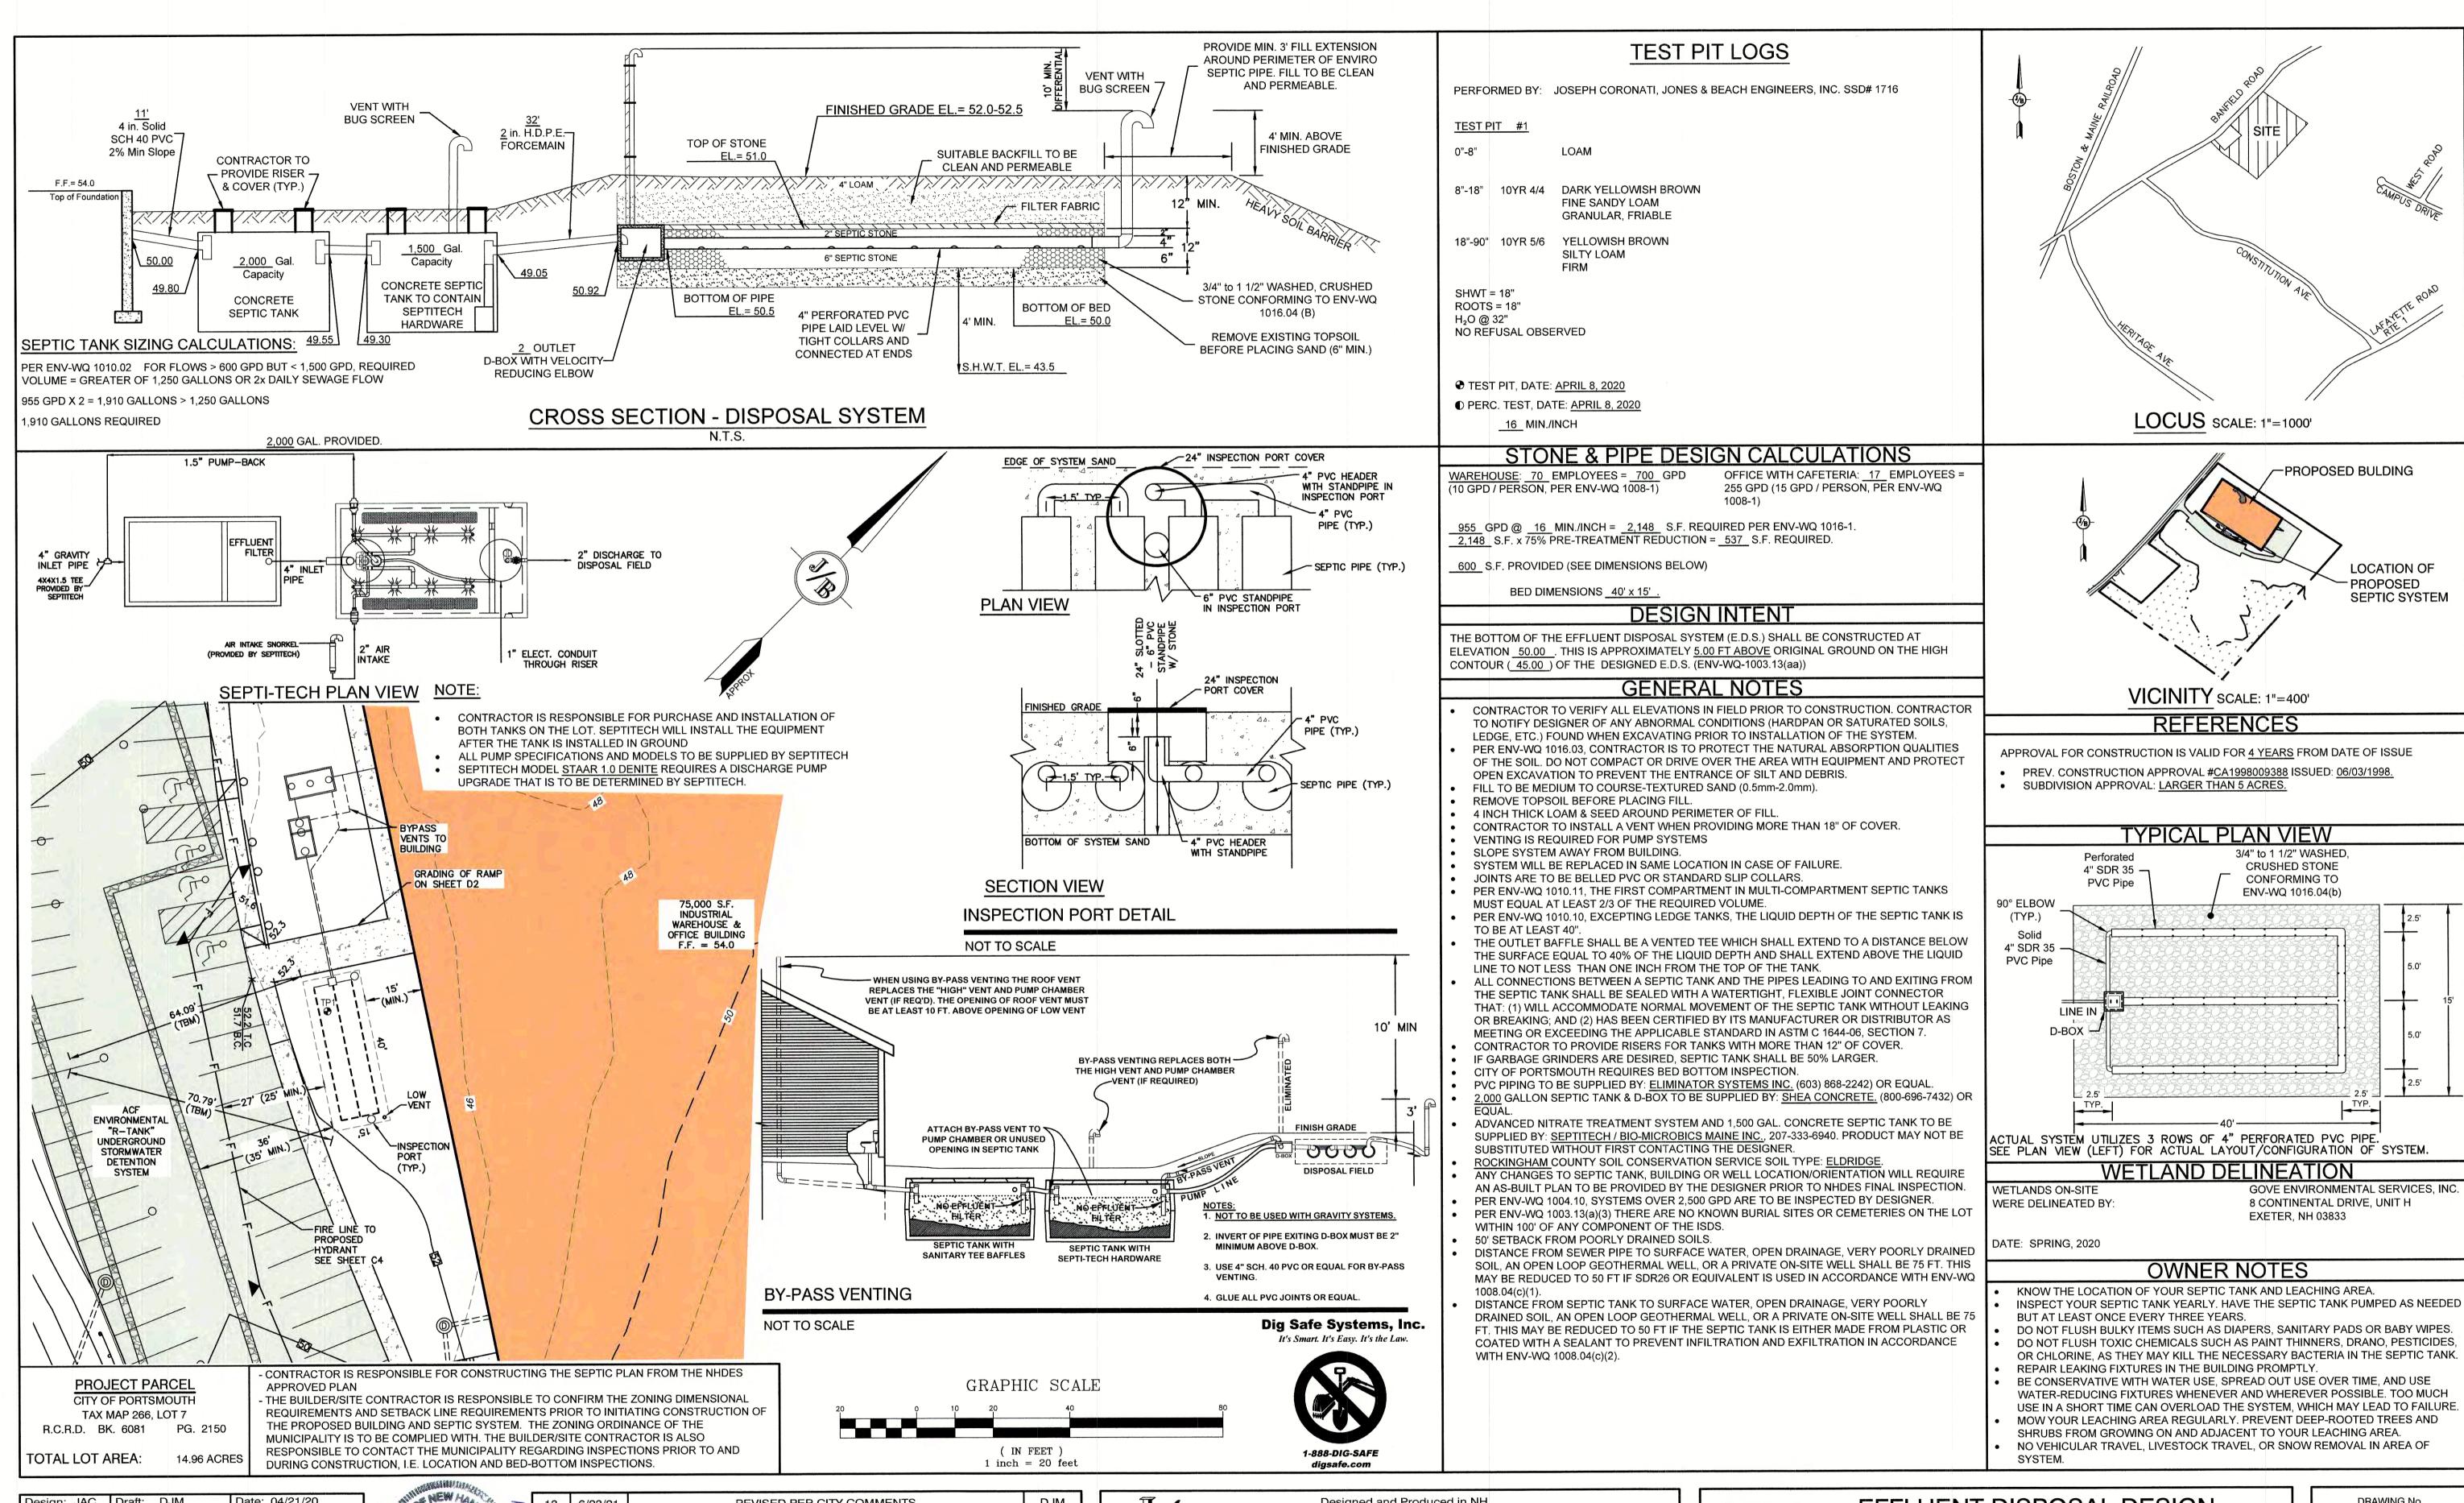

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Plan Name:

Owner of Record:

EFFLUENT DISPOSAL DESIGN

INDUSTRIAL WAREHOUSE

375 BANFIELD ROAD, PORTSMOUTH, NH 03801 BANFIELD REALTY LLC

304 MAPLEWOOD AVENUE, PORTSMOUTH, NH 03801

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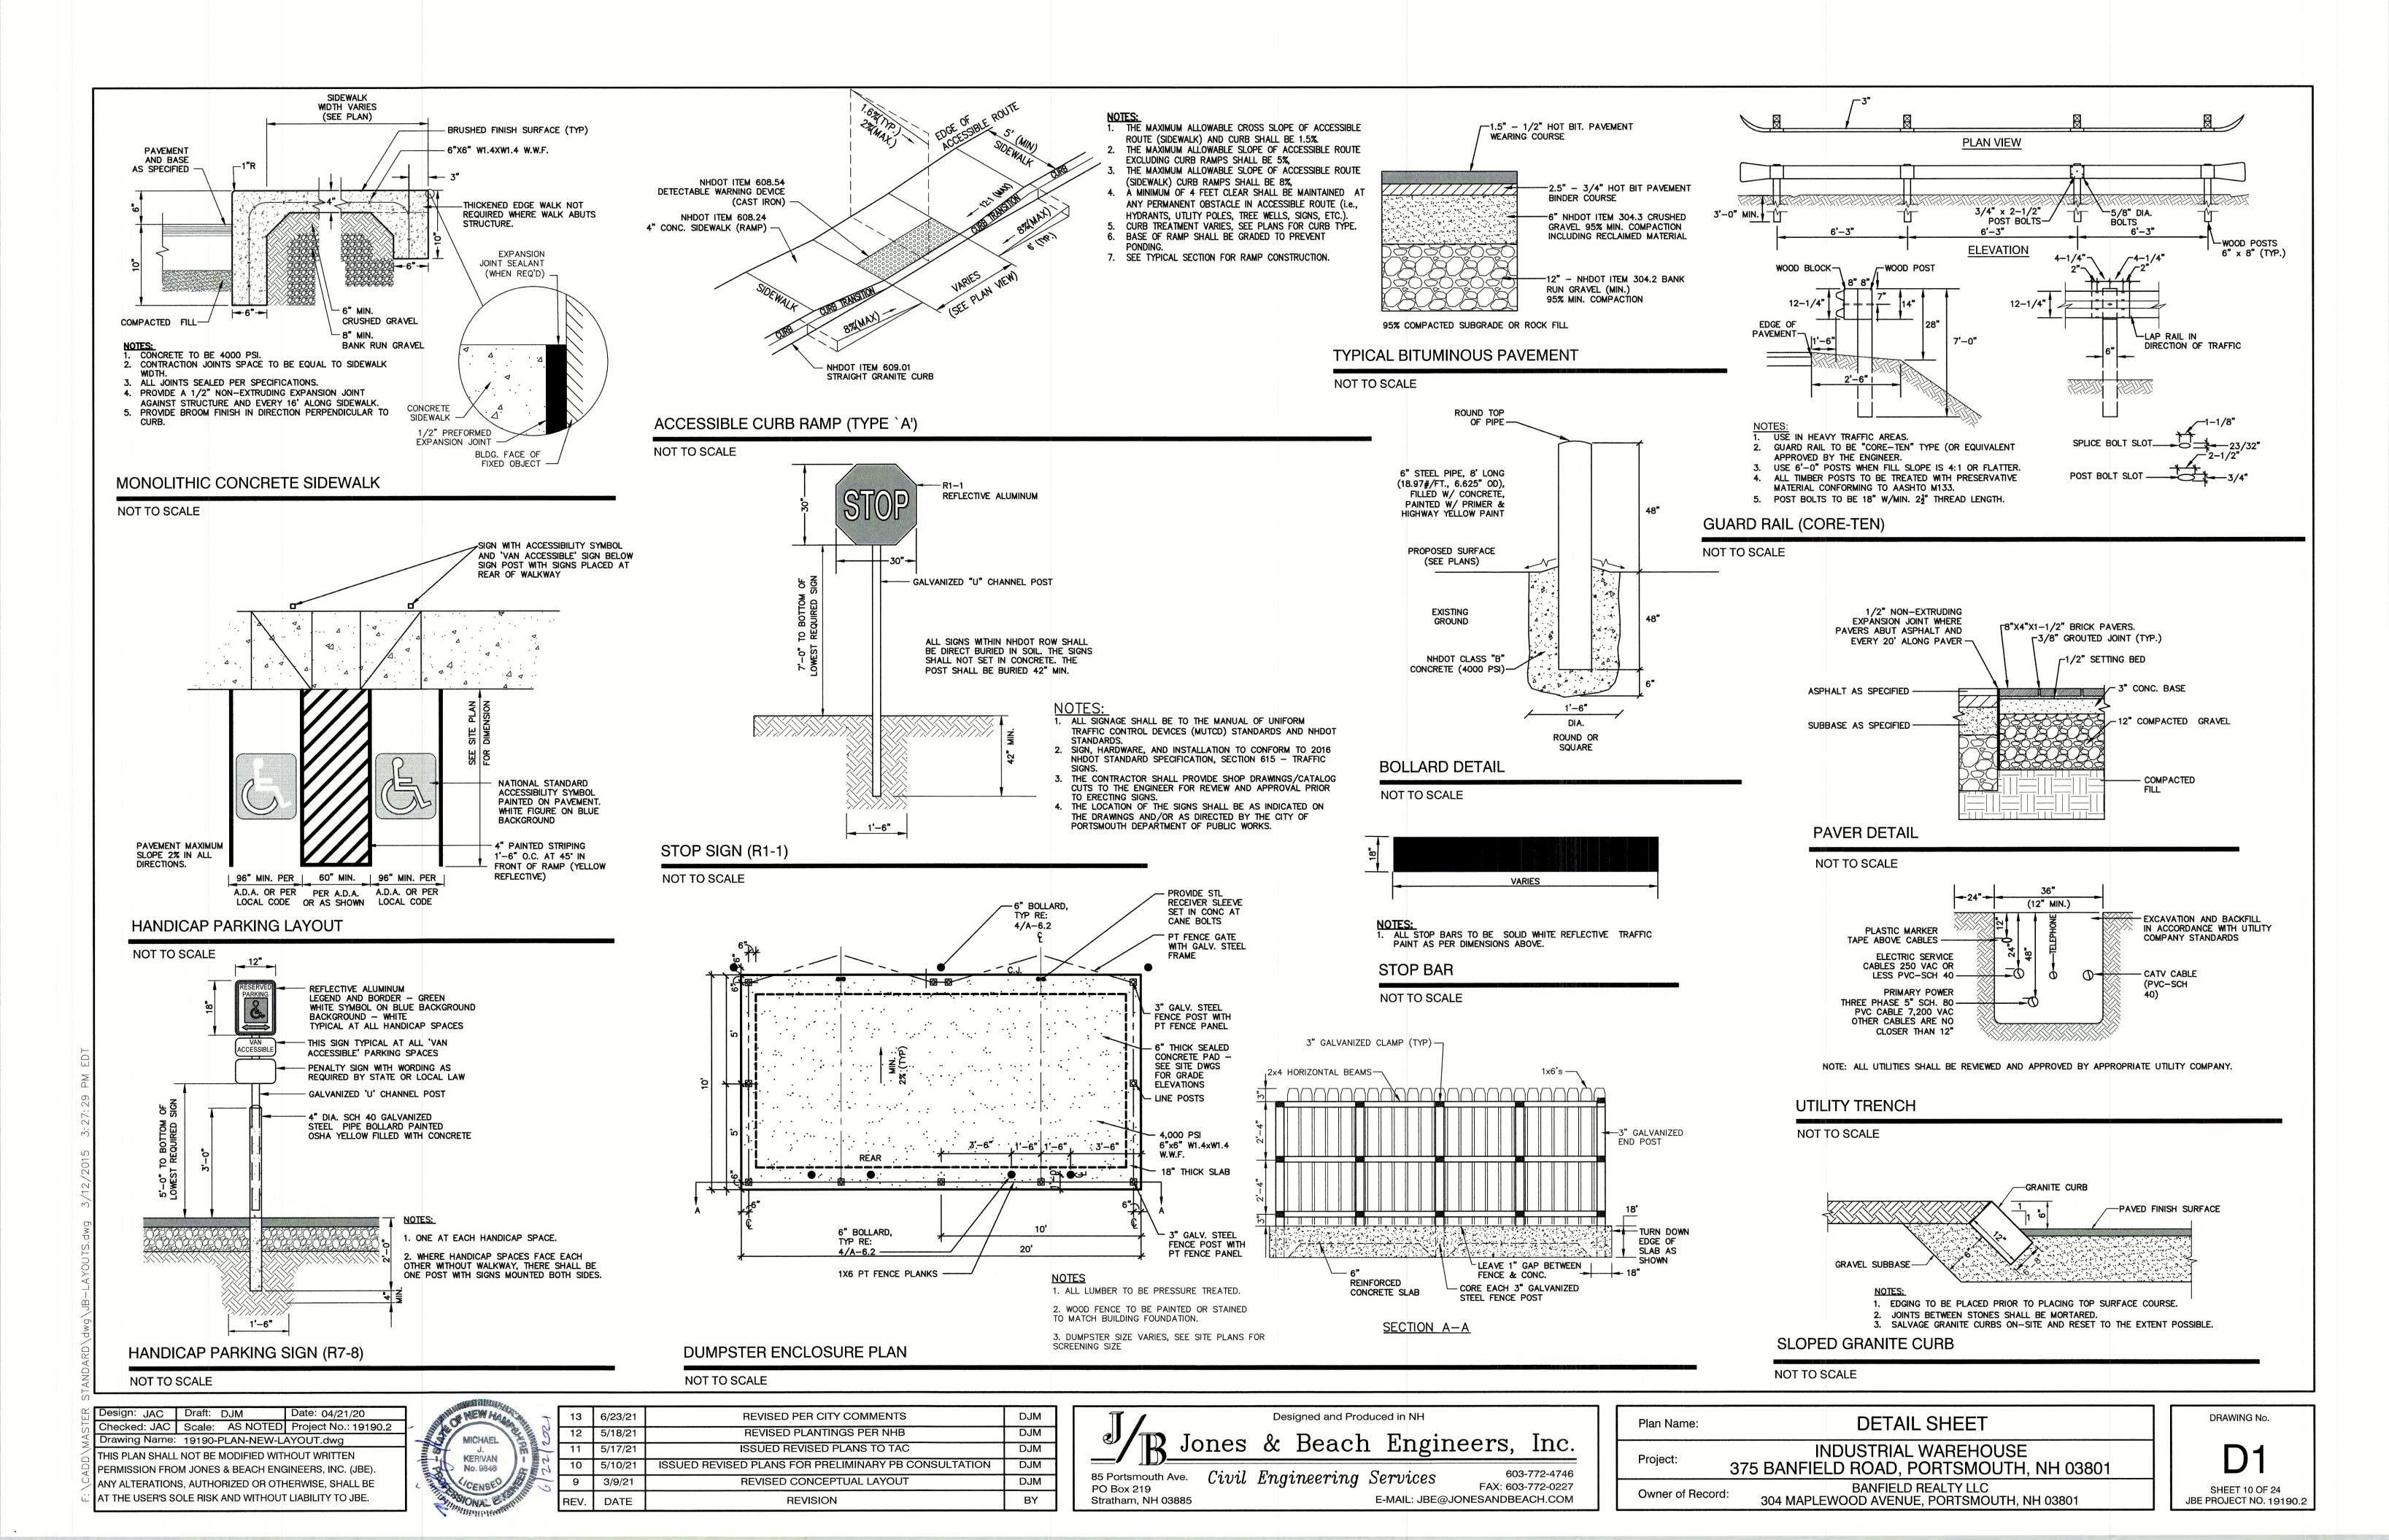
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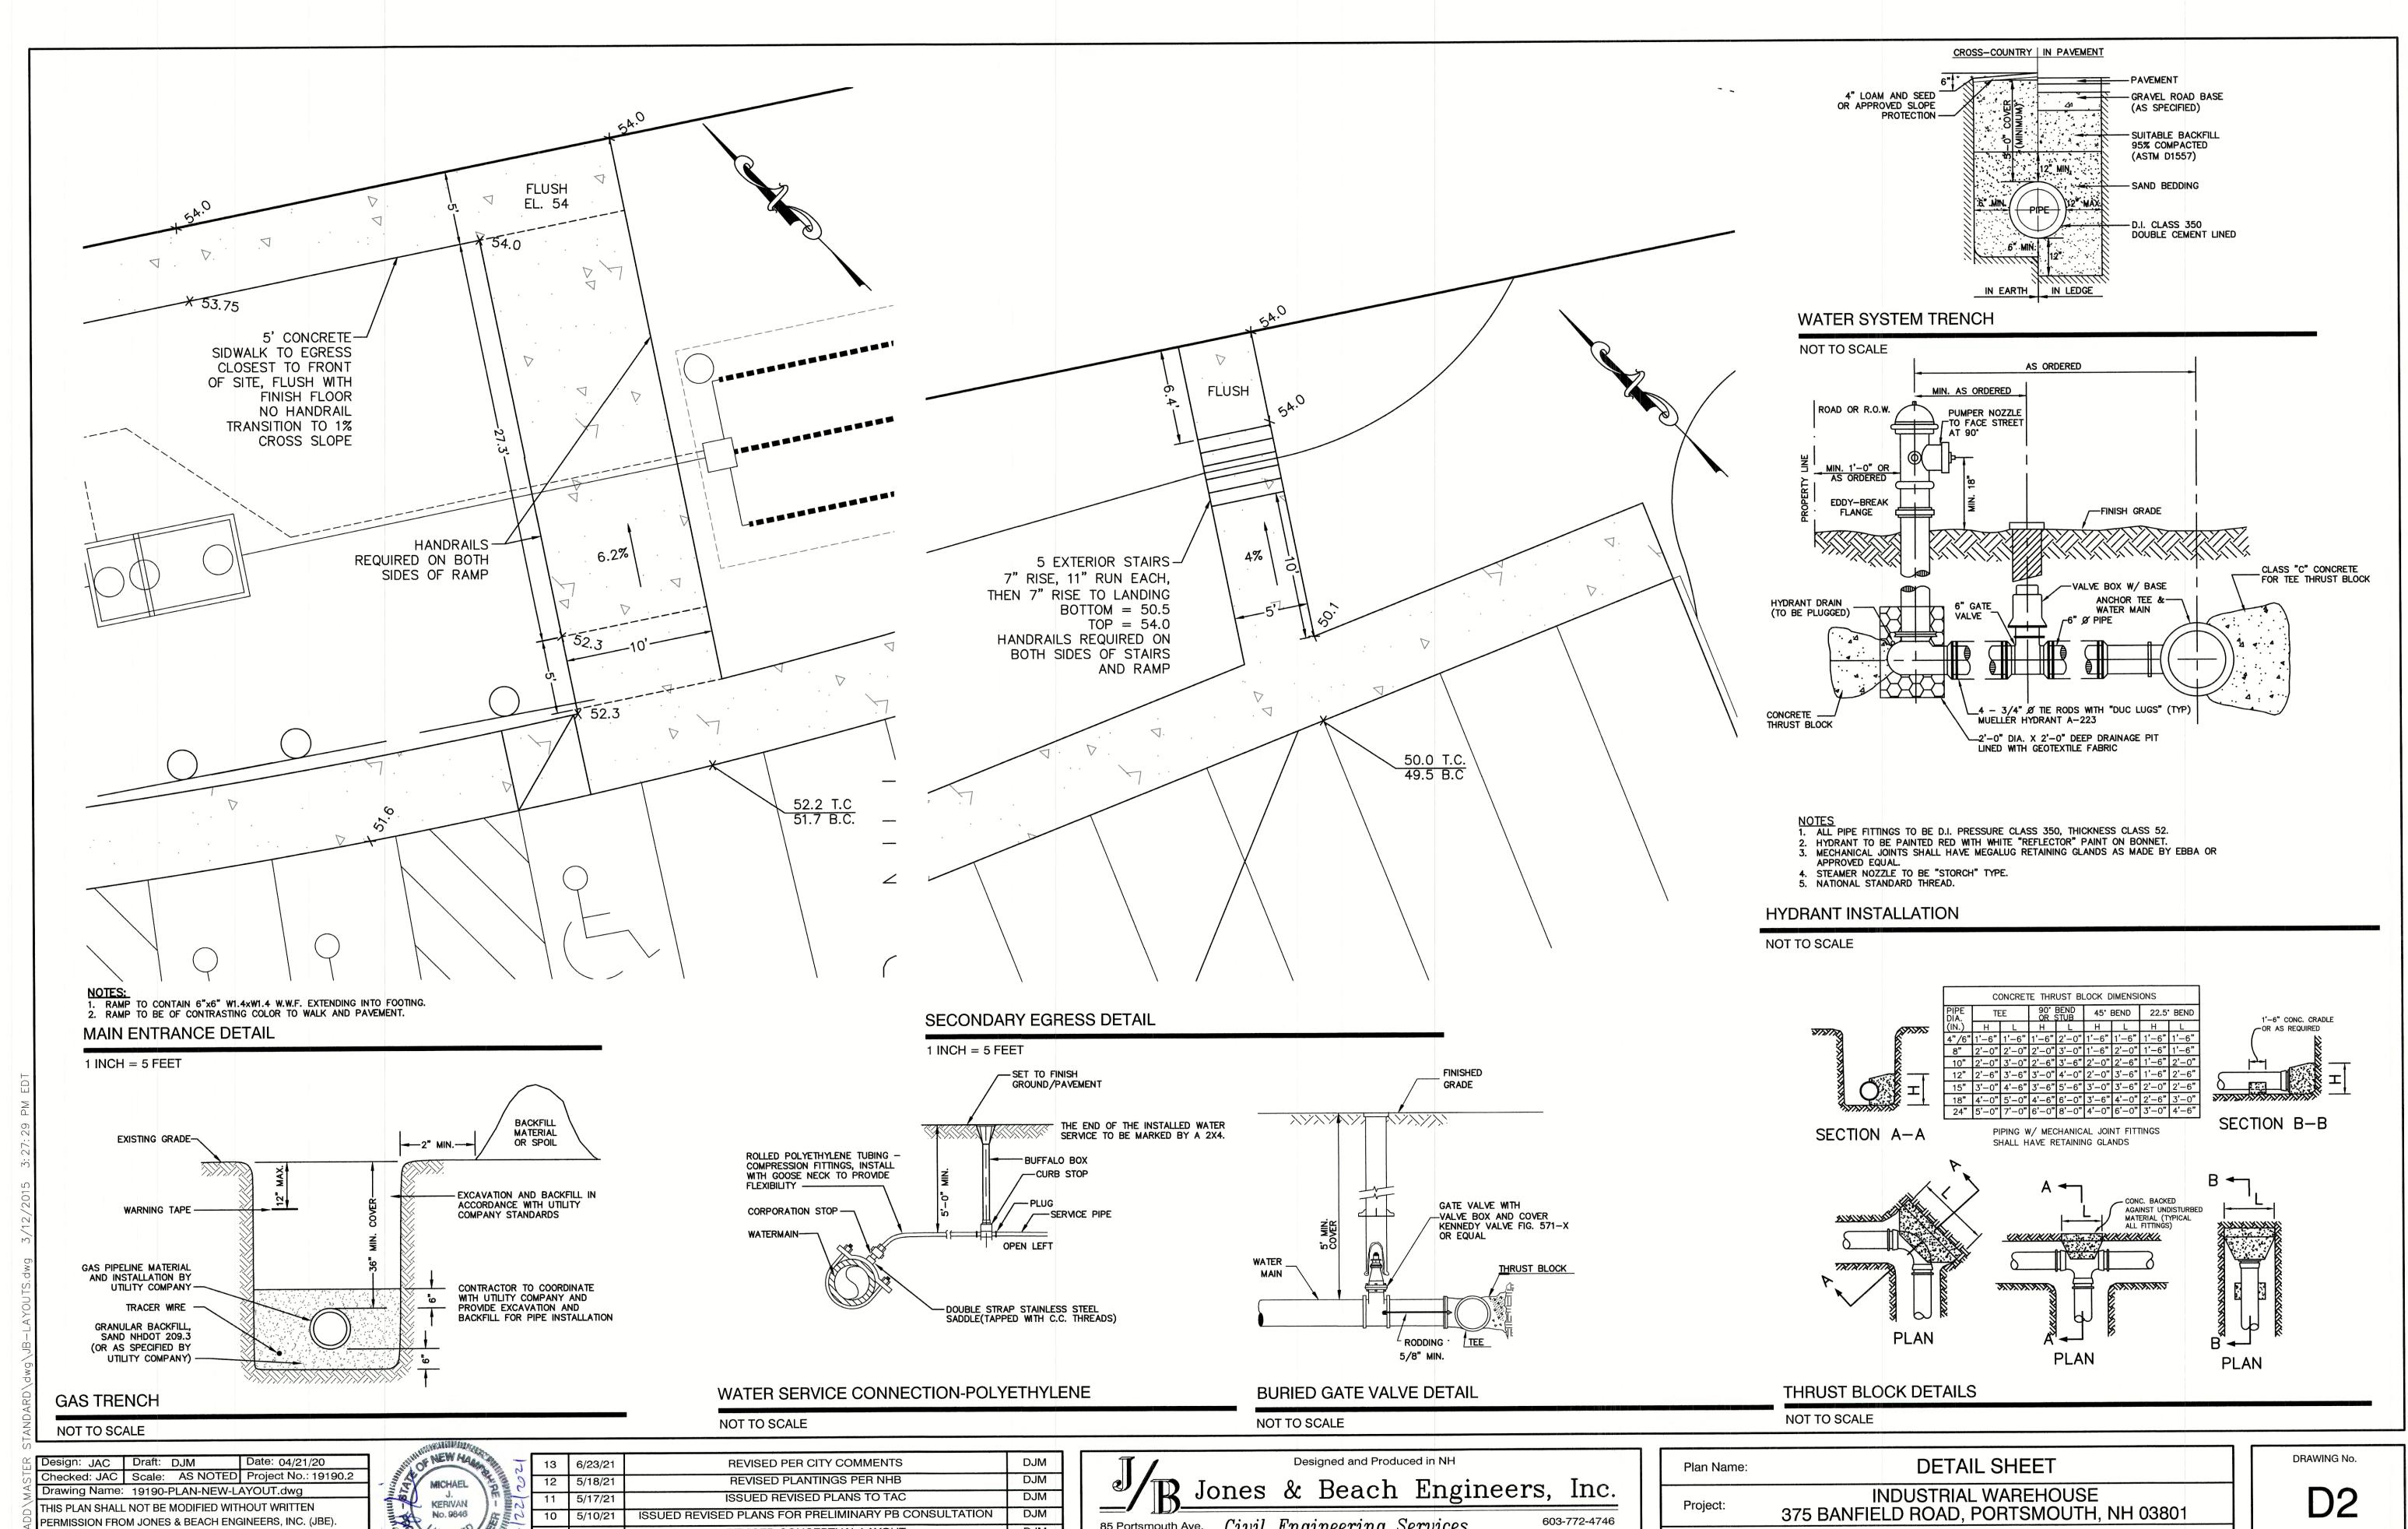
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LOCATION OF

SEPTIC SYSTEM

PROPOSED






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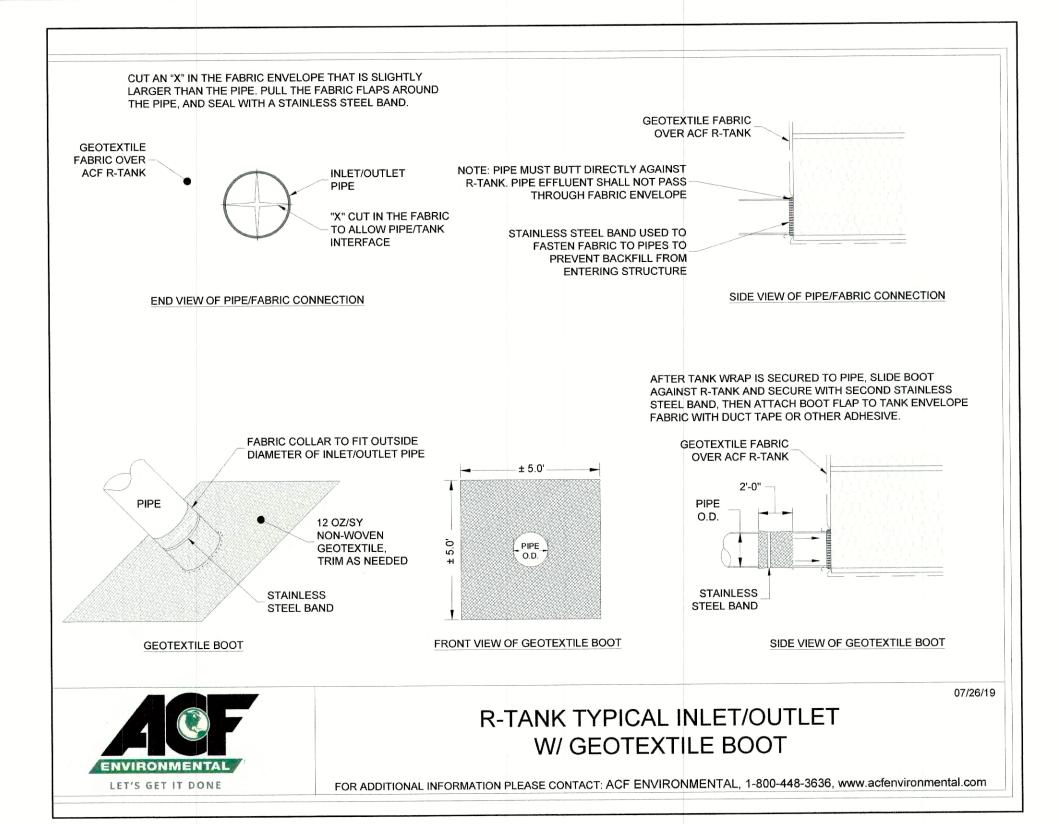
REVISED CONCEPTUAL LAYOUT DJM 9 3/9/21 BY REVISION REV. DATE


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BANFIELD REALTY LLC 304 MAPLEWOOD AVENUE, PORTSMOUTH, NH 03801 Owner of Record:

SHEET 11 OF 24 JBE PROJECT NO. 19190.2







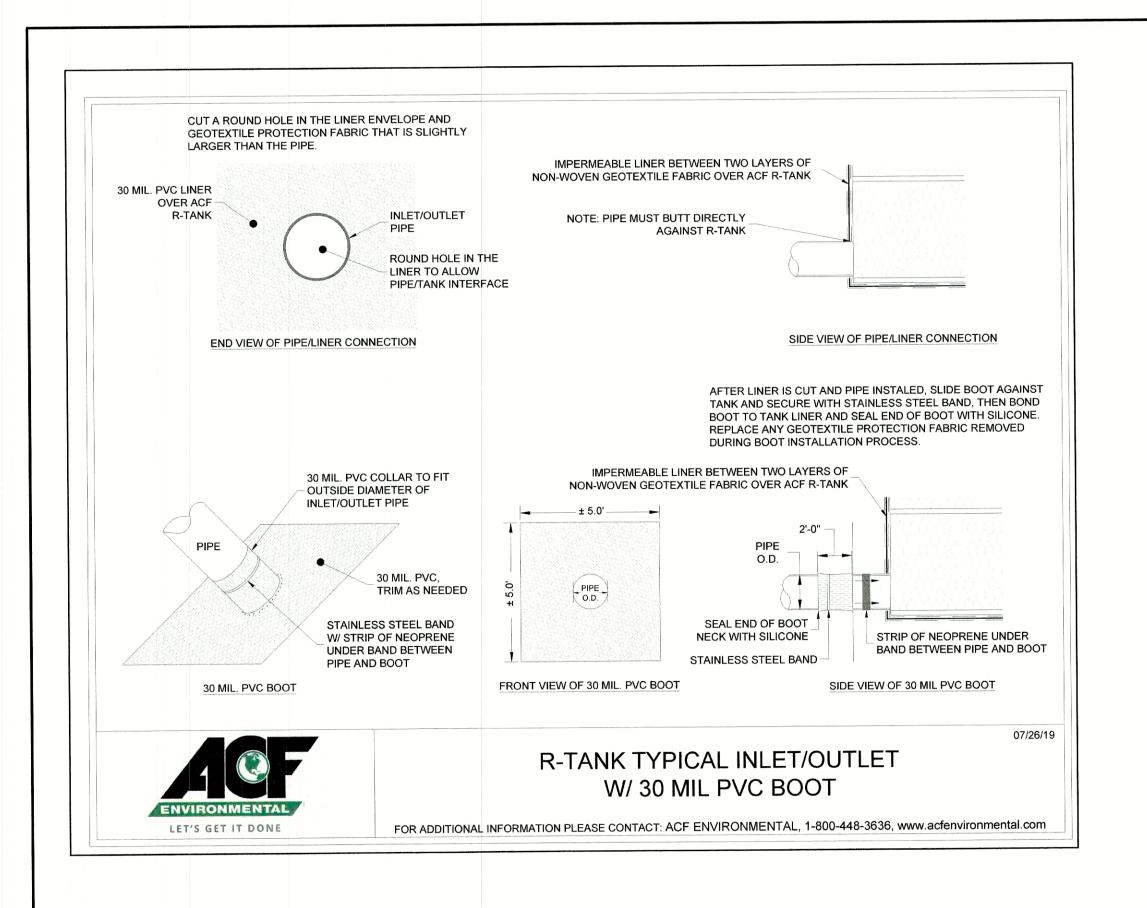

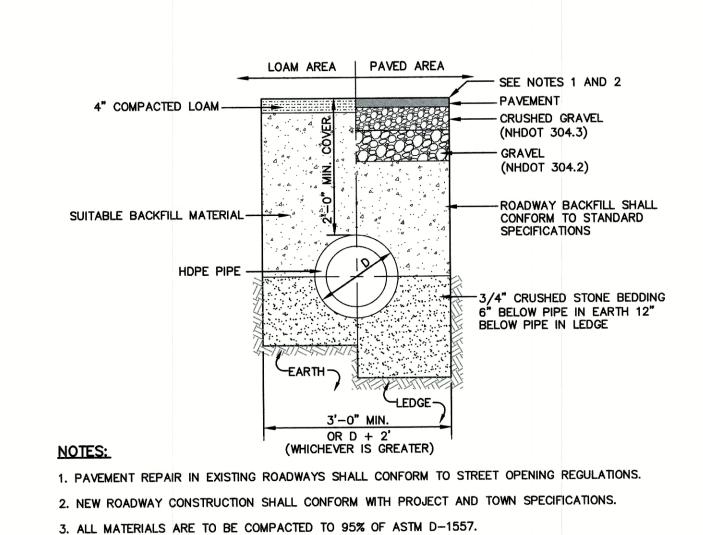
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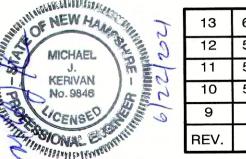




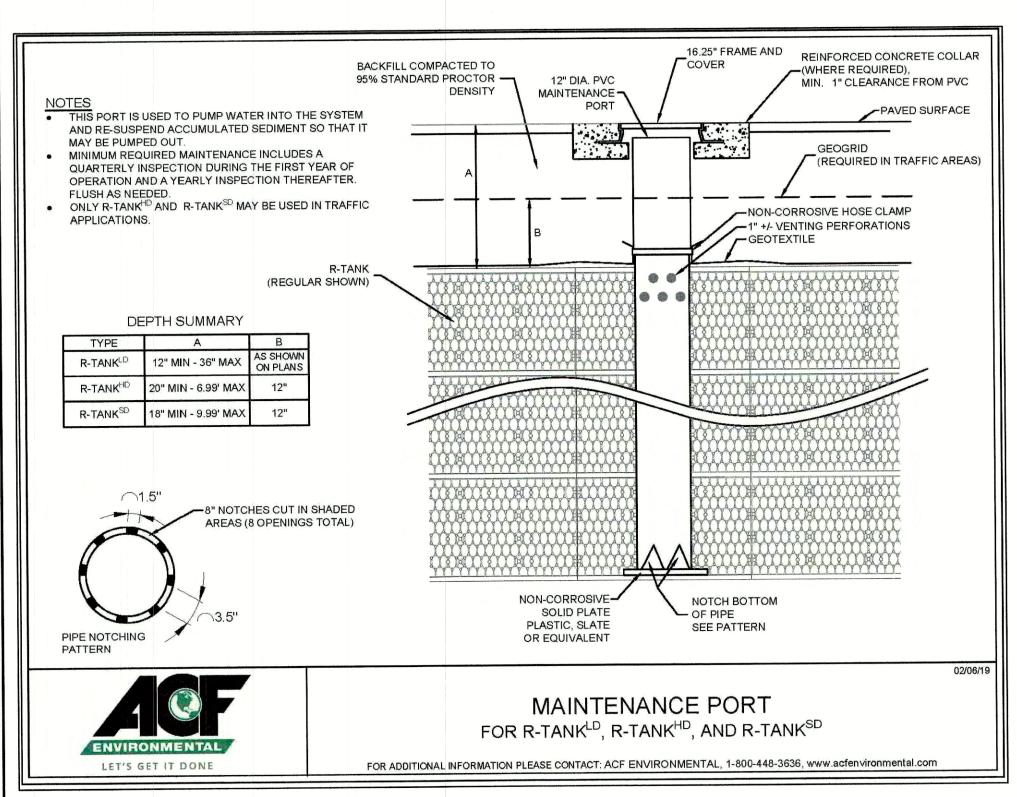


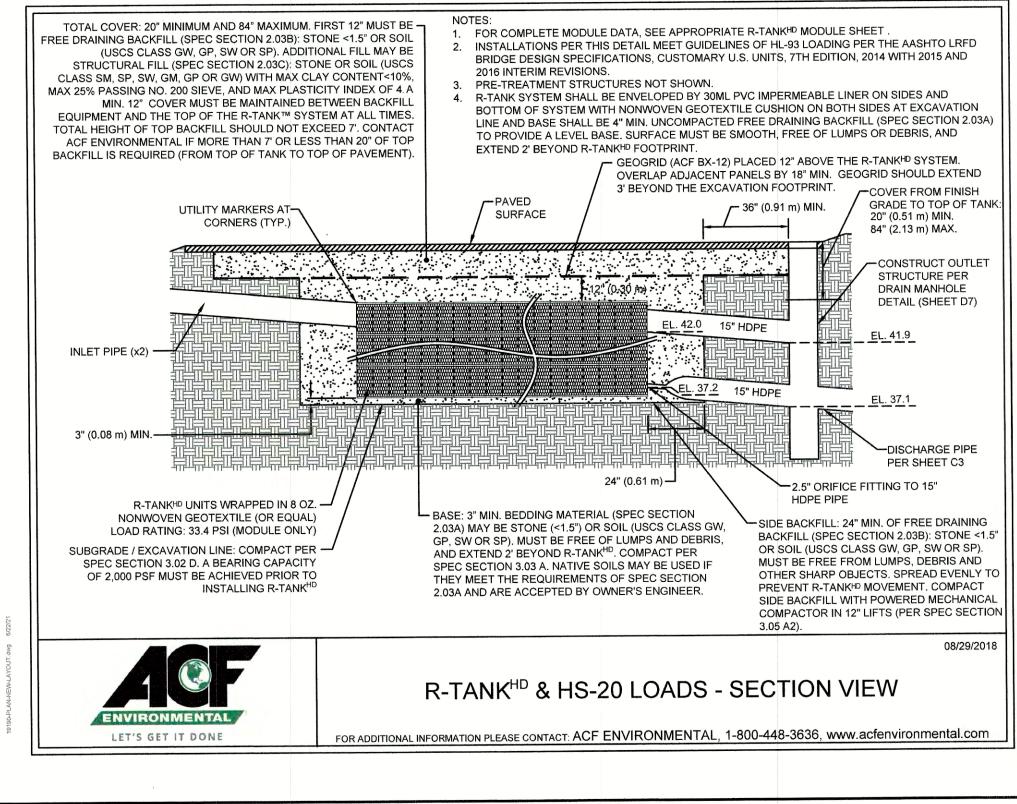FOR ADDITIONAL INFORMATION PLEASE CONTACT: ACF ENVIRONMENTAL, 1-800-448-3636, www.acfenvironmental.com
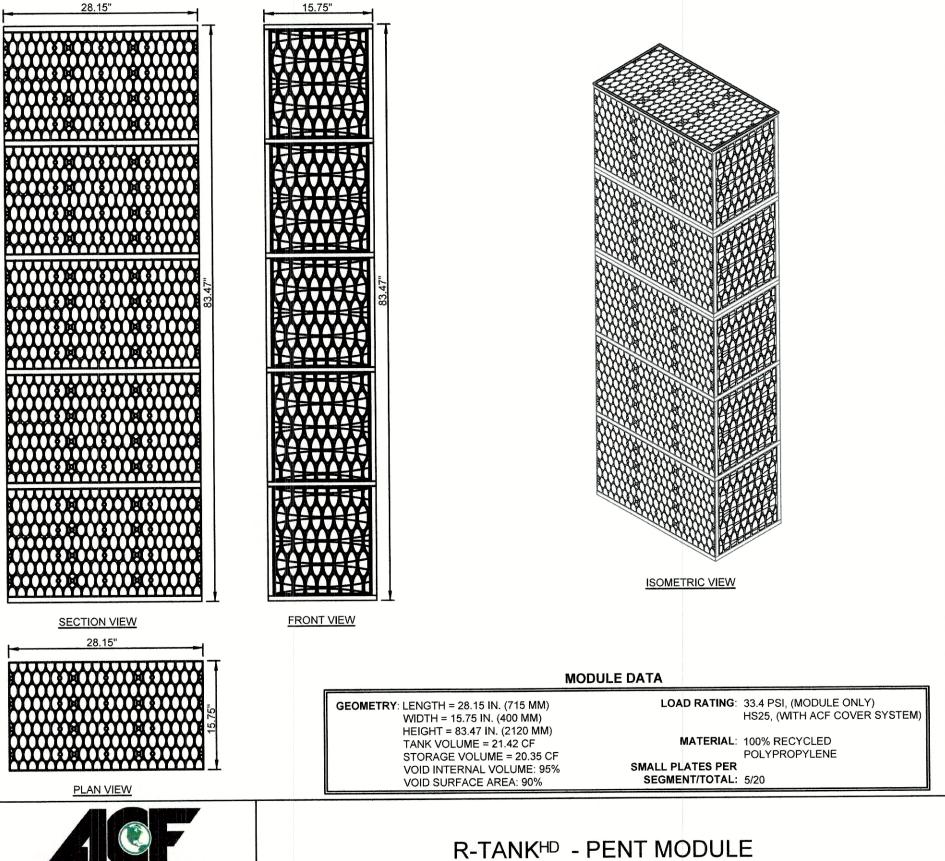
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F	9	3/9/21	REVISED CONCEPTUAL LAYOUT	DJM
F	REV.	DATE	REVISION	BY



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	Plan Name:	DETAIL SHEET	
	Project:	INDUSTRIAL WAREHOUSE 375 BANFIELD ROAD, PORTSMOUTH, NH 03801	

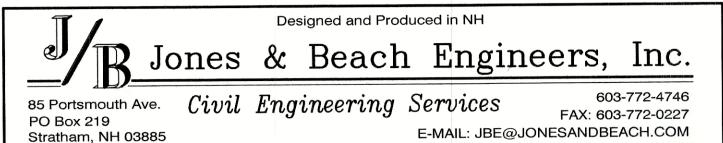BANFIELD REALTY LLC

304 MAPLEWOOD AVENUE, PORTSMOUTH, NH 03801

LET'S GET IT DONE

Owner of Record:

D3

SHEET 12 OF 24

JBE PROJECT NO. 19190.2

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Plan Name:	DETAIL SHEET
Project:	INDUSTRIAL WAREHOUSE 375 BANFIELD ROAD, PORTSMOUTH, NH 03801
	. BANFIELD REALTY LLC


304 MAPLEWOOD AVENUE, PORTSMOUTH, NH 03801


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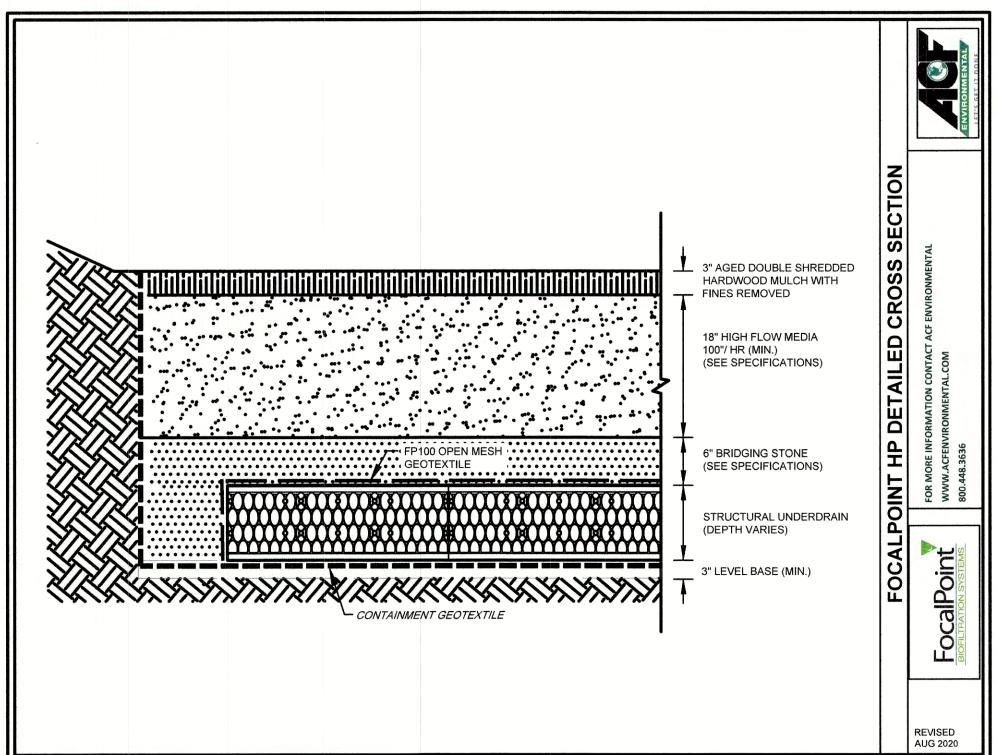
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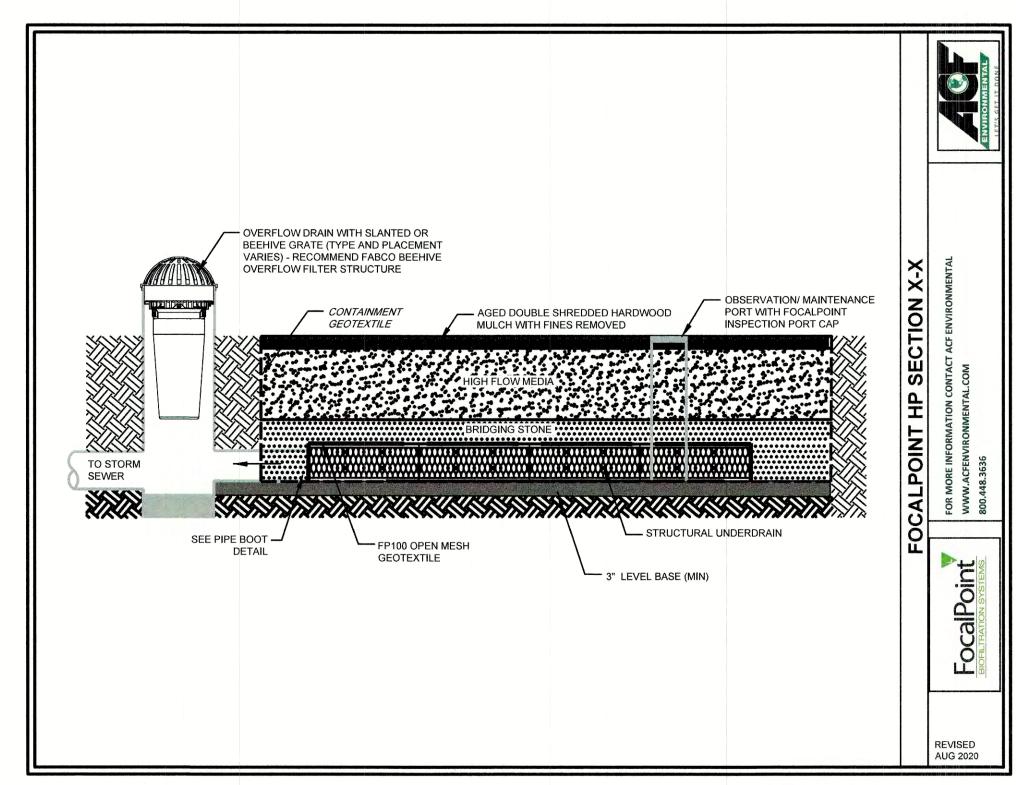
SHEET 13 OF 24

JBE PROJECT NO. 19190.2





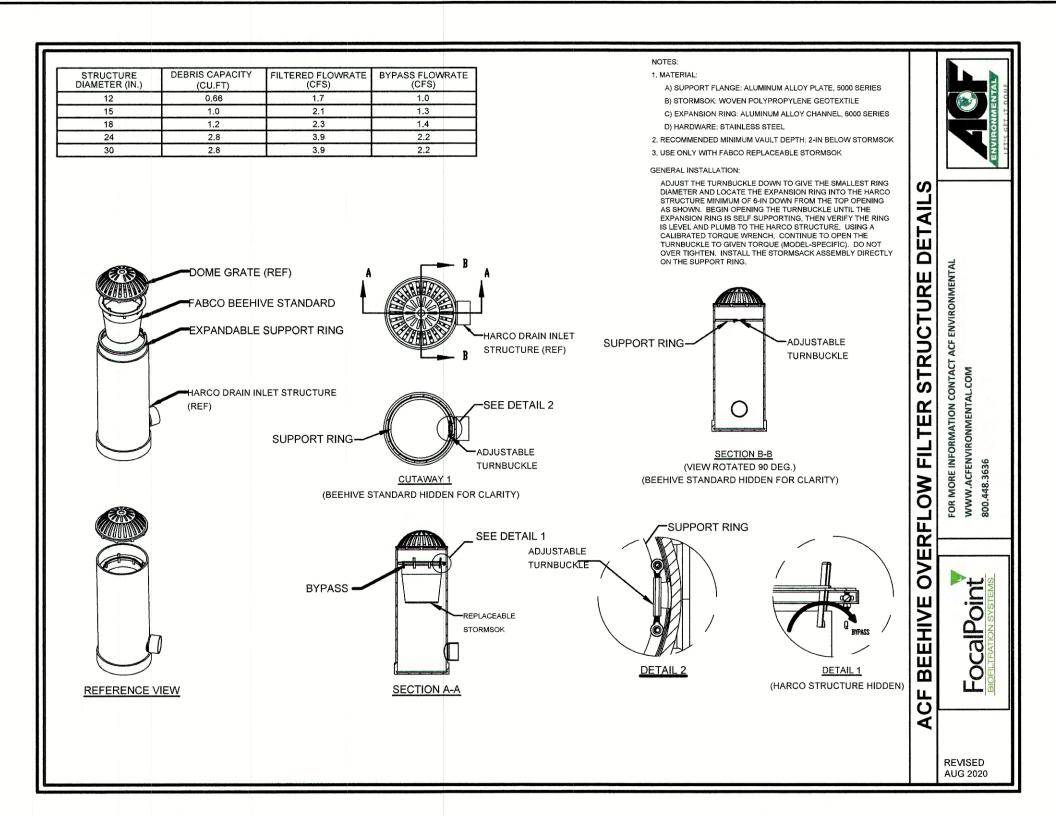

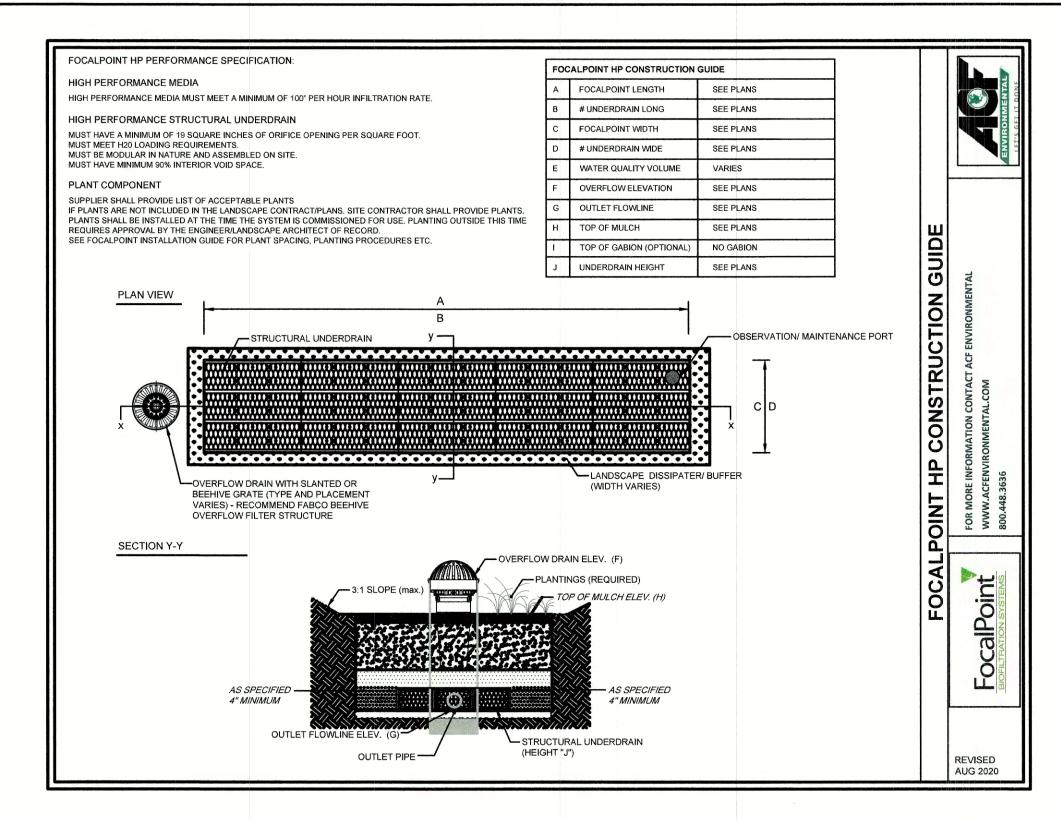

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Stratham, NH 03885

E-MAIL: JBE@JONESANDBEACH.COM

n	Name:			


DETAIL SHEET INDUSTRIAL WAREHOUSE 375 BANFIELD ROAD, PORTSMOUTH, NH 03801


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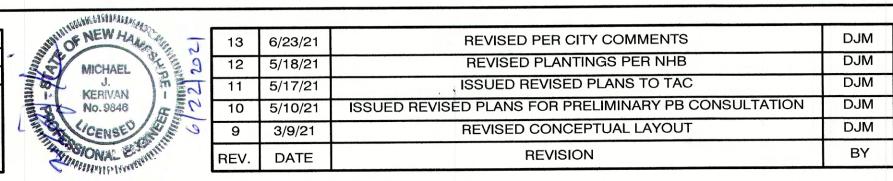
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DRAWING No. SHEET 14 OF 24 JBE PROJECT NO. 19190.2





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Stratham, NH 03885

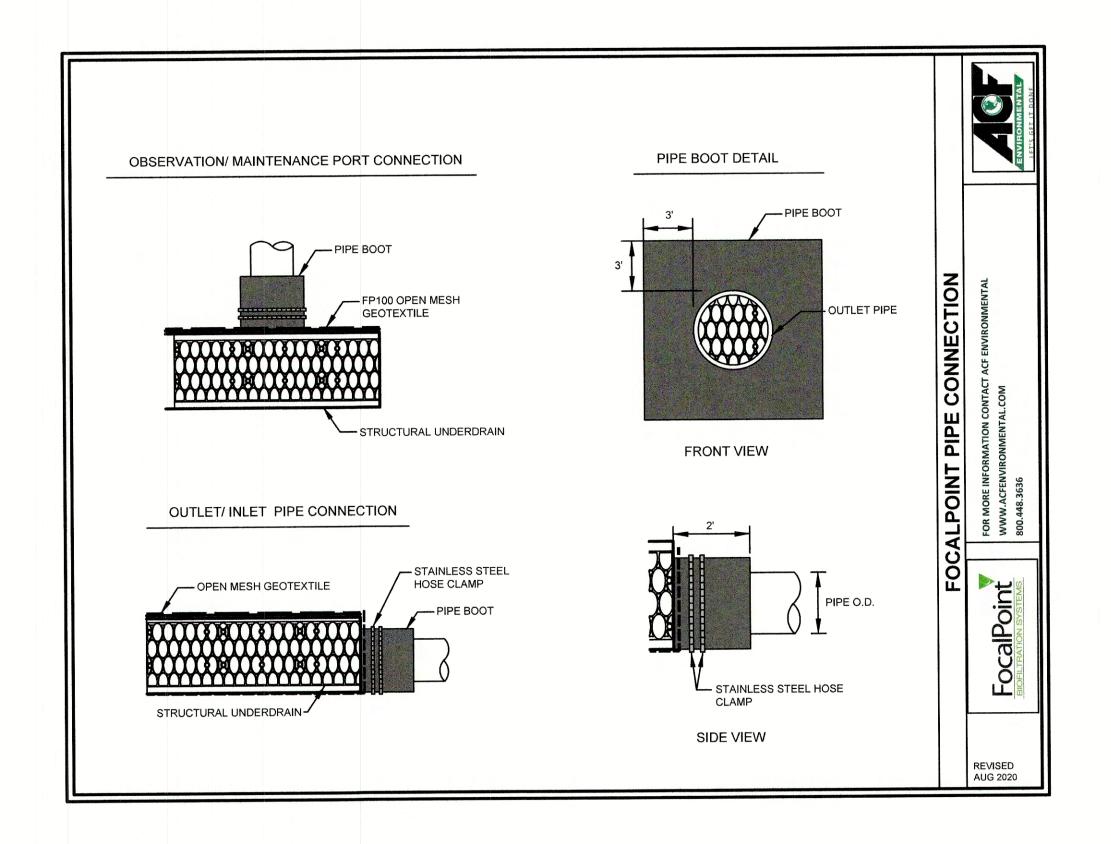Plan Name:	DETAIL SHEET
Project:	INDUSTRIAL WAREHOUSE 375 BANFIELD ROAD, PORTSMOUTH, NH 03801
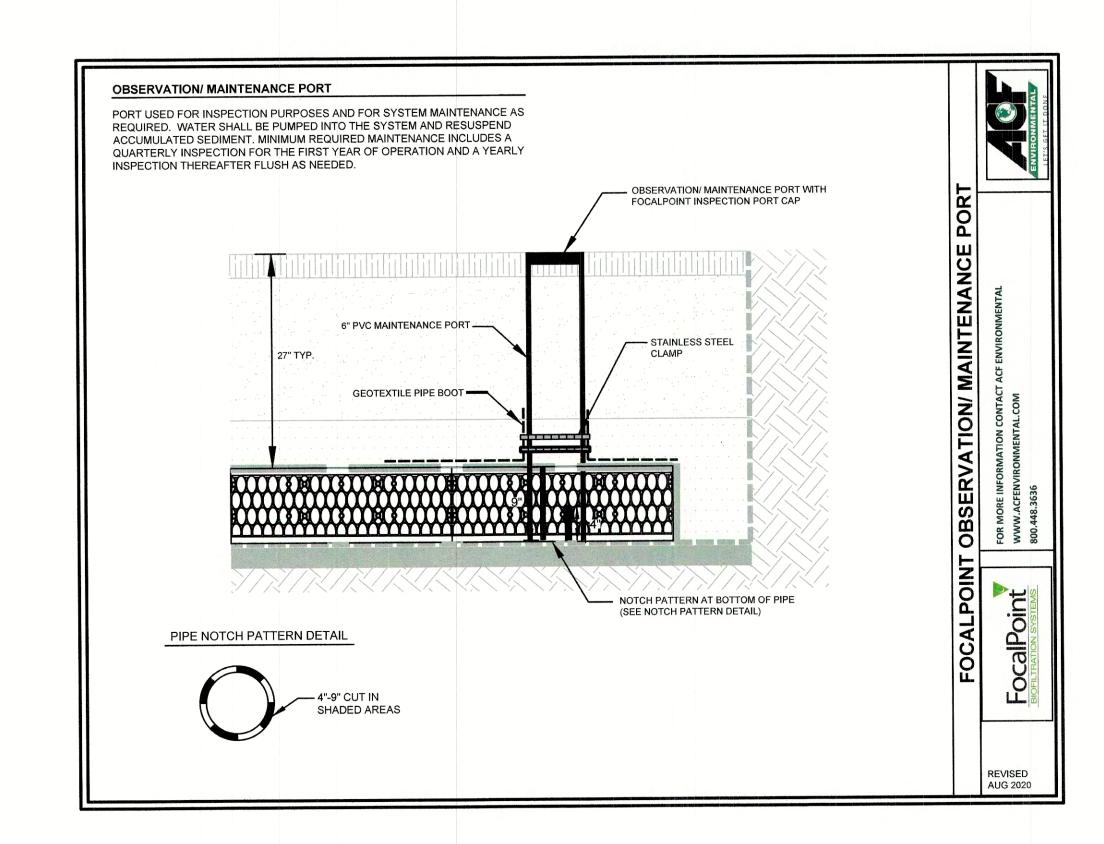
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SHEET 15 OF 24 JBE PROJECT NO. 19190.2


1. CONSTRUCT THE LEVEL SPREADER LIP ON A ZERO PERCENT GRADE TO ENSURE UNIFORM SPREADING OF RUNOFF.

CROSS SECTION

- 2. LEVEL SPREADER SHALL BE CONSTRUCTED ON UNDISTURBED SOIL AND NOT ON FILL.
- 3. AN EROSION STOP SHALL BE PLACED VERTICALLY A MINIMUM OF SIX INCHES DEEP IN A SLIT TRENCH ONE FOOT BACK OF THE LEVEL LIP AND PARALLEL TO THE LIP. THE EROSION STOP SHALL EXTEND THE ENTIRE LENGTH OF THE LEVEL LIP.
- 4. ENTIRE LEVEL LIP AREA SHALL BE PROTECTED BY PLACING TWO STRIPS OF JUTE OR EXCELSIOR MATTING ALONG THE LIP. EACH STRIP SHALL OVERLAP THE EROSION STOP BY AT LEAST SIX INCHES.
- 5. ENTRANCE CHANNEL TO THE LEVEL SPREADER SHALL NOT EXCEED A 1 PERCENT GRADE FOR AT LEAST 50 FEET BEFORE ENTERING THE SPREADER.
- 6. THE FLOW FROM THE LEVEL SPREADER SHALL OUTLET ONTO STABILIZED AREAS. WATER MUST NOT RECONCENTRATE IMMEDIATELY BELOW THE SPREADER.
- 7. PERIODIC INSPECTION AND REQUIRED MAINTENANCE SHALL BE PERFORMED.
- 8. MAINTENANCE: THE LEVEL SPREADER SHOULD BE CHECKED PERIODICALLY AND AFTER EVERY MAJOR STORM TO DETERMINE IF THE SPREADER HAS BEEN DAMAGED. SEDIMENT DEEPER THAN 4" ACCUMULATION SHOULD BE REMOVED. IF RILLING HAS TAKEN PLACE ON THE LIP, THEN THE DAMAGE SHOULD BE REPAIRED AND REVEGETATED. THE VEGETATION SHOULD BE MOWED OCCASIONALLY TO CONTROL WEEDS AND THE ENCROACHMENT OF WOODY VEGETATION. CLIPPINGS SHOULD BE REMOVED AND DISPOSED OF OUTSIDE THE SPREADER AND AWAY FROM OUTLET AREA. FERTILIZATION SHOULD BE DONE AS NECESSARY TO KEEP THE VEGETATION HEALTHY AND DENSE.

LEVEL SPREADER

NOT TO SCALE

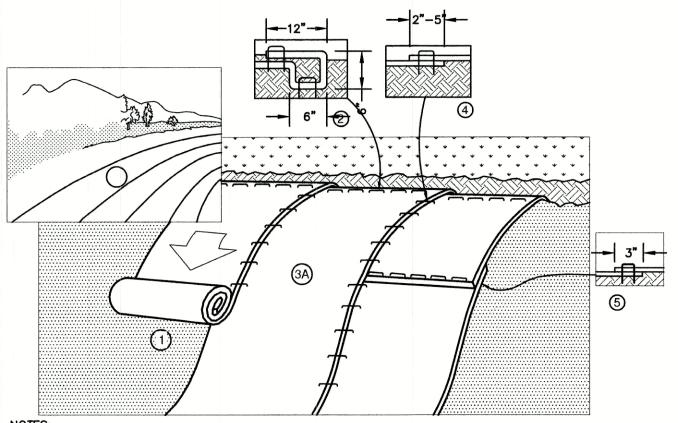

NOTES:

- 1. PREPARE SOIL BEFORE INSTALLING BLANKETS, INCLUDING ANY NECESSARY APPLICATION OF LIME, FERTILIZER, AND SEED. NOTE: WHEN USING CELL-O-SEED DO NOT SEED PREPARED AREA. CELL-O-SEED MUST BE INSTALLED WITH PAPER SIDE DOWN.
- 2. BEGIN AT THE TOP OF THE SLOPE BY ANCHORING THE BLANKET IN A 6" DEEP BY 6" WIDE TRENCH WITH APPROXIMATELY 12" OF BLANKET EXTENDED BEYOND THE UP-SLOPE PORTION OF THE TRENCH. ANCHOR THE BLANKET WITH A ROW OF STAPLES/STAKES APPROXIMATELY 12" APART IN THE BOTTOM OF THE TRENCH. BACKFILL AND COMPACT THE TRENCH AFTER STAPLING. APPLY SEED TO COMPACTED SOIL AND FOLD REMAINING 12" PORTION OF BLANKET BACK OVER SEED AND COMPACTED SOIL. SECURE BLANKET OVER COMPACTED SOIL WITH A ROW OF STAPLES/STAKES SPACED APPROXIMATELY 12" APART ACROSS THE WIDTH OF THE BLANKET.
- 3. ROLL THE BLANKETS (A) DOWN OR (B) HORIZONTALLY ACROSS THE SLOPE. BLANKETS WILL UNROLL WITH APPROPRIATE SIDE AGAINST THE SOIL SURFACE. ALL BLANKETS MUST BE SECURELY FASTENED TO SOIL SURFACE BY PLACING STAPLES/STAKES IN APPROPRIATE LOCATIONS AS SHOWN IN THE STAPLE PATTERN GUIDE. WHEN USING OPTIONAL DOT SYSTEMTM, STAPLES/STAKES SHOULD BE PLACED THROUGH EACH OF THE COLORED DOTS CORRESPONDING TO THE APPROPRIATE STAPLE PATTERN.
- 4. THE EDGES OF PARALLEL BLANKETS MUST BE STAPLED WITH APPROXIMATELY 2"-5" OVERLAP DEPENDING ON BLANKET TYPE. TO ENSURE PROPER SEAM ALIGNMENT, PLACE THE EDGE OF THE OVERLAPPING BLANKET (BLANKET BEING INSTALLED ON TOP) EVEN WITH THE COLORED SEAM STITCH ON THE PREVIOUSLY INSTALLED
- 5. CONSECUTIVE BLANKETS SPLICED DOWN THE SLOPE MUST BE PLACED END OVER END (SHINGLE STYLE) WITH AN APPROXIMATE 3" OVERLAP. STAPLE THROUGH OVERLAPPED AREA, APPROXIMATELY 12" APART ACROSS ENTIRE BLANKET WIDTH. NOTE: IN LOOSE SOIL CONDITIONS, THE USE OF STAPLE OR STAKE LENGTHS GREATER THAN 6" MAY BE NECESSARY TO PROPERLY SECURE THE BLANKETS.



NORTH AMERICAN GREEN 14649 HIGHWAY 41 NORTH EVANSVILLE, INDIANA 47725 1-800-772-2040

EROSION CONTROL BLANKET SLOPE INSTALLATION

(North American Green)

NOT TO SCALE

FNEWH Design: JAC Draft: DJM Date: 04/21/20 Checked: JAC | Scale: AS NOTED | Project No.: 19190.2 MICHAEL KERIVAN No. 9846 AT THE USER'S SOLE RISK AND WITHOUT LIABILITY TO JBE.



13 6/23/21 REVISED PER CITY COMMENTS DJM 12 5/18/21 REVISED PLANTINGS PER NHB DJM ISSUED REVISED PLANS TO TAC DJM 11 | 5/17/21 ISSUED REVISED PLANS FOR PRELIMINARY PB CONSULTATION 10 5/10/21 3/9/21 REVISED CONCEPTUAL LAYOUT DJM **REVISION** BY DATE REV.

NOT TO SCALE


LENGTH OF F.E.S. PARA GEOTEXTILE FABRIC (AMOCO 6" SAND FILTER TO BE PLACED #2006 OR EQUIVALENT) TO BE BELOW THE GEOTEXTILE FOR THE PLACED BETWEEN RIP RAP AND FULL EXTENT OF THE APRON (TYP.)-SOIL (TYP.)-

SECTION A-A PIPE OUTLET TO FLAT AREA WITH NO DEFINED CHANNEL

SECTION A-A PIPE OUTLET TO WELL-DEFINED CHANNEL

TABLE 7-24RECOMMENDED	RIP RAP GRAD	ATION RANGES
THICKNESS OF RIP RAP = 1.5	FEET	
d50 SIZE= 0.50	FEET 6	INCHES
% OF WEIGHT SMALLER THAN THE GIVEN d50 SIZE	SIZE OF ST FROM	TONE (INCHES) TO
100%	9	12
85%	8	11
50%	6	9
15%	2	3

- 1. THE SUBGRADE FOR THE GEOTEXTILE FABRIC AND RIP RAP SHALL BE PREPARED TO THE LINES AND GRADES SHOWN ON THE PLANS.
- 2. THE RIP RAP SHALL CONFORM TO THE SPECIFIED GRADATION.
- 3. GEOTEXTILE FABRICS SHALL BE PROTECTED FROM PUNCTURE OR TEARING DURING THE PLACEMENT OF THE ROCK RIP. DAMAGED AREAS IN THE FABRIC SHALL BE REPAIRED BY PLACING A PIECE OF FABRIC OVER THE DAMAGED AREA OR BY COMPLETE REPLACEMENT OF THE FABRIC. ALL OVERLAPS REQUIRED FOR REPAIRS OR JOINING TWO PIECES OF FABRIC SHALL BE A MINIMUM OF 12 INCHES.
- 4. STONE FOR THE RIP RAP MAY BE PLACED BY EQUIPMENT AND SHALL BE CONSTRUCTED TO THE FULL LAYER THICKNESS IN ONE OPERATION AND IN SUCH A MANNER AS TO PREVENT SEGREGATION OF THE STONE SIZES.
- 5. OUTLETS TO A DEFINED CHANNEL SHALL HAVE 2:1 OR FLATTER SIDE SLOPES AND SHOULD BEGIN AT THE TOP OF THE CULVERT AND TAPER DOWN TO THE CHANNEL BOTTOM THROUGH THE LENGTH OF THE APRON.
- 6. MAINTENANCE: THE OUTLET PROTECTION SHOULD BE CHECKED AT LEAST ANNUALLY AND AFTER EVERY MAJOR STORM. IF THE RIP RAP HAS BEEN DISPLACED, UNDERMINED OR DAMAGED, IT SHOULD BE REPAIRED IMMEDIATELY. THE CHANNEL IMMEDIATELY BELOW THE OUTLET SHOULD BE CHECKED TO SEE THAT EROSION IS NOT OCCURRING. THE DOWNSTREAM CHANNEL SHOULD BE KEPT CLEAR OF OBSTRUCTIONS SUCH AS FALLEN TREES, DEBRIS, AND SEDIMENT THAT COULD CHANGE FLOW PATTERNS AND/OR TAILWATER DEPTHS ON THE PIPES. REPAIRS MUST BE CARRIED OUT IMMEDIATELY TO AVOID ADDITIONAL DAMAGE TO OUTLET PROTECTION.

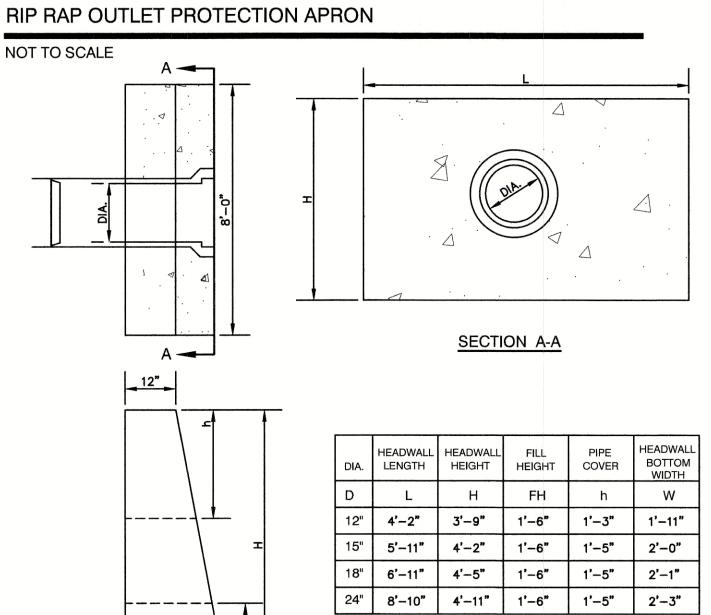

LONGITUDINAL SECTION

- ALL DIMENSIONS GIVEN IN FEET & INCHES. PROVIDE BELL END AT INLET HEADWALL, AND SPIGOT END AT OUTLET END HEADWALL. CONCRETE: 5,000 PSI MINIMUM AFTER 28 DAYS. CEMENT TO BE TYPE III PER ASTM
- C-150. REINFORCING TO MEET OR EXCEED ASTM A-615 GRADE 60 DEFORMED BARS. 4. 1" THREADED INSERTS PROVED FOR FINAL ATTACHMENT IN FIELD BY OTHERS.

PRECAST CONCRETE HEADWALL

Designed and Produced in NH Civil Engineering Services 603-772-4746


'HIGH BY 2'WIDE BERM IF NECESSARY, TO DIVERT FLOW INTO TRAP. LENGTH AS REQUIRED.

CONSTRUCTION SPECIFICATIONS:

- 1. THE AREA UNDER THE EMBANKMENT SHALL BE CLEARED, GRUBBED, AND STRIPPED OF ALL VEGETATION,
- 2. THE FILL MATERIAL FOR THE EMBANKMENT SHALL BE FREE OF ROOTS, WOODY VEGETATION, STONES OVER 6" SIZE, ORGANIC MATERIAL, OR OTHER OBJECTIONABLE MATERIALS. THE FILL SHALL BE COMPACTED BY ROUTING CONSTRUCTION EQUIPMENT OVER IT SO THAT THE ENTIRE AREA OF THE FILL IS TRAVERSED BY AT LEAST ONE WHEEL OR TREAD TRACK OF THE EQUIPMENT.
- 3. CONSTRUCTION OPERATIONS SHALL BE CARRIED OUT IN SUCH A MANNER THAT EROSION AND WATER POLLUTION ARE MINIMIZED.
- 4. ALL CUT AND FILL SLOPES SHALL BE 2:1 (H:V) OR FLATTER.
- 5. OUTLET CREST ELEVATIONS SHALL BE AT LEAST ONE FOOT BELOW THE TOP OF THE EMBANKMENT
- 6. OUTLET CREST IS TO BE STABILIZED WITH AMOCO #2004 GEOTEXTILE (OR APPROVED EQUAL), WHICH IS TO BE "TOED" INTO THE GROUND AT ITS ENDS AT LEAST SIX INCHES AND IS TO EXTEND AT LEAST ONE FOOT INTO THE TRAP AND ONE FOOT DOWNSTREAM FROM THE OUTLET EDGE FOR THE ENTIRE LENGTH OF THE
- 7. ALL DISTURBED AREAS SHALL BE VEGETATED USING THE APPROPRIATE VEGETATIVE BEST MANAGEMENT
- 8. ALL TRAPS ARE TO HAVE SEDIMENT DEPOSITS REMOVED AND DISPOSED PROPERLY AT LEAST ONCE WEEKLY


TEMPORARY SEDIMENT TRAP

NOT TO SCALE

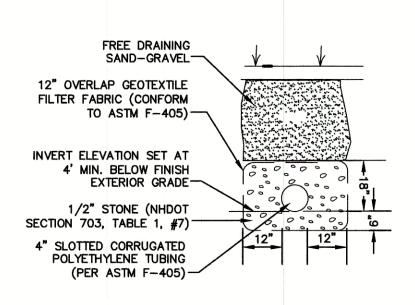

UNDERDRAIN DETAIL

NOT TO SCALE

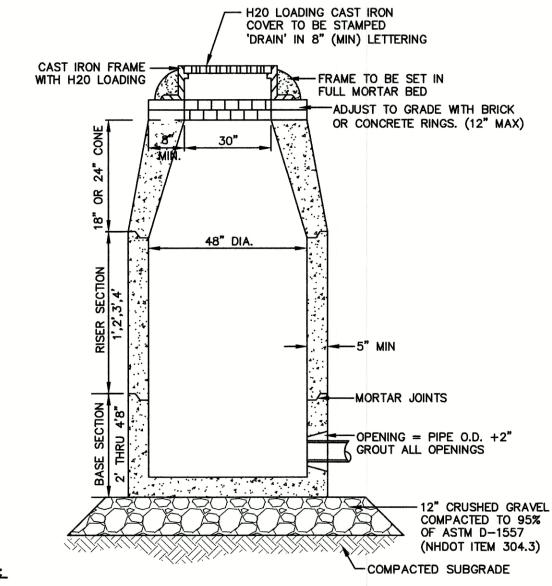


1. BASE SECTION SHALL BE MONOLITHIC WITH 48" INSIDE DIAMETER.

- 2. ALL SECTIONS SHALL BE DESIGNED FOR H20 LOADING.
- 3. CONCRETE SHALL BE COMPRESSIVE STRENGTH 4000 PSI, TYPE II CEMENT.
- 4. FRAMES AND GRATES SHALL BE HEAVY DUTY AND DESIGNED FOR H20 LOADING.
- 5. PROVIDE "V" KNOCKOUTS FOR PIPES WITH 2" MAX. CLEARANCE TO OUTSIDE OF PIPE. MORTAR ALL PIPE CONNECTIONS SO AS TO BE WATERTIGHT.
- 6. JOINT SEALANT BETWEEN PRECAST SECTIONS SHALL BE BUTYL RUBBER.
- 7. ALL DRAIN MANHOLE FRAMES AND GRATES SHALL BE NHDOT TYPE MH-1, OR NEENAH R-1798 OR APPROVED EQUAL (30" DIA. TYPICAL).
- 8. STANDARD FRAME(S) AND GRATE(S) SHALL BE SET IN FULL MORTAR BED. ADJUST TO GRADE WITH CLAY BRICK AND MORTAR (2 BRICK COURSES TYPICALLY, 5 BRICK COURSES MAXIMUM, BUT NO MORE THAN 12"), OR PRECAST CONCRETE 'DONUTS'.

DRAIN MANHOLE

TOP OF RISER-

NOT TO SCALE

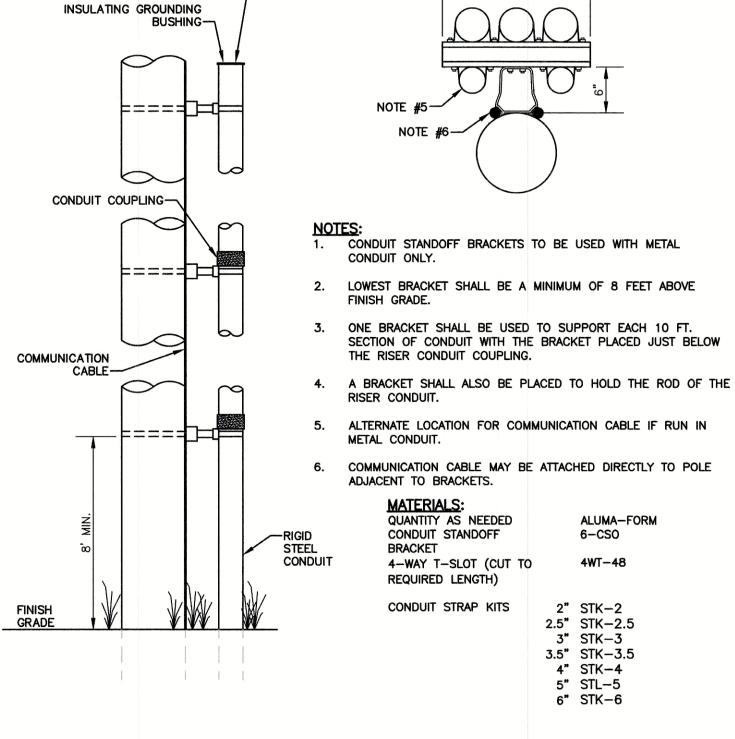

UTILITY POLE RISER DETAIL

NOT TO SCALE

Plan Name:

Owner of Record:

Project:

DETAIL SHEET INDUSTRIAL WAREHOUSE 375 BANFIELD ROAD, PORTSMOUTH, NH 03801

BANFIELD REALTY LLC

304 MAPLEWOOD AVENUE, PORTSMOUTH, NH 03801

DRAWING No. SHEET 16 OF 24 JBE PROJECT NO. 19190.2


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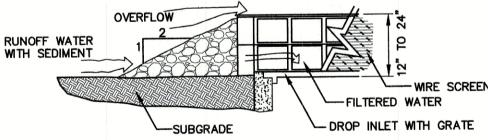
85 Portsmouth Ave. PO Box 219

FAX: 603-772-0227 E-MAIL: JBE@JONESANDBEACH.COM Stratham, NH 03885

EMPORARY EROSION CONTROL NOTES

- THE SMALLEST PRACTICAL AREA OF LAND SHALL BE EXPOSED AT ANY ONE TIME. AT NO TIME SHALL AN AREA IN EXCESS OF 5 ACRES BE EXPOSED AT ANY ONE TIME BEFORE DISTURBED AREAS ARE STABILIZED.
- EROSION, SEDIMENT AND DETENTION MEASURES SHALL BE INSTALLED AS SHOWN ON THE PLANS AND AT LOCATIONS AS REQUIRED, DIRECTED BY THE ENGINEER.
- ALL DISTURBED AREAS (INCLUDING POND AREAS BELOW THE PROPOSED WATERLINE) SHALL BE RETURNED TO PROPOSED GRADES AND ELEVATIONS. DISTURBED AREAS SHALL BE LOAMED WITH A MINIMUM OF 6" OF SCREENED ORGANIC LOAM AND SEEDED WITH SEED MIXTURE 'C' AT A RATE NOT LESS THAN 1.10 POUNDS OF SEED PER 1,000 S.F. OF AREA (48
- FIBER BERMS AND OTHER BARRIERS SHALL BE INSPECTED EVERY SEVEN CALENDAR DAYS AND WITHIN 24 HOURS OF A RAINFALL OF 0.5" OR GREATER. ALL DAMAGED AREAS SHALL BE REPAIRED, AND SEDIMENT DEPOSITS SHALL PERIODICALLY BE REMOVED AND DISPOSED OF.
- AFTER ALL DISTURBED AREAS HAVE BEEN STABILIZED, THE TEMPORARY EROSION CONTROL MEASURES SHALL BE REMOVED AND THE AREA DISTURBED BY THE REMOVAL SMOOTHED AND RE-VEGETATED.
- AREAS MUST BE SEEDED AND MULCHED OR OTHERWISE PERMANENTLY STABILIZED WITHIN 3 DAYS OF FINAL GRADING, OR TEMPORARILY STABILIZED WITHIN 14 DAYS OF THE INITIAL DISTURBANCE OF SOIL. ALL AREAS SHALL BE STABILIZED WITHIN 45 DAYS OF INITIAL DISTURBANCE.
- ALL PROPOSED VEGETATED AREAS THAT DO NOT EXHIBIT A MINIMUM OF 85 PERCENT VEGETATIVE GROWTH BY OCTOBER 15, OR WHICH ARE DISTURBED AFTER OCTOBER 15, SHALL BE STABILIZED BY SEEDING AND INSTALLING NORTH AMERICAN GREEN S75 EROSION CONTROL BLANKETS (OR AN EQUIVALENT APPROVED IN WRITING BY THE ENGINEER) ON SLOPES GREATER THAN 3:1, AND SEEDING AND PLACING 3 TO 4 TONS OF MULCH PER ACRE, SECURED WITH ANCHORED NETTING, ELSEWHERE. THE INSTALLATION OF EROSION CONTROL BLANKETS OR MULCH AND NETTING SHALL NOT OCCUR OVER ACCUMULATED SNOW OR ON FROZEN GROUND AND SHALL BE COMPLETED IN ADVANCE OF THAW OR SPRING MELT
- ALL DITCHES OR SWALES WHICH DO NOT EXHIBIT A MINIMUM OF 85 PERCENT VEGETATIVE GROWTH BY OCTOBER 15, OR WHICH ARE DISTURBED AFTER OCTOBER 15, SHALL BE STABILIZED TEMPORARILY WITH STONE OR EROSION CONTROL BLANKETS APPROPRIATE FOR THE DESIGN FLOW CONDITIONS.
- AFTER OCTOBER 15th, INCOMPLETE ROAD OR PARKING SURFACES, WHERE WORK HAS STOPPED FOR THE WINTER SEASON, SHALL BE PROTECTED WITH A MINIMUM OF 3" OF CRUSHED GRAVEL PER NHDOT ITEM 304.3.
- O. AN AREA SHALL BE CONSIDERED STABLE IF ONE OF THE FOLLOWING HAS OCCURRED:
 - BASE COURSE GRAVELS HAVE BEEN INSTALLED IN AREAS TO BE PAVED;
 - b. A MINIMUM OF 85% VEGETATED GROWTH HAS BEEN ESTABLISHED;
 - c. A MINIMUM OF 3" OF NON-EROSIVE MATERIAL SUCH STONE OR RIPRAP HAS BEEN INSTALLED; OR
 - d. EROSION CONTROL BLANKETS HAVE BEEN PROPERLY INSTALLED.
- FUGITIVE DUST CONTROL IS REQUIRED TO BE CONTROLLED IN ACCORDANCE WITH ENV-A 1000, AND THE PROJECT IS TO THE REQUIREMENTS AND INTENT OF RSA 430:53 AND AGR 3800 RELATIVE TO INVASIVE SPECIES.
- PRIOR TO BEGINNING CONSTRUCTION, THE CONTRACTOR'S NAME, ADDRESS, AND PHONE NUMBER SHALL BE SUBMITTED TO DES VIA EMAIL (SEE BELOW).
- PRIOR TO CONSTRUCTION, A PHASING PLAN THAT DELINEATES EACH PHASE OF THE PROJECT SHALL BE SUBMITTED. ALL TEMPORARY SEDIMENT BASINS THAT WILL BE NEEDED FOR DEWATERING WORK AREAS SHALL BE LOCATED AND IDENTIFIED
- IN ORDER TO ENSURE THE STABILITY OF THE SITE AND EFFECTIVE IMPLEMENTATION OF THE SEDIMENT AND EROSION CONTROL MEASURES SPECIFIED IN THE PLANS FOR THE DURATION OF CONSTRUCTION, THE CONTRACTOR SHALL BE IN STRICT COMPLIANCE WITH THE FOLLOWING INSPECTION AND MAINTENANCE REQUIREMENTS IN ADDITION TO THOSE CALLED
 - a. A CERTIFIED PROFESSIONAL IN EROSION AND SEDIMENT CONTROL OR A PROFESSIONAL ENGINEER LICENSED IN THE STATE OF NEW HAMPSHIRE ("MONITOR") SHALL BE EMPLOYED TO INSPECT THE SITE FROM THE START OF ALTERATION OF TERRAIN ACTIVITIES UNTIL THE SITE IS IN FULL COMPLIANCE WITH THE SITE SPECIFIC PERMIT
 - b. DURING THIS PERIOD, THE MONITOR SHALL INSPECT THE SUBJECT SITE AT LEAST ONCE A WEEK, AND IF POSSIBLE, DURING ANY 1/2 INCH OR GREATER RAIN EVENT (I.E. 1/2 INCH OF PRECIPITATION OR MORE WITHIN A 24 HOUR PERIOD). IF UNABLE TO BE PRESENT DURING SUCH A STORM, THE MONITOR SHALL INSPECT THE SITE WITHIN 24 HOURS OF THIS EVENT.
 - c. THE MONITOR SHALL PROVIDE TECHNICAL ASSISTANCE AND RECOMMENDATIONS TO THE CONTRACTOR ON THE APPROPRIATE BEST MANAGEMENT PRACTICES FOR EROSION AND SEDIMENT CONTROLS REQUIRED TO MEET THE REQUIREMENTS OF RSA 485 A:17 AND ALL APPLICABLE DES PERMIT CONDITIONS.
 - d. WITHIN 24 HOURS OF EACH INSPECTION, THE MONITOR SHALL SUBMIT A REPORT TO DES VIA EMAIL (RIDGELY MAUCK AT: RIDGELY.MAUCK@DES.NH.GOV).
 - e. THE MONITOR SHALL MEET WITH DES TO DECIDE UPON A REPORT FORMAT. THE REPORT FORMAT SHALL BE REVIEWED AND APPROVED BY DES PRIOR TO THE START OF CONSTRUCTION.



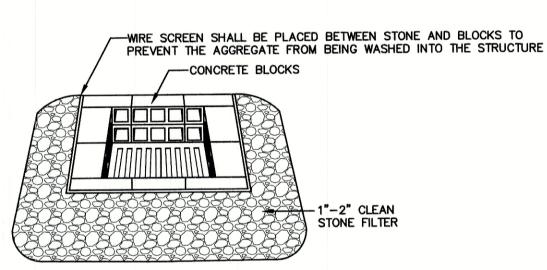

MAINTENANCE NOTE:

. ALL STRUCTURES SHOULD BE INSPECTED AFTER EVERY RAINFALL AND REPAIRS MADE AS NECESSARY. SEDIMENT SHOULD BE REMOVED FROM TRAPPING DEVICES AFTER THE SEDIMENT HAS REACHED A MAXIMUM OF ONE HALF THE DEPTH OF THE TRAP. THE SEDIMENT SHOULD BE DISPOSED IN A THE TEMPORARY TRAPS SHOULD BE REMOVED AND THE AREA REPAIRED AS SOON AS THE

TEMPORARY CATCH BASIN INLET PROTECTION

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MICHAEL KERIVAN No. 9846

REVISED PER CITY COMMENTS 13 6/23/21 REVISED PLANTINGS PER NHB 12 5/18/21 ISSUED REVISED PLANS TO TAC 11 5/17/21 ISSUED REVISED PLANS FOR PRELIMINARY PB CONSULTATION 10 | 5/10/21 REVISED CONCEPTUAL LAYOUT 9 | 3/9/21 REVISION DATE REV.

SEEDING SPECIFICATIONS I. GRADING AND SHAPING

- A. SLOPES SHALL NOT BE STEEPER THAN 2:1 WITHOUT APPROPRIATE EROSION CONTROL MEASURES AS SPECIFIED ON THE PLANS (3:1 SLOPES OR FLATTER ARE PREFERRED) B. WHERE MOWING WILL BE DONE, 3:1 SLOPES OR FLATTER ARE RECOMMENDED.

-50' MINIMUM (75 WITHOUT MOUNTABLE BERM)-- EXISTING

---50' MINIMUM (75' WITHOUT MOUNTABLE BERM)-

PLAN VIEW

1. STONE FOR STABILIZED CONSTRUCTION ENTRANCE SHALL BE 3 INCH STONE, RECLAIMED STONE, OR

MOUNTABLE BERM, AND EXCEPT FOR A SINGLE RESIDENTIAL LOT WHERE A 30 FOOT MINIMUM LENGTH

3. THICKNESS OF THE STONE FOR THE STABILIZED ENTRANCE SHALL NOT BE LESS THAN 6 INCHES.
4. THE WIDTH OF THE ENTRANCE SHALL NOT BE LESS THAN THE FULL WIDTH OF THE ENTRANCE WHERE

5. GEOTEXTILE FILTER FABRIC SHALL BE PLACED OVER THE ENTIRE AREA PRIOR TO PLACING THE STONE.

7. THE ENTRANCE SHALL BE MAINTAINED IN A CONDITION THAT WILL PREVENT TRACKING OR FLOWING OF

—2.5' (MIN)——

2. THE EROSION CONTROL MIX USED IN THE FILTER BERMS SHALL BE A WELL-GRADED MIXTURE OF

4. ON SLOPES LESS THAN 5%, OR AT THE BOTTOM OF SLOPES STEEPER THAN 3:1, UP TO 20' LONG, THE BERM SHALL BE A MINIMUM OF 12" HIGH (AS MEASURED ON THE UPHILL SIDE), AND

A MINIMUM OF 36" WIDE. ON LONGER OR STEEPER SLOPES, THE BERM SHALL BE WIDER TO

SHOULD BE USED AT LOW POINTS OF CONCENTRATED RUNOFF, BELOW CULVERT OUTLET APRONS.

5. FROZEN GROUND, OUTCROPS OF BEDROCK, AND VERY ROOTED FORESTED AREAS PRESENT THE

MOST PRACTICAL AND EFFECTIVE LOCATIONS FOR ORGANIC FILTER BERMS. OTHER BMP'S

AROUND CATCH BASINS, AND AT THE BOTTOM OF STEEP PERIMETER SLOPES THAT HAVE A

6. SEDIMENT SHALL BE REMOVED FROM BEHIND THE STRUCTURES WHEN IT HAS ACCUMULATED TO

1. ORGANIC FIBER BERMS SHALL BE UTILIZED IN LIEU OF SILT FENCE.

BRIDGES THAT WOULD ENABLE FINES TO WASH UNDER THE BERM.

ACCOMMODATE THE POTENTIAL ADDITIONAL RUNOFF.

ONE HALF THE ORIGINAL HEIGHT OF THE STRUCTURE.

7. STRUCTURES MAY BE LEFT IN PLACE ONCE THE SITE IS STABILIZED.

PASSING A 0.75" SCREEN.

6. ALL SURFACE WATER THAT IS FLOWING TO OR DIVERTED TOWARD THE CONSTRUCTION ENTRANCE SHALL BE PIPED BENEATH THE ENTRANCE. IF PIPING IS IMPRACTICAL, A STONE BERM WITH 5:1 SLOPES THAT CAN BE

SEDIMENT ONTO THE PUBLIC RIGHT-OF-WAY. THIS MAY REQUIRE PERIODIC TOP DRESSING WITH ADDITIONAL STONE AS CONDITIONS DEMAND AND REPAIR AND/OR CLEAN OUT OF ANY MEASURES USED TO TRAP SEDIMENT. ALL SEDIMENT SPILLED, WASHED, OR TRACKED ONTO THE PUBLIC RIGHT-OF-WAY MUST BE

2. THE LENGTH OF THE STABILIZED ENTRANCE SHALL NOT BE LESS THAN 50 FEET, 75' WITHOUT A

INGRESS OR EGRESS OCCURS, OR 10 FEET, WHICHEVER IS GREATER.

CROSSED BY VEHICLES MAY BE SUBSTITUTED FOR THE PIPE

STABILIZED CONSTRUCTION ENTRANCE

FILTER FABRIC IS NOT REQUIRED FOR A SINGLE FAMILY RESIDENTIAL LOT.

LEXISTING GROUND

WOVEN GEOTEXTILE

RECYCLED CONCRETE EQUIVALENT.

WOULD APPLY

NOT TO SCALE

FILTER FABRIC-

PAVEMENT

BERM (OPTIONAL)

PAVEMENT-

-EROSION CONTROL MIXTURE

-MOUNTABLE

- A. SURFACE AND SEEPAGE WATER SHOULD BE DRAINED OR DIVERTED FROM THE SITE TO PREVENT DROWNING OR WINTER KILLING OF THE PLANTS.
- B. STONES LARGER THAN 4 INCHES AND TRASH SHOULD BE REMOVED BECAUSE THEY INTERFERE WITH SEEDING AND FUTURE MAINTENANCE OF THE AREA. WHERE FEASIBLE, THE SOIL SHOULD BE TILLED TO A DEPTH OF ABOUT 4 INCHES TO PREPARE A SEEDBED AND FERTILIZER AND LIME MIXED INTO THE SOIL. THE SEEDBED SHOULD BE LEFT IN A REASONABLY FIRM AND SMOOTH CONDITION. THE LAST TILLAGE OPERATION SHOULD BE PERFORMED ACROSS THE SLOPE WHEREVER PRACTICAL.
- 3. ESTABLISHING A STAND
- A. LIME AND FERTILIZER SHOULD BE APPLIED PRIOR TO OR AT THE TIME OF SEEDING AND INCORPORATED INTO THE SOIL. TYPES AND AMOUNTS OF LIME AND FERTILIZER SHOULD BE BASED ON AN EVALUATION OF SOIL TESTS. WHEN A SOIL TEST IS NOT AVAILABLE, THE FOLLOWING MINIMUM AMOUNTS SHOULD BE
 - AGRICULTURAL LIMESTONE, 2 TONS PER ACRE OR 100 LBS. PER 1,000 SQ.FT. NITROGEN(N), 50 LBS. PER ACRE OR 1.1 LBS. PER 1,000 SQ.FT. PHOSPHATE(P205), 100 LBS. PER ACRE OR 2.2 LBS. PER 1,000 SQ.FT.
 - POTASH(K20), 100 LBS. PER ACRE OR 2.2 LBS. PER 1,000 SQ.FT. (NOTE: THIS IS THE EQUIVALENT OF 500 LBS. PER ACRE OF 10-20-20 FERTILIZER OR 1,000 LBS. PER ACRE OF 5-10-10.)
- B. SEED SHOULD BE SPREAD UNIFORMLY BY THE METHOD MOST APPROPRIATE FOR THE SITE. METHODS INCLUDE BROADCASTING, DRILLING AND HYDROSEEDING. WHERE BROADCASTING IS USED, COVER SEED WITH .25 INCH OF SOIL OR LESS, BY CULTIPACKING OR RAKING.
- REFER TO THE 'SEEDING GUIDE' AND 'SEEDING RATES' TABLES ON THIS SHEET FOR APPROPRIATE SEED MIXTURES AND RATES OF SEEDING. ALL LEGUMES (CROWNVETCH, BIRDSFOOT, TREFOIL AND FLATPEA) MUST BE INOCULATED WITH THEIR SPECIFIC INOCULANT PRIOR TO THEIR INTRODUCTION TO THE SITE.
- WHEN SEEDED AREAS ARE MULCHED, PLANTINGS MAY BE MADE FROM EARLY SPRING TO EARLY OCTOBER WHEN SEEDED AREAS ARE NOT MULCHED, PLANTINGS SHOULD BE MADE FROM EARLY SPRING TO MAY 20th OR FROM AUGUST 10th TO SEPTEMBER 1st.
- A. HAY, STRAW, OR OTHER MULCH, WHEN NEEDED, SHOULD BE APPLIED IMMEDIATELY AFTER SEEDING B. MULCH WILL BE HELD IN PLACE USING APPROPRIATE TECHNIQUES FROM THE BEST MANAGEMENT PRACTICE FOR MULCHING. HAY OR STRAW MULCH SHALL BE PLACED AT A RATE OF 90 LBS PER 1000 S.F.
- 5. MAINTENANCE TO ESTABLISH A STAND
- A. PLANTED AREAS SHOULD BE PROTECTED FROM DAMAGE BY FIRE, GRAZING, TRAFFIC, AND DENSE WEED
- B. FERTILIZATION NEEDS SHOULD BE DETERMINED BY ONSITE INSPECTIONS. SUPPLEMENTAL FERTILIZER IS USUALLY THE KEY TO FULLY COMPLETE THE ESTABLISHMENT OF THE STAND BECAUSE MOST PERENNIALS TAKE 2 TO 3 YEARS TO BECOME FULLY ESTABLISHED.
- C. IN WATERWAYS, CHANNELS, OR SWALES WHERE UNIFORM FLOW CONDITIONS ARE ANTICIPATED, ANNUAL MOWING MAY BE NECESSARY TO CONTROL GROWTH OF WOODY VEGETATION.


USE	SEEDING MIXTURE 1/	DROUGHTY	WELL DRAINED	MODERATELY WELL DRAINED	POORLY DRAINED
STEEP CUTS AND FILLS, BORROW AND DISPOSAL	A B C	FAIR POOR POOR	GOOD GOOD GOOD	GOOD FAIR EXCELLENT	FAIR FAIR GOOD
AREAS	D	FAIR	EXCELLENT	EXCELLENT	POOR
WATERWAYS, EMERGENC' SPILLWAYS, AND OTHER CHANNELS WITH FLOWING WATER.	Y A C	GOOD GOOD	GOOD EXCELLENT	GOOD EXCELLENT	FAIR FAIR
LIGHTLY USED PARKING LOTS, ODD AREAS, UNUSED LANDS, AND LOW INTENSITY USE RECREATION SITES.	A B C	GOOD GOOD GOOD	GOOD GOOD EXCELLENT	GOOD FAIR EXCELLENT	FAIR POOR FAIR
PLAY AREAS AND ATHLETIC FIELDS. (TOPSOIL IS ESSENTIAL FOR GOOD TURF.)	E F	FAIR FAIR	EXCELLENT EXCELLENT	EXCELLENT EXCELLENT	2/ 2/
CONTRACT OF SECURITY	A OA IN ADDE	IDIY FOR RECOM	MENDATION REGARD	ING RECLAMATIC	N OF SAND

- GRAVEL PIT, SEE NH-PM-24 IN APPENDIX FOR RECOMMENDATION REGARDING RECLAMATION OF SAND AND GRAVEL PITS.
- / REFER TO SEEDING MIXTURES AND RATES IN TABLE BELOW. POORLY DRAINED SOILS ARE NOT DESIRABLE FOR USE AS PLAYING AREA AND ATHLETIC FIELDS.
- NOTE: TEMPORARY SEED MIX FOR STABILIZATION OF TURF SHALL BE WINTER RYE OR OATS AT A RATE OF 2.5 LBS. PER 1000 S.F. AND SHALL BE PLACED PRIOR TO OCTOBER 15th, IF PERMANENT SEEDING NOT

SEEDING GUIDE

	MIXTURE	POUNDS PER ACRE	POUNDS PER 1.000 Sq. Ft			
	A. TALL FESCUE CREEPING RED FESCUE RED TOP TOTAL	20 20 2 42	0.45 0.45 <u>0.05</u> 0.95			
	B. TALL FESCUE CREEPING RED FESCUE CROWN VETCH	15 10 15	0.35 0.25 0.35			
	OR FLAT PEA TOTAL	30 40 OR 55	0.75 0.95 OR 1.35			
*	C. TALL FESCUE CREEPING RED FESCUE BIRDS FOOT TREFOIL TOTAL	20 20 <u>8</u> 48	0.45 0.45 <u>0.20</u> 1.10			
	D. TALL FESCUE FLAT PEA TOTAL	20 30 50	0.45 <u>0.75</u> 1.20			
	E. CREEPING RED FESCUE 1/ KENTUCKY BLUEGRASS 1/ TOTAL	50 50 100	1.15 1.15 2.30			
	F. TALL FESCUE 1	150	3.60			
	1/FOR HEAVY USE ATHLETIC FIELDS CONSULT THE UNIVERSITY OF NEW HAMPSHIRE COOPERATIVE EXTENSION TURF SPECIALIST FOR CURRENT VARIETIES AND SEEDING RATES.					

SEEDING RATES

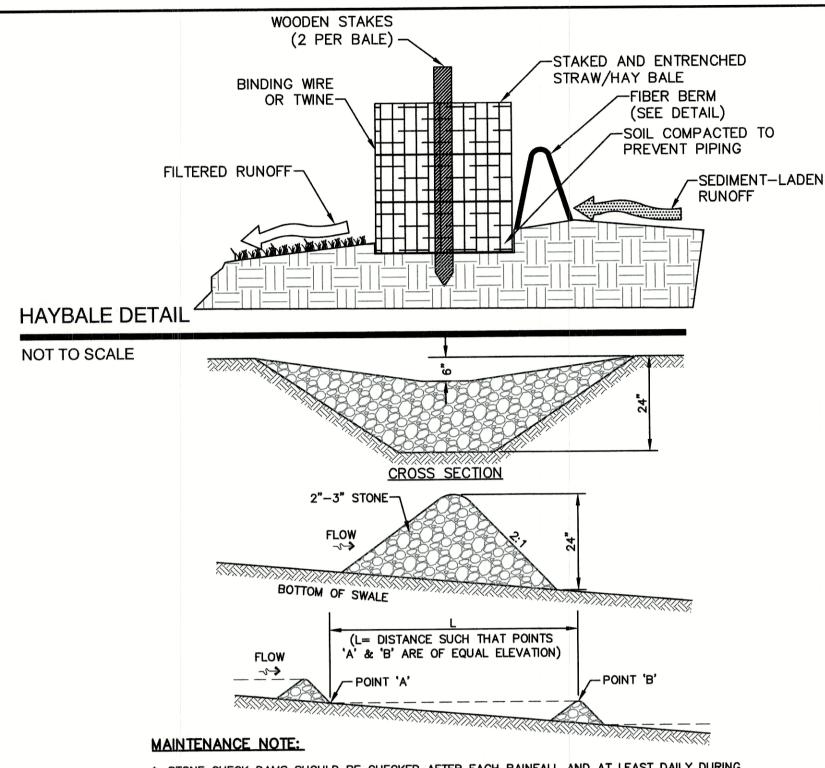

1. STONE CHECK DAMS SHOULD BE CHECKED AFTER EACH RAINFALL AND AT LEAST DAILY DURING PROLONGED RAINFALL. ANY NECESSARY REPAIRS SHOULD BE MADE IMMEDIATELY. PARTICULAR ATTENTION SHOULD BE GIVEN TO END RUN AND EROSION AT THE DOWNSTREAM TOE OF THE STRUCTURE. WHEN THE STRUCTURES ARE REMOVED, THE DISTURBED PORTION SHOULD BE BROUGHT TO THE EXISTING CHANNEL GRADE AND THE AREAS PREPARED, SEEDED AND MULCHED. WHILE THIS PRACTICE IS NOT INTENDED TO BE USED PRIMARILY FOR SEDIMENT TRAPPING, SOME SEDIMENT WILL ACCUMULATE BEHIND THE STRUCTURES. SEDIMENT SHALL BE REMOVED FROM BEHIND THE STRUCTURES WHEN IT HAS ACCUMULATED TO ONE HALF OF THE ORIGINAL HEIGHT OF THE STRUCTURE.

STONE CHECK DAM

NOT TO SCALE

CONSTRUCTION SEQUENCE

1. PRIOR TO THE START OF ANY ACTIVITY, IT IS THE RESPONSIBILITY OF THE SITE'S SITE DEVELOPER (OR OWNER) TO FILE A NOTICE OF INTENT (NOI) FORM WITH THE ENVIRONMENTAL PROTECTION AGENCY (EPA) IN ORDER TO GAIN COVERAGE UNDER THE NPDES GENERAL PERMIT FOR STORM WATER DISCHARGES FROM CONSTRUCTION ACTIVITIES. A PRE CONSTRUCTION MEETING IS TO BE HELD WITH ALL DEPARTMENT HEADS PRIOR TO THE START OF CONSTRUCTION

- 2. WETLAND BOUNDARIES ARE TO BE CLEARLY MARKED PRIOR TO THE START OF CONSTRUCTION. AT LEAST A TEMPORARY CULVERT OR ROADBED TO BE IN PLACE PRIOR TO THE START OF CONSTRUCTION.
- CUT AND REMOVE TREES IN CONSTRUCTION AREA AS REQUIRED OR DIRECTED.
- INSTALL SILT FENCING, HAY BALES AND CONSTRUCTION ENTRANCES PRIOR TO THE START OF CONSTRUCTION. THESE ARE TO BE MAINTAINED UNTIL THE FINAL PAVEMENT SURFACING AND LANDSCAPING AREAS ARE ESTABLISHED.
- CLEAR, CUT, GRUB AND DISPOSE OF DEBRIS IN APPROVED FACILITIES. THIS INCLUDES ANY REQUIRED DEMOLITION OF EXISTING STRUCTURES, UTILITIES,
- CONSTRUCT AND/OR INSTALL TEMPORARY OR PERMANENT SEDIMENT AND/OR DETENTION BASIN(S) AS REQUIRED. THESE FACILITIES SHALL BE NSTALLED AND STABILIZED PRIOR TO DIRECTING RUN-OFF TO THEM. STRIP LOAM AND PAVEMENT, OR RECLAIM EXISTING PAVEMENT WITHIN LIMITS OF WORK PER THE RECOMMENDATIONS OF THE PROJECT ENGINEER AND
- STOCKPILE EXCESS MATERIAL. STABILIZE STOCKPILE AS NECESSARY. 8. PERFORM PRELIMINARY SITE GRADING IN ACCORDANCE WITH THE PLANS, INCLUDING THE CONSTRUCTION OF ANY RETAINING WALLS AND SOUND WALLS.
- 9. PREPARE BUILDING PAD(S) TO ENABLE BUILDING CONSTRUCTION TO BEGIN.
- 10. INSTALL THE SEWER AND DRAINAGE SYSTEMS FIRST, THEN ANY OTHER UTILITIES IN ACCORDANCE WITH THE PLAN AND DETAILS. ANY CONFLICTS BETWEEN UTILITIES ARE TO BE RESOLVED WITH THE INVOLVEMENT AND APPROVAL OF THE ENGINEER. 11. INSTALL INLET PROTECTION AT ALL CATCH BASINS AS THEY ARE CONSTRUCTED IN ACCORDANCE WITH DETAILS.
- 12. ALL SWALES AND DRAINAGE STRUCTURES ARE TO BE CONSTRUCTED AND STABILIZED PRIOR TO HAVING RUN-OFF DIRECTED TO THEM.
- 13. DAILY, OR AS REQUIRED, CONSTRUCT TEMPORARY BERMS, DRAINAGE DITCHES, CHECK DAMS, SEDIMENT TRAPS, ETC., TO PREVENT EROSION ON THE SITE AND PREVENT ANY SILTATION OF ABUTTING WATERS AND/OR PROPERTY.
- 14. PERFORM FINAL FINE GRADING, INCLUDING PLACEMENT OF 'SELECT' SUBGRADE MATERIALS.
- 15. PAVE ALL PARKING LOTS AND ROADWAYS WITH INITIAL 'BASE COURSE'.
- 16. PERFORM ALL REMAINING SITE CONSTRUCTION (i.e. BUILDING, CURBING, UTILITY CONNECTIONS, ETC.).
- 17. LOAM AND SEED ALL DISTURBED AREAS AND INSTALL ANY REQUIRED SEDIMENT AND EROSION CONTROL FACILITIES (i.e. RIP RAP, EROSION CONTROL
- 18. FINISH PAVING ALL ROADWAYS AND PARKING AREAS WITH 'FINISH' COURSE.
- 19. ALL ROADWAYS AND PARKING LOTS SHALL BE STABILIZED WITHIN 72 HOURS OF ACHIEVING FINISHED GRADE.
- 20. ALL CUT AND FILL SLOPES SHALL BE SEEDED/LOAMED WITHIN 72 HOURS OF ACHIEVING FINISHED GRADE.
- 21. COMPLETE PERMANENT SEEDING AND LANDSCAPING.
- 22. REMOVE TEMPORARY EROSION CONTROL MEASURES AFTER SEEDING AREAS HAVE BEEN 75%-85% ESTABLISHED AND SITE IMPROVEMENTS ARE COMPLETE. SMOOTH AND RE-VEGETATE ALL DISTURBED AREAS.
- 23. CLEAN SITE AND ALL DRAINAGE STRUCTURES, PIPES AND SUMPS OF ALL SILT AND DEBRIS.
- 24. INSTALL ALL PAINTED PAVEMENT MARKINGS AND SIGNAGE PER THE PLANS AND DETAILS.
- 25. ALL EROSION CONTROLS SHALL BE INSPECTED WEEKLY AND AFTER EVERY HALF-INCH OF RAINFALL.
- UPON COMPLETION OF CONSTRUCTION, IT IS THE RESPONSIBILITY OF THE CONTRACTOR TO NOTIFY ANY RELEVANT PERMITTING AGENCIES THAT THE

304 MAPLEWOOD AVENUE, PORTSMOUTH, NH 03801

CONSTRUCTION HAS BEEN FINISHED IN A SATISFACTORY MANNER.

Owner of Record

EROSION AND SEDIMENT CONTROL DETAIL

INDUSTRIAL WAREHOUSE Project: 375 BANFIELD ROAD, PORTSMOUTH, NH 03801 BANFIELD REALTY LLC

SHEET 17 OF 24 JBE PROJECT NO. 19190.2

DRAWING No.

LARGE CONTRIBUTING AREA.

ORGANIC FIBER BERM

NOT TO SCALE

Designed and Produced in NH Jones & Beach Engineers, Inc. 603-772-4746

Civil Engineering Services 85 Portsmouth Ave. FAX: 603-772-0227 PO Box 219 E-MAIL: JBE@JONESANDBEACH.COM Stratham, NH 03885

PARTICLE SIZES, MAY CONTAIN ROCKS LESS THAN 4" IN DIAMETER, STUMP GRINDINGS, SHREDDED OR COMPOSTED BARK, OR ACCEPTABEL MANUFACTURED PRODUCTS, AND SHALL BE FREE OF REFUSE, PHYSICAL CONTAMINANTS, AND MATERIAL TOXIC TO PLANT GROWTH, AND SHALL MEET THE FOLLOWING STANDARDS: a) THE ORGANIC CONTENT SHALL BE 80-100% OF DRY WEIGHT. b) PARTICLE SIZE BY WEIGHT SHALL BE 100% PASSING A 6" SCREEN, AND 70-85%) THE ORGANIC PORTION SHALL BE FIBROUS AND ELONGATED. d) LARGE PORTIONS OF SILTS, CLAYS, OR FINE SANDS SHALL NOT BE INCLUDED IN THE e) SOLUBLE SALTS CONTENT SHALL BE >4.0mmhos/cm. f) THE pH SHALL BE BETWEEN 5.0 AND 8.0. 3. ORGANIC FILTER BERMS SHALL BE INSTALLED ALONG A RELATIVELY LEVEL CONTOUR. IT MAY BE NECESSARY TO CUT TALL GRASSES OR WOODY VEGETATION TO AVOID CREATING VOIDS AND

- Wire Screen

SUITABLE UPLAND AREA AND PROTECTED FROM EROSION BY EITHER STRUCTURE OR VEGETATIVE MEANS. CONTRIBUTING DRAINAGE AREA TO THE INLET HAS BEEN COMPLETELY STABILIZED.


(Block and Gravel Drop Inlet Sediment Filter)

NOT TO SCALE

Design: JAC | Draft: DJM

Drawing Name: 19190-PLAN-NEW-LAYOUT.dwg

DJM DJM DJM DJM BY

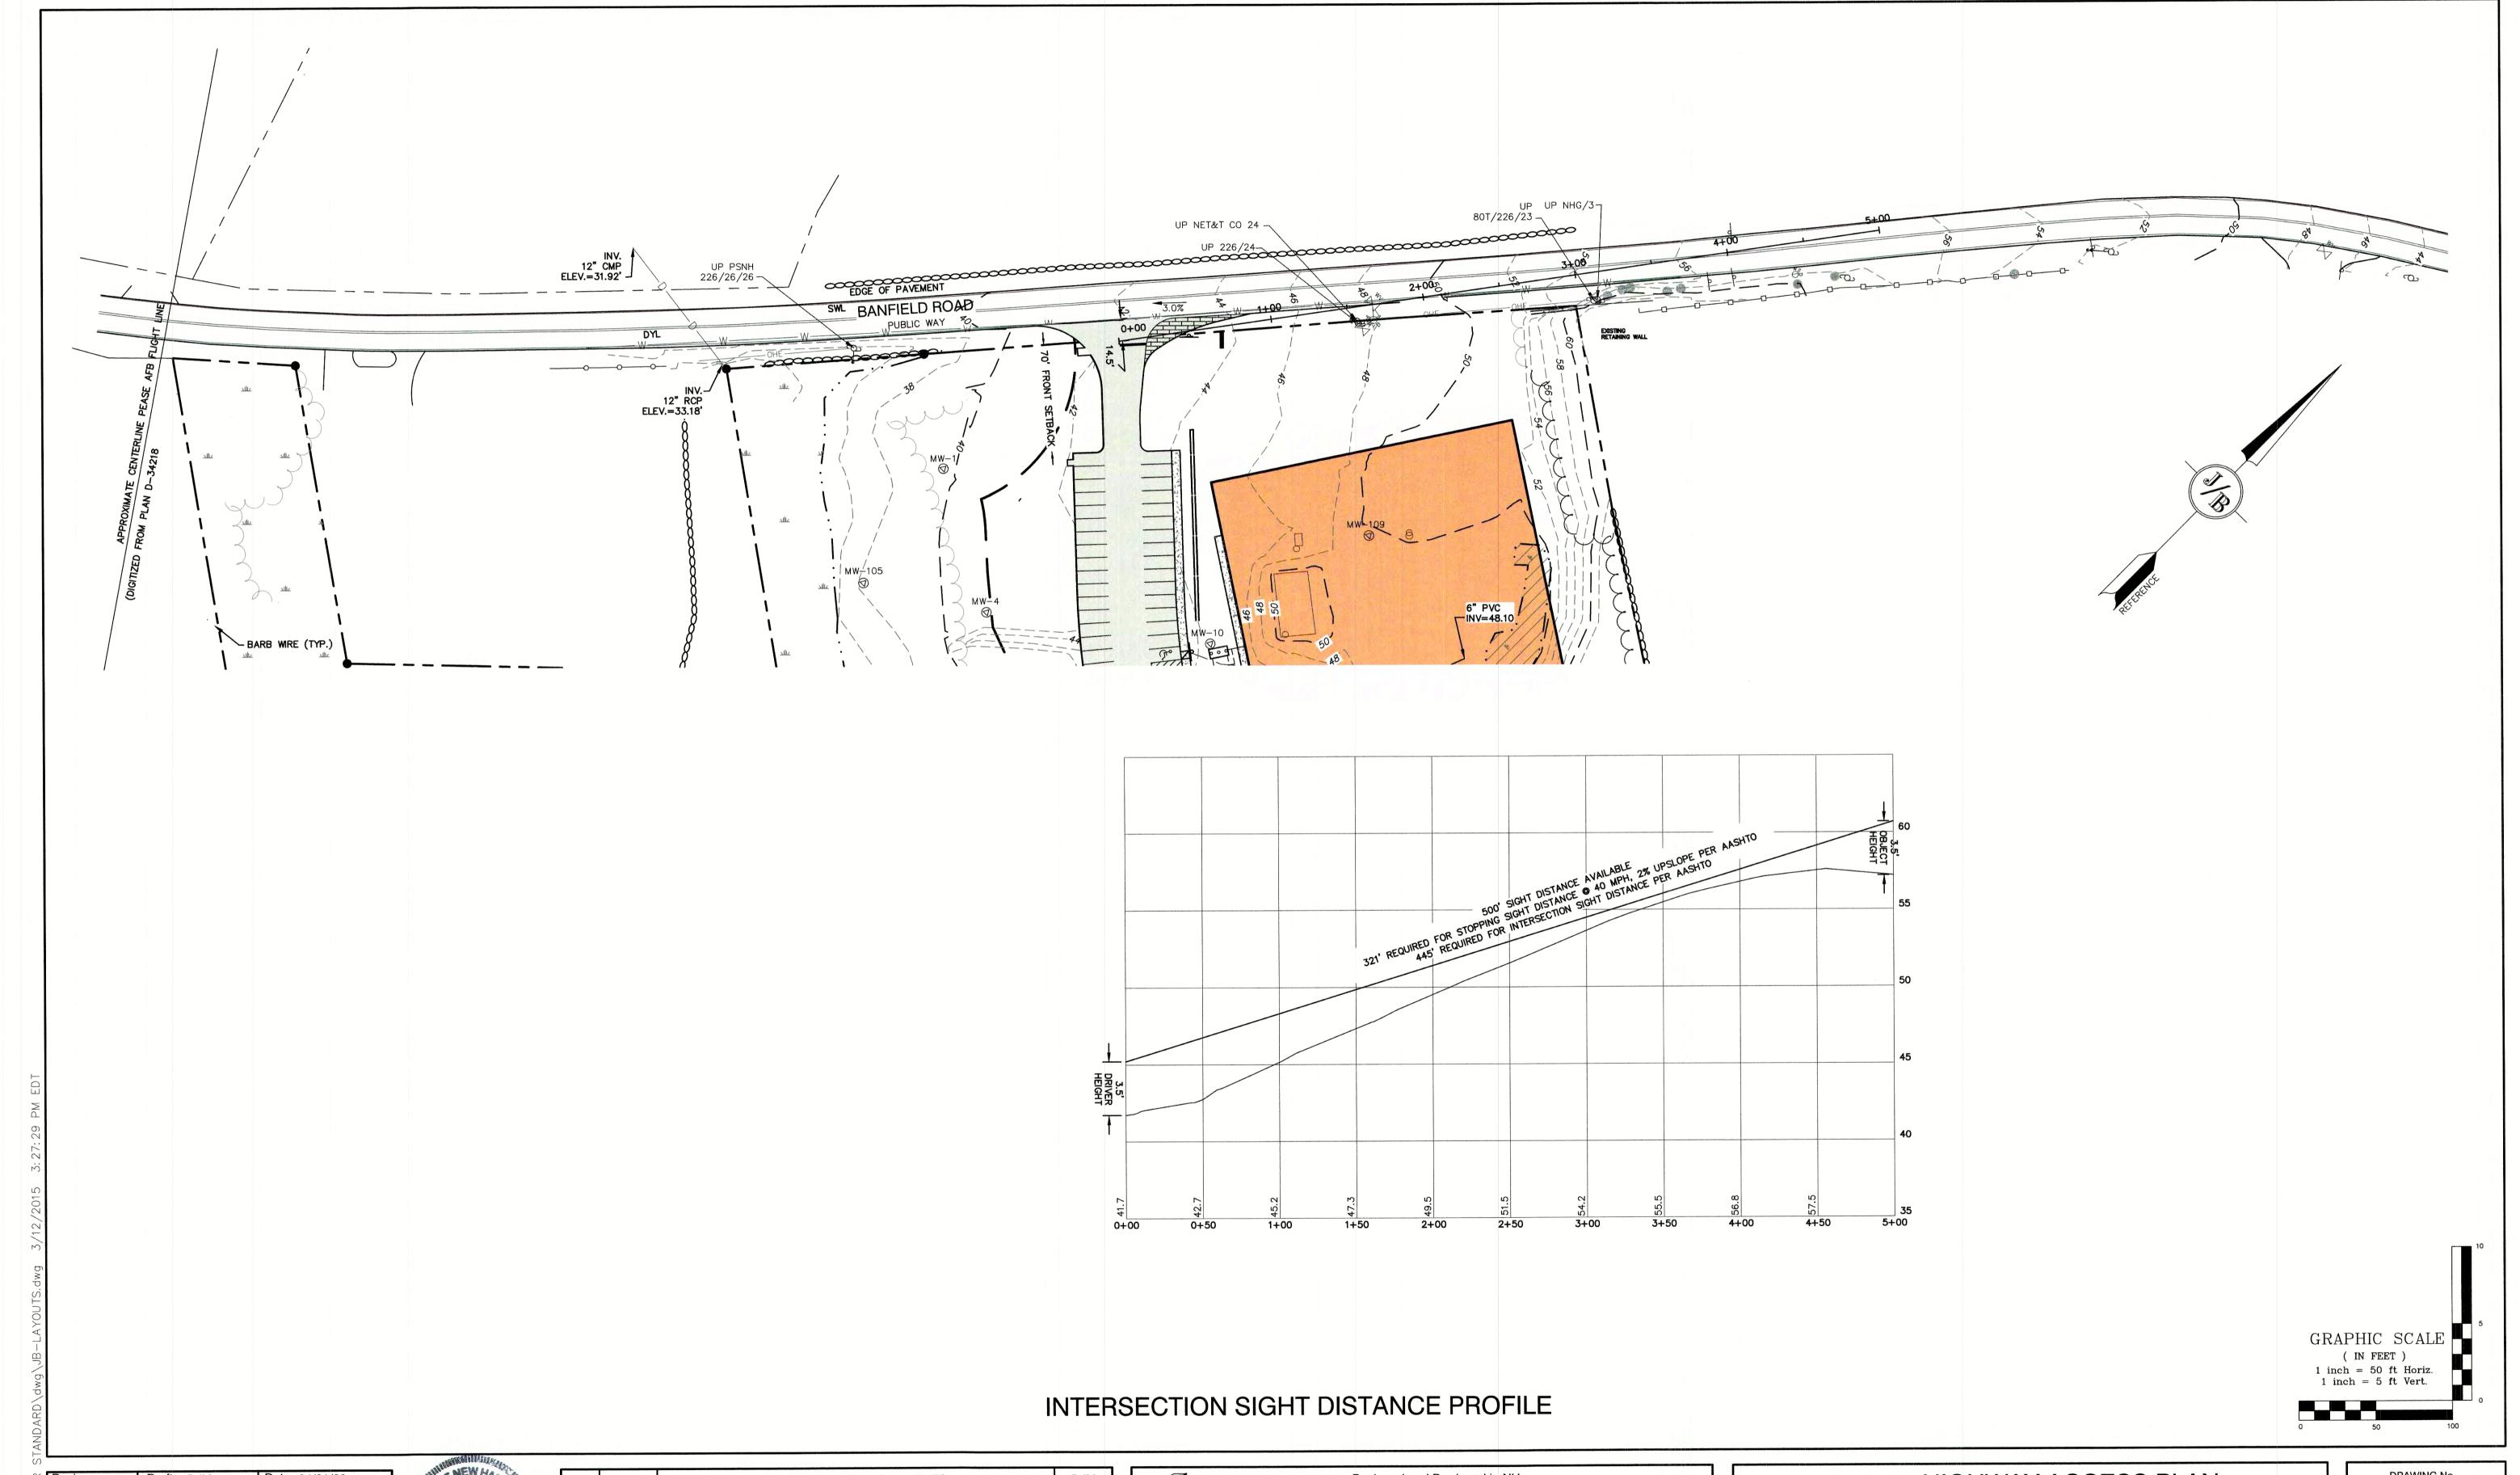

Design: JAC Draft: DJM Date: 04/21/20 Checked: JAC Scale: AS-NOTED Project No.: 19190.2
Drawing Name: 19190-PLAN-NEW-LAYOUT.dwg THIS PLAN SHALL NOT BE MODIFIED WITHOUT WRITTEN PERMISSION FROM JONES & BEACH ENGINEERS, INC. (JBE). ANY ALTERATIONS, AUTHORIZED OR OTHERWISE, SHALL BE AT THE USER'S SOLE RISK AND WITHOUT LIABILITY TO JBE.




7	13	6/23/21	REVISED PER CITY COMMENTS	DJM
203	12	5/18/21	REVISED PLANTINGS PER NHB	DJM
7	11	5/17/21	ISSUED REVISED PLANS TO TAC	DJM
2/2	10	5/10/21	ISSUED REVISED PLANS FOR PRELIMINARY PB CONSULTATION	DJM
0	9	3/9/21	REVISED CONCEPTUAL LAYOUT	DJM
	REV.	DATE	REVISION	BY

7/			signed and Pro				
B_{Jc}	nes	&	Beach	ı E	ngine	eers,	Inc.
85 Portsmouth Ave. PO Box 219 Stratham, NH 03885	Civil	Eng	ineering	Serv	ices	603	-772-4746

Plan Name:	HIGHWAY ACCESS PLAN
Project:	INDUSTRIAL WAREHOUSE 375 BANFIELD ROAD, PORTSMOUTH, NH 03801
Owner of Record:	BANFIELD REALTY LLC 304 MAPLEWOOD AVENUE, PORTSMOUTH, NH 03801



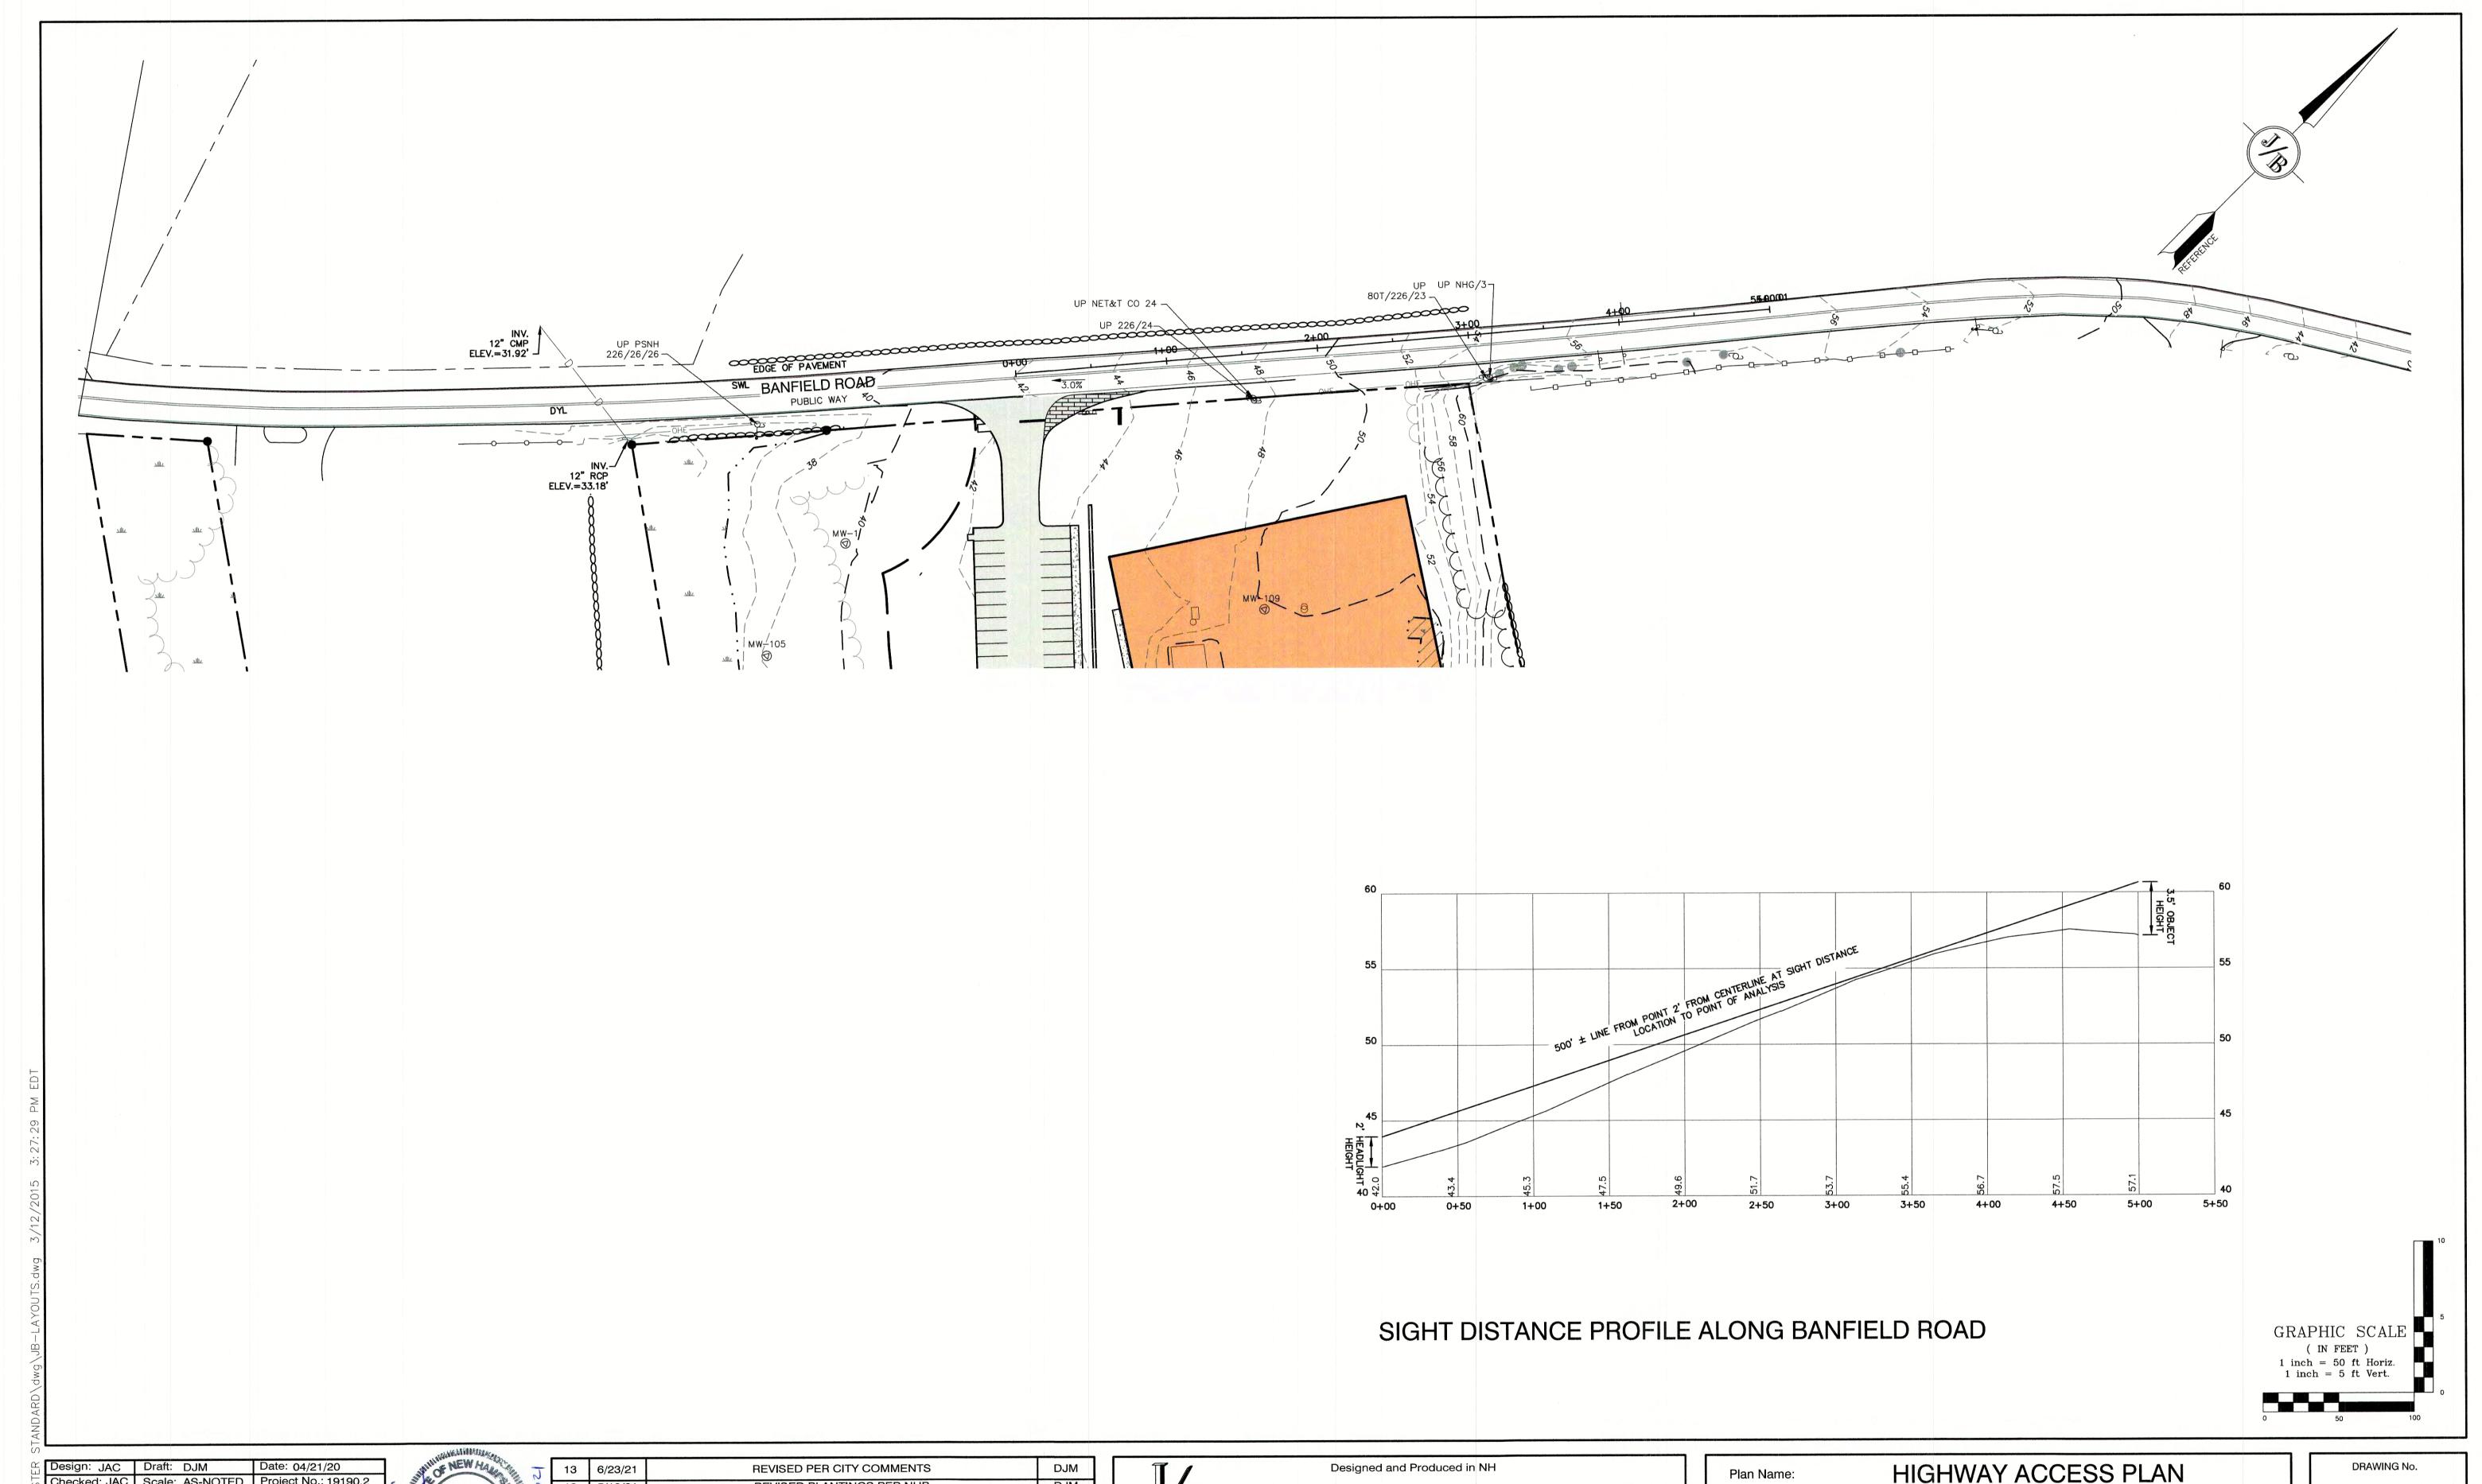

Design: JAC Draft: DJM Date: 04/21/20
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22	11	5/17/21	ISSUED REVISED PLANS TO TAC	DJM
	10	5/10/21	ISSUED REVISED PLANS FOR PRELIMINARY PB CONSULTATION	DJM
19	9	3/9/21	REVISED CONCEPTUAL LAYOUT	DJM
	REV.	DATE	REVISION	BY

B Jones & Beach Engineers, Inc.

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Stratham, NH 03885

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Beach Engineers, Inc.


603-772-4746
FAX: 603-772-0227
FAX: 603-772-0227
E-MAIL: JBE@JONESANDBEACH.COM


Plan Name:	HIGHWAY ACCESS PLAN
Project:	INDUSTRIAL WAREHOUSE

Owner of Record:


1NDUSTRIAL WAREHOUSE
375 BANFIELD ROAD, PORTSMOUTH, NH 03801

BANFIELD REALTY LLC
304 MAPLEWOOD AVENUE, PORTSMOUTH, NH 03801

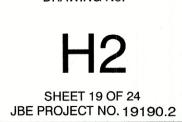

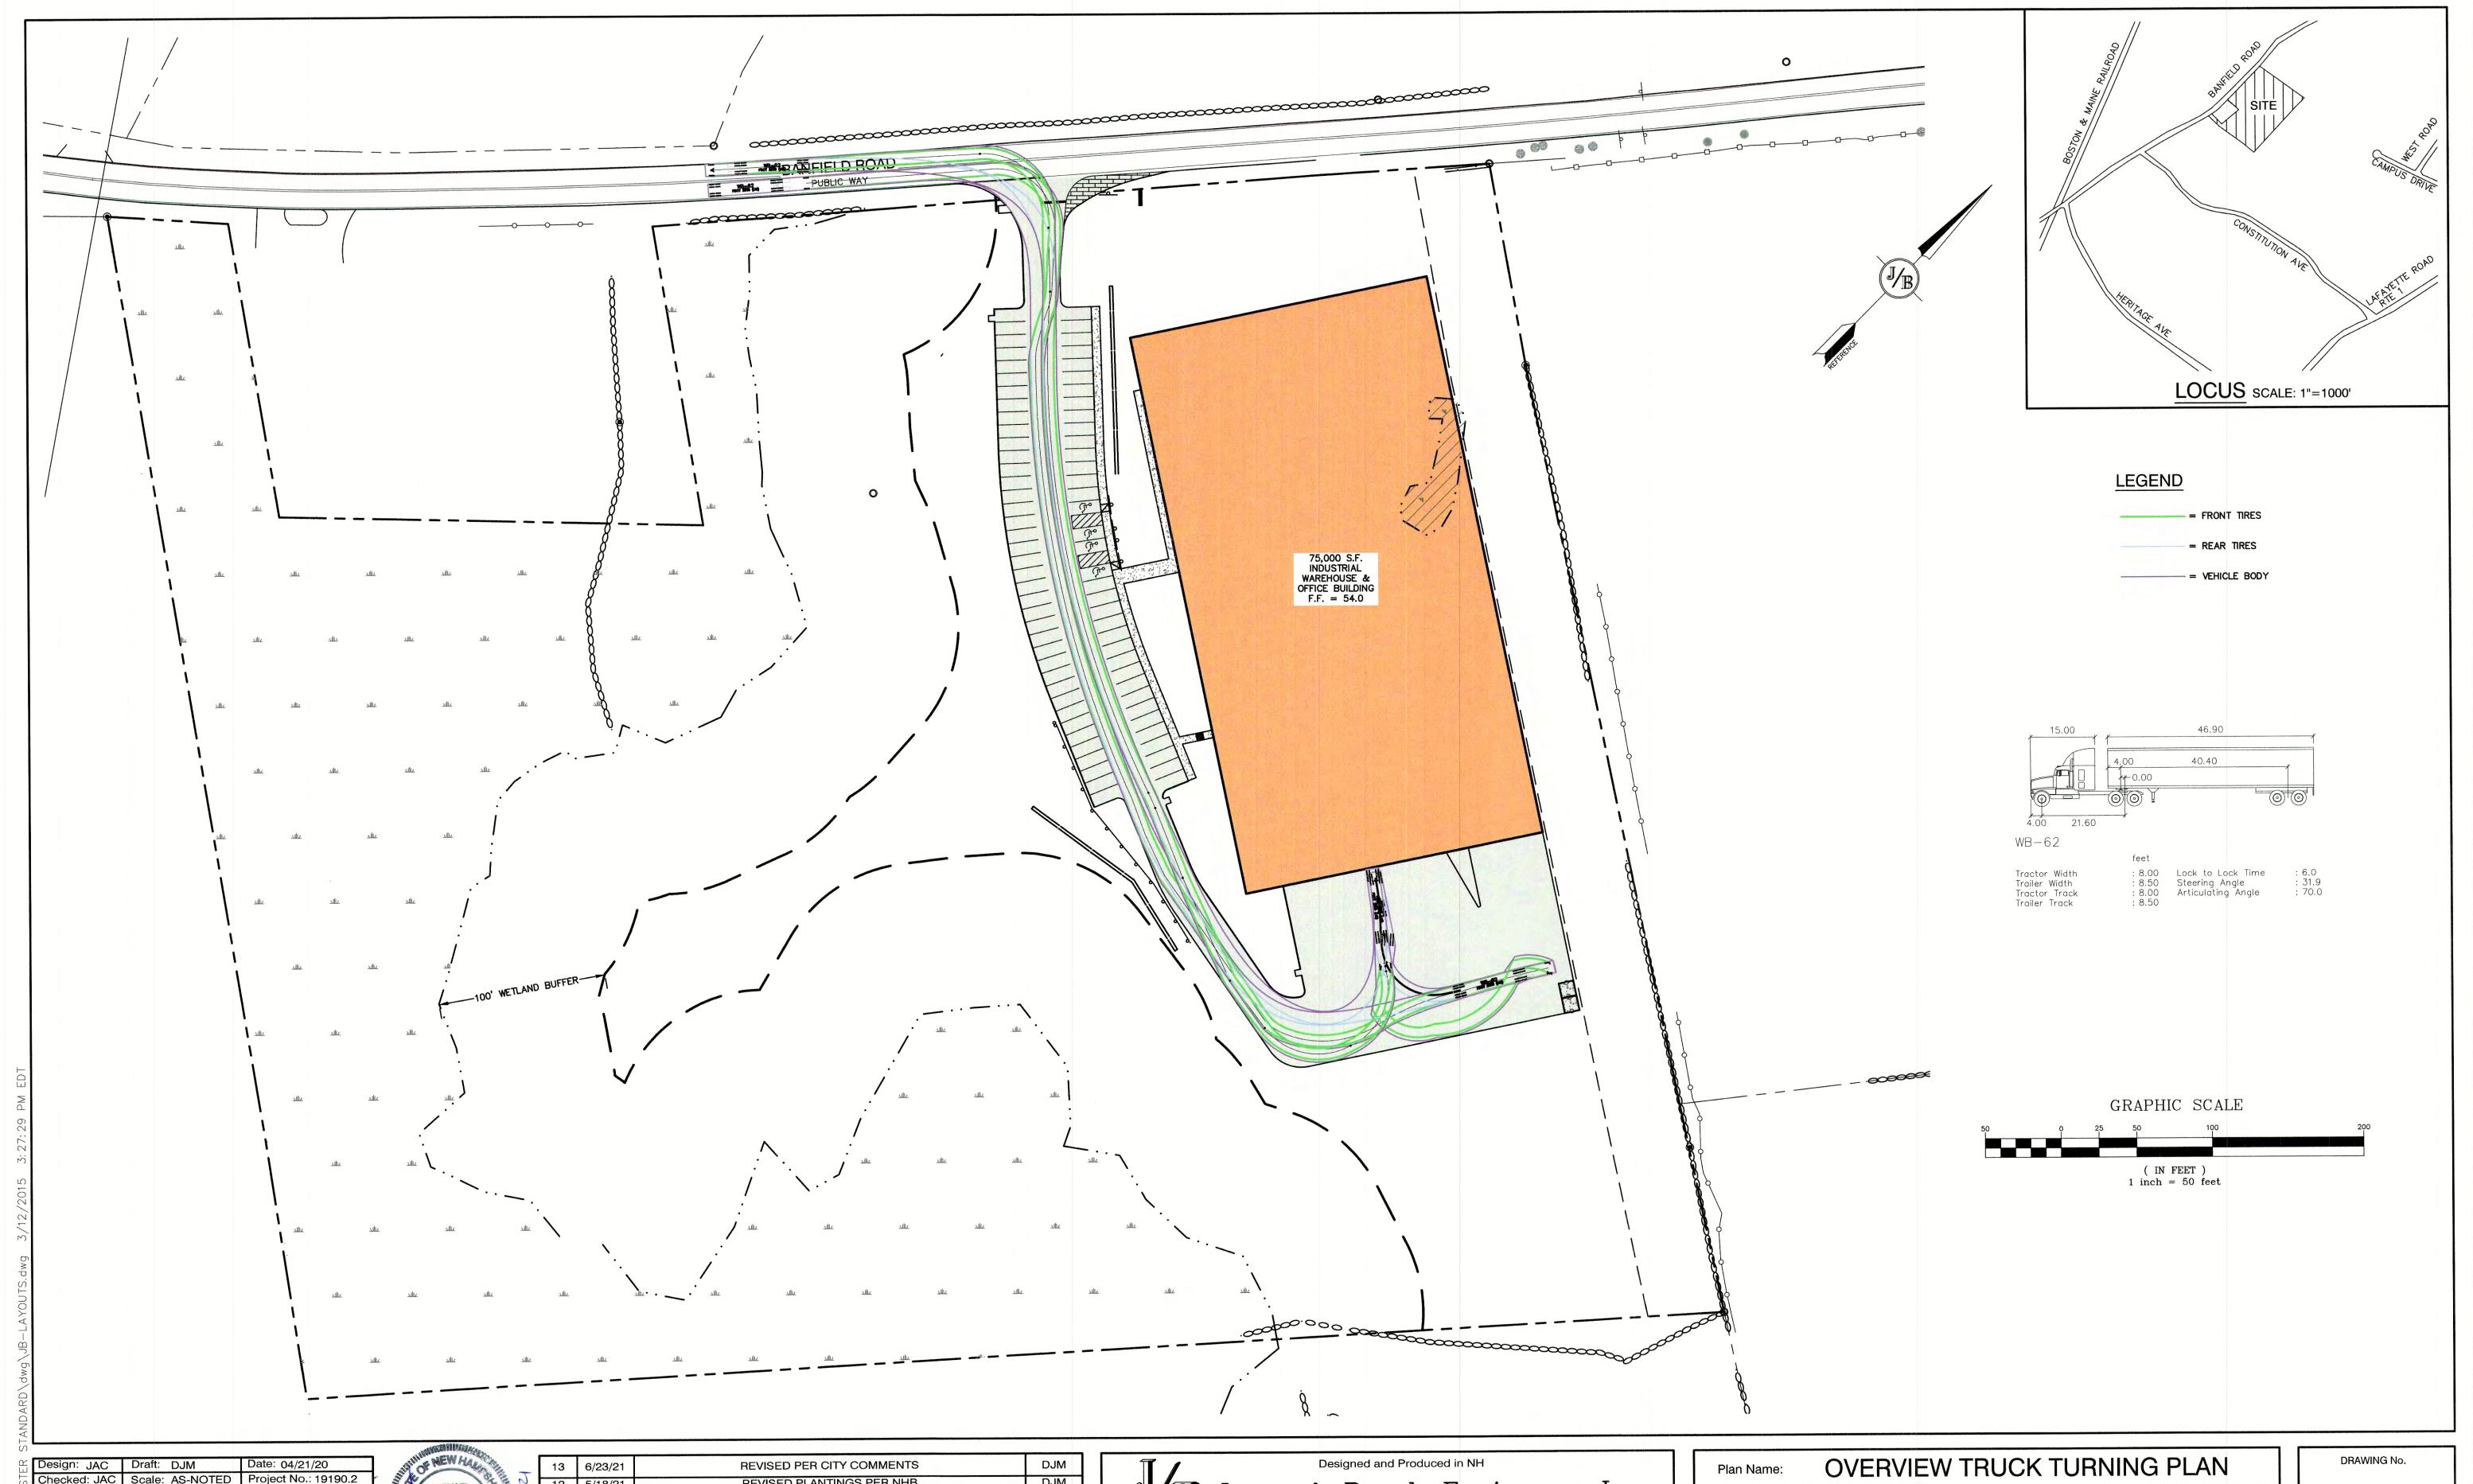

Design: JAC Draft: DJM Date: 04/21/20
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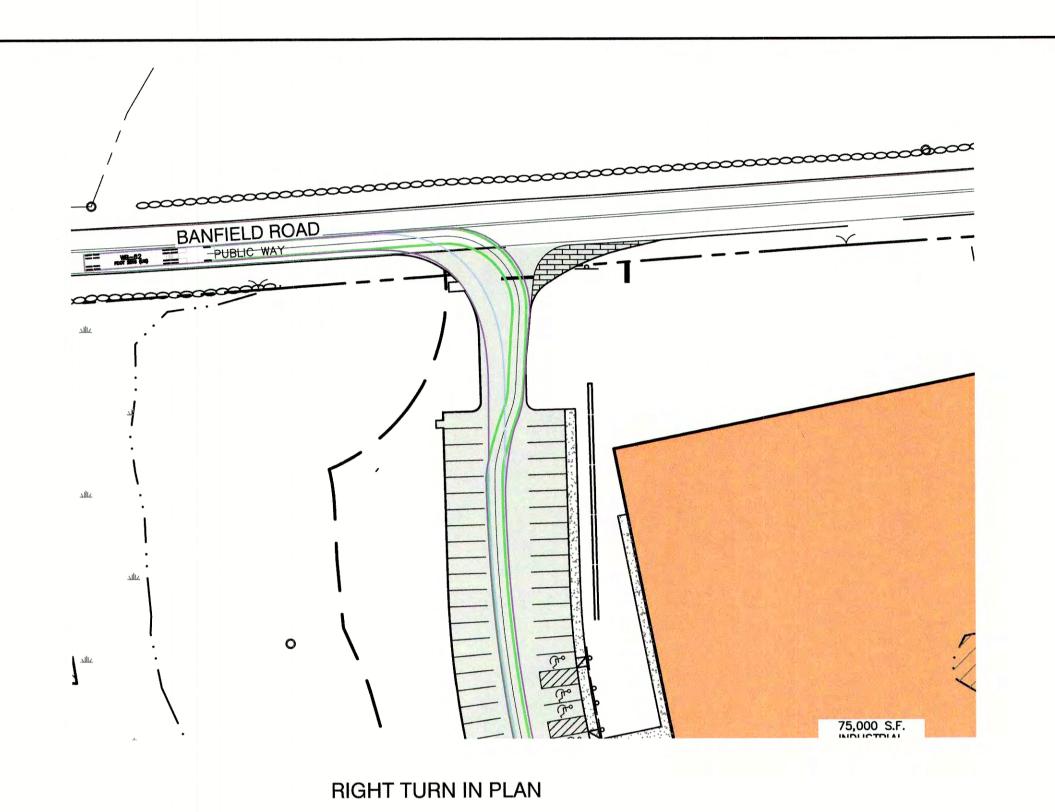


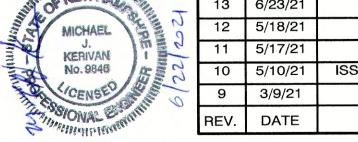
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	12	5/18/21	REVISED PLANTINGS PER NHB	DJM
	11	5/17/21	ISSUED REVISED PLANS TO TAC	DJM
22	10	5/10/21	ISSUED REVISED PLANS FOR PRELIMINARY PB CONSULTATION	DJM
9	9	3/9/21	REVISED CONCEPTUAL LAYOUT	DJM
	REV.	DATE	REVISION	BY


7/		Des	signed and Pro	duced ir	n NH		
B Jo	nes	&	Beach	ı E	nginee	rs,	Inc.
85 Portsmouth Ave. PO Box 219 Stratham, NH 03885	Civil	Eng	ineering	Serr	11.000	AX: 603	-772-0227

	Plan Name:	OVERVIEW TRUCK TURNING PLAN
ľ	Project:	INDUSTRIAL WAREHOUSE 375 BANFIELD ROAD, PORTSMOUTH, NH 03801
	Owner of Record:	BANFIELD REALTY LLC 304 MAPLEWOOD AVENUE, PORTSMOUTH, NH 03801

SHEET 20 OF 24 JBE PROJECT NO. 19190.2



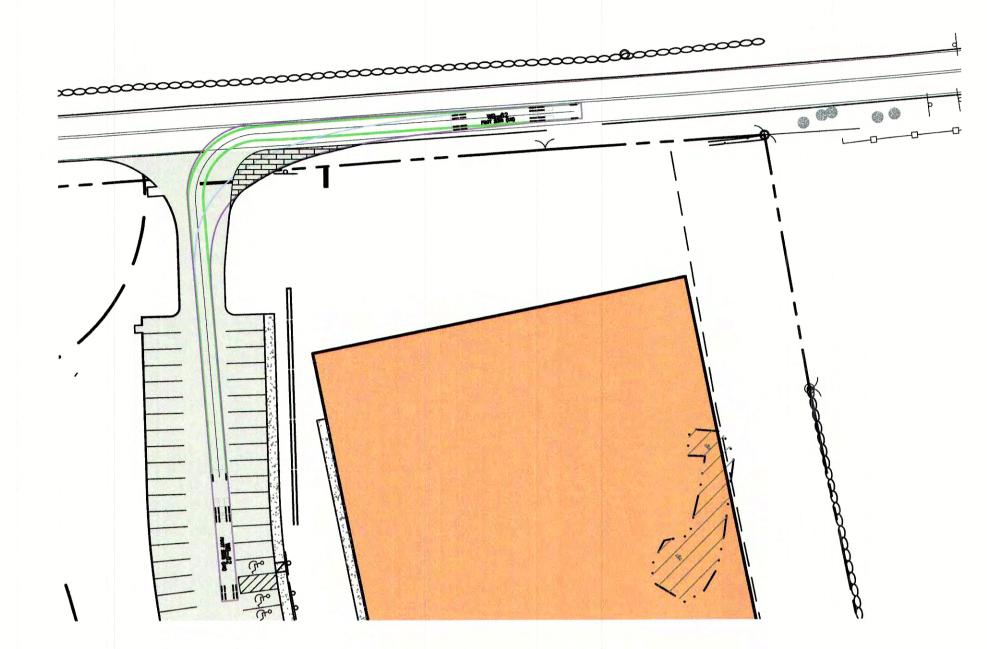

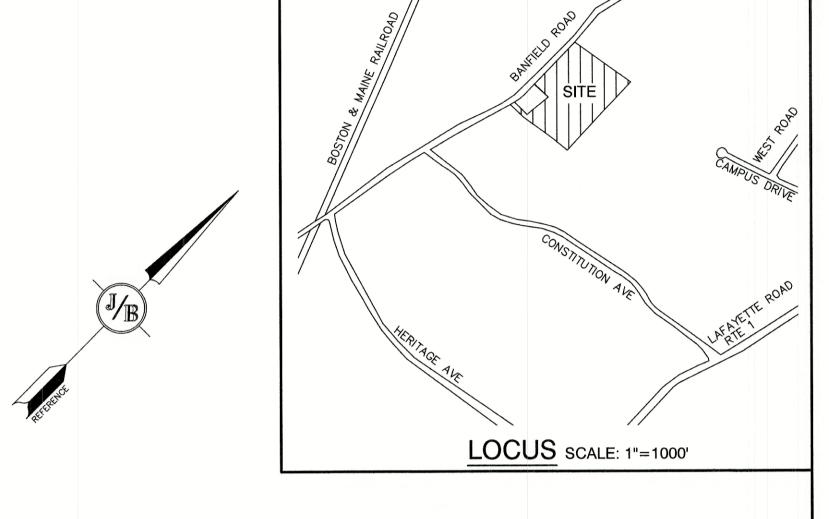



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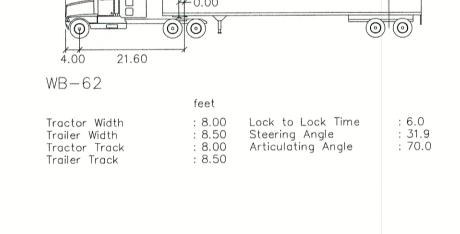
= FRONT TIRES

= VEHICLE BODY

RIGHT TURN OUT PLAN



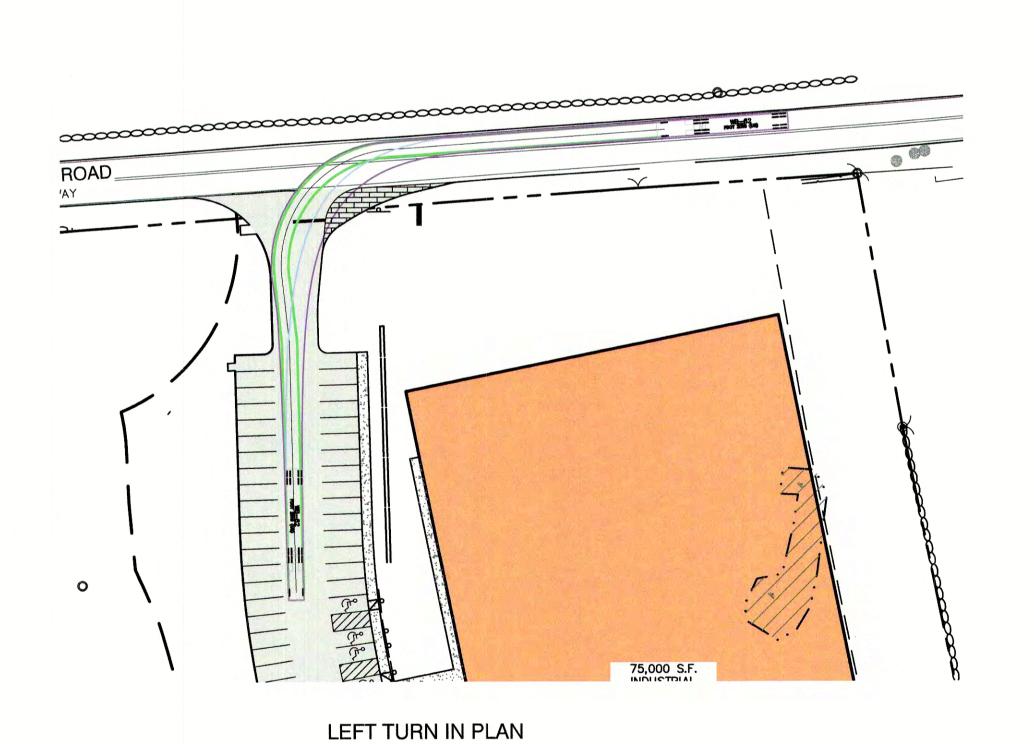

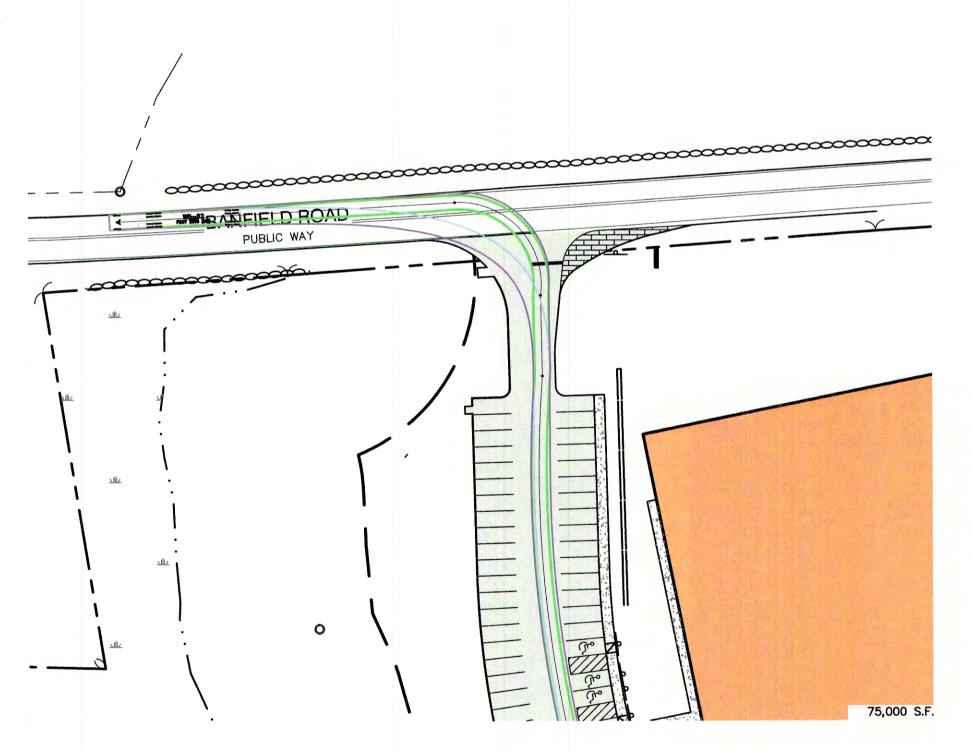

GRAPHIC SCALE

0 25 50 100 200

(IN FEET)
1 inch = 50 feet

LEFT TURN OUT PLAN

Design: JAC Draft: DJM Date: 04/21/20
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Drawing Name: 19190-PLAN-NEW-LAYOUT.dwg
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MICHAEL
KERIVAN
NO. 9846

CENSED

22/22	13	6/23/21	REVISED PER CITY COMMENTS	DJM
	12	5/18/21	REVISED PLANTINGS PER NHB	DJM
	11	5/17/21	ISSUED REVISED PLANS TO TAC	DJM
	10	5/10/21	ISSUED REVISED PLANS FOR PRELIMINARY PB CONSULTATION	DJM
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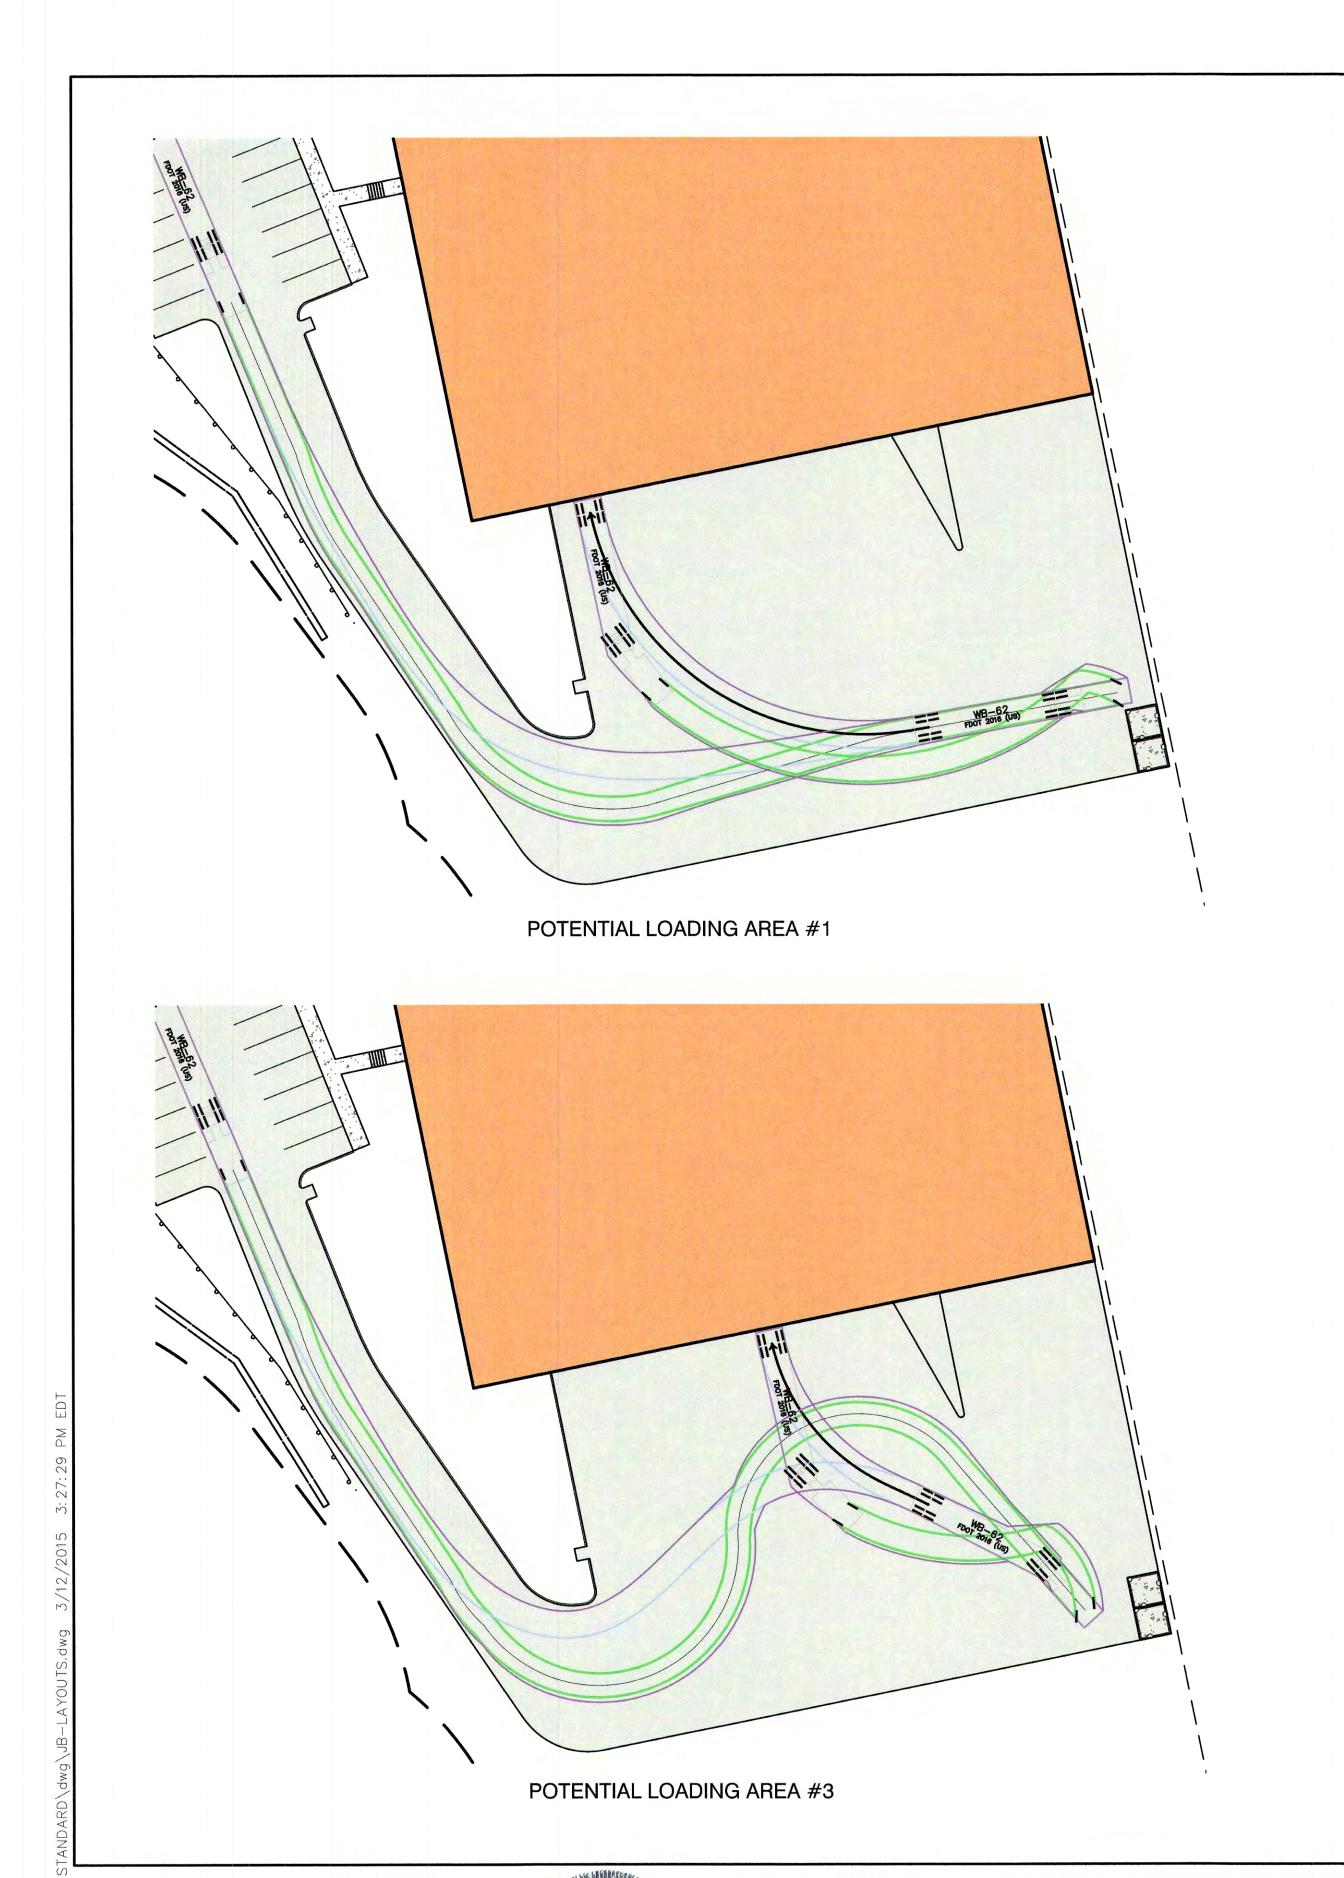



Plan Name:	DETAIL TRUCK TURNING PLAN


Project: INDUSTRIAL WAREHOUSE
375 BANFIELD ROAD, PORTSMOUTH, NH 03801

Owner of Record: BANFIELD REALTY LLC
304 MAPLEWOOD AVENUE, PORTSMOUTH, NH 03801


T2
SHEET 21 OF 24
JBE PROJECT NO. 19190.2




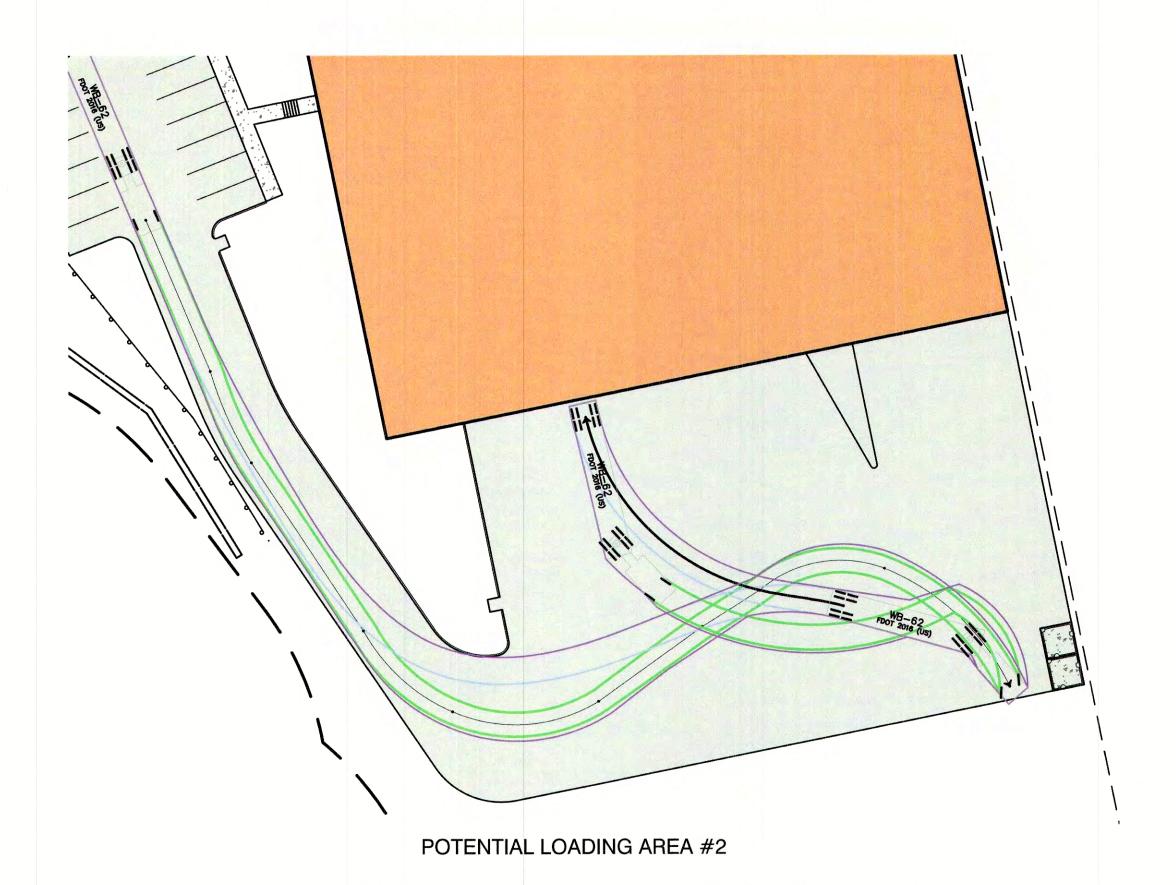

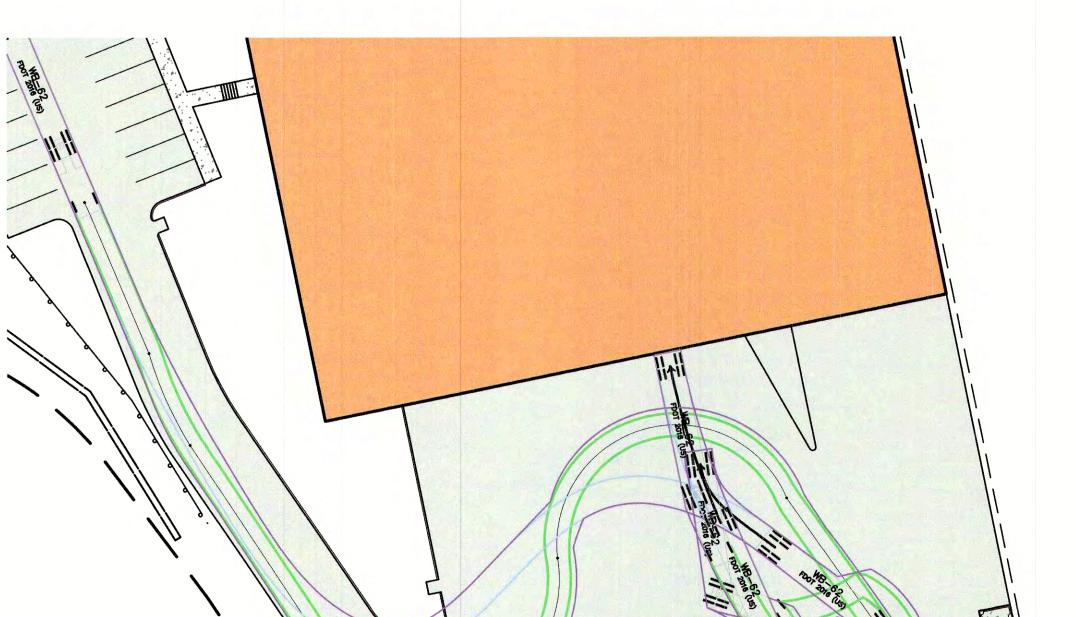


POTENTIAL LOADING AREA #4

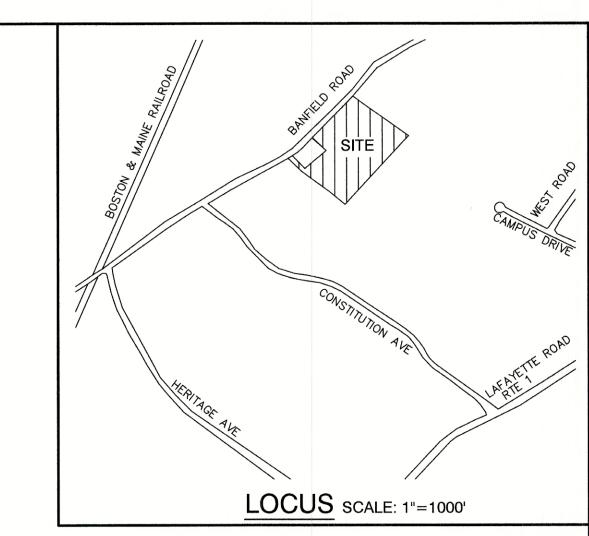

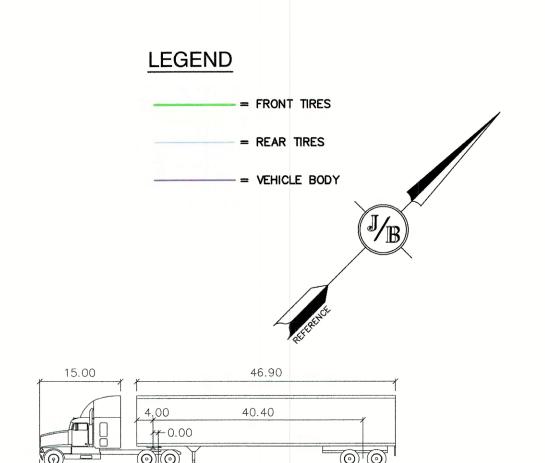

: 8.00 Lock to Lock Time : 8.50 Steering Angle : 8.00 Articulating Angle : 8.50

Tractor Width Trailer Width Tractor Track Trailer Track

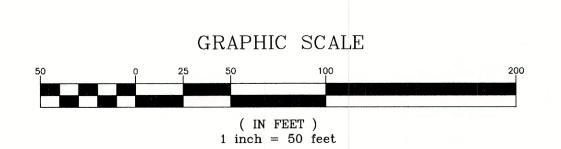

Design: JAC Draft: DJM Date: 04/21/20
Checked: JAC Scale: AS-NOTED Project No.: 19190.2 Drawing Name: 19190-PLAN-NEW-LAYOUT.dwg

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J. KERIVAN No. 9846

	13	6/23/21	REVISED PER CITY COMMENTS	DJM
202	12	5/18/21	REVISED PLANTINGS PER NHB	DJM
SID	11	5/17/21	ISSUED REVISED PLANS TO TAC	DJM
22	10	5/10/21	ISSUED REVISED PLANS FOR PRELIMINARY PB CONSULTATION	DJM
6/22	9	3/9/21	REVISED CONCEPTUAL LAYOUT	DJM
6	REV.	DATE	REVISION	BY

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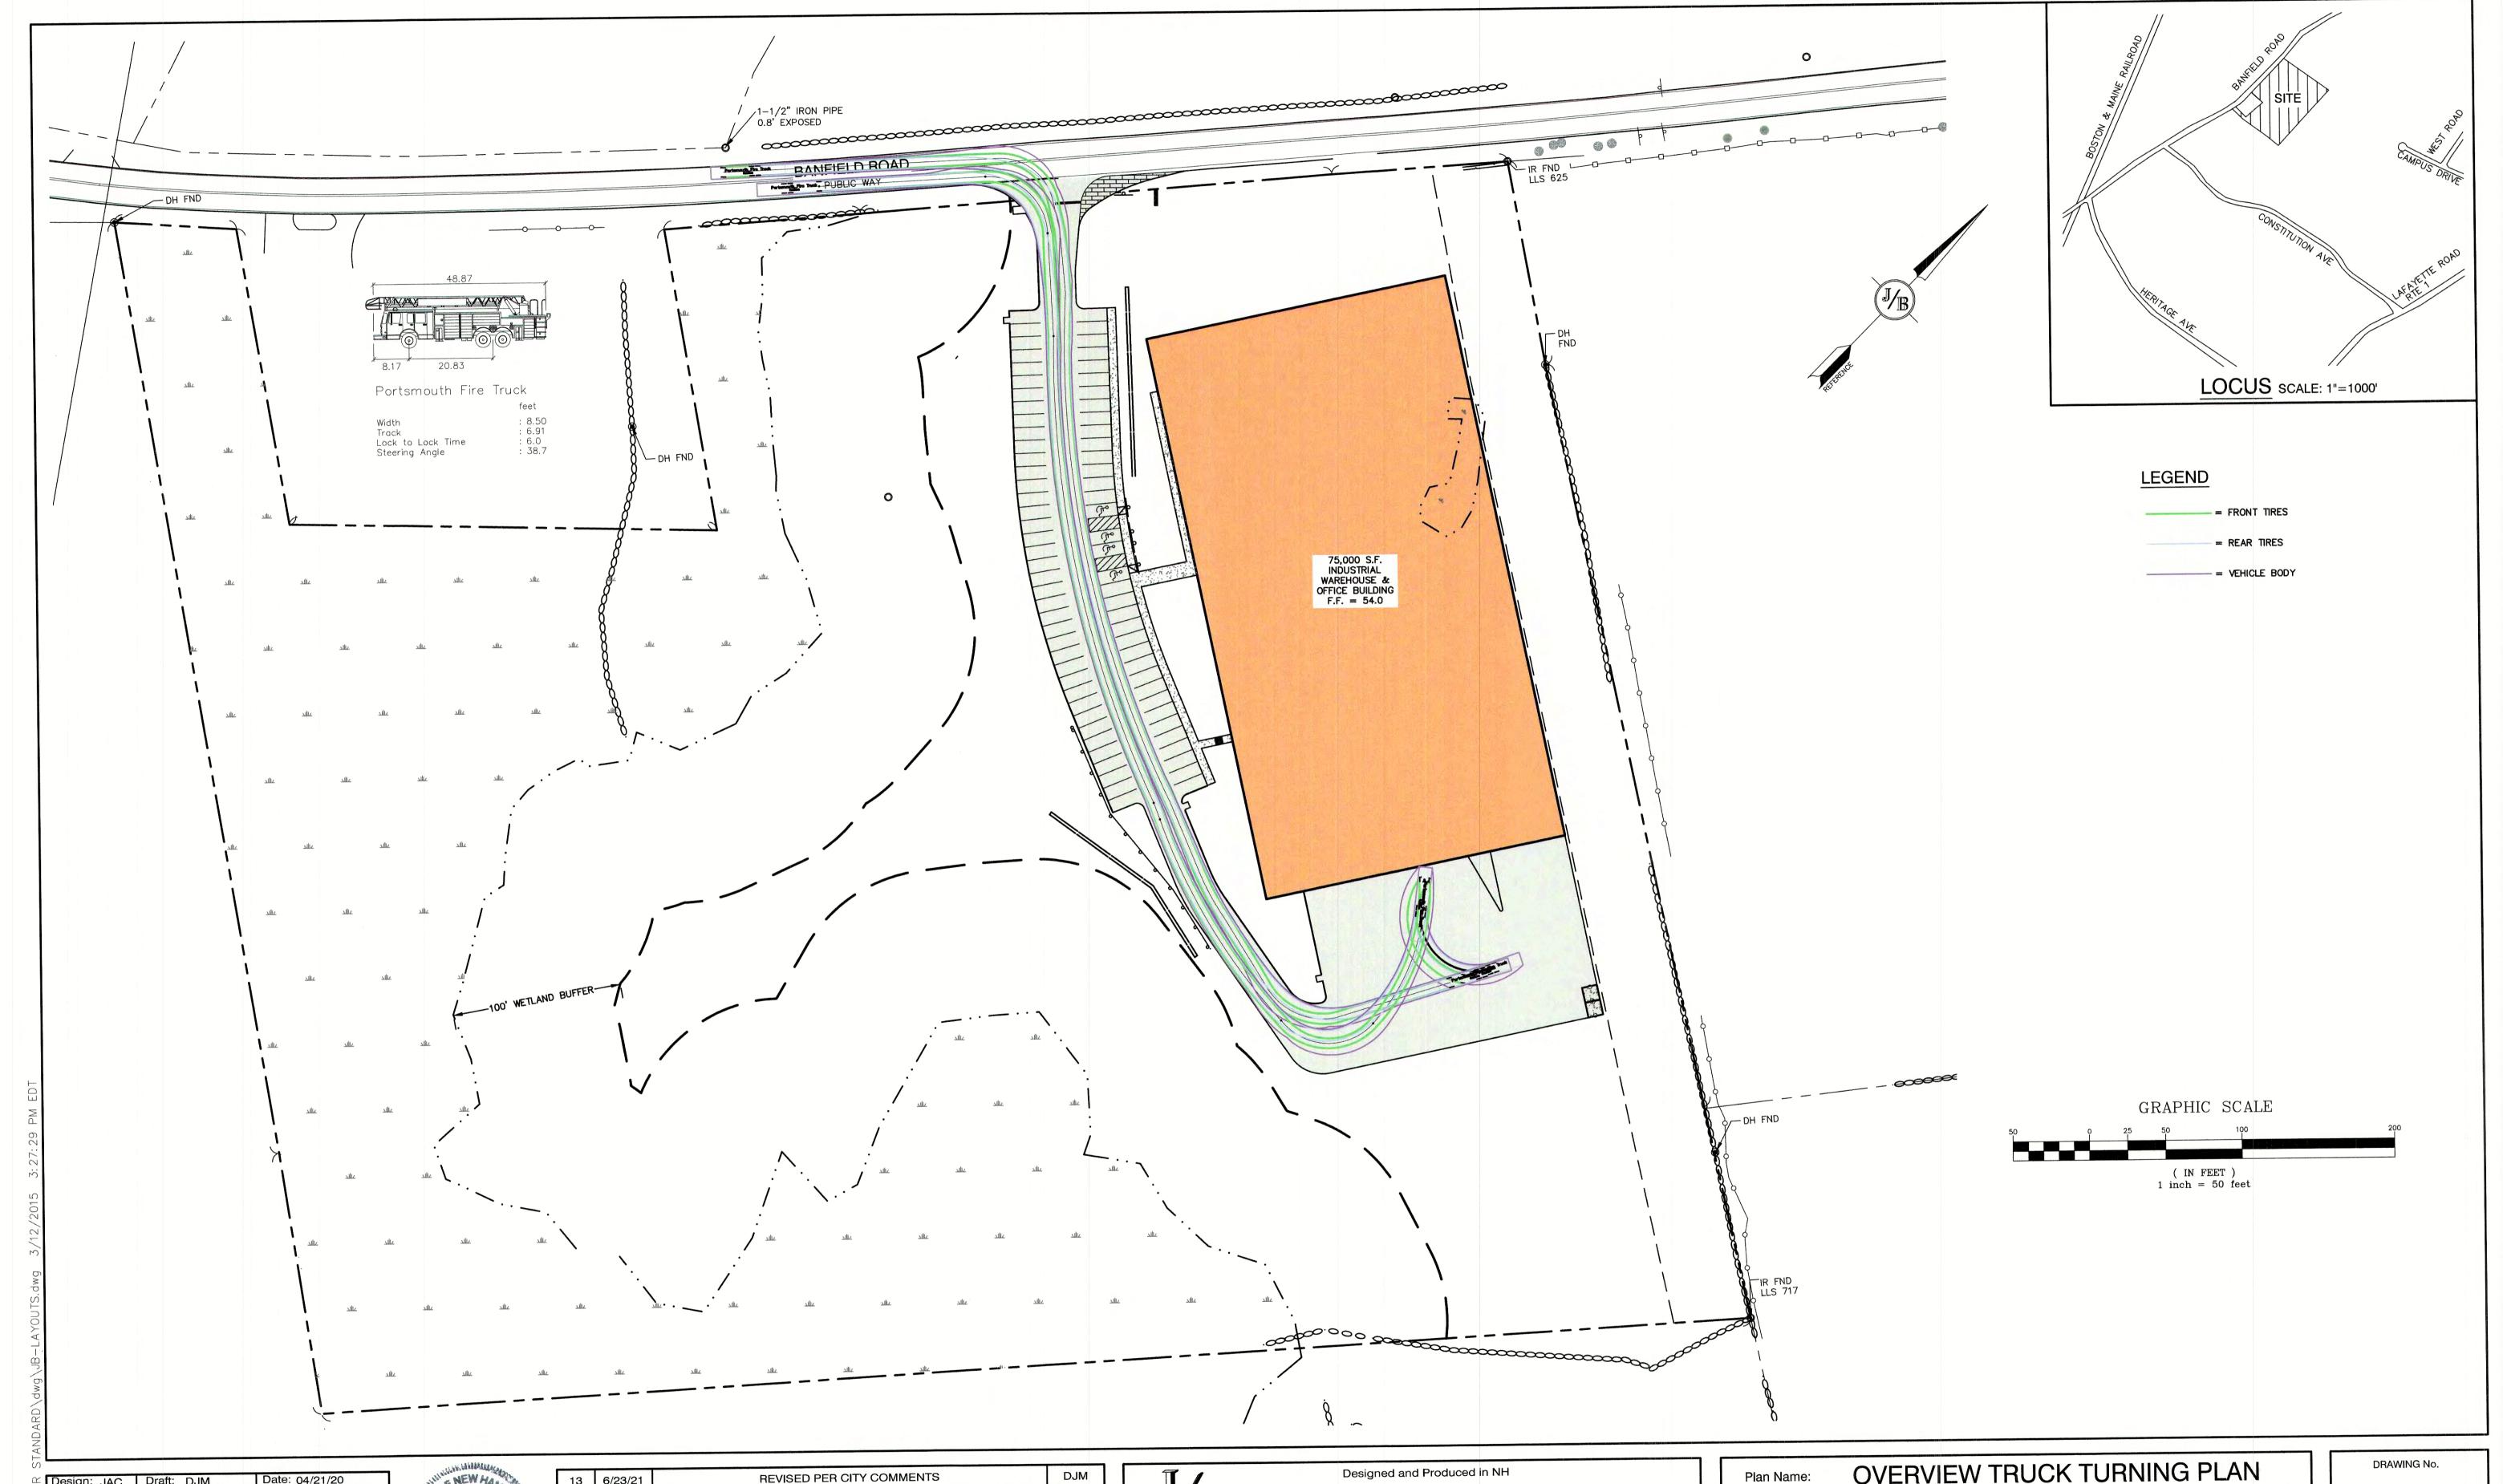
Civil Engineering Services
E-MAIL: JBE@. Services 603-772-4746 FAX: 603-772-0227 E-MAIL: JBE@JONESANDBEACH.COM

Plan Name:	REAR TRUCK TURNING PLAN
	INDUCTRIAL WAREHOUSE

Owner of Record:

INDUSTRIAL WAREHOUSE 375 BANFIELD ROAD, PORTSMOUTH, NH 03801 BANFIELD REALTY LLC 304 MAPLEWOOD AVENUE, PORTSMOUTH, NH 03801

DRAWING No. SHEET 22 OF 24 JBE PROJECT NO. 19190.2



Design: JAC Draft: DJM Date: 04/21/20
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Drawing Name: 19190-PLAN-NEW-LAYOUT.dwg
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		REVISION	BY
9	3/9/21	REVISED CONCEPTUAL LAYOUT	DJM
10	5/10/21	ISSUED REVISED PLANS FOR PRELIMINARY PB CONSULTATION	DJM
11	5/17/21	ISSUED REVISED PLANS TO TAC	DJM
12	5/18/21	REVISED PLANTINGS PER NHB	DJM
13	6/23/21	REVISED PER CITY COMMENTS	DJM

Bones & Beach Engineers, Inc.

See Bostomouth Ave. Civil Engineering Services 603-772-4746


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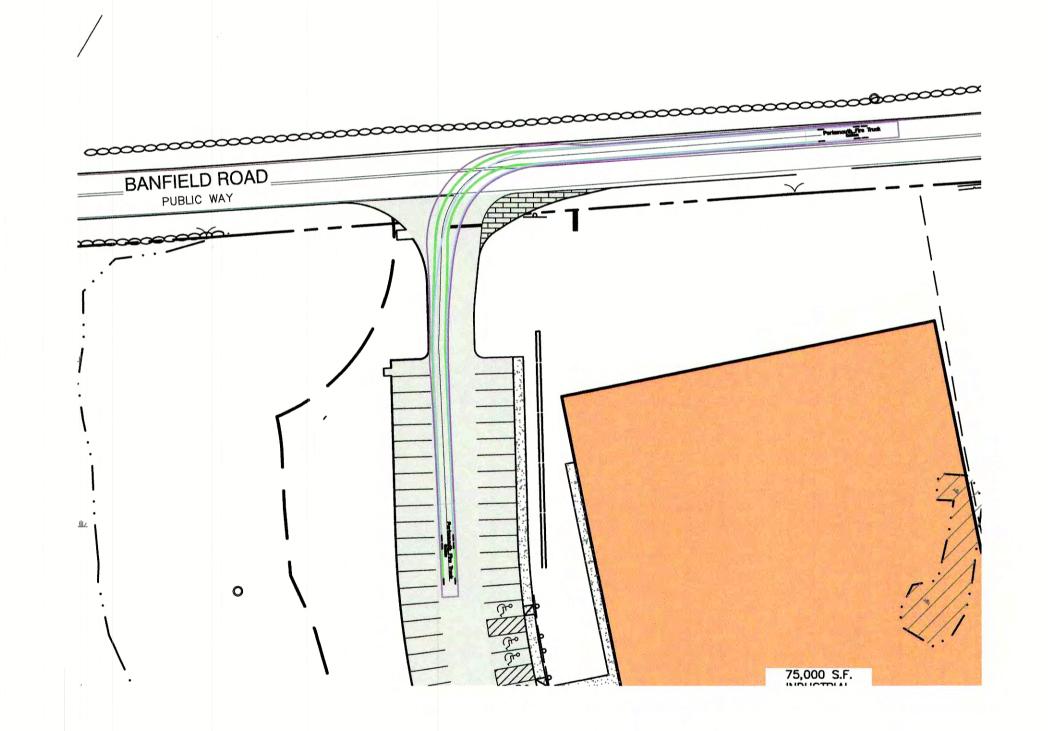
603-772-4746
FAX: 603-772-0227
E-MAIL: JBE@JONESANDBEACH.COM

Plan Name:	OVERVIEW TRUCK TURNING PLAN
Project:	INDUSTRIAL WAREHOUSE 375 BANFIELD ROAD, PORTSMOUTH, NH 03801
Owner of Record:	BANFIELD REALTY LLC 304 MAPLEWOOD AVENUE, PORTSMOUTH, NH 03801


T4
SHEET 23 OF 24
JBE PROJECT NO. 19190.2




RIGHT TURN IN PLAN

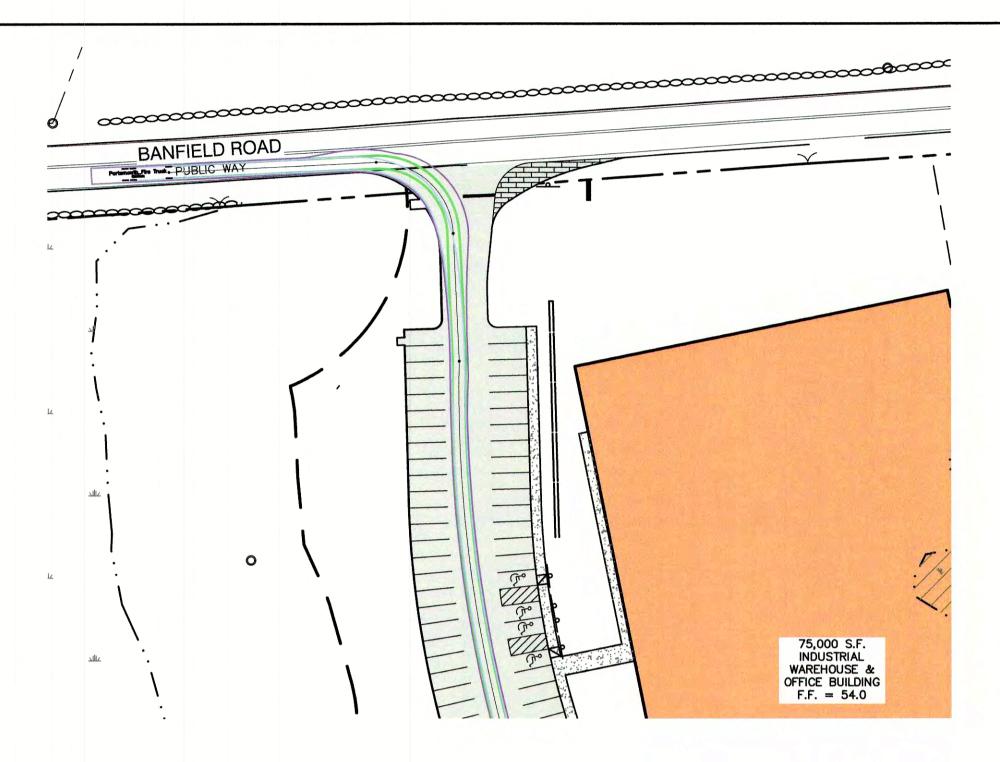


LEFT TURN IN PLAN

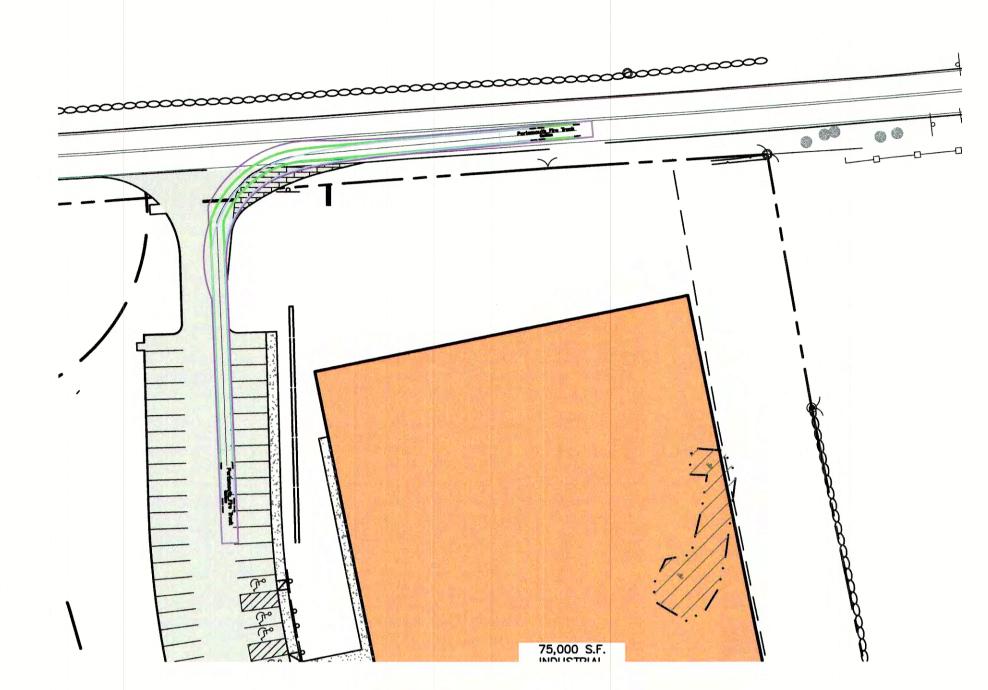

RIGHT TURN OUT PLAN

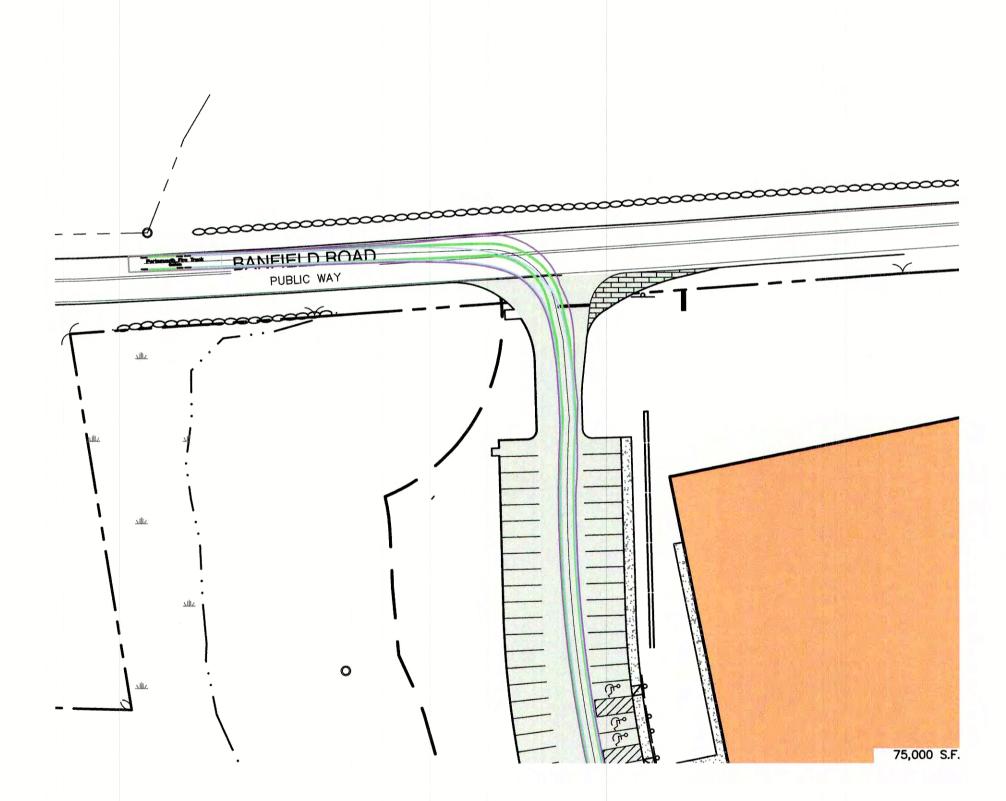


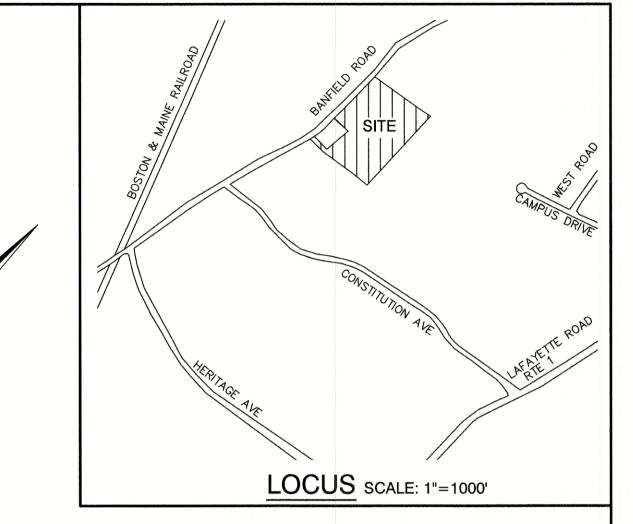

LEGE	V
------	---

- = FRONT TIRES = REAR TIRES

= VEHICLE BODY

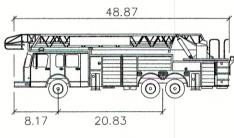

Portsmouth Fire Truck

Width Track Lock to Lock Time Steering Angle : 6.91 : 6.0 : 38.7

GRAPHIC SCALE (IN FEET) 1 inch = 50 feet

LEFT TURN OUT PLAN

Design: JAC Draft: DJM Date: 04/21/20
Checked: JAC Scale: AS-NOTED Project No.: 19190.2 Drawing Name: 19190-PLAN-NEW-LAYOUT.dwg

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6/22/2021	13	6/23/21	REVISED PER CITY COMMENTS	DJM
	12	5/18/21	REVISED PLANTINGS PER NHB	DJM
	11	5/17/21	ISSUED REVISED PLANS TO TAC	DJM
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	9	3/9/21	REVISED CONCEPTUAL LAYOUT	DJM
	REV.	DATE	REVISION	BY

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PO Box 219
Stratham, NH 03885

Civil Engineering Services
E-MAIL: JBE@G 603-772-4746 FAX: 603-772-0227

E-MAIL: JBE@JONESANDBEACH.COM

DETAIL TRUCK TURNING PLAN Plan Name:

INDUSTRIAL WAREHOUSE 375 BANFIELD ROAD, PORTSMOUTH, NH 03801 BANFIELD REALTY LLC 304 MAPLEWOOD AVENUE, PORTSMOUTH, NH 03801

Owner of Record:

SHEET 24 OF 24 JBE PROJECT NO. 19190.2