

DESCRIPTION **PROPERTY LINES** SETBACK LINES CENTERLINE RESHWATER WETLANDS LINE TIDAL WETLANDS LINE STREAM CHANNEL TREE LINE STONEWALL BARBED WIRE FENCE STOCKADE FENCE SOIL BOUNDARY AQUIFER PROTECTION LINE FLOOD PLAIN LINE ZONELINE EASEMENT MAJOR CONTOUR MINOR CONTOUR EDGE OF PAVEMENT VERTICAL GRANITE CURE SLOPE GRANITE CURB CAPE COD BERM POURED CONCRETE CURB SILT FENCE DRAINAGE LINE SEWER LINE SEWER FORCE MAIN GAS LINF WATFR IINF WATER SERVICE OVERHEAD ELECTRIC JNDERGROUND ELECTRIC GUARDRAIL JNDERDRAIN FIRE PROTECTION LINE THRUST BLOCK IRON PIPE/IRON ROD DRILL HOLE IRON ROD/DRILL HOLE STONE/GRANITE BOUND SPOT GRADE PAVEMENT SPOT GRADE CURB SPOT GRADE BENCHMARK (TBM) DOUBLE POST SIGN SINGLE POST SIGN WELL TEST PIT FAILED TEST PIT MONITORING WELL PERC TEST PHOTO LOCATION TREES AND BUSHES UTILITY POLE LIGHT POLES DRAIN MANHOLE SEWER MANHOLE HYDRANT WATER GATE WATER SHUT OFF REDUCER SINGLE GRATE CATCH BASIN DOUBLE GRATE CATCH BASIN TRANSFORMER CULVERT W/WINGWALLS CULVERT W/FLARED END SECTION CULVERT W/STRAIGHT HEADWALL STONE CHECK DAM DRAINAGE FLOW DIRECTION 4K SEPTIC AREA WETLAND IMPACT VEGETATED FILTER STRIP RIPRAP OPEN WATER FRESHWATER WETLANDS TIDAL WETLANDS STABILIZED CONSTRUCTION ENTRANCE CONCRETE GRAVEL SNOW STORAGE


# COMMERCIAL SITE PLAN TAX MAP 266, LOT 7

# "INDUSTRIAL WAREHOUSE" 375 BANFIELD ROAD, PORTSMOUTH, NH

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3/12/2015
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-BL/gwb/0
ASTER STANDARD
CADD\MASTER

Design: JAC	Draft: DJM	Date: 04/21/20
Checked: JAC		Project No.: 19190.2
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AT THE USER'S S	SOLE RISK AND WITHOU	T LIABILITY TO JBE.

RETAINING WALL

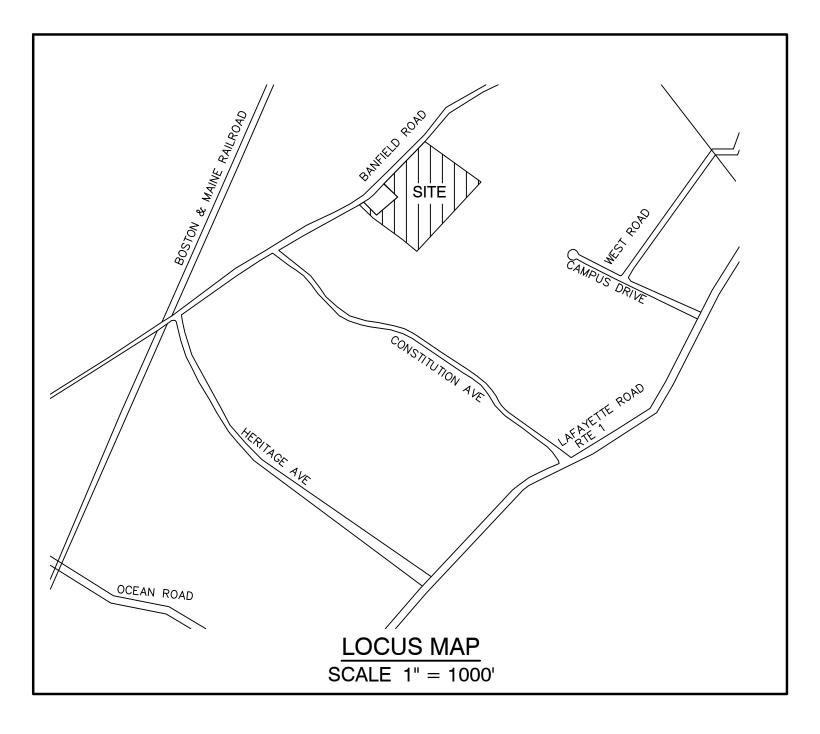

## SHEET INDEX

CS	COVER SHEET
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## **CIVIL ENGINEER / SURVEYOR**

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## WETLAND AND SOIL CONSULTANT

GOVE ENVIRONMENTAL SERVICES, INC. 8 CONTINENTAL DRIVE BUILDING 2 UNIT H EXETER, NH 03833 (603) 778-0644 CONTACT: JAMES GOVE JGOVE@GESINC.BIZ

## LANDSCAPE DESIGNER

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### ELECTRIC

EVERSOURCE ENERGY 74 OLD DOVER ROAD ROCHESTER, NH 03867 CONTACT: NICHOLAI KOSH (603) 555-5334

## TELEPHONE

FAIRPOINT COMMUNICATIO 1575 GREENLAND ROAD GREENLAND, NH 03840 CONTACT: JOE CONSIDINE (603) 427-5525

## CABLE TV

COMCAST COMMUNICATIO 334-B CALEF HIGHWAY EPPING, NH 03402-2325 (603) 679-5695


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ON CORPORATION			
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	DATE:		
COVER SHEET			DRAWING No.
INDUSTRIAL WAREHOUSE 5 BANFIELD ROAD, PORTSMOUTH, NH 03801			DRAWING No. DRAWING No. CS SHEET 1 OF 16 JBE PROJECT NO. 19190.2
BANFIELD REALTY LLC 304 MAPLEWOOD AVENUE, PORTSMOUTH, N		SHEET 1 OF 16	

## DIMENT CONTROL DETAILS


RAINAGE PLAN


IONS PLAN

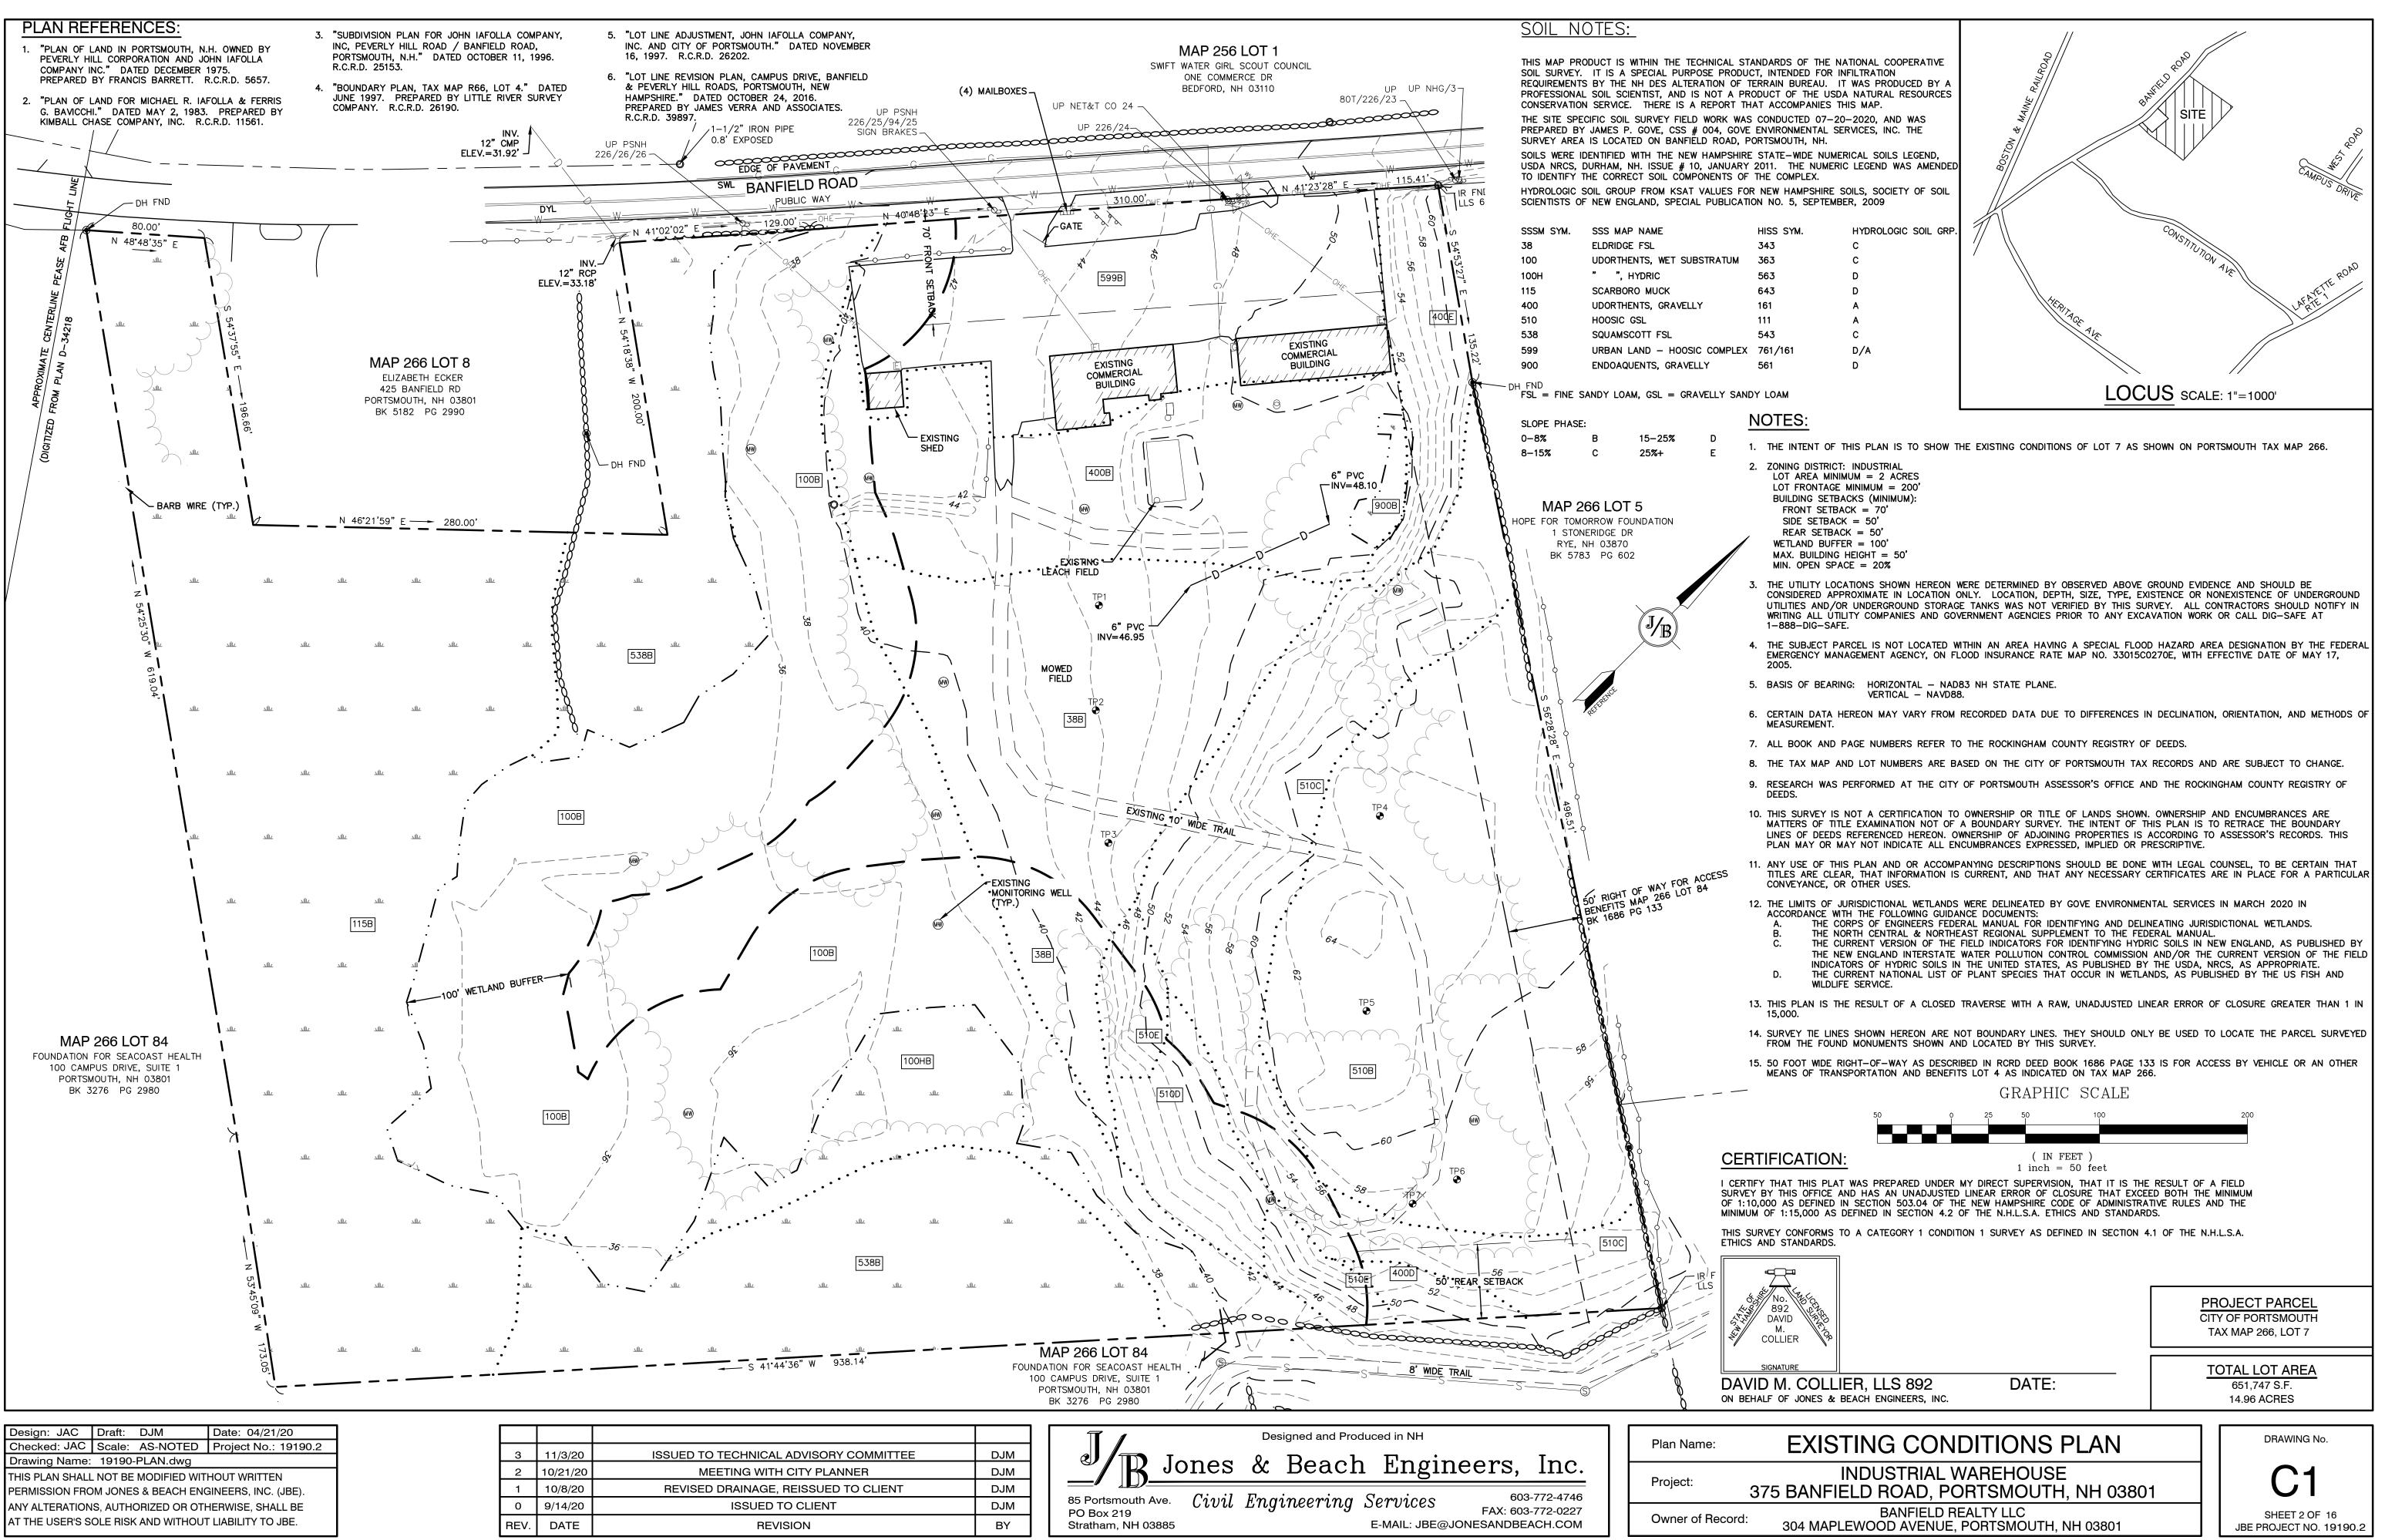

Design: JAC	Draft:	DJM	Date: 04/21/20	
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Drawing Name: 19190-PLAN.dwg				
THIS PLAN SHALL NOT BE MODIFIED WITHOUT WRITTEN				
PERMISSION FROM JONES & BEACH ENGINEERS, INC. (JBE).				
ANY ALTERATIONS, AUTHORIZED OR OTHERWISE, SHALL BE				
AT THE USER'S SOLE RISK AND WITHOUT LIABILITY TO JBE.				

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2	10/21/20	MEETING WITH CITY PI
1	10/8/20	REVISED DRAINAGE, REISSU
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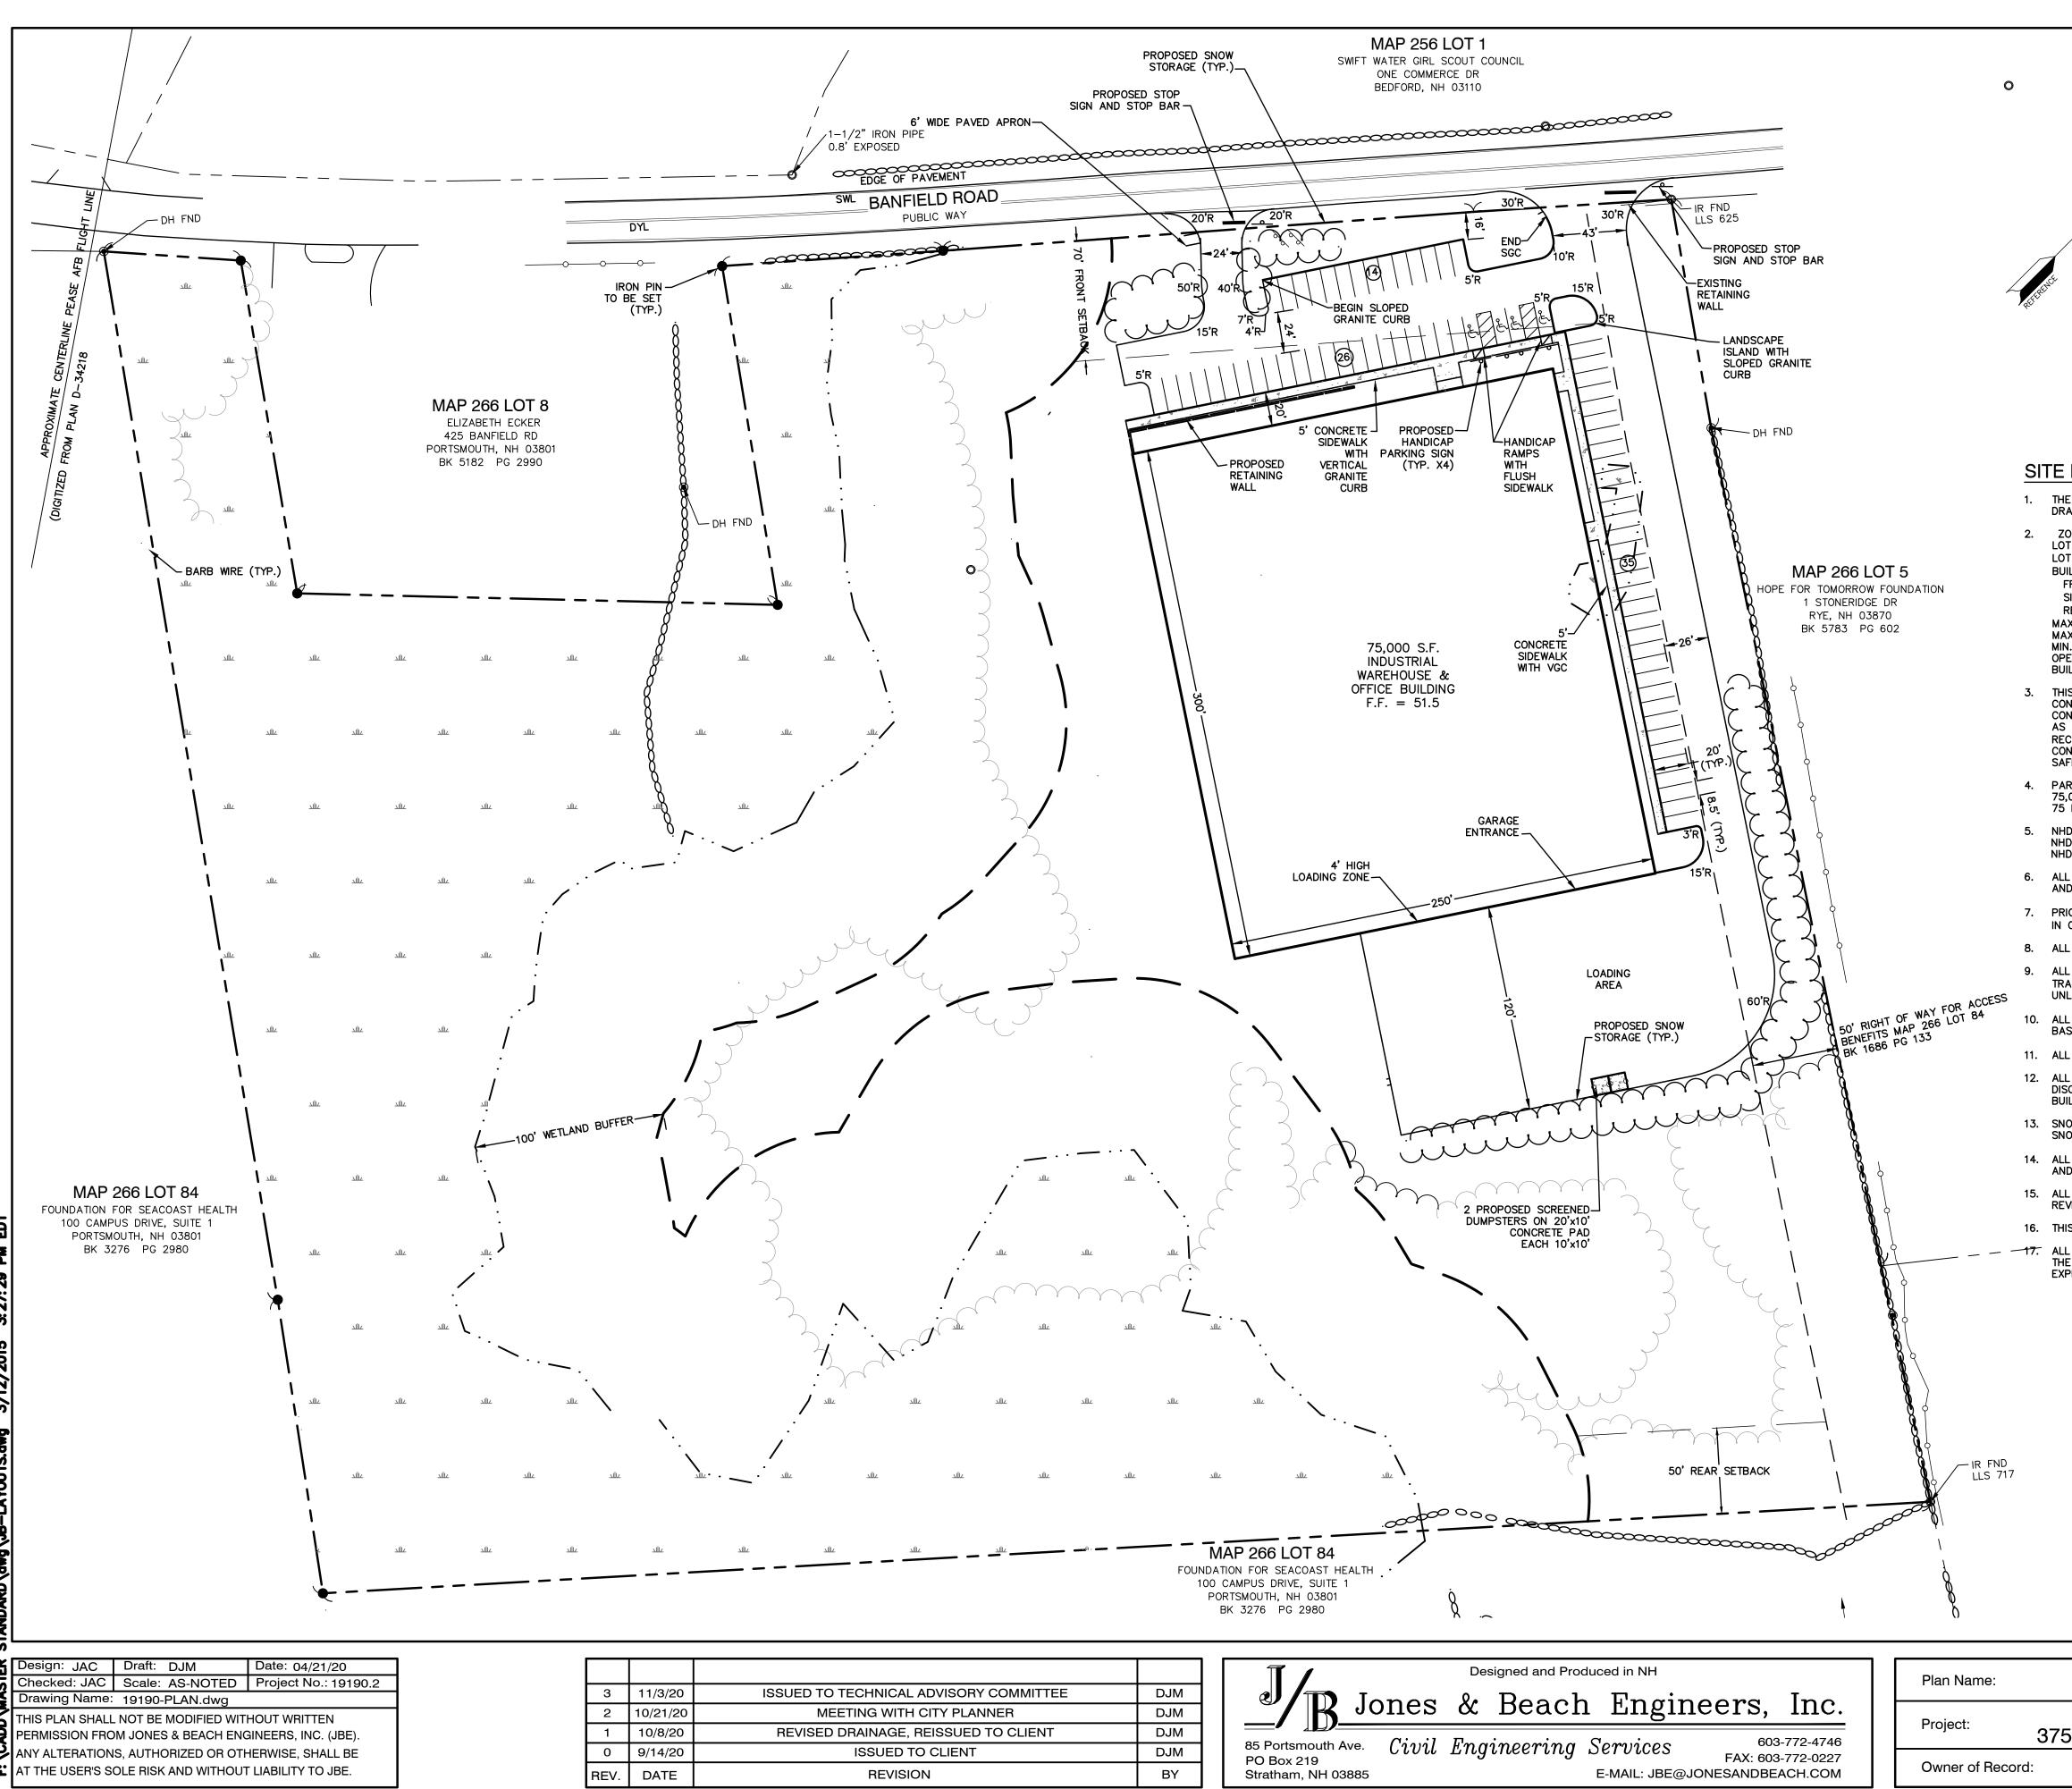


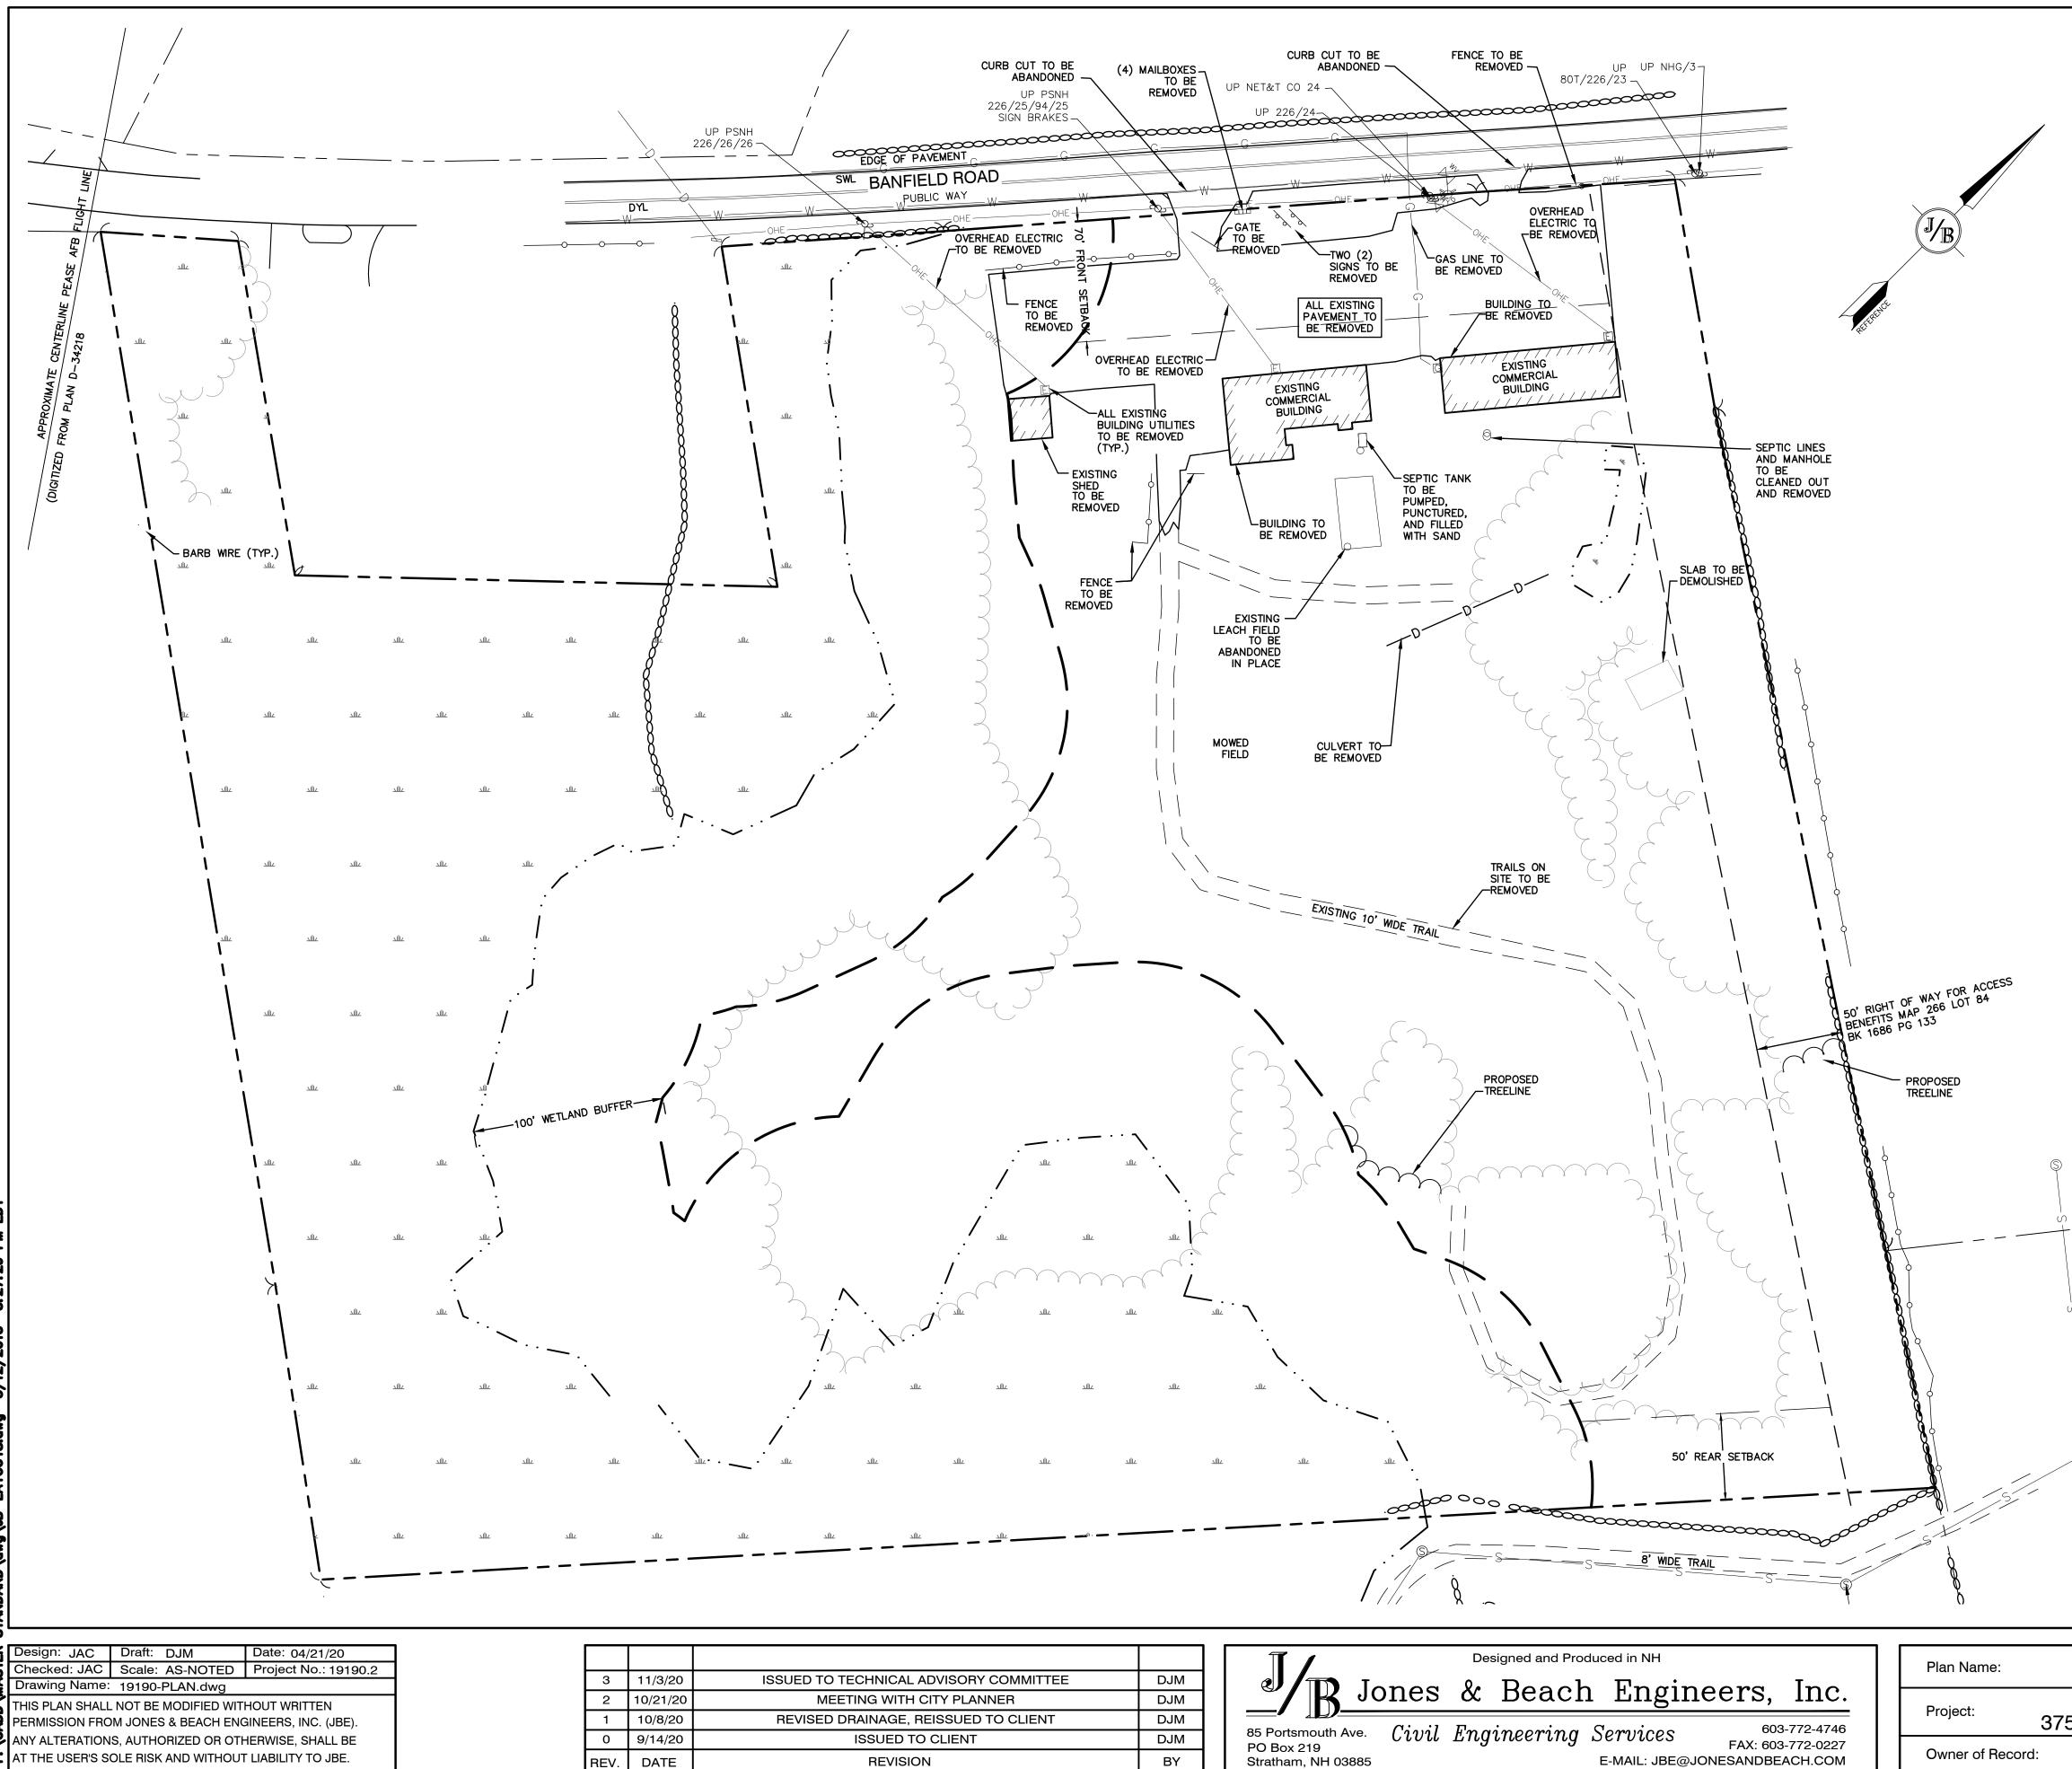

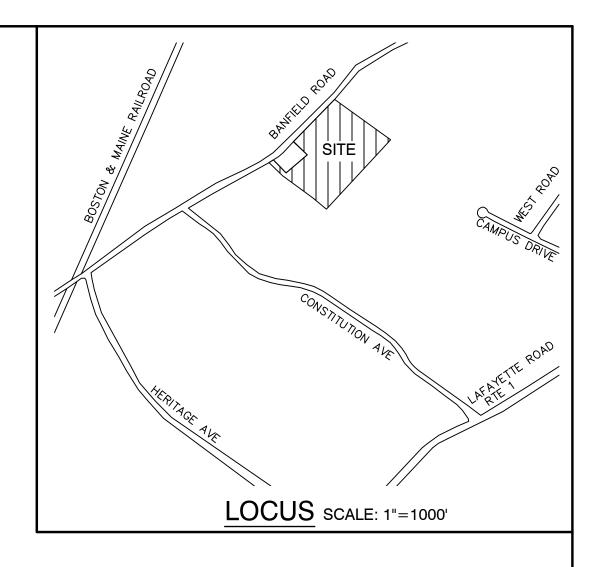
### DEMOLITION NOTES:

- 1. THIS PLAN IS INTENDED TO PROVIDE MINIMUM GUIDELINES FOR SITE DEMOLITION. IT SHOULD BE NOTED THAT ALL MANMADE FEATURES, PAVEMENT, SIGNS, POLES, CURBING, CONCRETE WALKS, UTILITIES, ETC., SHALL BE REMOVED AS NECESSARY TO CONSTRUCT WORK, UNLESS OTHERWISE NOTED TO REMAIN. THROUGHOUT THE CONSTRUCTION PROCESS, THE CONTRACTOR SHALL INFORM THE ENGINEER IMMEDIATELY OF ANY FIELD DISCREPANCIES FROM DATA AS SHOWN ON DESIGN PLANS. THIS INCLUDES ANY UNFORESEEN CONDITIONS, SUBSURFACE OR OTHERWISE FOR EVALUATION AND RECOMMENDATIONS. ANY CONTRADICTION BETWEEN ITEMS OF THIS PLAN/PLAN SET, OR BETWEEN THE PLANS AND ON-SITE CONDITIONS MUST BE RESOLVED BEFORE RELATED CONSTRUCTION HAS BEEN INITIATED.
- 2. WETLAND IMPACTS SHALL NOT OCCUR UNTIL ALL PERMITS HAVE BEEN ACQUIRED AND IMPACT MITIGATION REQUIREMENTS HAVE BEEN SATISFIED.
- PRIOR TO THE START OF CONSTRUCTION, THE CONTRACTOR IS REQUIRED TO HAVE THE 3. PROJECT LAND SURVEYOR STAKE OR FLAG CLEARING LIMITS. A MINIMUM OF 48 HOURS NOTICE IS REQUIRED. CLEARING LIMITS ARE THE EDGE OF THE PROPERTY AND THE LIMITS OF WORK.
- 4. ALL EXISTING STRUCTURES WITHIN THE CONSTRUCTION AREA, UNLESS OTHERWISE NOTED TO REMAIN, SHALL BE REMOVED AND DISPOSED OF OFF-SITE IN ACCORDANCE WITH ALL LOCAL, STATE AND FEDERAL GUIDELINES. ANY BURNING ON-SITE SHALL BE SUBJECT TO LOCAL ORDINANCES.
- 5. THE CONTRACTOR SHALL REMOVE AND PROPERLY DISPOSE OF ALL CONTAMINATED MATERIAL LOCATED IN THE AREA OF EXISTING LEACHFIELDS IN ACCORDANCE WITH LOCAL AND STATE REGULATIONS.
- 6. ALL CURBING, CONCRETE, PAVEMENT, BUILDINGS AND SUBBASE MATERIALS LOCATED WITHIN PROPOSED LANDSCAPED AREAS SHALL BE REMOVED AND REPLACED WITH LOAM MATERIALS SUITABLE FOR LANDSCAPING IN ACCORDANCE WITH TECHNICAL SPECIFICATIONS. (SEE ALSO LANDSCAPE PLAN).
- 7. THE CONTRACTOR SHALL OBTAIN TREE CLEARING PERMIT FROM LOCAL AND STATE AUTHORITIES PRIOR TO START OF CONSTRUCTION (IF REQUIRED).
- 8. IN AREAS WHERE CONSTRUCTION IS PROPOSED ADJACENT TO ABUTTING PROPERTIES, THE CONTRACTOR SHALL INSTALL ORANGE CONSTRUCTION FENCING ALONG PROPERTY LINES IN ALL AREAS WHERE SILT FENCING IS NOT REQUIRED.
- 9. EROSION AND SEDIMENTATION CONTROL MEASURES SHALL BE INSTALLED PRIOR TO CONSTRUCTION AND ANY EARTH MOVING OPERATIONS. SILT FENCE SHALL BE INSTALLED AT THE LIMITS OF IMPACT AREAS ACCORDING TO THE DETAILS SHOWN ON SHEET E1.
- 10. EXCAVATED MATERIALS WILL BE PLACED WITHIN UPLAND AREAS AS FILL MATERIAL OR HAULED OFF-SITE FOR DISPOSAL IN AN APPROPRIATE UPLAND LOCATION.

GRAPHIC SCA	LE 200
( IN FEET ) 1 inch = 50 feet	
	PROJECT PARCEL CITY OF PORTSMOUTH TAX MAP 266, LOT 7
	TOTAL LOT AREA 651,747 S.F. 14.96 ACRES
DEMOLITION PLAN	DRAWING No.
INDUSTRIAL WAREHOUSE 5 BANFIELD ROAD, PORTSMOUTH, NH 0380	1 DM-1
BANFIELD REALTY LLC 304 MAPLEWOOD AVENUE, PORTSMOUTH, NH 03801	SHEET 3 OF 16 JBE PROJECT NO. 19190.2



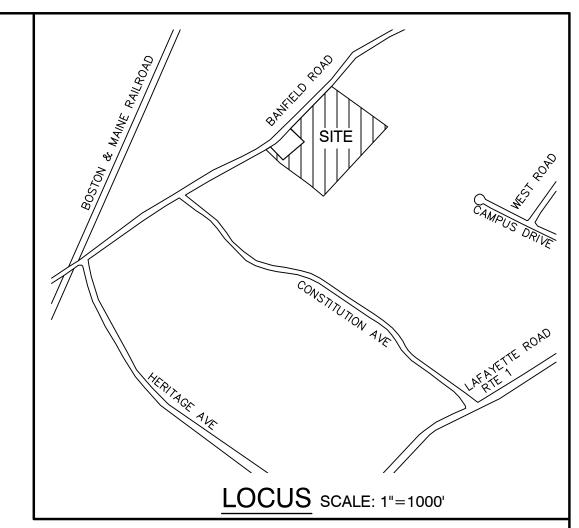

### SITE NOTES:

THE INTENT OF THIS PLAN IS TO CONSTRUCT AN INDUSTRIAL WAREHOUSE & OFFICE BUILDING WITH ASSOCIATED GRADING, DRAINAGE, AND UTILITIES.

2. ZONING DISTRICT: INDUSTRIAL LOT AREA MINIMUM = 2 ACRES LOT FRONTAGE MINIMUM = 200' BUILDING SETBACKS (MINIMUM):

FRONT SETBACK = 70'SIDE SETBACK = 50'REAR SETBACK = 50'MAX. BUILDING HEIGHT = 70'

MAX. BUIDLING COVERAGE = 50%MIN. OPEN SPACE = 20%

OPEN SPACE PROVIDED = 512,000 S.F. = 78.6% BUILDING COVERAGE PROVIDED = 75,000 S.F. = 11.5%

THIS PLAN SET HAS BEEN PREPARED BY JONES & BEACH ENGINEERS, INC., FOR MUNICIPAL AND STATE APPROVALS AND FOR CONSTRUCTION BASED ON DATA OBTAINED FROM ON-SITE FIELD SURVEY AND EXISTING MUNICIPAL RECORDS. THROUGHOUT THE CONSTRUCTION PROCESS, THE CONTRACTOR SHALL INFORM THE ENGINEER IMMEDIATELY OF ANY FIELD DISCREPANCY FROM DATA AS SHOWN ON THE DESIGN PLANS, INCLUDING ANY UNFORESEEN CONDITIONS, SUBSURFACE OR OTHERWISE, FOR EVALUATION AND RECOMMENDATIONS. ANY CONTRADICTION BETWEEN ITEMS ON THIS PLAN/PLAN SET, OR BETWEEN THE PLANS AND ON-SITE CONDITIONS, MUST BE RESOLVED BEFORE RELATED CONSTRUCTION HAS BEEN INITIATED. CONTRACTOR TO ALWAYS CONTACT DIG SAFE PRIOR TO DIGGING ONSITE OR OFFSITE TO ENSURE SAFETY AND OBEY THE LAW.

PARKING CALCULATIONS: GENERAL MANUFACTURING: 1 SPACE REQUIRED PER 1000 SF GFA 75,000 S.F. GFA PROPOSED: 75 PARKING SPACES REQUIRED

75 PARKING SPACES PROVIDED

5. NHDES ALTERATION OF TERRAIN PERMIT NO. DATED NHDES SEPTIC SYSTEM APPROVAL FOR CONSTRUCTION NO. DATED NHDES WETLANDS BUREAU PERMIT NO. DATED

6. ALL CONSTRUCTION SHALL CONFORM TO TOWN STANDARDS AND REGULATIONS, AND NHDOT STANDARD SPECIFICATIONS FOR ROAD AND BRIDGE CONSTRUCTION, WHICHEVER IS MORE STRINGENT.

PRIOR TO THE START OF CONSTRUCTION, THE CONTRACTOR SHALL COORDINATE WITH THE ENGINEER, ARCHITECT AND/OR OWNER, IN ORDER TO OBTAIN AND/OR PAY ALL THE NECESSARY LOCAL PERMITS, FEES AND BONDS.

8. ALL PROPOSED SIGNAGE SHALL CONFORM WITH THE TOWN ZONING REGULATIONS, UNLESS A VARIANCE IS OTHERWISE REQUESTED. ALL SIGNAGE AND PAVEMENT MARKINGS SHALL BE IN ACCORDANCE WITH THE LATEST EDITION OF THE MANUAL ON UNIFORM TRAFFIC CONTROL DEVICES (M.U.T.C.D.) AND NHDOT STANDARDS AND SPECIFICATIONS (NON-REFLECTORIZED PAVEMENT MARKINGS), UNLESS OTHERWISE NOTED.

10. ALL PARKING STALLS SHALL BE SEPARATED USING 4" WIDE SOLID STRIPES. STRIPING SHALL HAVE TWO COATS OF PAINT, ALKYD BASIN SYNTHETIC RESIN, FEDERAL SPECIFICATION TTP-115 TYPE 1, IN A COLOR OF WHITE.

11. ALL STOP BARS SHALL BE 18" IN WIDTH IN A COLOR OF WHITE; ALL TRAFFIC ARROWS SHALL BE PAINTED IN A COLOR OF WHITE. 12. ALL BUILDING DIMENSIONS SHALL BE VERIFIED WITH THE ARCHITECTURAL AND STRUCTURAL PLANS PROVIDED BY THE OWNER. ANY DISCREPANCIES SHOULD BE BROUGHT TO THE ATTENTION OF THE ENGINEER AND OWNER PRIOR TO THE START OF CONSTRUCTION. BUILDING DIMENSIONS AND AREAS TO BE TO OUTSIDE OF MASONRY, UNLESS OTHERWISE NOTED.


13. SNOW TO BE STORED AT EDGE OF PAVEMENT AND IN AREAS SHOWN ON THE PLANS, OR TRUCKED OFFSITE TO AN APPROVED SNOW DUMPING LOCATION.

14. ALL CONSTRUCTION ACTIVITIES SHALL CONFORM TO LABOR OCCUPATIONAL SAFETY AND HEALTH ADMINISTRATION (OSHA) RULES AND REGULATIONS.

15. ALL CONDITIONS ON THIS PLAN SHALL REMAIN IN EFFECT IN PERPETUITY PURSUANT TO THE REQUIREMENTS OF THE SITE PLAN REVIEW REGULATIONS. 16. THIS SITE PLAN SHALL BE RECORDED IN THE ROCKINGHAM COUNTY REGISTRY OF DEEDS.

-17: ALL IMPROVEMENTS SHOWN ON THIS SITE PLAN SHALL BE CONSTRUCTED AND MAINTAINED IN ACCORDANCE WITH THE PLAN BY THE PROPERTY OWNER AND ALL FUTURE PROPERTY OWNERS. NO CHANGES SHALL BE MADE TO THIS SITE PLAN WITHOUT THE EXPRESS APPROVAL OF THE PORTSMOUTH PLANNING DIRECTOR.

GRAPHIC	SCALE	C
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1  inch = 5		
APPROVED — PORTSMOUTH, NH PLANNING BOARD		
	-	PROJECT PARCEL CITY OF PORTSMOUTH TAX MAP 266, LOT 7
 DATE:		TOTAL LOT AREA 651,747 S.F. 14.96 ACRES
	·	
SITE PLAN		DRAWING No.
INDUSTRIAL WAREHOUSE BANFIELD ROAD, PORTSMOUTH, NH 0380	1	C2
BANFIELD REALTY LLC 304 MAPLEWOOD AVENUE, PORTSMOUTH, NH 03801		SHEET 4 OF 16 JBE PROJECT NO. 19190.2

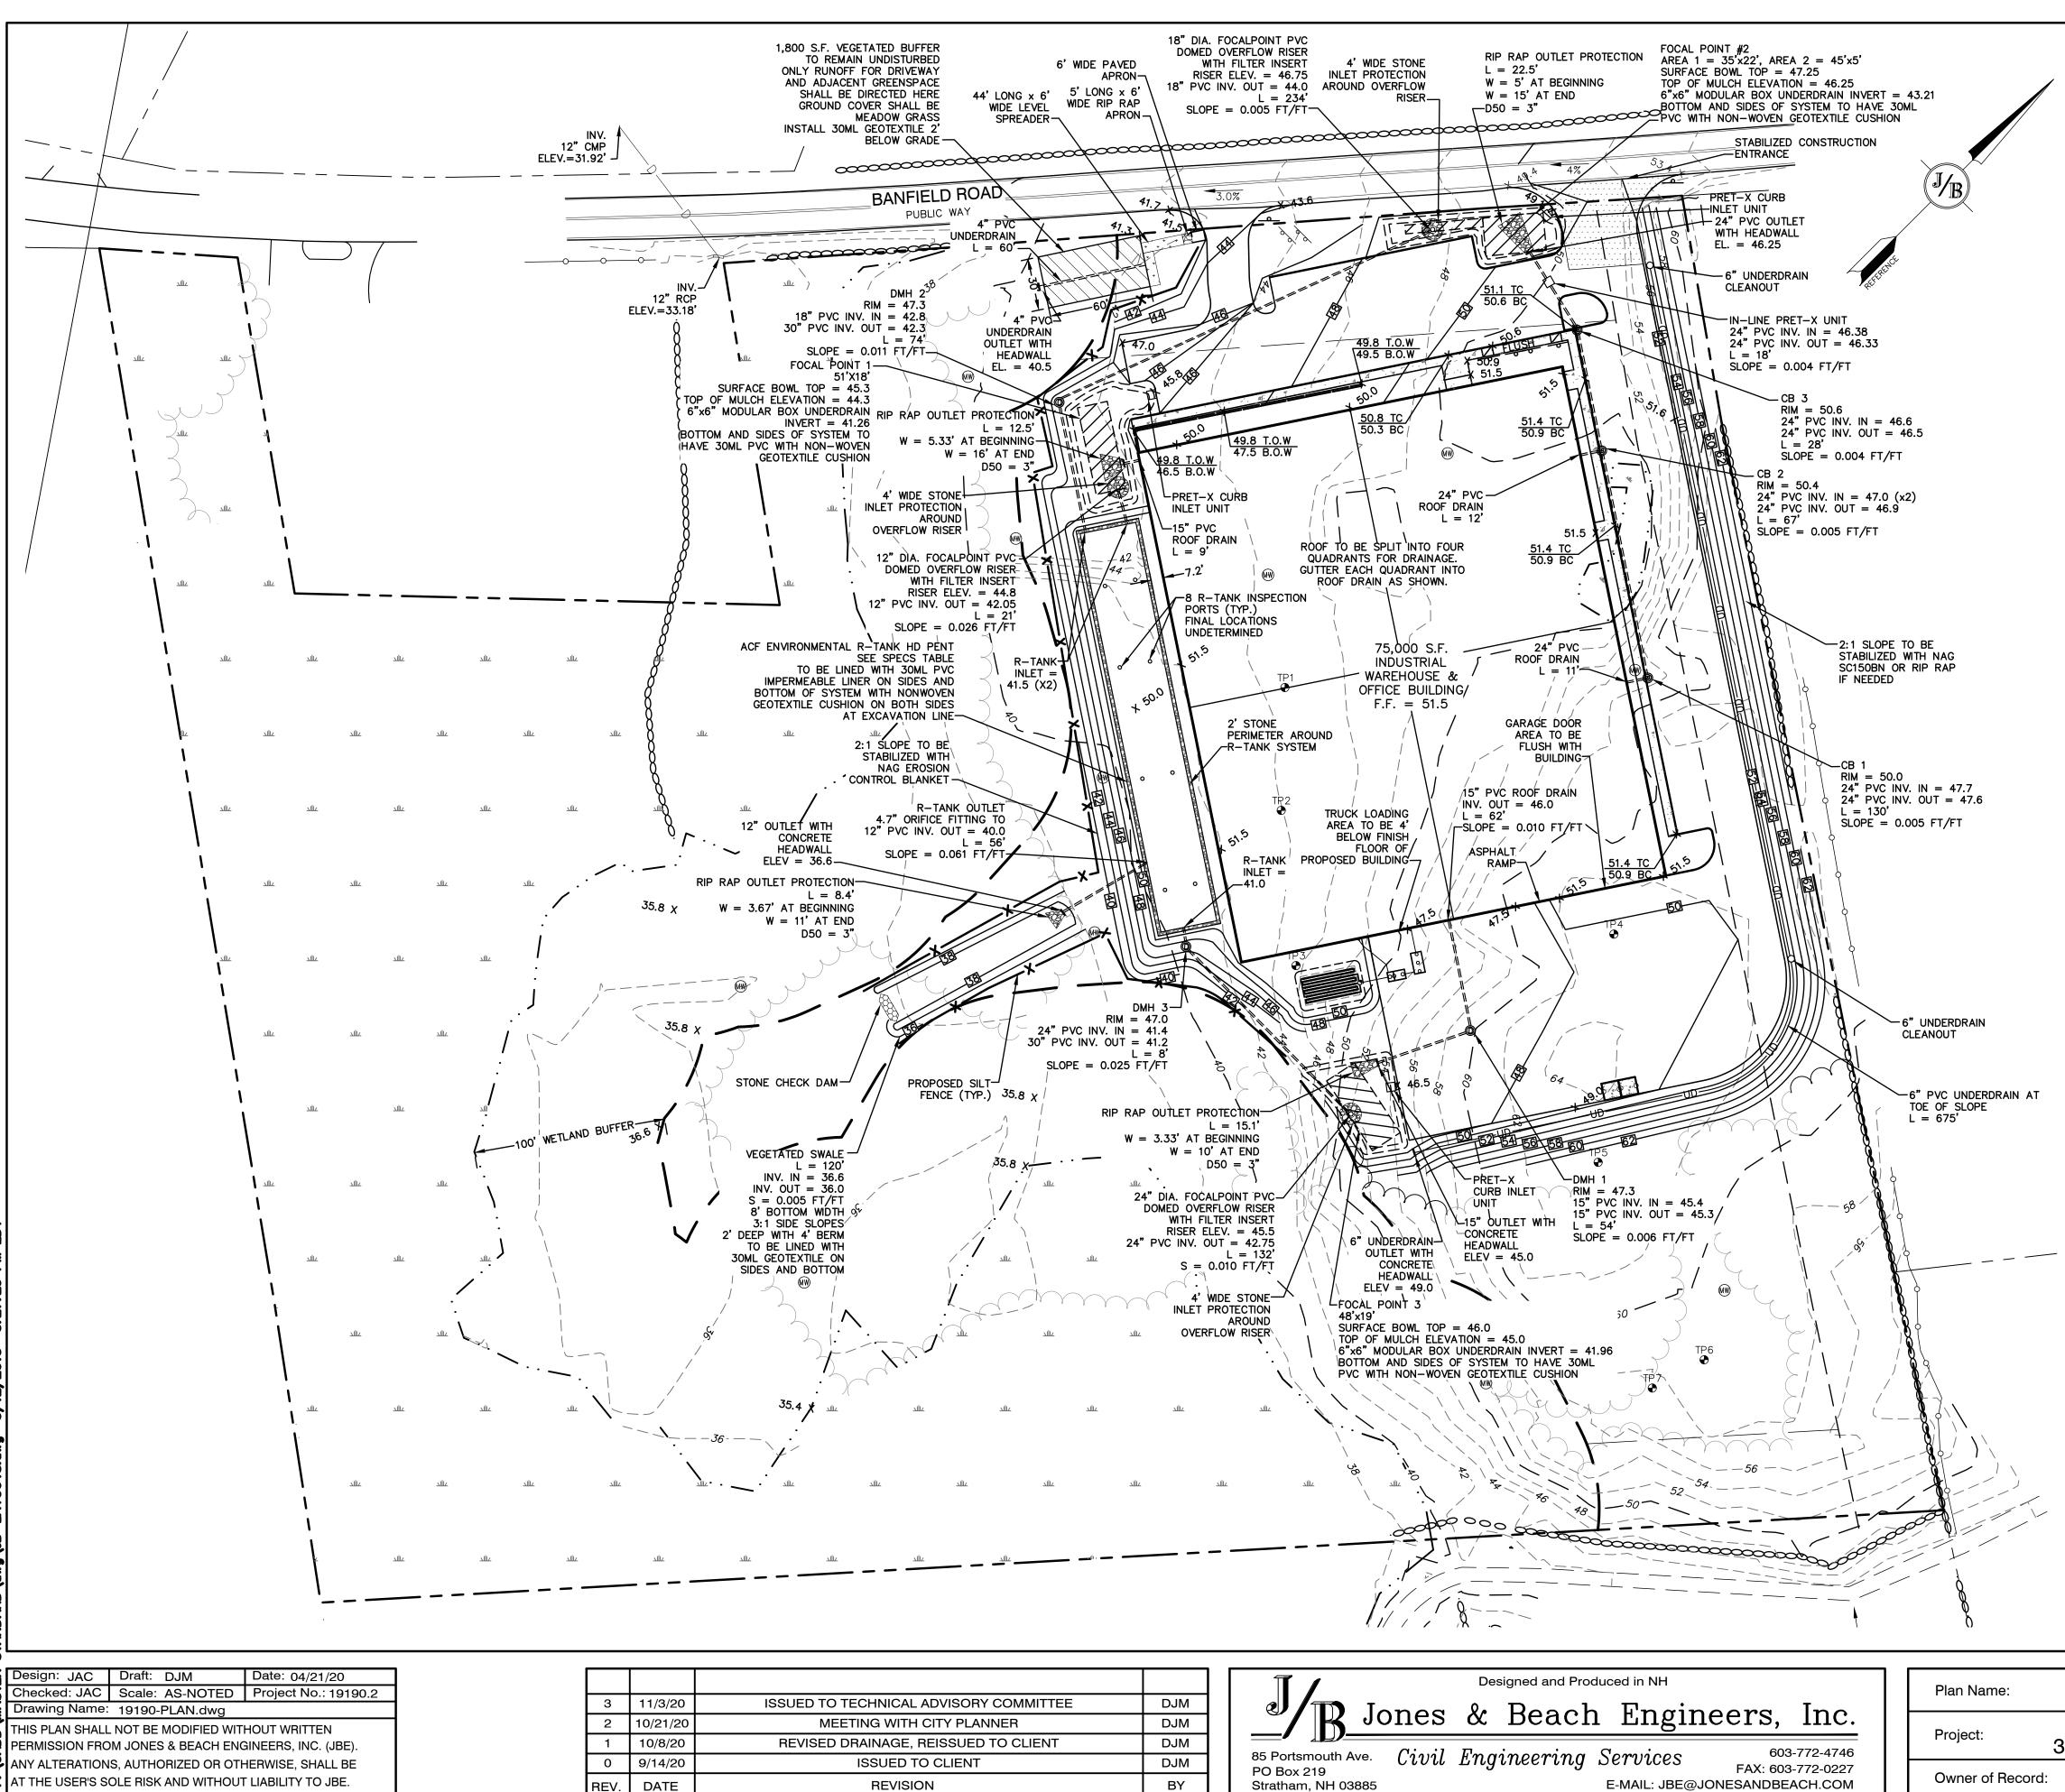


### **GRADING AND DRAINAGE NOTES:**

UNDERGROUND FACILITIES, UTILITIES AND STRUCTURES HAVE BEEN PLOTTED FROM FIELD OBSERVATION AND THEIR LOCATION MUST BE CONSIDERED APPROXIMATE ONLY. NEITHER JONES & BEACH ENGINEERS, INC., NOR ANY OF THEIR EMPLOYEES TAKE RESPONSIBILITY FOR THE LOCATION OF ANY UNDERGROUND STRUCTURES AND/OR UTILITIE NOT SHOWN THAT MAY EXIST. IT IS THE RESPONSIBILITY OF THE CONTRACTOR TO HAVE ALL UNDERGROUND STRUCTURES AND/OR UTILITIES LOCATED PRIOR TO EXCAVATION WORK BY CALLING 888-DIG-SAFE	
(888–344–7233).	

- 2. VERTICAL DATUM: NAVD88.
- 3. ALL BENCHMARKS AND TOPOGRAPHY SHOULD BE FIELD VERIFIED BY THE CONTRACTOR.
- 4. SITE GRADING SHALL NOT PROCEED UNTIL EROSION CONTROL MEASURES HAVE BEEN INSTALLED. SEE CONSTRUCTION SEQUENCE ON SHEET E1.
- 5. PRIOR TO THE START OF CONSTRUCTION, THE CONTRACTOR IS REQUIRED TO HAVE THE PROJECT'S LAND SURVEYOR STAKE OR FLAG CLEARING LIMITS. A MINIMUM OF 48 HOURS NOTICE IS REQUIRED.
- 6. ALL ROOF DRAINS FROM BUILDING SHALL END 5' OUTSIDE THE BUILDING LIMITS AS SHOWN ON PLAN AND SHALL BE PROVIDED WITH A TEMPORARY PLUG AND WITNESS AT THE END. ALL EXTERIOR ROOF DOWNSPOUTS ARE TO BE INSTALLED WITH OVERFLOW DEVICES.
- 7. ALL SWALES AND DETENTION PONDS ARE TO BE STABILIZED PRIOR TO DIRECTING RUNOFF TO THEM.
- PROPOSED RIM ELEVATIONS OF DRAINAGE STRUCTURES ARE APPROXIMATE. FINAL ELEVATIONS ARE TO BE SET FLUSH WITH FINISH GRADES.
   ALL SWALES AND ANY SLOPES GREATER THAN 3:1 SHALL BE STABILIZED WITH NORTH AMERICAN GREEN S75 EROSION CONTROL BLANKETS (OR AN EQUIVALENT APPROVED IN WRITING BY THE ENGINEER), UNLESS OTHERWISE
- SPECIFIED. 10. ALL DRAINAGE AND SANITARY STRUCTURE INTERIOR DIAMETERS (4' MIN) SHALL BE DETERMINED BY THE MANUFACTURER BASED ON THE PIPE CONFIGURATIONS SHOWN ON THESE PLANS. CATCH BASINS SHALL HAVE 3'
- DEEP SUMPS WITH GREASE HOODS, UNLESS OTHERWISE NOTED. 11. ALL DRAINAGE STRUCTURES SHALL BE PRECAST, UNLESS OTHERWISE SPECIFIED. SEE SHEETS D2-D6 FOR DRAINAGE
- DETAILS. 12. ALL DRAINAGE STRUCTURES AND STORMWATER PIPES SHALL MEET HEAVY DUTY TRAFFIC H20 LOADING AND SHALL BE INSTALLED ACCORDINGLY.
- 13. IN AREAS WHERE CONSTRUCTION IS PROPOSED ADJACENT TO ABUTTING PROPERTIES, THE CONTRACTOR SHALL INSTALL ORANGE CONSTRUCTION FENCING ALONG PROPERTY LINES IN ALL AREAS WHERE SILT FENCING IS NOT REQUIRED.
- 14. ALL DRAINAGE PIPE SHALL BE NON-PERFORATED ADS N-12 OR APPROVED EQUAL.
- STONE INLET PROTECTION SHALL BE PLACED AT ALL CATCH BASINS. SEE DETAIL WITHIN THE DETAIL SHEETS.
   LAND DISTURBING ACTIVITIES SHALL NOT COMMENCE UNTIL APPROVAL TO DO SO HAS BEEN RECEIVED BY ALL
- GOVERNING AUTHORITIES. THE GENERAL CONTRACTOR SHALL STRICTLY ADHERE TO THE EPA SWPPP DURING CONSTRUCTION OPERATIONS.
- 17. NO LAND CLEARING OR GRADING SHALL BEGIN UNTIL ALL EROSION CONTROL MEASURES HAVE BEEN INSTALLED.
- ALL EXPOSED AREAS SHALL BE SEEDED AS SPECIFIED WITHIN 3 DAYS OF FINAL GRADING.
   SHOULD CONSTRUCTION STOP FOR LONGER THAN 3 DAYS, THE SITE SHALL BE SEEDED AS SPECIFIED.
- 20. MAINTAIN EROSION CONTROL MEASURES AFTER EACH RAIN EVENT OF 0.5" OR GREATER IN A 24 HOUR PERIOD AND AT LEAST ONCE A WEEK.
- 21. THIS PLAN SHALL NOT BE CONSIDERED ALL INCLUSIVE, AS THE GENERAL CONTRACTOR SHALL TAKE ALL NECESSARY PRECAUTIONS TO PREVENT SEDIMENT FROM LEAVING THE SITE.
- 22. CONSTRUCTION VEHICLES SHALL UTILIZE THE STABILIZED CONSTRUCTION ENTRANCE TO THE EXTENT POSSIBLE THROUGHOUT CONSTRUCTION.
- 23. IF INSTALLATION OF STORM DRAINAGE SYSTEM SHOULD BE INTERRUPTED BY WEATHER OR NIGHTFALL, THE PIPE ENDS SHALL BE COVERED WITH FILTER FABRIC.
- 24. THE GENERAL CONTRACTOR SHALL BE RESPONSIBLE TO TAKE WHATEVER MEANS NECESSARY TO ESTABLISH
- PERMANENT SOIL STABILIZATION. 25. SEDIMENT SHALL BE REMOVED FROM ALL SEDIMENT BASINS BEFORE THEY ARE 25% FULL.
- 26. ALL WORK SHALL BE DONE IN STRICT ACCORDANCE WITH PROJECT SPECIFICATIONS.
- 27. ADDITIONAL EROSION AND SEDIMENT CONTROL MEASURES SHALL BE INSTALLED, IF DEEMED NECESSARY BY ON-SITE INSPECTION BY ENGINEER AND/OR REGULATORY OFFICIALS.
- 28. ALL CULVERT OR DRAINPIPE OUTLETS ARE TO HAVE CONCRETE HEADWALLS UNLESS OTHERWISE STATED.
- 29. AREA OF DISTURBANCE = 212,000 S.F. AREA OF DISTURBANCE IN 100' WETLAND BUFFER = 3,900 S.F. TO REMOVE PAVEMENT, INSTALL UNDERDRAIN, PLANT TREES AREA OF WETLAND FILL = 1,910 S.F. IMPERVIOUS SURFACE IN WETLAND BUFFER TO BE REMOVED = 3,350 S.F.

\* PERMANENT DISTURBANCE = IMPERVIOUS SURFACE, TEMPORARY DISTURBANCE = VEGETATED AREA


30. SEE ALSO EROSION AND SEDIMENT CONTROL SPECIFICATIONS ON SHEET E1.

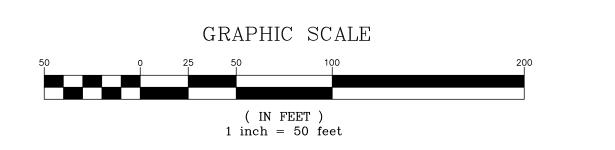

R-TANK	SPECS	
TOP OF FILL	50.0	
TOP OF STONE COVER	48.21	
TOP OF CHAMBER	47.21	PROJECT PARCEL
BOTTOM OF CHAMBER	40.25	CITY OF PORTSMOUTH
BOTTOM OF STONE BASE	40.0	TAX MAP 266, LOT 7
CHAMBERS PER ROW	100	
# OF ROWS	25	TOTAL LOT AREA
LENGTH	238.58'	651,747 S.F.
WIDTH	36.81'	14.96 ACRES


## GRADING AND DRAINAGE PLAN INDUSTRIAL WAREHOUSE 375 BANFIELD ROAD, PORTSMOUTH, NH 03801 BANFIELD REALTY LLC 304 MAPLEWOOD AVENUE, PORTSMOUTH, NH 03801


DRAWING No. C3 SHEET 5 OF 16 JBE PROJECT NO. 19190.2

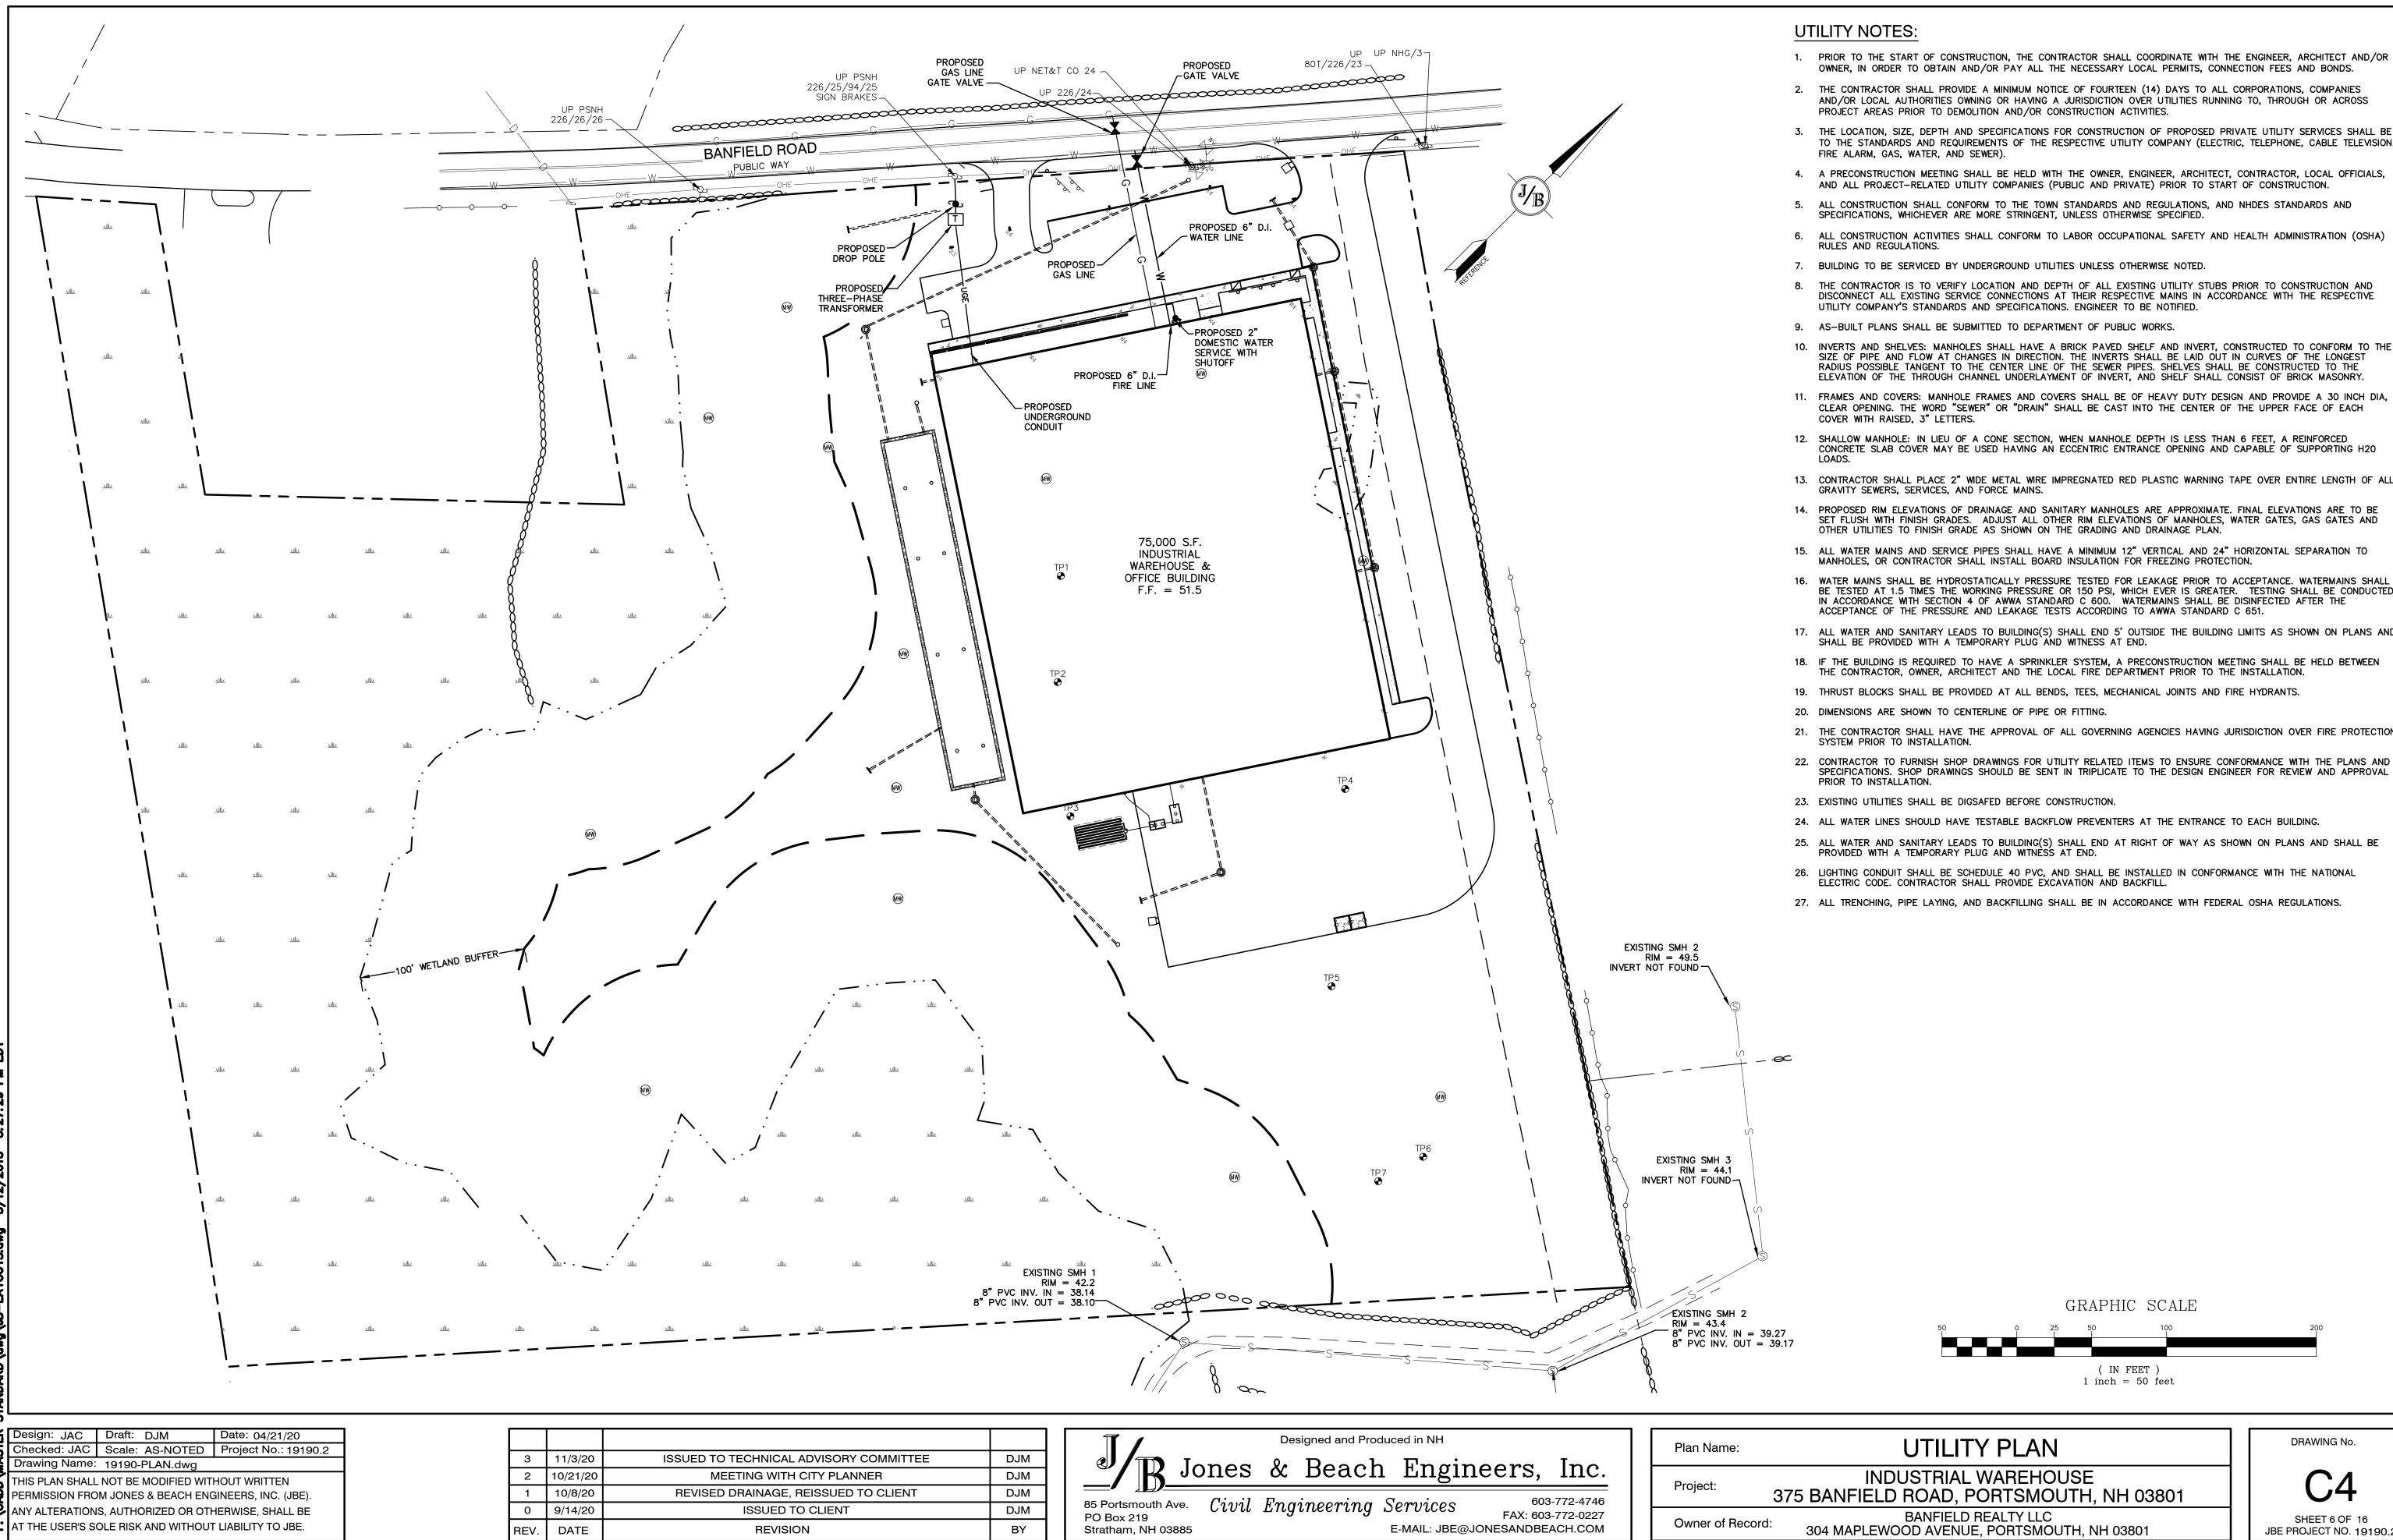


- PRIOR TO THE START OF CONSTRUCTION, THE CONTRACTOR SHALL COORDINATE WITH THE ENGINEER, ARCHITECT AND/OR OWNER, IN ORDER TO OBTAIN AND/OR PAY ALL THE NECESSARY LOCAL PERMITS, CONNECTION FEES AND BONDS.
- 2. THE CONTRACTOR SHALL PROVIDE A MINIMUM NOTICE OF FOURTEEN (14) DAYS TO ALL CORPORATIONS, COMPANIES AND/OR LOCAL AUTHORITIES OWNING OR HAVING A JURISDICTION OVER UTILITIES RUNNING TO, THROUGH OR ACROSS
- 3. THE LOCATION, SIZE, DEPTH AND SPECIFICATIONS FOR CONSTRUCTION OF PROPOSED PRIVATE UTILITY SERVICES SHALL BE TO THE STANDARDS AND REQUIREMENTS OF THE RESPECTIVE UTILITY COMPANY (ELECTRIC, TELEPHONE, CABLE TELEVISION,
- 4. A PRECONSTRUCTION MEETING SHALL BE HELD WITH THE OWNER, ENGINEER, ARCHITECT, CONTRACTOR, LOCAL OFFICIALS, AND ALL PROJECT-RELATED UTILITY COMPANIES (PUBLIC AND PRIVATE) PRIOR TO START OF CONSTRUCTION.
- 6. ALL CONSTRUCTION ACTIVITIES SHALL CONFORM TO LABOR OCCUPATIONAL SAFETY AND HEALTH ADMINISTRATION (OSHA)
- 8. THE CONTRACTOR IS TO VERIFY LOCATION AND DEPTH OF ALL EXISTING UTILITY STUBS PRIOR TO CONSTRUCTION AND DISCONNECT ALL EXISTING SERVICE CONNECTIONS AT THEIR RESPECTIVE MAINS IN ACCORDANCE WITH THE RESPECTIVE
- 10. INVERTS AND SHELVES: MANHOLES SHALL HAVE A BRICK PAVED SHELF AND INVERT, CONSTRUCTED TO CONFORM TO THE SIZE OF PIPE AND FLOW AT CHANGES IN DIRECTION. THE INVERTS SHALL BE LAID OUT IN CURVES OF THE LONGEST RADIUS POSSIBLE TANGENT TO THE CENTER LINE OF THE SEWER PIPES. SHELVES SHALL BE CONSTRUCTED TO THE ELEVATION OF THE THROUGH CHANNEL UNDERLAYMENT OF INVERT, AND SHELF SHALL CONSIST OF BRICK MASONRY.
- 11. FRAMES AND COVERS: MANHOLE FRAMES AND COVERS SHALL BE OF HEAVY DUTY DESIGN AND PROVIDE A 30 INCH DIA, CLEAR OPENING. THE WORD "SEWER" OR "DRAIN" SHALL BE CAST INTO THE CENTER OF THE UPPER FACE OF EACH
- 12. SHALLOW MANHOLE: IN LIEU OF A CONE SECTION, WHEN MANHOLE DEPTH IS LESS THAN 6 FEET, A REINFORCED CONCRETE SLAB COVER MAY BE USED HAVING AN ECCENTRIC ENTRANCE OPENING AND CAPABLE OF SUPPORTING H20
- 13. CONTRACTOR SHALL PLACE 2" WIDE METAL WIRE IMPREGNATED RED PLASTIC WARNING TAPE OVER ENTIRE LENGTH OF ALL
- 14. PROPOSED RIM ELEVATIONS OF DRAINAGE AND SANITARY MANHOLES ARE APPROXIMATE. FINAL ELEVATIONS ARE TO BE SET FLUSH WITH FINISH GRADES. ADJUST ALL OTHER RIM ELEVATIONS OF MANHOLES, WATER GATES, GAS GATES AND OTHER UTILITIES TO FINISH GRADE AS SHOWN ON THE GRADING AND DRAINAGE PLAN.
- 15. ALL WATER MAINS AND SERVICE PIPES SHALL HAVE A MINIMUM 12" VERTICAL AND 24" HORIZONTAL SEPARATION TO MANHOLES, OR CONTRACTOR SHALL INSTALL BOARD INSULATION FOR FREEZING PROTECTION.
- 16. WATER MAINS SHALL BE HYDROSTATICALLY PRESSURE TESTED FOR LEAKAGE PRIOR TO ACCEPTANCE. WATERMAINS SHALL BE TESTED AT 1.5 TIMES THE WORKING PRESSURE OR 150 PSI, WHICH EVER IS GREATER. TESTING SHALL BE CONDUCTED IN ACCORDANCE WITH SECTION 4 OF AWWA STANDARD C 600. WATERMAINS SHALL BE DISINFECTED AFTER THE ACCEPTANCE OF THE PRESSURE AND LEAKAGE TESTS ACCORDING TO AWWA STANDARD C 651.
- 17. ALL WATER AND SANITARY LEADS TO BUILDING(S) SHALL END 5' OUTSIDE THE BUILDING LIMITS AS SHOWN ON PLANS AND SHALL BE PROVIDED WITH A TEMPORARY PLUG AND WITNESS AT END.
- THE CONTRACTOR, OWNER, ARCHITECT AND THE LOCAL FIRE DEPARTMENT PRIOR TO THE INSTALLATION.
- 19. THRUST BLOCKS SHALL BE PROVIDED AT ALL BENDS, TEES, MECHANICAL JOINTS AND FIRE HYDRANTS.
- 21. THE CONTRACTOR SHALL HAVE THE APPROVAL OF ALL GOVERNING AGENCIES HAVING JURISDICTION OVER FIRE PROTECTION SYSTEM PRIOR TO INSTALLATION.
- SPECIFICATIONS. SHOP DRAWINGS SHOULD BE SENT IN TRIPLICATE TO THE DESIGN ENGINEER FOR REVIEW AND APPROVAL
- 24. ALL WATER LINES SHOULD HAVE TESTABLE BACKFLOW PREVENTERS AT THE ENTRANCE TO EACH BUILDING.
- 25. ALL WATER AND SANITARY LEADS TO BUILDING(S) SHALL END AT RIGHT OF WAY AS SHOWN ON PLANS AND SHALL BE
- 27. ALL TRENCHING, PIPE LAYING, AND BACKFILLING SHALL BE IN ACCORDANCE WITH FEDERAL OSHA REGULATIONS.


		(	GRAPH	IC SCALE	
50	0	25	50	100	200
( IN FEET $)1 inch = 50 feet$					

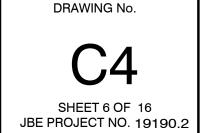

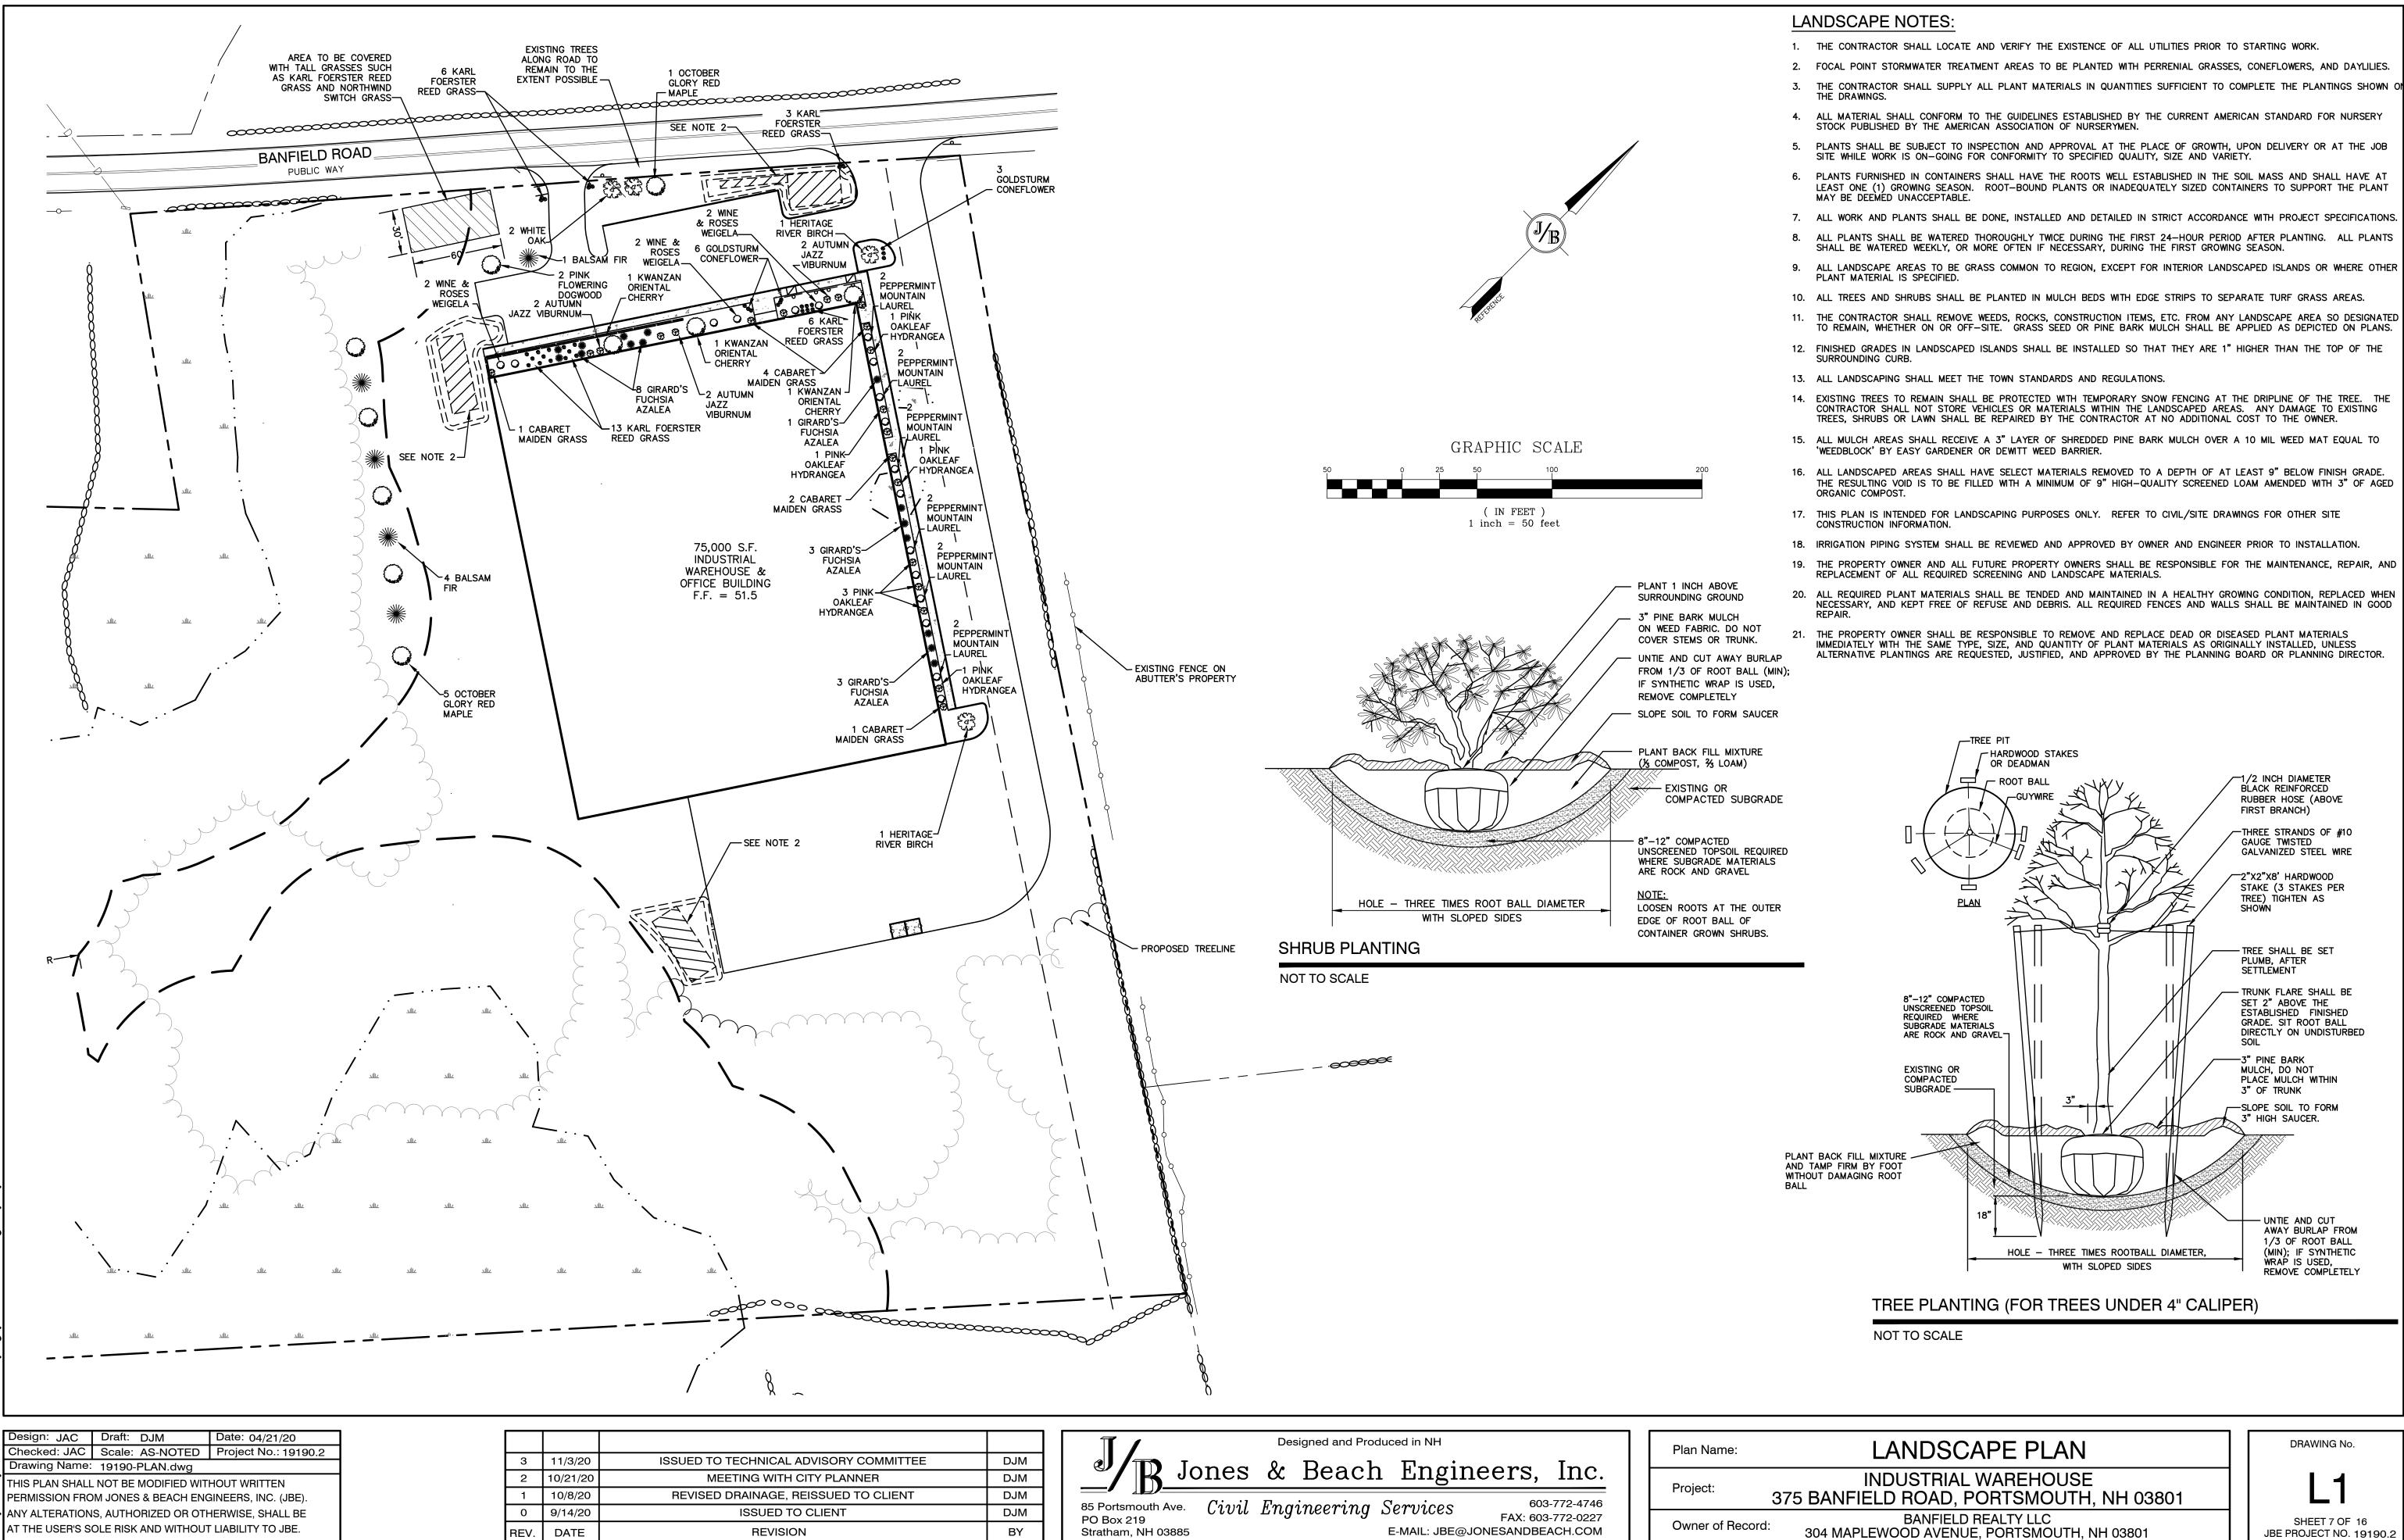


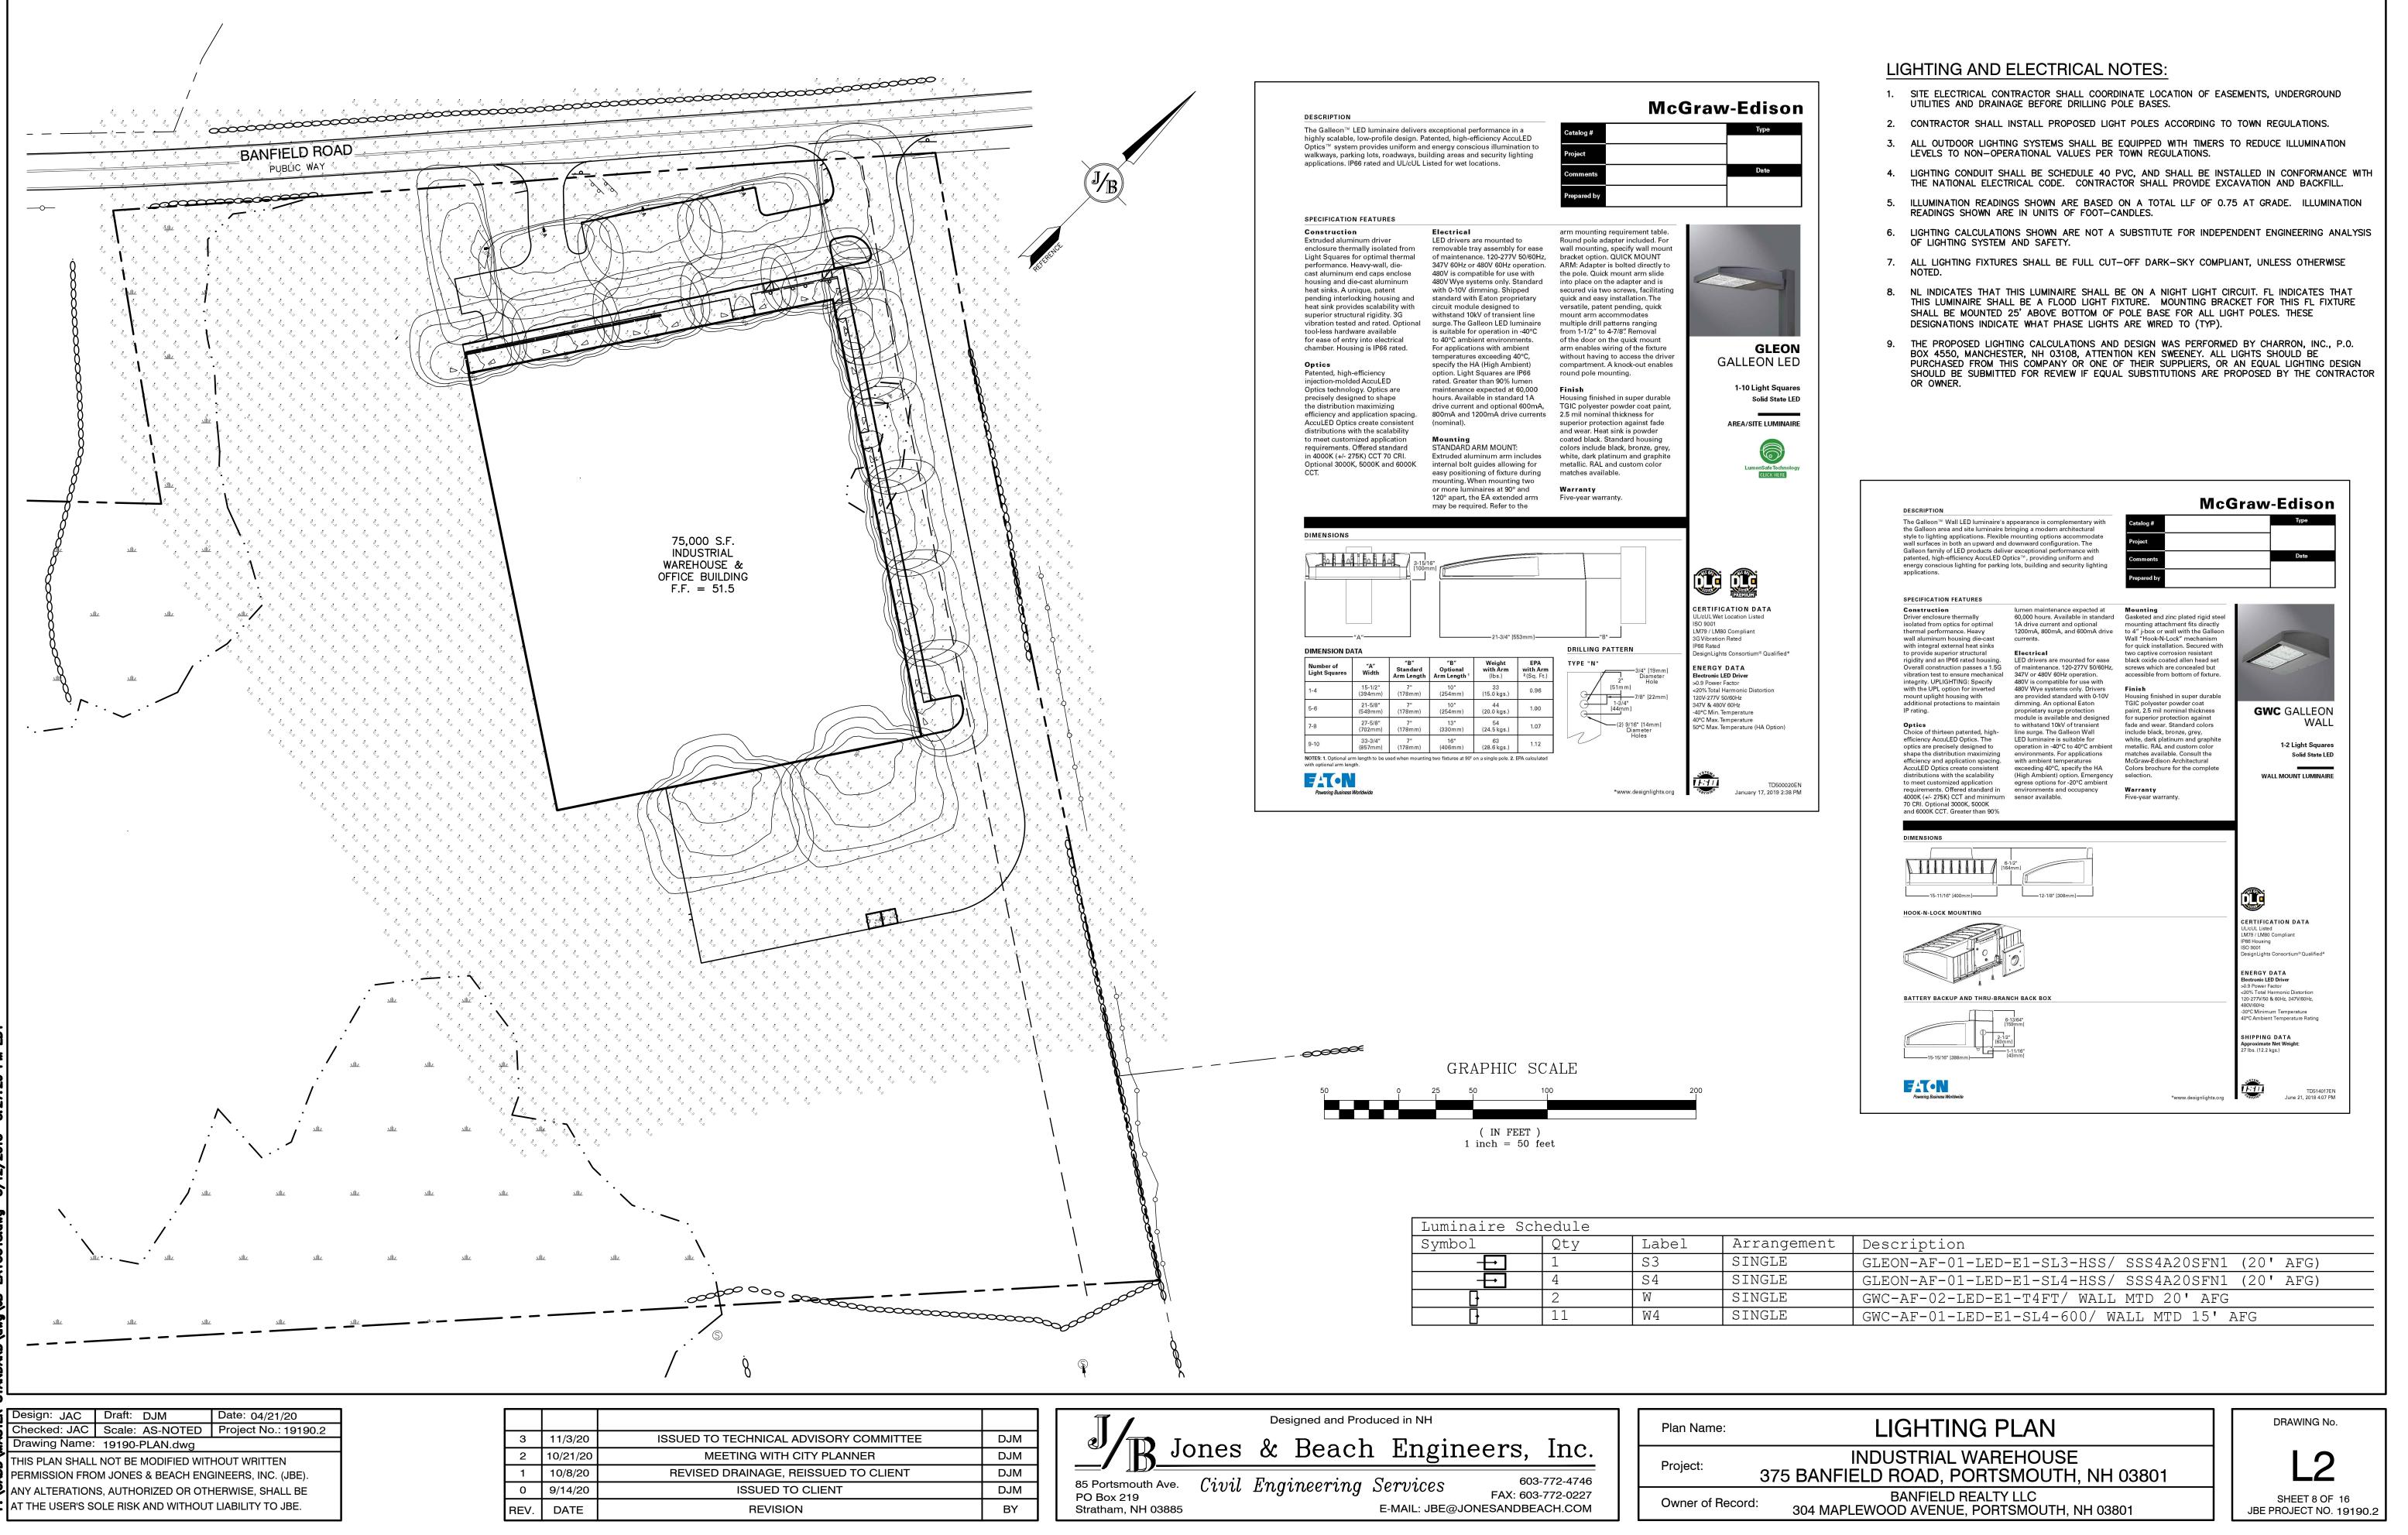

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304 MAPLEWOOD AVENUE, PORTSMOUTH, NH 03801

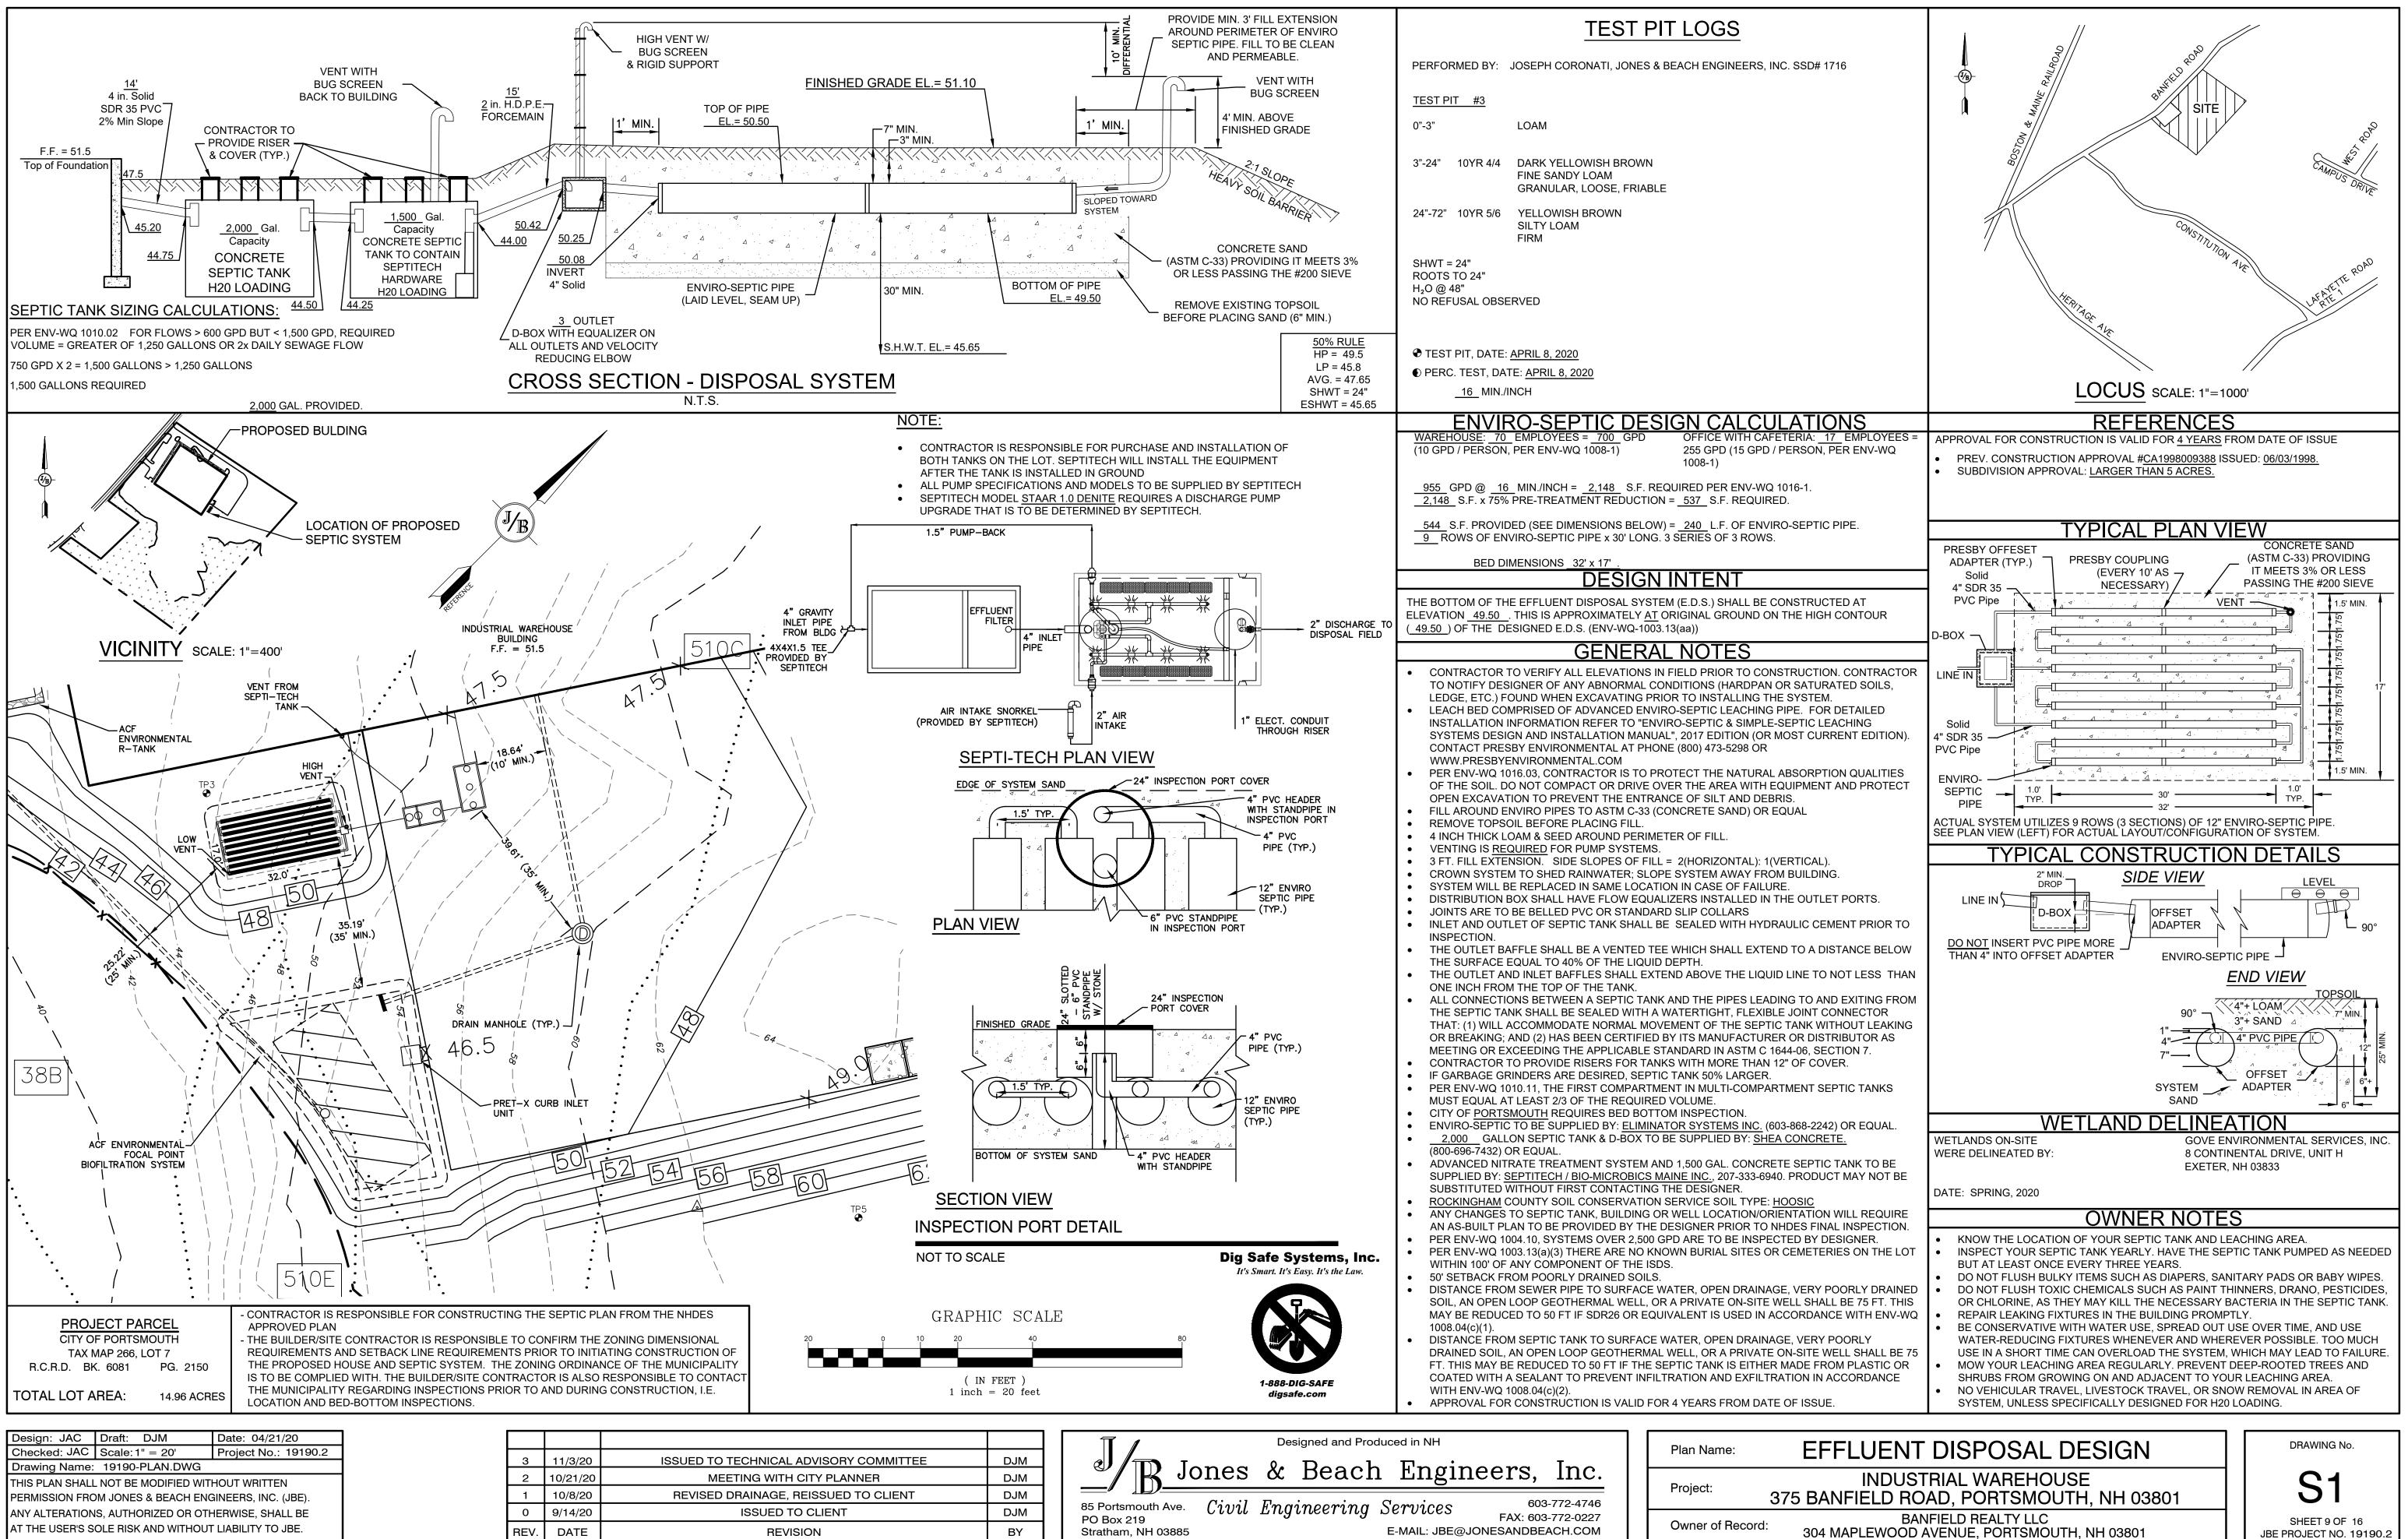


T THE USER'S SOLE RISK AND WITHOUT LIABILITY TO JBE.

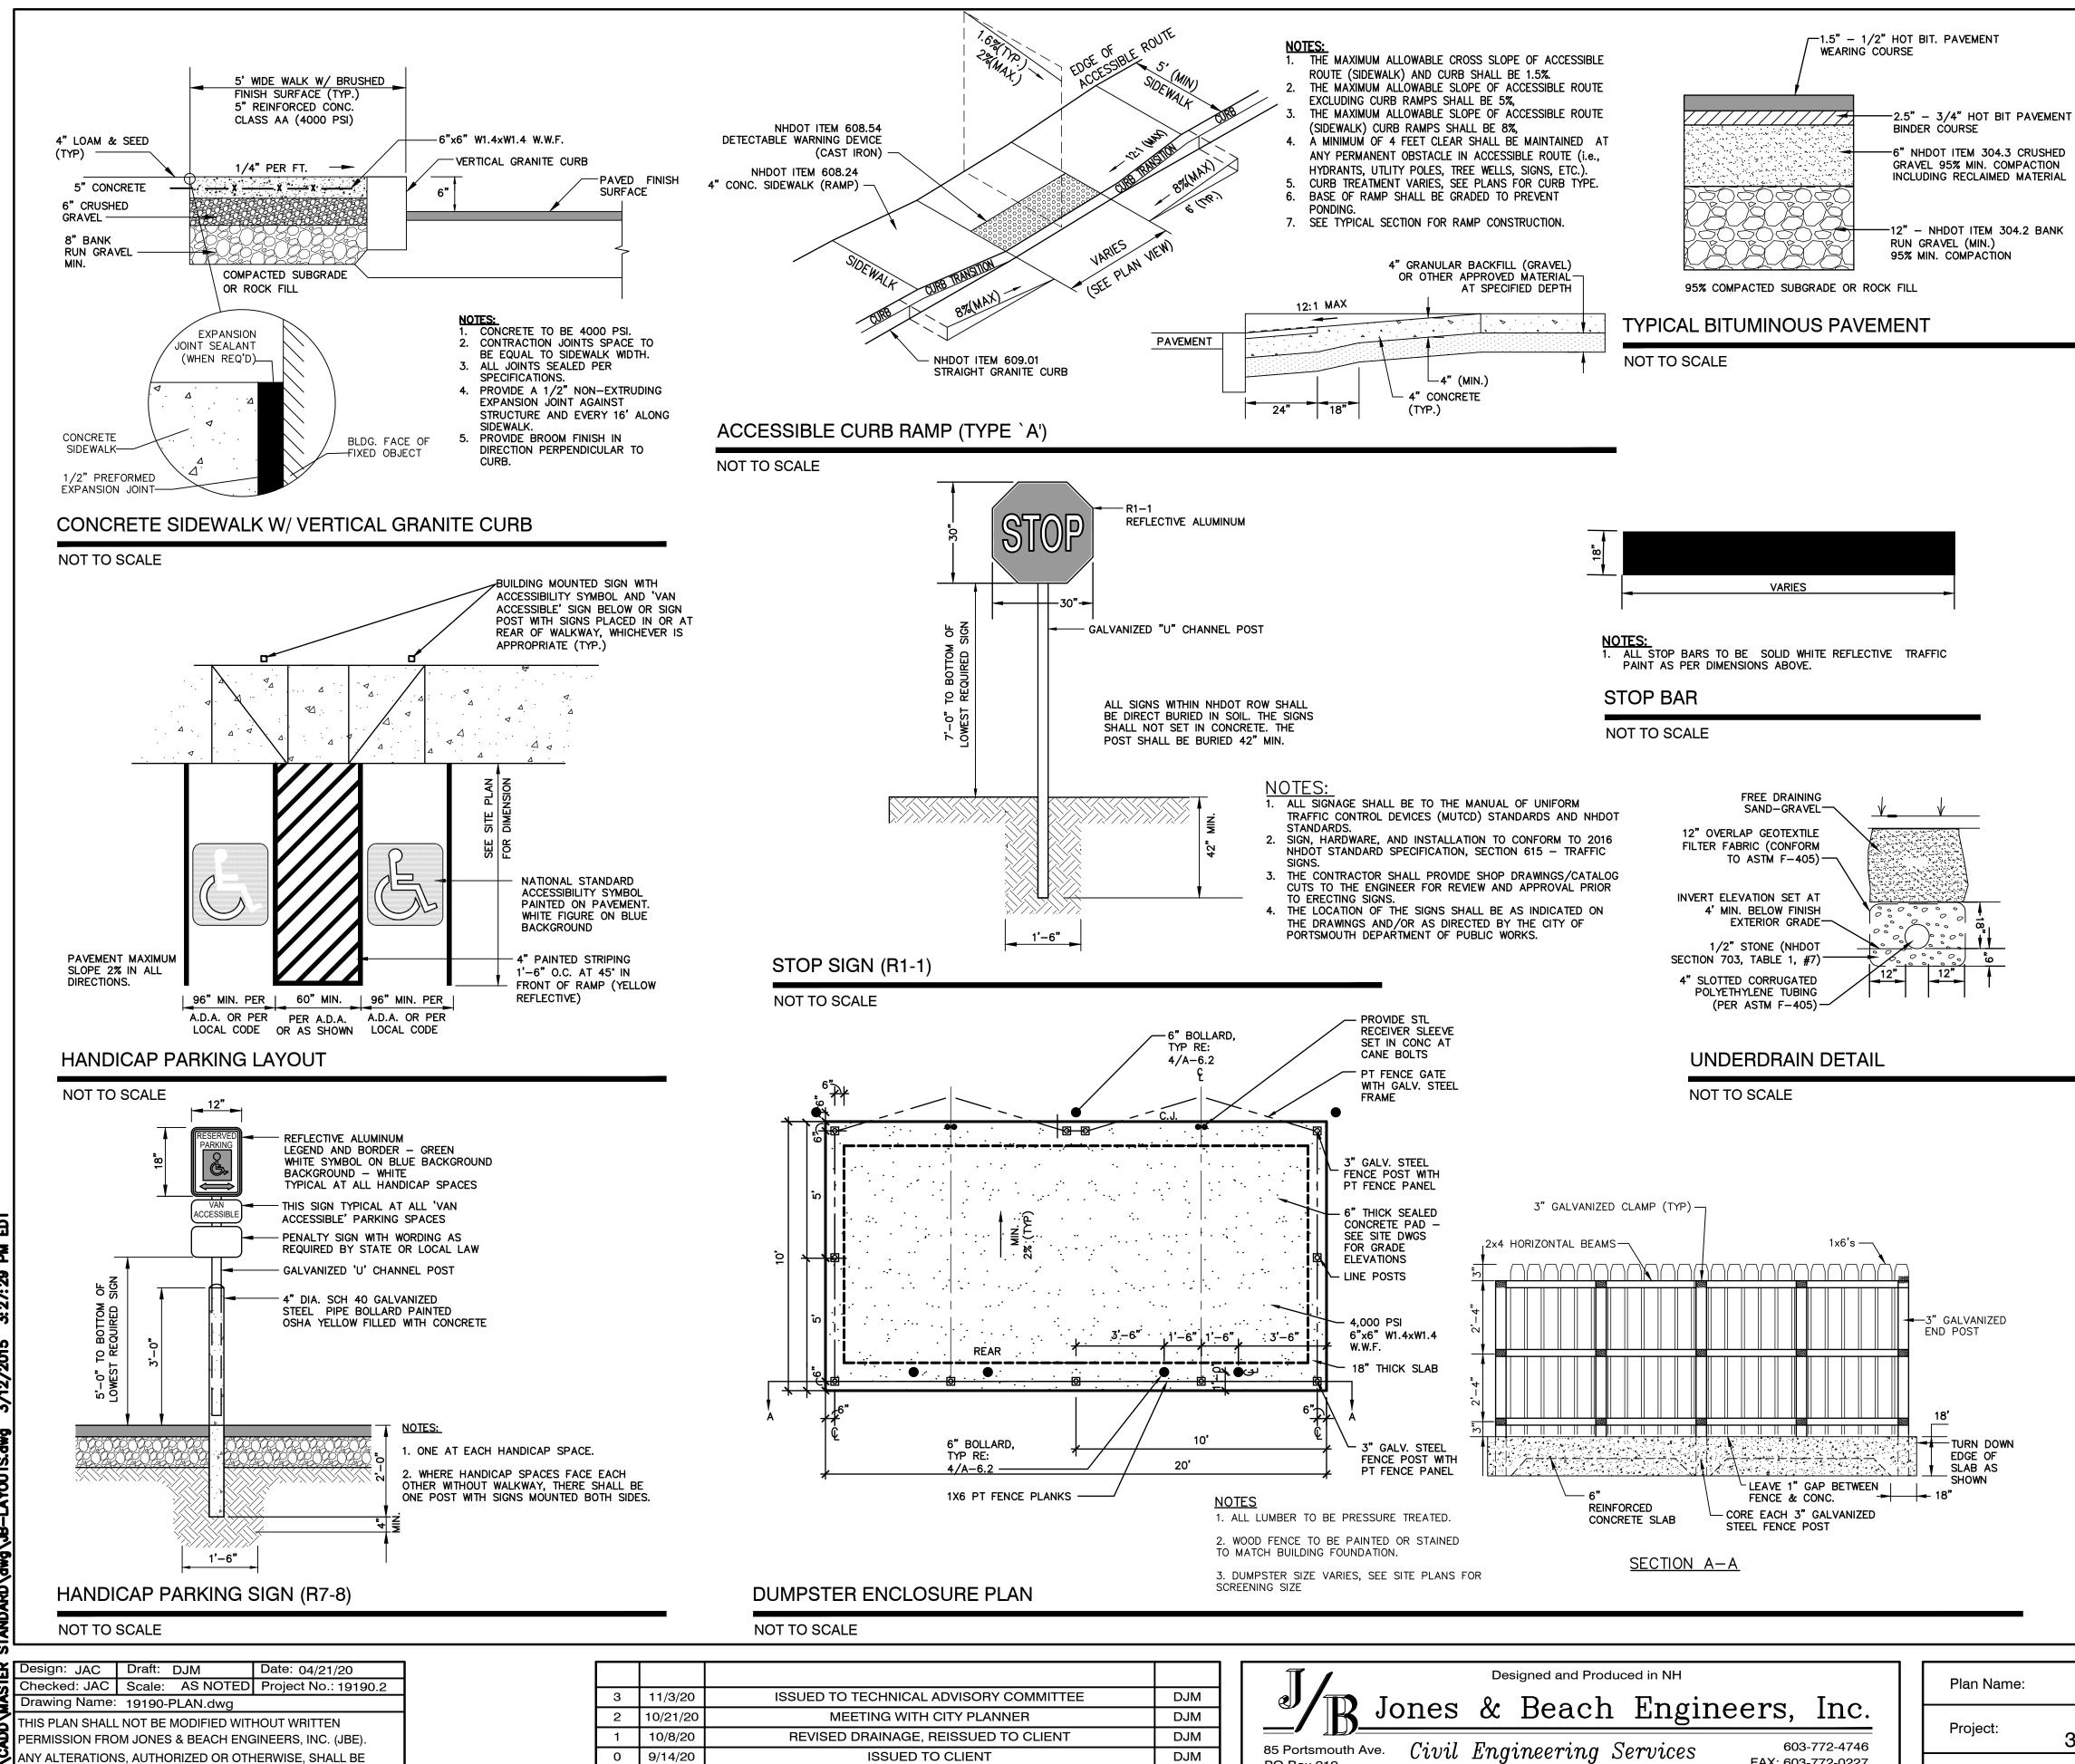
REVISION

DATE

REV.

		Designed and Produced in NH	Р	lan Name:
MMITTEE	DJM	Jones & Deach Engineers Inc.		
}	DJM	Jones & Beach Engineers, Inc.		we le et.
CLIENT	DJM	85 Portsmouth Ave Ciavil Emain corring Sorryicos 603-772-4746		roject:
	DJM	85 Portsmouth Ave. Civil Engineering Services 603-772-4746 PO Box 219 FAX: 603-772-0227		
	BY	Stratham, NH 03885 E-MAIL: JBE@JONESANDBEACH.COM		wner of Record

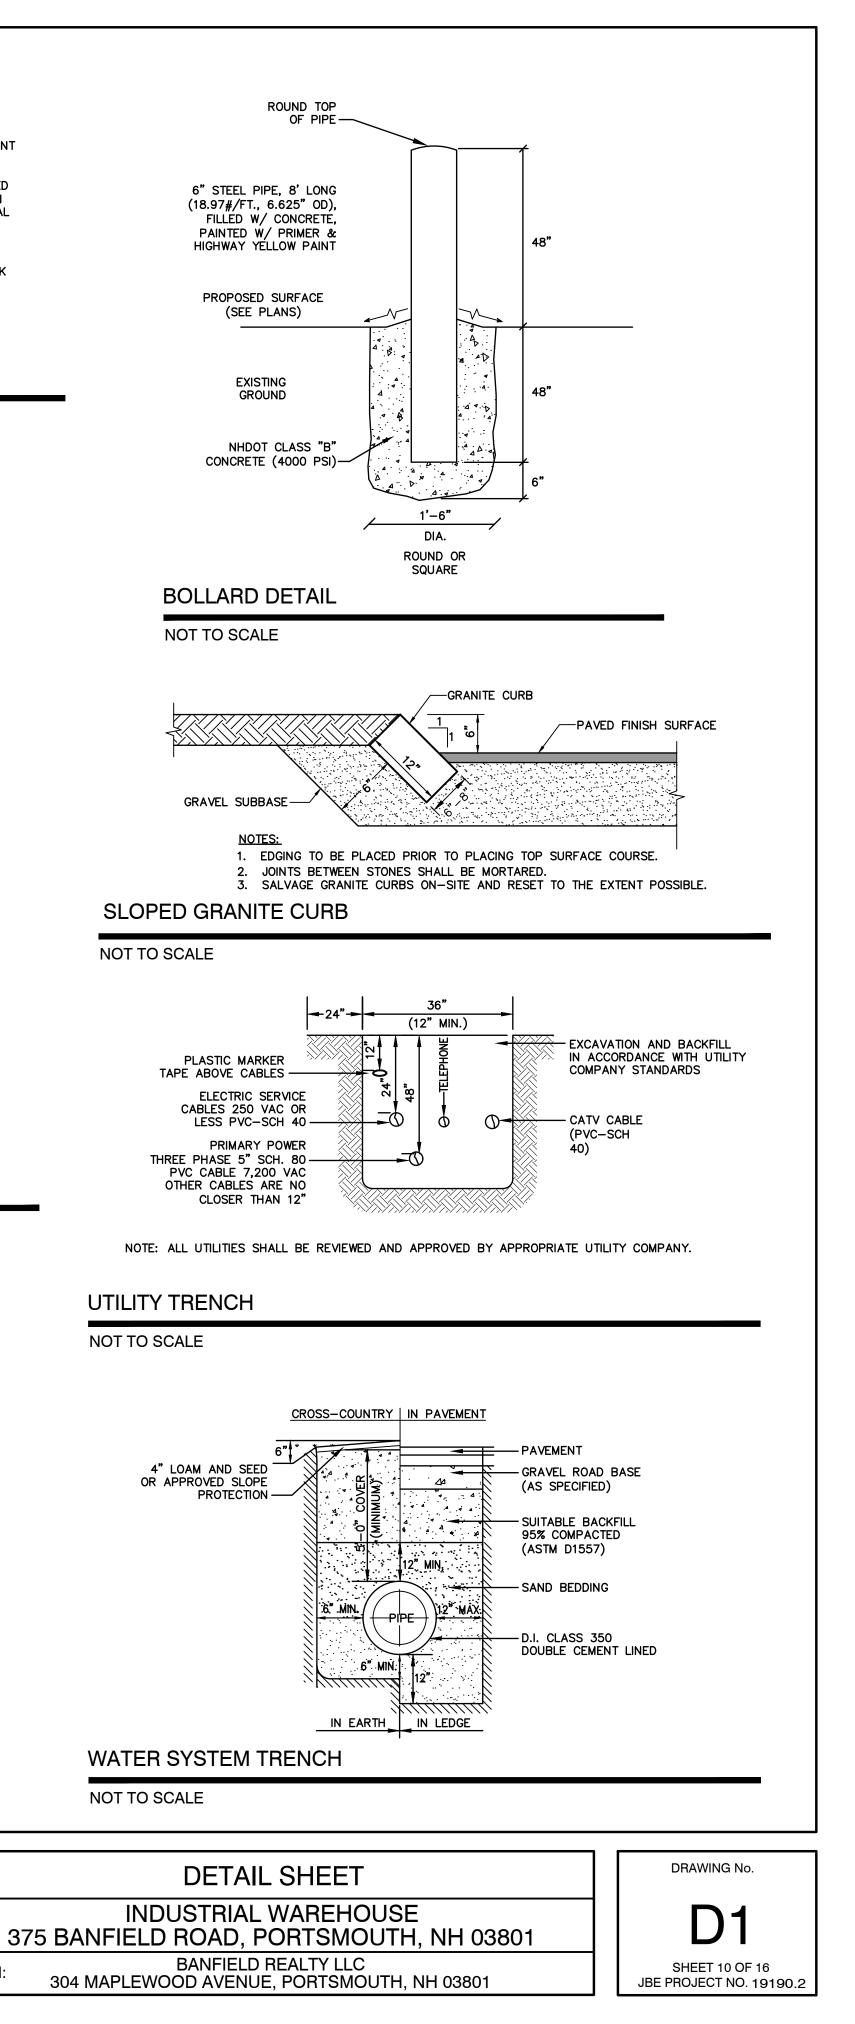

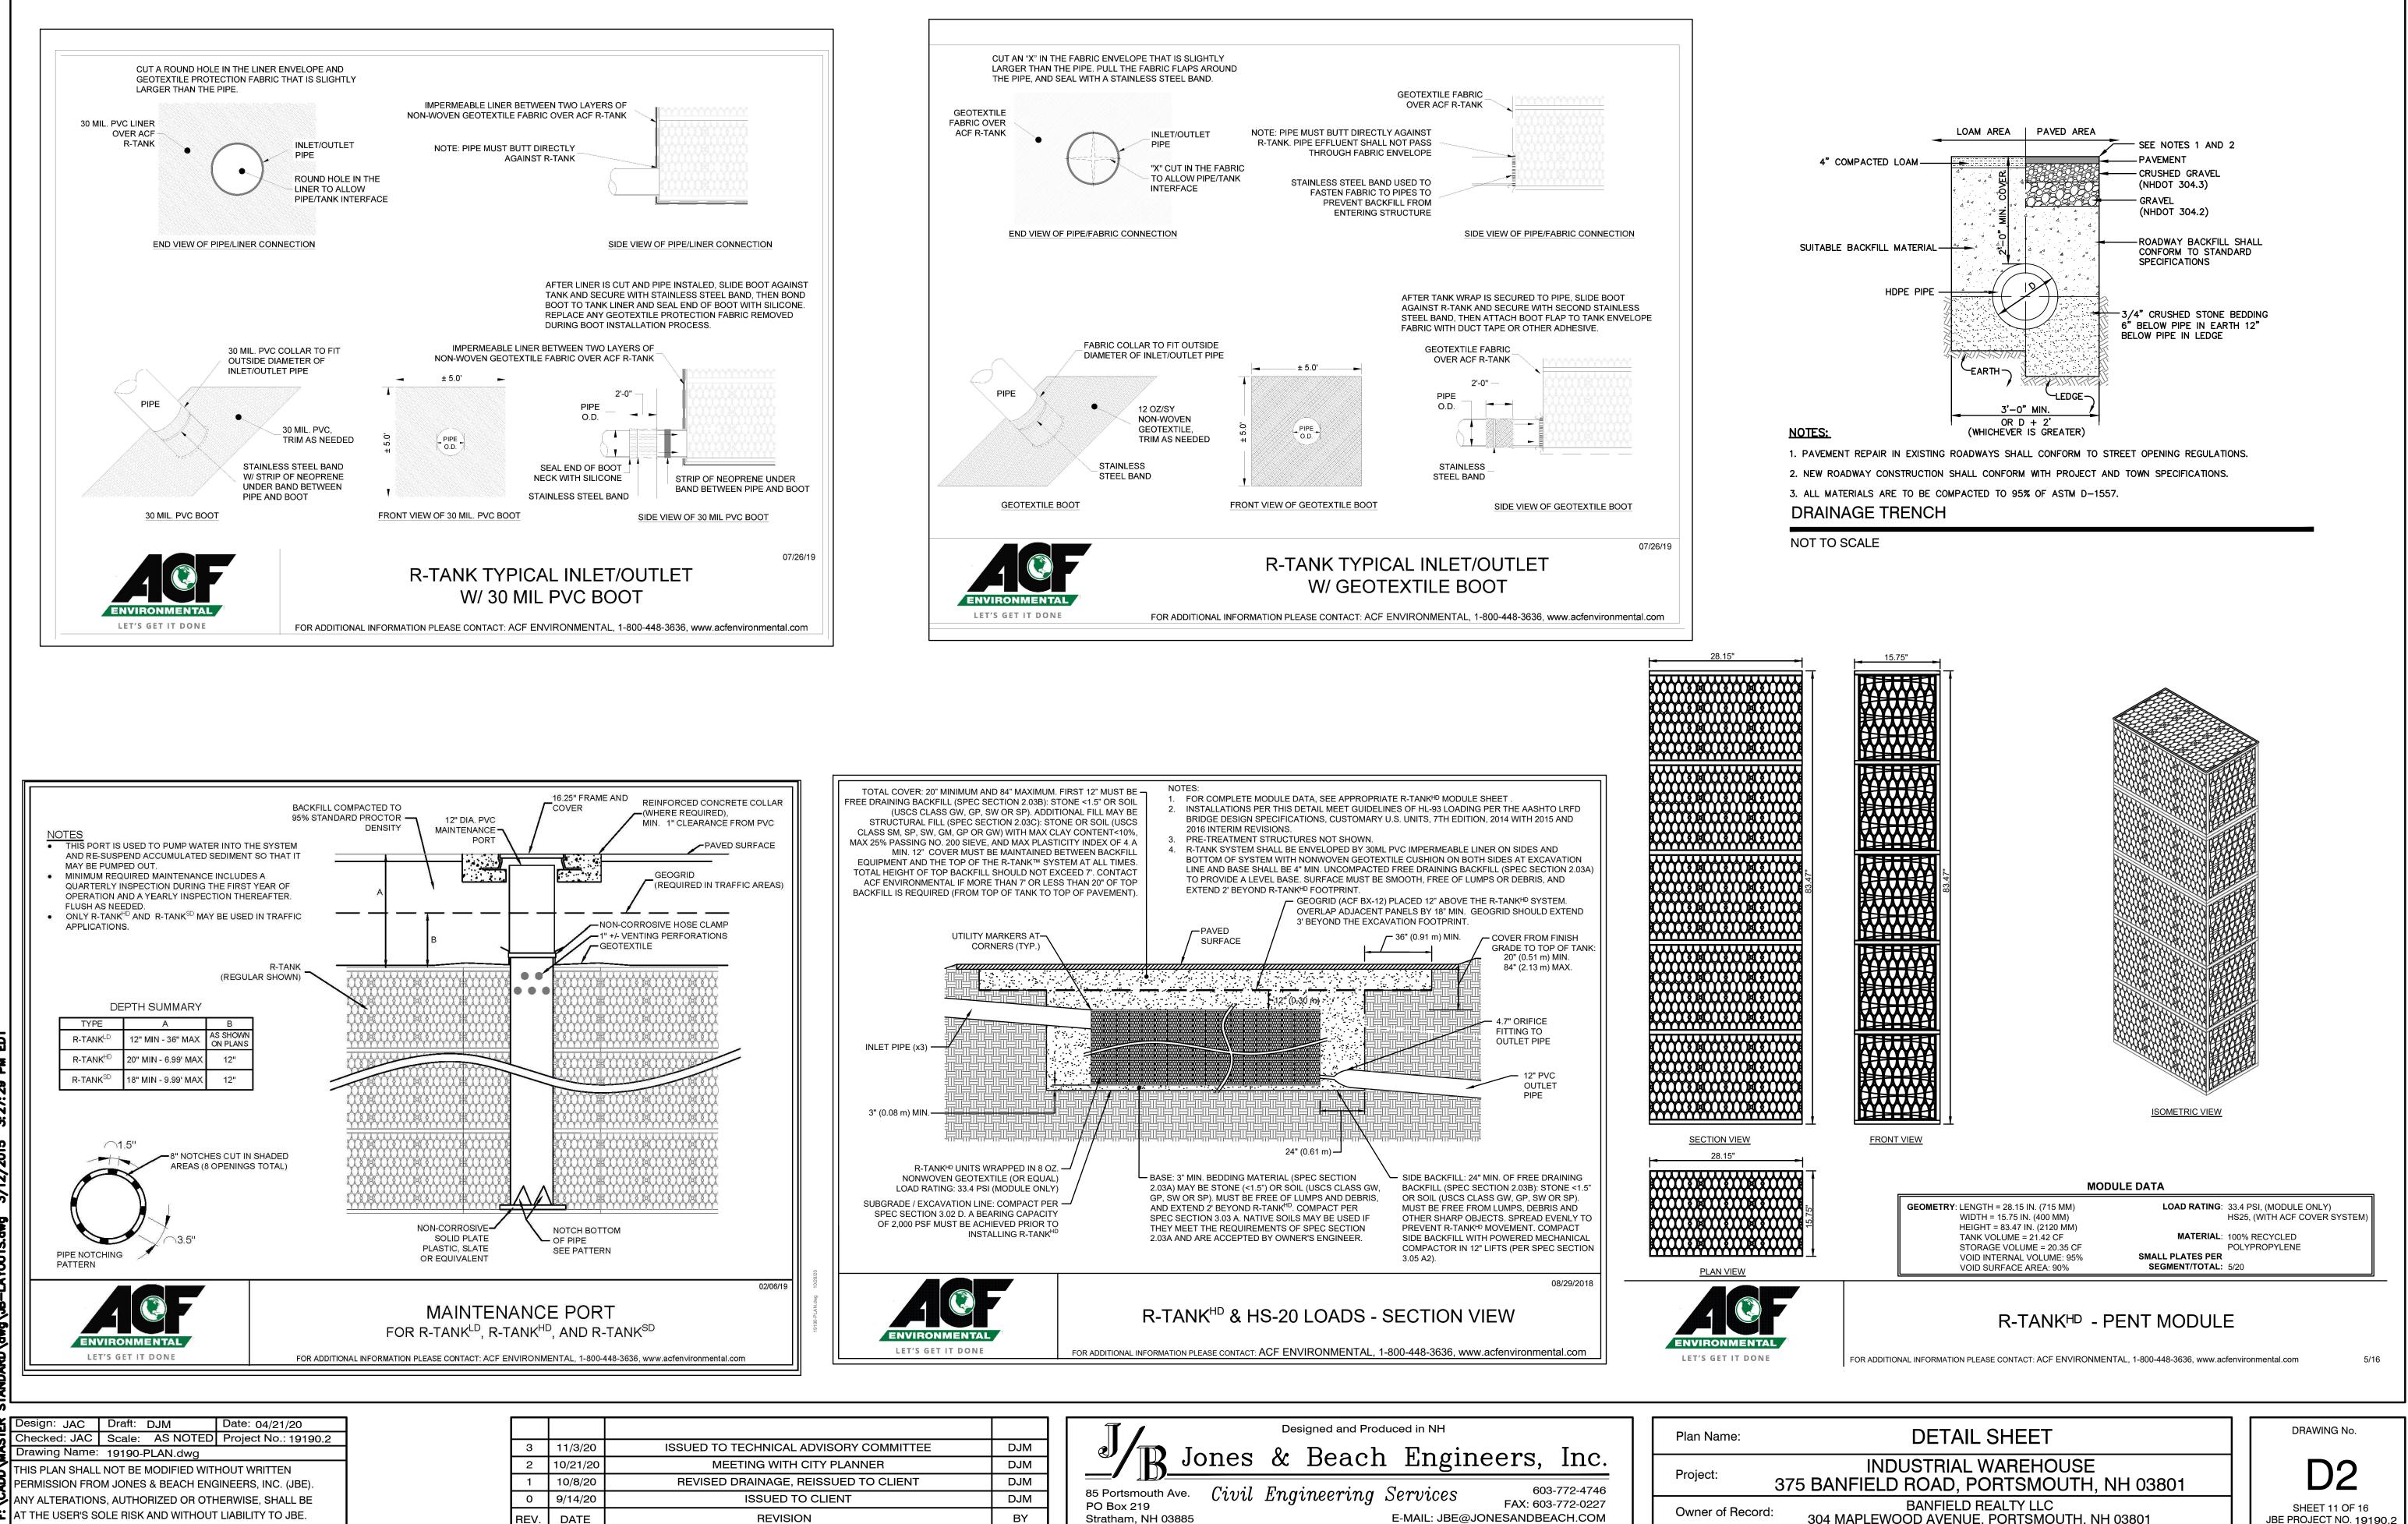

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REV.

DATE

Z 3: 27: 29

304 MAPLEWOOD AVENUE, PORTSMOUTH, NH 03801

JBE PROJECT NO. 19190.2

	PRETX SPECIFICATIONS A. <u>GENERAL</u> 1. PRETX SYSTEMS ARE A PRE-FILTER AND CRITICAL				FLUSH MOUNT FR
	MAINTENANCE BURDEN OF BIORETENTION SYSTEM PRACTICES BY FILTERING OUT SEDIMENT, TRASH A	IS, RAIN GARDENS, BIOSWALE	ATENDS THE OPERATING LIFE A S AND OTHER TYPES OF SURFA	AND REDUCES THE ACE BEST MANAGEMENT	
	<ul> <li>B. <u>PRODUCTS</u></li> <li>PRETX IS AVAILABLE IN 3 MODELS THAT MANAGE M</li> <li>PRETX-CURB IS FOR EDGE OF PAVEMENT RUNOFF</li> <li>PRETX-DROP IS FOR USE AS A DROP INLET CONFIG</li> </ul>	AT A CURB CUT IN LIEU OF A S	TONE SPREADER.		BULL NOSE
	<ul><li>GRATE.</li><li>PRETX-INLINE IS FOR USE WITH SUBSURFACE INLE</li><li>PRETX IS SIZED TO PRETREAT WATER QUALITY FLC</li></ul>	T AND OUTLET PIPE.			TOP SLAB
	<ul> <li>USED BOTH IN RETROFIT OR NEW INSTALLATIONS.</li> <li>6. ACCEPTABLE SYSTEM SUPPLIER: CONVERGENT WATER TECHNOLOGIES, INC. OF</li> </ul>	R ITS AUTHORIZED VALUE-ADD	ED RESELLER		
	(800) 711-5428 WWW.CONVERGENTWATER.COM C. SUBMITTALS				1.5" PAVEMENT
	<ol> <li>SUBMITTALS</li> <li>SUBMIT PROPOSED LAYOUT DRAWINGS. DRAWING RIM, PIPE INVERTS, OUTSIDE BOTTOM OF STRUCTU</li> </ol>		CTION DETAILS ANNOTED WITH	SYSTEM ELEVATIONS (E.G.,	
	<ol> <li>SUBMIT MATERIAL CERTIFICATES FOR FRAMES AND</li> <li>ANY PROPOSED EQUAL ALTERNATE PRODUCT SUB TO BID OPENING.</li> <li>EXECUTION</li> </ol>		ON MUST BE SUBMITTED FOR F	REVIEW AND APPROVED PRIOR	$\binom{6}{D1}$ 2" TIP DOWN
	<ul> <li>D. <u>EXECUTION</u></li> <li>All PUBLIC STORM DRAINAGE SYSTEMS SHALL BE C TRANSPORTATION STANDARDS AND SPECIFICATIO</li> <li>All STORM DRAINAGE SYSTEM CONSTRUCTION IS S</li> </ul>	NS AND ACCORDING TO LOCAL	MUNICIPAL REQ UIREME NTS.		
	<ol> <li>THE CONTRACTOR SHALL NOTIFYTHE PROJECT EN N.</li> <li>THE CONTRACTOR SHALL BE RESPONSIBLE FOR CONTRACTOR SHALL SHALL BE RESPONSIBLE FOR CONTRACTOR SHALL SHALL SHALL BE RESPONSIBLE FOR CONTRACTOR SHALL SHAL</li></ol>	GINEER A MINIMUM OF TWO FL	JLL BUSINESS DAYS PRIOR TO	THE START OF CONSTRUCTIO	
	<ul> <li>OF AII UNDERGROUND UTILITIES PRIOR TO THE STA POTENTIAL CONFLICTS.</li> <li>5. TO PROTECT STORMWATER FLOW CONTROL AND CONTROL AND</li></ul>	RT OF CONSTRUCTION/ EXCA	VATI ON AND SHALL NOTIFY THE	E PROJECT ENGINEER OF ANY	PRECAST STRUCTURE
	THE STORM CONVEYANCE SYSTEM ONLY AFTER AL ALL AREAS ABOVE AND UPSTREAM OF THE FACILIT	.L SITE WORK, ROAD CONSTRU Y.	JCTION, UTILITY WORK AND LAN	NDSCAPING ARE IN PLACE IN	
	<ol> <li>THE EXISTING STORM SEWER SYSTEM SHALL STAY FOR USE. THERE SHALL BE NO DEBRIS IN THE LINES</li> <li>PROVIDE A 1.5" MINIMUM GAP BETWEEN THE KNOCI WITH JOINT MORTAR</li> </ol>	3 OR FURTHER CLEANING WIII I	BE REQUIRED PRIOR TO ACCEP	PTANCE.	
	<ul><li>WITH JOINT MORTAR</li><li>8. THE OPENING SHALL BE MEASURED ATTHE TOP OF</li><li>9. All PICKUP HOLES SHALL BE GROUTED FULL AFTER</li></ul>				
	<ol> <li>STANDARD CURB INLETS AND TIPDOWNS SHALL BE</li> <li>PIPE ENDS SHALL BE FLUSH WITH THE INNER WALL USED TO ADJUST THE RISERS TO GRADE PRIOR TO</li> </ol>	PRECAST CONCRETE OR ASP OR 1" MAXIMUM INTRUSION. M	HALT.	SIMILIAR MATERIALS MA Y BE	D1 NOT
	<ol> <li>12. GROUTING SHALL BE SUFFICIENTTO PREVENT LEAP PERFORMED INSIDE, BETWEEN &amp; OUTSIDE OF AII RI</li> <li>13. MANHOLES TO BE CONSTRUCTED IN ACCORDANCE</li> </ol>	S BETWEEN THE PRECAST CO SERS, JOINTS & PIPE PENETRA	ATIONS.		/
	SPECIFICATIONS. 14. AII REINFORCED CAST IN PLACE CONCRETE SHALL	BE CLASS 4000. All PRECAST C	ONCRETE SHALL BE CLASS 400	0.	/ / / / /
	<ol> <li>RECAST BASES SHALL BE FURNISHED WITH CUTOU</li> <li>MATING SURFACES OF MANHOLE RINGS AND COVE</li> <li>CONSTRUCTION AND SEQUENCING</li> </ol>				
	EXAMINATION     A. VERIFY LAYOUT AND ORIENTATION OF PRE-TX S     BIOFILTRATION SYSTEM, AND CONNECTIONS.	YSTEM AREA INCLUDING EDGE	OF PAVEMENT, TIP DOWN, CUR	RBS AND SIDEWALK,	44" 12"
	BIOFICITIATION SYSTEM, AND CONNECTIONS. B. VERIFY EXCAVATION BASE IS READY TO RECEIVI DRAWINGS.	E WORK AND EXCAVATIONS, D	IMENSIONS, AND ELEVATIONS A	ARE AS INDICATED ON	
	2. PREPARATION A. CALL DIG SAFE AND RECEIVE APPROVAL BEFORE				
	<ul> <li>B. REQUEST UNDERGROUND UTILITIES TO BE LOCA</li> <li>C. IDENTIFY REQUIRED LINES, LEVELS, CONTOURS,</li> <li>D. CLEAR AND COUR THE PROPOSED DRE TY SYSTI</li> </ul>	AND DATUM.	) SURROUNDING CONSTRUCTIC	DN AREAS.	46" - AF
	<ul> <li>D. CLEAR AND GRUB THE PROPOSED PRE-TX SYSTI</li> <li>3. EXCAVATION AND INSTALLATION</li> <li>A. THE FOLLOWING CONSTRUCTION SEQUENCE IS <sup>1</sup></li> </ul>		JIDELINE. COORDINATE WITH TH	HE OWNER, AND ENGINFERS	
	FOR REVIEW AND APPROVAL PRIOR TO CONSTRU- B. INSTALL TEMPORARY EROSION AND SEDIMENT C	JCTION. ONTROLS TO DIVERT STORM \			3 PRETX CURB OUT
	C. EXCAVATE TO THE BOTTOM INVERT OF THE SYS D. TO MINIMIZE COMPACTION OF ADJACENT BIOFIL THE PRE-TX SYSTEM AREA TO ITS APPROPRIATE	RATION SYSTEMS, WORK EXC		I THE SIDES TO EXCAVATE	D1 NOT TO SCALE
	E. ROUGH GRADE THE PRE-TX SYSTEM AREA TO TIS APPROPRIATE FOOT OF STRUCTURE BOTTOM .			M FACILITIES TO WITHIN 1	
	F. PLACE 1 FOOT BED OF COARSE STONE TO ELEVA G. ESTABLISH ELEVATIONS FOR ADJACENT CURBS,			S FOR INLETS AND OUTLETS	
	AS INDICATED ON DRAWINGS. 4. INSTALLATION A. PLACE THE PRECAST SYSTEM TO NECESSARY EI	EVATION.			1
	B. VERIFY ELEVATIONS FOR ADJACENT CURBS, EDC PIPE INVERTS FOR INLETS AND OUTLETS, OUTLE	E OF PAVEMENT, PAVEMENT	GRADING FOR INLET GRATE FO	R PRETX-DROP, SIDEWALK,	
	C. FOR PRETX-SURFACE: a. VERIFY ELEVATIONS FOR ADJACENT CURBS.		_		EDGE OF 6"
	<ul> <li>b. VERIFY EDGE OF PAVEMENT TIP DOWN PAVEME</li> <li>c. VERIFY CURB ELEVATION IN RELATION TO PAVE</li> <li>d. VERIFY OUTLIET INVERTION KIEF WALL IN PERI</li> </ul>	MENT AND TIP DOWN.	E.		Z/////X////// 4" MI
	<ul> <li>d. VERIFY OUTLET INVERT FOR KNEE WALL IN REL</li> <li>D. FOR PRETX-DROP:</li> <li>a. VERIFY ALL INLET PIPES ENTER THE STRUCTUR</li> </ul>				
	<ul> <li>b. VERIFY ALL INCET PIPES ENTER THE STRUCTOR</li> <li>b. VERIFY FRAME AND GRATE OFFSET ON INLET S</li> <li>c. VERIFY CURB LOCATION WITH RESPECT TO FRAME</li> </ul>	IDE AND UPSTREAM OF BAFFL			TIP DOWN 1 <sup></sup>
	E. INSTALL BAFFLES, WEIR, AND SCREENS AS INDIC F. VERIFY MAINTENANCE ACCESS THROUGH GRATE	ATED ON DRAWINGS.			<u>SECTION A-A'</u>
	G. INSTALL TOP OF STRUCTURE LEVEL WITH ADJAC VISIT REQUIRED PRIOR TO BACKFILLING.			ATIONS. ENGINEER FIELD	
	<ol> <li>BACKFILLING         <ul> <li>A. BACKFILL WITH APPROVED SOIL AND STONE TO T</li> <li>B. BACKFILL WITH 12" OF NO. 57 STONE AROUND RE</li> </ul> </li> </ol>			REEN	
	C. BACKFILL WITH 12 OF NO. 57 STONE AROUND RE C. BACKFILL WITH BIORETENTION SOIL MIX BEYOND D. DO NOT BACKFILL SOIL OR STONE AGAINST STAIL	STONE BACKFILL TO EQUAL E			
	E. DO NOT COMPACT ADJACENT FILTRATION SYSTE F. STABILIZE AII REMAINING DISTURBED AREAS AND	M SOIL WITH MECHANICAL EQU		SION CONTROL BLANKETS AS	5 TIP DOWN CURB
	INDICATED ON DRAWINGS. 6. CLEAN UP A. AFTER COMPLETION OF THE WORK, REMOVE AND				D1 NOT TO SC/
	A. AFTER COMPLETION OF THE WORK, REMOVE AND ETC., FROM THE PROJECT SITE. REPAIR PROMPT SATISFACTORY CONDITION.	LY ANY IDENTIFIED DEFICIENC	NIS, CONSTRUCTION MATERIA	LS, RUBBISH, EXCESS SOIL, SITE IN A CLEAN AND	
					<b></b>
	PRETX-CL	IRB ELEVATIO	ON GUIDE		
POINT	DESCRIPTION	ELEV. (FP1)	ELEV. (FP2)	ELEV. (FP3)	
А	EDGE OF PAVEMENT	45.8	49.1	46.5	6 ELEVATION GUIDE
В	OUTSIDE TOP SLAB	46.5	49.8	47.2	D1 ELEVATION GUIDE NOT TO SCALE
С	TOP OF BIOFILTRATION	44.3	46.25	45.0	
D	SUMP INVERT	42.8	46.1	43.5	
		10.7	45.0	47.0	

OUTSIDE BOTTOM


42.3


45.6

43.0


_			
	3	11/3/20	ISSUED TO TECHNICAL ADVISORY (
	2	10/21/20	MEETING WITH CITY PLANN
	1	10/8/20	REVISED DRAINAGE, REISSUED T
	0	9/14/20	ISSUED TO CLIENT
	REV.	DATE	REVISION


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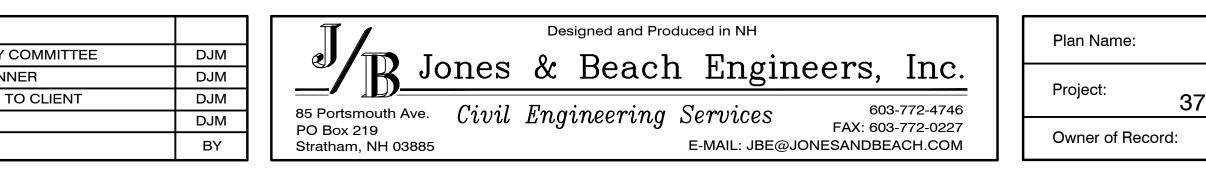


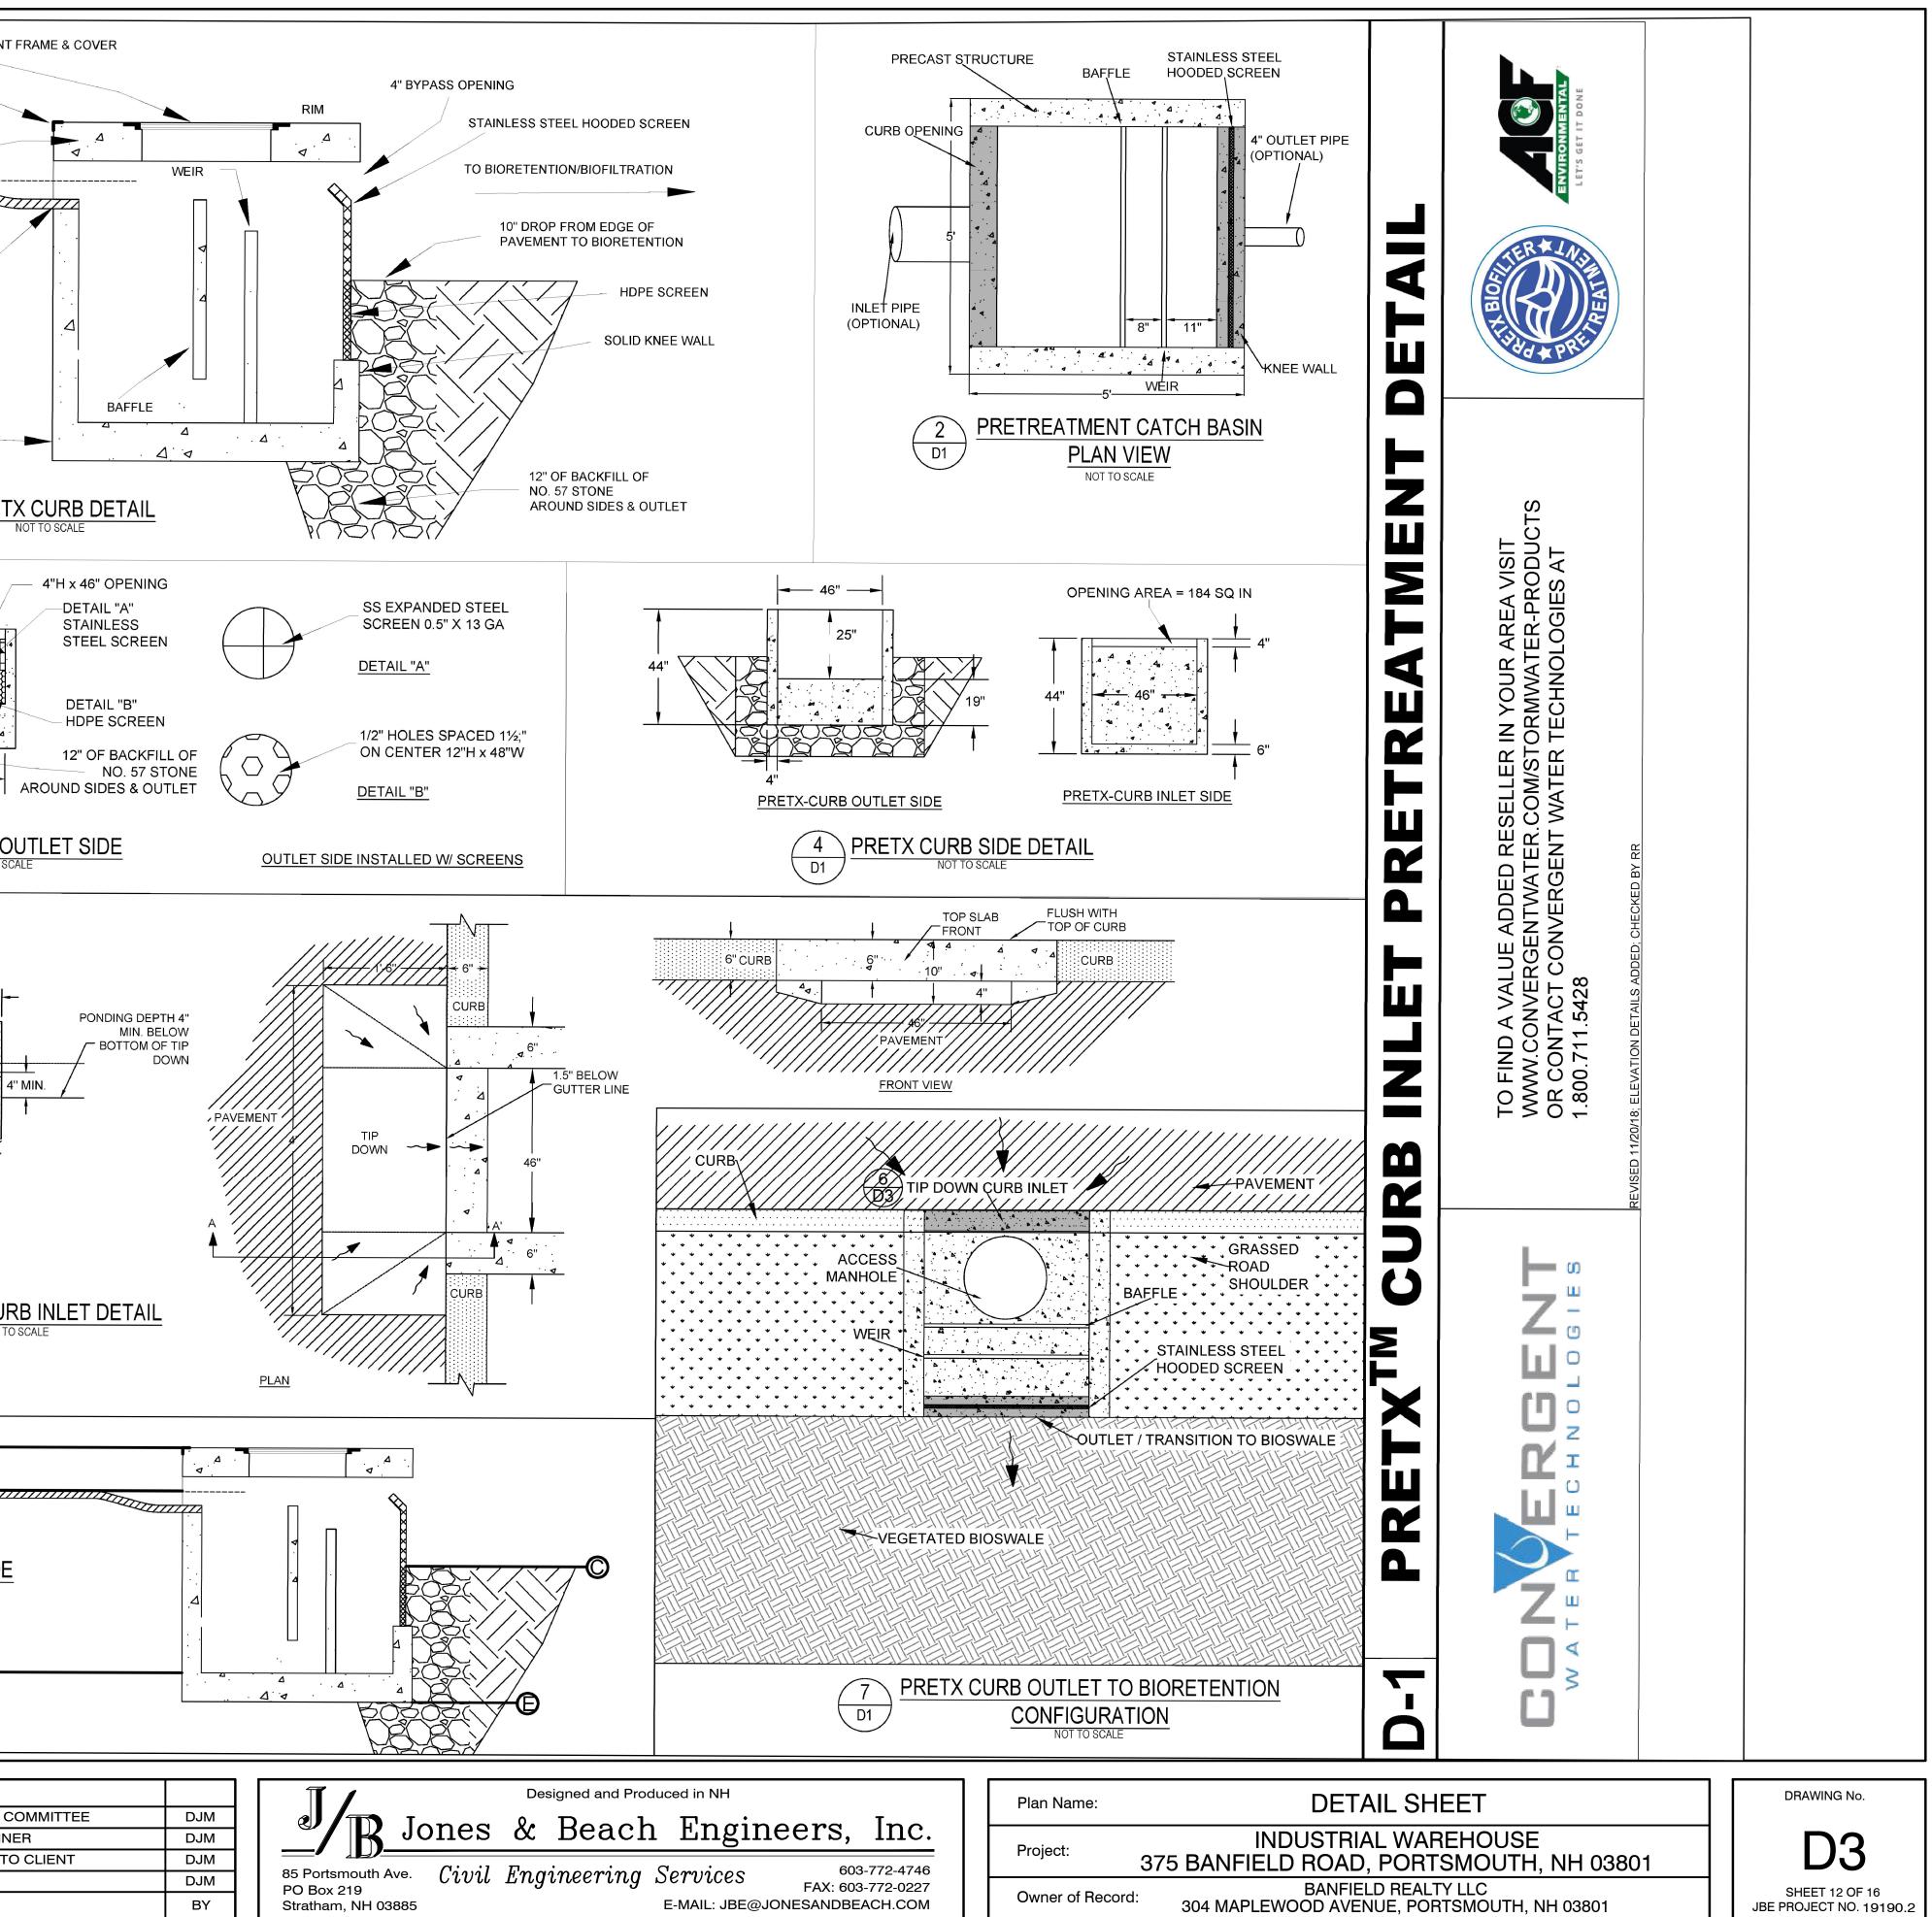

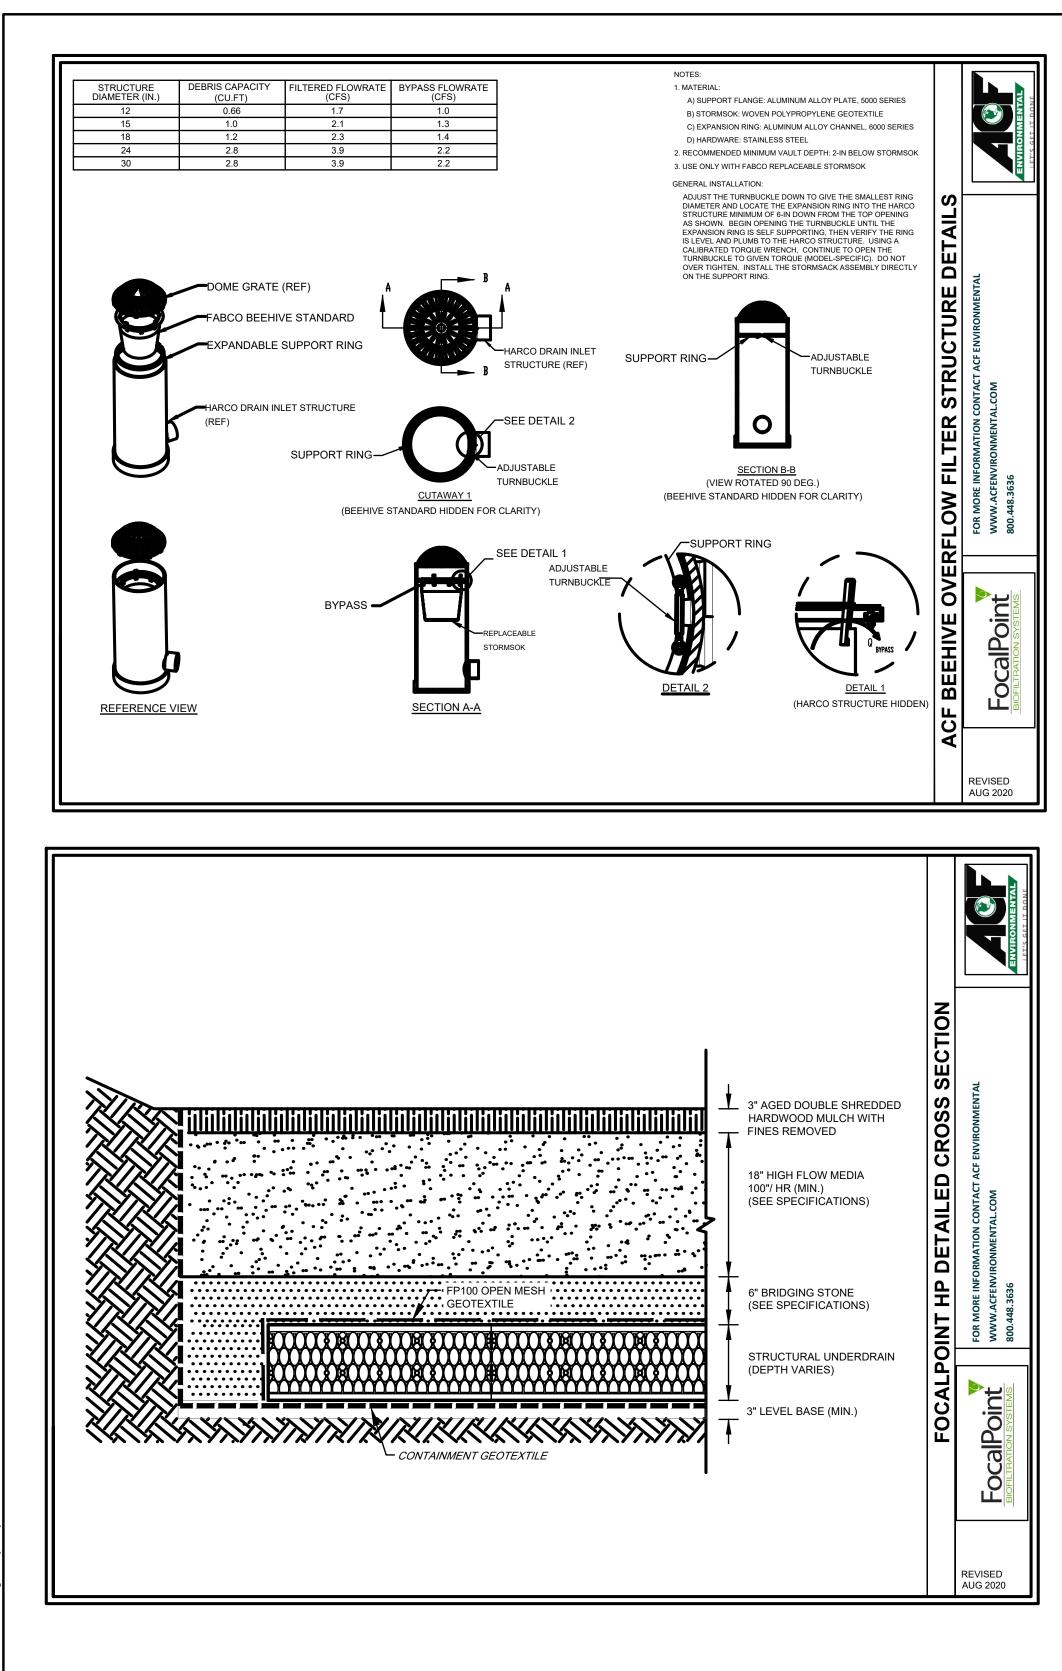Design: JAC	Draft: DJM	Date: 04/21/20
Checked: JAC		Project No.: 19190.2
Drawing Name:	19190-PLAN.dwg	
THIS PLAN SHALI	L NOT BE MODIFIED WIT	HOUT WRITTEN
	OM JONES & BEACH ENG	
ANY ALTERATION	IS, AUTHORIZED OR OTH	IERWISE, SHALL BE
AT THE USER'S S	OLE RISK AND WITHOUT	LIABILITY TO JBE.



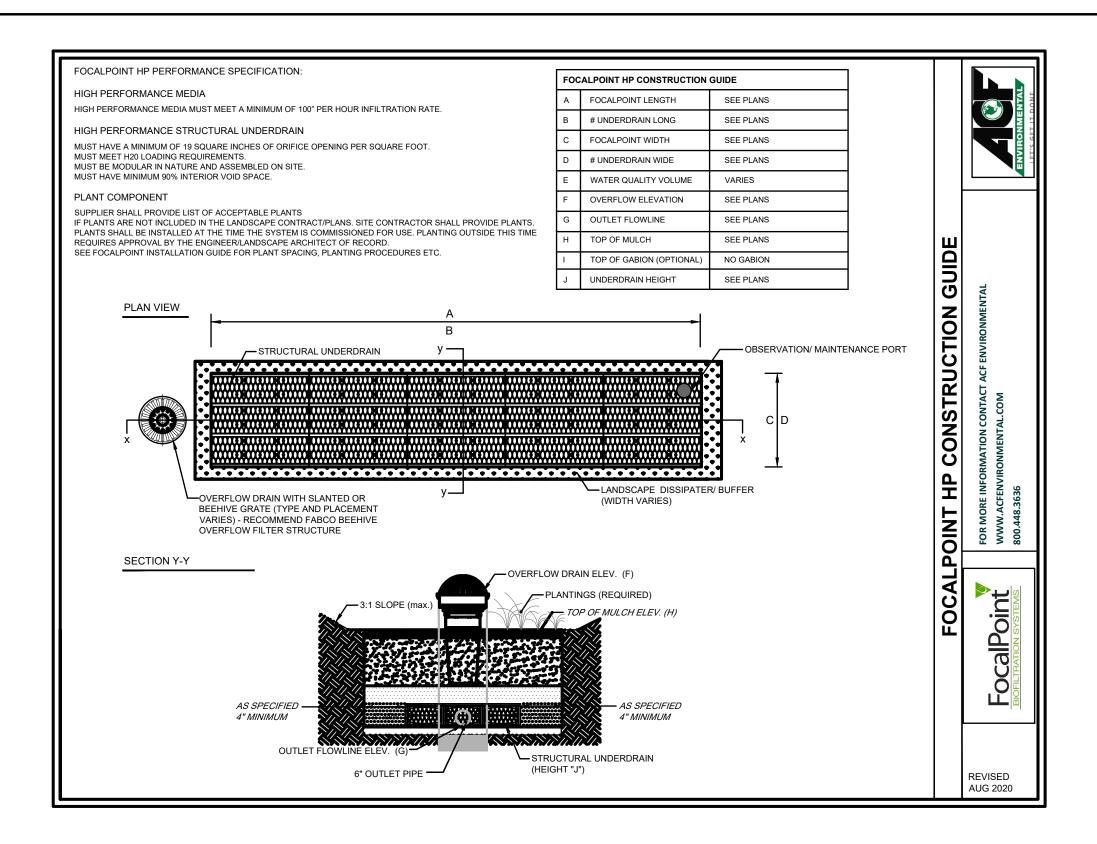


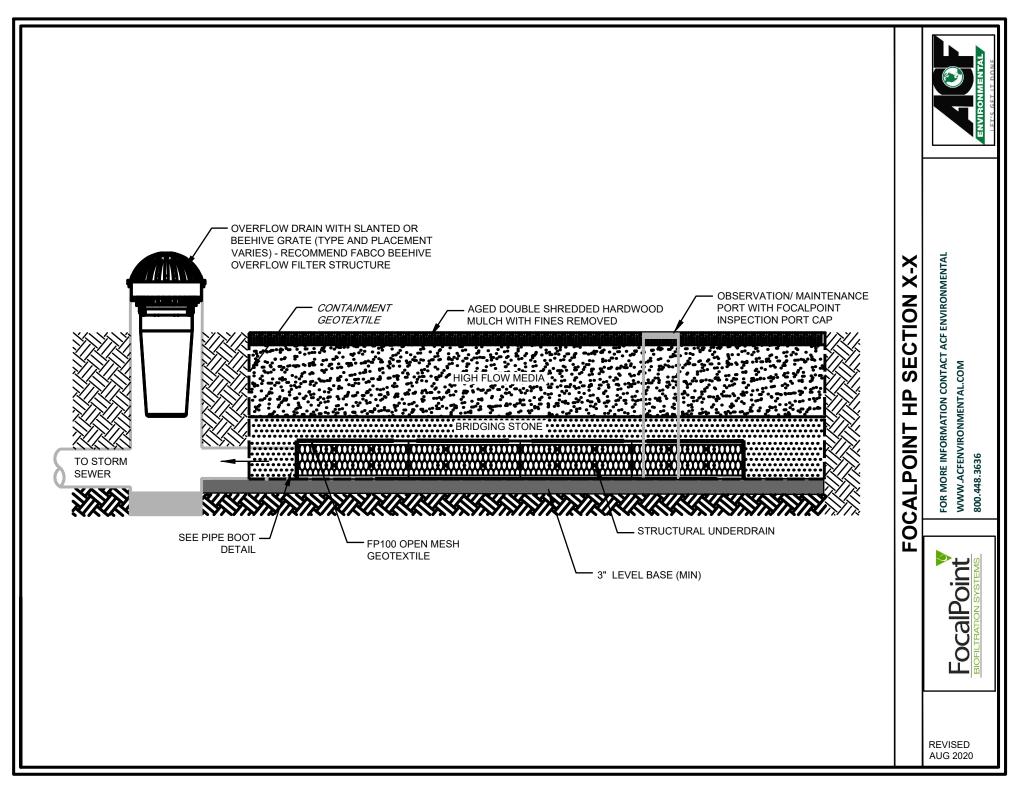

DETAIL SHEET INDUSTRIAL WAREHOUSE 375 BANFIELD ROAD, PORTSMOUTH, NH 03801 BANFIELD REALTY LLC 304 MAPLEWOOD AVENUE, PORTSMOUTH, NH 03801

DRAWING No.




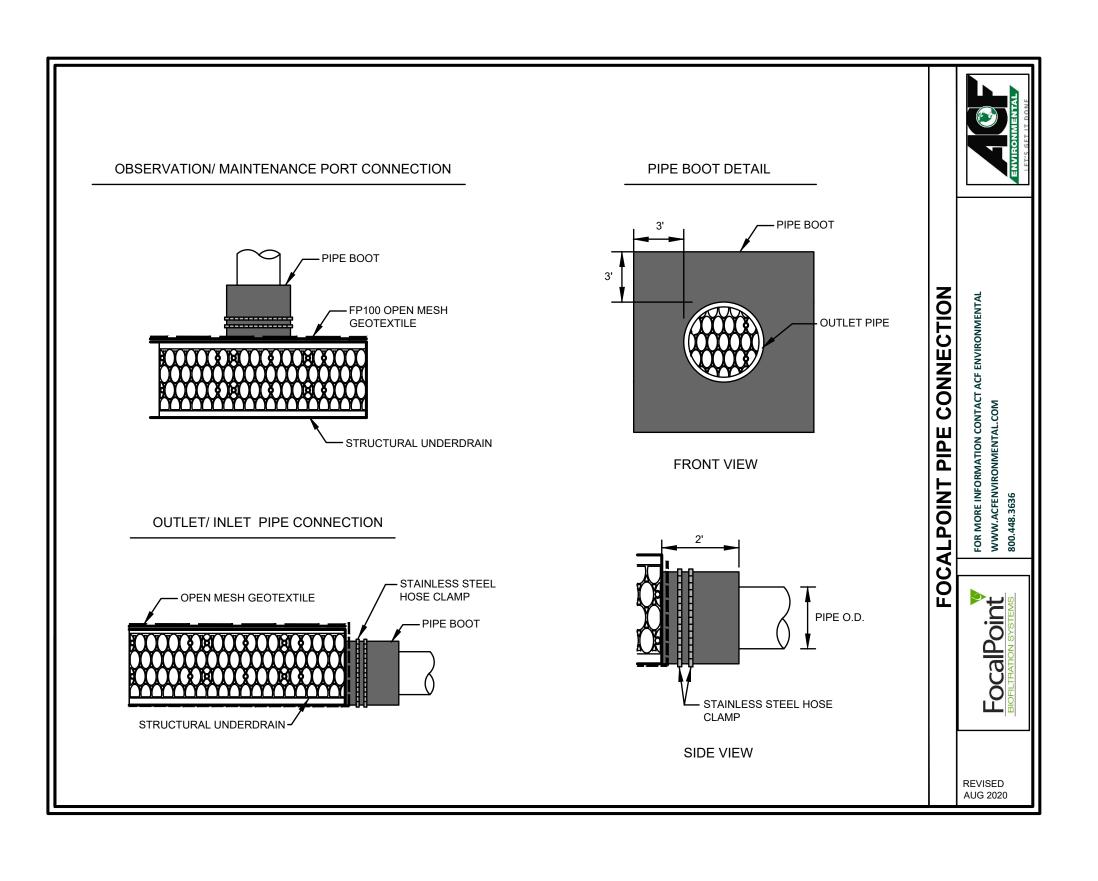




E	Design: JAC	Draft: DJM	Date: 04/21/20
ST	Checked: JAC	Scale: AS NOTED	Project No.: 19190.2
MA	Drawing Name:	19190-PLAN.dwg	
2	THIS PLAN SHALL	NOT BE MODIFIED WIT	HOUT WRITTEN
Q	PERMISSION FRC	M JONES & BEACH ENG	GINEERS, INC. (JBE).
ÿ	ANY ALTERATION	S, AUTHORIZED OR OTH	HERWISE, SHALL BE
Ŀ	AT THE USER'S S	OLE RISK AND WITHOUT	LIABILITY TO JBE.

3	11/3/20	ISSUED TO TECHNICAL ADVISORY
2	10/21/20	MEETING WITH CITY PLANN
1	10/8/20	REVISED DRAINAGE, REISSUED T
0	9/14/20	ISSUED TO CLIENT
REV.	DATE	REVISION

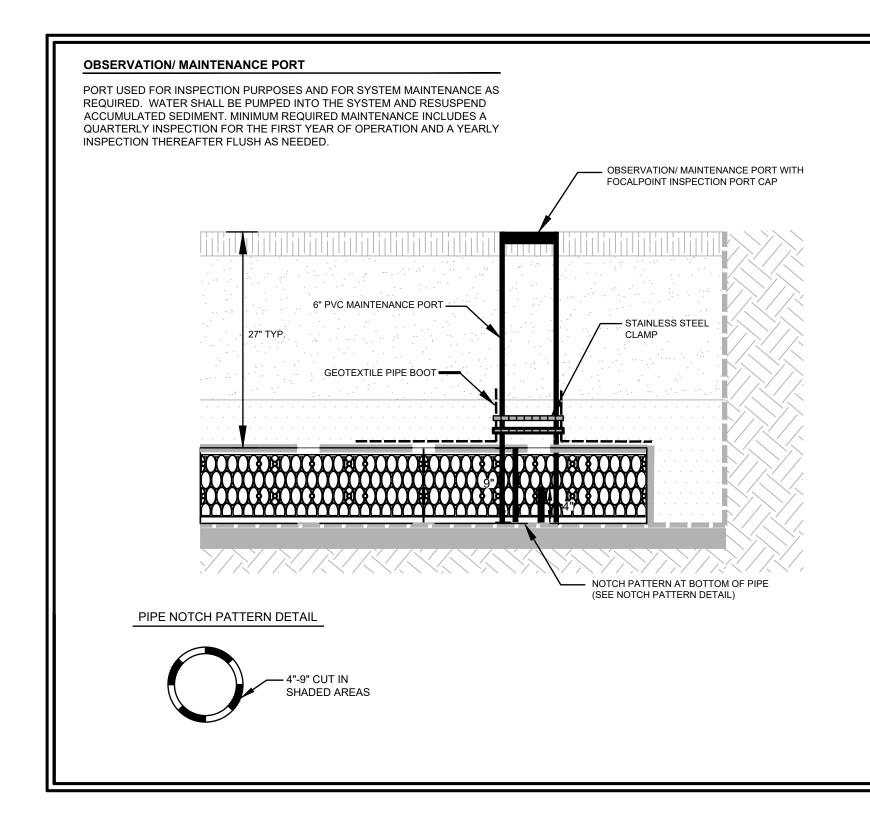

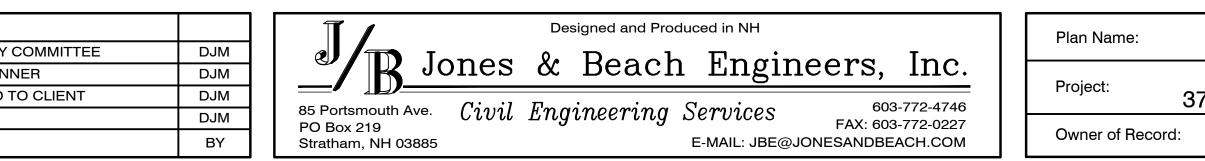




DETAIL SHEET INDUSTRIAL WAREHOUSE 375 BANFIELD ROAD, PORTSMOUTH, NH 03801 d: 304 MAPLEWOOD AVENUE, PORTSMOUTH, NH 03801

DRAWING No.


BHEET 14 OF 16 JBE PROJECT NO. 19190.2

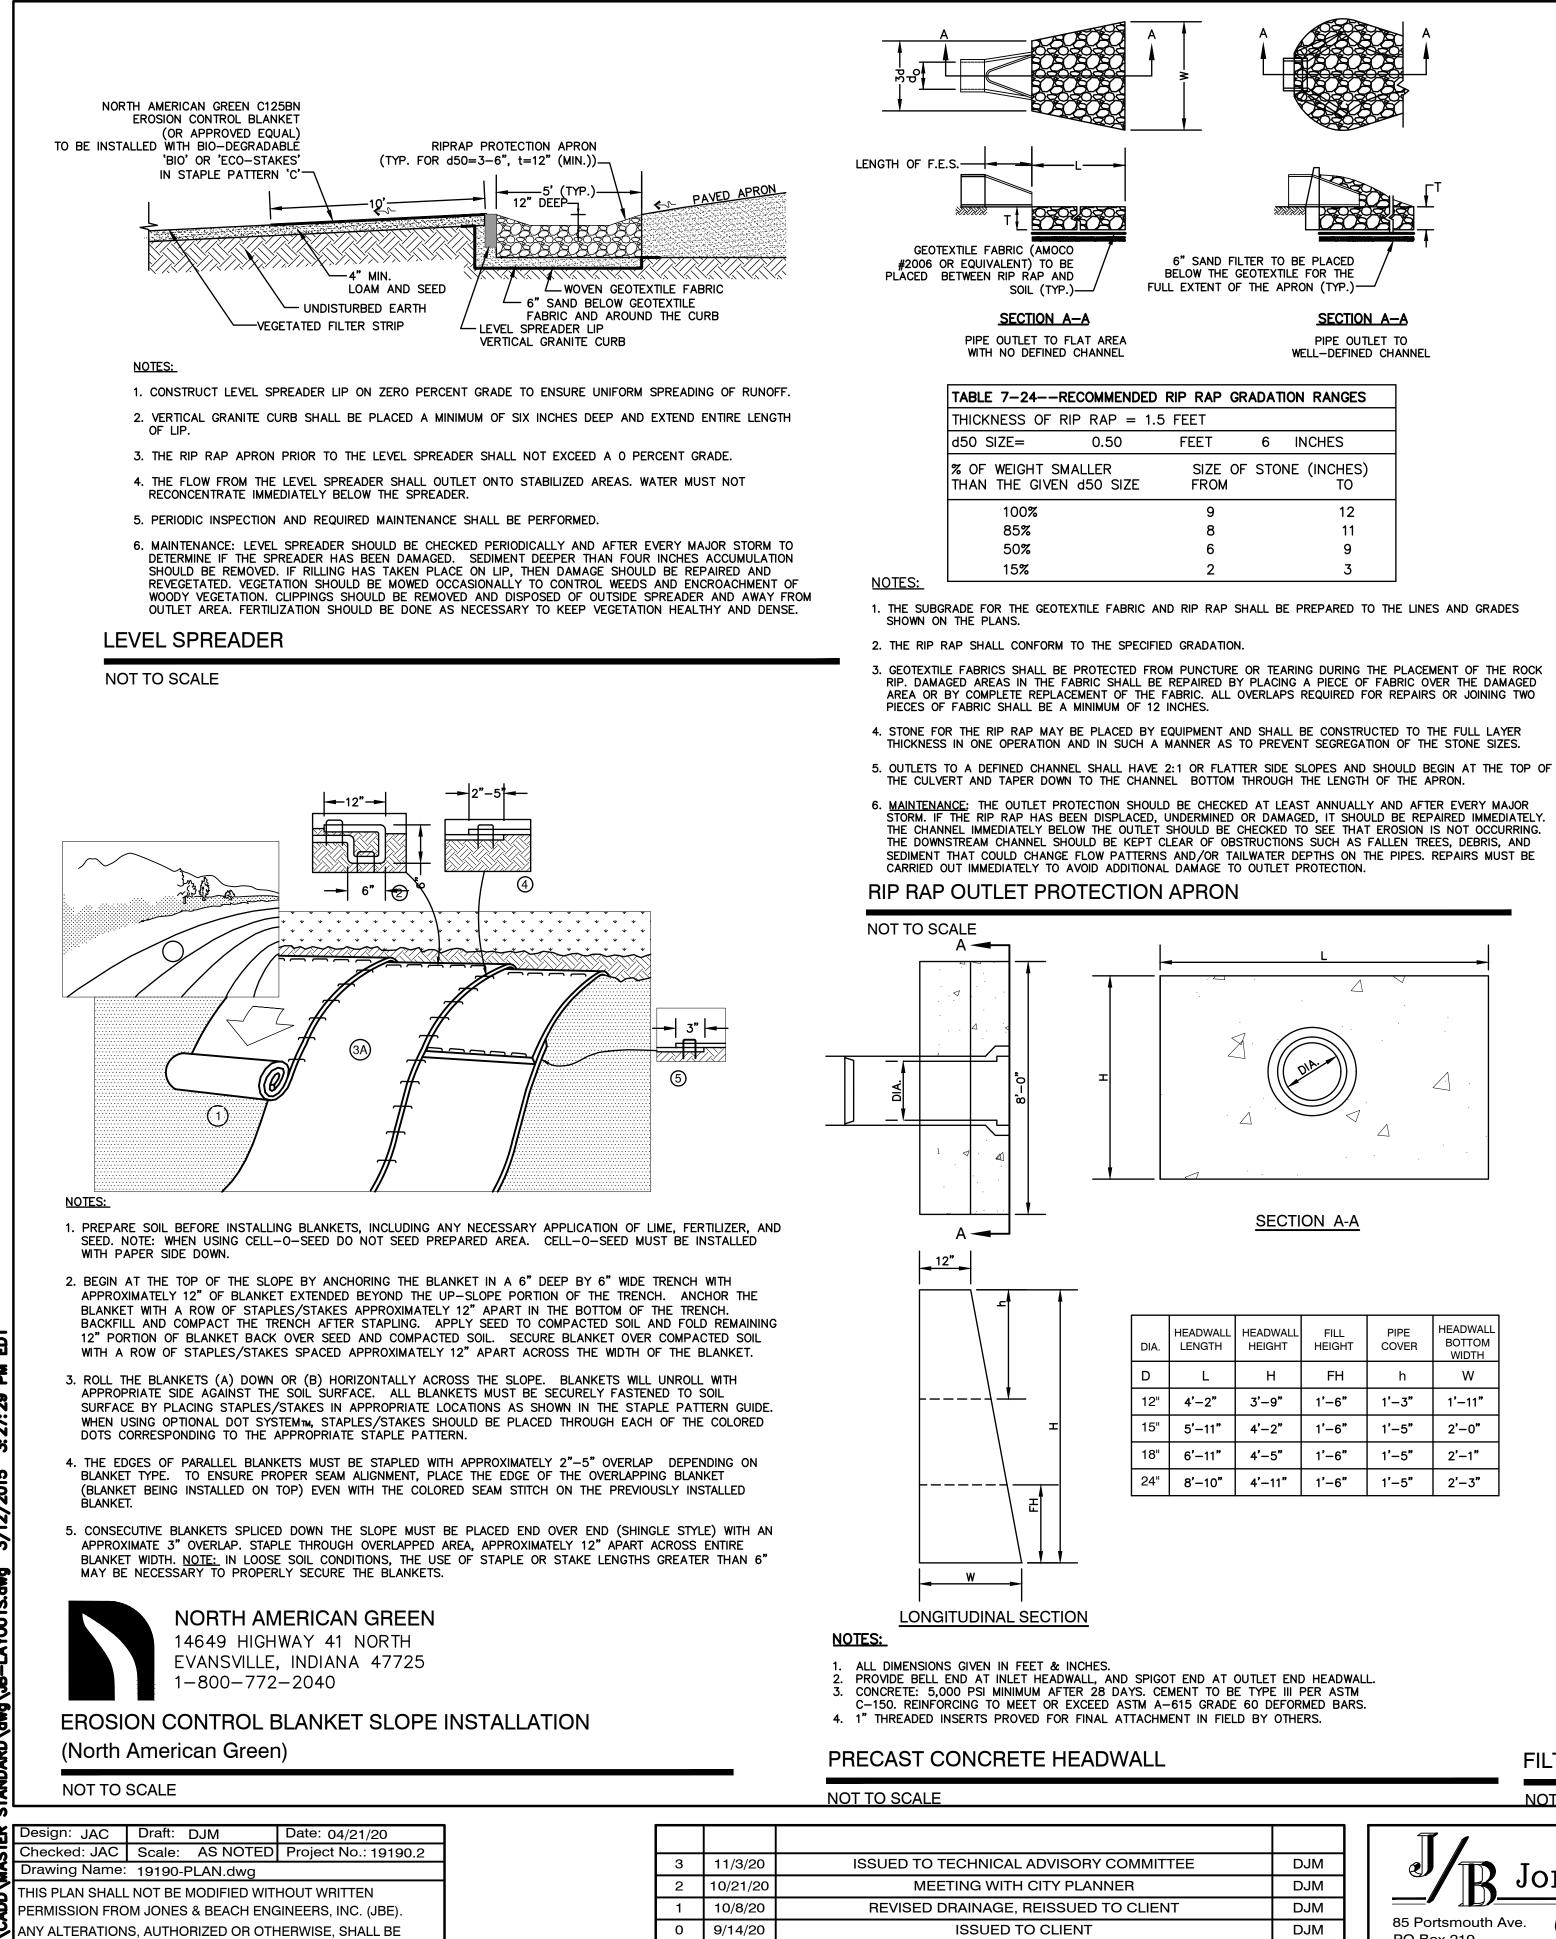

REV.

DATE

AT THE USER'S SOLE RISK AND WITHOUT LIABILITY TO JBE.

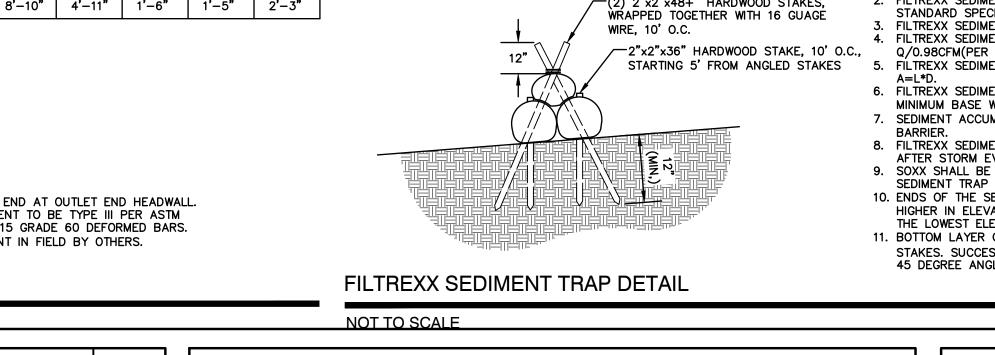

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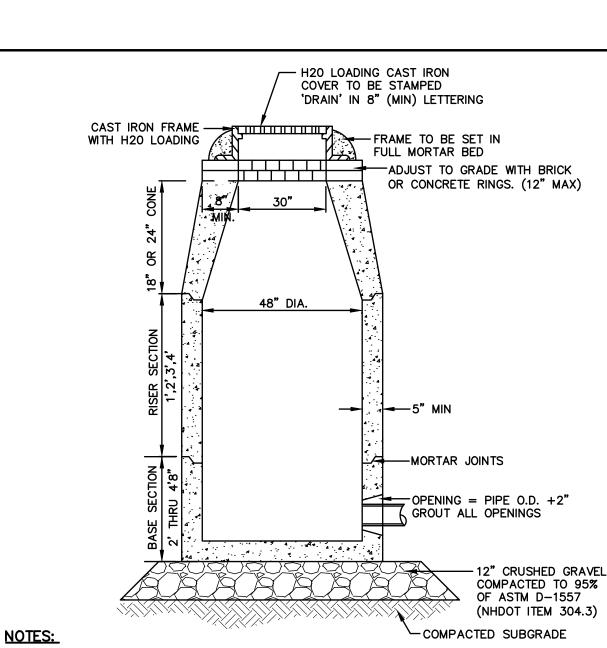
WALL			FILTREXX SEDIMENT TRAP DETAIL	
			NOT TO SCALE	
COMMITTEE	DJM		Designed and Produced in NH	Plan Name:
IER	DJM		🛛 🖉 🕂 🕅 Jones & Beach Engineers, Inc. 🛛	Duciest
O CLIENT	DJM		85 Portsmouth Ave. Civil Engineering Services 603-772-4746	Project: 3
	DJM	_	85 Portsmouth Ave. Civil Engineering Services PO Box 219 Stratham NH 03885 E-MAIL: JBE@JONESANDBEACH COM	Owner of Record:

ΒY

Stratham, NH 03885

DIA.	HEADWALL LENGTH	HEADWALL HEIGHT	FILL HEIGHT	PIPE COVER	HEADWALL BOTTOM WIDTH
D	L	Н	FH	h	w
12"	4'-2"	3'-9"	1'-6"	1'-3"	1'—11"
15"	5'—11"	4'-2"	1'-6"	1'-5"	2'-0"
18"	6'–11"	4'-5"	1'—6"	1'-5"	2'-1"
24"	8'–10"	4'-11"	1'-6"	1'–5"	2'-3"

MMENDED	RIP RAP G	RADAT	ION	RANGES	
RAP = 1.5	5 FEET				
0.50	FEET	6	IN	CHES	
ER 0 SIZE	SIZE OF FROM	- stoi	NE	(INCHES) TO	
	9			12	
	8			11	
	6			9	
	2			3	



1. BASE SECTION SHALL BE MONOLITHIC WITH 48" INSIDE DIAMETER.

3. CONCRETE SHALL BE COMPRESSIVE STRENGTH 4000 PSI, TYPE II CEMENT.

6. JOINT SEALANT BETWEEN PRECAST SECTIONS SHALL BE BUTYL RUBBER.

4. FRAMES AND GRATES SHALL BE HEAVY DUTY AND DESIGNED FOR H20 LOADING.

5. PROVIDE "V" KNOCKOUTS FOR PIPES WITH 2" MAX. CLEARANCE TO OUTSIDE OF PIPE. MORTAR ALL PIPE

7. ALL DRAIN MANHOLE FRAMES AND GRATES SHALL BE NHDOT TYPE MH-1, OR NEENAH R-1798 OR APPROVED

8. STANDARD FRAME(S) AND GRATE(S) SHALL BE SET IN FULL MORTAR BED. ADJUST TO GRADE WITH CLAY

BRICK AND MORTAR (2 BRICK COURSES TYPICALLY, 5 BRICK COURSES MAXIMUM, BUT NO MORE THAN 12"),

2. ALL SECTIONS SHALL BE DESIGNED FOR H20 LOADING.

CONNECTIONS SO AS TO BE WATERTIGHT.

EQUAL (30" DIA. TYPICAL).

DRAIN MANHOLE

NOT TO SCALE

\_\_\_\_


OR PRECAST CONCRETE 'DONUTS'.

## \_\_\_\_\_ 12" DIAMETER FILTREXX SOXX (ALSO AVAILABLE IN 8", 18", 24" AND 32" DIAMETERS) 1. FILTREXX SEDIMENT TRAP MUST BE INSTALLED BY FILTREXX CERTIFIED INSTALLER. 2. FILTREXX SEDIMENT TRAP MUST BE COMPLY WITH ALL FILTREXX (2) 2"x2"x48+" HARDWOOD STAKES. STANDARD SPECIFICATIONS. . FILTREXX SEDIMENT TRAP MUST USE FILTREXX FILTERMEDIA. 4. FILTREXX SEDIMENT TRAP BARRIER FACE SIZING SHALL USE Q/0.98CFM(PER SF OF AREA FACE) = A (Q=5L/SEC/SQ.M)STARTING 5' FROM ANGLED STAKES 5. FILTREXX SEDIMENT TRAP BARRIER FACE SHALL BE MEASURED AS 6. FILTREXX SEDIMENT TRAP SHALL BE CONSTRUCTED SO THAT THE MINIMUM BASE WIDTH IS EQUIVALENT TO THE HEIGHT (1H:1V). 7. SEDIMENT ACCUMULATION SHALL NOT EXCEED 1/2 THE HEIGHT OF THE 8. FILTREXX SEDIMENT TRAP SHALL BE INSPECTED AND MAINTAINED AFTER STORM EVENTS. 9. SOXX SHALL BE OF LARGER DIAMETER AT THE BASE OF THE

E-MAIL: JBE@JONESANDBEACH.COM


### SEDIMENT TRAP AND DECREASE IN DIAMETER FOR SUCCESSIVE LAYERS. 10. ENDS OF THE SEDIMENT TRAP SHALL BE A MINIMUM 1 FT (30 CM) HIGHER IN ELEVATION THAN THE MID-SECTION, WHICH SHALL BE AT THE LOWEST ELEVATION.

11. BOTTOM LAYER OF SOXX SHALL BE STAKED WITH 2X2X36" WOODEN STAKES. SUCCESSIVE LAYERS SHALL BE STAKED WITH  $\frac{1}{2}$ " REBAR AT A 45 DEGREE ANGLE.

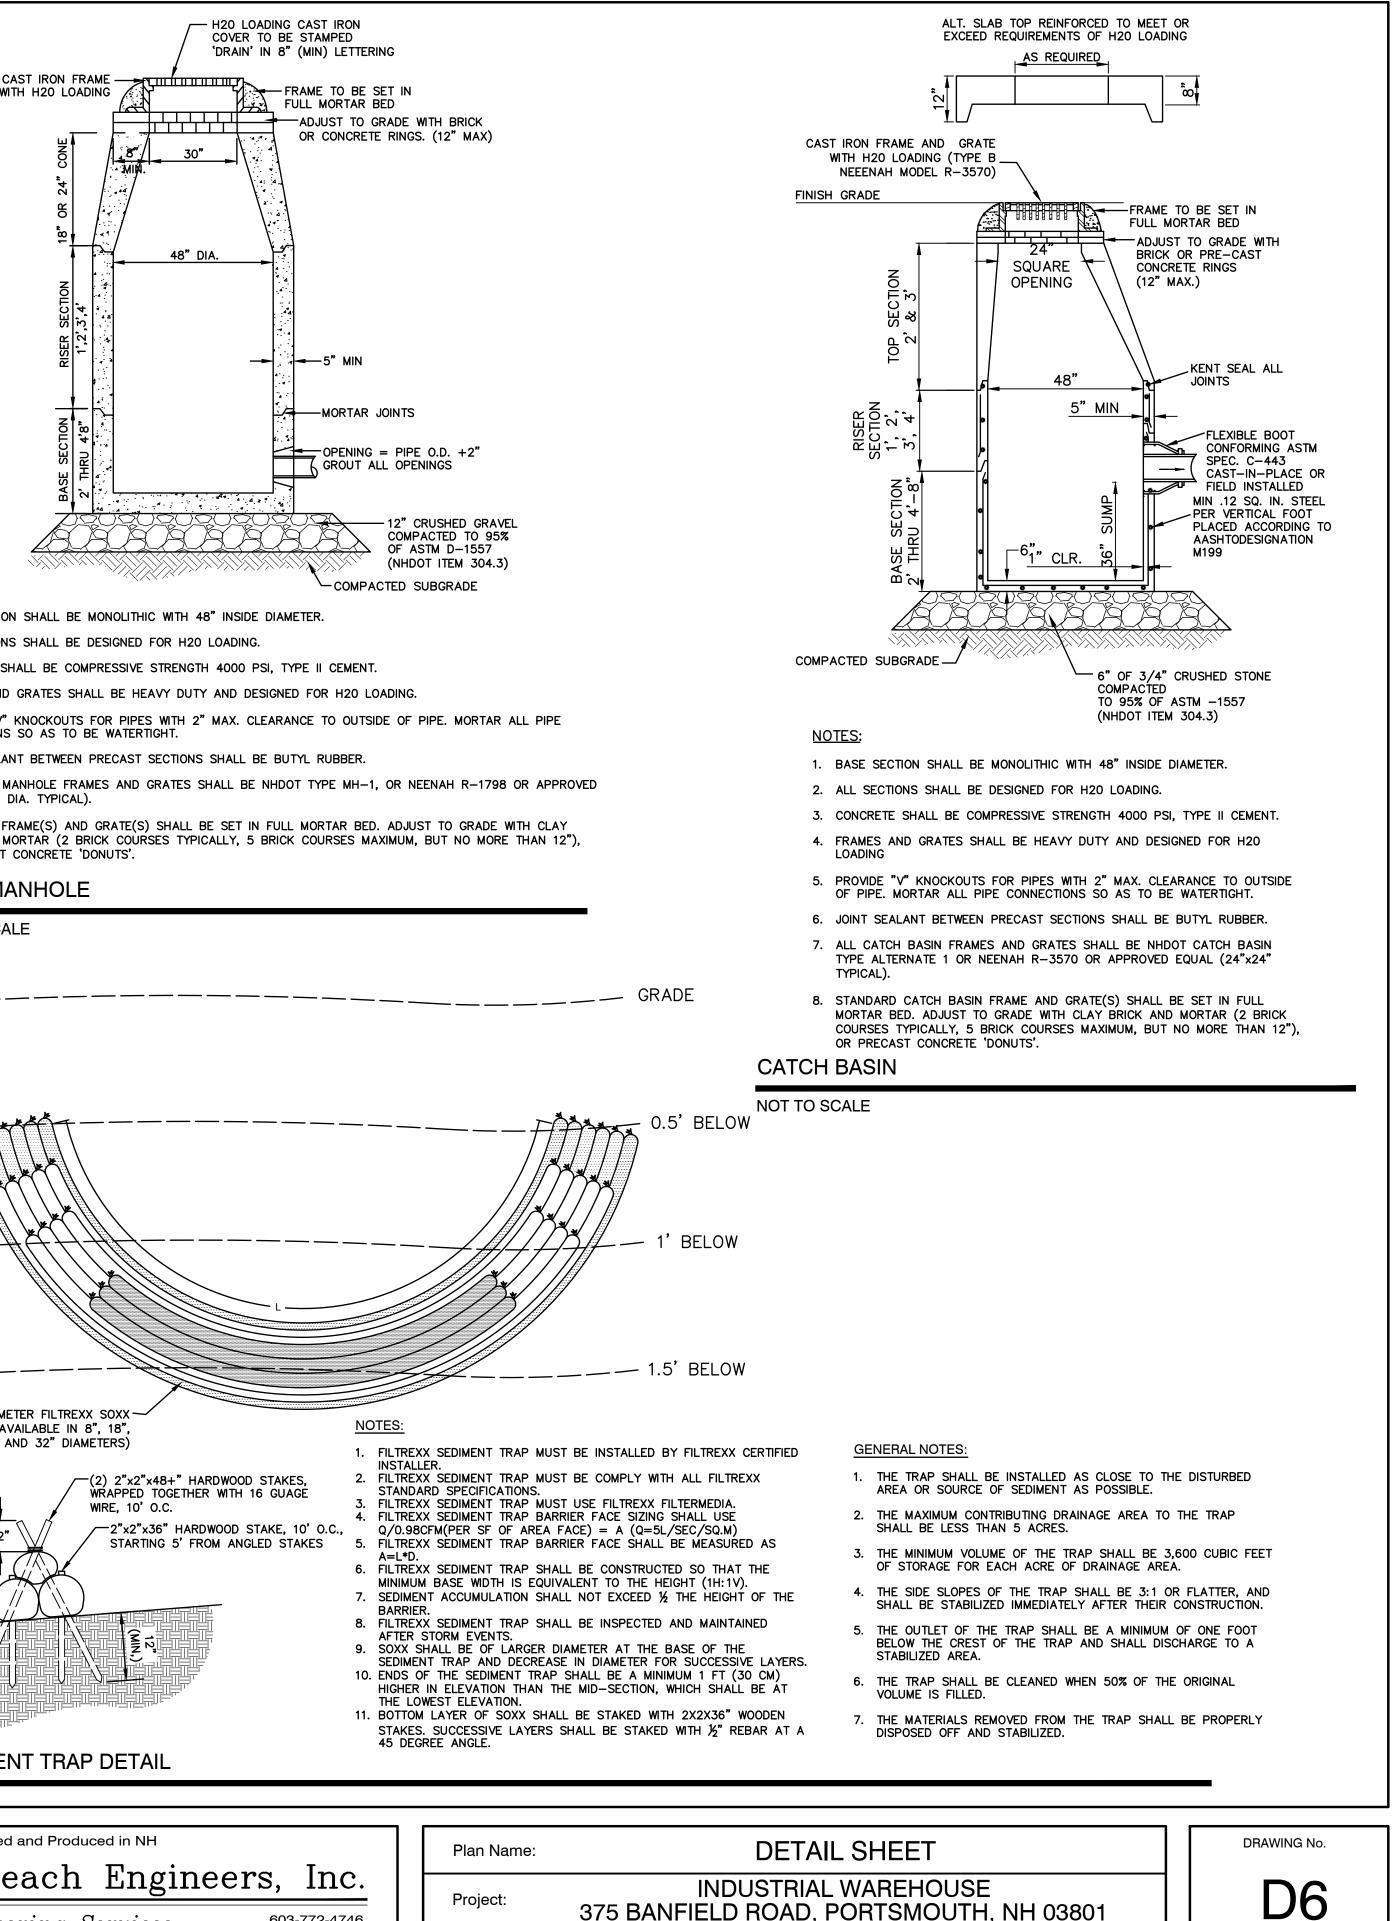

**BANFIELD REALTY LLC** 304 MAPLEWOOD AVENUE, PORTSMOUTH, NH 03801

SHEET 15 OF 16 JBE PROJECT NO. 19190.2

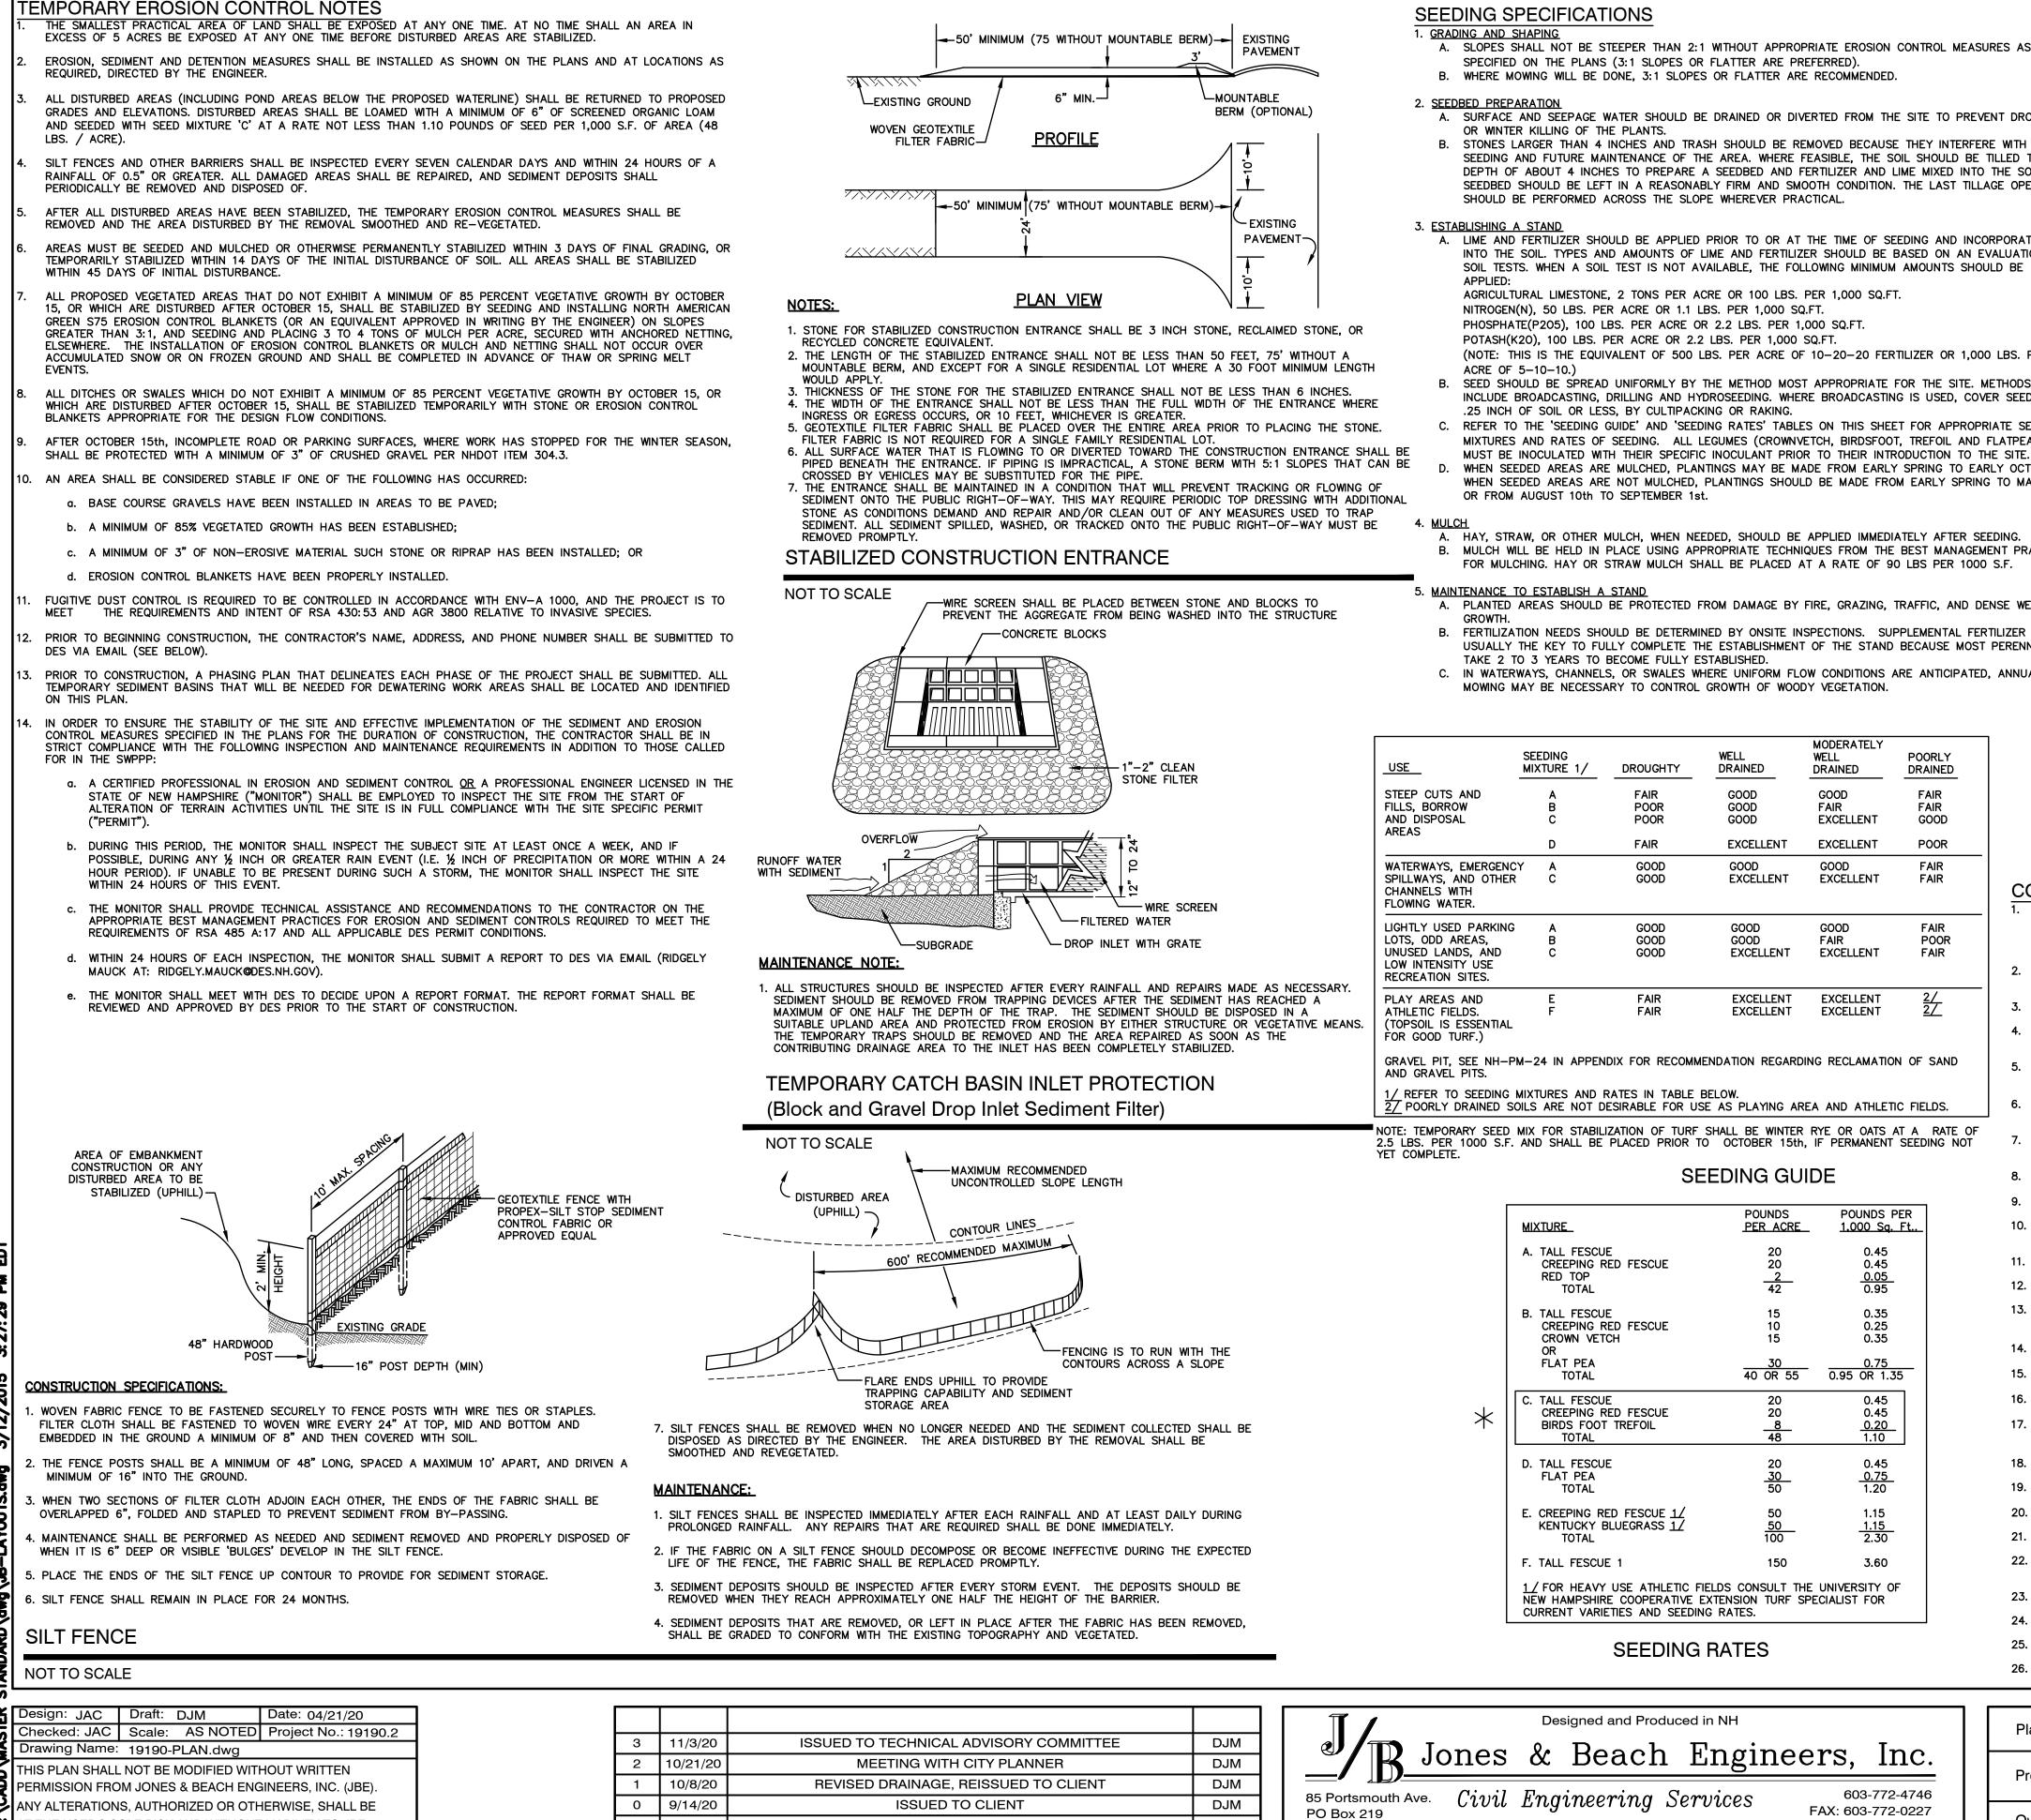

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Stratham, NH 03885

- A. SLOPES SHALL NOT BE STEEPER THAN 2:1 WITHOUT APPROPRIATE EROSION CONTROL MEASURES AS

- A. SURFACE AND SEEPAGE WATER SHOULD BE DRAINED OR DIVERTED FROM THE SITE TO PREVENT DROWNING
- SEEDING AND FUTURE MAINTENANCE OF THE AREA. WHERE FEASIBLE, THE SOIL SHOULD BE TILLED TO A DEPTH OF ABOUT 4 INCHES TO PREPARE A SEEDBED AND FERTILIZER AND LIME MIXED INTO THE SOIL. THE SEEDBED SHOULD BE LEFT IN A REASONABLY FIRM AND SMOOTH CONDITION. THE LAST TILLAGE OPERATION
- A. LIME AND FERTILIZER SHOULD BE APPLIED PRIOR TO OR AT THE TIME OF SEEDING AND INCORPORATED INTO THE SOIL. TYPES AND AMOUNTS OF LIME AND FERTILIZER SHOULD BE BASED ON AN EVALUATION OF SOIL TESTS. WHEN A SOIL TEST IS NOT AVAILABLE, THE FOLLOWING MINIMUM AMOUNTS SHOULD BE

- (NOTE: THIS IS THE EQUIVALENT OF 500 LBS. PER ACRE OF 10-20-20 FERTILIZER OR 1,000 LBS. PER
- B. SEED SHOULD BE SPREAD UNIFORMLY BY THE METHOD MOST APPROPRIATE FOR THE SITE. METHODS INCLUDE BROADCASTING, DRILLING AND HYDROSEEDING. WHERE BROADCASTING IS USED, COVER SEED WITH
- C. REFER TO THE 'SEEDING GUIDE' AND 'SEEDING RATES' TABLES ON THIS SHEET FOR APPROPRIATE SEED MIXTURES AND RATES OF SEEDING. ALL LEGUMES (CROWNVETCH, BIRDSFOOT, TREFOIL AND FLATPEA)
- MUST BE INOCULATED WITH THEIR SPECIFIC INOCULANT PRIOR TO THEIR INTRODUCTION TO THE SITE. WHEN SEEDED AREAS ARE MULCHED, PLANTINGS MAY BE MADE FROM EARLY SPRING TO EARLY OCTOBER. WHEN SEEDED AREAS ARE NOT MULCHED, PLANTINGS SHOULD BE MADE FROM EARLY SPRING TO MAY 20th

A. HAY, STRAW, OR OTHER MULCH, WHEN NEEDED, SHOULD BE APPLIED IMMEDIATELY AFTER SEEDING. B. MULCH WILL BE HELD IN PLACE USING APPROPRIATE TECHNIQUES FROM THE BEST MANAGEMENT PRACTICE

A. PLANTED AREAS SHOULD BE PROTECTED FROM DAMAGE BY FIRE, GRAZING, TRAFFIC, AND DENSE WEED


- B. FERTILIZATION NEEDS SHOULD BE DETERMINED BY ONSITE INSPECTIONS. SUPPLEMENTAL FERTILIZER IS USUALLY THE KEY TO FULLY COMPLETE THE ESTABLISHMENT OF THE STAND BECAUSE MOST PERENNIALS
- C. IN WATERWAYS, CHANNELS, OR SWALES WHERE UNIFORM FLOW CONDITIONS ARE ANTICIPATED, ANNUAL

1"-2" CLEAN STONE FILTER	USE	SEEDING MIXTURE 1/	DROUGHTY	WELL DRAINED	MODERATELY WELL DRAINED	POORLY DRAINED		
	STEEP CUTS AND FILLS, BORROW AND DISPOSAL AREAS	A B C	FAIR POOR POOR	GOOD GOOD GOOD	GOOD FAIR EXCELLENT	FAIR FAIR GOOD		
		D	FAIR	EXCELLENT	EXCELLENT	POOR		
	WATERWAYS, EMERGENC SPILLWAYS, AND OTHER CHANNELS WITH FLOWING WATER.		GOOD GOOD	GOOD EXCELLENT	GOOD EXCELLENT	FAIR FAIR	<u>C(</u> 1.	ONSTRI PRIOR TO
FILTERED WATER	LIGHTLY USED PARKING LOTS, ODD AREAS, UNUSED LANDS, AND LOW INTENSITY USE RECREATION SITES.	A B C	GOOD GOOD GOOD	GOOD GOOD EXCELLENT	GOOD FAIR EXCELLENT	FAIR POOR FAIR	2.	FORM WIT DISCHARG CONSTRUC WETLAND
TER EVERY RAINFALL AND REPAIRS MADE AS NECESSARY. PING DEVICES AFTER THE SEDIMENT HAS REACHED A TRAP. THE SEDIMENT SHOULD BE DISPOSED IN A COM EROSION BY EITHER STRUCTURE OR VEGETATIVE MEANS. D AND THE AREA REPAIRED AS SOON AS THE T HAS BEEN COMPLETELY STABILIZED.	PLAY AREAS AND ATHLETIC FIELDS. (TOPSOIL IS ESSENTIAL FOR GOOD TURF.)	E F	FAIR FAIR	EXCELLENT EXCELLENT	EXCELLENT EXCELLENT	<u>2/</u> 2/	3. 4.	IN PLACE CUT AND INSTALL S THE FINA
	GRAVEL PIT, SEE NH-PI AND GRAVEL PITS.	M-24 IN APPEN	DIX FOR RECOMM	IENDATION REGARE	DING RECLAMATIC	N OF SAND	5.	CLEAR, C ETC.
INLET PROTECTION	1/ REFER TO SEEDING N						e	CONSTRU
Sediment Filter)	2     POORLY DRAINED SC       NOTE:     TEMPORARY SEED						6.	INSTALLEI
	2.5 LBS. PER 1000 S.F. YET COMPLETE.						7.	STRIP LO STOCKPIL
			SI	FDING GU	IIDF		8.	PERFORM

4.	INSTALL SILT FENCING, THE FINAL PAVEMENT S
5.	CLEAR, CUT, GRUB AND ETC.
6.	CONSTRUCT AND/OR IN INSTALLED AND STABILI
7.	STRIP LOAM AND PAVE STOCKPILE EXCESS MAT
8.	PERFORM PRELIMINARY
9.	PREPARE BUILDING PAD
10.	INSTALL THE SEWER AN BETWEEN UTILITIES ARE
11.	INSTALL INLET PROTECT
12.	ALL SWALES AND DRAIN
13.	DAILY, OR AS REQUIRED SITE AND PREVENT ANY
14.	PERFORM FINAL FINE G
15.	PAVE ALL PARKING LOT
16.	PERFORM ALL REMAININ
17.	LOAM AND SEED ALL D BLANKETS, ETC.).
18.	FINISH PAVING ALL ROA
19.	ALL ROADWAYS AND PA
20.	ALL CUT AND FILL SLOP
21.	COMPLETE PERMANENT
22.	REMOVE TEMPORARY ER COMPLETE. SMOOTH AN
23.	CLEAN SITE AND ALL D
24.	INSTALL ALL PAINTED P
25.	ALL EROSION CONTROLS
26.	UPON COMPLETION OF CONSTRUCTION HAS BE

Plan Name:	ERO
Project:	375
Owner of Rec	ord:

E-MAIL: JBE@JONESANDBEACH.COM

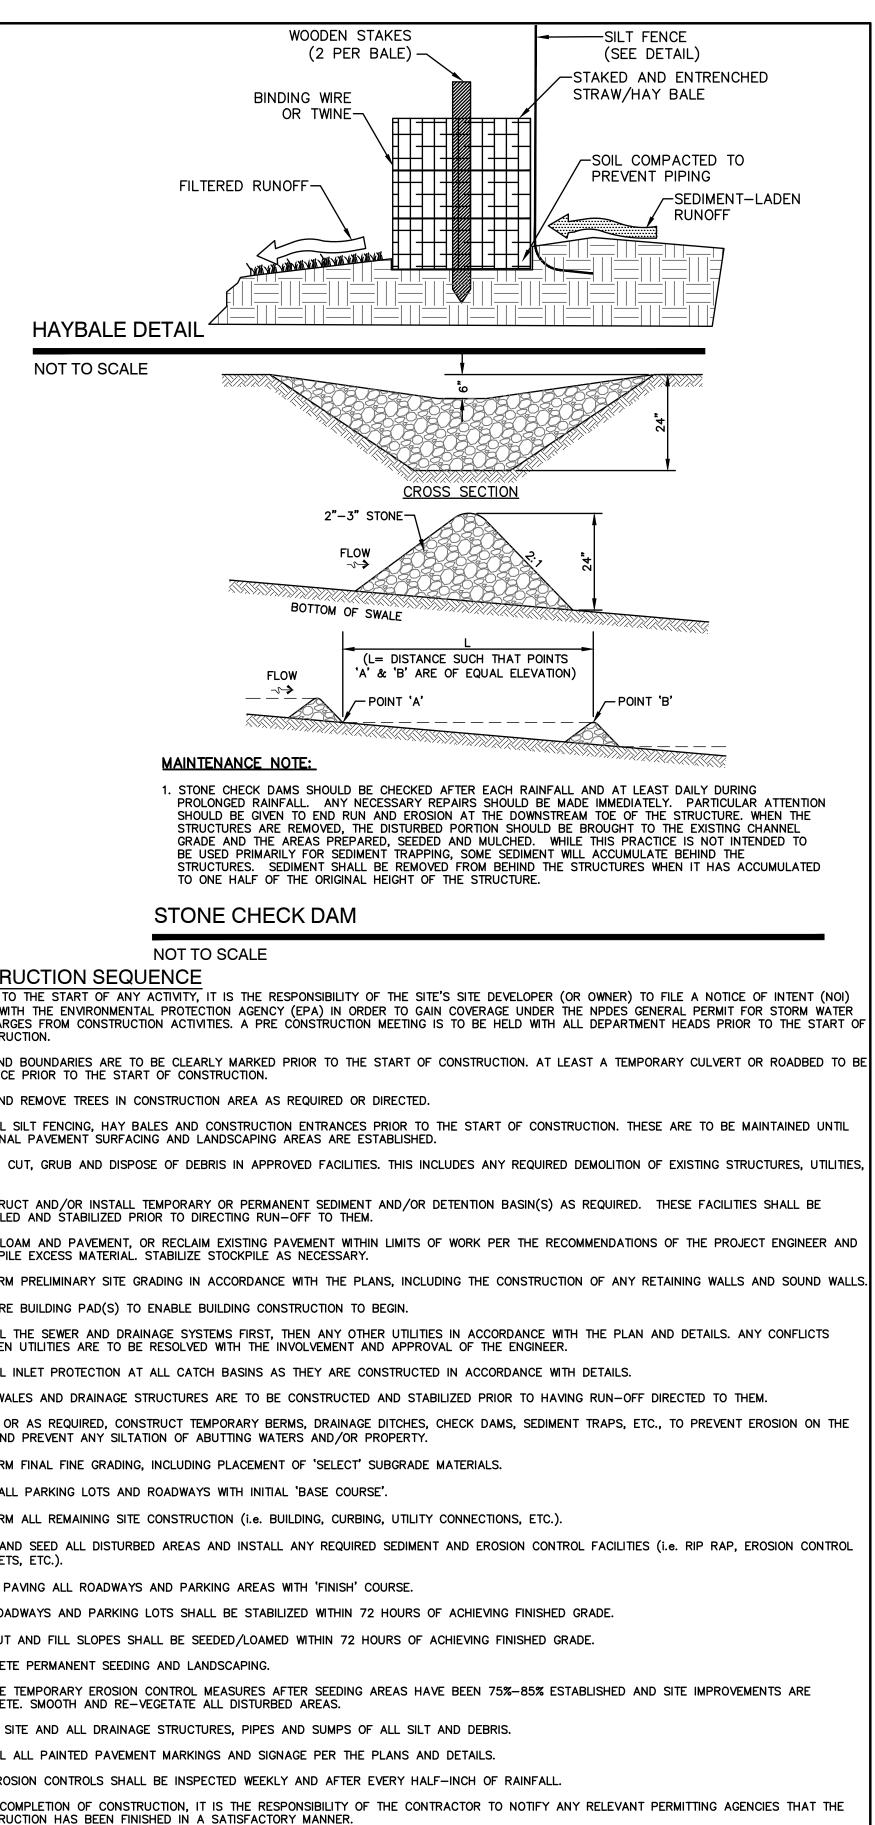

## SION AND SEDIMENT CONTROL DETAILS

INDUSTRIAL WAREHOUSE BANFIELD ROAD, PORTSMOUTH, NH 03801 BANFIELD REALTY LLC 304 MAPLEWOOD AVENUE, PORTSMOUTH, NH 03801

DRAWING No. **SHEET 16 OF 16** 

JBE PROJECT NO. 19190.2