Date: 9/11/19

Profile Homes NH 953 Islington St, Unit 22C Portsmouth, NH 03801 603-433-2464

RECEIVED

SEP 16 2019

City of Portsmouth Historical District Commission

RE: 202 Court St Request for public hearing

BY:_____

Dear Members of the Historical District Commission,

Please see the attached request for public hearing for the October 2nd meeting for 202 Court St and attached plans, and specification description.

We appreciate the opportunity we have had for discussion related to this property so far and have worked to incorporate all the ideas and feedback we have received from the board.

Thank you,

Matt Silva Profile Homes of NH Attached is the description for these documents which relative to the exterior improvements which include:

New Widows
Solar Panels
New siding/trim
New Garage Doors
Railings of the building
New Front Façade
Fencing for shielding of the utilities and disposal areas

Introduction:

The property is located in the CD4-L1 zoning district within downtown. It is commonly known as the Wright Baker Auto Garage for the last 90 years, but for many others, the original Portsmouth Fire station prior to the current Portsmouth fire station built in 1920.

The proposed improvements to the site consist of converting the building from an existing auto mechanic garage with approved residential living above and into a 3 family condominium. Upon complete review of the plans in order to work within the restrictions of the variance relief we have received we are working to begin construction with improvement to revive the history of this structure.

SPECIFICATIONS:

<u>Windows:</u> The existing widows of the structure have been damaged or left without repair. While original to the building these windows do not appear to hold a significant amount of character to the details of the building. The tradition aspects of wavy glass seen from this time period are not available for these.

With the advice of the board our company has elected to purchase Green Mountain Windows for there historical character aspects and details throughout the building and rebuild the windows with full size trim and sils as seen in the original time period of the building

Solar Panels: Our company has a long standing history of energy efficient improvements to historical and new construction buildings. In the method of the energy efficiency improvements to the air sealing and added insulation to the building we are seeking to allow owners of the building the rights to install solar panels on the southern side of the building. All panels will be a "full black Panel" with not aluminum edging shown.

Siding: The original wood siding of the building has been covered over with a aluminum siding which is in complete disrepair. We have elected to strip all layers of siding off the building. Installed a weather air barrier (WRB) against new sheathing of the building. Provide an added layer of exterior insulation and install new wood Clapboards to be painted on the structure.

Trim details will be done in wood to match the existing or original on the structure and from the

historical photo's made available.

Garage Doors: The existing garage doors will be replaced with new garage doors similar to the fire station located next door. Above the doors we will locate the names of the previous fire equipment on the front of the building and above the rear unit garage doors. These include The Kearsarge, The Sampson and The Dearborn.

Lighting on the exterior of the building will be located above these doors and traditional to the age of the structure.

Front Façade and Shielding:

We will be removing the brick façade on the building now and re establishing the original look of the building with a enhanced corner board


The utility Shielding will be natural wood custom fencing


Metal Railings will be a standard all black posts and top rail.

Please note all photo's attached for representation and discussion

Thank you,

Matt Silva Profile Homes

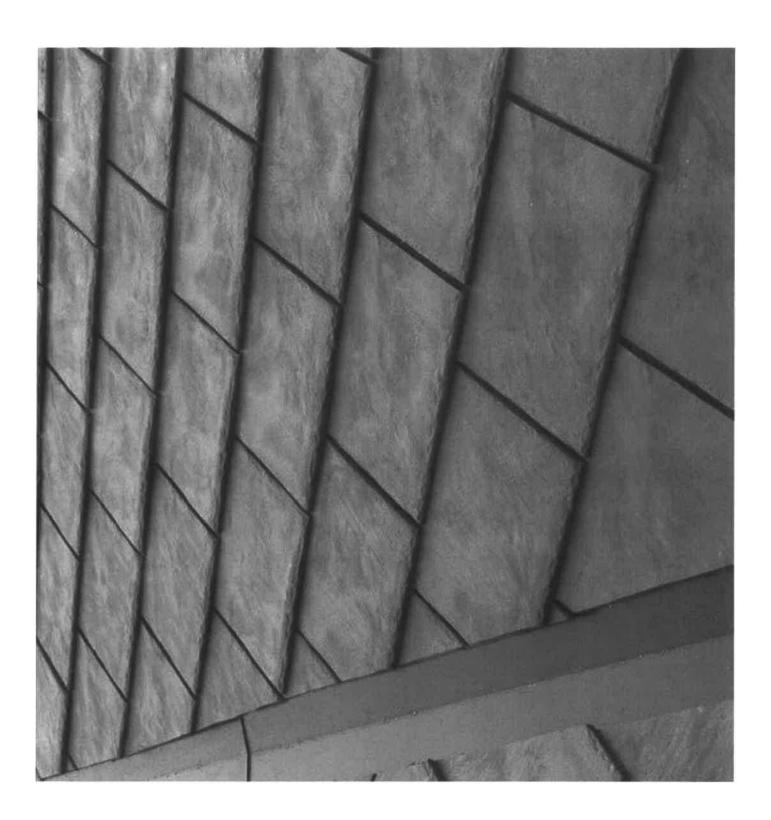

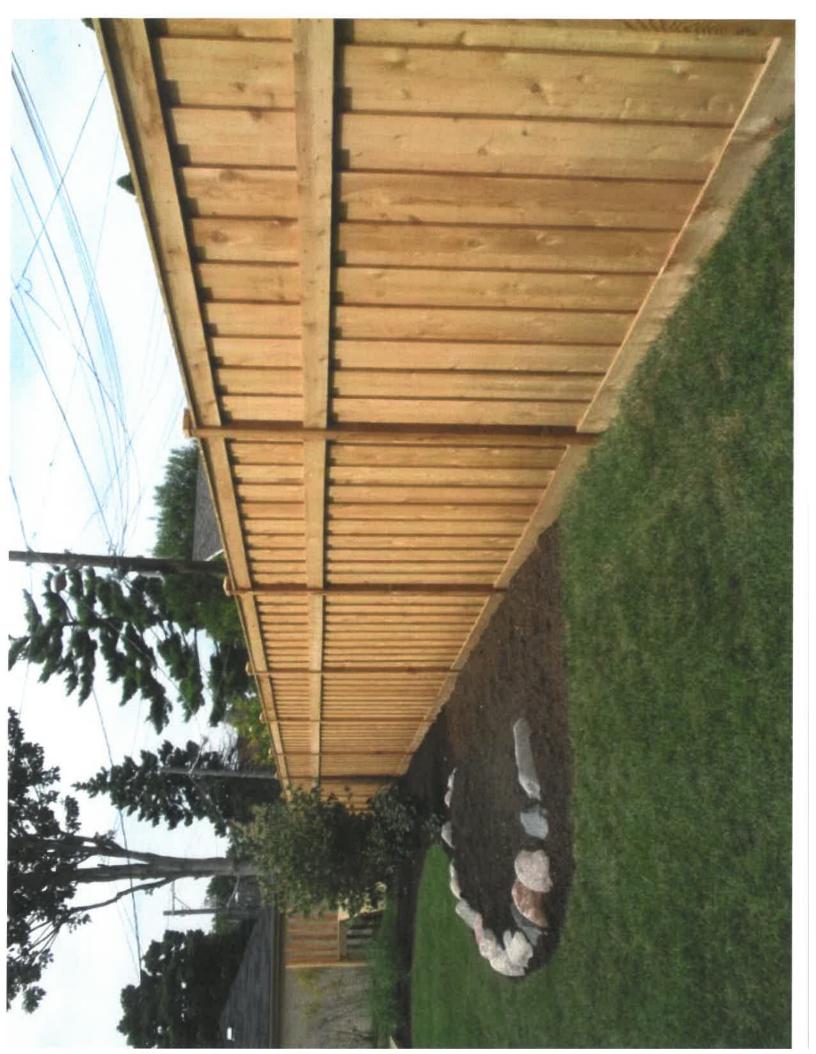












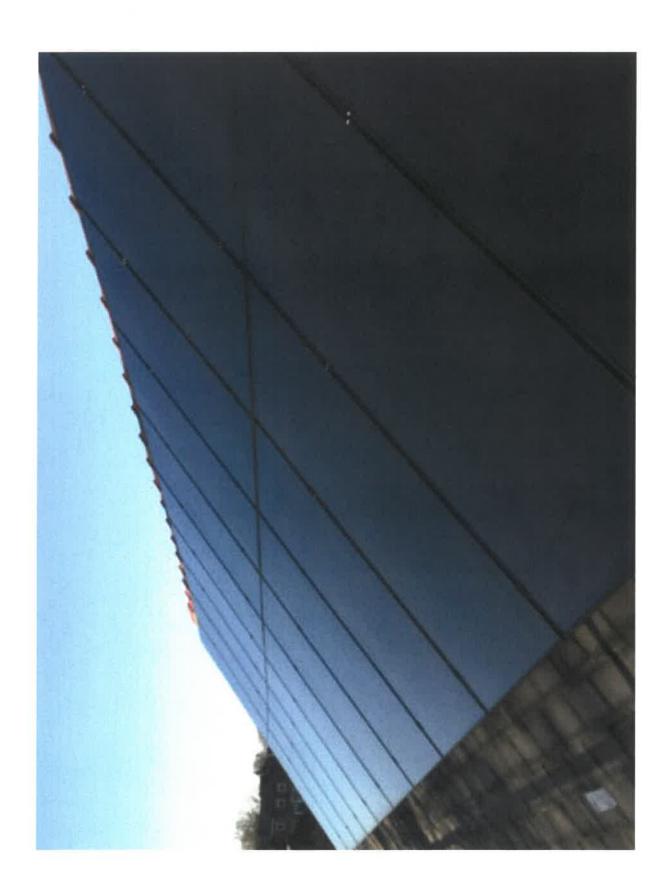

Green Mountain Window Company 92 Park Street

Rutland, VT 05701 Phone: (802) 747-6915 Fax: (802) 747-7864



To: ZZZNH MISC RETAIL - NH

Ship To: Profile Homes

05701

Quote Quo #: 038882

Route: NONE Page: 1 of 1

Quote: 06/25/19 Scheduled To Ship By Date: 06/26/19

Printed Date: 06/25/19 Time: 10:25 AM

| FOB: DLVD | Entd By: FRAN | Via: OUR TRUCK | Contact: Matt Silv |
|--|---------------|----------------|-----------------------|
| Type: WHSE In: 03 / Out: 03 Terms: COD | | Terms: COD | Your Order: MDH Quote |
| | | | Customer Instructions |

| _ine # | Item Number | Description | Quantity | U/M | List / Discount | Net Extended |
|---------|------------------|--|----------|-----|--------------------|-----------------|
| 0001,00 | *038882001.00 | DH Mile-1w (RO=2'8-5/16" x 4'5-3/8") 26X22. Pine, Primed Exterior, Beige Weatherstrip, Primed Interior, 5/4X6 No FJ Casing, 1/2" Glass, Wood Glazing Bead, Low-E w/ Krypton, 4 9/16 Jamb, White Lock, White Tilt Latch, 2/2, 5/8" SDL w/ Gray Pencil Bar, Historic Sill Nose No FJ | 1.00 | EA | 709.92 | 709.92 |
| 010 | SCREEN2622 | Screen 26x22 Standard | 1.00 | EA | | |
| 0002.00 | SOWNDWCUSTOM-GMW | Per Unit Painted Exterior Upcharge; Sashes; SDL; Casings: | 1.00 | EA | 232.56 | 232.56 |

Merchandise ...: 942.48 Tax.... 0.00 Misc Charges..: 0.00 Quote Total ...: 942.48



FIREHOUSE CONDOS

PROFILE
HOMES
NE-2580 EXERTY BUILDING
WY April friedwish LERN
WHO SERVED THE SERVED THE

202 COURT ST., PORTSMOUTH, NEW HAMPSHIRE

DRAWING INDEX

ADDITION/ REMODEL

ARCHITECTURAL:

TITLE SHEET
AB-1.0 EXISTING 1ST FLOOR PLAN
AB-1.1 EXISTING 2ND FLOOR PLAN
AB-2.0 EXISTING ELEVATIONS
AB-2.1 EXISTING ELEVATIONS
A-1.0 FIRST FLOOR PLAN
A-1.1 SECOND FLOOR PLAN

A-1.2 THIRD FLOOR PLAN A-2.0 ELEVATIONS

A-2.1 ELEVATIONS



CONSULTANTS

ARCHITECTURAL DESIGNER: JEREMY SHEAFF PH: 603-793-8431

STRUCTURAL ENGINEER: ATTAR ENGINEERING LEW CHAMBERLAIN PH: 207-439-6023

RECEIVED


SEP 16 2019

BY:____



NET-ZERO ENERGY BUILDING www.profilehomesnh.com Ph: 603-765-6648

ISSUED FOR DESIGN#4 MAY 30, 2019

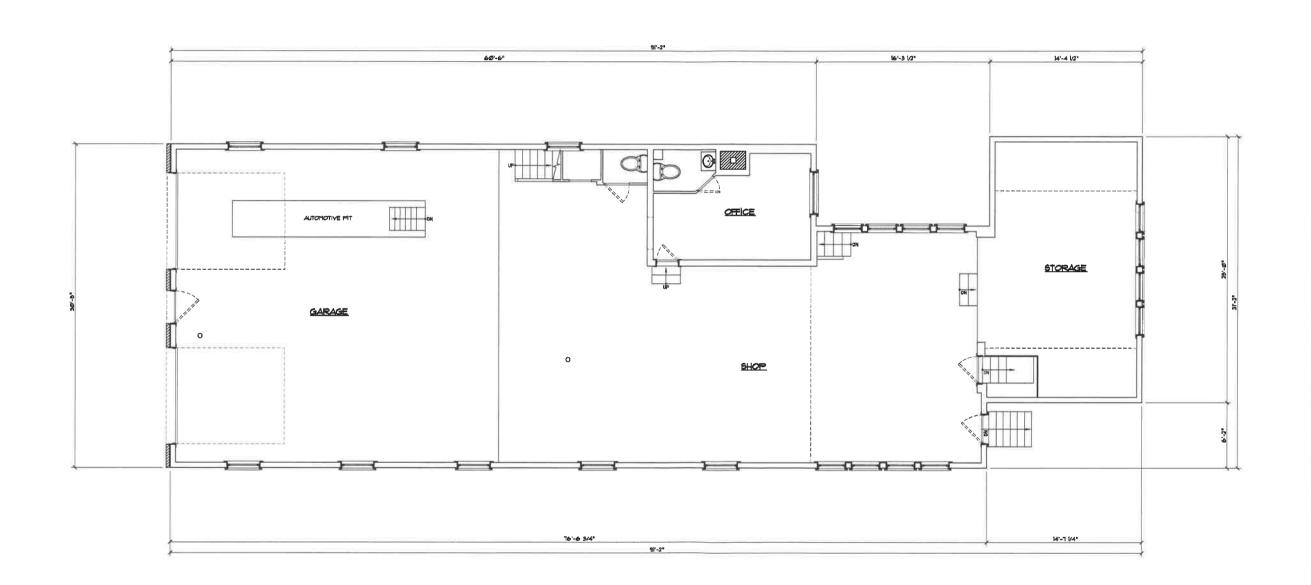

1 FIRST FLOOR PLAN

PROFILE HOMES NET-ZERG ENERGY BUILDING www.profilehomesnih.com Ph: 603-765-6618

FIREHOUSE CONDOS

ISSUED DATES & REVISIONS:

ISSUED FOR DESIGN #1 MARCH 13, 2019 ISSUED FOR DESIGN #2 APRIL 10, 2019

ISSUED FOR DESIGN #3 APRIL 25, 2019

ISSUED FOR DESIGN #4 MAY 30, 2019

GENERAL NOTES:
General Contractor shall make all flubountractors and simplified where of the requirements of these notes.

REGISTRATION:



EXISTING FIRST FLOOR PLAN


| JOB NUMBER: | N/A |
|-------------|---------------|
| DRAWN BY: | Jeremy Sheaff |
| CHECKED BY: | Matt Silva |
| SCALE: | As Noted |

AB-1.0

SQUARE FOOT NOTES:

L FIRST FLOOR 2. SECOND FLOOR - 2,569 8F - 2,083 8F EXISTING TOTAL AREA = 4,652 SF

DRAWING SCALE: 1/4" = 1'-0"

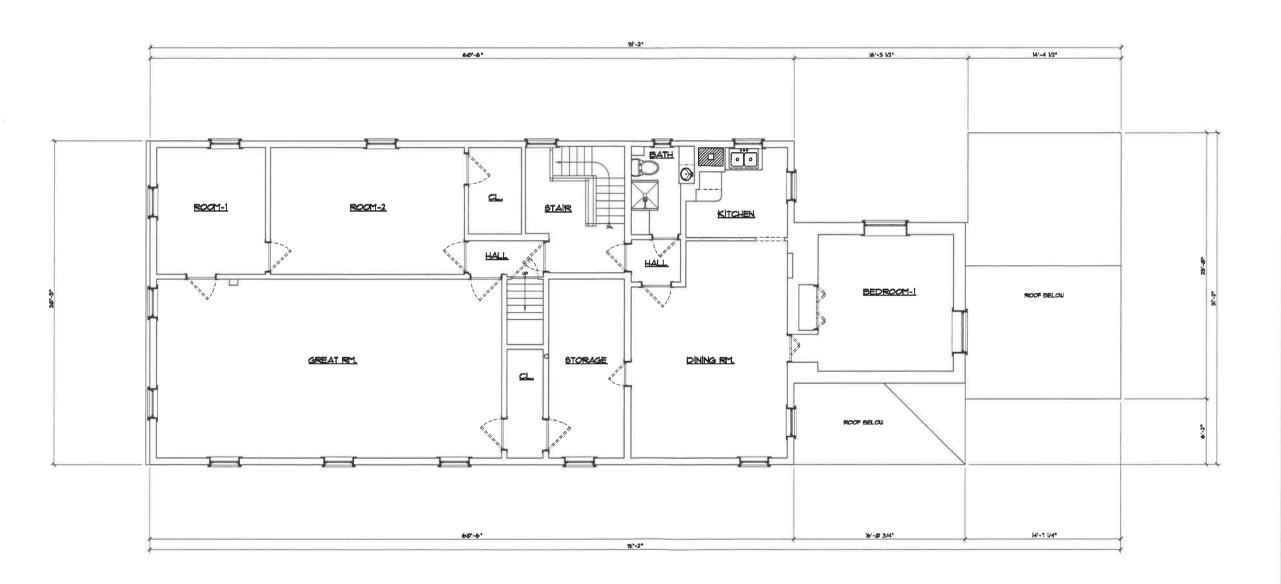



FIREHOUSE CONDOS

ISSUED DATES & REVISIONS:

ISSUED FOR DESIGN #1 MARCH 13, 2019 ISSUED FOR DESIGN #2 APRIL 10, 2019 ISSUED FOR DESIGN #3 APRIL 25, 2019

ISSUED FOR DESIGN #4 MAY 30, 2019

GENERAL NOTES:

General Contractor shall make all flubomirectors and suppliers aware of the requirements of these notes.

All work shall be performed in compliance with applicable Local, State and Sational Building, Li Safety and Electrical codes.

General Contractors shall be responsible for securing all permits as necessary for the examplation of work shown throughout the Contrac Tommerts.

before constructing any part, and shall varify a existing conditions and locations before proceed follows to write dimensions and conditions being

the required removal of completed work at Genera Contractor Cost. If a discrepancy which could have been discovered cause modifications to the plans.

trudes.

mency of specialty is to be position out to Prof. Romes immediately.

phone. Profile Homes asymmet no responsibility to use of incorrect steals.

edited, denoral Contractor shall provide paid the it is measured for the proper hestallation or notion of an New shown or specified, furpillers of fubcontractors shall inform the General

. ...

Frontile Romesi, expressibly resizers the Common Lat Copyrights and other Property Eights in these plans. These drawings are the property of Frontis Romesi, and shall not be reproduced in any manner, nor are they to be springed in any manner, without first obtaining the expressed

REGISTRATION:




EXISTING SECOND FLOOR PLAN


| ISSUE DATE: | 5/30/19 |
|-------------|---------------|
| JOB NUMBER: | N/A |
| DRAWN BY: | Jeremy Sheaff |
| CHECKED BY: | Matt Silva |
| SCALE: | As Noted |


AB-1.1

1 SECOND FLOOR PLAN

DRAWING SCALE: 1/4" = 1'-0"

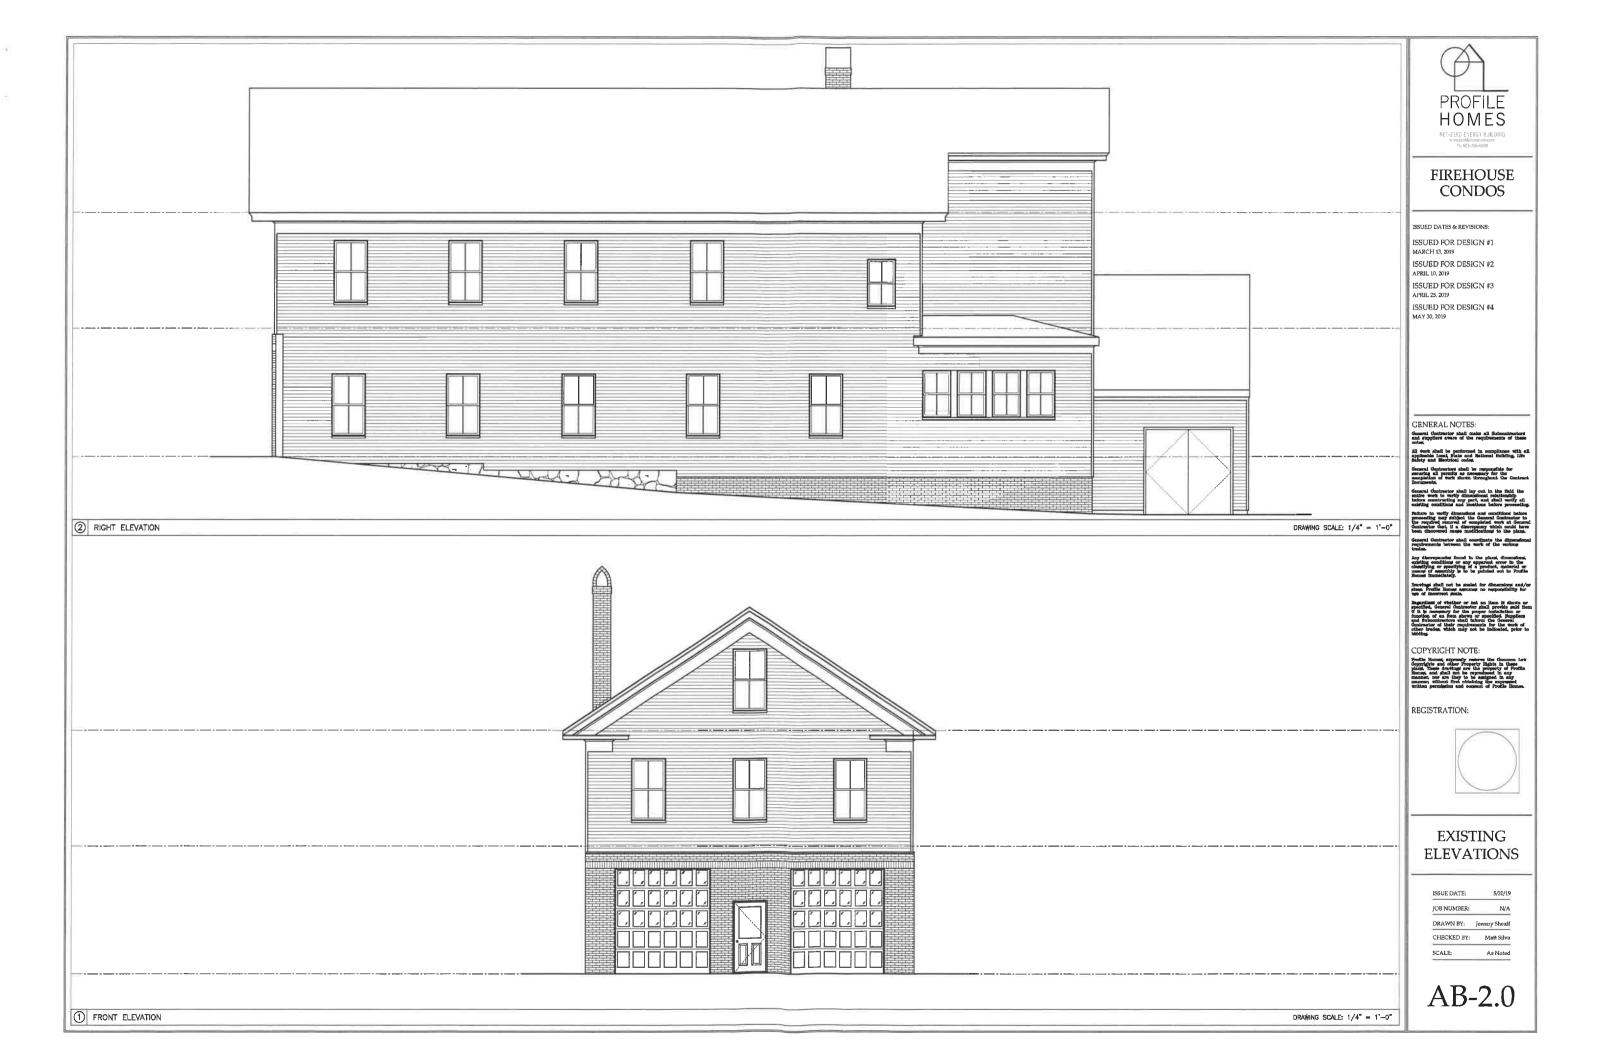

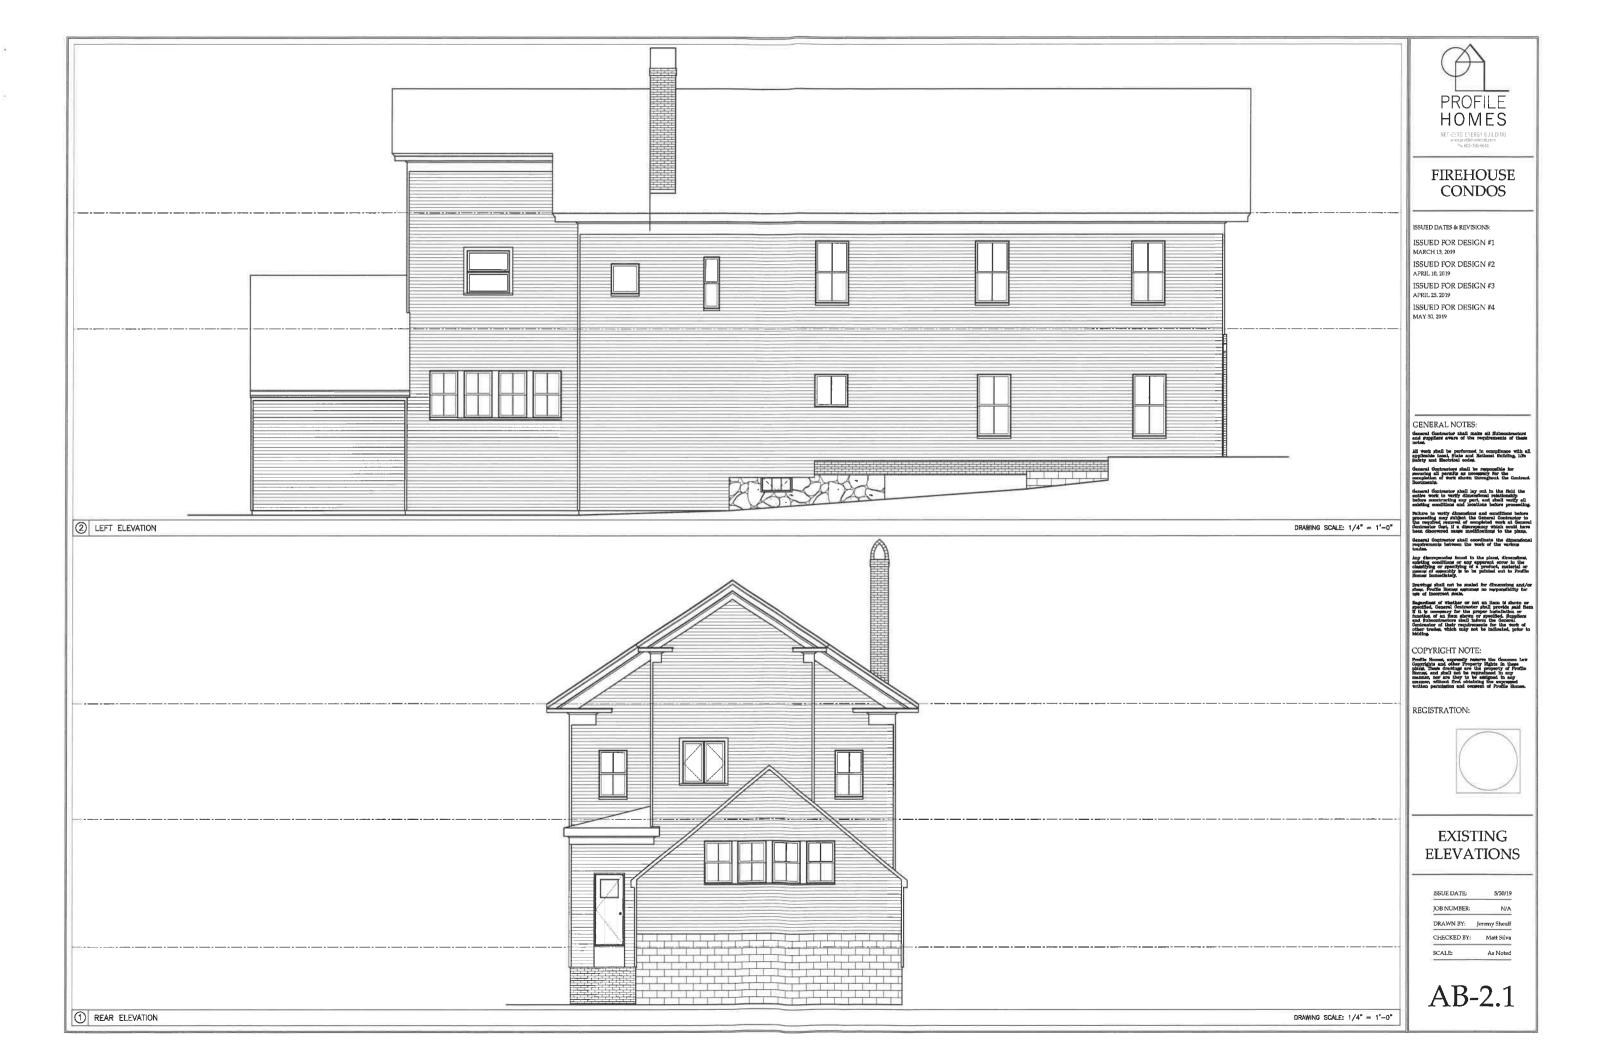

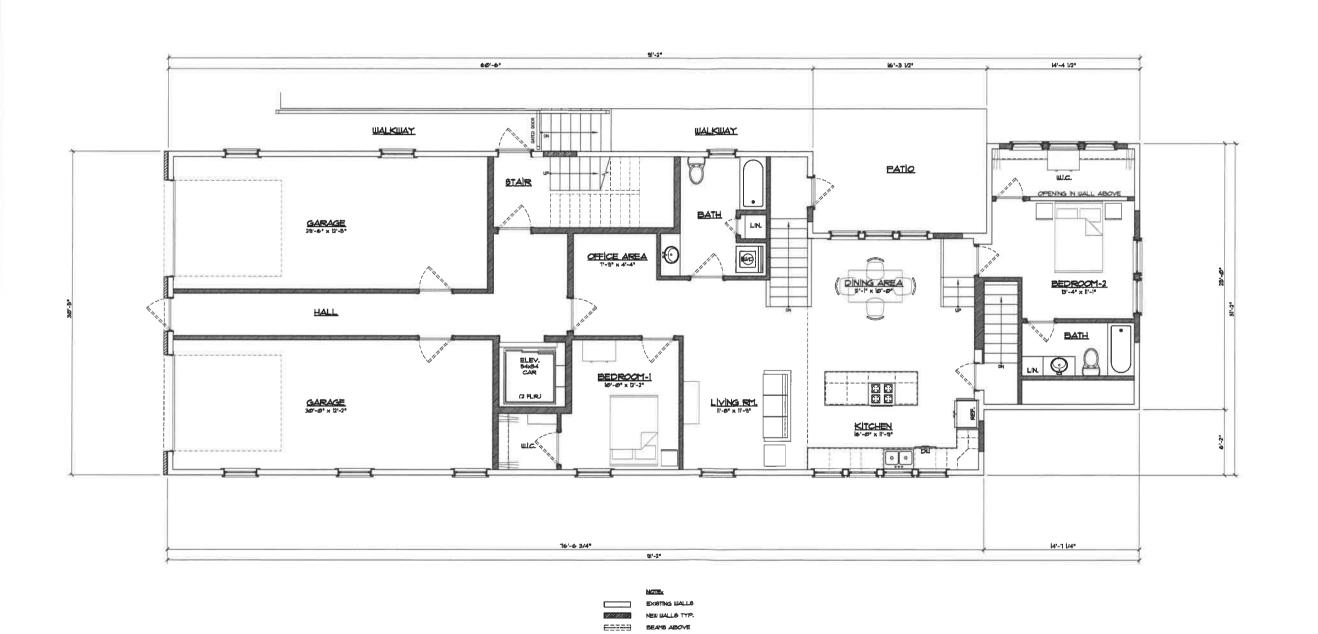



FIREHOUSE **CONDOS**

ISSUED DATES & REVISIONS:

ISSUED FOR DESIGN #1 MARCH 13, 2019

ISSUED FOR DESIGN #2 APRIL 10, 2019

ISSUED FOR DESIGN #3 APRIL 25, 2019 ISSUED FOR DESIGN #4 MAY 30, 2019

GENERAL NOTES:

General Contractor shall make all Subsentractors and suppliers overs of the requirements of these notes.

COPYRIGHT NOTE:

REGISTRATION:



FIRST FLOOR PLAN

ISSUE DATE: 5/30/19 JOB NUMBER: N/A CHECKED BY: Matt Silva SCALE: As Noted


A-1.0

SQUARE FOOT NOTES:

L FIRST FLOOR 2_SECOND FLOOR 3. THIRD FLOOR

= 2,569 SF = 2,063 SF = 1,654 SF TOTAL AREA • 6,306 €F

DRAWING SCALE: 1/4" = 1'-0"

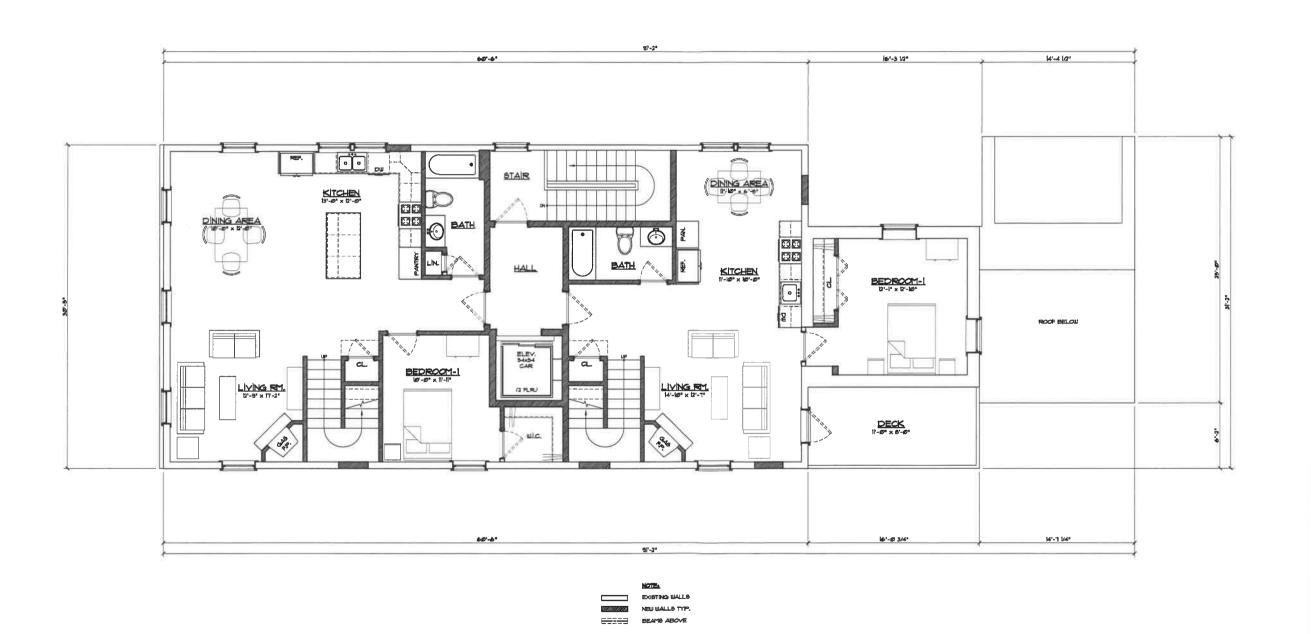



FIREHOUSE CONDOS

ISSUED DATES & REVISIONS:
ISSUED FOR DESIGN #1
MARCH 13, 2019
ISSUED FOR DESIGN #2
APRIL 10, 2019
ISSUED FOR DESIGN #3
APRIL 25, 2019
ISSUED FOR DESIGN #4
MAY 30, 2019

GENERAL NOTES:

GENERAL NOTES:

General Generate and make all finhousts selected and singularies searce of the requirements of these notes.

All work shall be performed in compiliones with applicable local field and the selected social soci


DECTOTE A TUCK



SECOND FLOOR PLAN

| ISSUE DATE: | 5/30/19 |
|-------------|--------------|
| JOB NUMBER: | N/A |
| DRAWN BY: | Jeremy Sheaf |
| CHECKED BY: | Matt Silva |
| | |

A-1.1

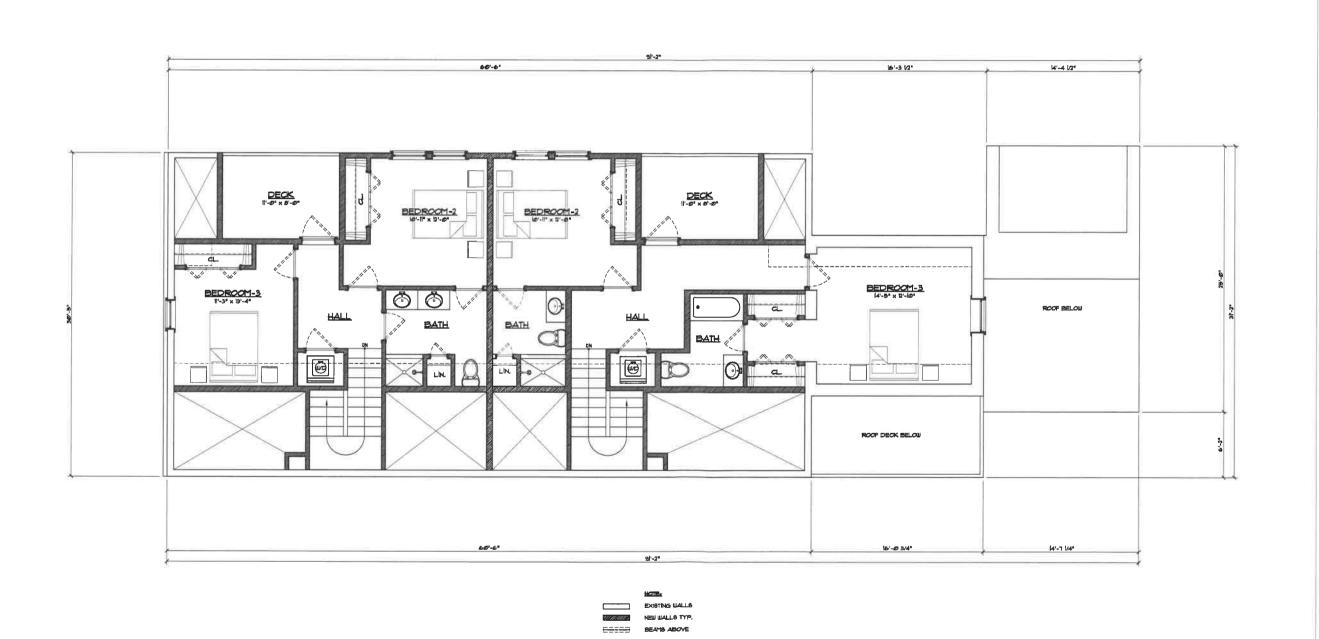



FIREHOUSE CONDOS

ISSUED DATES & REVISIONS:

ISSUED FOR DESIGN #1
MARCH 13, 2019
ISSUED FOR DESIGN #2
APRIL 10, 2019
ISSUED FOR DESIGN #3
APRIL 25, 2019

ISSUED FOR DESIGN #4 MAY 30, 2019

GENERAL NOTES:

General Contractor shall make all Hubennizenters and suppliers aware of the requirements of these notes.

All work shall be performed in compliance with all spokeshie local, State and Sational Suffiths. Life

Safety and Hactrical codes.

denaral Contractors shall be responsible for securing all pararity as mecasion; for the compaction of work shows throughout the Contract

emissist terminates final say out in the pool to earlies work to wently dimensional relationship before constructing my part, and shall workly a castisting conditional and locations before proceed Fallure to workly dimensional and conditional before

universize Cost, if a discrepancy which could have sen discovered cause modifications to the plans, energy Contractor shall occordinate the dimensions:

classifying or specifying of a product, material or means of assumbly is to be pointed out to Profile House Immediately.

Brewings shall not be socied for dimensions and, sharp, Fradia Hennes assumes no responsibility for use of incorrect scale.

By the incompany for these panels provide many for the first bit is necessary for these panels and function of an item shows or specified, Supplier and Subsembracture shall inform the General Contractor of their requirements for the work of other brades, which may not be indicated, prior bidding.

COPYRIGHT NOTE:

Copyrights and other Properly Rights in these plans, These drawings are the property of Profile Homes, and pitall not be reproduced in any manner, nor are they to be saistgned in any manner, without first obtaining the expressed written permission and consum of Profile Homes.

REGISTRATION:



THIRD FLOOR PLAN

| ISSUE DATE: | 5/30/19 |
|-------------|---------------|
| JOB NUMBER: | N/A |
| DRAWN BY: | Jeremy Sheaff |
| CHECKED BY: | Matt Silva |
| SCALE: | As Noted |

A-1.2





NOOFING RECEIVED OCCTT1281 20099 INSPIRE BY: ROOFING PRODUCTS Inspire Roofing Products, a HWHEADWATERS company


Premium Composite Slate and Shake

Color Palettes

ROOFING

ALEDORA AND CLASSIC SLATE

Aledora and Classic Slate offer a range of colors nicely reflecting nature's own hues. No matter your home's shade and style, an Inspire color can provide a perfect complement.

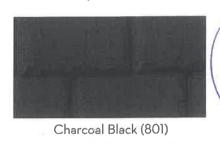



Mist Grey (803)



Olive (814)



Steel Grey (804)



Sage Green (815)



Red Rock (809)



Brandywine (806)



Grey/Black Blend (718) Not available in Aledora Slate

COOL ROOFING - For Aledora, Classic Slate, and Arcella Shake



Evergreen (CR-730)



Ash Grey (CR-731)



Granite (CR-732)



Graphite (CR-733)



Wintergreen (CR-792) Mix Aledora and Classic only





Red Cedar (CR-738)



WHERE TO BUY

77504 NANTUCKET

SERIES: <u>Nantucket Collection™</u>
TYPE: Exterior French & Sash

<u>APPLICATIONS:</u> Can be used for a swing door, Dutch Door, with barn track hardware, with pivot hardware, in a patio swing door or slider system and many other

applications for the home's exterior.

MATCHING COMPONENTS

Nantucket Sidelight (77802)

<u>Construction Type:</u> Two-Piece Laminated Wood Stiles and Rails with Modified Mortise-and-Tenon Stile/Rail Joinery

Panels: 3/4" Flat Panel or 1-7/16" Innerbond®

Double Hip-Raised Panel

Profile: Ovolo Sticking or Shaker Sticking


Glass: 3/4" Insulated Glazing

GET A QUOTE


If you are interested in receiving a quote from a dealer, please select the options below and click on the "Request Dealer Quote" below.

Rough opening needs to be 2" wider and 21/2" taller than your door.

| WIDTH | 3'0" ∨ | | | |
|--------|----------|----------------|---|---|
| HEIGHT | 6'8" ∨ | Province | | |
| WOOD S | PECIES | Fir | ~ | |
| GLASS | 3/4" Cle | ear IG | | V |
| PANEL | 3/4" So | lid Flat Pnl V | | |
| REQUE | ST DEA | LER QUOTE | | |

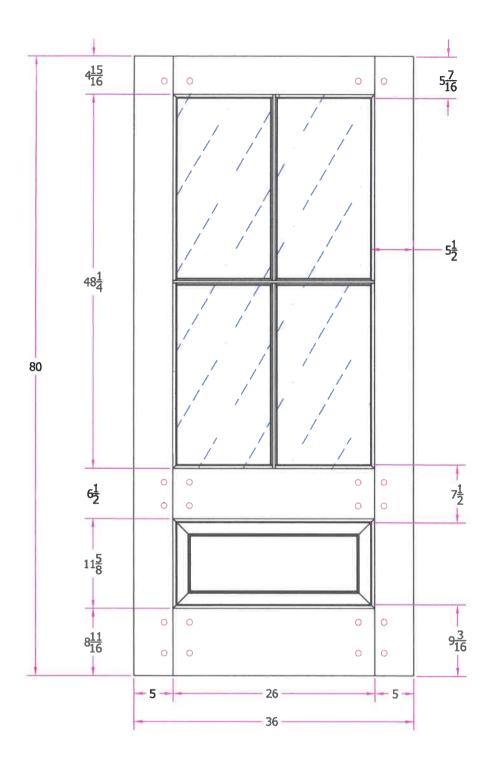

THIS DRAWING AND THE INFORMATION CONTAINED HEREIN IS PROPRIETARY TO TITLE 77504 3/0 x 6/8 SIMPSON DOOR COMPANY AND SHALL NOT BE REPRODUCED, COPIED OR DISCLOSED IN **Customer Layout** WHOLE OR PART, OR USED FOR MANUFACTURE OR FOR ANY OTHER PURPOSE WITHOUT THE WRITTEN PERMISSION OF SIMPSON DOOR COMPANY. D-77504-300-608-0700 Revisions SCALE NTS LAYOUT N/A MORTISE 0006 Rev. # Description Date by Whom DATE 12/21/2010 DRAWN BY: J. Decker **Simpson®**

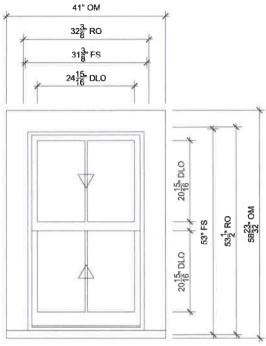

UNIT A SCALE: 1/2" = 1'-0"



Jamb

Sill

Divided Lite

Checkrail

SPECIFICATIONS

Line #: 1 Qty: 1

Mark Unit: UNIT A

Product Line: Ultimate Wood Unit Description: Double Hung Rough Opening: 32 3/8" X 53 1/2"

Frame Size: 31 3/8" X 53" Exterior Finish: Primed

Species: Pine

Interior Finish: Painted Interior Finish - White

Unit Type: Double Hung

Divider Type: 5/8" Rectangular SDL W/ Spacer - Stainless Hardware Type: Sash Lock, Lift Type: None, No Finger Pull

Screen Type: Aluminum Screen

FOR DESIGN INTENT ONLY, NOT FOR MANUFACTURE.



PROJ/JOB: SK FIRE HOUSE 1 / MATT

DIST/DEALER: SELECTWOOD-MWD SHOWCASE

DRAWN: STEVE KING

QUOTE#: BWVGQV6


PK VER: 0002.28.00


CREATED: 10/18/2019

REVISION:

SHEET


OF

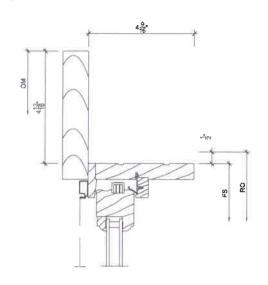


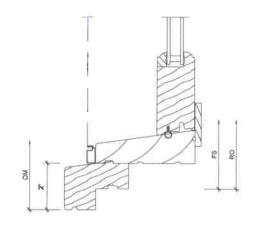

1 Head SCALE: 3" = 1'-0"

3 Sill 2 SCALE: 3" = 1'-0"

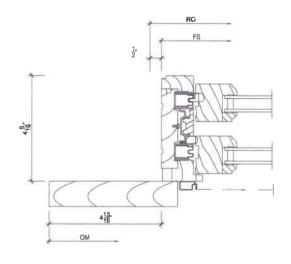

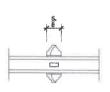


2 Jamb 2 SCALE: 3" = 1'-0" Divided Lite
SCALE: 3" = 1'-0"

MARVIN'®

PROJ/JOB: SK FIRE HOUSE 1 / MATT
DIST/DEALER: SELECTWOOD-MWD SHOWCASE
DRAWN: STEVE KING
QUOTE#: BWVGQV6 PK VER: 0002.28.00

CREATED: 10/18/2019 REVISION:

SHEET 2 OF 3

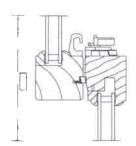

Checkrail

SCALE: 3" = 1'-0"

NOT USED

SCALE: 3" = 1'-0"

2 3

NOT USED

SCALE: 3" = 1'-0"

NOT USED

SCALE: 3" = 1'-0"

MARVIN'®

PROJ/JOB: SK FIRE HOUSE 1 / MATT

DIST/DEALER: SELECTWOOD-MWD SHOWCASE DRAWN: STEVE KING

QUOTE#: BWVGQV6

PK VER: 0002.28.00

CREATED:10/18/2019 REVISION:

SHEET

OF 3


X

SIDING AND TRIM | INSPIRATION | INSTALLATION | RESOURCES | WHERE TO BUY

About Blog

Search

٥

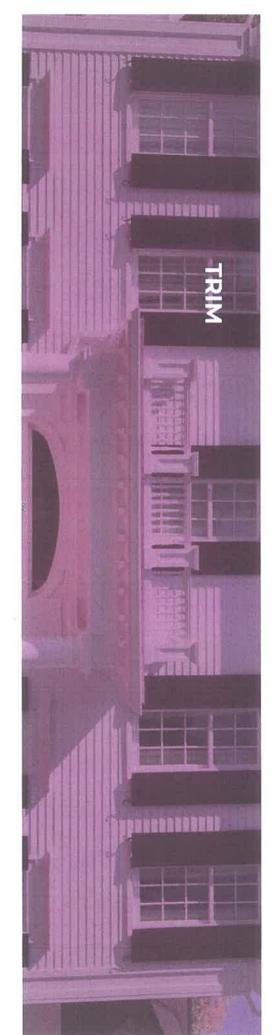



The Freedom To Create Your Custom

trim will outlast traditional wood. the ability to cut, miter and route TruExterior Trim, any custom look that you want for your homes. With TruExterior offers you the versatility to create virtually you can shape your perfect profile and know your

- engineered wood trim Better workability compared to wood, fiber cernant or
- Installs with standard woodworking tools and methods
- No edge sealing of cuts required
- Pre-primed and ready to paint any color
- Available in 16' lengths

Request Sample

Sample Request Form

Technical Data

Product Certifications Download

Content SCS Global Services - Minimum 70% Recycled

























BROMLEY

2364MB

MEDIUM WALL MOUNT LANTERN

Bromley's handsome silhouette features an updated traditional design that combines elegant and stately details. These dignified die-casted aluminum fixtures convey sophistication in a Museum Black finish that complements any façade. Specialty touches such as a "Shepherd's Hook" decorative scrolled arm and multiple mounting points highlight Bromley's homage to tradition and quality.

| DETAILS | | |
|-----------|--------------|--|
| FINISH: | Museum Black | |
| MATERIAL: | Aluminum | |
| GLASS: | Clear | |

| DIMENSIONS | | |
|------------|--------|--|
| WIDTH: | 8" | |
| HEIGHT: | 20" | |
| WEIGHT: | 5 lbs. | |

| LIGHT SOURCE | | |
|---------------|-------------|--|
| LIGHT SOURCE: | Socket | |
| WATTAGE: | 2-60w Cand. | |
| VOLTAGE: | 120v | |

| SHIPPING | | |
|----------------|--------|--|
| CARTON LENGTH: | 12.5" | |
| CARTON WIDTH: | 11" | |
| CARTON HEIGHT: | 23.5" | |
| CARTON WEIGHT: | 7 lbs. | |

PRODUCT DETAILS:

- Suitable for use in wet (interior direct splash and outdoor direct rain or sprinkler) locations as defined by NEC and CEC. Meets United States UL Underwriters Laboratories & CSA Canadian Standards Association Product Safety Standards
- 2 year finish warranty
- 12 year warranty on electrical wiring and components
- · Classic lines and heritage details complement traditional architecture
- Striking black finish enhances design





ALL-BLACK CS6K-290 | 295 | 300 MS

Canadian Solar's All-Black CS6K-MS modules enhance the aesthetics of our 5 bus bar mono modules while providing a higher energy output. All-Black CS6K-MS modules are equipped with Mono-PERC cells, a dark colored backsheet and a black frame.



KEY FEATURES



9 % more power than conventional modules



Excellent performance at low irradiance of up to: 97.5 %



Improved energy production due to low temperature coefficients



IP68 junction box for longterm weather endurance



Heavy snow load up to 6000 Pa, wind load up to 4000 Pa *



linear power output warranty



product warranty on materials and workmanship

MANAGEMENT SYSTEM CERTIFICATES*

ISO 9001:2008 / Quality management system
ISO 14001:2004 / Standards for environmental management system
OHSAS 18001:2007 / International standards for occupational health & safety

PRODUCT CERTIFICATES*

IEC 61215 / IEC 61730: VDE / CE





* If you need specific product certificates, and if module installations are to deviate from our guidance specified in our installation manual, please contact your local Canadian Solar sales and technical representatives.

CANADIAN SOLAR INC. is committed to providing high quality solar products, solar system solutions and services to customers around the world. As a leading PV project developer and manufacturer of solar modules with over 25 GW deployed around the world since 2001, Canadian Solar Inc. is one of the most bankable solar companies worldwide.

CANADIAN SOLAR INC.

^{*}For detail information, please refer to Installation Manual.

Date: 10/18/19

Profile Homes NH 953 Islington St, Unit 22C Portsmouth, NH 03801 603-433-2464

City of Portsmouth Historical District Commission

RE: 202 Court St Request for public hearing

Dear Members of the Historical District Commission,

Please see the attached request for public hearing for the October 2nd meeting for 202 Court St and attached plans, and specification description.

We appreciate the opportunity we have had for discussion related to this property so far and have worked to incorporate all the ideas and feedback we have received from the board.

Thank you,

Matt Silva Profile Homes of NH Attached is the description for these documents which relative to the exterior improvements which include:

New Widows
Solar Panels
New siding/trim
New Garage Doors
Railings of the building
New Front Façade
Fencing for shielding of the utilities and disposal areas

Introduction:

The property is located in the CD4-L1 zoning district within downtown. It is commonly known as the Wright Baker Auto Garage for the last 90 years, but for many others, the original Portsmouth Fire station prior to the current Portsmouth fire station built in 1920.

The proposed improvements to the site consist of converting the building from an existing auto mechanic garage with approved residential living above and into a 3 family condominium. Upon complete review of the plans in order to work within the restrictions of the variance relief we have received we are working to begin construction with improvement to revive the history of this structure.

SPECIFICATIONS:

<u>Windows:</u> The existing widows of the structure have been damaged or left without repair. While original to the building these windows do not appear to hold a significant amount of character to the details of the building. The tradition aspects of wavy glass seen from this time period are not available for these.

With the advice of the board our company has elected to purchase Green Mountain Windows for there historical character aspects and details throughout the building and rebuild the windows with full size trim and sils as seen in the original time period of the building

Solar Panels: Our company has a long standing history of energy efficient improvements to historical and new construction buildings. In the method of the energy efficiency improvements to the air sealing and added insulation to the building we are seeking to allow owners of the building the rights to install solar panels on the southern side of the building. All panels will be a "full black Panel" with not aluminum edging shown.

Siding: The original wood siding of the building has been covered over with a aluminum siding which is in complete disrepair. We have elected to strip all layers of siding off the building. Installed a weather air barrier (WRB) against new sheathing of the building. Provide an added layer of exterior insulation and install new wood Clapboards to be painted on the structure.

Trim details will be done in wood in areas where Boral Trim Material cannot accommodate the details to

match the existing or original on the structure and from the historical photo's made available.

Garage Doors: The existing garage doors will be replaced with new garage doors similar to the doors notated on the rendering of this plan. Above the doors we will locate the names of the previous fire equipment on the front of the building and above the rear unit garage doors. These include The Kearsarge, The Sampson and The Dearborn. Similar to the photo's of the original front of the building Lighting on the exterior of the building will be located above these doors and traditional to the age of the structure.

Front Façade and Shielding:

We will be removing the brick façade on the building now and reestablishing the original look of the building with a enhanced corner board

The utility Shielding will be natural wood custom fencing

Metal Railings will be a standard all black posts and top rail.

Please note all photo's attached for representation and discussion

Thank you,

Matt Silva Profile Homes

Date: 11/15/19

Profile Homes NH 953 Islington St, Unit 22C Portsmouth, NH 03801 603-433-2464



NOV 15 2019

City of Portsmouth Historical District Commission

RE: 202 Court St Request for public hearing

BY:____

Dear Members of the Historical District Commission,

Please see the attached request for public hearing for the October 2nd meeting for 202 Court St and attached plans, and specification description.

We appreciate the opportunity we have had for discussion related to this property so far and have worked to incorporate all the ideas and feedback we have received from the board.

Thank you,

Matt Silva Profile Homes of NH Attached is the description for these documents which relative to the exterior improvements which include:

New Widows
Solar Panels
New siding/trim
New Garage Doors
Railings of the building
New Front Façade
Fencing for shielding of the utilities and disposal areas

Introduction:

The property is located in the CD4-L1 zoning district within downtown. It is commonly known as the Wright Baker Auto Garage for the last 90 years, but for many others, the original Portsmouth Fire station prior to the current Portsmouth fire station built in 1920.

The proposed improvements to the site consist of converting the building from an existing auto mechanic garage with approved residential living above and into a 3 family condominium. Upon complete review of the plans in order to work within the restrictions of the variance relief we have received, we are working to begin construction with improvement to revive the history of this structure.

SPECIFICATIONS:

<u>Windows:</u> The existing widows of the structure have been damaged or left without repair. Historical photo's of the building also show that these windows are not the original to the building. The tradition aspects of wavy glass seen from this time period are not available for these. With the advice of the board our company has elected to purchase a Marvin Wood exterior window for their historical character aspects and details throughout the building and rebuild the windows with full size trim and sils as seen in the original time period of the building. This is notated on in the specifications of the window schematics.

Historical photo evidence of the building shows the widows were once black sashes. We would look to reproduce this look

Solar Panels: Our company has a long standing history of energy efficient improvements to historical and new construction buildings. In the method of the energy efficiency improvements to the air sealing and added insulation to the building we are seeking to allow owners of the building the rights to install solar panels on the southern side of the building. All panels will be a "full black Panel" with not aluminum edging shown.

Siding: The original wood siding of the building has been covered over with an aluminum siding which is in complete disrepair. We have elected to strip all layers of siding off the building. Installed a weather air barrier (WRB) against new sheathing of the building. Provide an added layer of exterior insulation and install new wood Clapboards to be painted on the structure through one of Benjamin Moore's Historical Color pallet selections

Trim details will be done in wood in areas where Boral Trim Material cannot accommodate the details to match the existing or original on the structure and from the historical photo's made available.

Garage Doors: The existing garage doors will be replaced with new garage doors similar to the doors notated on the rendering of this plan. Above the doors we will locate the names of the previous fire equipment on the front of the building and above the rear unit garage doors. These include The Kearsarge, The Sampson and The Dearborn. Similar to the photo's of the original front of the building Lighting on the exterior of the building will be located above these doors and traditional to the age of the structure.

Front Façade and Shielding:

We will be removing the brick façade on the building now and reestablishing the original look of the building with a enhanced corner board

The utility Shielding will be natural wood custom fencing

Metal Railings will be a standard all black posts and top rail.

Please note all photo's attached for representation and discussion

Thank you,

Matt Silva Profile Homes



FIREHOUSE CONDOS

PROFILE
HOMES
NET-ZERG EVERGY BUILDING
WHIS ANTERSECTION
PHOST TRE-SECTION
PHOST TRE

202 COURT ST., PORTSMOUTH, NEW HAMPSHIRE

DRAWING INDEX

ADDITION/ REMODEL

ARCHITECTURAL:

TITLE SHEET

AB-1.0 EXISTING 1ST FLOOR PLAN

AB-1.1 EXISTING 2ND FLOOR PLAN

AB-2.0 EXISTING ELEVATIONS

AB-2.1 EXISTING ELEVATIONS A-1.0 FIRST FLOOR PLAN

A-1.1 SECOND FLOOR PLAN

A-1.2 THIRD FLOOR PLAN

A-2.0 ELEVATIONS

A-2.1 ELEVATIONS



CONSULTANTS

ARCHITECTURAL DESIGNER: JEREMY SHEAFF

STRUCTURAL ENGINEER:

PH: 603-793-8431

ATTAR ENGINEERING LEW CHAMBERLAIN PH: 207-439-6023

RECEIVED


NOV 1 5 2019

BY:____



NET-ZERO ENERGY BUILDING www.profilehomesnh.com Ph: 603-765-6648

ISSUED FOR DESIGN#5 NOVEMBER 14, 2019

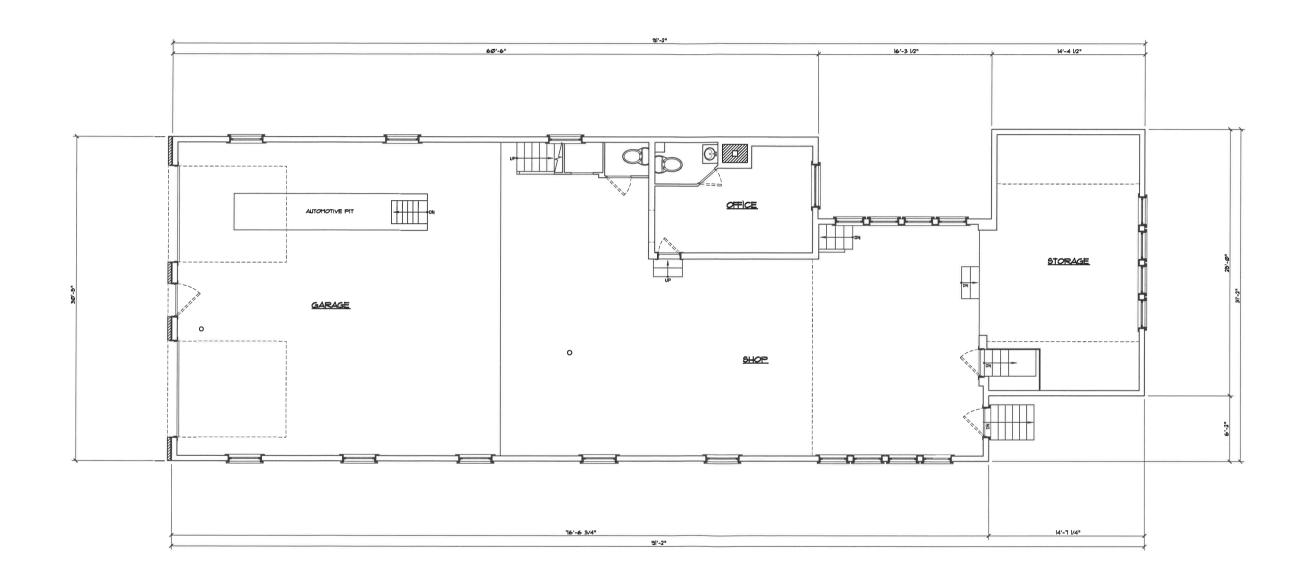

SQUARE FOOT NOTES:

1. FIRST FLOOR = 2,569 SF 2. SECOND FLOOR = 2,083 SF

EXISTING TOTAL AREA = 4,652 SF

DRAWING SCALE: 1/4" = 1'-0"

PROFILE HOMES

NET-ZERO EVEROY BJILDING www.beschiberorina.com
https://doi.org/10.1001/10.0001

FIREHOUSE CONDOS

ISSUED DATES & REVISIONS:

ISSUED FOR DESIGN #1 MARCH 13, 2019

ISSUED FOR DESIGN #2 APRIL 10, 2019

ISSUED FOR DESIGN #3 APRIL 25, 2019

ISSUED FOR DESIGN #4 MAY 30, 2019

ISSUED FOR DESIGN #5 NOVEMBER 14, 2019

GENERAL NOTES:

General Contractor shall make all Subcontractors and suppliers aware of the requirements of thes

applicable Local, State and National Building, Life Safety and Mectrical codes.

securing all permits as necessary for the completion of work shown throughout the Cor

tre work to verify dimensional relationship ore constructing any part, and shall verify all ting conditions and locations before proceeding. ure to verify dimensions and conditions before

seen discovered cause modifications to the plans. General Contractor shall coordinate the dimensions

discrepancies found in the plans, dimensions, sting conditions or any apparent error in the safrying or specifying of a product, material or

Drawings shall not be scaled for dimensions and/o

urdiess of whether or not an item is shown or dified, denoral Contractor shall provide said item is necessary for the proper installation or in them shown or specified, Suppliers Subsections and Interest the de-

unition of an item shown or precined, propplers and Subcontractors shall inform the General contractor of their requirements for the work of other trades, which may not be indicated, prior t sidding.

COPYRIGHT NOTE:

Copyrights and other Property Hights in these plans; Insee drawings are the property of Froff Homes; and shall not be reproduced in any manmar, nor are they to be assigned in any manmar, without first obtaining the expressed written permission and consent of Profile Home


REGISTRATION:



EXISTING FIRST FLOOR PLAN

| ISSUE DATE: | 11/14/19 |
|-------------|---------------|
| JOB NUMBER: | N/A |
| DRAWN BY: | Jeremy Sheafi |
| CHECKED BY: | Matt Silva |
| SCALE: | As Noted |

AB-1.0

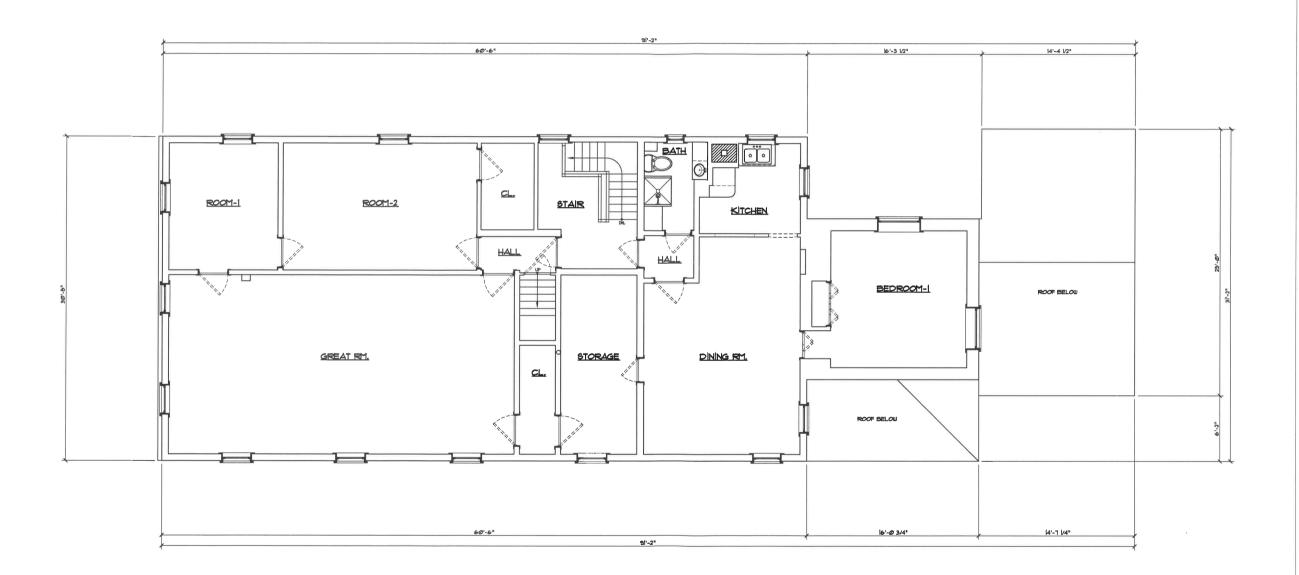



FIREHOUSE CONDOS

ISSUED DATES & REVISIONS:

ISSUED FOR DESIGN #1 MARCH 13, 2019

ISSUED FOR DESIGN #2 APRIL 10, 2019

ISSUED FOR DESIGN #3 APRIL 25, 2019

ISSUED FOR DESIGN #4 MAY 30, 2019

ISSUED FOR DESIGN #5 NOVEMBER 14, 2019

GENERAL NOTES:

General Contractor shall make all Subcontractors and suppliers aware of the requirements of these notes:

COPYRIGHT NOTE:

REGISTRATION:



EXISTING SECOND FLOOR PLAN

ISSUE DATE: 11/14/19 JOB NUMBER: N/A DRAWN BY: Jeremy Sheaff CHECKED BY: Matt Silva

AB-1.1



PROFILE HOMES NET-ZERO ENERGY BJILDING www.profilehomesnh.com Ph; 603-765-6648

FIREHOUSE CONDOS




EXISTING ELEVATIONS

| SSUE DATE: | 11/14/19 |
|-------------|---------------|
| OB NUMBER: | N/A |
| ORAWN BY: | Jeremy Sheaff |
| CHECKED BY: | Matt Silva |
| SCALE: | As Noted |

AB-2.0



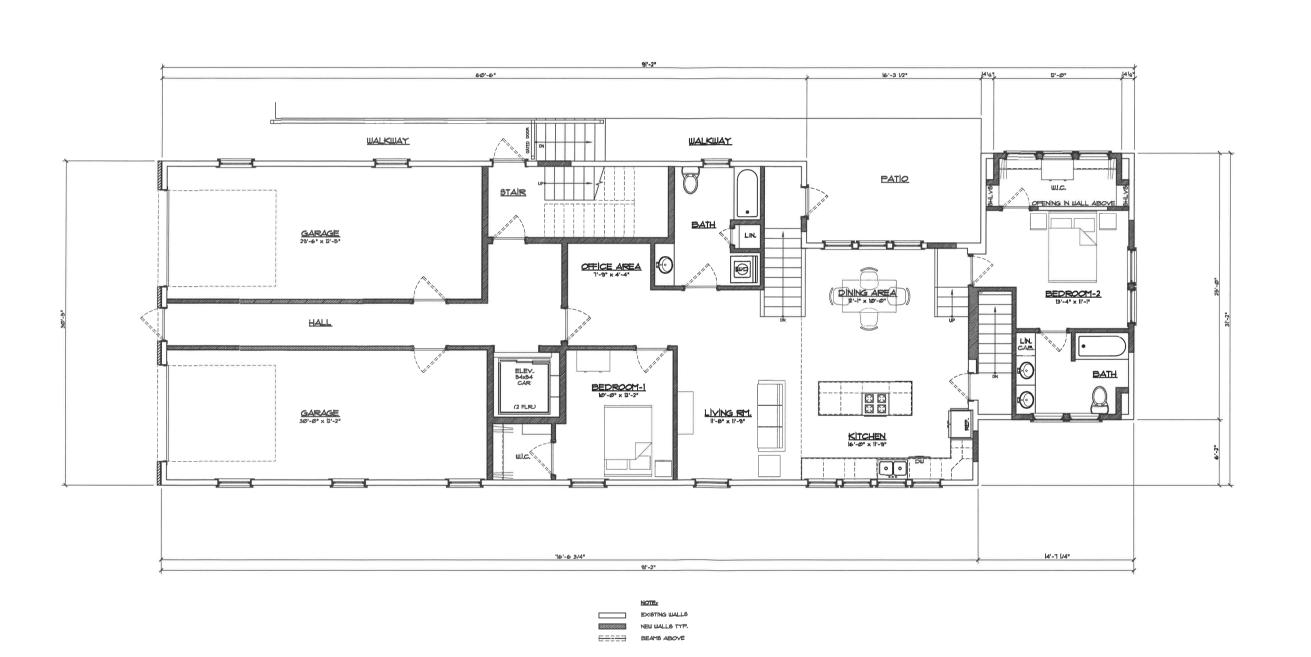



FIREHOUSE CONDOS

ISSUED DATES & REVISIONS:

ISSUED FOR DESIGN #1 MARCH 13, 2019

ISSUED FOR DESIGN #2 APRIL 10, 2019

ISSUED FOR DESIGN #3 APRIL 25, 2019

ISSUED FOR DESIGN #4

MAY 30, 2019

ISSUED FOR DESIGN #5 NOVEMBER 14, 2019

GENERAL NOTES:

General Contractor shall make all Subcontractors and suppliers aware of the requirements of these notes:

COPYRIGHT NOTE:

REGISTRATION:



FIRST FLOOR PLAN

| ISSUE DATE: | 11/14/19 |
|-------------|---------------|
| JOB NUMBER: | N/A |
| DRAWN BY: | Jeremy Sheaff |
| CHECKED BY: | Matt Silva |
| SCALE: | As Noted |

A-1.0

SQUARE FOOT NOTES:

1. FIRST FLOOR 2. SECOND FLOOR 3. THIRD FLOOR

= 2,569 SF = 2,083 SF = 1,654 SF TOTAL AREA = 6306 SF

DRAWING SCALE: 1/4" = 1"-0"



NEW WALLS TYP. BEAMS ABOVE



FIREHOUSE CONDOS

ISSUED DATES & REVISIONS:

ISSUED FOR DESIGN #1 MARCH 13, 2019

ISSUED FOR DESIGN #2 APRIL 10, 2019

ISSUED FOR DESIGN #3 APRIL 25, 2019

ISSUED FOR DESIGN #4 MAY 30, 2019

ISSUED FOR DESIGN #5 NOVEMBER 14, 2019

GENERAL NOTES:

General Contractor shall make all Subcontractors and suppliers aware of the requirements of these notes.

COPYRIGHT NOTE:

REGISTRATION:




SECOND FLOOR PLAN

| 11/14/19 | ISSUE DATE: |
|---------------|-------------|
| N/A | JOB NUMBER: |
| Jeremy Sheaff | DRAWN BY: |
| Matt Silva | CHECKED BY: |
| As Noted | SCALE: |

A-1.1

1 SECOND FLOOR PLAN

DRAWING SCALE: 1/4" = 1'-0"

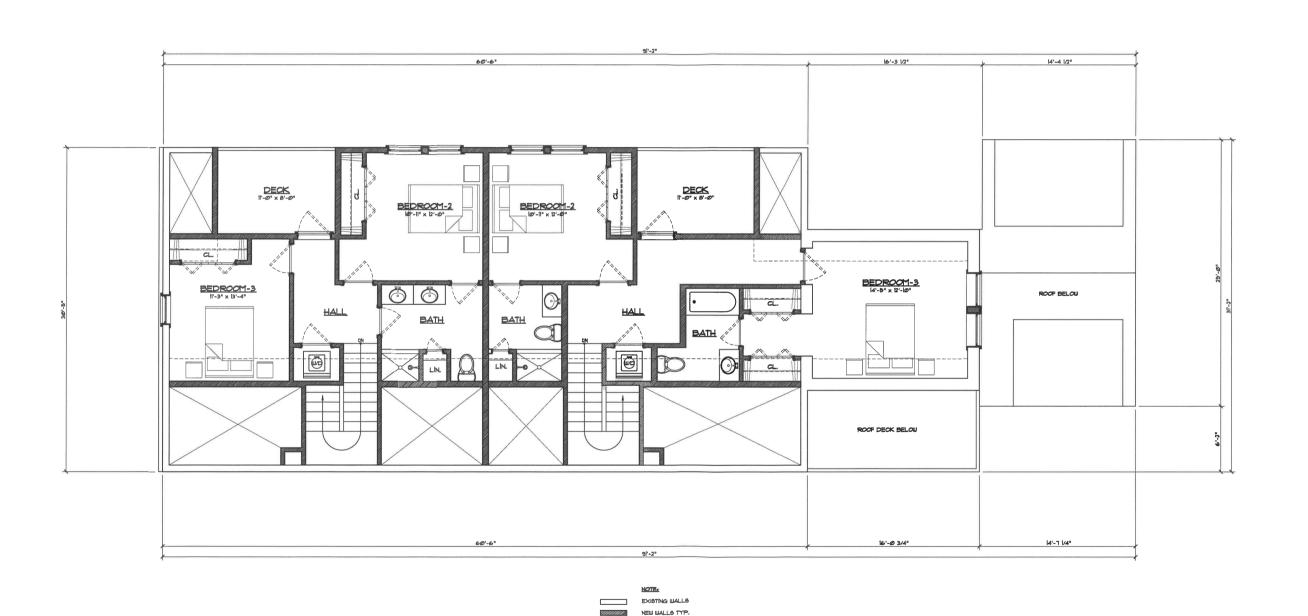

BEAMS ABOVE



FIREHOUSE CONDOS

ISSUED DATES & REVISIONS:

ISSUED FOR DESIGN #1 MARCH 13, 2019

ISSUED FOR DESIGN #2 APRIL 10, 2019

ISSUED FOR DESIGN #3 APRIL 25, 2019

ISSUED FOR DESIGN #4 MAY 30, 2019

ISSUED FOR DESIGN #5 NOVEMBER 14, 2019

GENERAL NOTES:

General Contractor shall make all Subcontractors and suppliers aware of the requirements of these notes.

COPYRIGHT NOTE:

REGISTRATION:



THIRD FLOOR PLAN

| 11/14/19 |
|---------------|
| N/A |
| Jeremy Sheaff |
| Matt Silva |
| As Noted |
| |

A-1.2

1 THIRD FLOOR PLAN

DRAWING SCALE: 1/4" = 1'-0"







CONDOS



| 11/14/19 | ISSUE DATE: |
|---------------|-------------|
| N/A | JOB NUMBER: |
| Jeremy Sheafi | DRAWN BY: |
| Matt Silva | CHECKED BY: |
| As Noted | SCALE: |