

John K. Bosen Admitted in NH & MA

Christopher P. Mulligan Admitted in NH & ME

Molly C. Ferrara
Admitted in NH & ME

Austin Mikolaities
Admitted in NH

Bernard W. Pelech 1949 - 2021

October 20, 2022

Peter Stith, Chair Site Review Technical Advisory Committee 1 Junkins Avenue Portsmouth, NH 03801

RE: 85 Daniel Street LU-22-75

Dear Mr. Stith:

On behalf of Seaport Realty, LLC, enclosed please find updated site and floor plans and exterior elevations for the above-referenced site, along with email correspondence with an Eversource representative regarding the contemplated relocation of the utility pole in the rear of the property on Custom House Court.

Significant changes from the previous plan are as follows:

- *Installation of parking lifts in the garage; resulting in a total of 6 off street parking spaces (4 in garage, 2 outside);
- *Removal of designated home office space in the first floor dwellings;
- *Reconfigured sewer to attach to existing junction with main. Added note to plans for sewer department to witness installation and connection to main;
- *3/4" water line to be cut and capped, new 1" line to be installed and secondary service for fire suppression added;
- *Basement egress stairway to comply with NPFA 101, 30.2.4.6.

We look forward to meeting with you.

Sincerely,

Christopher P. Mulligan Christopher P. Mulligan

CPM/ Encs.



City of Portsmouth, New Hampshire Site Plan Application Checklist

This site plan application checklist is a tool designed to assist the applicant in the planning process and for preparing the application for Planning Board review. The checklist is required to be completed and uploaded to the Site Plan application in the City's online permitting system. A preapplication conference with a member of the planning department is strongly encouraged as additional project information may be required depending on the size and scope. The applicant is cautioned that this checklist is only a guide and is not intended to be a complete list of all site plan review requirements. Please refer to the Site Plan review regulations for full details.

Applicant Responsibilities (Section 2.5.2): Applicable fees are due upon application submittal along with required attachments. The application shall be complete as submitted and provide adequate information for evaluation of the proposed site development. <u>Waiver requests must be submitted in writing with appropriate justification</u>.

Name of Applicant: SEAPORT REALTY, LLC	_ Date Submitted: <u>9-23-2022</u>
Application # (in City's online permitting): LU-22-	
Site Address: 85 Daniel St	Map: 107 Lot: 8

	Application Requirements			
M	Required Items for Submittal	Item Location (e.g. Page or Plan Sheet/Note #)	Waiver Requested	
	Complete <u>application</u> form submitted via the City's web-based permitting program (2.5.2.1(2.5.2.3A)		N/A	
	All application documents, plans, supporting documentation and other materials uploaded to the application form in viewpoint in digital Portable Document Format (PDF). One hard copy of all plans and materials shall be submitted to the Planning Department by the published deadline. (2.5.2.8)		N/A	

	Site Plan Review Application Required Info	ormation	
Ø	Required Items for Submittal	Item Location (e.g. Page/line or Plan Sheet/Note #)	Waiver Requested
	Statement that lists and describes "green" building components and systems. (2.5.3.1B)		
Ø	Existing and proposed gross floor area and dimensions of all buildings and statement of uses and floor area for each floor. (2.5.3.1C)	A-1, A-2, A-3	N/A
Ø	Tax map and lot number, and current zoning of all parcels under Site Plan Review. (2.5.3.1D)	Sheet 1	N/A

	Site Plan Review Application Required Info	ormation	
Ø	Required Items for Submittal	Item Location (e.g. Page/line or Plan Sheet/Note #)	Waiver Requested
Ø	Owner's name, address, telephone number, and signature. Name, address, and telephone number of applicant if different from owner. (2.5.3.1E)	Sheet 1	N/A
	Names and addresses (including Tax Map and Lot number and zoning districts) of all direct abutting property owners (including properties located across abutting streets) and holders of existing conservation, preservation or agricultural preservation restrictions affecting the subject property. (2.5.3.1F)	Sheets 1 & 2	N/A
Ø	Names, addresses and telephone numbers of all professionals involved in the site plan design. (2.5.3.1G)		N/A
	List of reference plans. (2.5.3.1H)	Sheet 1	N/A
Ø	List of names and contact information of all public or private utilities servicing the site. (2.5.3.11)		N/A

	Site Plan Specifications		
Ø	Required Items for Submittal	Item Location (e.g. Page/line or Plan Sheet/Note #)	Waiver Requested
Ø	Full size plans shall not be larger than 22 inches by 34 inches with match lines as required, unless approved by the Planning Director (2.5.4.1A)	Required on all plan sheets	N/A
Ø	Scale: Not less than 1 inch = 60 feet and a graphic bar scale shall be included on all plans. (2.5.4.1B)	Required on all plan sheets	N/A
	GIS data should be referenced to the coordinate system New Hampshire State Plane, NAD83 (1996), with units in feet. (2.5.4.1C)	Sheets 1 & 2	N/A
	Plans shall be drawn to scale and stamped by a NH licensed civil engineer. (2.5.4.1D)	Required on all plan sheets	N/A
Ø	Wetlands shall be delineated by a NH certified wetlands scientist and so stamped. (2.5.4.1E)	N/A No Wetlands	N/A
Ø	Title (name of development project), north point, scale, legend. (2.5.4.2A)	Sheet 2	N/A
	Date plans first submitted, date and explanation of revisions. (2.5.4.2B)	Sheet 1 & 2	N/A
Ø	Individual plan sheet title that clearly describes the information that is displayed. (2.5.4.2C)	Required on all plan sheets	N/A
	Source and date of data displayed on the plan. (2.5.4.2D)	Sheet 1	N/A

	Site Plan Specifications – Required Exhibits and Data		
\square	Required Items for Submittal	Item Location (e.g. Page/line or Plan Sheet/Note #)	Waiver Requested
	 Existing Conditions: (2.5.4.3A) Surveyed plan of site showing existing natural and built features; Existing building footprints and gross floor area; Existing parking areas and number of parking spaces provided; Zoning district boundaries; Existing, required, and proposed dimensional zoning requirements including building and open space coverage, yards and/or setbacks, and dwelling units per acre; Existing impervious and disturbed areas; Limits and type of existing vegetation; Wetland delineation, wetland function and value assessment (including vernal pools); SFHA, 100-year flood elevation line and BFE data, as required. 	Sheet 1	
	 2. Buildings and Structures: (2.5.4.3B) Plan view: Use, size, dimensions, footings, overhangs, 1st fl. elevation; Elevations: Height, massing, placement, materials, lighting, façade treatments; Total Floor Area; Number of Usable Floors; Gross floor area by floor and use. 	A-1, A-2, A-3	
☑ □	 Access and Circulation: (2.5.4.3C) Location/width of access ways within site; Location of curbing, right of ways, edge of pavement and sidewalks; Location, type, size and design of traffic signing (pavement markings); Names/layout of existing abutting streets; Driveway curb cuts for abutting prop. and public roads; If subdivision; Names of all roads, right of way lines and easements noted; AASHTO truck turning templates, description of minimum vehicle allowed being a WB-50 (unless otherwise approved by TAC). 	Sheet 2	
Ø	 4. Parking and Loading: (2.5.4.3D) Location of off street parking/loading areas, landscaped areas/buffers; Parking Calculations (# required and the # provided). 	Sheet 2	
Ø	 5. Water Infrastructure: (2.5.4.3E) Size, type and location of water mains, shut-offs, hydrants & Engineering data; Location of wells and monitoring wells (include protective radii). 	Sheet 2	
Ø	 Sewer Infrastructure: (2.5.4.3F) Size, type and location of sanitary sewage facilities & Engineering data, including any onsite temporary facilities during construction period. 	Sheet 2	

			(2.5.4.3G) type and location of all ab	ove & below ground utilities;	Sheet 2	
	•			pads, transformers and other		
	8. Sc	olid Wa	ste Facilities: (2.5.4.3H)		N/A	
	•	The size,	type and location of solid	waste facilities.	N/A	
	• 1 • 1 s • L	The locat The locat site snow Location Location locations	tion of onsite snow storage removal provisions. and containment measure	of all storm-water drainage. areas and/or proposed off- s for any salt storage facilities d permanent material storage	N/A Due to redu in Impervious S	
	• 7	Type and	Lighting: (2.5.4.3J) I placement of all lighting (enter areas of the site) and	exterior of building, parking lot photometric plan.	N/A Lighting Exists	
Ø	be	een imp	where dark sky friendly li llemented. (10.1)	ghting measures have	N/A	
	12. La •	Identi which	ning: (2.5.4.3K) ify all undisturbed area, exing is to be retained; ion of any irrigation system		N/A	
Ø	13. Co	Existir	and Elevation: (2.5.4.3L ng/Proposed contours (2 fo elevations.		N/A	
	•	Type,		existing/proposed open space.	Sheet 2	
			nents, deed restrictions a 2.5.4.3N)	and non-public rights of	N/A	
Ø	in • •	Applic Applic Applic Propo Propo): (2.5.4.3P) cable Building Height (10.5) cable Special Requirements osed building form/type (10.5) osed community space (10.5)	s (10.5A21.30);).5A43); 5A46).	Sheet 2	
☑	17. Sp • •	The p minin All pu minin Adeq	mize or eliminate flood dam	onsistent with the need to re located and construction to	Sheet 1, Note 4	

	Other Required Information		
Ø	Required Items for Submittal	Item Location (e.g. Page/line or Plan Sheet/Note #)	Waiver Requested
Ø	Traffic Impact Study or Trip Generation Report, as required. (3.2.1-2)	N/A	
Ø	Indicate where Low Impact Development Design practices have been incorporated. (7.1)	N/A	
Ø	Indicate whether the proposed development is located in a wellhead protection or aquifer protection area. Such determination shall be approved by the Director of the Dept. of Public Works. (7.3.1)	N/A	
Ø	Stormwater Management and Erosion Control Plan. (7.4)	N/A	
Ø	Inspection and Maintenance Plan (7.6.5)	N/A	

	Final Site Plan Approval Required Information			
V	Required Items for Submittal	Item Location (e.g. Page/line or Plan Sheet/Note #)	Waiver Requested	
	All local approvals, permits, easements and licenses required, including but not limited to: • Waivers; • Driveway permits; • Special exceptions; • Variances granted; • Easements; • Licenses. (2.5.3.2A)	N/A		
	 Exhibits, data, reports or studies that may have been required as part of the approval process, including but not limited to: Calculations relating to stormwater runoff; Information on composition and quantity of water demand and wastewater generated; Information on air, water or land pollutants to be discharged, including standards, quantity, treatment and/or controls; Estimates of traffic generation and counts pre- and post-construction; Estimates of noise generation; A Stormwater Management and Erosion Control Plan; Endangered species and archaeological / historical studies; Wetland and water body (coastal and inland) delineations; Environmental impact studies. (2.5.3.2B) 	N/A		
₫	A document from each of the required private utility service providers indicating approval of the proposed site plan and indicating an ability to provide all required private utilities to the site. (2.5.3.2D)	To Be Submitted		

	Final Site Plan Approval Required Info	rmation	
\square	Required Items for Submittal	Item Location (e.g. Page/line or Plan Sheet/Note #)	Waiver Requested
☑	A list of any required state and federal permit applications required for the project and the status of same. (2.5.3.2E)	No state or federal permits required	
Ø	A note shall be provided on the Site Plan stating: "All conditions on this Plan shall remain in effect in perpetuity pursuant to the requirements of the Site Plan Review Regulations." (2.5.4.2E)	Sheet 2	N/A
	For site plans that involve land designated as "Special Flood Hazard Areas" (SFHA) by the National Flood Insurance Program (NFIP) confirmation that all necessary permits have been received from those governmental agencies from which approval is required by Federal or State law, including Section 404 of the Federal Water Pollution Control Act Amendments of 1972, 33 U.S.C. 1334. (2.5.4.2F)	N/A	
	Plan sheets submitted for recording shall include the following notes: a. "This Site Plan shall be recorded in the Rockingham County Registry of Deeds." b. "All improvements shown on this Site Plan shall be constructed and maintained in accordance with the Plan by the property owner and all future property owners. No changes shall be made to this Site Plan without the express approval of the Portsmouth Planning Director."	Sheet 2	N/A
	(2.13.3)		

Applicant's Signature:	Date:	

MEMORANDUM

Date:	September 22, 2022
Project:	85 Daniel St.
Subject:	Green building components

The scope of the project modifies an existing building located on the site of 85 Daniel St. while incorporating green building materials and systems into the renovation and addition. As part of the site plan review application, section 2.5.3.1b, the project has incorporated green components into the project as listed below.

- Increased roof and wall insulation to provide code minimum.
- Reuse of existing structure and cladding.
- Energy efficient glazing and frames for replacement and new windows.
- Low flow plumbing fixtures.
- LED energy efficient lighting.
- Recycled content for many building components including interior finishes.

Richard Desjardins

From: Kosko, Nickolai E <nickolai.kosko@eversource.com>

Sent: Tuesday, October 18, 2022 6:57 AM

To: Lane Cheney

Cc: david@lemieuxbuildersllc.com

Subject: RE: Custom House Court Pole Relocation

Good Morning Mr Cheney:

Eversource will indeed help you relocate the pole to a more suitable position for your construction. This may include putting facilities underground in order to make this happen. However in any circumstance Eversource will help with a solution to get you access to your parking location.

Sincerely,

Thanks

Nickolai Kosko

Nick Kosko

Field Supervisor Electrical Design

Eastern Region Phone: 603-332-7565 Cell: 603-842-0416

Email: nickolai.kosko@eversource.com

EVERSURCE

From: Lane Cheney < lane@cheneyco.com> Sent: Monday, October 17, 2022 3:24 PM

To: Kosko, Nickolai E < nickolai.kosko@eversource.com>

Cc: david@lemieuxbuildersllc.com

Subject: Custom House Court Pole Relocation

EVERSOURCE IT NOTICE – EXTERNAL EMAIL SENDER ** Don't be quick to click! ******

Do not click on links or attachments if sender is unknown or if the email is unexpected from someone you know, and never provide a user ID or password. Report suspicious emails by selecting 'Report Phish' or forwarding to SPAMFEEDBACK@EVERSOURCE.COM for analysis by our cyber security team.

Hello Mr. Kosko,

I am writing as a follow up to our meeting a few weeks back. As discussed, we hope to work with Eversource to have a utility pole relocated a few feet in order to allow access to a proposed parking space at our property, located on Custom House Court. Alternatively, converting the roadway to underground power would also work and in fact would be preferred, but we get that that is a very involved project.


We don't expect guarantees and are aware that there will be costs to us. That being said, we are looking for some sort of acknowledgement from you folks that we will work together in good faith to allow access to the parking spot. We would share this acknowledgement with the city, so that they are aware that access to the parking spot is feasible. This spot has a significant impact on the project, regarding the number of units allowed.


Thanks for your attention to this matter. We look forward to working with you.

Thanks, Lane

Lane Cheney 603-502-8232 Dave Lemieux 603-235-4370

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1,641 SF 1,641 SF BUILDING COVERAGE 1,641 / 3,142 = 52.2%

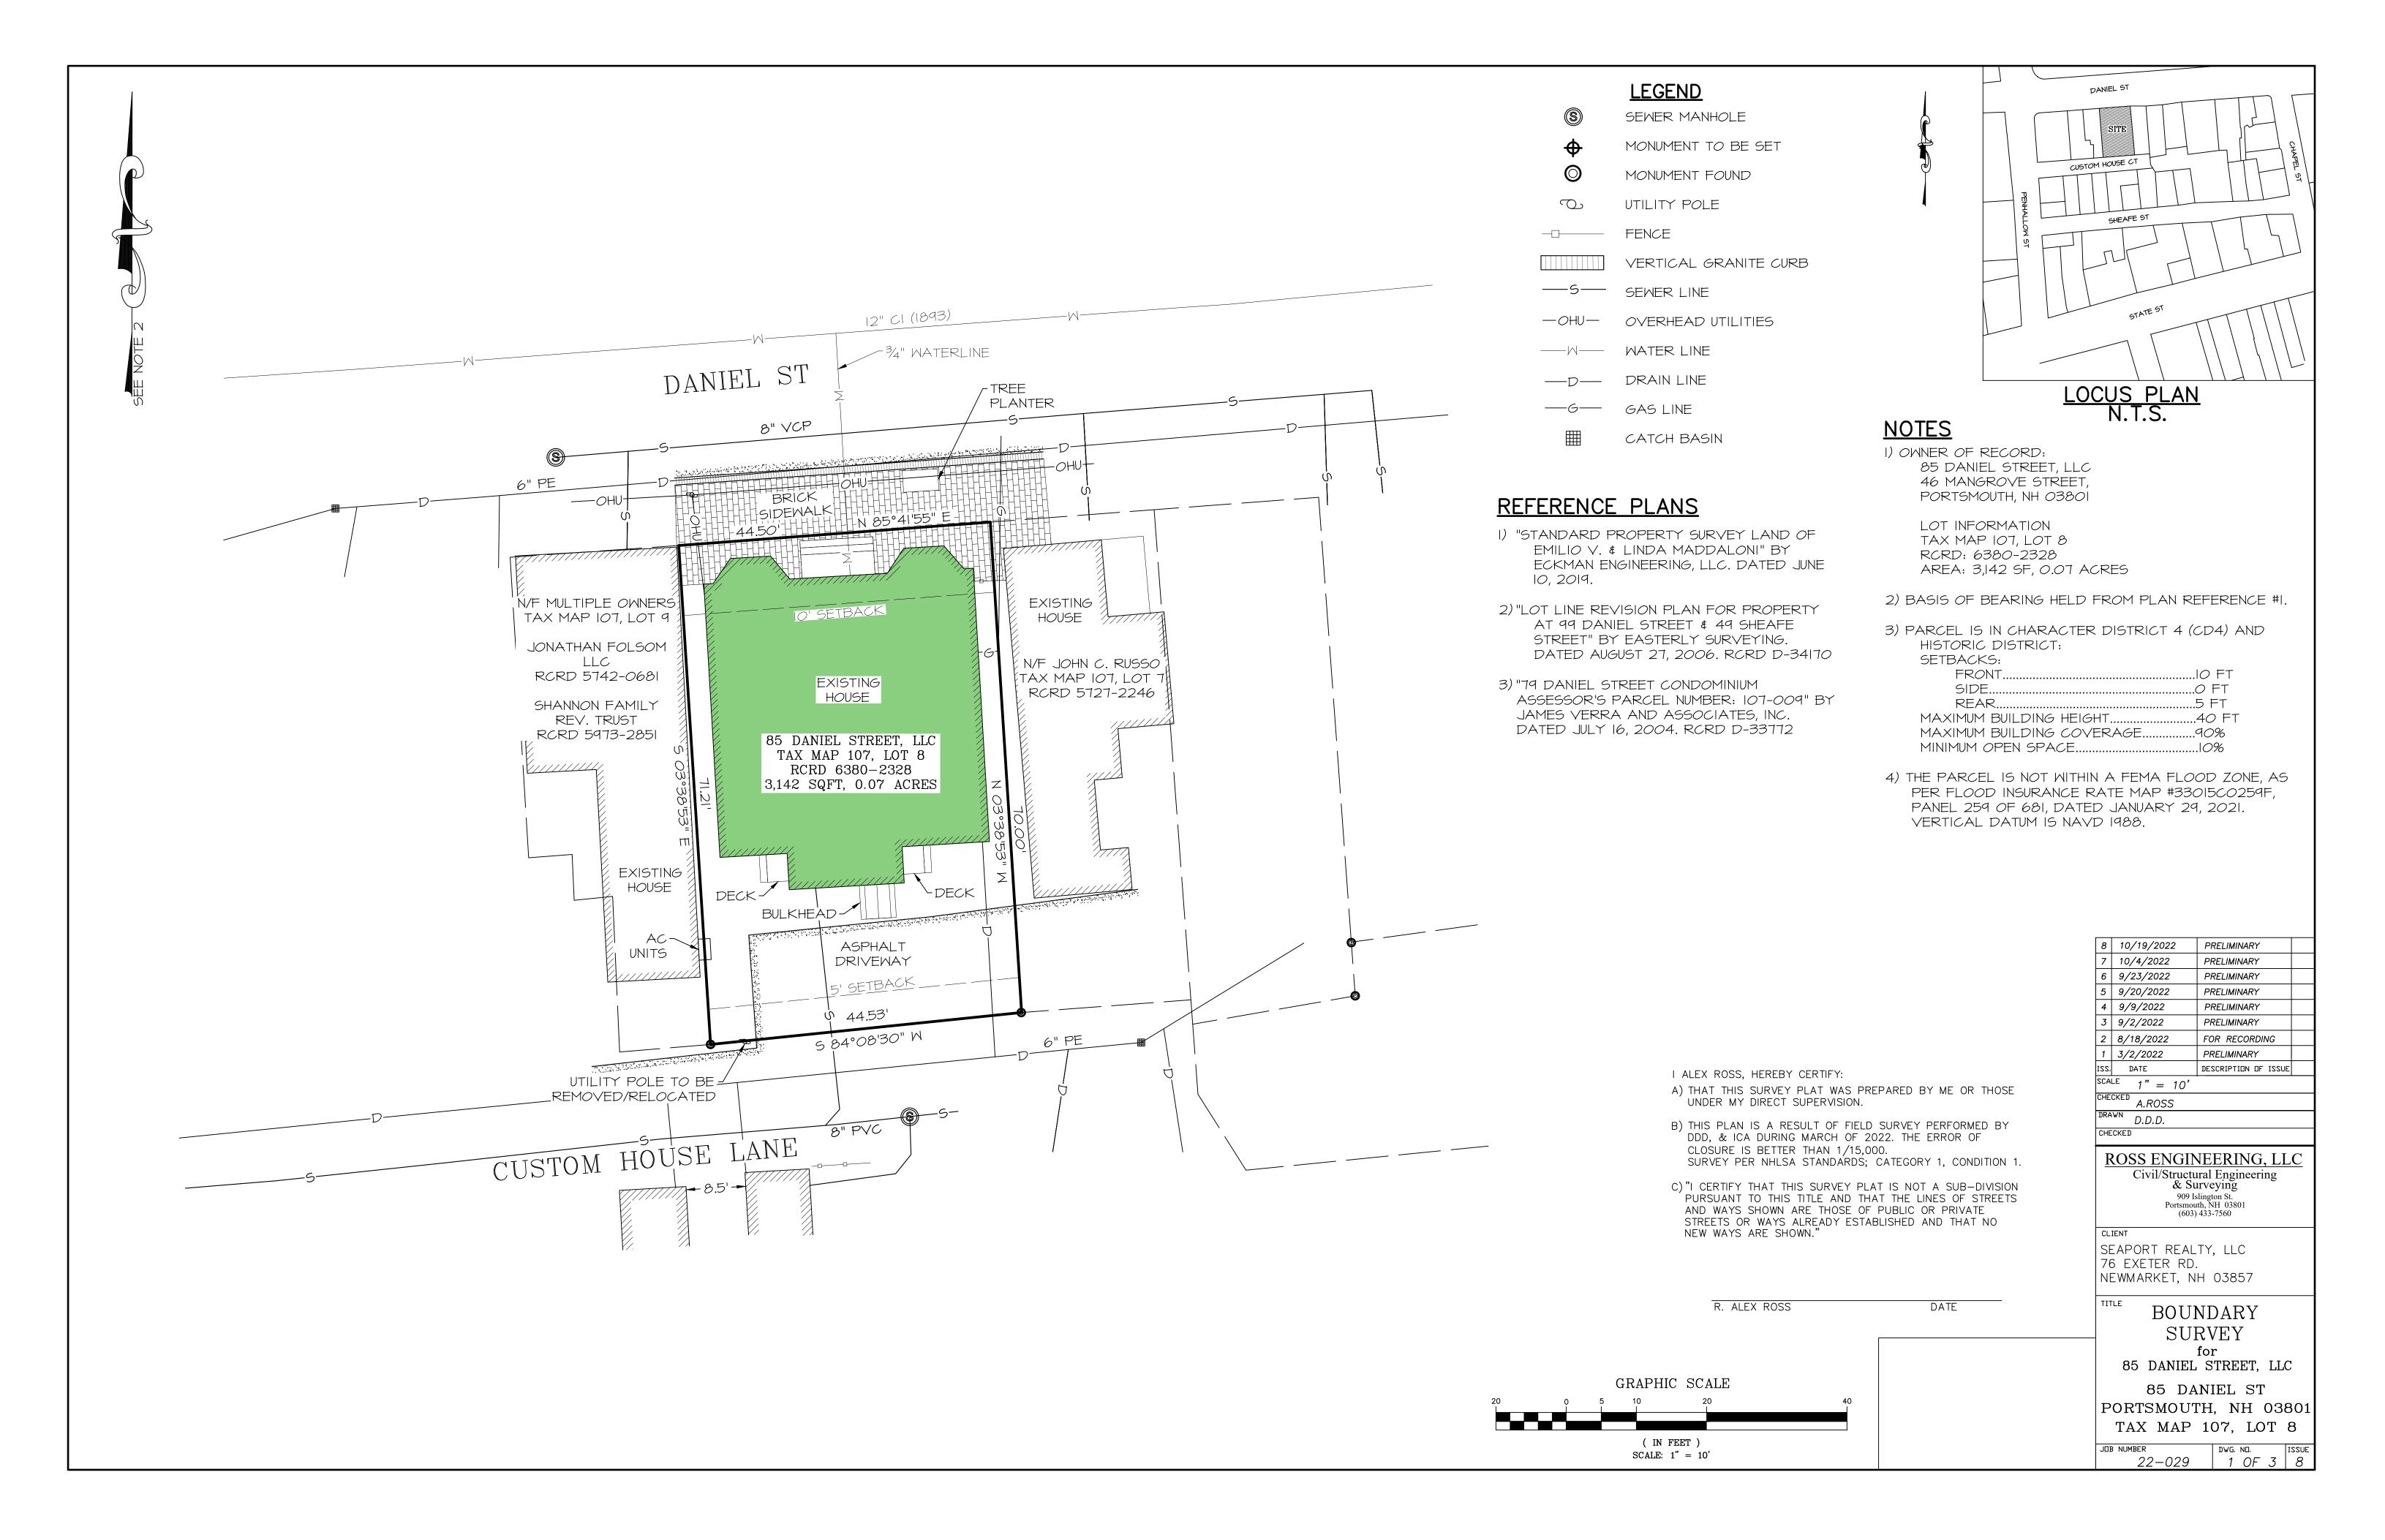PROPOSED BUILDING COVERAGE

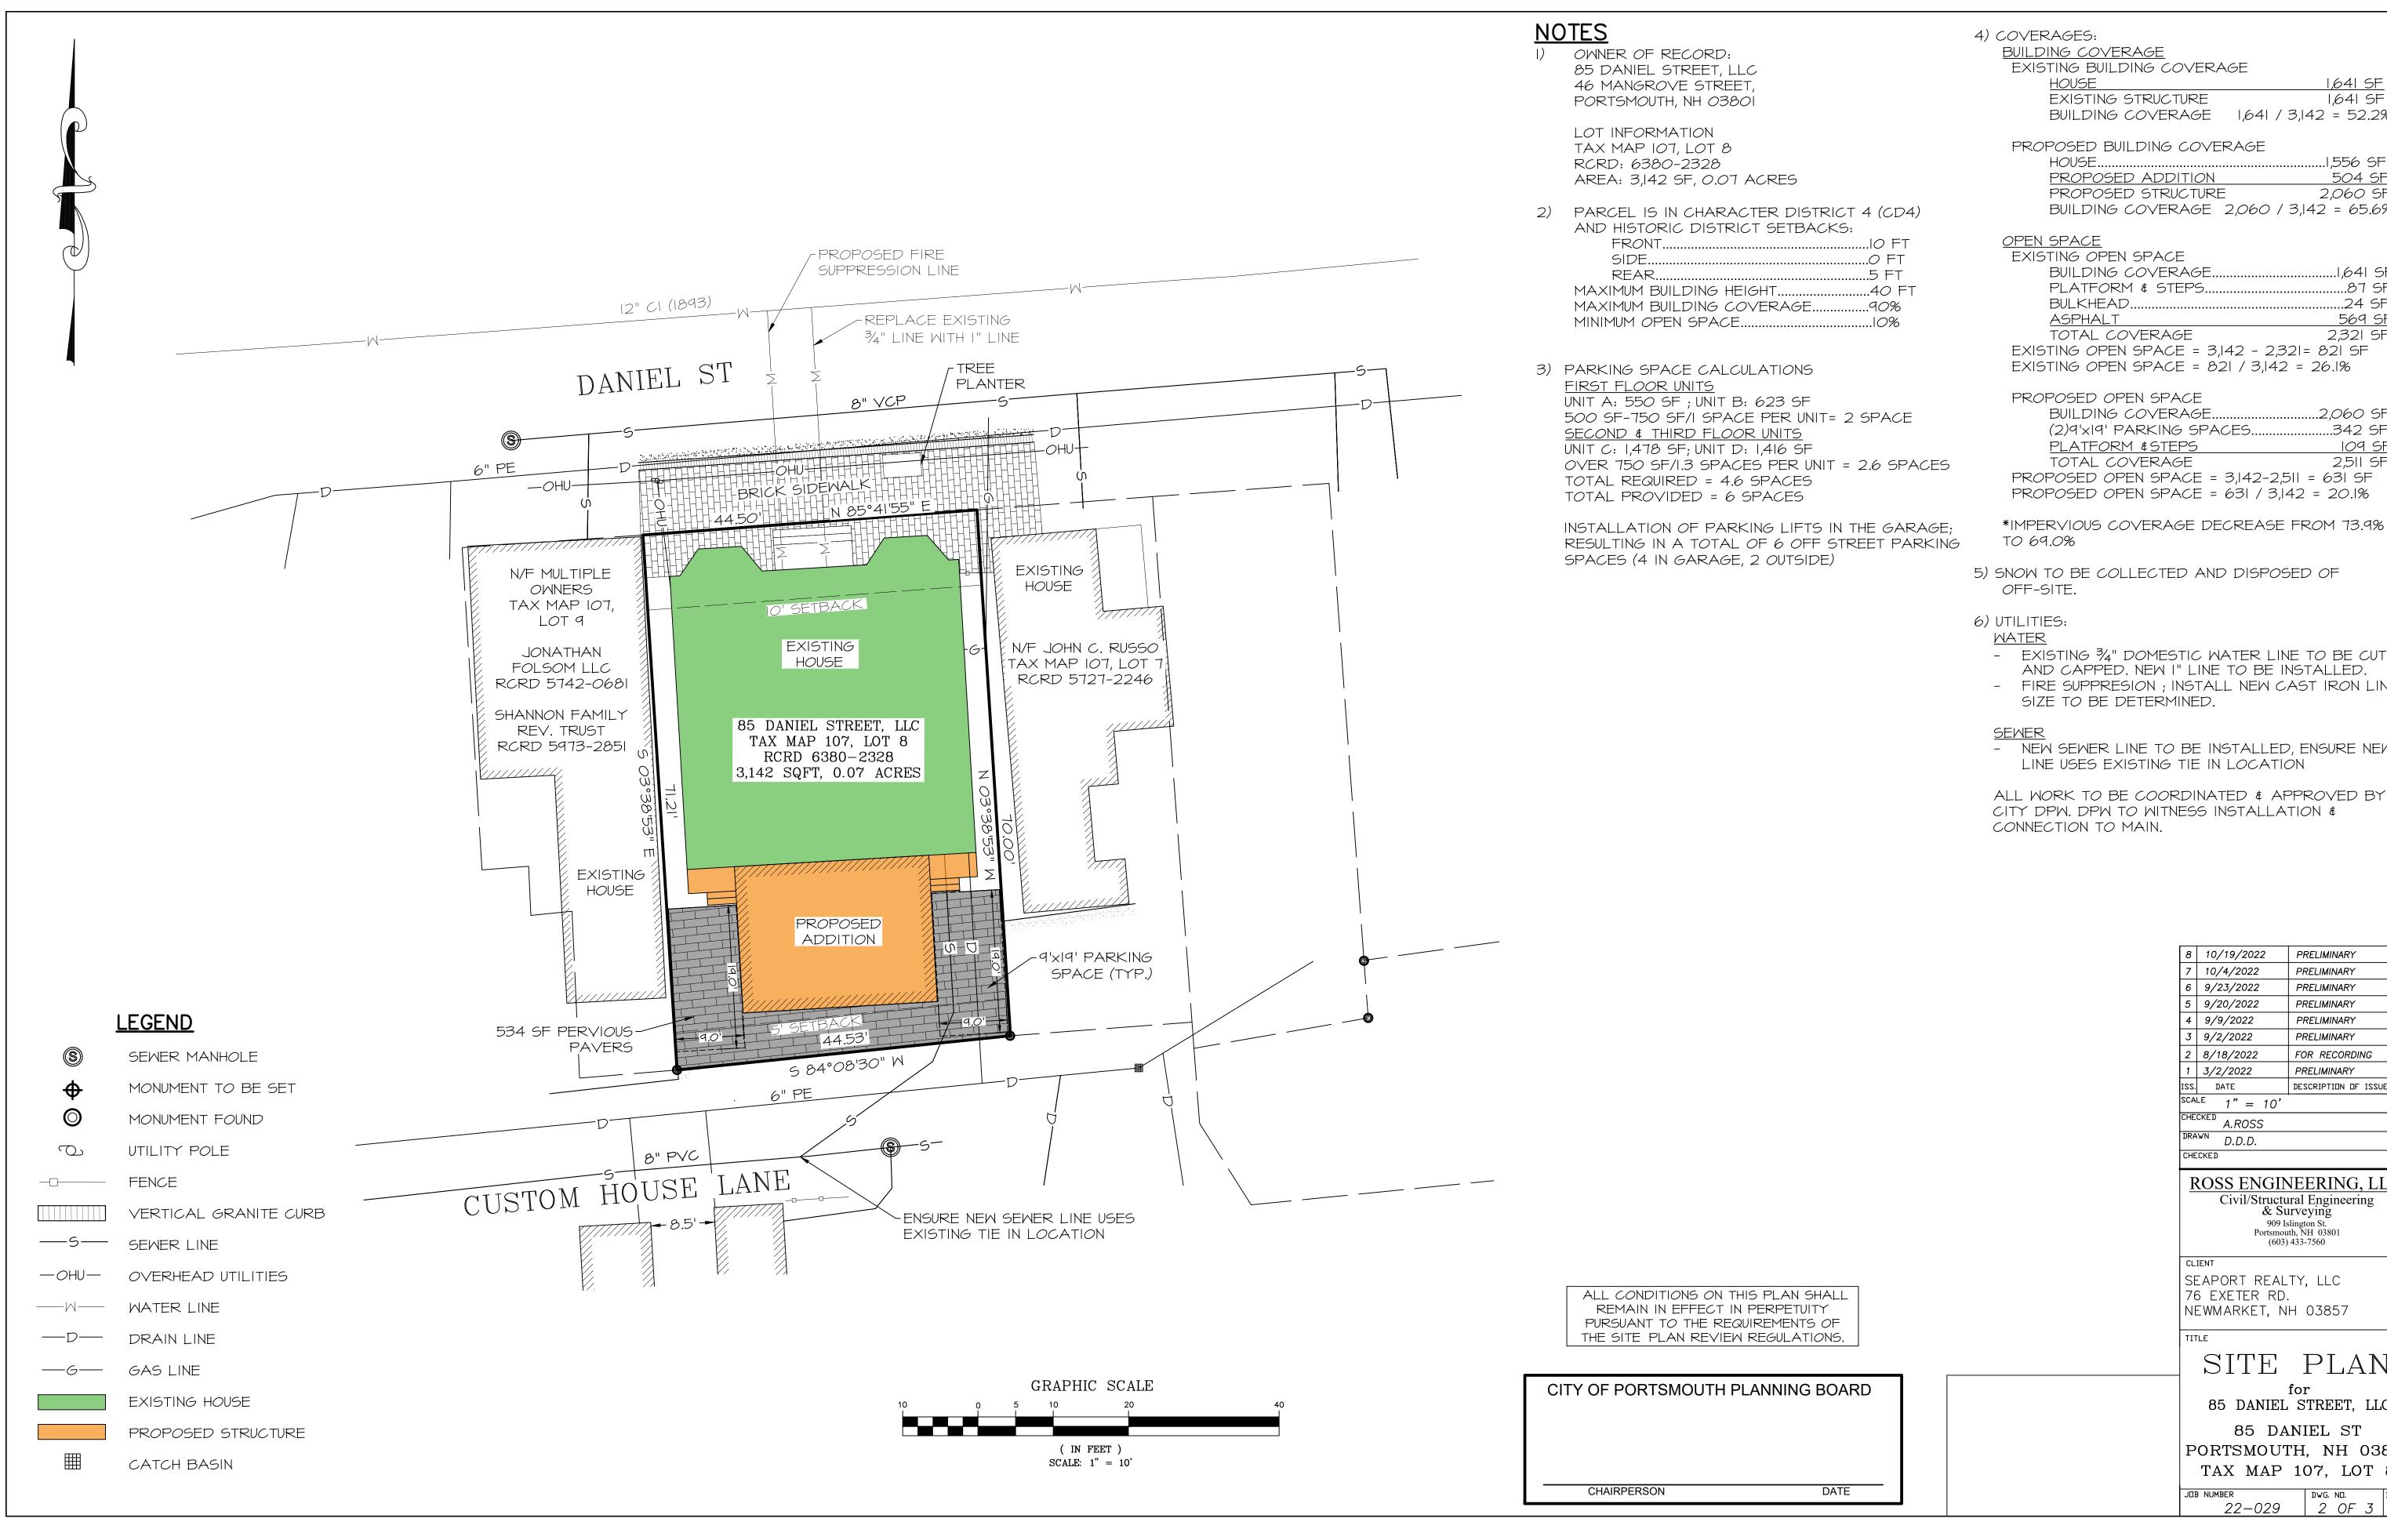...I,556 SF PROPOSED ADDITION 504 SF 2,060 SF PROPOSED STRUCTURE BUILDING COVERAGE 2,060 / 3,142 = 65.6%

.1,641 SF ..87 SF ..24 SF 569 SF 2,321 SF

..2,060 SF BUILDING COVERAGE .. (2)9'x19' PARKING SPACES. ...342 SF 109 SF 2,511 SF PROPOSED OPEN SPACE = 3,142-2,511 = 631 SF

PROPOSED OPEN SPACE = 631 / 3,142 = 20.1%

5) SNOW TO BE COLLECTED AND DISPOSED OF

- EXISTING 34" DOMESTIC WATER LINE TO BE CUT AND CAPPED. NEW I" LINE TO BE INSTALLED. - FIRE SUPPRESION; INSTALL NEW CAST IRON LINE,

- NEW SEWER LINE TO BE INSTALLED, ENSURE NEW LINE USES EXISTING TIE IN LOCATION

ALL WORK TO BE COORDINATED & APPROVED BY CITY DPW. DPW TO WITNESS INSTALLATION &

7	10/4/2022	PRELIMINARY	
6	9/23/2022	PRELIMINARY	
5	9/20/2022	PRELIMINARY	
4	9/9/2022	PRELIMINARY	
3	9/2/2022	PRELIMINARY	
2	8/18/2022	FOR RECORDING	
1	3/2/2022	PRELIMINARY	
122.	DATE	DESCRIPTION OF ISSUE	
004	_		

SCALE 1" = 10' CHECKED A.ROSS DRAWN D.D.D.

CHECKED

ROSS ENGINEERING, LLC Civil/Structural Engineering & Surveying 909 Islington St. Portsmouth, NH 03801 (603) 433-7560

SEAPORT REALTY, LLC 76 EXETER RD. NEWMARKET, NH 03857

for 85 DANIEL STREET, LLC 85 DANIEL ST

PORTSMOUTH, NH 03801 TAX MAP 107, LOT 8

22-029 | 2 OF 3 | 8

TECHO-BLOC & PERVIOUS PAVER INSTALLATION <u>GENERAL NOTES</u>

DATA COLLECTION

DETERMINE THE SIZE, SHAPE AND INTENDED USE OF FINISHED AREAS.

- 2. CLASSIFY SUB-GRADE SOILS.
- 3. DOCUMENT ALL EXISTING CONDITIONS. (FIXED POINTS, EXISTING GRADES, SITE CONTOURS,
- 4. DOCUMENT SOIL TYPE, LOCATION, AND ELEVATION OF BELOW GRADE AND OVERHEAD UTILITIES BOTH PUBLIC AND PRIVATE.
- 5. ENSURE PUBLIC UTILITIES ARE MARKED THROUGH THE USE OF LOCATING SERVICE.
- 6. DETERMINE THE CROSS SECTION DESIGN OF THE SYSTEM BASED ON SOIL TYPE AND APPLICATION, SHOWING PROPOSED SUB-GRADE AND FINISHED GRADE ELEVATIONS AND ALL GEOTEXTILES AND DRAINAGE DRAINAGE PIPES NEEDED FOR CONSTRUCTION.
- 7. ESTABLISH THE TYPE, LOCATION, AND ELEVATION OF RELIEF STRUCTURES IF REQUIRED (OVERFLOW PIPE DISCHARGING TO RAIN GARDEN, ETC).
- 8. DETERMINE CURB OR EDGE RESTRAINT TYPE, ELEVATION, AND LOCATION.
- 9. CHOOSE PATTERN APPROPRIATE TO THE APPLICATION (TRAFFIC TYPE AND LOAD).

EXCAVATION

- . BEFORE EXCAVATING, CALL ALL LOCAL UTILITY COMPANIES (E.G., PHONE, GAS, ELECTRICAL) TO ENSURE THAT THE AREA IN WHICH YOU PLAN TO DIG IS CLEAR OF UNDERGROUND CABLES OR WIRES. IF ANY ARE FOUND, PLEASE NOTIFY THE APPROPRIATE COMPANIES BEFORE YOU BEGIN.
- 2. EXCAVATION DEPTH IS DETERMINE FROM THE FOUNDATION THICKNESS ACCORDING TO THE PROJECT SPECIFICATIONS (FOUNDATION THICKNESS IS DETERMINED BY QUALIFIED ENGINEER BASED ON STRUCTURAL AND HYDROLOGIC ANALYSIS.)
- 3. THE SLOPE OF THE SUB-GRADE WILL DEPEND ON DRAINAGE DESIGN AND INFILTRATION TYPE, A MINIMUM SLOPE OF .5% (%" PER FOOT) IS REQUIRED.
- 4. THE DISTANCE THAT THE EXCAVATED AREA SHOULD EXTEND BEYOND THE AREA TO BE PAVED SHALL BE ONE TO 1.5 TIMES THE THICKNESS OF THE FOUNDATION. EXTRA SPACE ENSURE STABILITY OF PAVERS NEAR EDGE AND EDGE RESTRAINTS.
- 5. LEVEL THE BOTTOM OF THE EXCAVATED AREA WITH A RAKE.
- 6. COMPACTION WILL REDUCE THE PERMEABILITY OF THE SUB-GRADE. CARE SHOULD BE TAKEN TO MAINTAIN UNDISTURBED SOIL INFILTRATION DURING EXCAVATION AND CONSTRUCTION. STABILIZATION OF SUB-GRADE MAY BE REQUIRED WITH WEAK, OR CONTINUOUSLY SATURATED SOILS. REDUCED INFILTRATION MAY REQUIRE DRAINAGE PIPES WITHIN THE SUB-BASE TO CONFORM TO STORMWATER DRAINAGE REQUIREMENTS.

GEOTEXTILES, IMPERMEABLE LINERS, AND DRAIN PIPES.

- . USE A WOVEN GEOTEXTILE WITH HIGH BI-AXEL STRENGTH.
- 2. PLACE THE GEOTEXTILE ON THE BOTTOM AND SIDES OF THE SOIL SUB-GRADE. ELIMINATE WRINKLES IN THE GEOTEXTILE AND ENSURE IT IS NOT DAMAGED DURING CONSTRUCTION.
- 3. OVERLAP OF GEOTEXTILE SHALL BE A MINIMUM 2'-O" IN THE DIRECTION OF DRAINAGE. OVERLAPPING SHOULD BE "SHINGLE" STYLE WITH RESPECT TO ANY SLOPE DIRECTION AND BASE STONE DISTRIBUTION DIRECTION. KEEP PROPERLY TENSIONED, ELIMINATE WRINKLES, AND AVOID DAMAGING FABRIC (NO SPIKES).

- USE SUB-BASE ASTM NO. 2 OR NO. 3 MEETING THE FOLLOWING REQUIREMENTS:
 - 90% FRACTURED SYMMETRICAL PARTICALS
- LESS THAN 5% PASSING 200 SIEVE C. INDUSTRY HARDNESS TESTED
- 2. MOISTEN SPREAD AND COMPACT ASTM NO. 2 AGGREGATE SUB-BASE IN MINIMUM 6" LIFTS (WITHOUT DAMAGING OR DISTORTING THE GEOTEXTILE).
- 3. MAKE AT LEAST TWO PASSES IN VIBRATORY MODE FOLLOWED BY AT LEAST TWO PASSES IN STATIC MODE WITH A MINIMUM IO TON VIBRATORY ROLLER, UNTIL THERE IS NOT VISIBLE MOVEMENT OF THE AGGREGATE.
- 4. DO NOT ALLOW COMPACTOR TO CRUSH AGGREGATE. 5. SURFACE TOLERANCE OF THE ASTM NO. 2 SUB-BASE SHOULD BE ±21/2" OVER 10'.

- INSTALL AVIGNON, BELGIK, PIETRA, TUNDRA, OR UNIVERSAL EDGE CUT UNITS. CAST-IN-PLACE CONCRETE OR PRECAST CONCRETE CURBS SHALL BE UTILIZED IN VEHICULAR APPLICATIONS.
- 2. EDGE RESTRAINT MAY REST ON AN OPEN-GRADED OR DENSE-GRADED AGGREGATE BASE.

- I. MOISTEN, SPREAD AND COMPACT THE ASTM NO. 57 AGGREGATE BASE LAYER IN ONE 4"
- THICK LIFT. 2. MAKE A MINIMUM OF TWO PASSES IN VIBRATORY MODE FOLLOWED BY AT LEAST TWO STATIC MODE WITH A MINIMUM IO TON ROLLER, UNTIL NO VISIBLE MOVEMENT OF THE AGGREGATE. ALTERNATIVELY, A 13,500 LB PLATE COMPACTOR CAN BE USED TO COMPACTER ASTM NO. 57 AGGREGATE BASE.
- 3. DO NOT ALLOW COMPACTOR TO CRUSH AGGREGATE.
- 4. SURFACE TOLERANCE OF THE ASTM NO. 57 BASE SHOULD BE ±1" OVER 10'.

BEDDING COURSE

- I. MOISTEN, SPREAD AND SCREED ASTM NO 8. AGGREGATE BEDDING LAYER IN ONE 2"
- 2. SURFACE TOLERANCE OF THE ASTM NO 8. BEDDING COURSE ±3/8" OVER 10' 3. CONSTRUCTION EQUIPMENT AND PEDESTRIAN TRAVEL ON SCREEDED BEDDING COARSE IS

- . PAVERS SHOULD BE PLACED IN PATTERN SHOWN ON DRAWINGS. LAY UNITS TIGHT TO DESIGNATED LAYING PATTERNS. UNITS HAVE LUGS TO MAINTAIN CONSISTENT JOINT WIDTH.
- 2. IN SLOPED CONDITIONS START LAYING FROM THE BOTTOM IN AN UPHILL DIRECTION.
- 3. THE MINIMUM SLOPE FOR PERMEABLE PAVEMENT SURFACE IS 1%.
- 4. INFLO PAVERS CAN BE INSTALLED WITH TBIOOSI (TECHO-BLOC MECHANICAL TOOL) TO
- EXPEDITE INSTALLATION. 5. WHEN SUBJECT IT VEHICULAR TRAFFIC, CUT UNITS SHOULD NOT BE SMALLER THEN 为 THE
- WHOLE PAVER. WHEN USING CUT PAVERS MAINTAIN JOINT. 6. IN VEHICULAR APPLICATION LAY PATTERN PERPENDICULAR TO TRAFFIC FLOW.


- I. FILL PAVER JOINT OPENINGS WITH ASTM NO. 8 AGGREGATE. SWEEP STONE TO FILL JOINTS. SURFACE MUST BE SWEPT CLEAN PRIOR TO COMPACTION
- 2. COMPACT WITH 5,000 LB PLATE COMPACTOR (TWO PASSES MINIMUM). INSTALL OF NEOPRENE PAD TO PROTECT THE TEXTURE OF THE PAVING UNITS.
- 3. DO NOT COMPACT WITHIN 6' OF UNRESTRAINED EDGES OF PAVERS.
- 4. APPLY ADDITIONAL AGGREGATE TO FILL THE JOINT OPENINGS IF NEEDED AND COMPACT.
- 5. SURFACE TOLERANCE OF COMPACTED PAVERS SHOULD BE $\pm \frac{3}{6}$ " OVER IO'.

POST INSTALLATION PROTECTION

I. MAINTAIN EROSION AND SEDIMENT MEASURES AT PERIMETER TO PREVENT CONTAMINATION OF POROUS PAVEMENT SYSTEM.

MAINTENANCE NOTES

- A. Maintenance of Common Facilities or Property
- 1. Future owners or assigns are responsible for maintenance of all stormwater infrastructure associated with the facility and the property. This includes the roof drainage system, stone infiltration beds, gravel areas, and the pervious pavers.
- B. General Inspection and Maintenance Requirements
- 1. Permanent stormwater and sediment and erosion control facilities to be maintained on the site include but are not limited to the following:
- a. Pervious Pavers
- 2. Maintenance of permanent measures shall follow the following schedule:
- a. The following requirements will help assure that the pervious pavers system is maintained to preserve its effectiveness:
 - i. Inspection of site shall occur monthly for the first few months after construction. Then inspections can occur on an annual basis, preferably after rain events when clogging can occur and be obvious. Permeable pavers require minimal maintenance; however maintenance is absolutely necessary to ensure a proper working system.
 - ii. Asphalt seal coating is absolutely forbidden. Surface seal coating is not reversible.
 - iii. Street sweepers with vacuums, water, and brushes can be used to restore permeability. Follow sweeping with high-pressure hosing of the surface pores. Surface should be vacuumed 4 times per year, and at any additional times sediment is spilled, eroded, or tracked onto the surface.
 - iv. Planted areas adjacent to pervious pavers should be well maintained to prevent soil washout onto the pavement. If any bare spots or eroded areas are observed within the planted areas, they should be replanted and/or stabilized at once.
 - v. Immediately clean any soil deposited on pavers. Superficial dirt does not necessarily clog the voids. However, dirt that is ground in repeatedly by tires can lead to clogging. Therefore, trucks or other heavy vehicles should be prevented from tracking or spilling dirt onto the pavement. Replace any damaged paving blocks.
 - vi. Do not allow construction staging, soil/mulch storage, etc. on unprotected pavers surface.
 - vii. No winter sanding. Mechanical snow and ice removal preferred.
 - viii. Written and verbal communication to the porous paver's future owner should make clear the special purpose and special maintenance requirements such as those listed here.

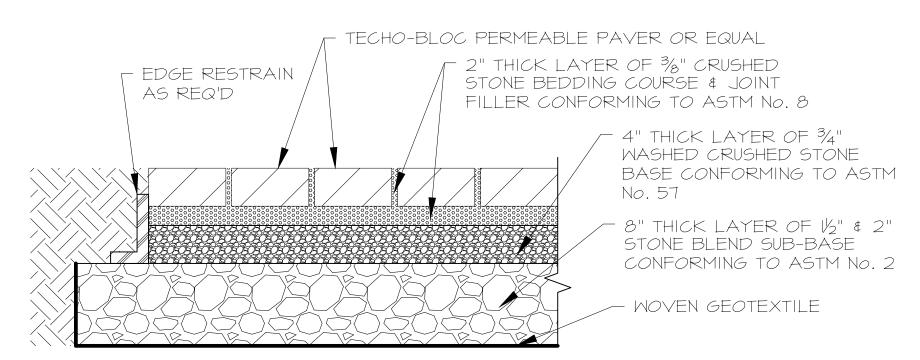

PERVIOUS PAVERS DETAIL

ANNUAL OPERATIONS & MAINTENANCE REPORT

ACTIVITY	DATE OF INSPECTION	WHO INSPECTED	SATISFACTORY: YES, NO, N/A	MAINTENANCE NEEDED	IMPLEMENTED DATE OF CORRECTIVE ACTION	FINDINGS OF INSPECTOR
PARKING LOT SWEEPING PERVIOUS PAVEMENT						

8	10/19/2022	PRELIMINARY				
7	10/4/2022	PRELIMINARY				
6	9/23/2022	PRELIMINARY				
5	9/20/2022	PRELIMINARY				
4	9/9/2022	PRELIMINARY				
3	9/2/2022	PRELIMINARY				
2	8/18/2022	FOR RECORDING				
1	3/2/2022	PRELIMINARY				
ISS.	DATE	DESCRIPTION OF ISSUE				

 $\sqrt{\text{SCALE}}$ 1" = 10' A.ROSS D.D.D. CHECKED

ROSS ENGINEERING, LLC Civil/Structural Engineering & Surveying 909 Islington St. Portsmouth, NH 03801


(603) 433-7560

SEAPORT REALTY, LLC 76 EXETER RD. NEWMARKET, NH 03857

NOTES

85 DANIEL STREET, LLC 85 DANIEL ST PORTSMOUTH, NH 03801 TAX MAP 107, LOT 8


22-029 | 3 OF 3 | 8

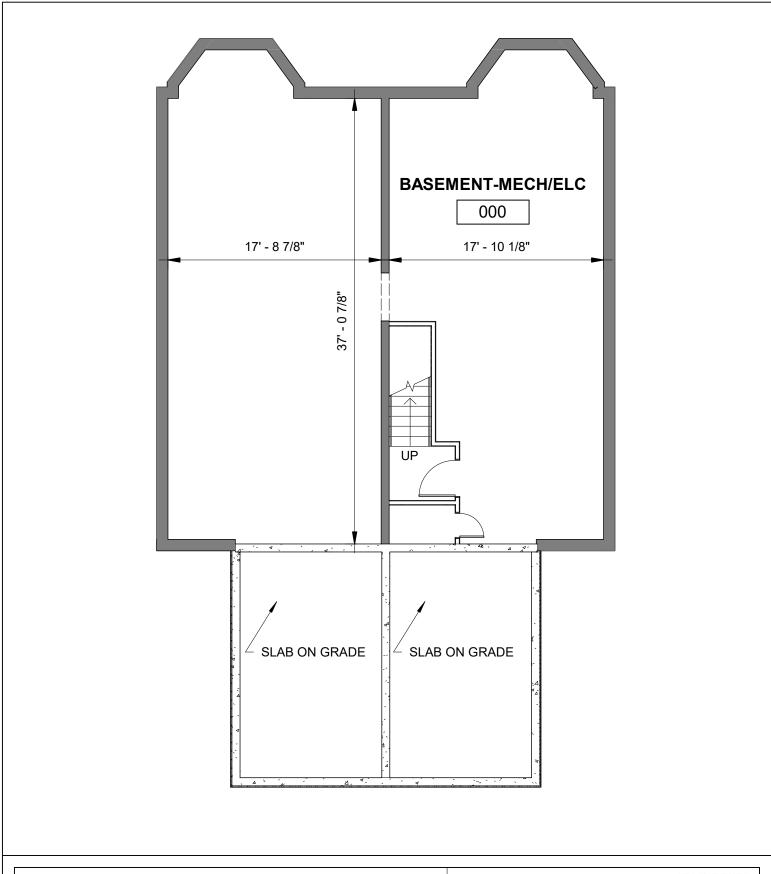


85 DANIEL STREET PORTSMOUTH, NH 03801			McHENRY ARCHITECTURE
	Project Number:	22081	
	Date:	10/17/2022	A-0
BASEMENT PLAN	Drawn By:	RD	
	Checked By:	MG	Scale 1/8" = 1'-0"



85 DANIEL STREET PORTSMOUTH, NH 03801				ACHENRY ITECTURE
	Project Number:	22081		
	Date:	10/17/2022		A-1
FIRST FLOOR PLAN	Drawn By:	RD	-	
	Checked By:	MG	Scale	1/8" = 1'-0"

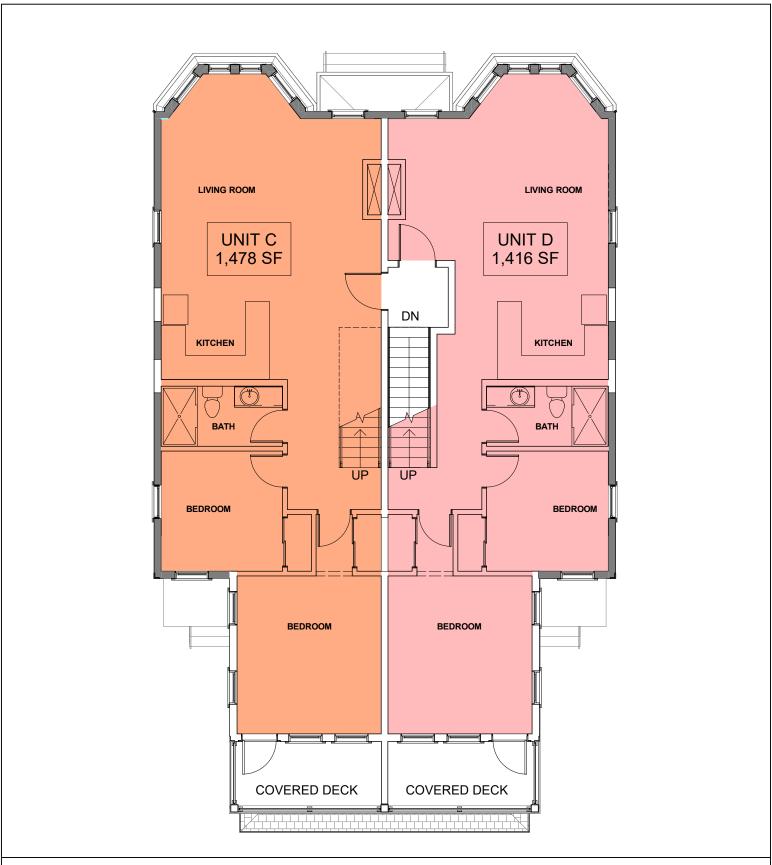

85 DANIEL STREET PORTSMOUTH, NH 03801				ACHENRY ITECTURE
	Project Number:	22081		
	Date:	10/17/2022		A-2
SECOND FLOOR	Drawn By:	RD	_	
	Checked By:	MG	Scale	1/8" = 1'-0"

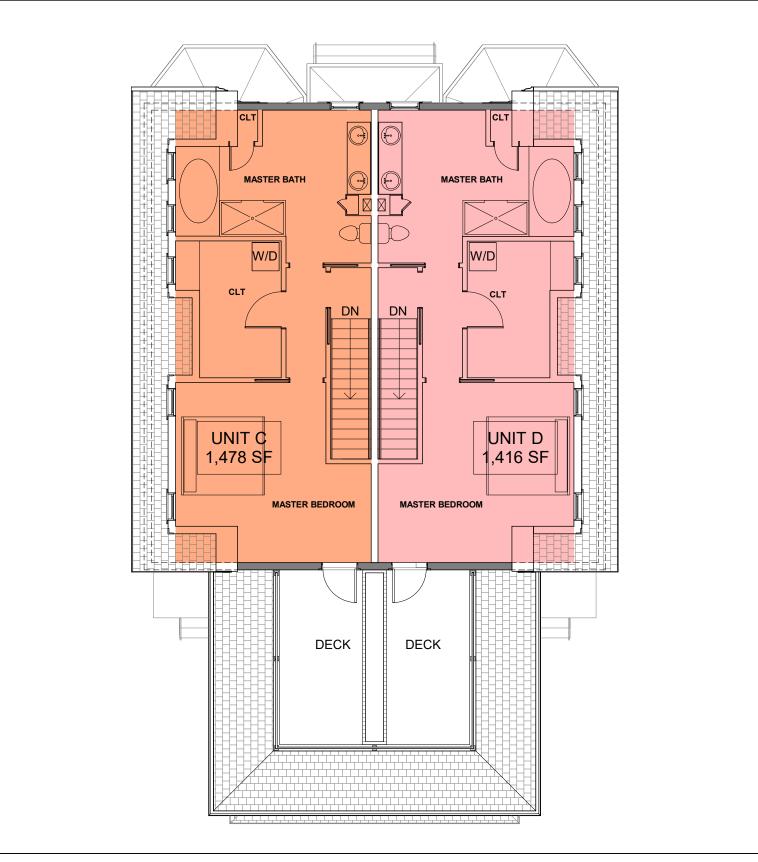

85 DANIEL STREET PORTSMOUTH, NH 03801				McHENRY ITECTURE
	Project Number:	22081		
	Date:	10/17/2022	/	4- 3
THIRD FLOOR	Drawn By:	RD	_	
	Checked By:	MG	Scale	1/8" = 1'-0"



85 DANIEL STREET PORTSMOUTH, NH 03801

VIEW FROM DANIEL STREET

McHENRY ARCHITECTURE

4 Market Street

Portsmouth, New Hampshire

06/17/2022 McHA: JD / RD / MG



85 DANIEL STREET PORTSMOUTH, NH 03801 VIEW FROM DANIEL STREET

McHENRY ARCHITECTURE

4 Market Street

Portsmouth, New Hampshire

McHA: JD / RD / MG A-5



85 DANIEL STREET PORTSMOUTH, NH 03801

VIEW FROM REAR ALLEY

McHENRY ARCHITECTURE

4 Market Street

Portsmouth, New Hampshire

06/17/2022 McHA: JD / RD / MG A-6




85 DANIEL STREET PORTSMOUTH, NH 03801 VIEW FROM REAR ALLEY

McHENRY ARCHITECTURE

4 Market Street

Portsmouth, New Hampshire

06/17/2022 McHA: JD / RD / MG A-7

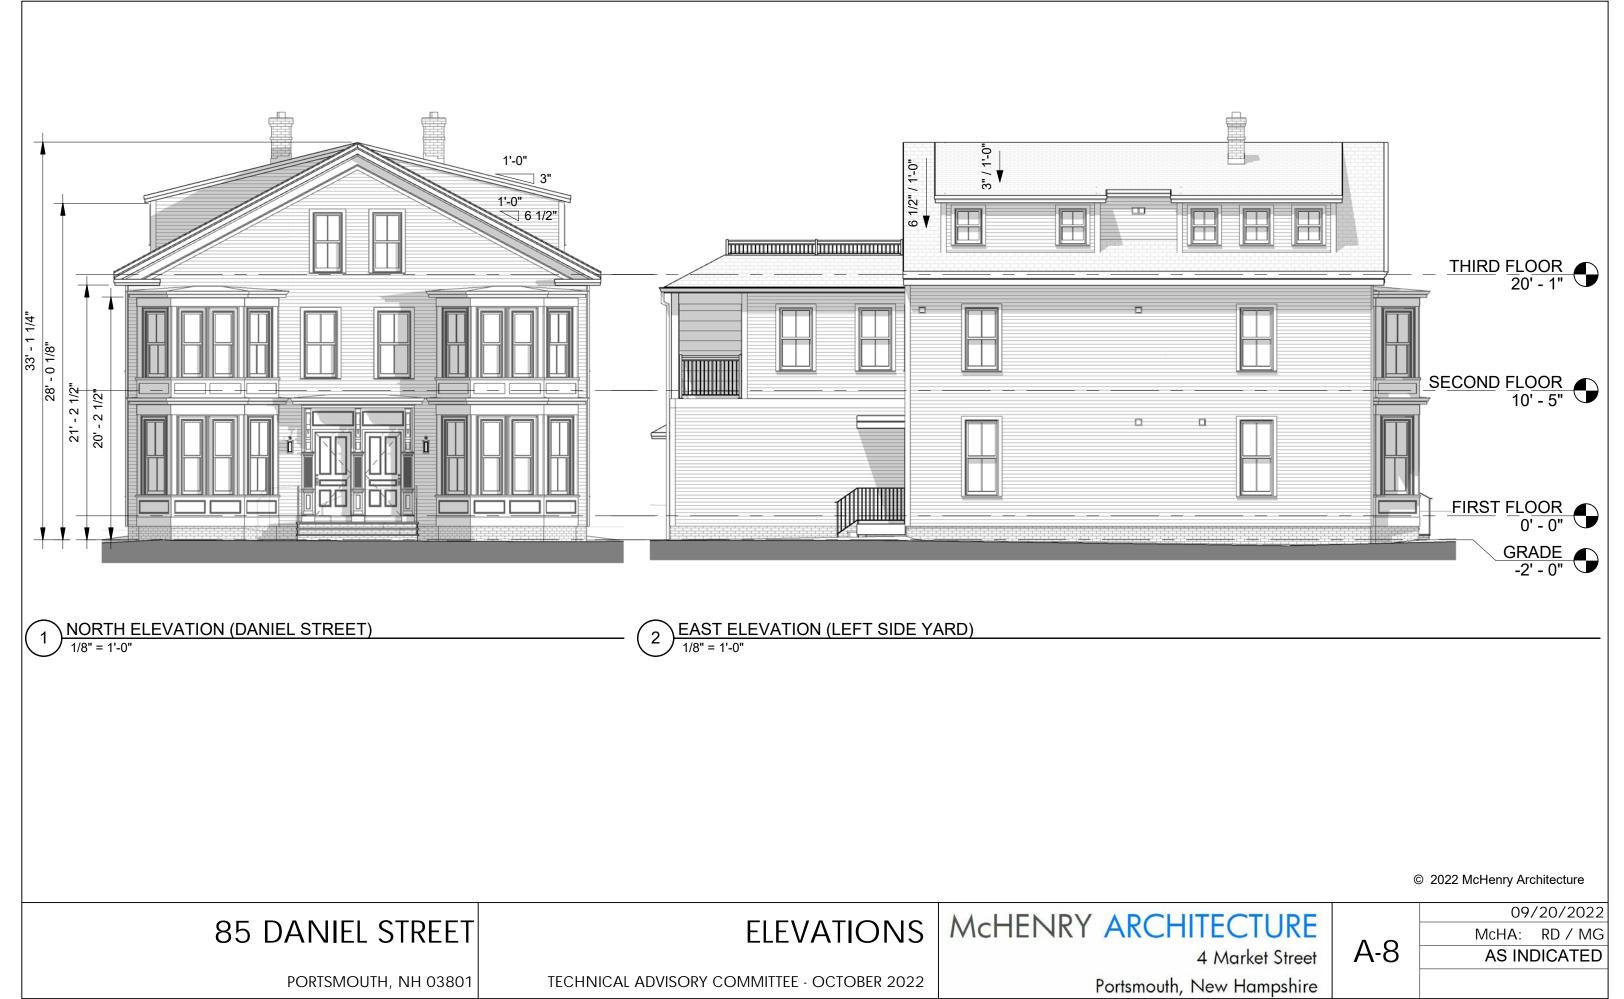



SOUTH ELEVATION (CUSTOM HOUSE LANE)

1/8" = 1'-0"

2 WEST ELEVATION (RIGHT SIDE YARD)
1/8" = 1'-0"

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85 DANIEL STREET

PORTSMOUTH, NH 03801

ELEVATIONS

McHENRY ARCHITECTURE

Portsmouth, New Hampshire

4 Market Street A

A-9

09/20/2022 McHA: RD / MG AS INDICATED