

### 53 Green Street - HDC Work Session and Public Hearing / Application for Approval

We respectfully submit this Application for Approval for the construction of a new Mixed-Use building located at 53 Green Street.

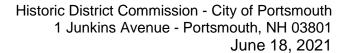
### **Work Session:**

- The Green Street Elevation has been shifted over 8' and grew by 4' total to meet zoning requirements.
- This modification allows for an increase in Commercial Space area with glazed corners, and maintains a 20 foot wide pedestrian way.
- The transformer has been relocated to a less prominent location improving the pedestrian experience at the Green Street entrance of the path.

### **Design Development Summary:**

- After studying several options for a Signature Portsmouth Style, this Curved Nautical Form emerged as the preferred identity for this location along North Mill Pond.
- Window patterns have been refined for a decidedly more residential feel.
- The memory of the existing arches carries forward as a backdrop for a landscaped earth berm framed by a low seating wall.
- Strong stepping forms allow the building to recede away from North Mill Pond and reveal more
  of the lighter-toned horizontal siding.
- The top floor is set back in a light horizontal band with pronounced overhangs. Horizontal siding further enhances the top floor ribbon.
- Details at the base of the building include varied cast stone and textured brick.
- Horizontal cast stone banding elements encircle the building at key elevations.
- Light metal balcony rails add texture.
- Windows and doors are appropriately detailed with traditional lintels, brick sills, and soldier courses.
- A Public Art installation is planned in cooperation with 3S Artspace located along the pedestrian way.

### CJ Architects





Please refer to the attached drawings for more information.

Thank you for your consideration. Sincerely,

Carla Goodknight, AIA Principal, CJ Architects

Representing: Jeff Johnston, Owner

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3.0 - 3.4: Materials

4.0: Scaled Drawings

- Floor Plans
- Elevations
- Building Sections
- Wall Sections
- Details
- Site Plan
- Landscape Plan









PORTSMOUTH, NEW HAMPSHIRE

VIEW FROM GREEN STREET
































### GARAGE SCREEN

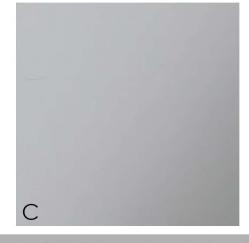MANUFACTURER: PARASOLEIL

PATTERN/COLOR: NUKUBALAVU / BLACK LICORICE










### COMPOSITE METAL PANELS

MANUFACTURER: REYNOBOND
PATTERN/COLOR: A= PURE WHITE

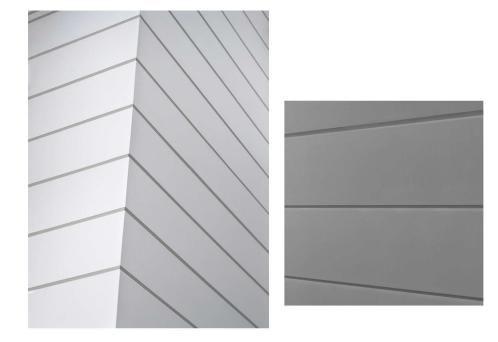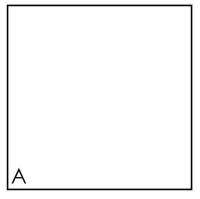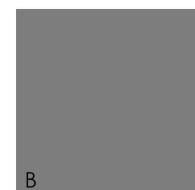B= PEWTER C=CADET GREY







### FIBER CEMENT SIDING

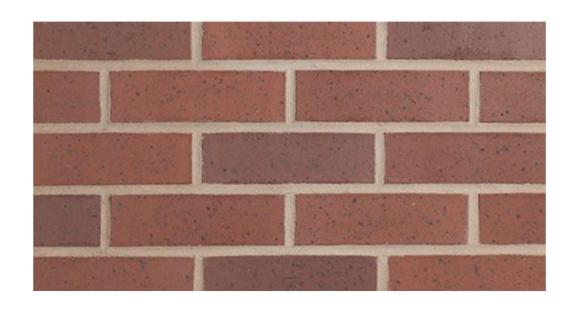
MANUFACTURER: ARTISAN SIDING
STYLE: V-GROOVE

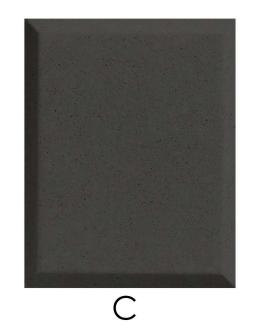
COLOR: A=STONE WHITE (SHIPLAP)
B=GREY SLATE (PANEL)

















BRICK

MANUFACTURER: **GLEN-GERY** 

COLOR: NAPA VALLEY SMIOOTH IRONSPOT MORTAR: NATURAL PORTLAND LIME CEMENT

SPECIAL INSTRUCTIONS: RUNNING BOND

MANUFACTURER: COLOR A:

NORTHERN DESIGN ARCHITECTURAL PRECAST & STONE MANUFACTURER: JAKOB ROPE SYSTEMS NATURAL LIMESTONE / LIGHT ETCH

CAST STONE

COLOR B: SLATE / LIGHT ETCH COLOR C: PEWTER / LIGHT ETCH

COLOR D: BRICK MATCH RED / LIGHT ETCH

53 GREEN STREET

PORTSMOUTH, NEW HAMPSHIRE



COLOR:



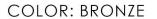
MATCH ADJACENT WINDOW COLOR

RAILINGS

PAINTED METAL TO

A





COLOR: STONE WHITE







CASEMENT AND AWNING WINDOWS

MANUFACTURER: MARVIN
SERIES: ESSENTIAL

MATERIALS

DOORS

MANUFACTURER: MARVIN

SERIES: SIGNATURE ULTIMATE OUTSWING DOOR

COLOR: MATCH WINDOWS

STOREFRONT

MANUFACTURER: TRIFAB

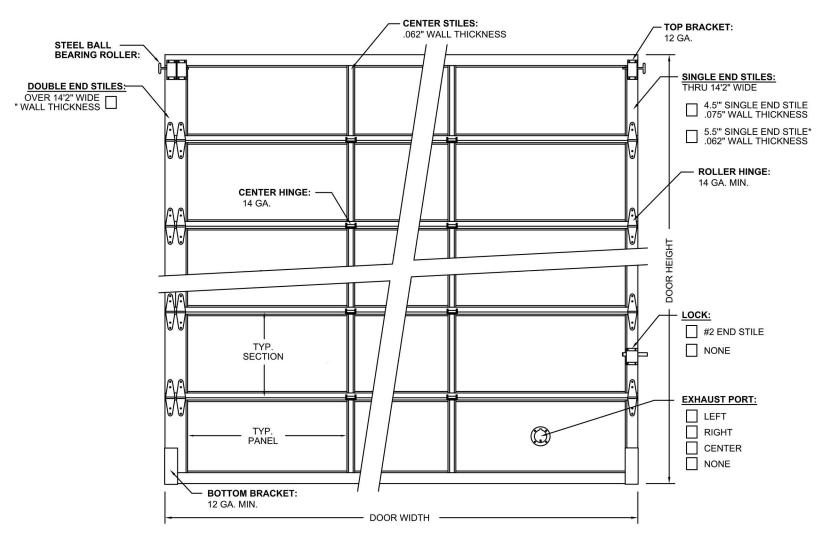
SERIES/COLOR A: 451UT / DARK BRONZE

SERIES/COLOR B: 451UT / ANODIZED ALUMINUM

STOREFRONT DOOR: MAHOGANY









### GARAGE DOOR

MANUFACTURER: CLOPAY MODEL: #904

PANEL COLOR: ALUMINUM PANEL COLOR MATCH

FRAME COLOR: DARK BROZE

Satin Stainless Steel US32D 630

Dark Oxidized Satin Bronze, Equivalent US10BE 613E

### DOOR PULLS

MANUFACTURER: ASSA ABLOY

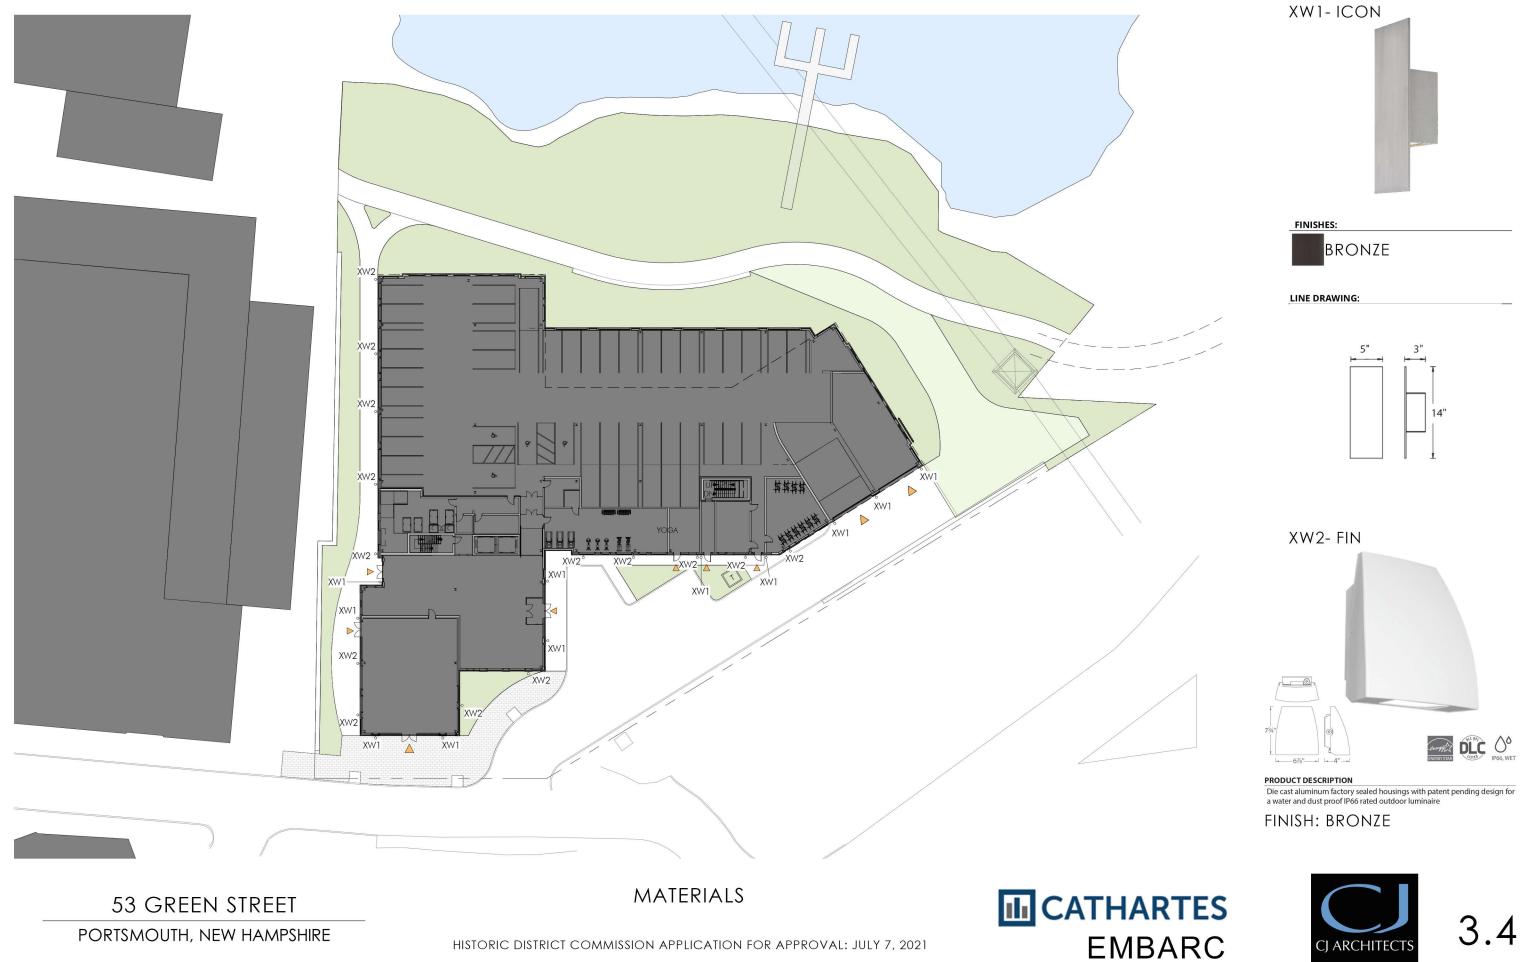
SERIES/COLOR A: NOIRMET - RM3810 / DARK BRONZE
SERIES/COLOR B: NOIRMET - RM3810 / STAINLESS STEEL

53 GREEN STREET

**MATERIALS** 







### THE FOLLOWING SECTION INCLUDES SCALED DRAWINGS:

-FLOOR PLANS

-ELEVATIONS

-BUILDING SECTIONS

-WALL SECTIONS

-DETAILS

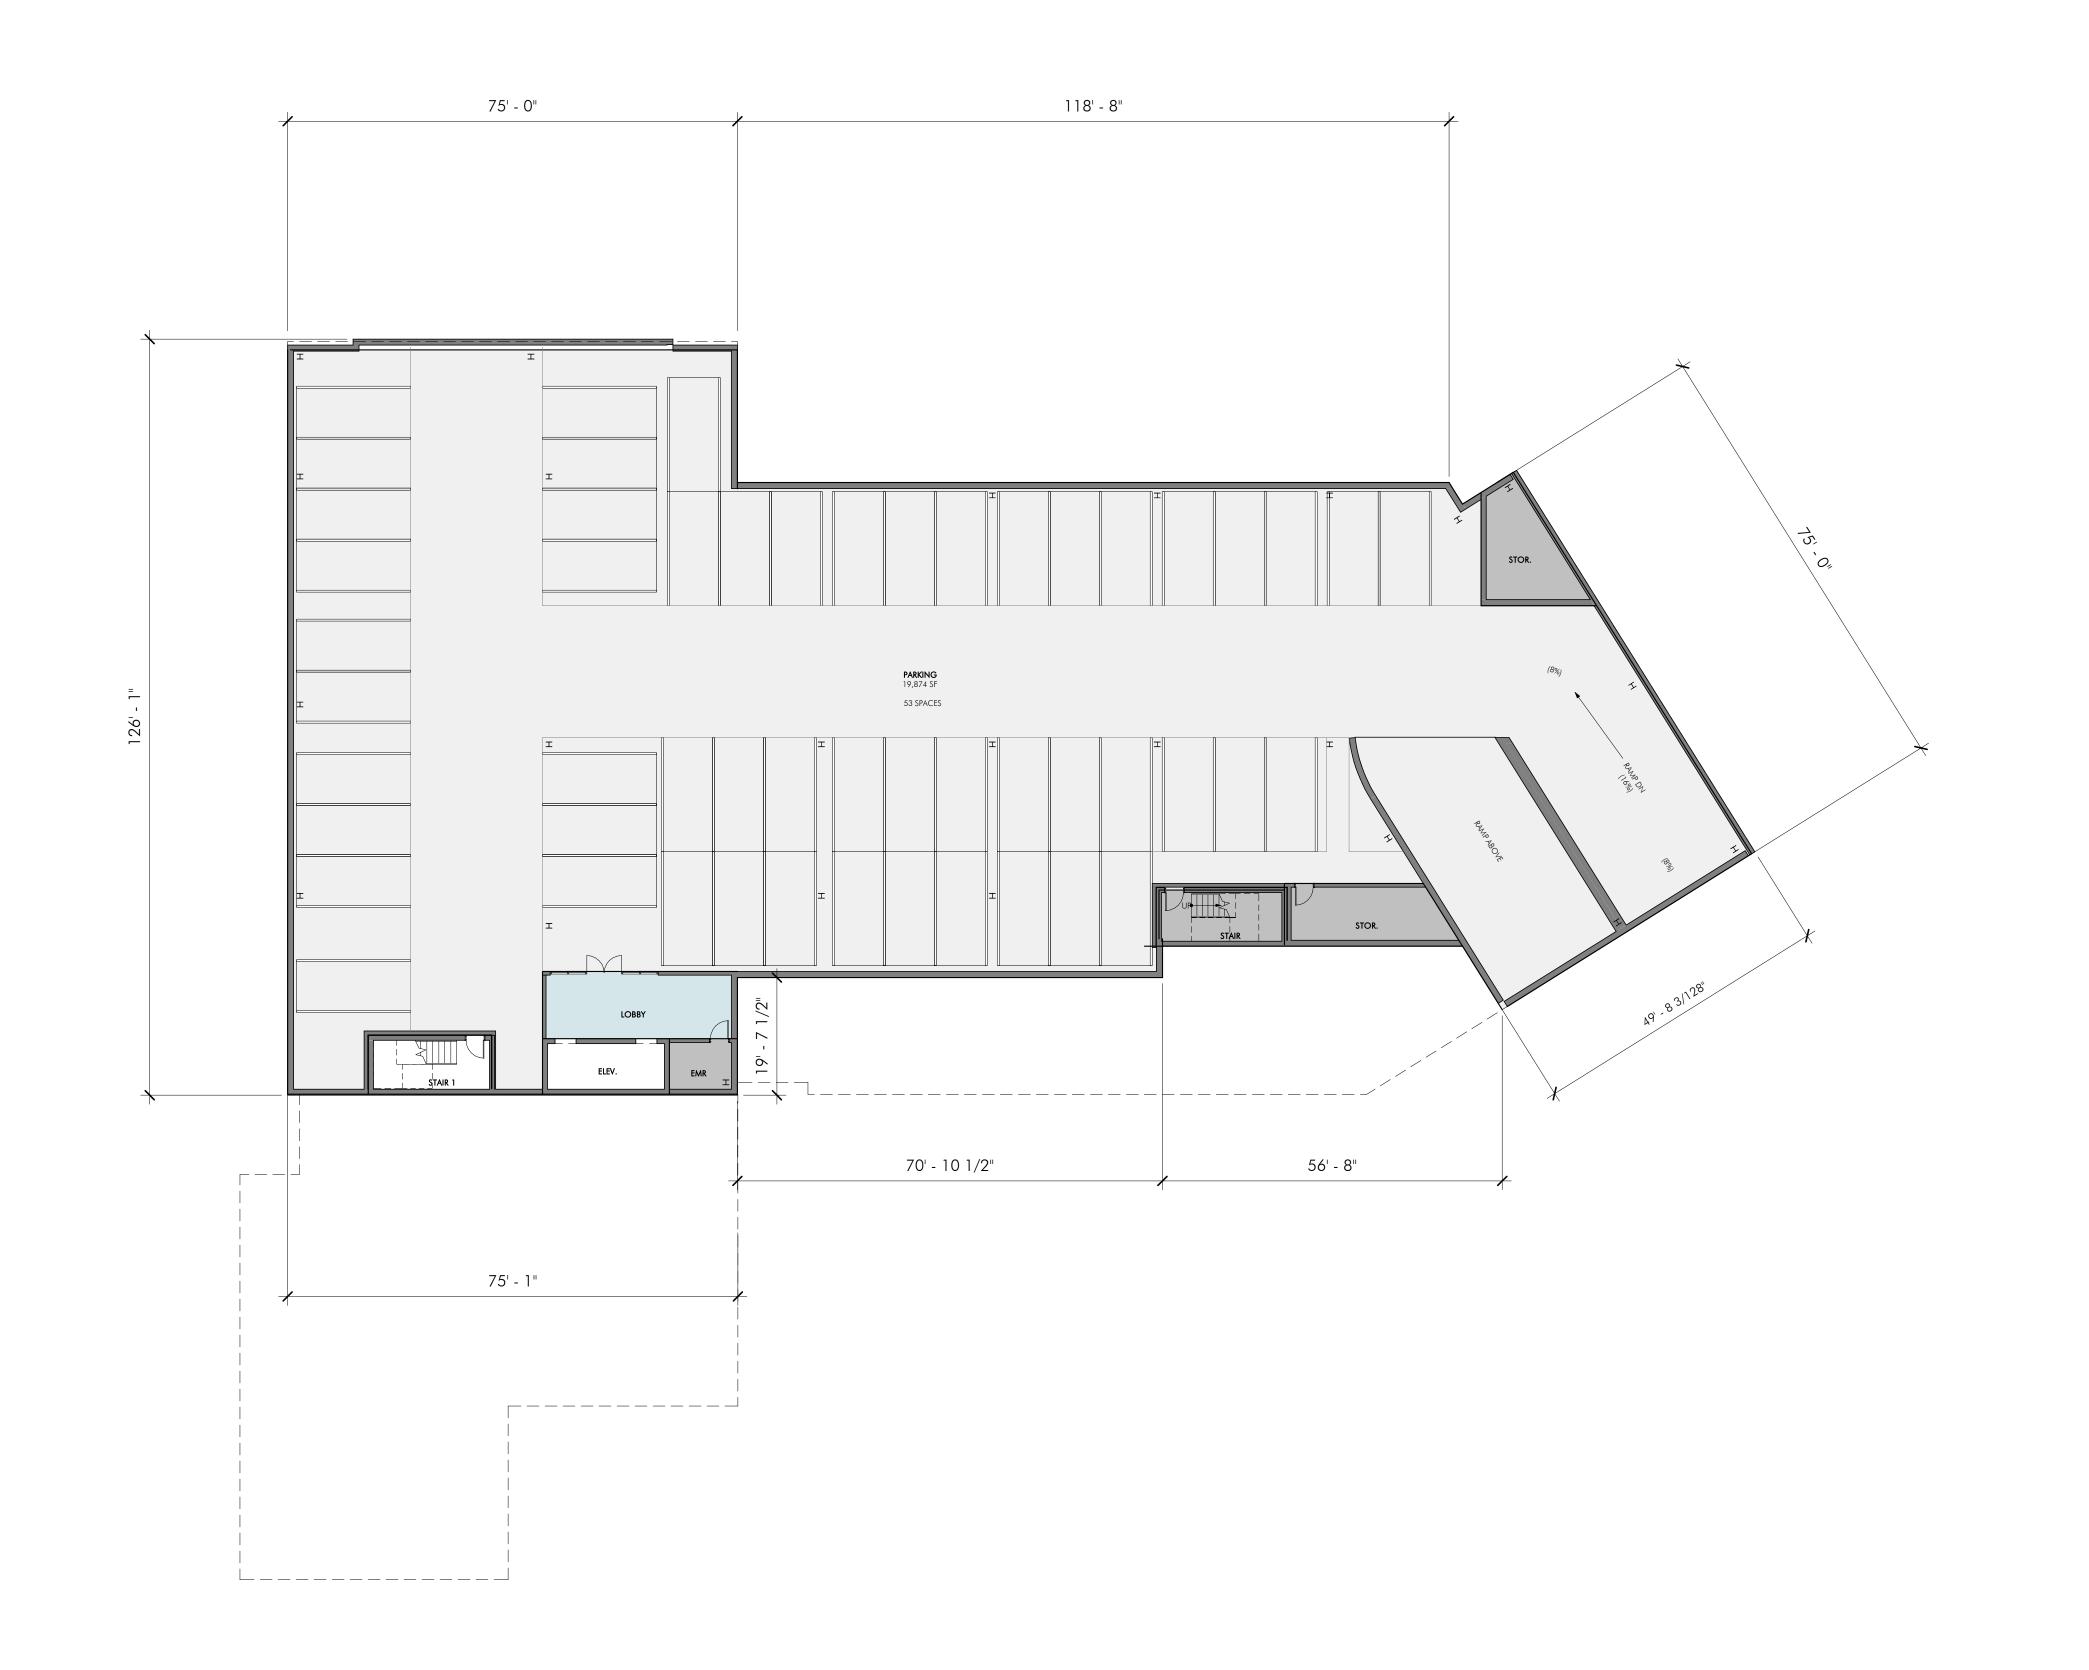
-SITE PLAN

- LANDSCAPE PLAN

53 GREEN STREET







ARCHITECT

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STREET 53 GREEN STREET PC 03801
HDC SUBM

SUBMISSION

REVISIONS

MARK ISSUE DATE

DRAWING INFORMATION ISSUE: HDC SUBMISSION

DATE: <u>JUNE 18, 2021</u> PROJECT #: 20055 SCALE: 1/16" = 1'-0"

DRAWING TITLE

BASEMENT FLOOR PLAN

DRAWING NUMBER

SUBMISSION

DRAWING INFORMATION

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FIRST FLOOR

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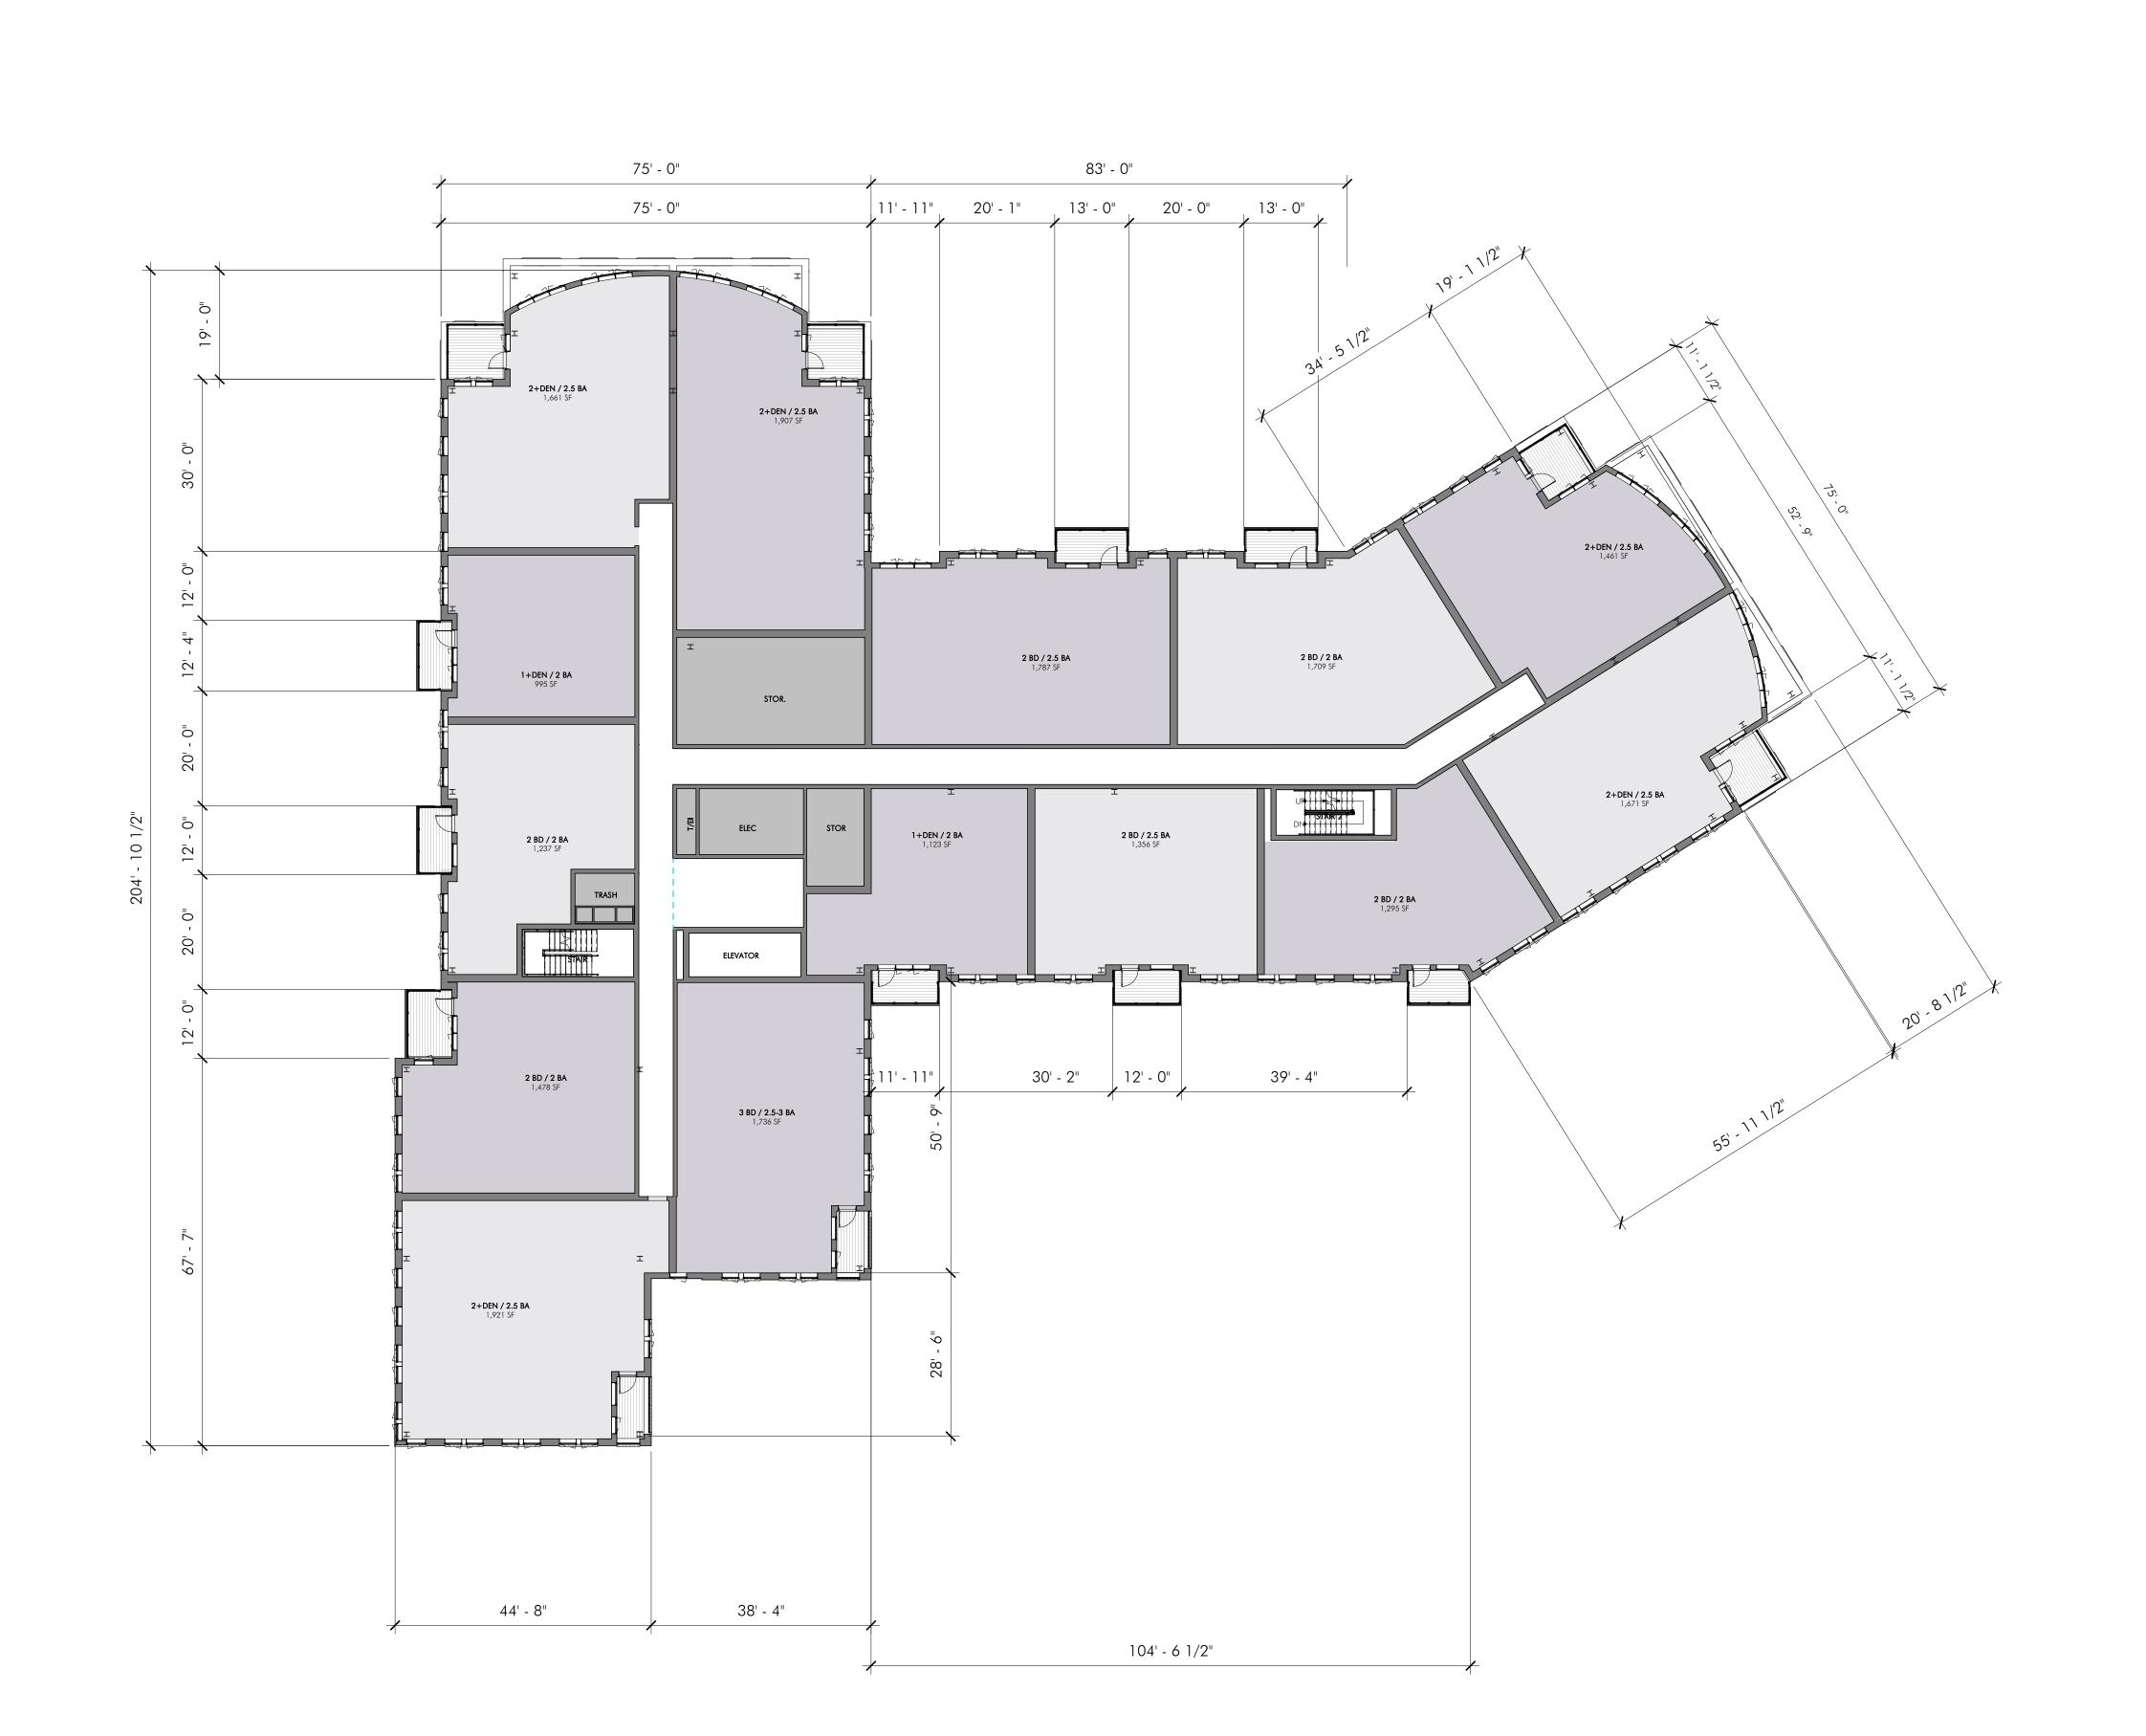
DRAWING INFORMATION

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SECOND FLOOR

DRAWING NUMBER





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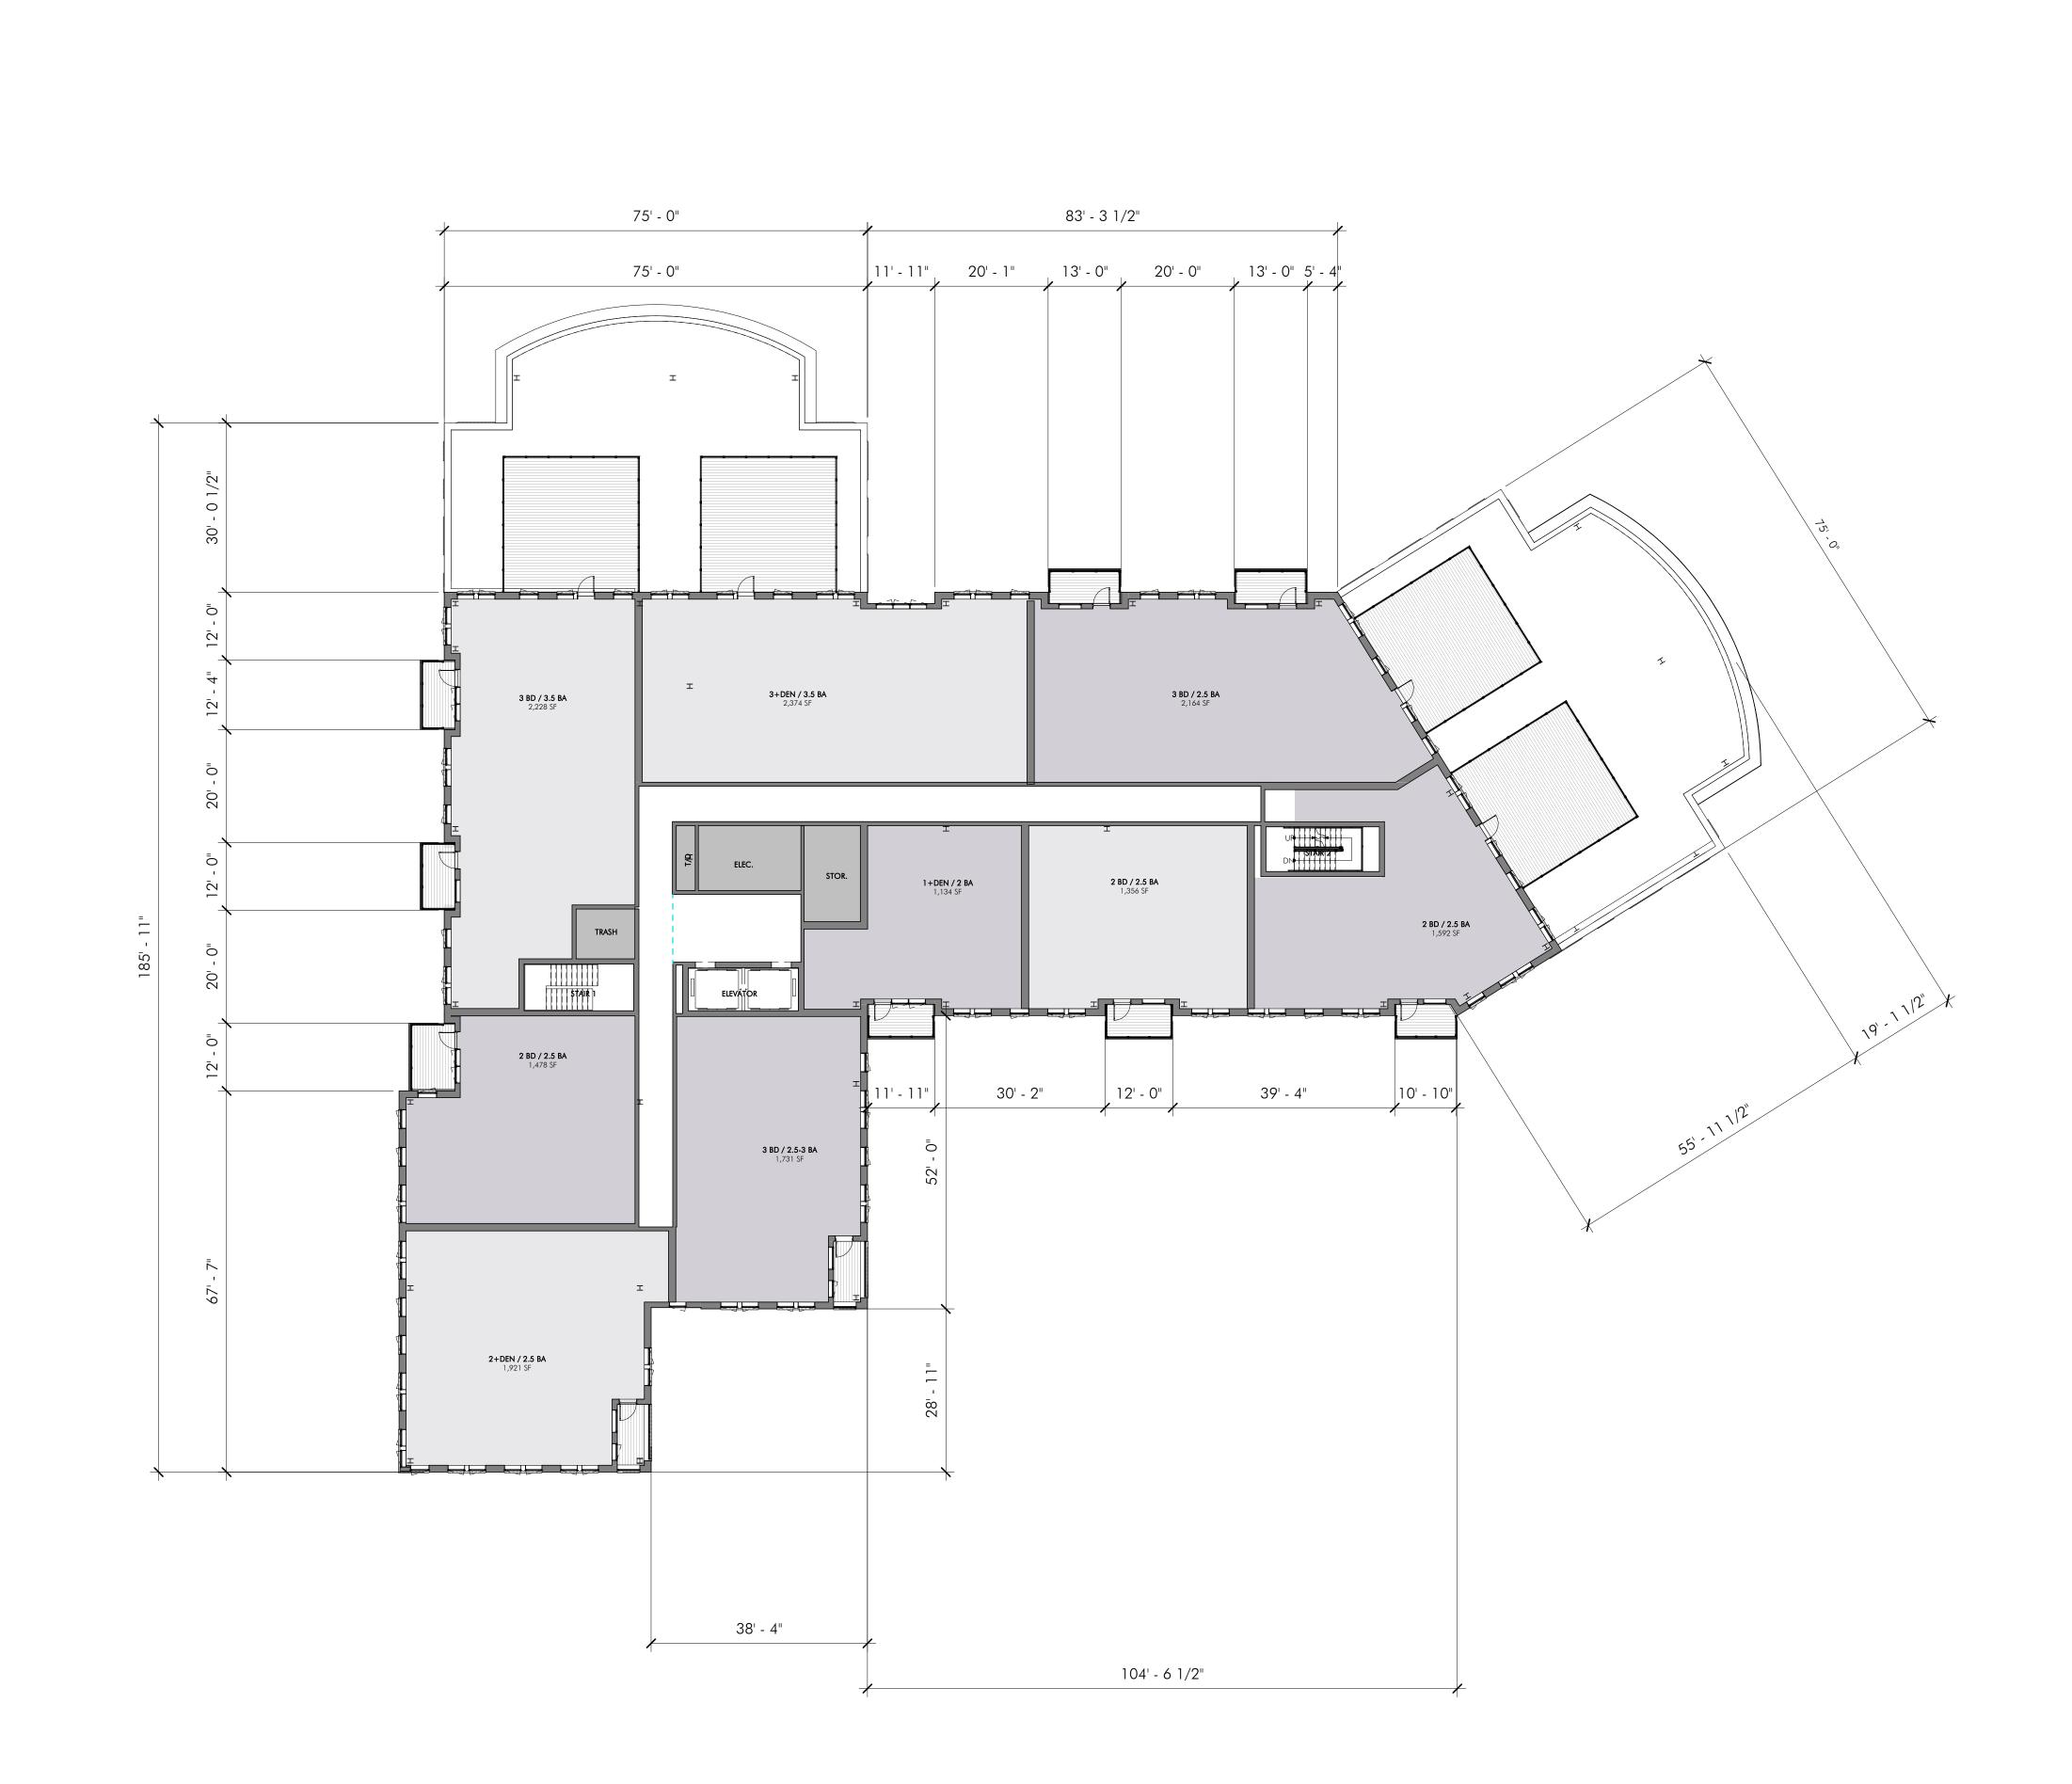
SCALE: 1/16" = 1'-0"

### DRAWING TITLE

THIRD FLOOR PLAN

# DRAWING NUMBER





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# DRAWING TITLE

FOURTH FLOOR PLAN

# DRAWING NUMBER

140' - 3"

66' - 8 1/2"

71' - 9 1/2"

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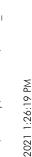
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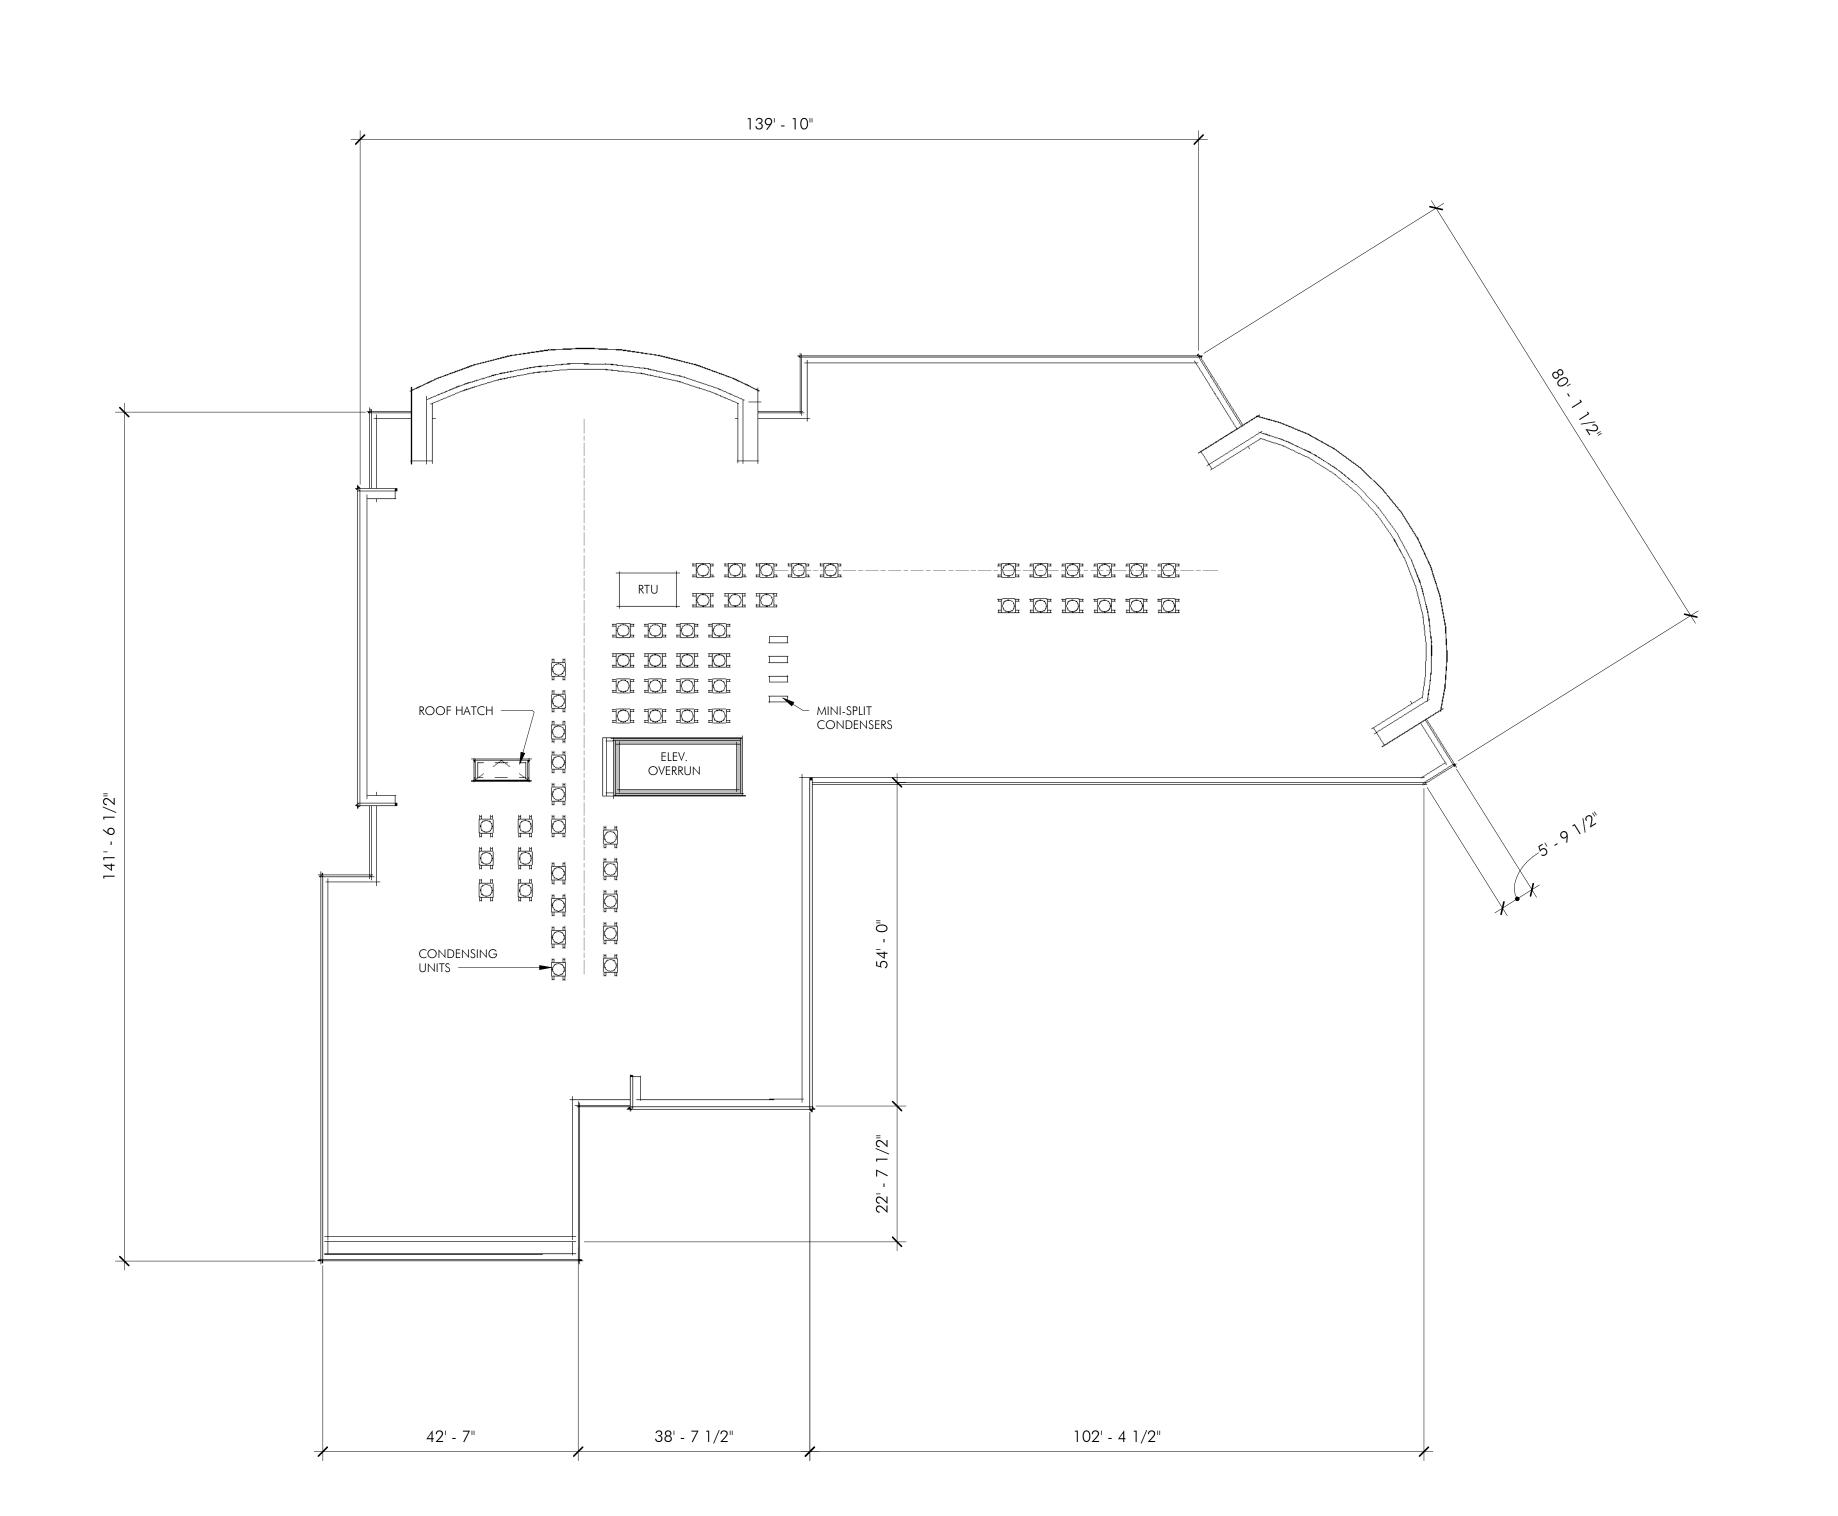
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# DRAWING TITLE

FIFTH FLOOR PLANS

# DRAWING NUMBER





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ROOF PLAN

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KEY PLAN

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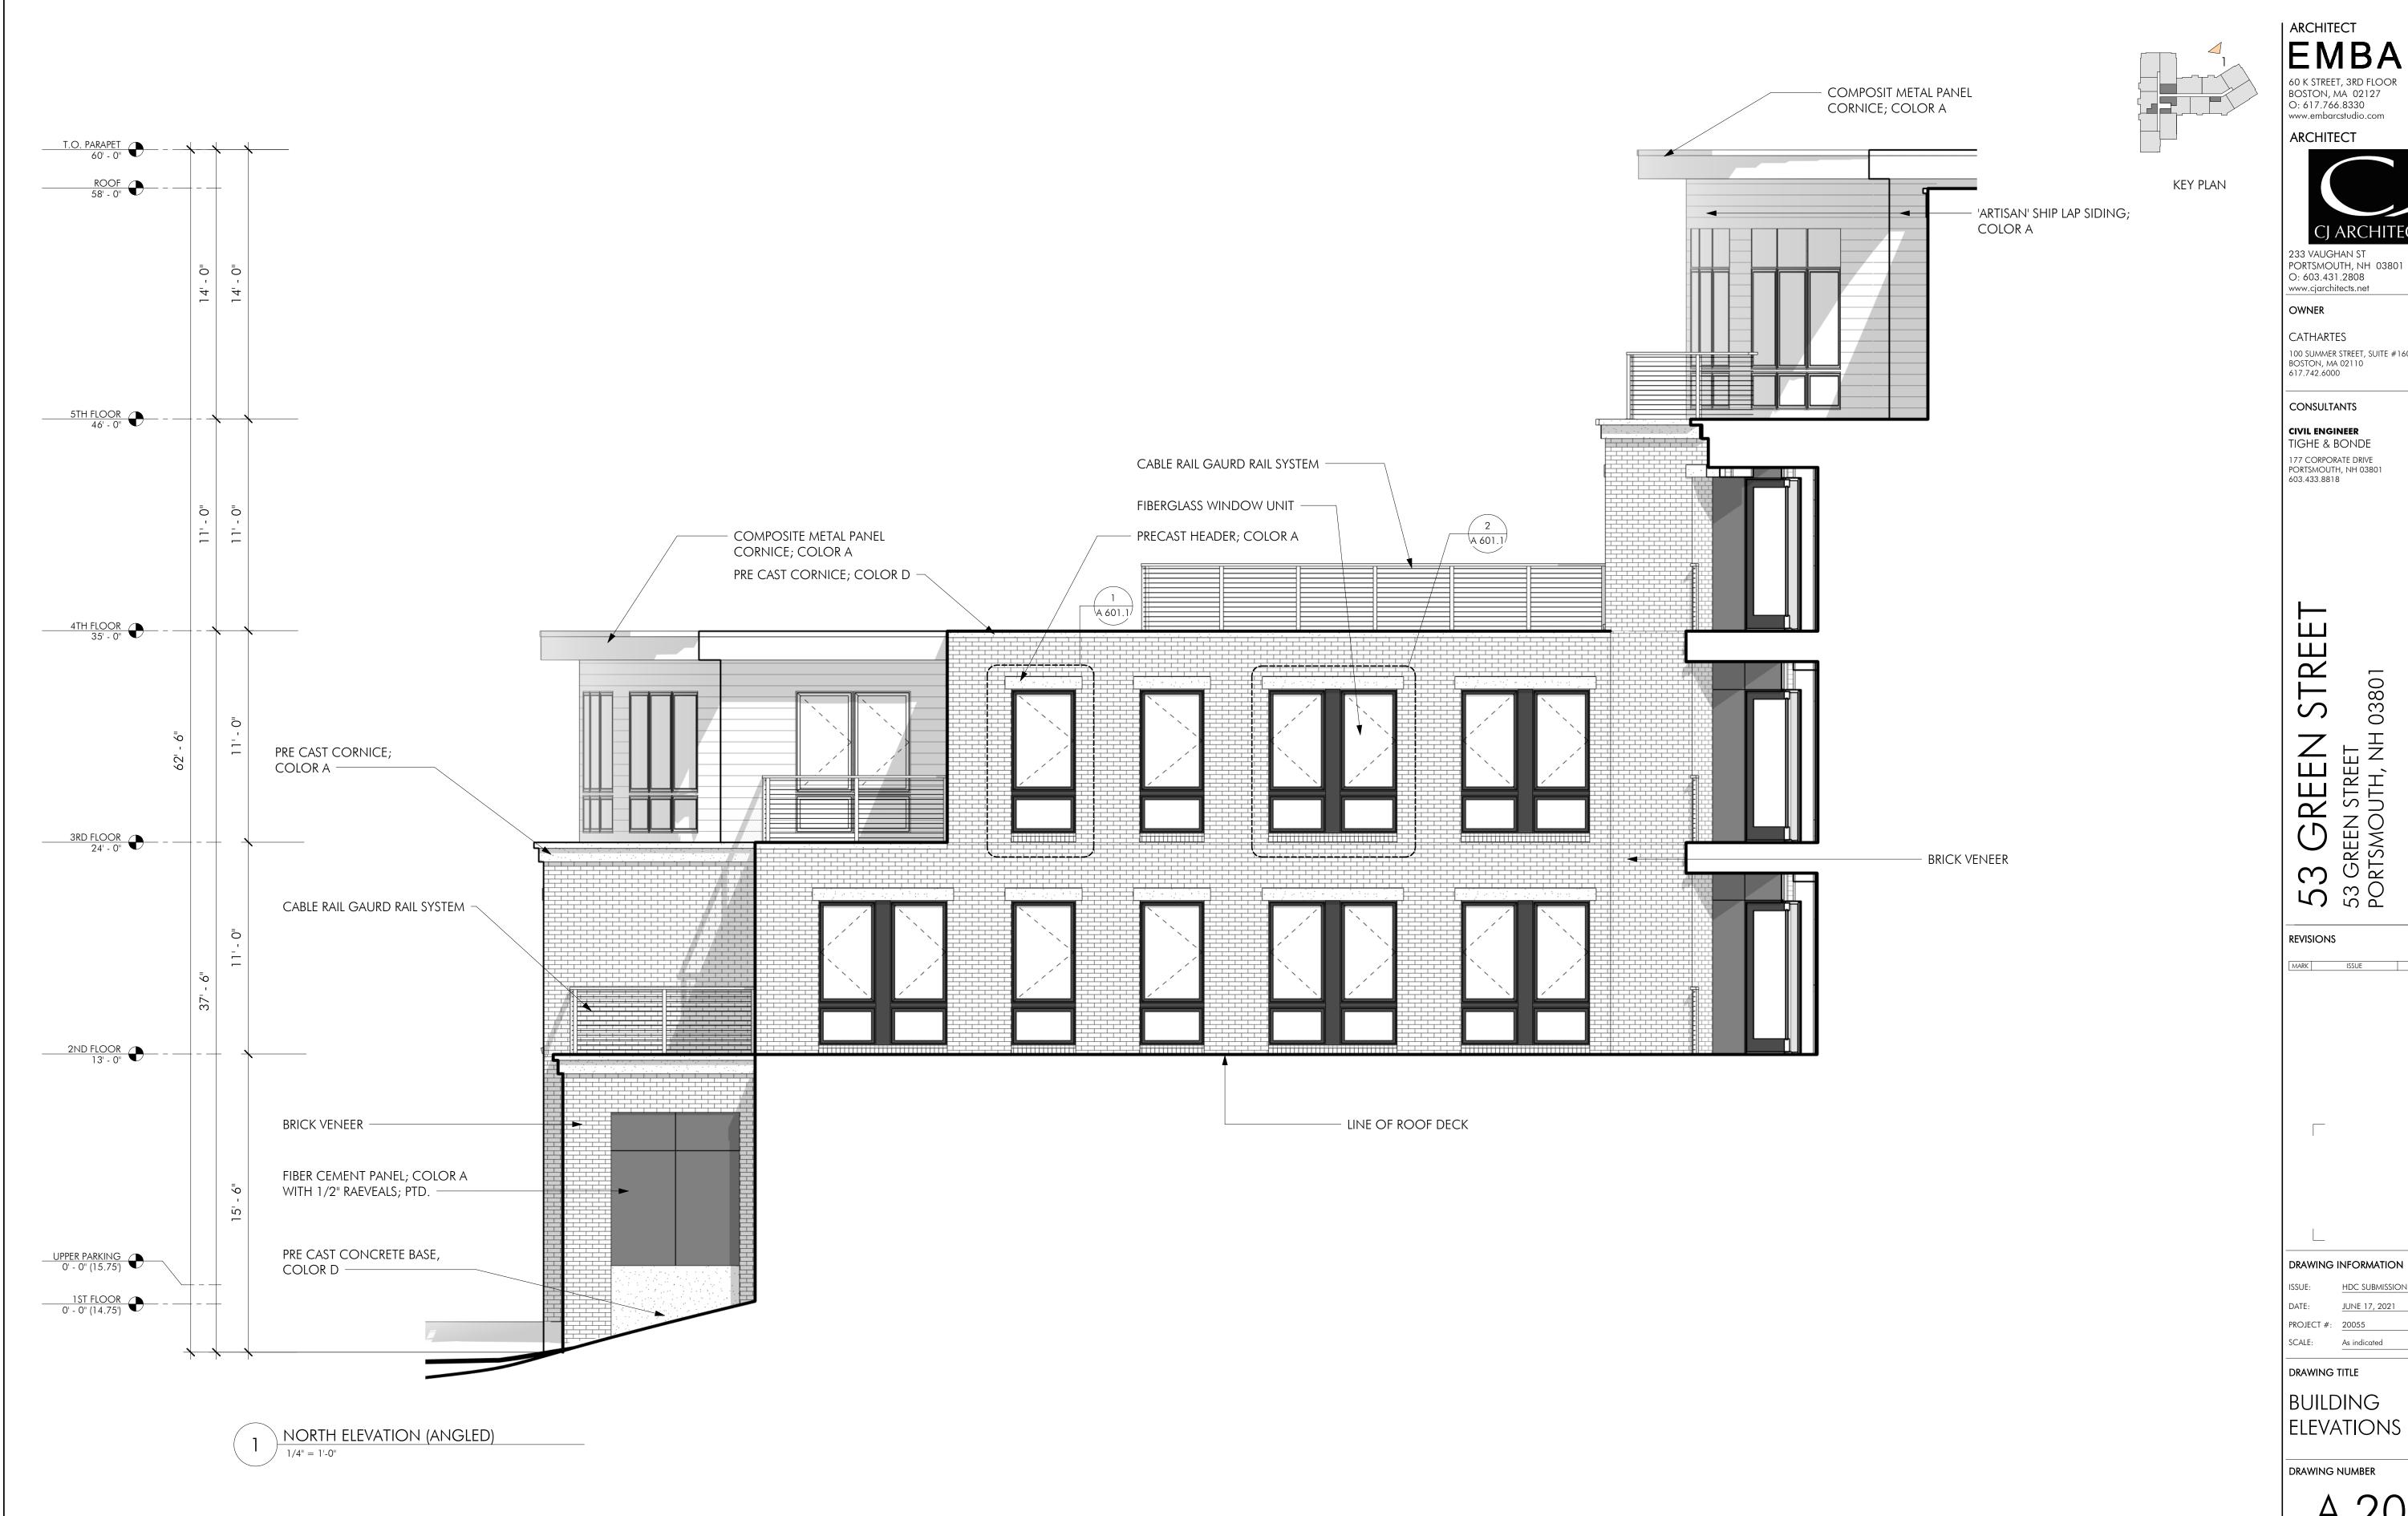
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BUILDING ELEVATIONS

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BUILDING ELEVATIONS

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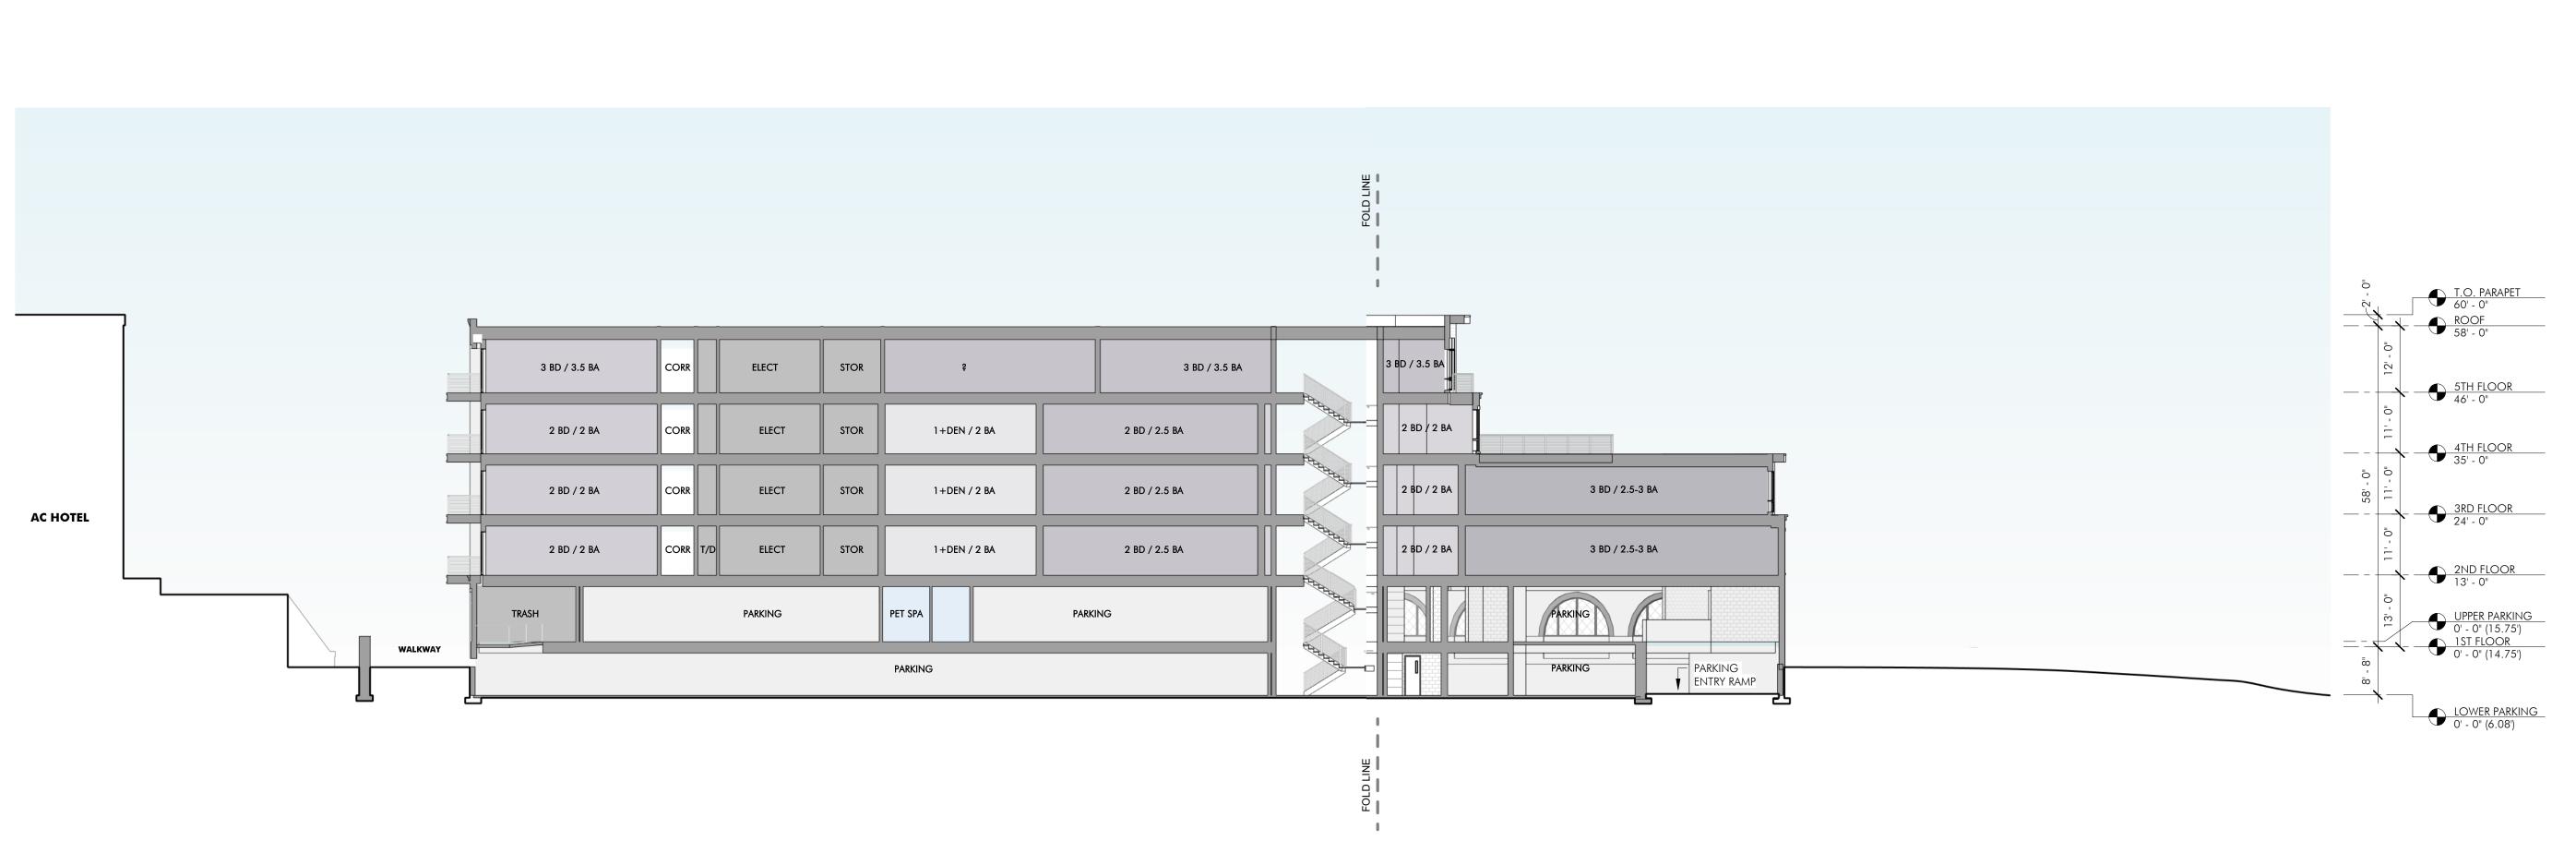
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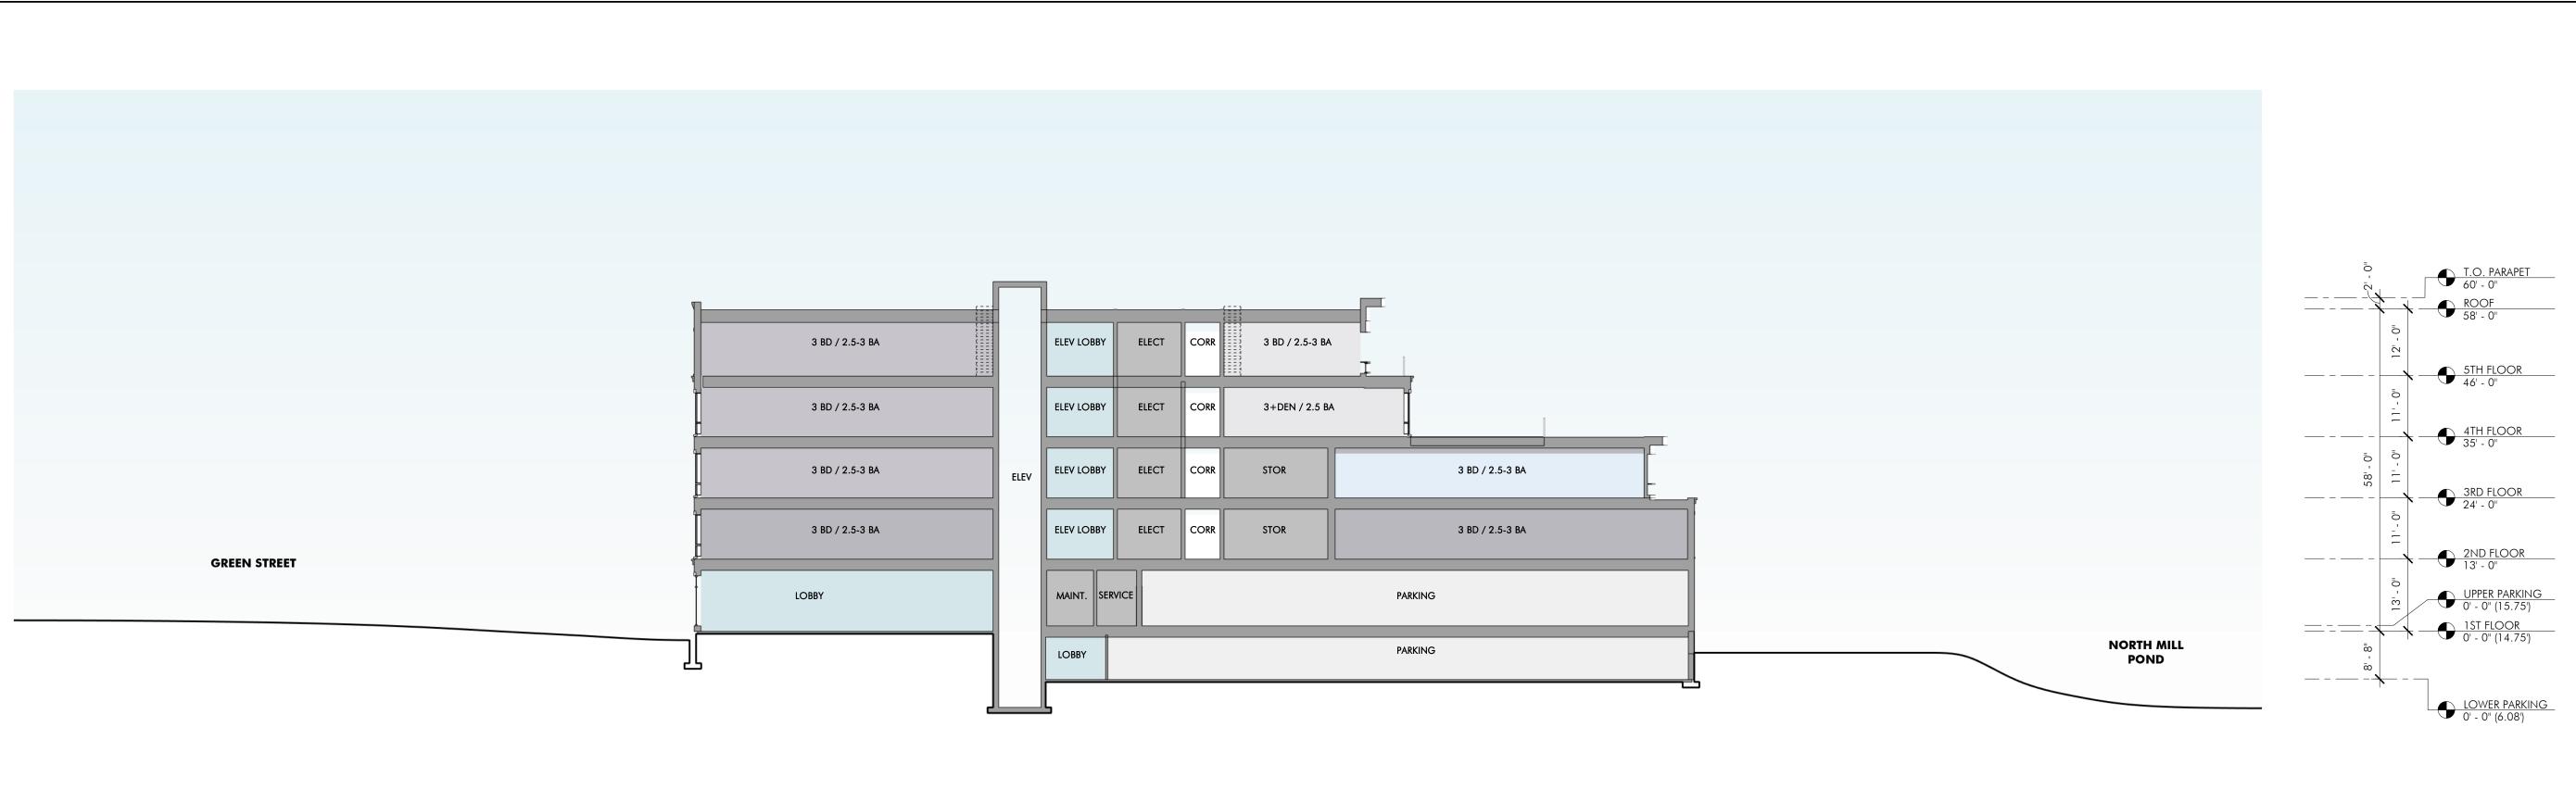
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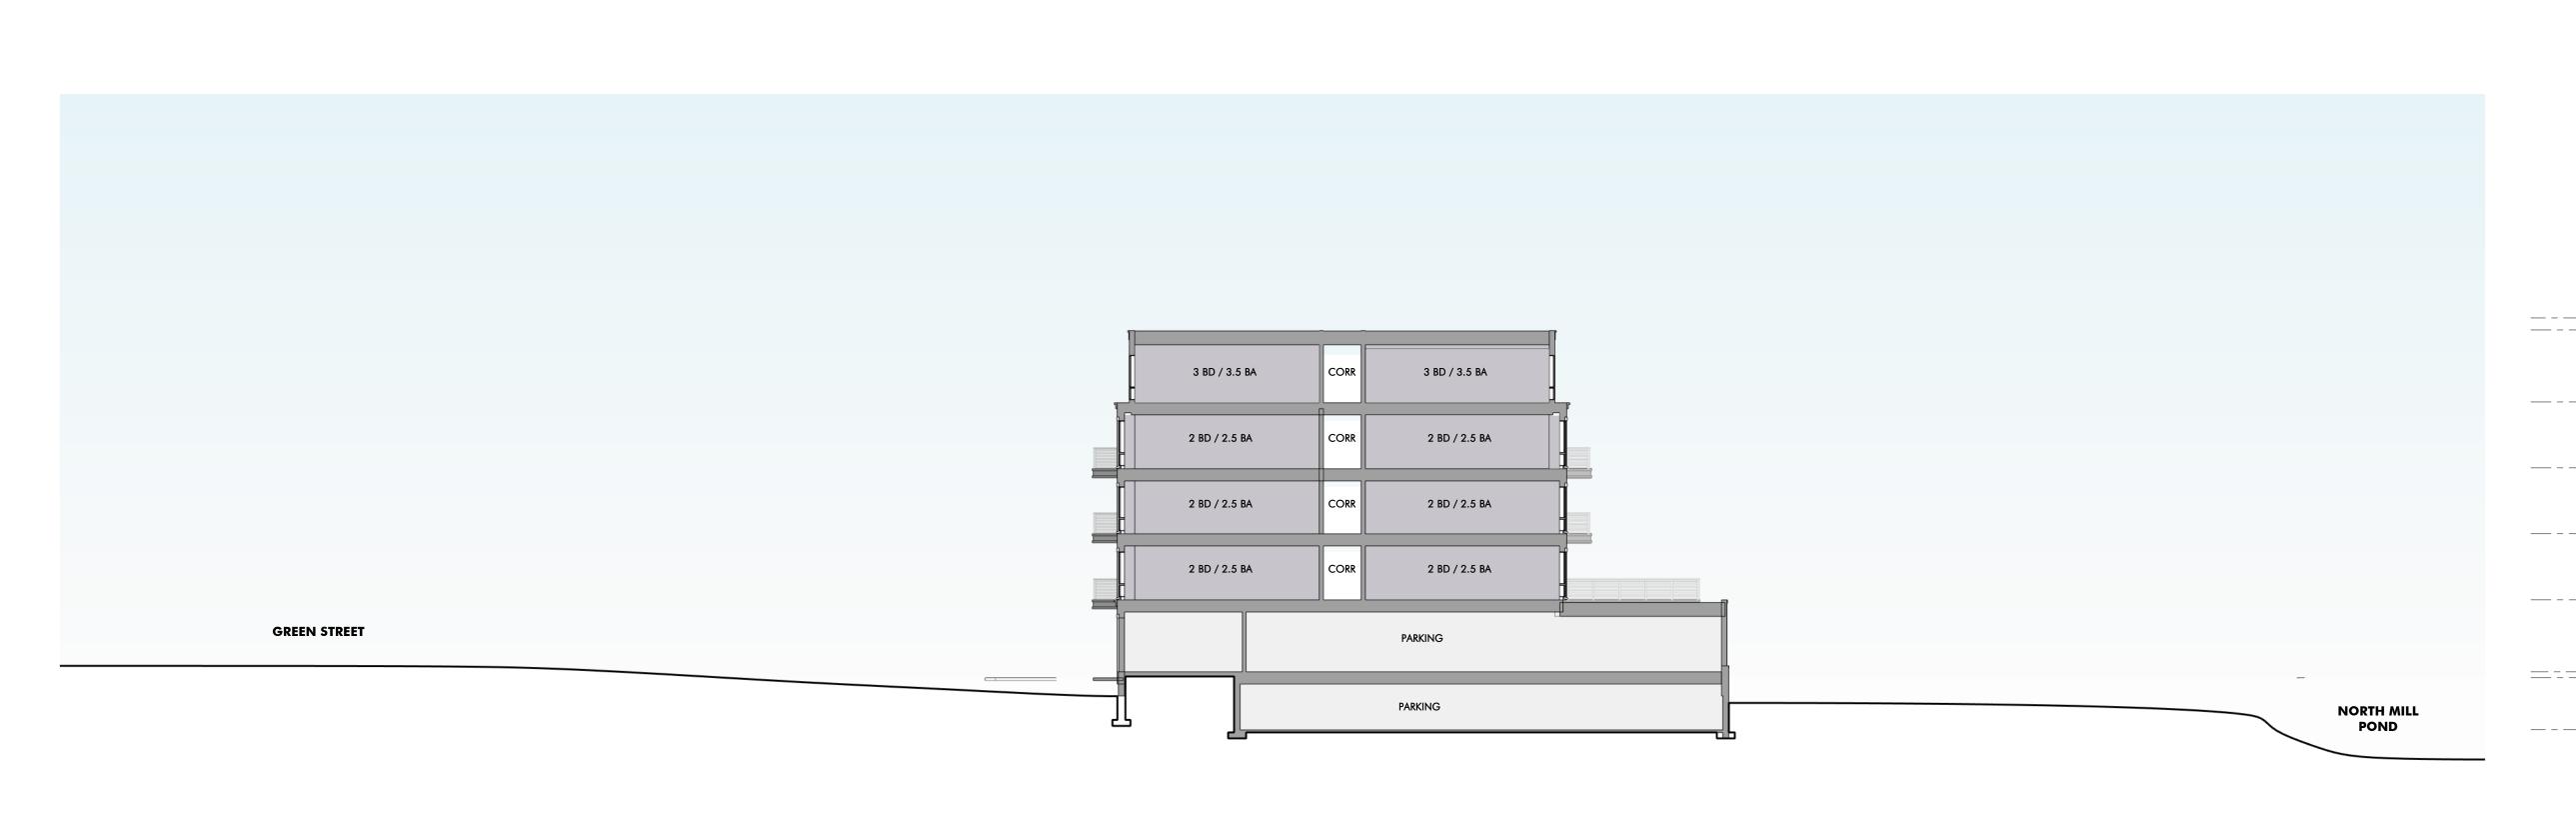
SECTION DIAGRAM

DRAWING NUMBER

SITE SECTION - NORTH / SOUTH

1/16" = 1'-0"







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SECTION

DIAGRAM

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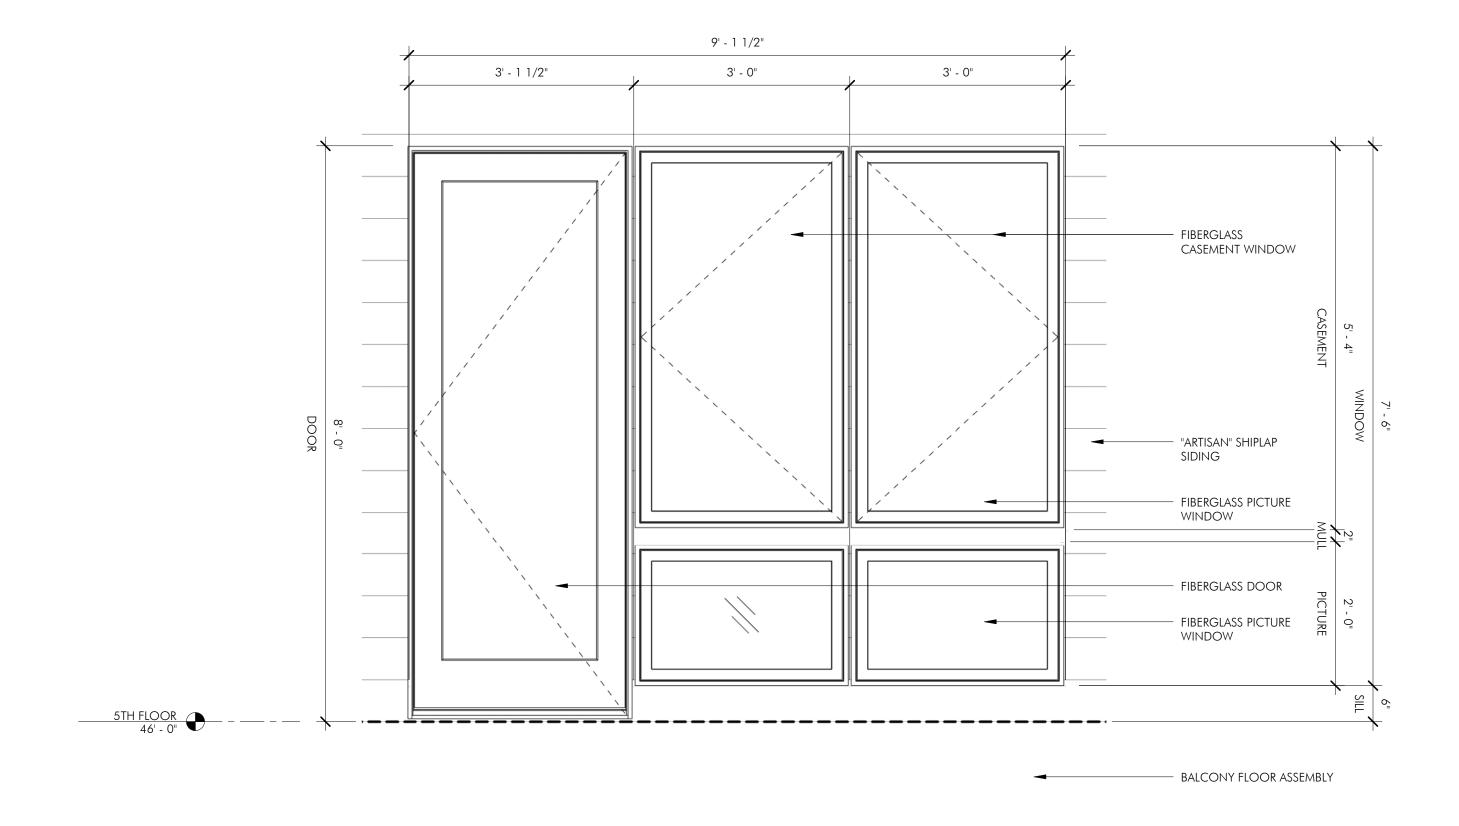
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2 SITE SECTION - EAST WEST1


SITE SECTION - EAST / WEST
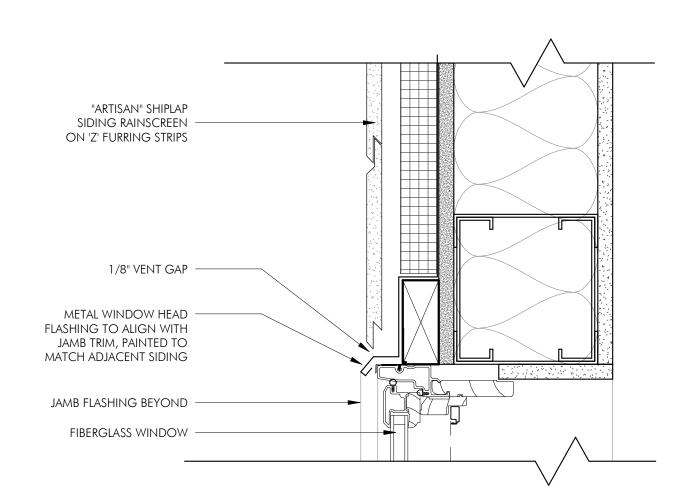
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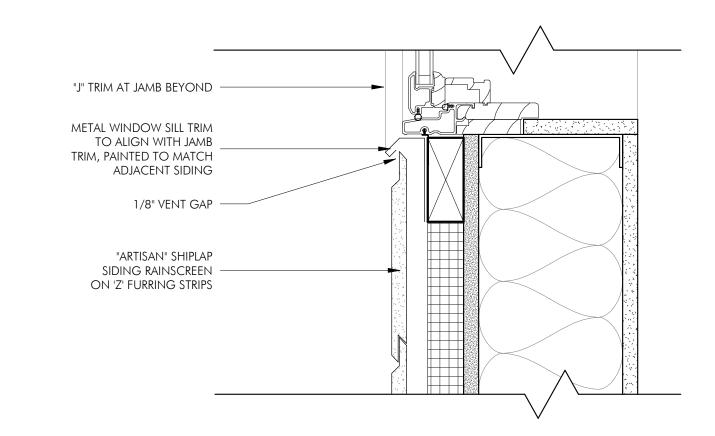
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3 ENLARGED WINDOW ELEVATION (PAIRED DOOR) AT HORIZONTAL FIBER CEMENT SIDING




WINDOW HEAD AT FIBER CEMENT



5 WINDOW SILL AT FIBER CEMENT

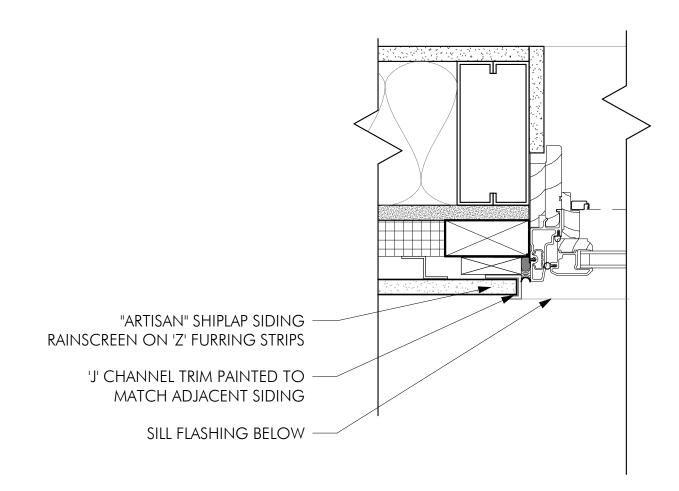3" = 1'-0"



WINDOW JAMB AT FIBER CEMENT

3" = 1'-0"

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WINDOW DETAILS AT FIBER **.CEMENT** 

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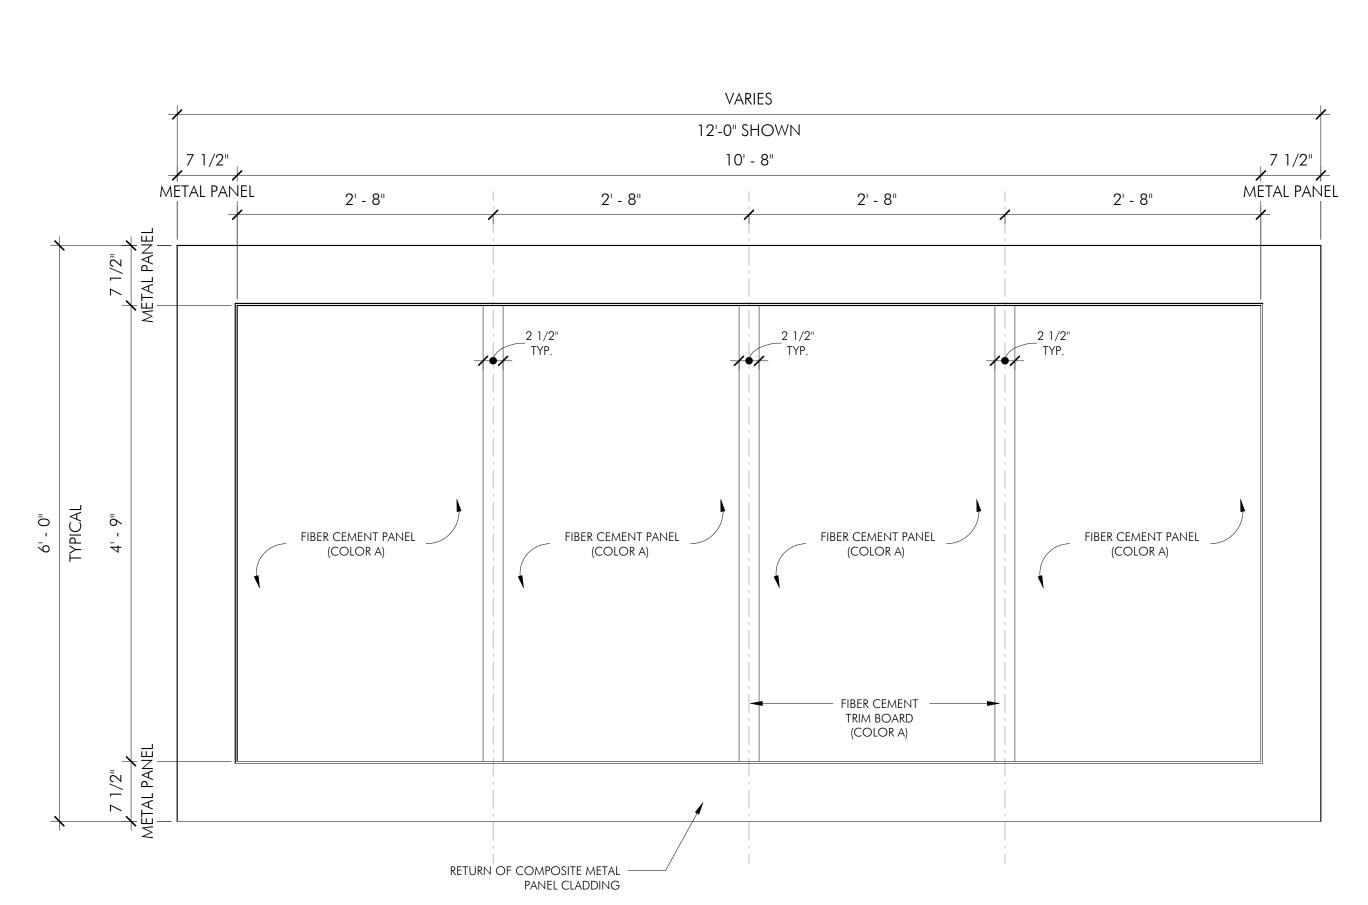
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BALCONY EDGE DETAIL



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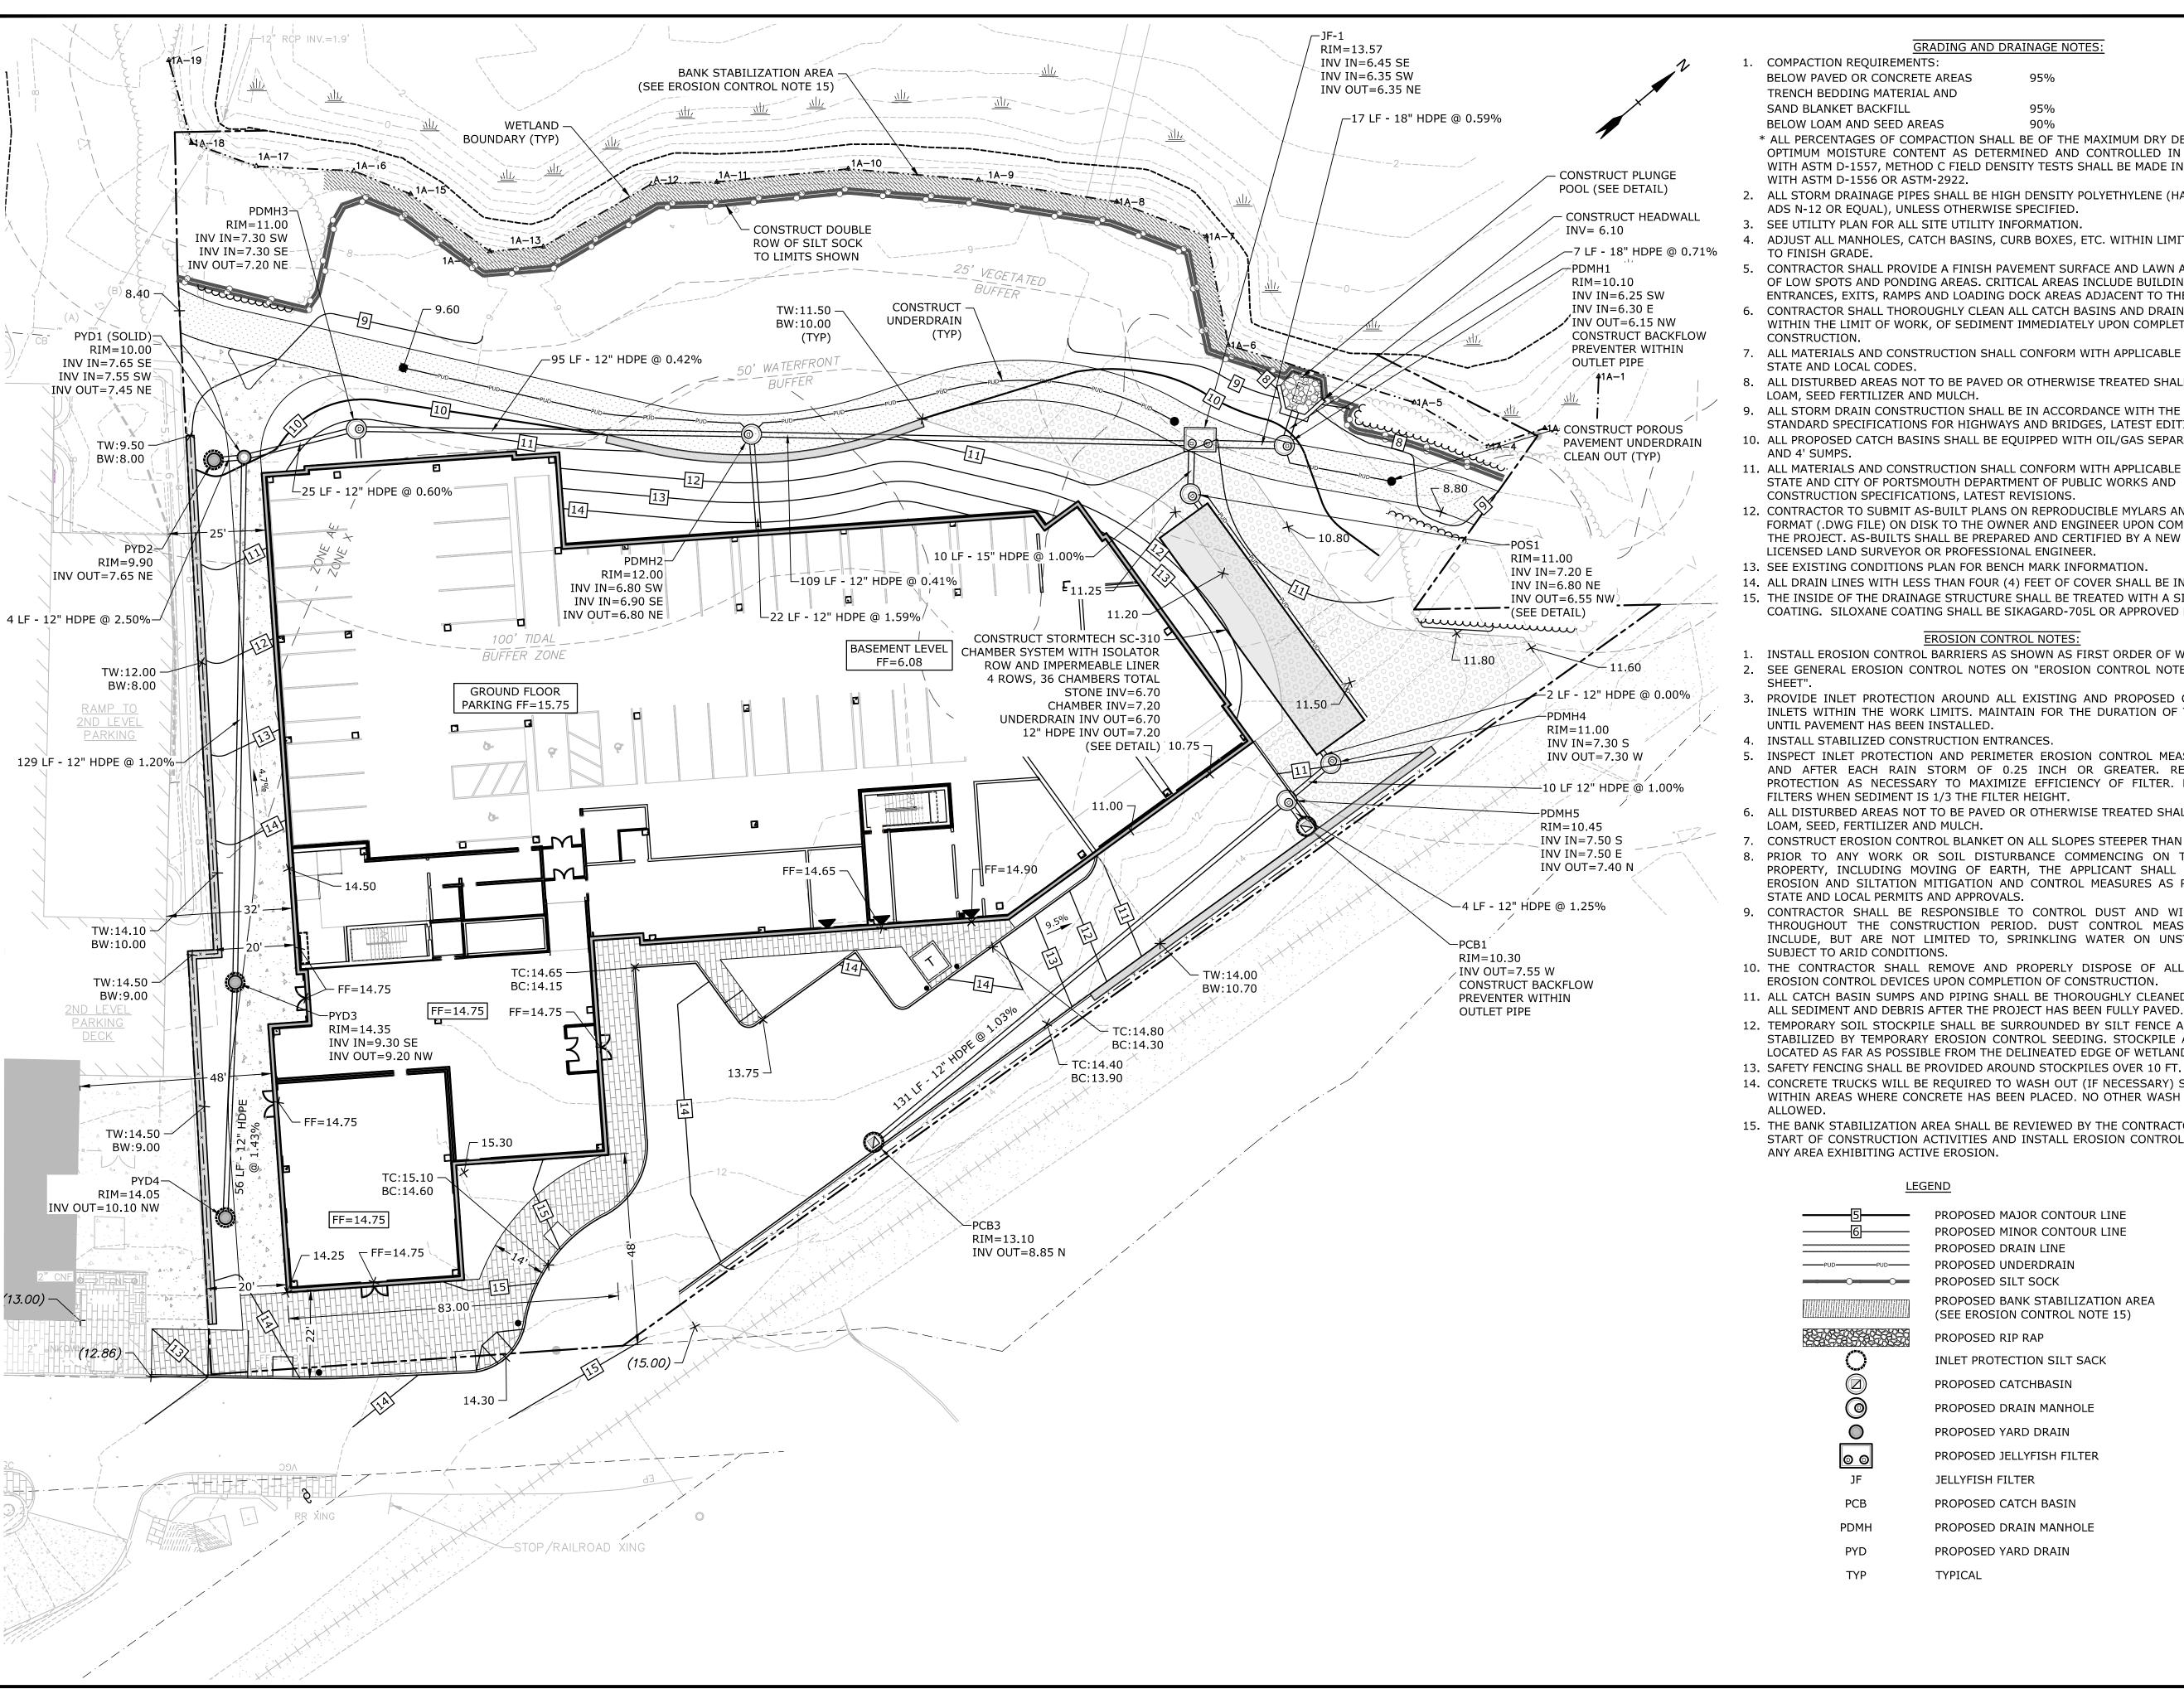
DETAILS

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A 603

5 CEILING PLAN OF UNDERSIDE OF BALCONY




### GRADING AND DRAINAGE NOTES:

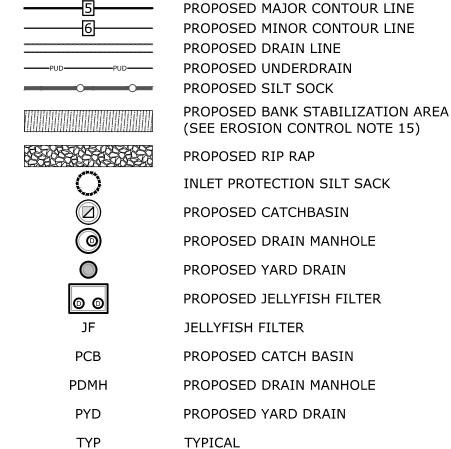- COMPACTION REQUIREMENTS: BELOW PAVED OR CONCRETE AREAS TRENCH BEDDING MATERIAL AND
- SAND BLANKET BACKFILL BELOW LOAM AND SEED AREAS
- \* ALL PERCENTAGES OF COMPACTION SHALL BE OF THE MAXIMUM DRY DENSITY AT THE OPTIMUM MOISTURE CONTENT AS DETERMINED AND CONTROLLED IN ACCORDANCE WITH ASTM D-1557, METHOD C FIELD DENSITY TESTS SHALL BE MADE IN ACCORDANCE WITH ASTM D-1556 OR ASTM-2922.
- 2. ALL STORM DRAINAGE PIPES SHALL BE HIGH DENSITY POLYETHYLENE (HANCOR HI-Q,
- ADS N-12 OR EQUAL), UNLESS OTHERWISE SPECIFIED. 3. SEE UTILITY PLAN FOR ALL SITE UTILITY INFORMATION.
- 4. ADJUST ALL MANHOLES, CATCH BASINS, CURB BOXES, ETC. WITHIN LIMITS OF WORK TO FINISH GRADE.
- CONTRACTOR SHALL PROVIDE A FINISH PAVEMENT SURFACE AND LAWN AREAS FREE OF LOW SPOTS AND PONDING AREAS. CRITICAL AREAS INCLUDE BUILDING ENTRANCES, EXITS, RAMPS AND LOADING DOCK AREAS ADJACENT TO THE BUILDING.
- 6. CONTRACTOR SHALL THOROUGHLY CLEAN ALL CATCH BASINS AND DRAIN LINES, WITHIN THE LIMIT OF WORK, OF SEDIMENT IMMEDIATELY UPON COMPLETION OF
- 7. ALL MATERIALS AND CONSTRUCTION SHALL CONFORM WITH APPLICABLE FEDERAL, STATE AND LOCAL CODES.
- 8. ALL DISTURBED AREAS NOT TO BE PAVED OR OTHERWISE TREATED SHALL RECEIVE 6" LOAM, SEED FERTILIZER AND MULCH.
- ALL STORM DRAIN CONSTRUCTION SHALL BE IN ACCORDANCE WITH THE NHDOT
- STANDARD SPECIFICATIONS FOR HIGHWAYS AND BRIDGES, LATEST EDITION. 10. ALL PROPOSED CATCH BASINS SHALL BE EQUIPPED WITH OIL/GAS SEPARATOR HOODS
- 11. ALL MATERIALS AND CONSTRUCTION SHALL CONFORM WITH APPLICABLE FEDERAL, STATE AND CITY OF PORTSMOUTH DEPARTMENT OF PUBLIC WORKS AND
- 12. CONTRACTOR TO SUBMIT AS-BUILT PLANS ON REPRODUCIBLE MYLARS AND IN DIGITAL FORMAT (.DWG FILE) ON DISK TO THE OWNER AND ENGINEER UPON COMPLETION OF THE PROJECT. AS-BUILTS SHALL BE PREPARED AND CERTIFIED BY A NEW HAMPSHIRE LICENSED LAND SURVEYOR OR PROFESSIONAL ENGINEER.
- 13. SEE EXISTING CONDITIONS PLAN FOR BENCH MARK INFORMATION.
- 14. ALL DRAIN LINES WITH LESS THAN FOUR (4) FEET OF COVER SHALL BE INSULATED.
- 15. THE INSIDE OF THE DRAINAGE STRUCTURE SHALL BE TREATED WITH A SILOXANE COATING. SILOXANE COATING SHALL BE SIKAGARD-705L OR APPROVED EQUAL.

### **EROSION CONTROL NOTES:**

- INSTALL EROSION CONTROL BARRIERS AS SHOWN AS FIRST ORDER OF WORK.
- 2. SEE GENERAL EROSION CONTROL NOTES ON "EROSION CONTROL NOTES & DETAILS
- PROVIDE INLET PROTECTION AROUND ALL EXISTING AND PROPOSED CATCH BASIN INLETS WITHIN THE WORK LIMITS. MAINTAIN FOR THE DURATION OF THE PROJECT UNTIL PAVEMENT HAS BEEN INSTALLED.
- INSTALL STABILIZED CONSTRUCTION ENTRANCES.
- INSPECT INLET PROTECTION AND PERIMETER EROSION CONTROL MEASURES DAILY AND AFTER EACH RAIN STORM OF 0.25 INCH OR GREATER. REPAIR/MODIFY PROTECTION AS NECESSARY TO MAXIMIZE EFFICIENCY OF FILTER. REPLACE ALL FILTERS WHEN SEDIMENT IS 1/3 THE FILTER HEIGHT.
- ALL DISTURBED AREAS NOT TO BE PAVED OR OTHERWISE TREATED SHALL RECEIVE 6" LOAM, SEED, FERTILIZER AND MULCH.
- CONSTRUCT EROSION CONTROL BLANKET ON ALL SLOPES STEEPER THAN 3:1
- PRIOR TO ANY WORK OR SOIL DISTURBANCE COMMENCING ON THE SUBJECT PROPERTY, INCLUDING MOVING OF EARTH, THE APPLICANT SHALL INSTALL ALL EROSION AND SILTATION MITIGATION AND CONTROL MEASURES AS REQUIRED BY STATE AND LOCAL PERMITS AND APPROVALS
- CONTRACTOR SHALL BE RESPONSIBLE TO CONTROL DUST AND WIND EROSION THROUGHOUT THE CONSTRUCTION PERIOD. DUST CONTROL MEASURES SHALL INCLUDE, BUT ARE NOT LIMITED TO, SPRINKLING WATER ON UNSTABLE SOILS SUBJECT TO ARID CONDITIONS.
- 10. THE CONTRACTOR SHALL REMOVE AND PROPERLY DISPOSE OF ALL TEMPORARY
- EROSION CONTROL DEVICES UPON COMPLETION OF CONSTRUCTION. 11. ALL CATCH BASIN SUMPS AND PIPING SHALL BE THOROUGHLY CLEANED TO REMOVE
- 12. TEMPORARY SOIL STOCKPILE SHALL BE SURROUNDED BY SILT FENCE AND SHALL BE STABILIZED BY TEMPORARY EROSION CONTROL SEEDING. STOCKPILE AREAS TO BE LOCATED AS FAR AS POSSIBLE FROM THE DELINEATED EDGE OF WETLANDS.
- 13. SAFETY FENCING SHALL BE PROVIDED AROUND STOCKPILES OVER 10 FT.
- 14. CONCRETE TRUCKS WILL BE REQUIRED TO WASH OUT (IF NECESSARY) SHOOTS ONLY WITHIN AREAS WHERE CONCRETE HAS BEEN PLACED. NO OTHER WASH OUT WILL BE
- 15. THE BANK STABILIZATION AREA SHALL BE REVIEWED BY THE CONTRACTOR UPON THE START OF CONSTRUCTION ACTIVITIES AND INSTALL EROSION CONTROL BLANKET ON ANY AREA EXHIBITING ACTIVE EROSION.

# <u>LEGEND</u>



# Tighe&Bond



**GRAPHIC SCALE** 

**CPI** Management,

53 Green Street Portsmouth, NH

Е	7/7/2021	PB Submission
D	5/19/2021	TAC Resubmission
С	4/21/2021	TAC Resubmission
В	3/22/2021	TAC & CC Submission
Α	1/27/2021	CC Work Session
MARK	DATE	DESCRIPTION
PROJE	CT NO:	C0960-011
DATE:		January 27, 2021

GRADING, DRAINAGE, AND **EROSION CONTROL PLAN** 

C0960-011\_C-DSGN.DWG

NAH/PMC

AS SHOWN

SCALE:

DRAWN BY:

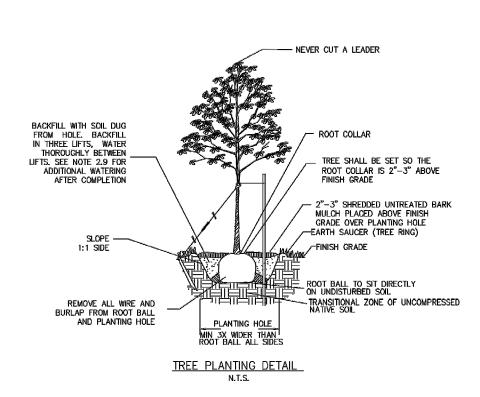
CHECKED:

APPROVED:

C-103


# Landscape Notes

- . Design is based on drawings by Tighe & Bond dated 6/22/2021 and may require adjustment due to actual field conditions 2. The contractor shall follow best management practices during construction and shall take all means necessary to stabilize and protect the site from erosion.
- Erosion Control shall be in place prior to construction.
- 4. Erosion Control to consist of Hay Bales and Erosion Control Fabric shall be staked in place between the work and Water bodies, Wetlands and/or drainage ways prior to any construction.
- 5. The Contractor shall verify layout and grades and inform the Landscape Architect or Client's Representative of any discrepancies or changes in layout and/or grade relationships prior to construction.
- 6. It is the contractor's responsibility to verify drawings provided are to the correct scale prior to any bid, estimate or installation. A graphic scale bar has been provided on each sheet for this purpose. If it is determined that the scale of the drawing is incorrect, the landscape architect will provide a set of drawings at the correct scale, at the request of the contractor.
- 7. Trees to Remain within the construction zone shall be protected from damage for the duration of the project by snow fence or other suitable means of protection to be approved by Landscape Architect or Client's Representative. Snow fence shall be located at the drip line at a minimum and shall include any and all surface roots. Do not fill or mulch on the trunk flare. Do not disturb roots. In order to protect the integrity of the roots, branches, trunk and bark of the tree(s) no vehicles or construction equipment shall drive or park in or on the area within the drip line(s) of the tree(s). Do not store any refuse or construction materials or portalets within the tree protection area.
- 8. Location, support, protection, and restoration of all existing utilities and appurtenances shall be the responsibility of the
- 9. The Contractor shall verify exact location and elevation of all utilities with the respective utility owners prior to construction. Call DIGSAFE at 1-888-344-7233.
- 10. The Contractor shall procure any required permits prior to construction.
- 11. Prior to any landscape construction activities Contractor shall test all existing loam and loam from off-site intended to be used for lawns and plant beds using a thorough sampling throughout the supply. Soil testing shall indicate levels of pH, nitrates, macro and micro nutrients, texture, soluble salts, and organic matter. Contractor shall provide Landscape Architect with test results and recommendations from the testing facility along with soil amendment plans as necessary for the proposed plantings to thrive. All loam to be used on site shall be amended as approved by the Landscape Architect prior to placement.
- 12. Contractor shall notify landscape architect or owner's representative immediately if at any point during demolition or construction a site condition is discovered which may negatively impact the completed project. This includes, but is not limited to, unforeseen drainage problems, unknown subsurface conditions, and discrepancies between the plan and the site. If a contractor is aware of a potential issue, and does not bring it to the attention of the landscape architect or owner's representative immediately, they may be responsible for the labor and materials associated with correcting the problem.
- 13. The Contractor shall furnish and plant all plants shown on the drawings and listed thereon. All plants shall be nursery-grown under climatic conditions similar to those in the locality of the project. Plants shall conform to the botanical names and standards of size, culture, and quality for the highest grades and standards as adopted by the American Association of Nurserymen, Inc. in the American Standard of Nursery Stock, American Standards Institute, Inc. 230 Southern Building,
- Washington, D.C. 20005. 14. A complete list of plants, including a schedule of sizes, quantities, and other requirements is shown on the drawings. In the event that quantity discrepancies or material omissions occur in the plant materials list, the planting plans shall govern.
- 15. All plants shall be legibly tagged with proper botanical name.
- 16. The Contractor shall guarantee all plants for not less than one year from time of acceptance. 17. Owner or Owner's Representative will inspect plants upon delivery for conformity to Specification requirements. Such approval shall not affect the right of inspection and rejection during or after the progress of the work. The Owner reserves the right to inspect and/or select all trees at the place of growth and reserves the right to approve a representative sample of each type of shrub, herbaceous perennial, annual, and ground cover at the place of growth. Such sample will serve as a minimum standard
- for all plants of the same species used in this work. 18. No substitutions of plants may be made without prior approval of the Owner or the Owner's Representative for any reason.
- 19. All landscaping shall be provided with the following: a. Outside hose attachments spaced a maximum of 150 feet apart, and
- b. An underground irrigation system, or
- c. A temporary irrigation system designed for a two-year period of plant establishment.
- 20. If an automatic irrigation system is installed, all irrigation valve boxes shall be located within planting bed areas. 21. The contractor is responsible for all plant material from the time their work commences until final acceptance. This includes but is not limited to maintaining all plants in good condition, the security of the plant material once delivered to the site, and watering of plants. Plants shall be appropriately watered prior to, during and after planting. It is the contractor's responsibility
- to provide clean water suitable for plant health from off site, should it not be available on site. 22. All disturbed areas will be dressed with 6" of topsoil and planted as noted on the plans or seeded except plant beds. Plant beds shall be prepared to a depth of 12" with 75% loam and 25% compost.
- 23. Trees, ground cover, and shrub beds shall be mulched to a depth of 2" with one-year-old, well-composted, shredded native bark not longer than 4" in length and ½" in width, free of woodchips and sawdust. Mulch for ferns and herbaceous perennials shall be no longer than 1" in length. Trees in lawn areas shall be mulched in a 5' diameter min. saucer. Color of mulch shall be
- 24. Drip strip shall extend to 6" beyond roof overhang and shall be edged with 3/16" thick metal edger.
- 25. In no case shall mulch touch the stem of a plant nor shall mulch ever be more than 3" thick total (including previously applied mulch) over the root ball of any plant.
- 26. Secondary lateral branches of deciduous trees overhanging vehicular and pedestrian travel ways shall be pruned up to a height of 6' to allow clear and safe passage of vehicles and pedestrians under tree canopy. Within the sight distance triangles at vehicle intersections the canopies shall be raised to 8' min.
- 27. Snow shall be stored a minimum of 5' from shrubs and trunks of trees.
- 28. Landscape Architect is not responsible for the means and methods of the contractor.



### PARI 1 - GENERAL:

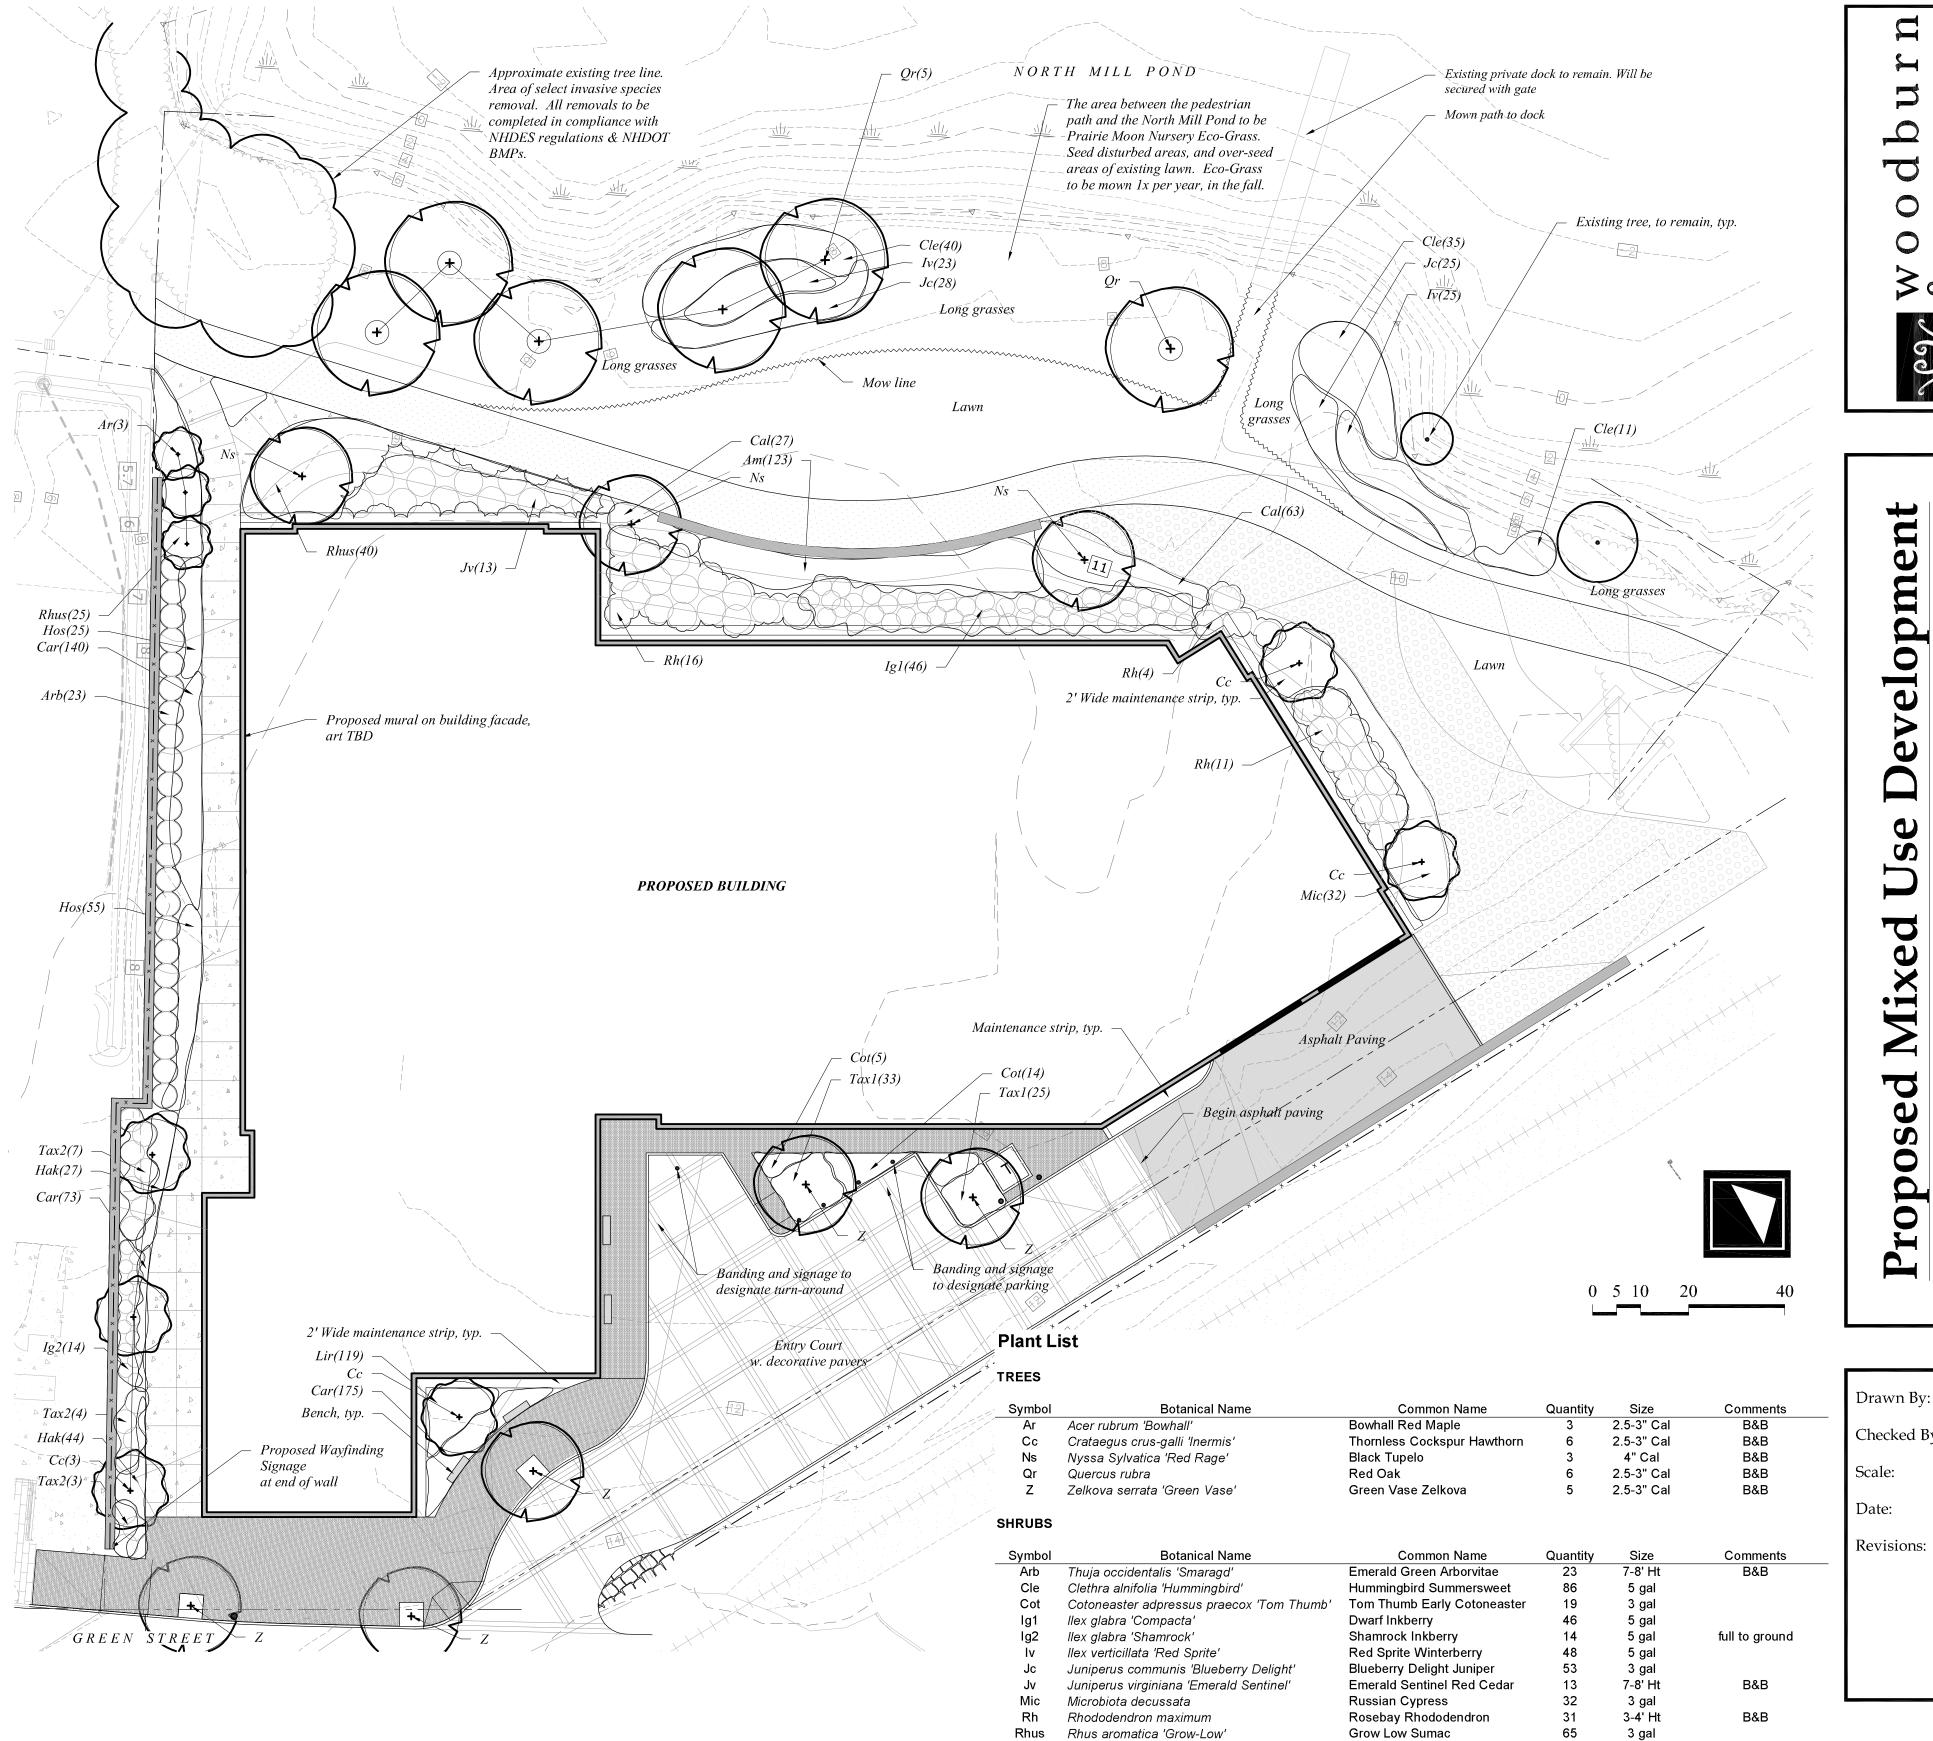- 1.1 THE BASE OF THE CITY OF PORTSMOUTH TREE PLANTING REQUIREMENTS IS THE ANSI A300 PART 6 STANDARD PRACTICES FOR PLANTING AND TRANSPLANTING. ANSI A300 PART 6 LAYS OUT TERMS AND BASIC STANDARDS AS SET FORTH BY INDUSTRY BUT IT IS NOT THE "END ALL" FOR THE CITY OF PORTSMOUTH. THE FOLLOWING ARE THE CITY OF PORTSMOUTH, NH TREE PLANTING REQUIREMENTS THAT ARE IN ADDITION TO OR THAT GO BEYOND THE ANSI A300 PART 6.
- PART 2 EXECUTION:
- 2.1 ALL PLANTING HOLES SHALL BE DUG BY HAND NO MACHINES. THE ONLY EXCEPTIONS ARE NEW CONSTRUCTION WHERE NEW PLANTING PITS, PLANTING BEDS WITH GRANITE CURBING, AND PLANTING SITES WITH SIVA CELLS ARE BEING CREATED. IF A MACHINE IS USED TO DIG IN ANY OF THESE SITUATIONS AND PLANTING DEPTH NEEDS TO BE
- 2.2 ALL WIRE AND BURLAP SHALL BE REMOVED FROM THE ROOT BALL AND PLANTING HOLE.
- 2.3 THE ROOT BALL OF THE TREE SHALL BE WORKED SO THAT THE ROOT COLLAR OF THE TREE IS VISIBLE AND NO GRDLING ROOTS ARE
- 2.4 THE ROOT COLLAR OF THE TREE SHALL BE 2"-3" ABOVE GRADE OF
- 2.5 ALL PLANTINGS SHALL BE BACKFILLED WITH SOIL FROM THE SITE AND AMENDED NO MORE THAN 20% WITH ORGANIC COMPOST. THE ONLY EXCEPTIONS ARE NEW CONSTRUCTION WHERE ENGINEERED SOIL IS BEING USED IN CONJUNCTION WITH SILVA CELLS AND WHERE NEW PLANTING BEDS ARE BEING CREATED.
- 2.6 ALL PLANTINGS SHALL BE BACKFILLED IN THREE LIETS AND ALL LIETS SHALL BE WATERED SO THE PLANTING WILL BE SET AND FREE OF AIR POCKETS — NO EXCEPTIONS.
- 2.7 AN EARTH BERM SHALL BE PLACED AROUND THE PERIMETER OF THE PLANTING HOLE EXCEPT WHERE CURBED PLANTING BEDS OR PITS ARE
- 2.8 2"-3" OF MULCH SHALL BE PLACED OVER THE PLANTING AREA.
- 2.9 AT THE TIME OF PLANTING IS COMPLETE THE PLANTING SHALL RECEIVE ADDITIONAL WATER TO ENSURE COMPLETE HYDRATION OF THE ROOTS, BACKFILL MATERIAL AND MULCH LAYER.
- 2.10 STAKES AND GUYS SHALL BE USED WHERE APPROPRIATE AND/OR NECESSARY. GUY MATERIAL SHALL BE NON-DAMAGING TO THE TREE.
- THE RIGHT TO REFUSE/REJECT ANY PLANT MATERIAL OR PLANTING ACTION THAT FAILS TO MEET THE STANDARDS SET FORTH IN THE ANSI A300 PART 6 STANDARD PRACTICES FOR PLANTING AND TRANSPORTATION AND/OR THE CITY OF PORTSMOUTH, NH PLANTING



Tax1

Symbol

Am

Car

Hak

Hos

Taxus media 'Ever-Low'

Amsonia hubrichti

Carex appalachica

Hakonechloa macra

Hosta 'Guacamole'

Liriope spicata

Taxus media 'Greenwave'

PERENNIALS, GROUNDCOVERS, VINES and ANNUALS

Calamagrostis acutifolia 'Karl Foerster'

Penninton Smartseed Tall Fescue Blend

**Botanical Name** 

City of Portsmouth Tree Planting Detail

Checked By: 1'' = 20' - 0Scale: March 22, 2021 Date: April 21, 202 Revisions: May 19, 202 June 29, 2021 Comments

58

14

Quantity 123

388

90

71

80

119

3 gal

5 gal

Size

1 gal

1 gal

1 gal

1 gal

1 gal

1 gal

Ever-Low Yew

Greenwave Yew

Blue Star Flower

Appalachian Sedge

Feather Reed Grass

Guacamole Hosta

Lily Turf

Japanese Frost Grass

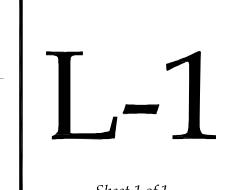
Common Name

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