

210700-026
November 9, 2023

Peter Stith, AICP
Planning Manager
Department of Planning & Sustainability
City Hall, 3rd Floor
1 Junkins Avenue
Portsmouth, NH 03801

**Re: Lonza Biologics – Proposed Industrial Development
Traffic Peer Review Response 2
Supplemental PB Submission – Amended Site Plan Review Application**

Dear Peter,

On behalf of Lonza Biologics, Inc. (Lonza), we are pleased to submit one (1) set of hard copies and one electronic file (.pdf) of the following revised information to support a request to the Planning Board for a recommendation for approval to the Pease Development Authority (PDA) for Amended Site Plan Review for the above referenced project originally submitted on September 22, 2022:

On behalf of Port Harbor Land, LLC (owner/applicant), we are pleased to submit the following revised information to support a request for a Site Review Permit and Technical Advisory Committee Meeting, for the above referenced project originally submitted on September 27, 2023:

- One (1) full size & one (1) half size copy of the Site Plan Set, last revised November 9, 2023
- Traffic Third Party Review Documents
 - TEC Traffic Peer Review Letter, dated October 3, 2023;
 - Traffic Peer Review Comment Response Letter 1, dated October 24, 2023;
 - TEC Traffic Peer Review Letter, dated November 8, 2023

In response to the third-party review of the previously submitted Traffic Impact Study in a letter dated October 3, 2023, and the subsequent letter dated November 8, 2023, Tighe & Bond is providing the enclosed plan set to address comments 20 through 24 of the October 3rd letter as described in the enclosed response letter dated October 24, 2023. The enclosed revised plans have been updated from the package submitted on September 27, 2023, as follows:


- A central sidewalk has been added through the 150 space parking area connecting to the currently proposed sidewalk. (Sheet C-165)
- A second trash compactor has been added to the site adjacent to the Utility Building. Truck turning was studied to confirm access. (Sheet C-166)
- Pedestrian warning signs have been added to the plans as recommended. (Sheets C-165, C-167 & C-502)
- Crosswalk Striping detail has been revised to note an 8' width. (Sheet C-502)



An updated submission package has been uploaded to the City's online permitting site and hard copy has been hand delivered to the Planning Department. We look forward to meeting with the Planning Board on November 16, 2023. If you have any questions or need any additional information, please contact Neil Hansen by phone at (603) 294-9213 or by email at nahansen@tighebond.com.

Sincerely,

TIGHE & BOND, INC.

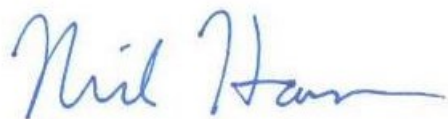

Neil A. Hansen, PE
Project Manager



Colter J. Krzcuik, EIT
Staff Engineer

Copy: Lonza Biologics (via email)
Pease Development Authority

J:\L\L0700 Lonza Biologics Expansion was 1576F\026_Project Albacore\Report_Evaluations\Applications\City of Portsmouth\20231109_PB Submission 2\L-0700-026 Supplemental 20231109.docx

PROPOSED INDUSTRIAL DEVELOPMENT

70 & 80 CORPORATE DRIVE PORTSMOUTH, NEW HAMPSHIRE


PROJECT NO: L-0700-13

APRIL 3, 2018

LAST REVISED: NOVEMBER 9, 2023

PLAN SET INDEX		
SHEET TITLE	# OF SHEETS	LAST REVISED
COVER SHEET	1	11/9/2023
SHEET INDEX	1	11/9/2023
EXISTING CONDITIONS & SUBDIVISION PLANS COVER SHEET	1	11/2/2021
EXISTING CONDITIONS & SUBDIVISION PLANS	6	11/2/2021
MASTER PLAN COVER SHEET	1	11/9/2023
MASTER PLAN SET	19	11/9/2023
PHASE 2 COVER SHEET	1	11/9/2023
PHASE 2 PLAN SET	27	11/9/2023
DETAILS COVER SHEET	1	11/9/2023
EROSION CONTROL NOTES & DETAILS SHEETS	12	11/9/2023

LIST OF PERMITS		
LOCAL	STATUS	DATE
SITE PLAN REVIEW PERMIT	APPROVED	1/17/2019
AMENDED SITE PLAN REVIEW PERMIT	PENDING	
STATE		
NHDES - ALTERATION OF TERRAIN PERMIT	ISSUED: AOT-1498	10/02/2018
NHDES - WETLANDS PERMIT	ISSUED: #2018-01731	12/21/2018
FEDERAL		
PHASE 1A - EPA - NPDES CGP	ISSUED: NHR1001EU	2/24/2022
PHASE 1B - EPA - NPDES CGP	ISSUED: NHR1001SK	7/21/2023
	ISSUED: NHR1001SL	7/24/2023

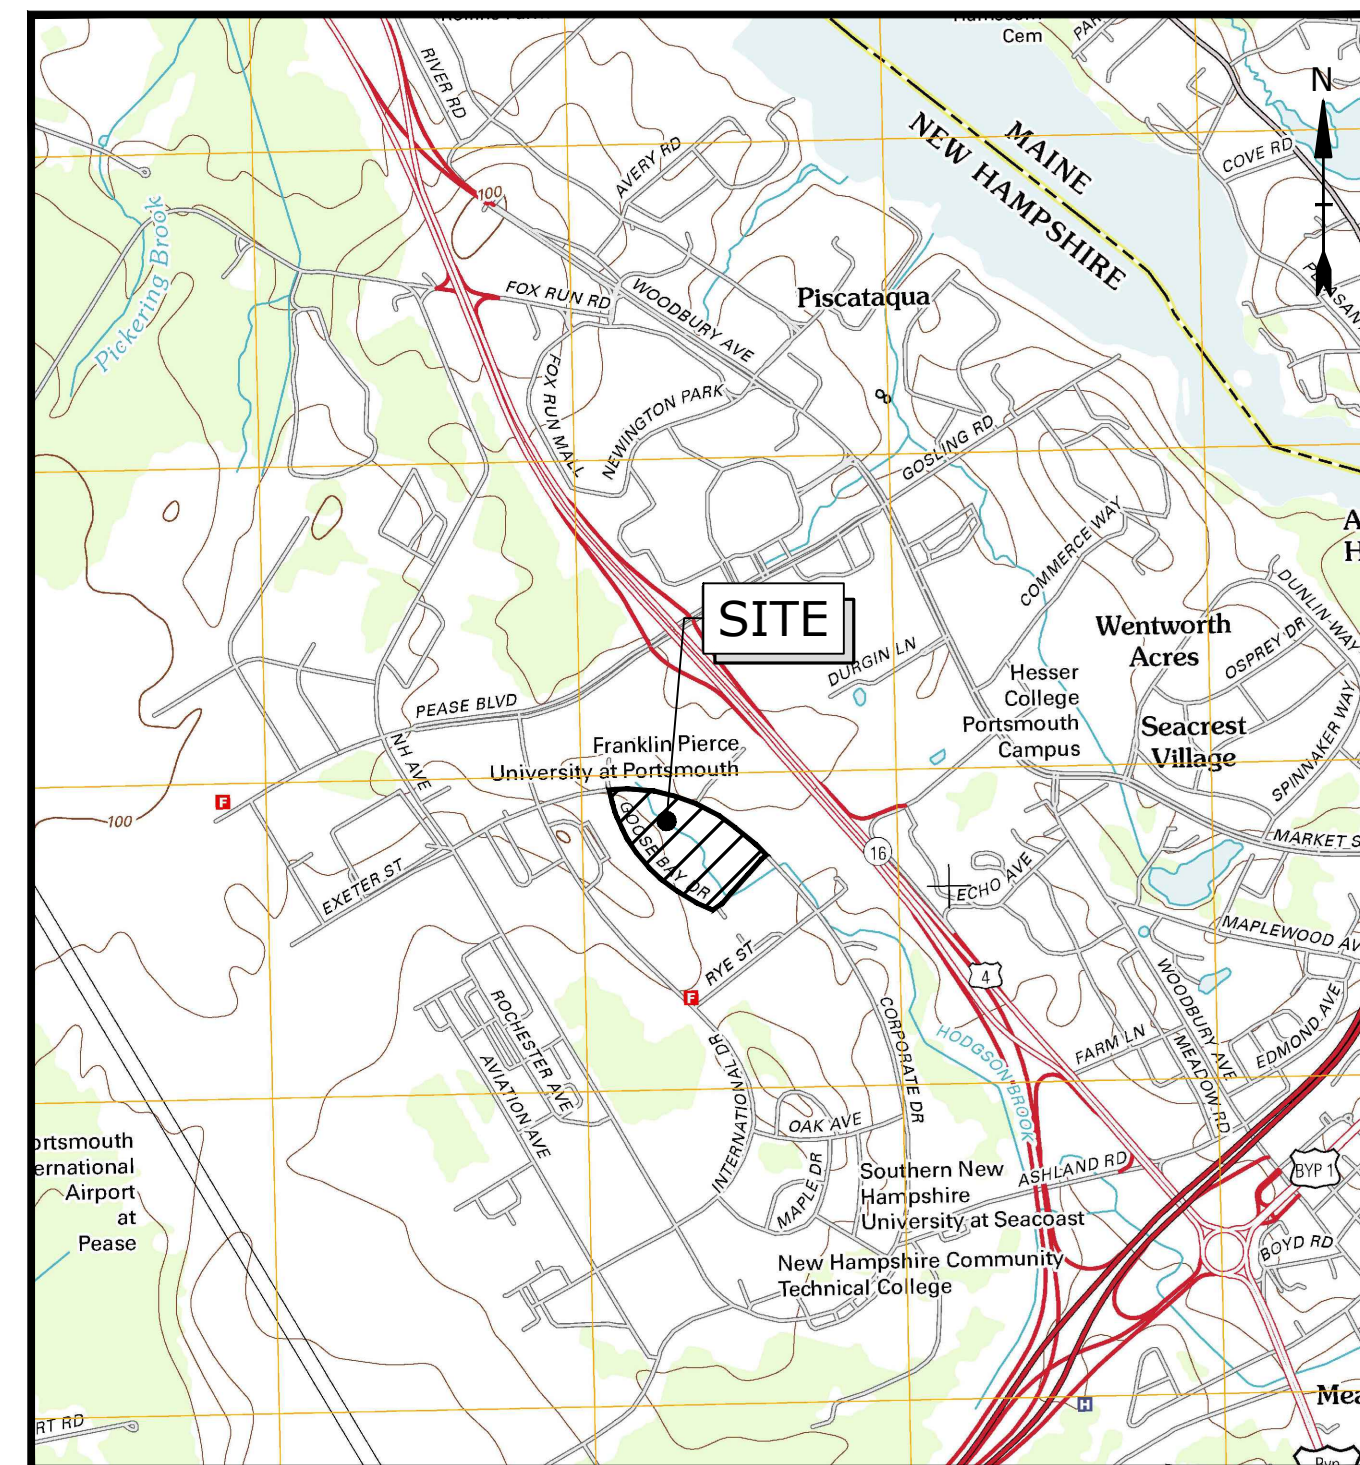

LOCATION MAP
SCALE: 1" = 2,000'


LESSOR: PEASE DEVELOPMENT AUTHORITY
55 INTERNATIONAL DRIVE
PORTSMOUTH, NEW HAMPSHIRE 03801

APPLICANT/OWNER: LONZA BIOLOGICS
101 INTERNATIONAL DRIVE
PORTSMOUTH, NH 03801

CIVIL ENGINEER: **Tighe&Bond**
177 CORPORATE DRIVE
PORTSMOUTH, NEW HAMPSHIRE 03801

SURVEYOR: DOUCET SURVEY, INC.
102 KENT PLACE
NEWMARKET, NEW HAMPSHIRE 03857

WETLAND SCIENTIST: GOVE ENVIRONMENTAL SERVICES, INC.
8 CONTINENTAL DRIVE, UNIT H
EXETER, NEW HAMPSHIRE 03833

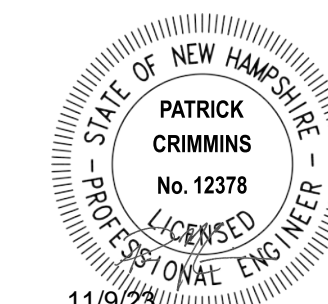


**PLANNING BOARD SUBMISSION
COMPLETE SET 70 SHEETS**

EXISTING CONDITIONS & SUBDIVISION PLANS SHEET INDEX		
SHEET NO.	SHEET TITLE	LAST REVISED
	COVER SHEET	11/2/2021
1 of 4	EXISTING CONDITIONS PLAN	08/16/2018
2 of 4	EXISTING CONDITIONS PLAN	08/16/2018
3 of 4	EXISTING CONDITIONS PLAN	08/16/2018
4 of 4	EXISTING CONDITIONS PLAN	08/16/2018
1 of 2	SUBDIVISION PLAN	11/2/2021
2 of 2	SUBDIVISION PLAN	11/2/2021

MASTER PLAN SET SHEET INDEX		
SHEET NO.	SHEET TITLE	LAST REVISED
	MASTER PLAN SET COVER SHEET	11/9/2023
C-101	DEMOLITION PLAN	9/27/2023
C-102	DEMOLITION PLAN	11/9/2023
C-103	DEMOLITION PLAN	11/9/2023
C-104	OVERALL SITE PLAN	9/27/2023
C-105	SITE PLAN	11/9/2023
C-106	SITE PLAN	11/9/2023
C-107	SITE PLAN	11/9/2023
C-108	GRADING, DRAINAGE & EROSION CONTROL PLAN	11/9/2023
C-109	GRADING, DRAINAGE & EROSION CONTROL PLAN	11/9/2023
C-110	GRADING, DRAINAGE & EROSION CONTROL PLAN	11/9/2023
C-111	UTILITIES PLAN	9/27/2023
C-112	UTILITIES PLAN	11/9/2023
C-113	UTILITIES PLAN	11/9/2023
C-114	LANDSCAPE PLAN	9/27/2023
C-115	LANDSCAPE PLAN	11/9/2023
C-116	LANDSCAPE PLAN	11/9/2023
C-117	PHOTOMETRIC LIGHTING PLAN	9/27/2023
C-118	PHOTOMETRIC LIGHTING PLAN	9/27/2023
C-119	PHOTOMETRIC LIGHTING PLAN	9/27/2023

PHASE 2 PLAN SET SHEET INDEX		
SHEET NO.	SHEET TITLE	LAST REVISED
	PHASE 2 PLAN SET COVER SHEET	11/9/2023
C-161	PHASE 2 DEMOLITION PLAN	9/27/2023
C-162	PHASE 2 DEMOLITION PLAN	11/9/2023
C-163	PHASE 2 DEMOLITION PLAN	11/9/2023
C-163.1	PHASE 2 PRE-CONSTRUCTION LAYOUT PLAN	11/9/2023
C-164	PHASE 2 OVERALL SITE PLAN	11/9/2023
C-165	PHASE 2 SITE PLAN	11/9/2023
C-166	PHASE 2 SITE PLAN	11/9/2023
C-167	PHASE 2 SITE PLAN	11/9/2023
C-168	PHASE 2 GRADING, DRAINAGE & EROSION CONTROL PLAN	11/9/2023
C-169	PHASE 2 GRADING, DRAINAGE & EROSION CONTROL PLAN	11/9/2023
C-170	PHASE 2 GRADING, DRAINAGE & EROSION CONTROL PLAN	11/9/2023
C-171	PHASE 2 UTILITIES PLAN	11/9/2023
C-172	PHASE 2 UTILITIES PLAN	11/9/2023
C-173	PHASE 2 UTILITIES PLAN	11/9/2023
C-174	PHASE 2 LANDSCAPE PLAN	11/9/2023
C-175	PHASE 2 LANDSCAPE PLAN	11/9/2023
C-176	PHASE 2 LANDSCAPE PLAN	11/9/2023
C-177	PHASE 2 PHOTOMETRIC LIGHTING PLAN	11/9/2023
C-178	PHASE 2 PHOTOMETRIC LIGHTING PLAN	11/9/2023
C-179	PHASE 2 PHOTOMETRIC LIGHTING PLAN	9/27/2023
8-046-1-1110	FIRST FLOOR PLAN - CUB	8/24/2023
8-046-1-2002	BUILDING ELEVATIONS (E-W) - CUB	8/24/2023
8-046-1-2003	BUILDING ELEVATIONS (N-S) - CUB	9/18/2023
8-070-1-1110	FIRST FLOOR PLAN - BL1	8/24/2023
8-070-1-2001	OVERALL BUILDINGS ELEVATIONS	7/12/2023
8-070-1-2002	BUILDING ELEVATIONS (E-W) - BL1	8/24/2023
8-070-1-2003	BUILDING ELEVATIONS (N-S) - BL1	8/24/2023

DETAILS SHEET INDEX		
SHEET NO.	SHEET TITLE	LAST REVISED
	DETAILS COVER SHEET	11/9/2023
C-501	EROSION CONTROL NOTES & DETAILS SHEET	9/27/2023
C-502	DETAILS SHEET	11/9/2023
C-503	DETAILS SHEET	11/9/2023
C-504	DETAILS SHEET	9/27/2023
C-505	DETAILS SHEET	9/27/2023
C-506	DETAILS SHEET	9/27/2023
C-507	DETAILS SHEET	9/27/2023
C-508	DETAILS SHEET	9/27/2023
C-509	DETAILS SHEET	11/9/2023
C-510	DETAILS SHEET	9/27/2023
C-511	DETAILS SHEET	9/27/2023
C-512	DETAILS SHEET	9/27/2023

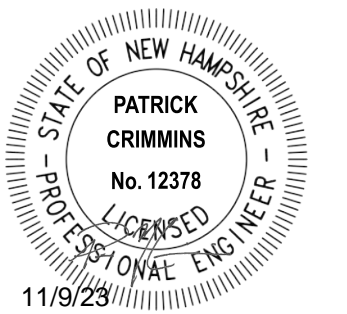

Proposed Industrial Development

Lonza Biologics

Portsmouth,
New Hampshire

N	11/9/2023	Revised P.B. Submission
M	9/27/2023	P.B. Submission
L	9/1/2022	Issued for Construction
K	5/27/2022	Issued for Bid
J	5/23/2022	Third Party Rev. Comments
I	4/26/2022	Revised PB Stipulations

MARK	DATE	DESCRIPTION
PROJECT NO:	L-0700-013	
DATE:	04/03/2018	
FILE:	L-0700-026-C-COVR.dwg	
DRAWN BY:	CJK	
CHECKED:	NAH	
APPROVED:	PMC	

SHEET INDEX

SCALE: AS SHOWN

C-100



EXISTING CONDITIONS & SUBDIVISION PLANS

APRIL 3, 2018

REVISED: NOVEMBER 2, 2021



LIST OF DRAWINGS		
SHEET NO.	SHEET TITLE	LAST REVISED
	COVER SHEET	11/2/2021
1 of 4	EXISTING CONDITIONS PLAN	11/2/2021
2 of 4	EXISTING CONDITIONS PLAN	08/16/2018
3 of 4	EXISTING CONDITIONS PLAN	08/16/2018
4 of 4	EXISTING CONDITIONS PLAN	08/16/2018
1 of 2	SUBDIVISION PLAN	11/2/2021
2 of 2	SUBDIVISION PLAN	11/2/2021

Last Save Date: September 25, 2023 5:16 PM By: CKRZCUK
Plot Date: Wednesday, September 27, 2023 Plotted By: Colter Krzulk
P&E File Location: J:\0700 Lanza Biologics Expansion.was.12781028 - Project Abbrev: Drawings\AutoCAD\0700-026-C-COVR.dwg Layout: Tab: EX-CS

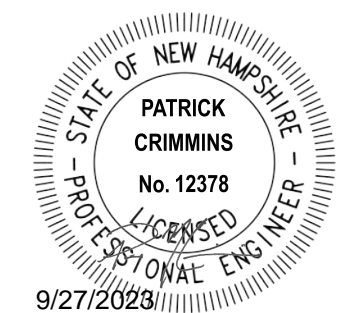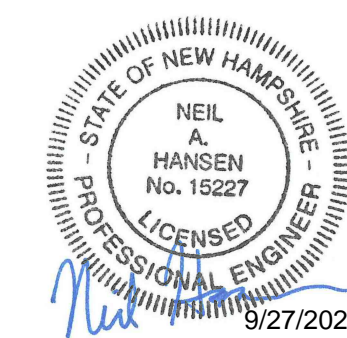

COMPLETE SET 7 SHEETS

SOIL IDENTIFICATION LEGEND	
SYMBOL	SOIL TAXONOMIC NAME, SLOPE RATING
89C	CHATFIELD, 8 TO 15 PERCENT SLOPES
313B	DEERFIELD, 0 TO 8 PERCENT SLOPES
313C	DEERFIELD, 8 TO 15 PERCENT SLOPES
915B	DEERFIELD VARIANT, 0 TO 8 PERCENT SLOPES
546B/P	WALPOLE POORLY DRAINED, 0 TO 8 PERCENT SLOPES
799B	UDORTHENTS URBAN LAND, 0 TO 8 PERCENT SLOPES
799E	UDORTHENTS URBAN LAND, >25 PERCENT SLOPES

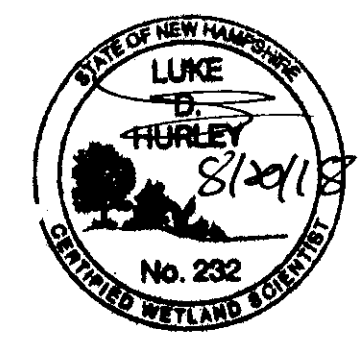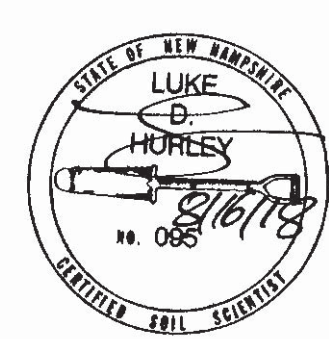

TAX MAP 303, LOT 2-1
OPROCK PORTSMOUTH INTL FEE LLC
C/O OCEAN PROPERTIES LTD
1000 MARKET ST SUITE 300
PORTSMOUTH, NH 03801
R.C.R.D. BOOK 4831, PAGE 2677

TAX MAP 303, LOT 2-2
RESPORT LLC
1000 MARKET ST BLDG 1 STE 300
PORTSMOUTH, NH 03801


TAX MAP 305, LOT 7
PEASE DEVELOPMENT AUTHORITY
55 INTERNATIONAL DRIVE
PORTSMOUTH, NEW HAMPSHIRE 03801

TAX MAP 305, LOT 7-1
UNIVERSITY SYSTEM OF NEW HAMPSHIRE
COLLEGE FOR LIFELONG LEARNING
51 INTERNATIONAL DRIVE
PORTSMOUTH, NH 03801

TAX MAP 305, LOT 7-1
CITY OF PORTSMOUTH
1 JUNKINS AVE
PORTSMOUTH, NH 03801

TAX MAP 303, LOT 3
RED HOOK BREWERY INC
C/O WIDMER BROTHERS BREWING CO
929 NORTH RUSSELL ST.
PORTLAND, OR 97227

TAX MAP 305, LOT 6
LONZA BIOLOGICS INC
101 INTERNATIONAL DRIVE
PORTSMOUTH, NH 03801

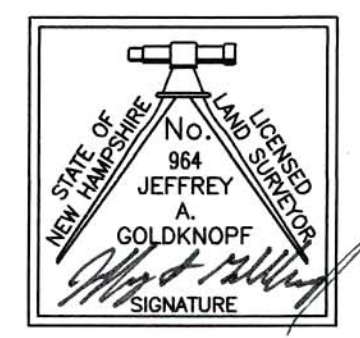


PURSUANT TO RSA 676:18, III:
I CERTIFY THAT THIS SURVEY PLAT IS NOT A SUBDIVISION PURSUANT TO THIS TITLE AND THAT THE LINES OF STREETS AND WAYS SHOWN ARE THOSE OF PUBLIC OR PRIVATE STREETS OR WAYS ALREADY ESTABLISHED AND THAT NO NEW WAYS ARE SHOWN.

I CERTIFY THAT THIS SURVEY AND PLAN WERE PREPARED BY ME OR BY THOSE UNDER MY DIRECT SUPERVISION AND FALLS UNDER THE URBAN SURVEY CLASSIFICATION OF THE NH CODE OF ADMINISTRATIVE RULES OF THE BOARD OF LICENSURE FOR LAND SURVEYORS. I CERTIFY THAT THIS SURVEY WAS MADE ON THE GROUND AND IS CORRECT TO THE BEST OF MY KNOWLEDGE AND BELIEF. RANDOM TRAVERSE SURVEY BY TOTAL STATION, WITH A PRECISION GREATER THAN 1:15,000."

Jeffrey A. Goldknopf L.L.S. #964
8-16-15 DATE


THE CERTIFICATIONS SHOWN HEREON ARE INTENDED TO MEET REGISTRY OF DEED REQUIREMENTS AND ARE NOT A CERTIFICATION TO TITLE OR OWNERSHIP OF PROPERTY SHOWN. OWNERS OF ADJOINING PROPERTIES ARE ACCORDING TO CURRENT TOWN ASSESSORS RECORDS.

EXISTING CONDITIONS PLAN
FOR
TIGHE & BOND AND LONZA
LAND OF
PEASE DEVELOPMENT AUTHORITY
(TAX MAP 305, LOTS 1 & 2)
GOOSE BAY DRIVE & CORPORATE DRIVE
PORTSMOUTH, NEW HAMPSHIRE


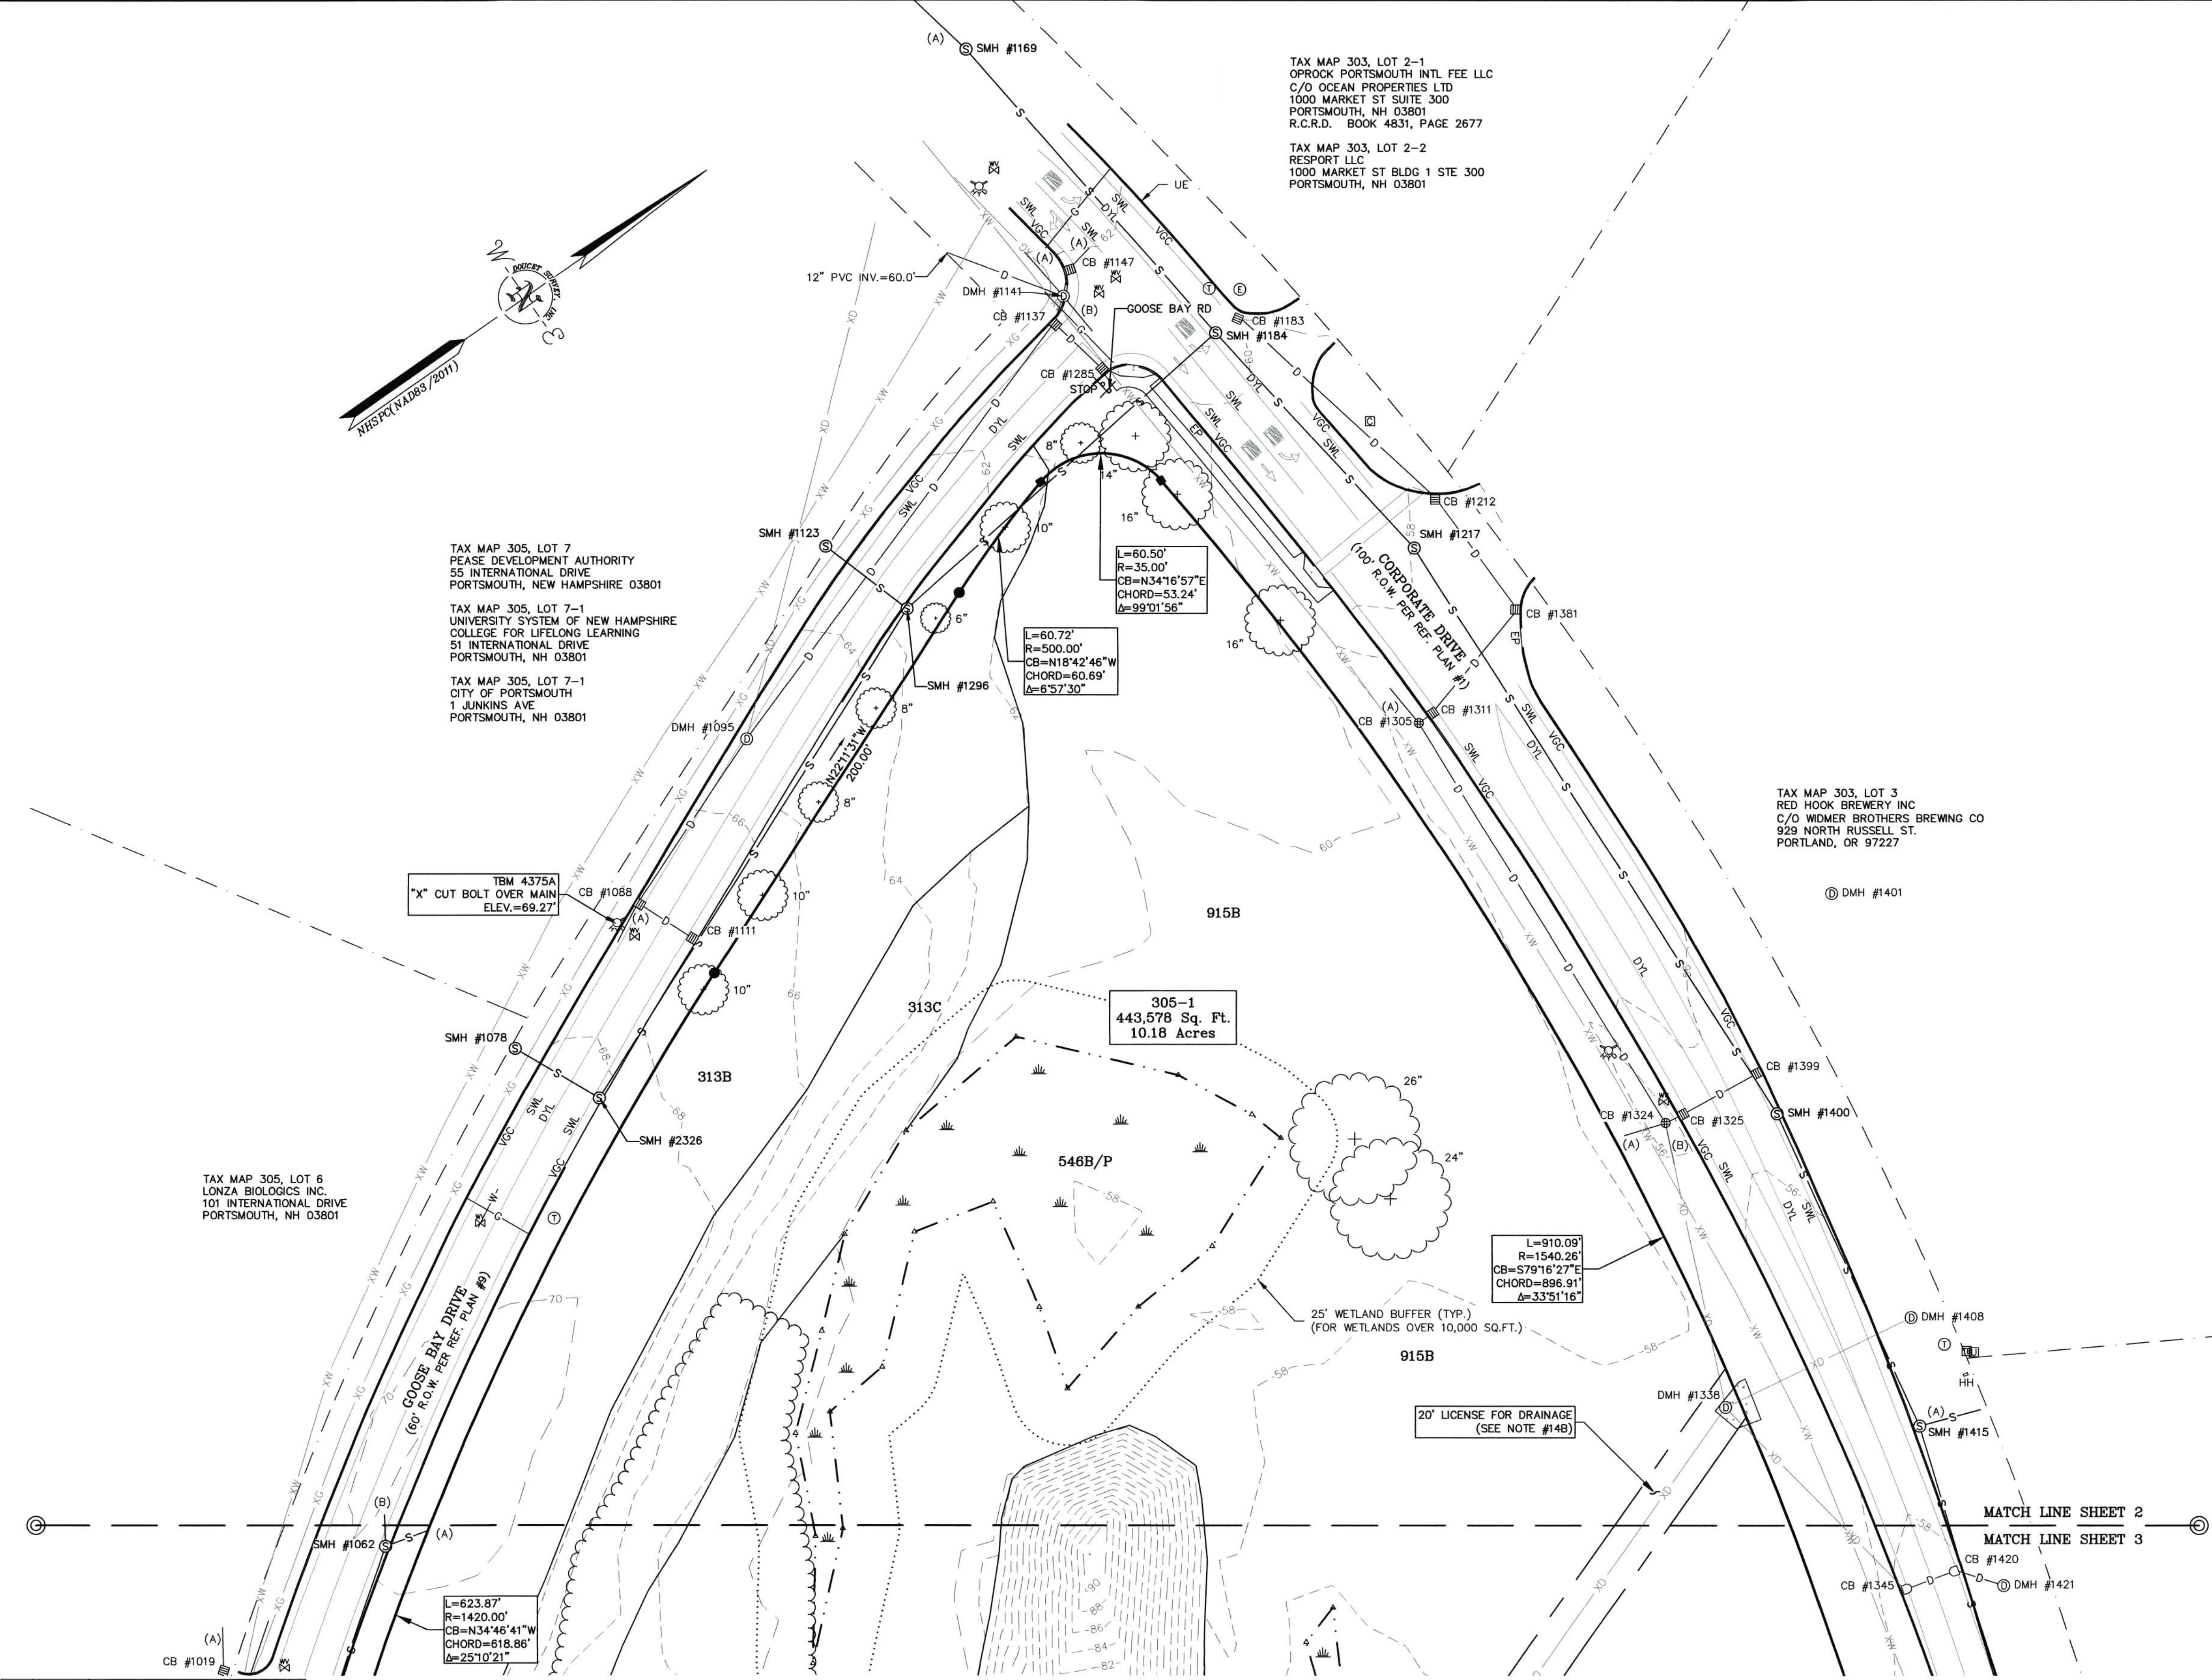


NO.	DATE	DESCRIPTION	BY
2	8/16/18	MOD. DRAINAGE	J.A.G.
		MOD. SOIL TYPES PER G.E.S.	
1	8/3/16	GENERAL EDITS AND ADDED WETLANDS BUFFER	J.A.G.

NOTE:
ALL ELECTRIC, GAS, TEL, WATER, SEWER AND DRAIN SERVICES ARE SHOWN IN SCHEMATIC FASHION. THEIR LOCATIONS ARE NOT PRECISE OR NECESSARILY ACCURATE. NO WORK WHATSOEVER SHALL BE UNDERTAKEN ON THIS SITE USING THIS PLAN TO LOCATE THE ABOVE SERVICES. CONSULT WITH THE PROPER AUTHORITIES CONCERNED WITH THE SUBJECT SERVICE LOCATIONS FOR INFORMATION REGARDING SUCH. CALL DIG-SAFE AT 1-888-DIG-SAFE.

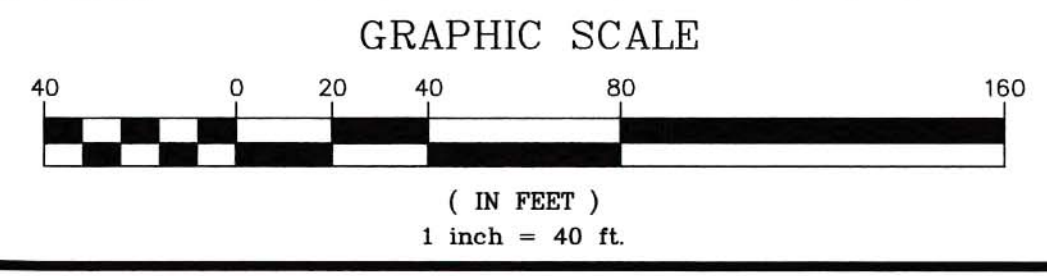


DRAWN BY:	K.C.W.	DATE:	DEC. 23, 2015
CHECKED BY:	J.A.G.	DRAWING NO.:	4375A
JOB NO.:	4375	SHEET	2 OF 4

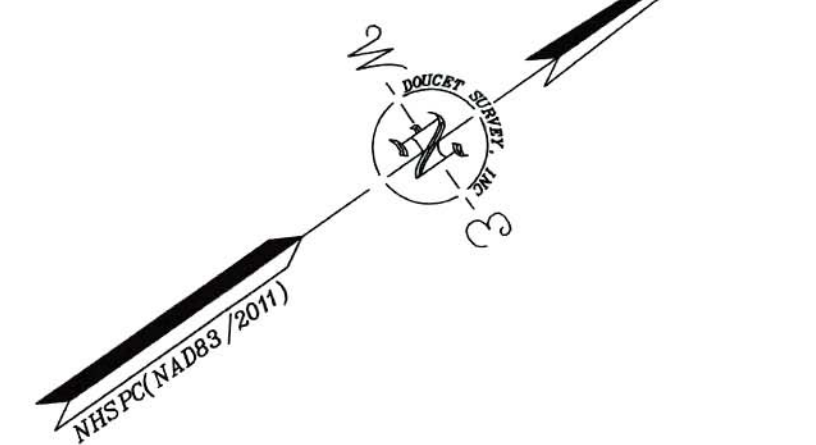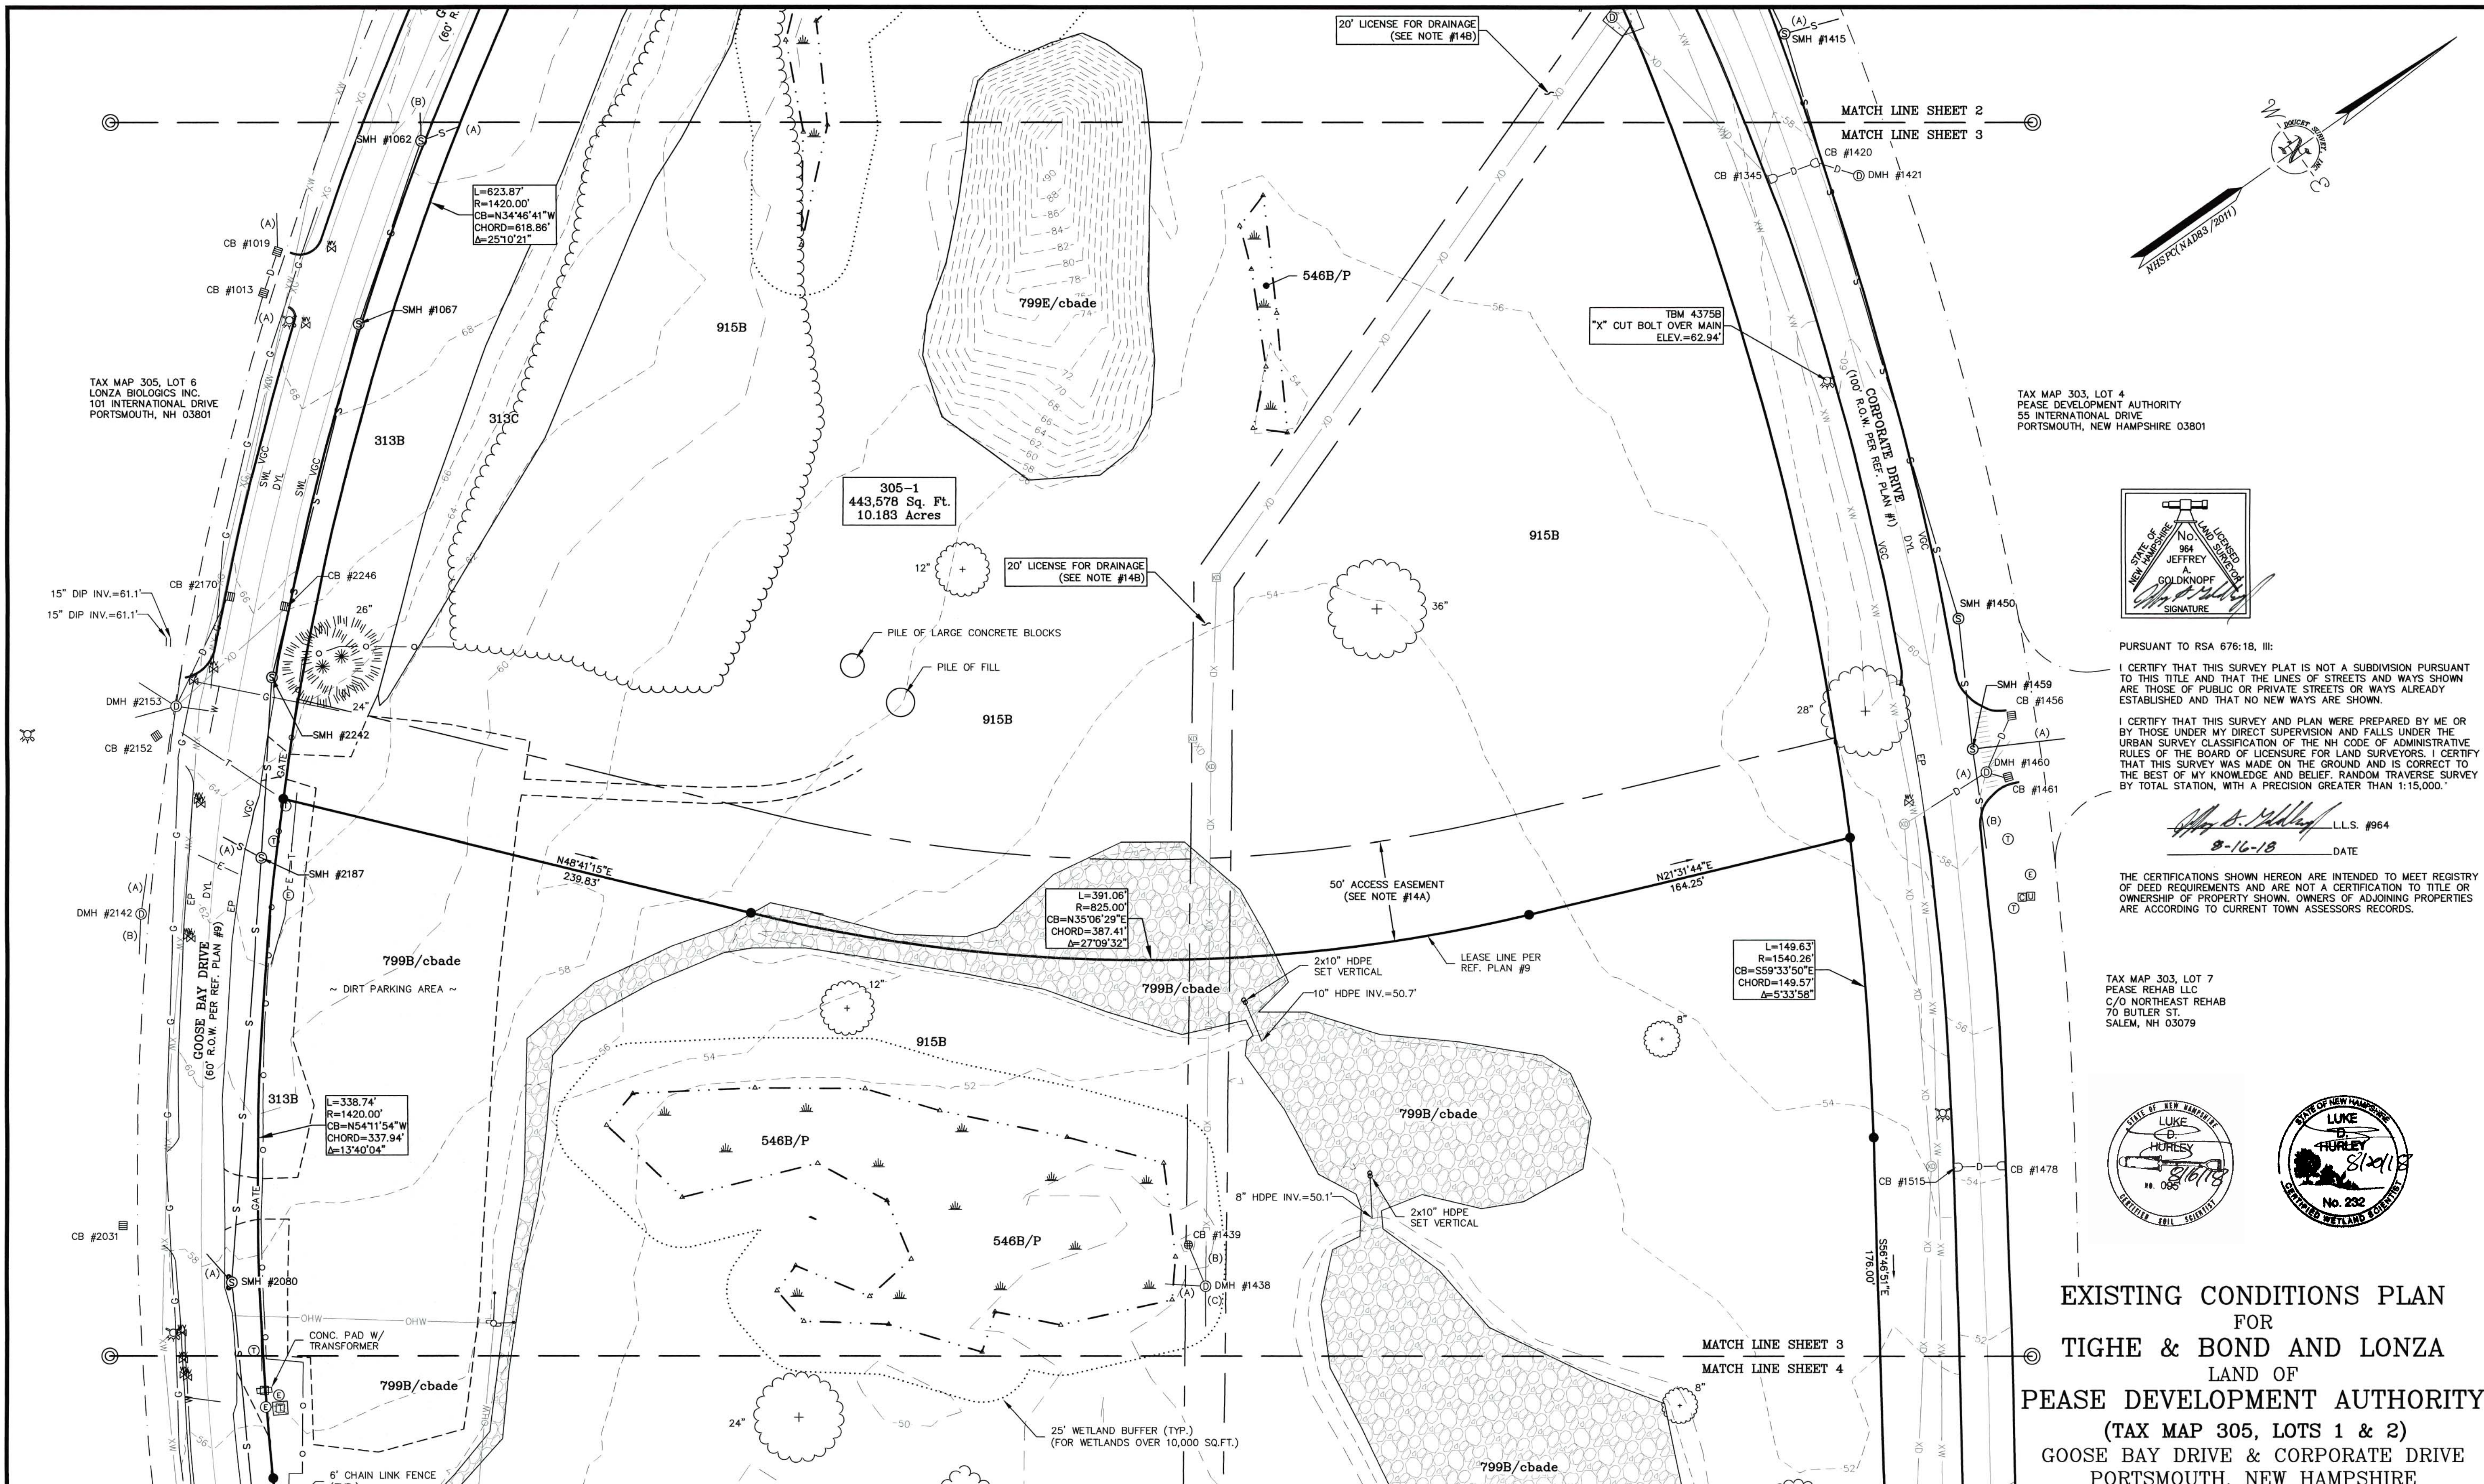

TAX MAP 305, LOT 6
LONZA BIOLOGICS INC.
101 INTERNATIONAL DRIVE
PORTSMOUTH, NH 03801

TAX MAP 303, LOT 4
PEASE DEVELOPMENT AUTHORITY
55 INTERNATIONAL DRIVE
PORTSMOUTH, NEW HAMPSHIRE 03801

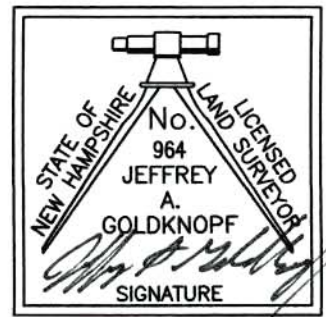

PURSUANT TO RSA 676:18, III:
I CERTIFY THAT THIS SURVEY PLAT IS NOT A SUBDIVISION PURSUANT TO THIS TITLE AND THAT THE LINES OF STREETS AND WAYS SHOWN ARE THOSE OF PUBLIC OR PRIVATE STREETS OR WAYS ALREADY ESTABLISHED AND THAT NO NEW WAYS ARE SHOWN.

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Luke D. Hurley L.L.S. #964
8-16-18 DATE

THE CERTIFICATIONS SHOWN HEREON ARE INTENDED TO MEET REGISTRY OF DEED REQUIREMENTS AND ARE NOT A CERTIFICATION TO TITLE OR OWNERSHIP OF PROPERTY SHOWN, OWNERS OF ADJOINING PROPERTIES ARE ACCORDING TO CURRENT TOWN ASSESSORS RECORDS.


TAX MAP 303, LOT 7
PEASE REHAB LLC
C/O NORTHEAST REHAB
70 BUTLER ST.
SALEM, NH 03079



EXISTING CONDITIONS PLAN
FOR
TIGHE & BOND AND LONZA
LAND OF
PEASE DEVELOPMENT AUTHORITY
(TAX MAP 305, LOTS 1 & 2)
GOOSE BAY DRIVE & CORPORATE DRIVE
PORTSMOUTH, NEW HAMPSHIRE




NO.	DATE	DESCRIPTION	BY
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DRAWN BY:	K.C.W.	DATE:	DEC. 23, 2015
CHECKED BY:	J.A.G.	DRAWING NO.:	4375A
JOB NO.:	4375	SHEET	3 OF 4



DOUCET SURVEY
Serving Your Professional Surveying & Mapping Needs
102 Kent Place, Newmarket, NH 03857 (603) 859-8560
10 Steer Street (Riverview Station) Kennebunk, ME (207) 502-7005
<http://www.doucetsurvey.com>

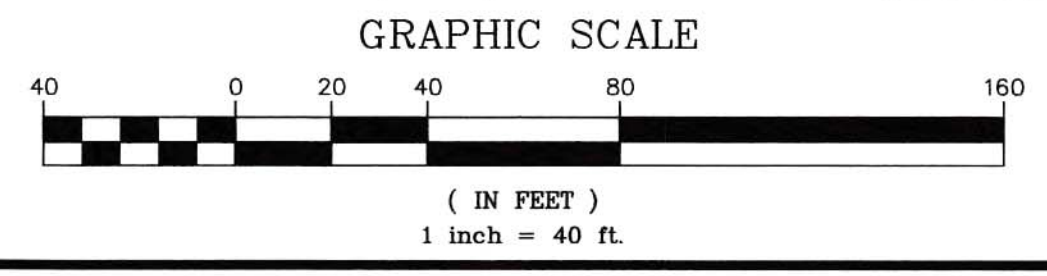

PURSUANT TO RSA 676:18, III:
 I CERTIFY THAT THIS SURVEY PLAN IS NOT A SUBDIVISION PURSUANT TO THIS TITLE AND THAT THE LINES OF STREETS AND WAYS SHOWN ARE THOSE OF PUBLIC OR PRIVATE STREETS OR WAYS ALREADY ESTABLISHED AND THAT NO NEW WAYS ARE SHOWN.
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Jeffrey A. Goldknopf L.L.S. #964
 8-16-18 DATE

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TAX MAP 303, LOT 7
 PEASE REHAB LLC
 C/O NORTHEAST REHAB
 70 BUTLER ST.
 SALEM, NH 03079

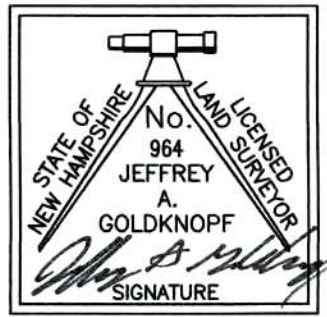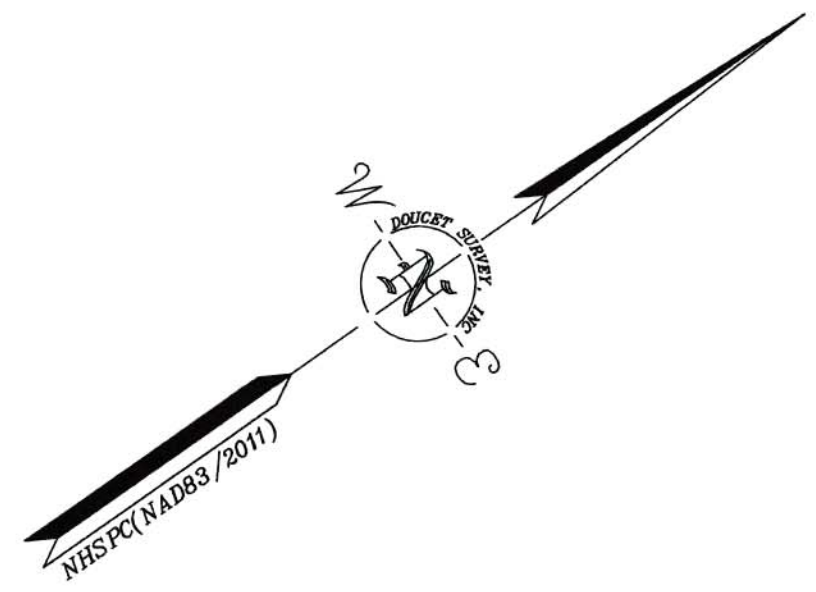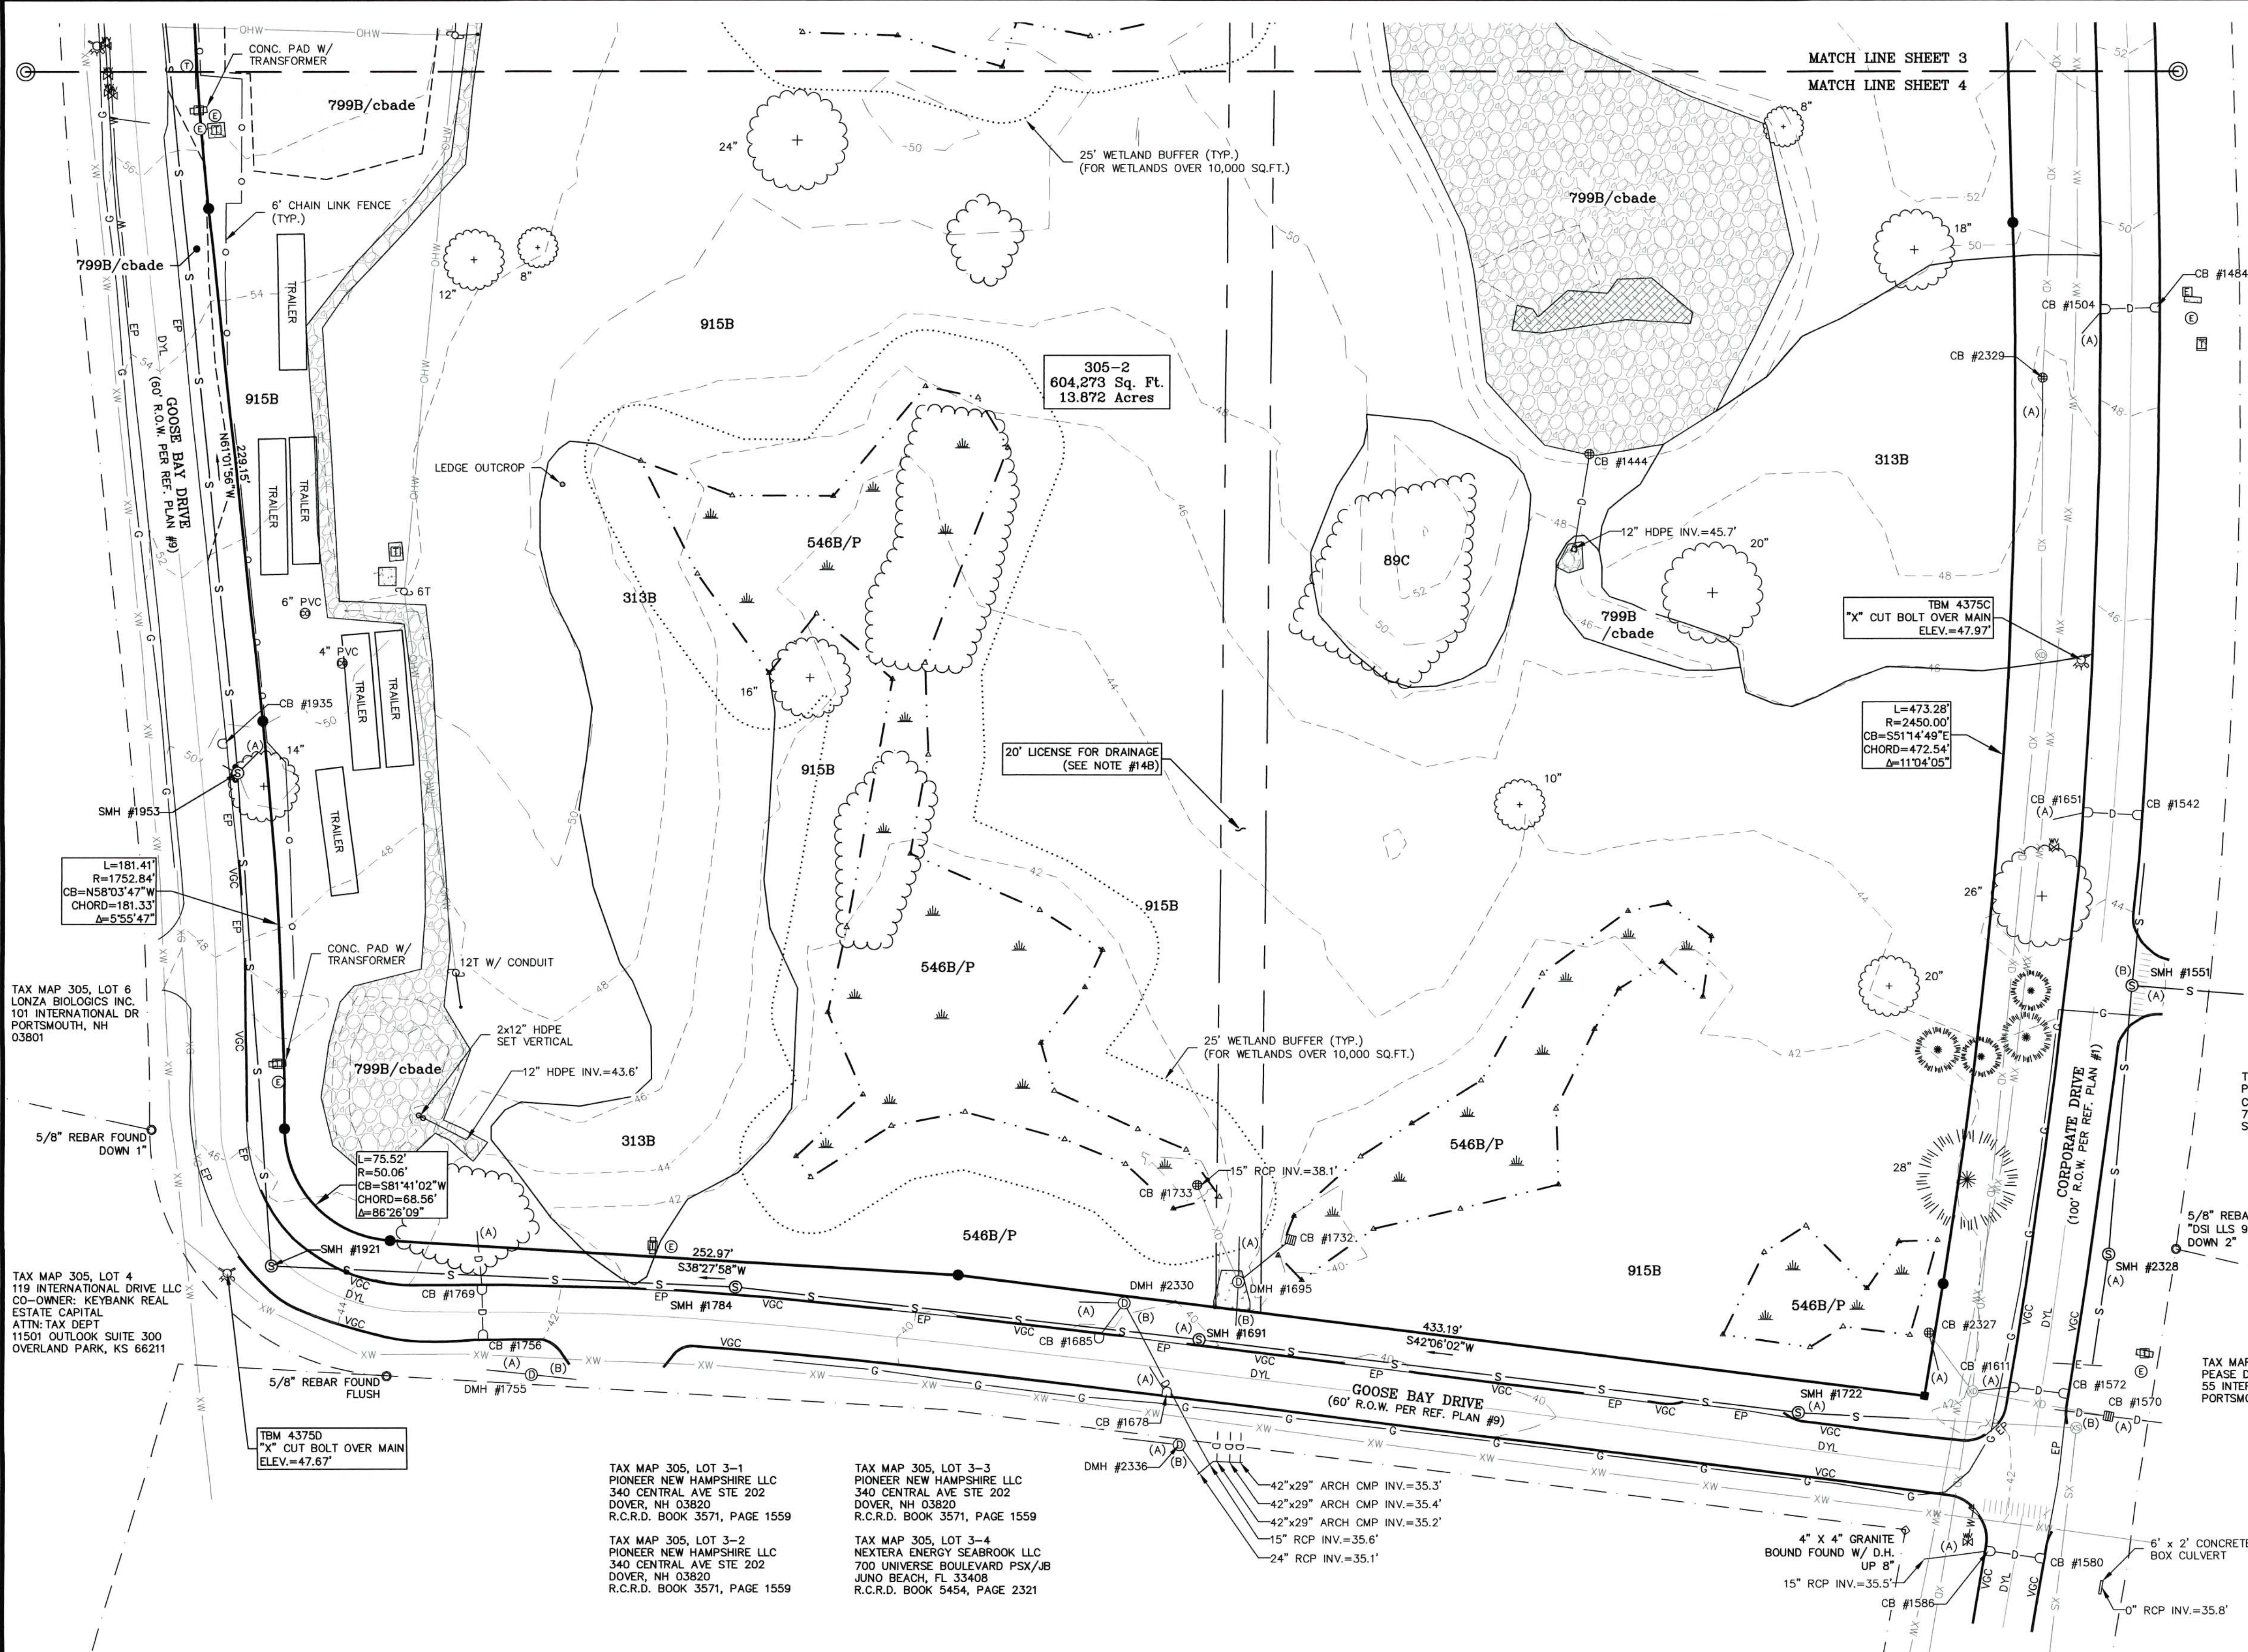5/8" REBAR FOUND W/
 "DSI ILLS 937" CAP,
 DOWN 2"

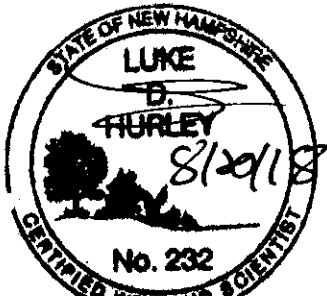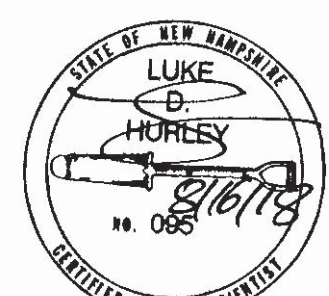TAX MAP 303, LOT 8
 PEASE DEVELOPMENT AUTHORITY
 55 INTERNATIONAL DRIVE
 PORTSMOUTH, NEW HAMPSHIRE 03801

**EXISTING CONDITIONS PLAN
 FOR
 TIGHE & BOND AND LONZA
 LAND OF
 PEASE DEVELOPMENT AUTHORITY
 (TAX MAP 305, LOTS 1 & 2)
 GOOSE BAY DRIVE & CORPORATE DRIVE
 PORTSMOUTH, NEW HAMPSHIRE**

TAX MAP 305, LOT 6
 LONZA BIOLOGICS INC.
 101 INTERNATIONAL DR
 PORTSMOUTH, NH
 03801

TAX MAP 305, LOT 4
 119 INTERNATIONAL DRIVE LLC
 CO-OWNER: KEYBANK REAL
 ESTATE CAPITAL
 ATTN: TAX DEPT.
 11501 OUTLOOK SUITE 300
 OVERLAND PARK, KS 66211

TAX MAP 305, LOT 3-1
 PIONEER NEW HAMPSHIRE LLC
 340 CENTRAL AVE STE 202
 DOVER, NH 03820
 R.C.R.D. BOOK 3571, PAGE 1559


TAX MAP 305, LOT 3-3
 PIONEER NEW HAMPSHIRE LLC
 340 CENTRAL AVE STE 202
 DOVER, NH 03820
 R.C.R.D. BOOK 3571, PAGE 1559

TAX MAP 305, LOT 3-2
 PIONEER NEW HAMPSHIRE LLC
 340 CENTRAL AVE STE 202
 DOVER, NH 03820
 R.C.R.D. BOOK 3571, PAGE 1559

TAX MAP 305, LOT 3-4
 NEXTERA ENERGY SEABROOK LLC
 700 UNIVERSE BOULEVARD PSX/JB
 JUNO BEACH, FL 33408
 R.C.R.D. BOOK 5454, PAGE 2321

NO.	DATE	DESCRIPTION	BY
2	8/16/18	MOD. DRAINAGE	J.A.G.
1	8/3/16	MOD. SOIL TYPES PER G.E.S. GENERAL EDITS AND ADDED WETLANDS BUFFER	J.A.G.


NOTE:
 ALL ELECTRIC, GAS, TEL, WATER, SEWER AND DRAIN SERVICES ARE SHOWN IN SCHEMATIC FASHION. THEIR LOCATIONS ARE NOT PRECISE OR NECESSARILY ACCURATE. NO WORK WHATSOEVER SHALL BE UNDERTAKEN ON THIS SITE USING THIS PLAN TO LOCATE THE ABOVE SERVICES. CONSULT WITH THE PROPER AUTHORITIES CONCERNED WITH THE SUBJECT SERVICE LOCATIONS FOR INFORMATION REGARDING SUCH. CALL DIG-SAFE AT 1-888-DIG-SAFE.

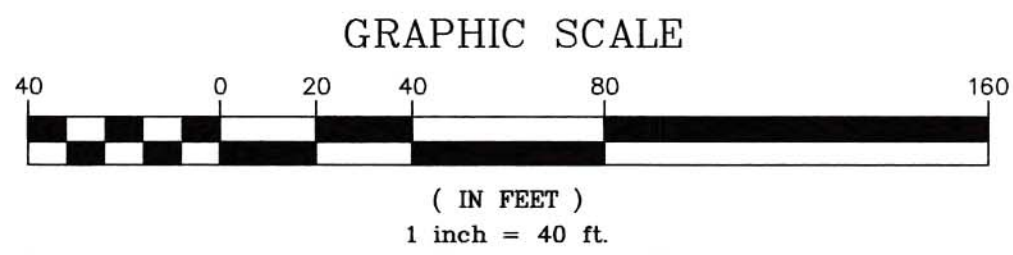

DRAWN BY:	K.C.W.	DATE:	DEC. 23, 2015
CHECKED BY:	J.A.G.	DRAWING NO.:	4375A
JOB NO.:	4375	SHEET	4 OF 4


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Carolyn Seay

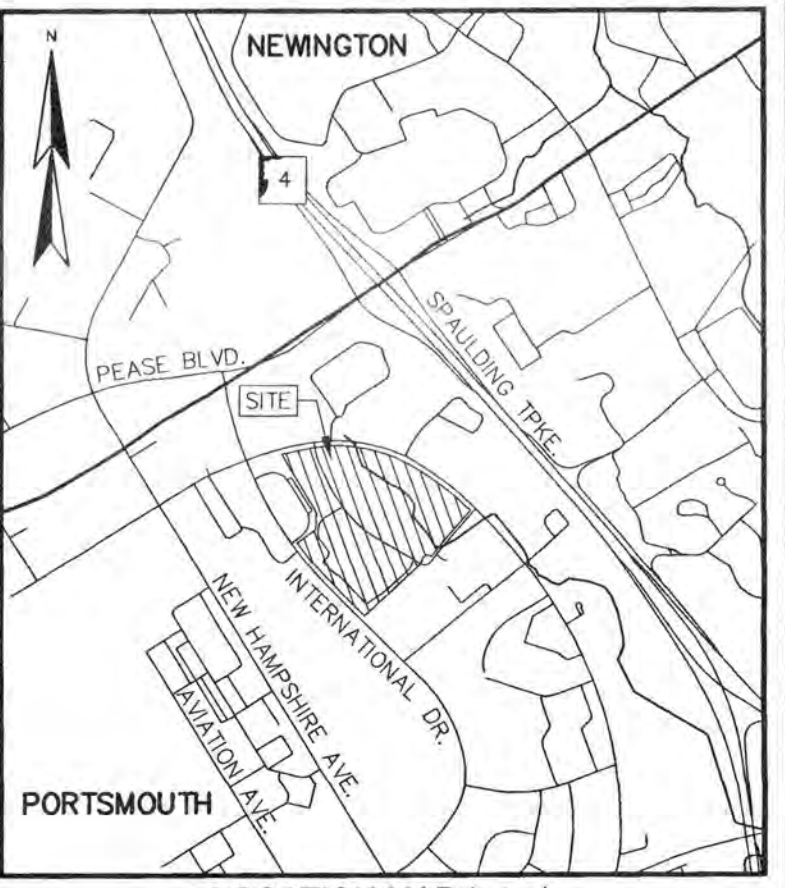

LOCATION MAP (n.t.s.)

- LEGEND**
- LEASE LINE
 - - - PROPOSED LEASE LINE
 - - - PROPOSED EASEMENT/LICENSE
 - - - LEASE/ROW/EASEMENT/LICENSE LINE TO BE ABANDONED
 - - - APPROXIMATE ABUTTERS LOT LINE
 - - - EASEMENT LINE
 - TAX MAP 305, LOT 3-4
 - DRILL HOLE FOUND
 - IRON PIPE/ROD FOUND
 - TYP. TYPICAL
 - GRAN. GRANITE
 - CONC. CONCRETE
 - BND. FND. BOUND FOUND
 - D.H.F. DRILL HOLE FOUND
 - I.P.F. IRON PIPE FOUND
 - 4"x4" GRANITE BOUND SET FLUSH (10/28/2021)
 - 5/8" REBAR W/ ID CAP SET FLUSH (10/28/2021)

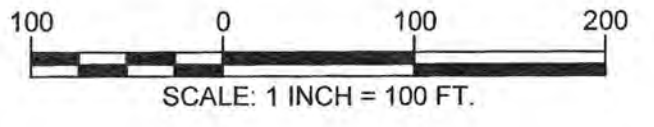


SUBDIVISION PLAN
 LAND OF
 PEASE DEVELOPMENT AUTHORITY
 LEASED TO
 LONZA BIOLOGICS, INC.
 OF
 TAX MAP 305 LOTS 1, 2, 5, 6, & 7
 AND
 GOOSE BAY DRIVE
 INTERNATIONAL DRIVE - CORPORATE DRIVE
 GOOSE BAY DRIVE
 PORTSMOUTH, NEW HAMPSHIRE

NO.	DATE	DESCRIPTION	BY
1	11/02/21	ADDED MONUMENTS SET	J.A.G.

DRAWN BY:	W.D.C.	DATE:	JUNE 21, 2021
CHECKED BY:	J.A.G.	DRAWING NO.:	6228B
JOB NO.:	6228	SHEET	1 OF 2

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APPROVED BY:
[Signature]
 PEASE DEVELOPMENT AUTHORITY
 CITY OF PORTSMOUTH PLANNING BOARD
 DATE: 12/16/21
 DATE: 12/22/21

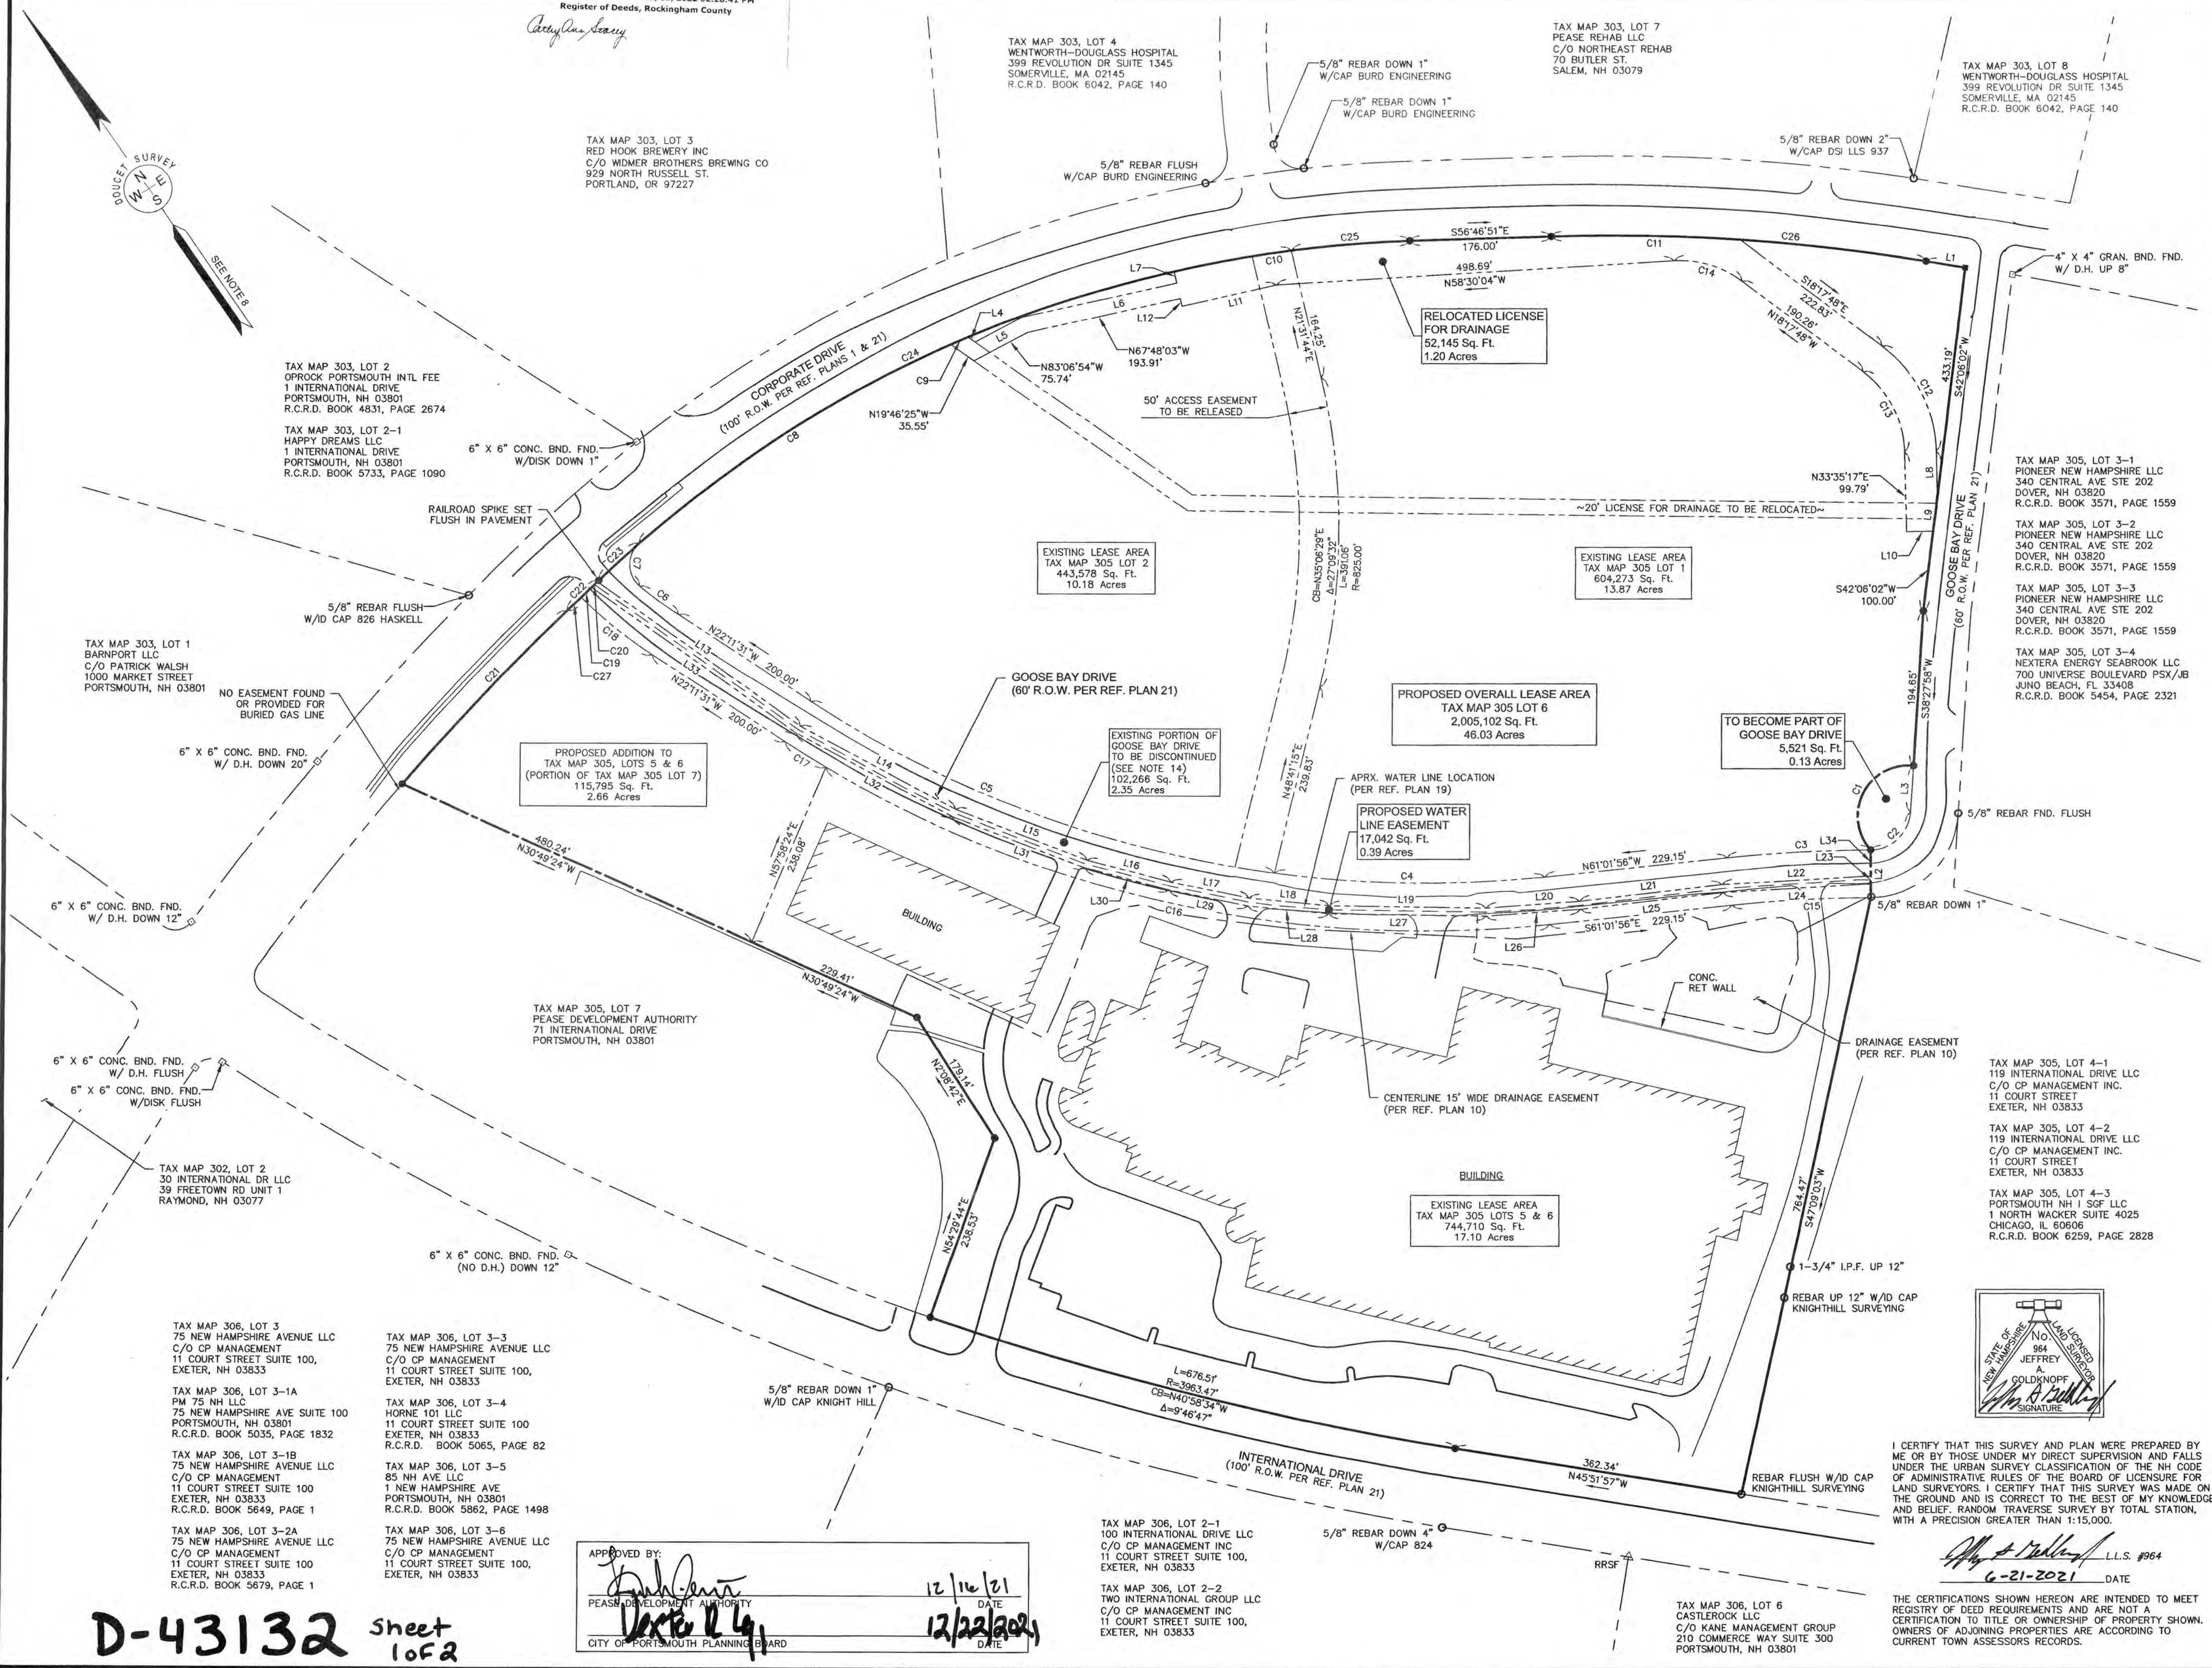I CERTIFY THAT THIS SURVEY AND PLAN WERE PREPARED BY ME OR BY THOSE UNDER MY DIRECT SUPERVISION AND FALLS UNDER THE URBAN SURVEY CLASSIFICATION OF THE NH CODE OF ADMINISTRATIVE RULES OF THE BOARD OF LICENSURE FOR LAND SURVEYORS. I CERTIFY THAT THIS SURVEY WAS MADE ON THE GROUND AND IS CORRECT TO THE BEST OF MY KNOWLEDGE AND BELIEF. RANDOM TRAVERSE SURVEY BY TOTAL STATION, WITH A PRECISION GREATER THAN 1:15,000.

[Signature] L.L.S. #964
 6-21-2021 DATE

THE CERTIFICATIONS SHOWN HEREON ARE INTENDED TO MEET REGISTRY OF DEED REQUIREMENTS AND ARE NOT A CERTIFICATION TO TITLE OR OWNERSHIP OF PROPERTY SHOWN. OWNERS OF ADJOINING PROPERTIES ARE ACCORDING TO CURRENT TOWN ASSESSORS RECORDS.

D-43132 Sheet 1 of 2

FILE NAME: \\P:\PROJECTS\43132\SUBDIVISION PLAN (SHEET 1) - 10/18/2021 10:00 AM; PLOTTED: Tuesday, December 14, 2021 - 4:01 PM

Christy L. Leary

NOTES:

- REFERENCE: TAX MAP 305, LOTS 5 & 6
PHYSICAL ADDRESS: 101 INTERNATIONAL DRIVE
TAX MAP 305, LOTS 1 & 2
PHYSICAL ADDRESS: 70 CORPORATE DRIVE
TAX MAP 305, LOT 7
PHYSICAL ADDRESS: 71 INTERNATIONAL DRIVE
- PROPOSED LEASE AREA: TAX MAP 305, LOT 6: 1,889,305 SQ. FT. OR 4⁺
- OWNER OF RECORD: PEASE DEVELOPMENT AUTHORITY
55 INTERNATIONAL DRIVE
PORTSMOUTH, NEW HAMPSHIRE 03801
R.C.R.D. BOOK 4227, PAGE 001
- LESSEE OF RECORD: TAX MAP 305, LOTS 5 & 6
LONZA BIOLOGICS, INC.
101 INTERNATIONAL DRIVE
PORTSMOUTH, NEW HAMPSHIRE 03801
R.C.R.D. BOOK 3015, PAGE 2559
(LEASE EXTENSIONS AND MODIFICATIONS
HAVE NOT BEEN RECORDED, BUT HAVE
BEEN PROVIDED BY THE LESSEE)
SEE REFERENCE PLAN 10
- ZONE: AIRPORT, BUSINESS, AND COMMERCIAL (ABC)
DIMENSIONAL REQUIREMENTS:
MINIMUM LOT AREA 217,800 sq.ft. OR 5.0 AC.
MINIMUM STREET FRONTAGE 200 ft.
FRONT YARD SETBACK 70 ft.
SIDE SETBACK 30 ft.
REAR SETBACK 50 ft.
MINIMUM OPEN SPACE 25 %
MAXIMUM STRUCTURE HEIGHT SHALL NOT EXCEED FAA CRITERIA
WETLAND BUFFER 25 ft. (PER PDA REGULATIONS: WETLANDS LESS THAN 1/4 ACRE DO NOT HAVE A BUFFER)
ZONING INFORMATION LISTED HEREON WAS PROVIDED BY TIGHE & BOND. ADDITIONAL REGULATIONS APPLY, AND REFERENCE IS HEREBY MADE TO THE EFFECTIVE ZONING ORDINANCE. THE LAND OWNER IS RESPONSIBLE FOR COMPLYING WITH ALL APPLICABLE MUNICIPAL, STATE, AND FEDERAL REGULATIONS.
- FIELD SURVEY PERFORMED BY B.T. & J.C.M. DURING MARCH 2018 USING A TRIMBLE S6 ROBOTIC TOTAL STATION WITH A TRIMBLE TSC3 DATA COLLECTOR. TRAVERSE ADJUSTMENT BASED ON LEAST SQUARE ANALYSIS.
- FLOOD HAZARD ZONE: "X", PER FIRM MAP #33015C0260F, MAP REVISED JANUARY 29, 2021.
- HORIZONTAL DATUM BASED ON NH STATE PLANE 2800(NAD83/86) PER REFERENCE PLANS 10, 11, & 12.
- THE INTENT OF THIS PLAN IS TO SHOW THE LOCATION OF BOUNDARIES IN ACCORDANCE WITH AND IN RELATION TO THE CURRENT LEGAL DESCRIPTION, AND IS NOT AN ATTEMPT TO DEFINE UNWRITTEN RIGHTS, DETERMINE THE EXTENT OF OWNERSHIP, OR DEFINE THE LIMITS OF TITLE.
- TAX MAP 305, LOTS 1 & 2 ARE EITHER SUBJECT TO OR IN BENEFIT OF, BUT NOT LIMITED TO, THE FOLLOWING EASEMENTS/RIGHTS OF RECORD:
10.A. 50' WIDE ACCESS EASEMENT FOR THE BENEFIT OF LOT 305-2. (SHOWN PER REFERENCE PLAN 9)
10.B. APPROXIMATE LOCATION OF 20' WIDE LICENSE TO THE CITY OF PORTSMOUTH FOR THE PURPOSES OF MAINTAINING A DRAINAGE LINE. (SHOWN PER REFERENCE PLAN 9)
- TAX MAP 305, LOTS 5 & 6 ARE EITHER SUBJECT TO OR IN BENEFIT OF, BUT NOT LIMITED TO, THE FOLLOWING EASEMENTS/RIGHTS OF RECORD:
11.A. 15' WIDE DRAINAGE EASEMENT. (SHOWN PER REFERENCE PLAN 10)
11.B. DRAINAGE EASEMENT. (SHOWN PER REFERENCE PLAN 10)
- FINAL MONUMENTATION MAY BE DIFFERENT THAN THE PROPOSED MONUMENTATION SHOWN HEREON, DUE TO THE FACT THAT SITE CONDITIONS WILL DICTATE THE ACTUAL LOCATION AND TYPE OF MONUMENTS INSTALLED IN THE FIELD. PLEASE REFER TO EITHER THE "MONUMENTATION LOCATION PLAN" TO BE RECORDED OR CONTACT DOUCET SURVEY, INC. FOR CLARIFICATION OF MONUMENTS SET. (A RECORDED PLAN WILL BE PRODUCED AT THE DISCRETION OF DOUCET SURVEY, INC.).
- IMPROVEMENTS SHOWN HEREON ARE APPROXIMATE.
- REGARDING THE PORTION GOOSE BAY DRIVE TO BECOME PART OF THE PROPOSED LEASE AREA:
14.A. THE PEASE DEVELOPMENT AUTHORITY REPORTS THAT THE OWNERSHIP UNDERLYING ROADWAYS WITHIN THE TRADEPORT REMAINS VESTED IN THE PEASE DEVELOPMENT AUTHORITY.
14.B. THE PEASE DEVELOPMENT AUTHORITY REPORTS THAT THERE ARE UNDERGROUND UTILITY EASEMENTS ON LANDS IN THEIR OWNERSHIP. THIS MAY INCLUDE, BUT NOT BE LIMITED TO, BURIED OVERHEAD ELECTRIC, TELECOMMUNICATIONS, GAS, WATER, AND SEWER.
- THE APPLICANT WILL BE REQUESTING THE FOLLOWING WAIVER FROM THE BOARD REGARDING SECTION IV.3.I. CUL-DE-SACS:
15.A. MAXIMUM LENGTH OF CUL-DE-SAC OF 50'
15.B. MINIMUM RADIUS OF CUL-DE-SAC PAVEMENT OF 50'

REFERENCE PLANS:

- "R.O.W. WORKSHEET, CORPORATE DRIVE PREPARED FOR PEASE DEVELOPMENT AUTHORITY" DATED DEC. 21, 1992 BY RICHARD D. BARTLETT & ASSOCIATES, INC. SHEETS 1 AND 2. (NOT RECORDED)
- "PEASE A.F.B. / PORTSMOUTH, N.H. REPAVE BASE STREETS, PORTSMOUTH AVE, ROCKINGHAM AVE." DATED 7 DEC 82 BY STRATEGIC AIR COMMAND CIVIL ENGINEERING. SHEET 4 OF 5. (NOT RECORDED)
- "PORTSMOUTH AIR FORCE BASE, PORTSMOUTH, N.H. ROADS AND STORAGE AREA FY-56" DATED DEC 1955 BY WHITMAN & HOWARD ENGINEERS. INDEX PAGE AND SHEETS 2 - 5 OF 11. (NOT RECORDED)
- "PEASE INTERNATIONAL TRADEPORT SUBDIVISION PLAT, INTERNATIONAL DRIVE LOTS BC11-001 & BC11-002, PORTSMOUTH, N.H." DATED FEBRUARY 5, 1993 BY RICHARD D. BARTLETT & ASSOCIATES INC. R.C.R.D. PLAN D-22536.
- "SUBDIVISION PLAN OF LAND FOR REDHOOK ALE BREWERY, INC. CORPORATE DRIVE, COUNTY OF ROCKINGHAM, PORTSMOUTH, N.H." DATED DECEMBER 10, 1994 BY RICHARD P. MILLETTE AND ASSOCIATES. R.C.R.D. PLAN D-23978.
- "ALTA/ACSM LAND TITLE SURVEY FOR RESPORT, LLC, ONE INTERNATIONAL DRIVE, COUNTY OF ROCKINGHAM, PORTSMOUTH, N.H." DATED FEBRUARY 27, 1998 BY MILLETTE, SPRAGUE & COLWELL, INC. R.C.R.D. PLAN D-26125.
- "FRANKLIN PIERCE COLLEGE, PEASE INTERNATIONAL TRADEPORT, 73 CORPORATE DRIVE, PORTSMOUTH, NH" DATED JANUARY 15, 1998 BY RONALD R. BURD. R.C.R.D. PLAN D-26427.
- "SUBDIVISION PLAN FOR LAND LEASED BY PEASE DEVELOPMENT AUTHORITY & KNOWN AS 119 INTERNATIONAL DRIVE LOCATED AT PEASE INTERNATIONAL TRADEPORT, PORTSMOUTH, N.H." DATED MARCH 1, 2000 BY KNIGHT HILL LAND SURVEYING SERVICES, INC. R.C.R.D. PLAN D-28059.
- "SUBDIVISION PLAT PREPARED FOR 80 CORPORATE DRIVE LLC C/O BOULOS PROPERTY MANAGEMENT, LOCATION CORPORATE & GOOSE BAY DRIVES, PEASE INTERNATIONAL TRADEPORT - PORTSMOUTH, NH" DATED APRIL 11, 2000 BY FWS LAND SURVEYING P.L.L.C. R.C.R.D. PLAN D-28447.
- "LEASE LINE REVISION PLAN FOR LONZA BIOLOGICS, INC. 101 INTERNATIONAL DRIVE, PORTSMOUTH, NEW HAMPSHIRE" DATED SEPT. 17, 2001 BY DOUCET SURVEY, INC. R.C.R.D. PLAN D-29538.
- "SUBDIVISION PLAN OF LAND OF PEASE DEVELOPMENT AUTHORITY TO BE LEASED TO NORTHEAST REHABILITATION (A PORTION OF TAX MAP 303, LOT 6) 105 & 121 CORPORATE DRIVE, PEASE TRADEPORT, PORTSMOUTH, NEW HAMPSHIRE" DATED NOV. 5, 2008 BY DOUCET SURVEY, INC. R.C.R.D. PLAN D-35869.
- "CONDOMINIUM SITE & FLOOR PLAN PREPARED FOR PIONEER NEW HAMPSHIRE, LLC, LAND OF PEASE DEVELOPMENT AUTHORITY, TAX MAP PARCEL 305-3 (108, 110, 112 & 114 CORPORATE DRIVE) PORTSMOUTH, NEW HAMPSHIRE" DATED APRIL 12, 2013 BY FIELDSTONE LAND CONSULTANTS, PLLC. SHEET 1 OF 5. R.C.R.D. PLAN D-37765.
- "SUBDIVISION PLAN FOR PEASE DEVELOPMENT AUTHORITY, (TAX MAP 303, LOT 4) 67 CORPORATE DRIVE, PEASE TRADEPORT, PORTSMOUTH NEW HAMPSHIRE" DATED MAY 29, 2009 BY DOUCET SURVEY, INC. (NOT RECORDED)
- "EXISTING CONDITIONS, BUILDING A, 80 CORPORATE DRIVE AND BUILDING B, 70 CORPORATE DRIVE, PORTSMOUTH, NH" DATED 4/14/2000 AND REVISED 6/05/2000 BY OPECHEE CONSTRUCTION CORPORATION. (NOT RECORDED)
- "EXISTING CONDITIONS PLAN FOR TIGHE & BOND AND LONZA, LAND OF PEASE DEVELOPMENT AUTHORITY, (TAX MAP 305, LOTS 1 & 2), GOOSE BAY DRIVE & CORPORATE DRIVE, PORTSMOUTH, NEW HAMPSHIRE" DATED DECEMBER 23, 2015 BY DOUCET SURVEY, INC. (NOT RECORDED)
- "119 INTERNATIONAL DRIVE CONDOMINIUM, CONDOMINIUM SITE PLAN, FOR PROPERTY OWNED BY PEASE DEVELOPMENT AUTHORITY, LEASED TO 119 INTERNATIONAL DRIVE, LLC, KNOWN AS PORTSMOUTH TAX MAP 305, LOT 4, PORTSMOUTH, NH" DATED OCT. 10, 2017 BY KNIGHT HILL LAND SURVEYING SERVICES, INC. R.C.R.D. PLAN 40449
- "ALTA/NSPS LAND TITLE SURVEY FOR 130 INTERNATIONAL DRIVE, LLC AND PEASE DEVELOPMENT AUTHORITY, 130 INTERNATIONAL DRIVE, PORTSMOUTH, NH" DATED JULY 2017 AND REVISED THROUGH 8/9/17 BY DOUCET SURVEY, INC. (NOT RECORDED)
- "ALTA/ACSM LAND TITLE SURVEY FOR 100 INTERNATIONAL DRIVE, LLC, 100 INTERNATIONAL DRIVE, PEASE INTERNATIONAL TRADEPORT, PORTSMOUTH, NH" DATED MARCH 30, 2006 BY DOUCET SURVEY, INC. (NOT RECORDED)
- "CITY OF PORTSMOUTH, NEW HAMPSHIRE, FOR CONSTRUCTION, CORPORATE DRIVE AND GOOSE BAY DRIVE SEWER IMPROVEMENTS" DATED JULY 28, 2017 BY UNDERWOOD ENGINEERS, INC. (NOT RECORDED)
- "SUBDIVISION PLAN FOR LONZA BIOLOGICS, INC. AND THE PEASE DEVELOPMENT AUTHORITY OF TAX MAP 305, LOTS 1, 2, 5 & 6 AND GOOSE BAY DRIVE, INTERNATIONAL DRIVE - CORPORATE DRIVE - GOOSE BAY DRIVE, PORTSMOUTH, NEW HAMPSHIRE" DATED APRIL 16, 2018 BY DOUCET SURVEY, INC (NOT RECORDED)
- "APPENDIX VI, MUNICIPAL SERVICES AGREEMENT BETWEEN CITY OF PORTSMOUTH, TOWN OF NEWINGTON AND PEASE DEVELOPMENT AUTHORITY" EFFECTIVE AS OF JULY 1, 1998 (ROADWAY WIDTHS) (NOT RECORDED)
- "THIRD AMENDED SITE/FLOOR PLAN ADDENDUM FOR 75 NEW HAMPSHIRE CONDOMINIUM SHOWING BUILDING 5 - UNIT 6 - LIMITED COMMON AREA" DATED JULY 2019 BY KNIGHT HILL LAND SURVEYING SERVICES, INC. R.C.R.D. PLAN D-41611
- "LEASE LINE DISCONTINUANCE & EXISTING BUILDING UPDATE PLAN, 25, 29 RETAIL CONDOMINIUM" DATED DECEMBER 2018 AND REVISED JULY 20, 2017 BY KNIGHT HILL LAND SURVEYING SERVICES. R.C.R.D. PLAN D-40388
- "SUBDIVISION PLAN AT 30 INTERNATIONAL DRIVE AT PEASE INTERNATIONAL TRADEPORT, PORTSMOUTH, NEW HAMPSHIRE" DATED JANUARY 1997 BY CLD CONSULTING ENGINEERS & SURVEYORS R.C.R.D. PLAN D-25370
- "LEASE LINE REVISION FOR BARNPORT, LLC AND PEASE DEVELOPMENT AUTHORITY, 27 INTERNATIONAL DRIVE, PORTSMOUTH, NEW HAMPSHIRE" DATED APRIL 11, 2000 BY DOUCET SURVEY, INC. R.C.R.D. PLAN D-28254

LINE	BEARING	DISTANCE
L1	S45°42'46"E	50.48'
L2	S34°54'07"W	60.00'
L3	S38°27'58"W	58.32'
L4	N19°46'25"W	11.01'
L5	N83°06'54"W	66.09'
L6	N67°48'03"W	196.60'
L7	S22°03'02"W	14.87'
L8	S33°35'17"W	57.08'
L9	S42°06'02"W	43.59'
L10	N55°44'33"W	33.55'
L11	N67°48'03"W	122.22'
L12	N22°11'57"E	10.00'
L13	N19°52'39"W	313.89'
L14	N27°09'05"W	222.06'
L15	N33°51'22"W	175.26'
L16	N40°07'36"W	107.83'
L17	N43°37'13"W	99.98'

LINE	BEARING	DISTANCE
L18	N49°42'47"W	102.16'
L19	N54°07'45"W	195.64'
L20	N59°11'41"W	116.15'
L21	N61°40'21"W	179.46'
L22	N58°20'21"W	187.76'
L23	S34°54'07"W	10.02'
L24	N58°20'21"W	186.91'
L25	N61°40'21"W	179.39'
L26	N59°11'41"W	116.81'
L27	N54°07'45"W	196.47'
L28	N49°42'47"W	103.08'
L29	N43°37'13"W	100.81'
L30	N40°07'36"W	108.68'
L31	N33°51'22"W	176.39'
L32	N27°09'05"W	223.29'
L33	N19°52'39"W	316.47'
L34	S34°54'07"W	32.65'

CURVE	ARC LENGTH	RADIUS	DELTA ANGLE	CHORD BEARING	CHORD LENGTH
C1	152.83'	63.00'	138°59'47"	S61°54'24"W	118.02'
C2	75.52'	50.06'	86°26'09"	S81°41'02"W	68.56'
C3	181.41'	1752.84'	5°55'47"	N58°03'47"W	181.33'
C4	338.74'	1420.00'	13°40'04"	S54°11'54"E	337.94'
C5	623.87'	1420.00'	25°10'21"	S34°46'41"E	618.86'
C6	60.72'	500.00'	6°57'30"	S18°42'46"E	60.69'
C7	60.50'	35.00'	99°01'56"	S34°16'57"W	53.24'
C8	466.96'	1540.26'	17°22'14"	N87°30'58"W	465.18'
C9	23.43'	1540.26'	0°52'17"	N78°23'43"W	23.43'
C10	300.24'	1540.26'	11°10'07"	N62°21'55"W	299.77'
C11	237.27'	2450.00'	5°32'56"	N54°00'23"W	237.18'
C12	153.95'	170.00'	51°53'06"	N7°38'44"E	148.74'
C13	117.72'	130.00'	51°53'06"	N7°38'44"E	113.74'
C14	91.22'	130.00'	40°12'15"	N38°23'56"W	89.36'
C15	175.20'	1692.80'	5°55'47"	N58°03'47"W	175.12'
C16	942.18'	1480.00'	36°28'30"	S42°47'41"E	926.35'
C17	61.10'	1480.00'	2°21'56"	N23°22'29"W	61.10'
C18	115.23'	560.00'	11°47'23"	N16°17'50"W	115.03'
C19	18.12'	3710.06'	0°16'48"	S80°54'45"W	18.12'
C20	10.19'	3710.06'	0°09'26"	N81°07'52"E	10.19'
C21	298.54'	3710.06'	4°36'38"	N78°05'40"E	298.46'
C22	54.86'	3710.06'	0°50'50"	N80°49'24"E	54.86'
C23	68.59'	1540.26'	2°33'06"	N82°31'22"E	68.59'
C24	910.09'	1540.26'	33°51'16"	S79°16'27"E	896.91'
C25	149.63'	1540.26'	5°33'58"	S59°33'50"E	149.57'
C26	473.28'	2450.00'	11°04'05"	S51°14'49"E	472.54'
C27	24.14'	3710.06'	0°22'22"	N80°35'10"E	24.14'

SUBDIVISION PLAN
LAND OF
PEASE DEVELOPMENT AUTHORITY
LEASED TO
LONZA BIOLOGICS, INC.
OF
TAX MAP 305 LOTS 1, 2, 5, 6, & 7
AND
GOOSE BAY DRIVE
INTERNATIONAL DRIVE - CORPORATE DRIVE
GOOSE BAY DRIVE
PORTSMOUTH, NEW HAMPSHIRE

NO.	DATE	ADDED MONUMENTS SET	J.A.G.
1	11/02/21		
		DESCRIPTION	BY

DRAWN BY:	W.D.C.	DATE:	JUNE 21, 2021
CHECKED BY:	J.A.G.	DRAWING NO.:	6228B
JOB NO.:	6228	SHEET	2 OF 2

I CERTIFY THAT THIS SURVEY AND PLAN WERE PREPARED BY ME OR BY THOSE UNDER MY DIRECT SUPERVISION AND FALLS UNDER THE URBAN SURVEY CLASSIFICATION OF THE NH CODE OF ADMINISTRATIVE RULES OF THE BOARD OF LICENSURE FOR LAND SURVEYORS. I CERTIFY THAT THIS SURVEY WAS MADE ON THE GROUND AND IS CORRECT TO THE BEST OF MY KNOWLEDGE AND BELIEF. RANDOM TRAVERSE SURVEY BY TOTAL STATION, WITH A PRECISION GREATER THAN 1:15,000.

Jeffrey A. Goldknope L.L.S. #964
6-21-2021 DATE

THE CERTIFICATIONS SHOWN HEREON ARE INTENDED TO MEET REGISTRY OF DEED REQUIREMENTS AND ARE NOT A CERTIFICATION TO TITLE OR OWNERSHIP OF PROPERTY SHOWN. OWNERS OF ADJOINING PROPERTIES ARE ACCORDING TO CURRENT TOWN ASSESSORS RECORDS.

APPROVED BY:
Jeffrey A. Goldknope
PEASE DEVELOPMENT AUTHORITY
CITY OF PORTSMOUTH PLANNING BOARD
DATE: 12/16/21
DATE: 12/22/21



D-43132 sheet 2 of 2



MASTER PLAN SET

APRIL 3, 2018

REVISED: NOVEMBER 9, 2023







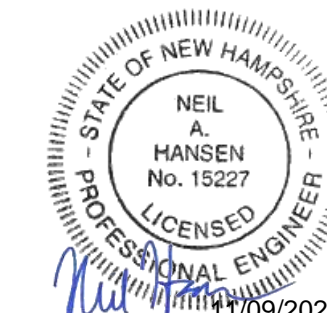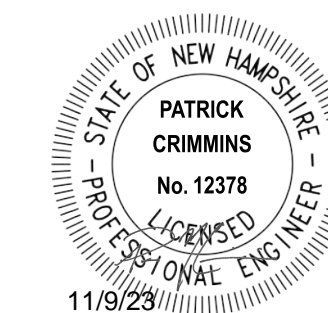






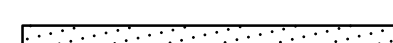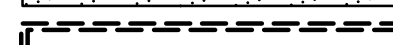

LIST OF DRAWINGS		
SHEET NO.	SHEET TITLE	LAST REVISED
	MASTER PLAN SET COVER SHEET	11/9/2023
C-101	DEMOLITION PLAN	9/27/2023
C-102	DEMOLITION PLAN	11/9/2023
C-103	DEMOLITION PLAN	11/9/2023
C-104	OVERALL SITE PLAN	9/27/2023
C-105	SITE PLAN	11/9/2023
C-106	SITE PLAN	11/9/2023
C-107	SITE PLAN	11/9/2023
C-108	GRADING, DRAINAGE & EROSION CONTROL PLAN	11/9/2023
C-109	GRADING, DRAINAGE & EROSION CONTROL PLAN	11/9/2023
C-110	GRADING, DRAINAGE & EROSION CONTROL PLAN	11/9/2023
C-111	UTILITIES PLAN	9/27/2023
C-112	UTILITIES PLAN	11/9/2023
C-113	UTILITIES PLAN	11/9/2023
C-114	LANDSCAPE PLAN	9/27/2023
C-115	LANDSCAPE PLAN	11/9/2023
C-116	LANDSCAPE PLAN	11/9/2023
C-117	PHOTOMETRIC LIGHTING PLAN	9/27/2023
C-118	PHOTOMETRIC LIGHTING PLAN	9/27/2023
C-119	PHOTOMETRIC LIGHTING PLAN	9/27/2023
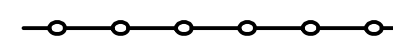
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Plot Date: Thursday, November 09, 2023 Plotted By: Neil A. Hansen
P&E File Location: J:\U700\Lozza Biologicals Expansion.was.12767.026 - Project Abstract\Drawings\AutoCAD\0700-026-C-CORR.dwg Layout Tab: MASTER-CS





COMPLETE SET 20 SHEETS

LEGEND

-  APPROXIMATE LIMIT OF PROPOSED SAW CUT
-  LIMIT OF WORK
-  TREELINE TO BE REMOVED
-  APPROXIMATE LIMIT OF PAVEMENT TO BE REMOVED
-  LOCATION OF PROPOSED BUILDING
-  PROPOSED CONSTRUCTION ENTRANCE
-  PROPOSED SILT SOCK
-  PROPOSED TEMPORARY SNOW FENCE
-  PROPOSED TREE PROTECTION
-  PROPOSED INLET PROTECTION BARRIER
-  TBR TO BE REMOVED
-  BLDG TO BE REMOVED
-  TYP TYPICAL
-  COORD COORDINATE
-  CONST CONSTRUCT

DEMOLITION NOTES:

1. THE LOCATIONS OF UNDERGROUND UTILITIES ARE APPROXIMATE AND THE LOCATIONS ARE NOT GUARANTEED BY THE OWNER OR THE ENGINEER. IT IS THE CONTRACTOR'S RESPONSIBILITY TO LOCATE ALL UTILITIES, ANTICIPATE CONFLICTS, REPAIR EXISTING UTILITIES AND RELOCATE EXISTING UTILITIES REQUIRED TO COMPLETE THE WORK.
2. THE CONTRACTOR SHALL VERIFY LOCATION OF ALL EXISTING UTILITIES. CALL DIG SAFE AT LEAST 72 HOURS PRIOR TO THE COMMENCEMENT OF ANY DEMOLITION/CONSTRUCTION ACTIVITIES.
3. ALL MATERIALS SCHEDULED TO BE REMOVED SHALL BECOME THE PROPERTY OF THE CONTRACTOR UNLESS OTHERWISE SPECIFIED. THE CONTRACTOR SHALL DISPOSE OF ALL MATERIALS OFF-SITE IN ACCORDANCE WITH ALL FEDERAL, STATE, AND LOCAL REGULATIONS, ORDINANCES AND CODES EXCEPT AS SPECIFIED IN NOTE #25.
4. COORDINATE REMOVAL, RELOCATION, DISPOSAL OR SALVAGE OF UTILITIES WITH THE OWNER AND APPROPRIATE UTILITY COMPANY.
5. ANY EXISTING WORK OR PROPERTY DAMAGED OR DISRUPTED BY CONSTRUCTION/ DEMOLITION ACTIVITIES SHALL BE REPLACED OR REPAIRED TO MATCH ORIGINAL EXISTING CONDITIONS BY THE CONTRACTOR AT NO ADDITIONAL COST TO THE OWNER.
6. SAW CUT AND REMOVE PAVEMENT ONE (1) FOOT OFF PROPOSED EDGE OF PAVEMENT OR EXISTING CURB LINE IN ALL AREAS WHERE PAVEMENT TO BE REMOVED ABUTS EXISTING PAVEMENT OR CONCRETE TO REMAIN.
7. IT IS THE CONTRACTOR'S RESPONSIBILITY TO FAMILIARIZE THEMSELVES WITH THE CONDITIONS OF ALL OF THE PERMIT APPROVALS.
8. THE CONTRACTOR SHALL OBTAIN AND PAY FOR ADDITIONAL PERMITS, NOTICES AND FEES NECESSARY TO COMPLETE THE WORK AND ARRANGE FOR AND PAY FOR NECESSARY INSPECTIONS AND APPROVALS FROM THE AUTHORITIES HAVING JURISDICTION.
9. THE CONTRACTOR SHALL BE RESPONSIBLE FOR ALL DEMOLITION AND OFF-SITE DISPOSAL OF MATERIALS REQUIRED TO COMPLETE THE WORK, EXCEPT FOR WORK NOTED TO BE COMPLETED BY OTHERS AND AS SPECIFIED IN NOTE #25.
10. UTILITIES SHALL BE TERMINATED AT THE MAIN LINE PER UTILITY COMPANY AND THE CITY OF PORTSMOUTH STANDARDS. THE CONTRACTOR SHALL REMOVE ALL ABANDONED UTILITIES LOCATED WITHIN THE LIMITS OF WORK.
11. CONTRACTOR SHALL VERIFY ORIGIN OF ALL DRAINS AND UTILITIES PRIOR TO REMOVAL/TERMINATION TO DETERMINE IF DRAINS OR UTILITY IS ACTIVE, AND SERVICES ANY ON OR OFF-SITE STRUCTURE TO REMAIN. THE CONTRACTOR SHALL NOTIFY ENGINEER IMMEDIATELY OF ANY SUCH UTILITY FOUND AND SHALL MAINTAIN THESE UTILITIES UNTIL PERMANENT SOLUTION IS IN PLACE.
12. PAVEMENT REMOVAL LIMITS ARE SHOWN FOR CONTRACTOR'S CONVENIENCE. ADDITIONAL PAVEMENT REMOVAL MAY BE REQUIRED DEPENDING ON THE CONTRACTOR'S OPERATION. CONTRACTOR TO VERIFY FULL LIMITS OF PAVEMENT REMOVAL PRIOR TO BID.
13. THE CONTRACTOR SHALL REMOVE AND DISPOSE OF ALL EXISTING STRUCTURES, CONCRETE PADS, UTILITIES AND PAVEMENT WITHIN THE WORK LIMITS SHOWN UNLESS SPECIFICALLY IDENTIFIED TO REMAIN. ITEMS TO BE REMOVED INCLUDE BUT ARE NOT LIMITED TO: CONCRETE, PAVEMENT, CURBS, LIGHTING, MANHOLES, CATCH BASINS, UNDER GROUND PIPING, POLES, STAIRS, SIGNS, FENCES, RAMPS, WALLS, BOLLARDS, BUILDING SLABS, FOUNDATION, TREES AND LANDSCAPING.
14. COORDINATE ALL WORK WITHIN THE PUBLIC RIGHT OF WAYS WITH THE CITY OF PORTSMOUTH AND PEASE DEVELOPMENT AUTHORITY.
15. REMOVE TREES AND BRUSH AS REQUIRED FOR COMPLETION OF WORK. CONTRACTOR SHALL GRUB AND REMOVE ALL STUMPS WITHIN LIMITS OF WORK AND DISPOSE OF OFF SITE IN ACCORDANCE WITH FEDERAL, STATE, AND LOCAL LAWS AND REGULATIONS.
16. CONTRACTOR SHALL PROTECT ALL PROPERTY MONUMENTATION THROUGHOUT DEMOLITION AND CONSTRUCTION OPERATIONS. SHOULD ANY MONUMENTATION BE DISTURBED BY THE CONTRACTOR, THE CONTRACTOR SHALL EMPLOY A NEW HAMPSHIRE LICENSED SURVEYOR TO REPLACE DISTURBED MONUMENTS.
17. PROVIDE INLET PROTECTION BARRIERS AT ALL CATCH BASINS/CURB INLETS WITHIN CONSTRUCTION LIMITS AS WELL AS CATCH BASINS/CURB INLETS THAT MAY RECEIVE RUNOFF FROM CONSTRUCTION ACTIVITIES. INLET PROTECTION BARRIERS SHALL BE MAINTAINED FOR THE DURATION OF THE PROJECT. INLET PROTECTION BARRIERS SHALL BE "HIGH FLOW SILT SACK" BY ACF ENVIRONMENTAL OR EQUAL. INSPECT BARRIERS WEEKLY AND AFTER EACH RAIN EVENT OF 0.25 INCHES OR GREATER. CONTRACTOR SHALL COMPLETE A MAINTENANCE INSPECTION REPORT AFTER EACH INSPECTION. SEDIMENT DEPOSITS SHALL BE REMOVED AFTER EACH STORM EVENT OR MORE OFTEN IF THE FABRIC BECOMES CLOGGED OR SEDIMENT HAS ACCUMULATED TO 1/3 THE DESIGN DEPTH OF THE BARRIER.
18. THE CONTRACTOR SHALL PHASE DEMOLITION AND CONSTRUCTION AS REQUIRED TO PROVIDE CONTINUOUS SERVICE TO EXISTING BUSINESSES THROUGHOUT THE CONSTRUCTION PERIOD. EXISTING BUSINESS SERVICES INCLUDE, BUT ARE NOT LIMITED TO ELECTRICAL, COMMUNICATION, FIRE PROTECTION, DOMESTIC WATER AND SEWER SERVICES. TEMPORARY SERVICES, IF REQUIRED, SHALL COMPLY WITH ALL FEDERAL, STATE, LOCAL AND UTILITY COMPANY STANDARDS. CONTRACTOR SHALL PROVIDE DETAILED CONSTRUCTION SCHEDULE TO OWNER PRIOR TO ANY DEMOLITION/CONSTRUCTION ACTIVITIES.
19. EROSION CONTROL MEASURES SHALL BE INSTALLED PRIOR TO THE START OF ANY CLEARING OR DEMOLITION ACTIVITIES.
20. THE CONTRACTOR SHALL PAY ALL COSTS NECESSARY FOR TEMPORARY PARTITIONING, BARRICADING, FENCING, SECURITY AND SAFETY DEVICES REQUIRED FOR THE MAINTENANCE OF A CLEAN AND SAFE CONSTRUCTION SITE.
21. SAW CUT AND REMOVE PAVEMENT AND CONSTRUCT PAVEMENT TRENCH PATCH FOR ALL UTILITIES TO BE REMOVED AND PROPOSED UTILITIES LOCATED IN EXISTING PAVEMENT AREAS TO REMAIN.
22. THE CONTRACTOR SHALL ACQUIRE A PDA DIG PERMIT BEFORE ANY EARTH DISTURBANCE CAN TAKE PLACE. ALLOW 7 CALENDAR DAYS FOR PROCESSING.
23. ALL MONITORING WELLS WITHIN LIMIT OF WORK SHALL BE PROTECTED DURING CONSTRUCTION. IF ANY MONITORING WELL NEEDS TO BE REMOVED OR ADJUSTED THIS WORK SHALL BE COORDINATED WITH THE PEASE DEVELOPMENT AUTHORITY.
24. CONTRACTOR SHALL COORDINATE WITH THE PROJECT SURVEYOR FOR BENCHMARK AND CONTROL POINTS PRIOR TO CONSTRUCTION.
25. ALL EXCESS SOIL RESULTING FROM THE CONSTRUCTION SHALL REMAIN ON SITE. COORDINATE WITH OWNER AND PEASE DEVELOPMENT AUTHORITY ON FINAL LOCATION OF EXCESS MATERIALS.
26. BEFORE ANY DEWATERING IS PERFORMED, COORDINATION BETWEEN THE OWNER, CONTRACTOR, PDA, NHDES AND THE AIR FORCE IS REQUIRED TO DETERMINE PROPER PROCEDURES AND PERMITTING REQUIRED. AT A MINIMUM A NHDES TEMPORARY DISCHARGE PERMIT IS REQUIRED.

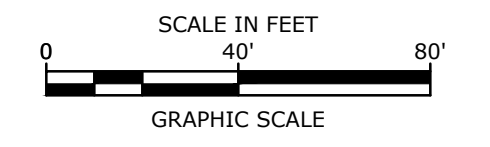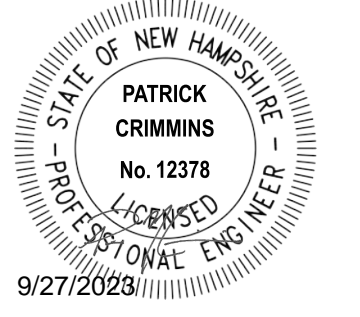

Proposed Industrial Development

Lonza Biologics

Portsmouth, New Hampshire

MARK	DATE	DESCRIPTION
M	9/27/2023	P.B. Submission
L	7/17/2023	Amended Site Plan Review
K	5/5/2023	Phase 1B Issued for Bid
J	3/15/2023	Phase 1B Issued for Preliminary Pricing
I	1/9/2023	Admin. Approval Submission
H	12/10/2021	Planning Board Stipulation
G	8/19/2019	Admin. Approval Submission
F	11/6/2018	P.B. Submission


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DATE:	04/03/2018
FILE:	L-0700-026-C-DSGN.dwg
DRAWN BY:	CJK
CHECKED:	NAH
APPROVED:	PMC






DEMOLITION PLAN

SCALE: AS SHOWN

C-101

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Proposed Industrial Development

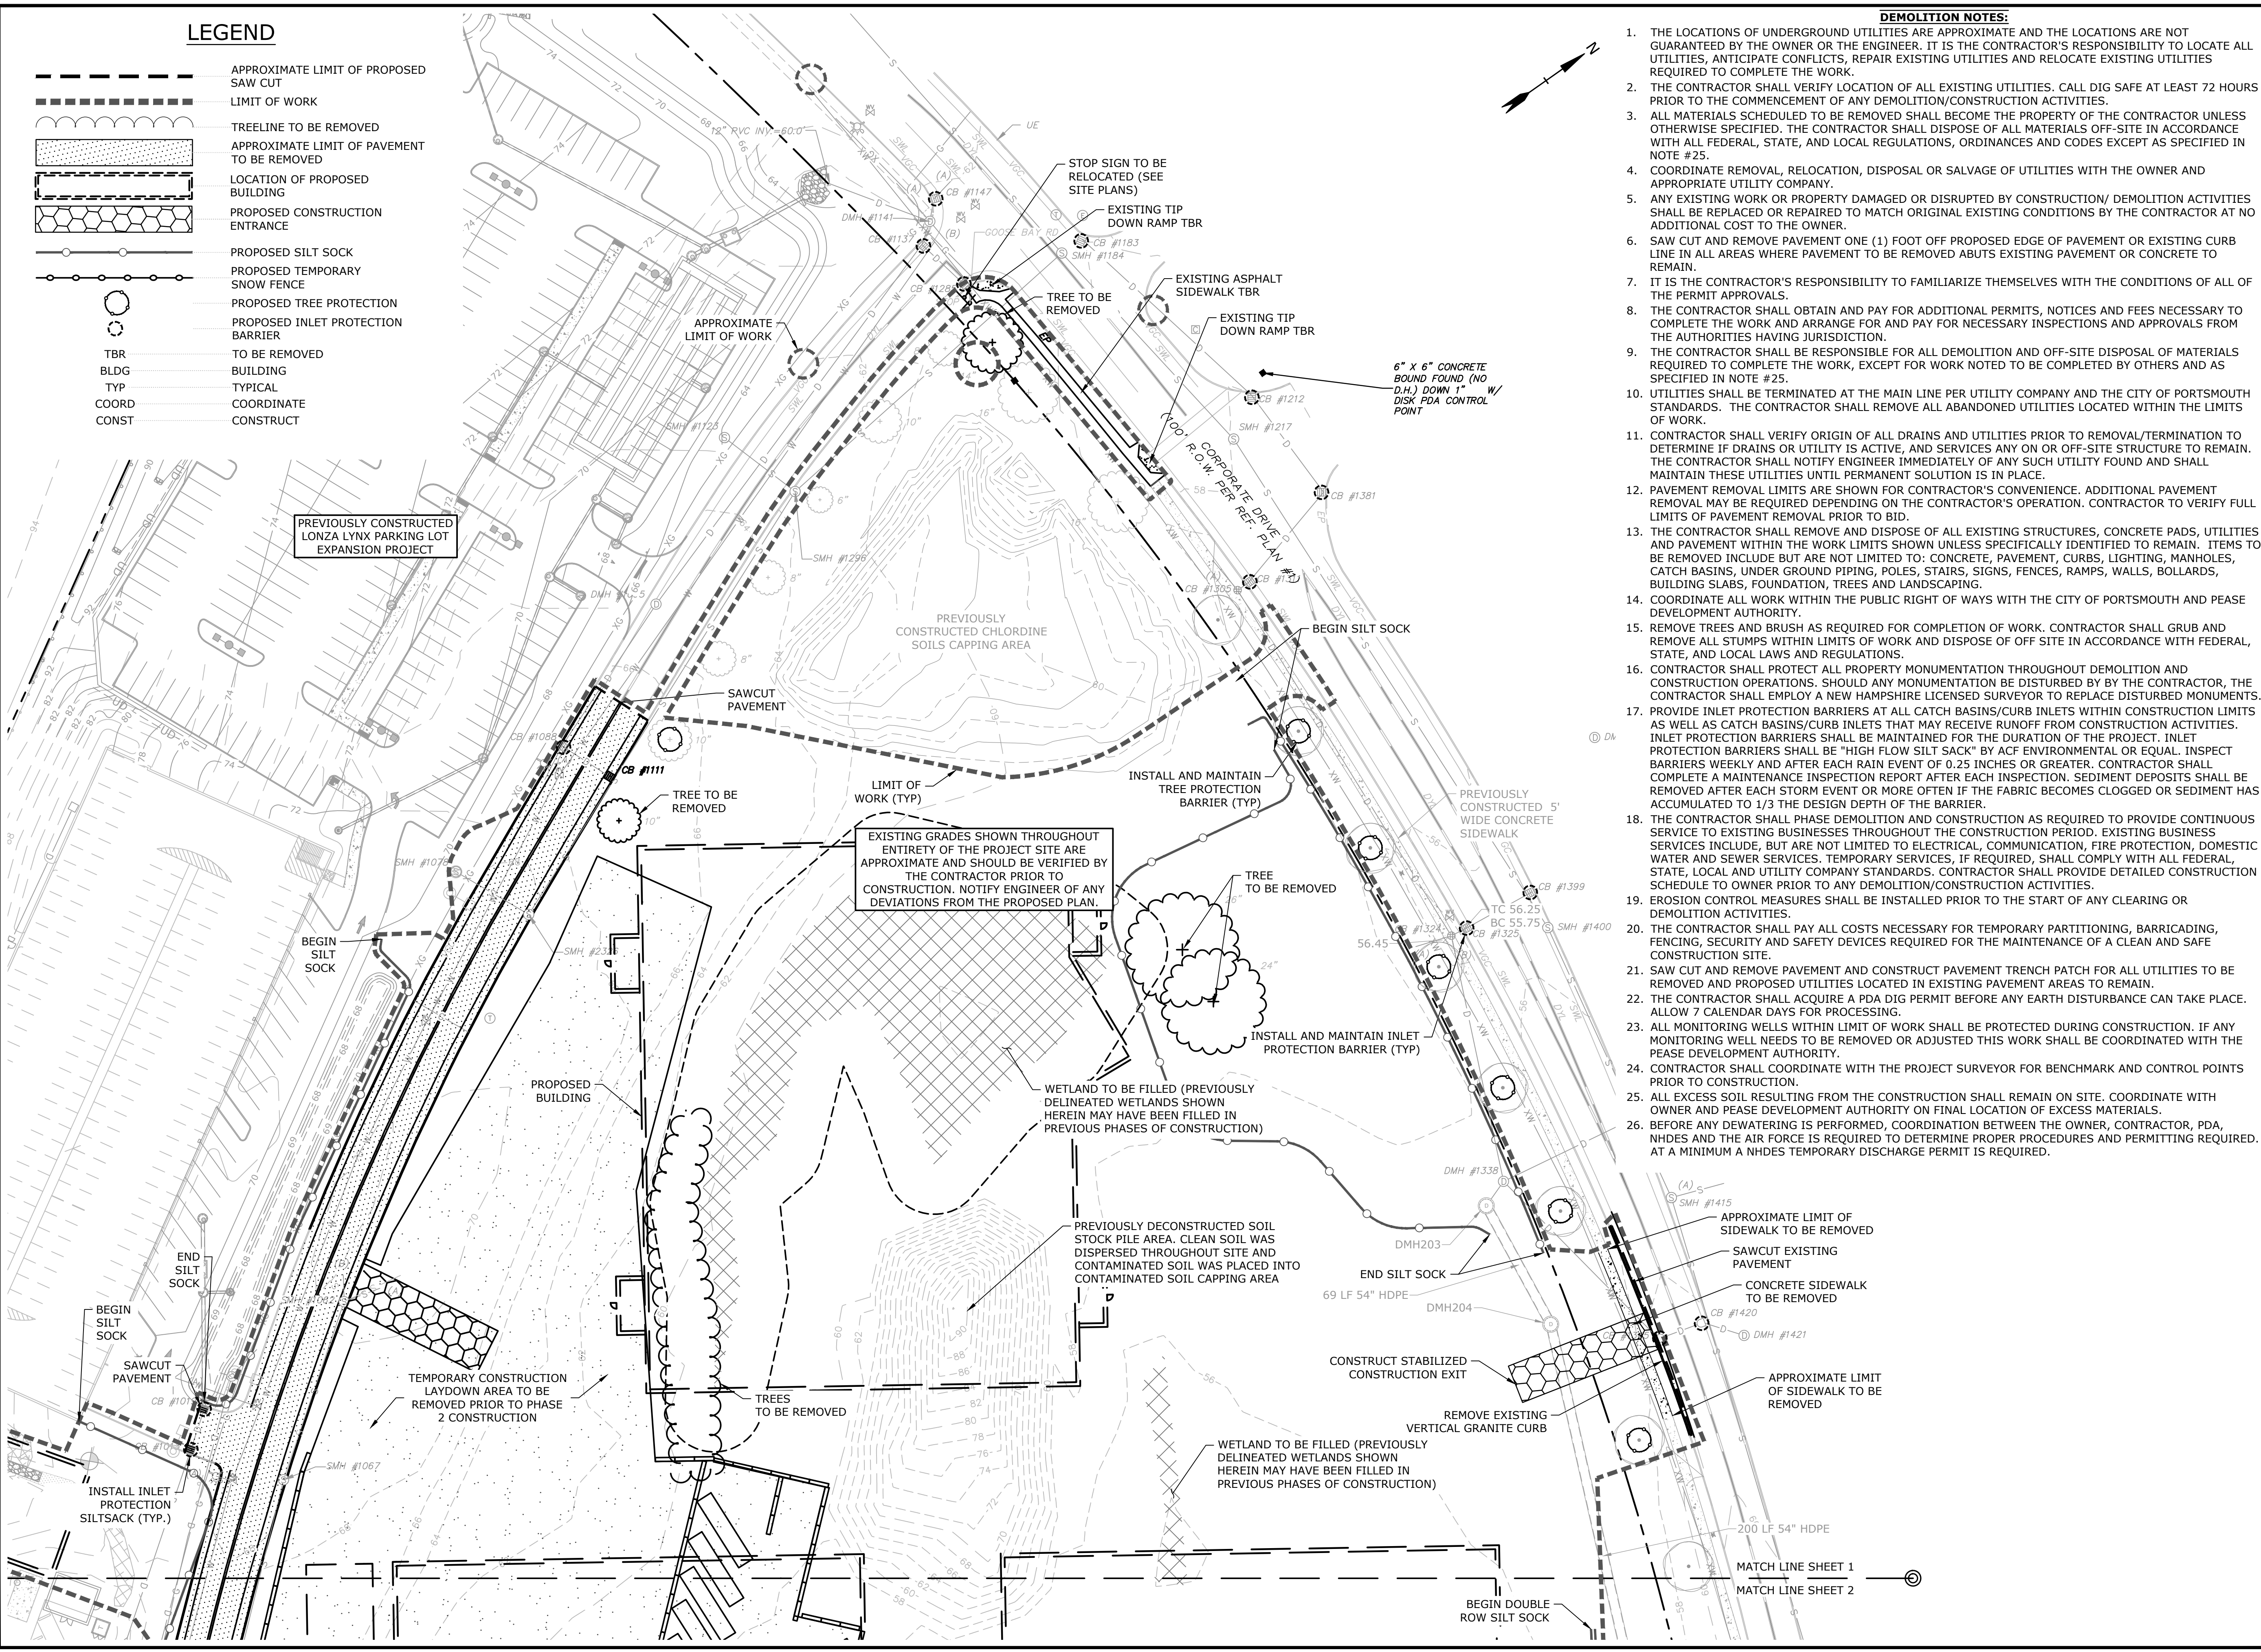Lonza Biologics

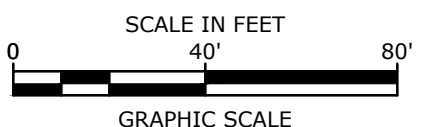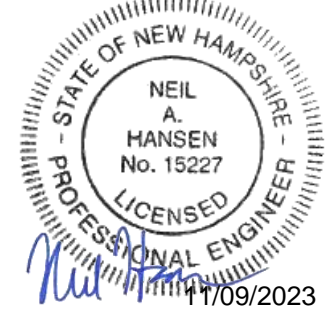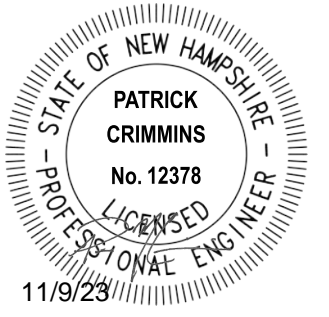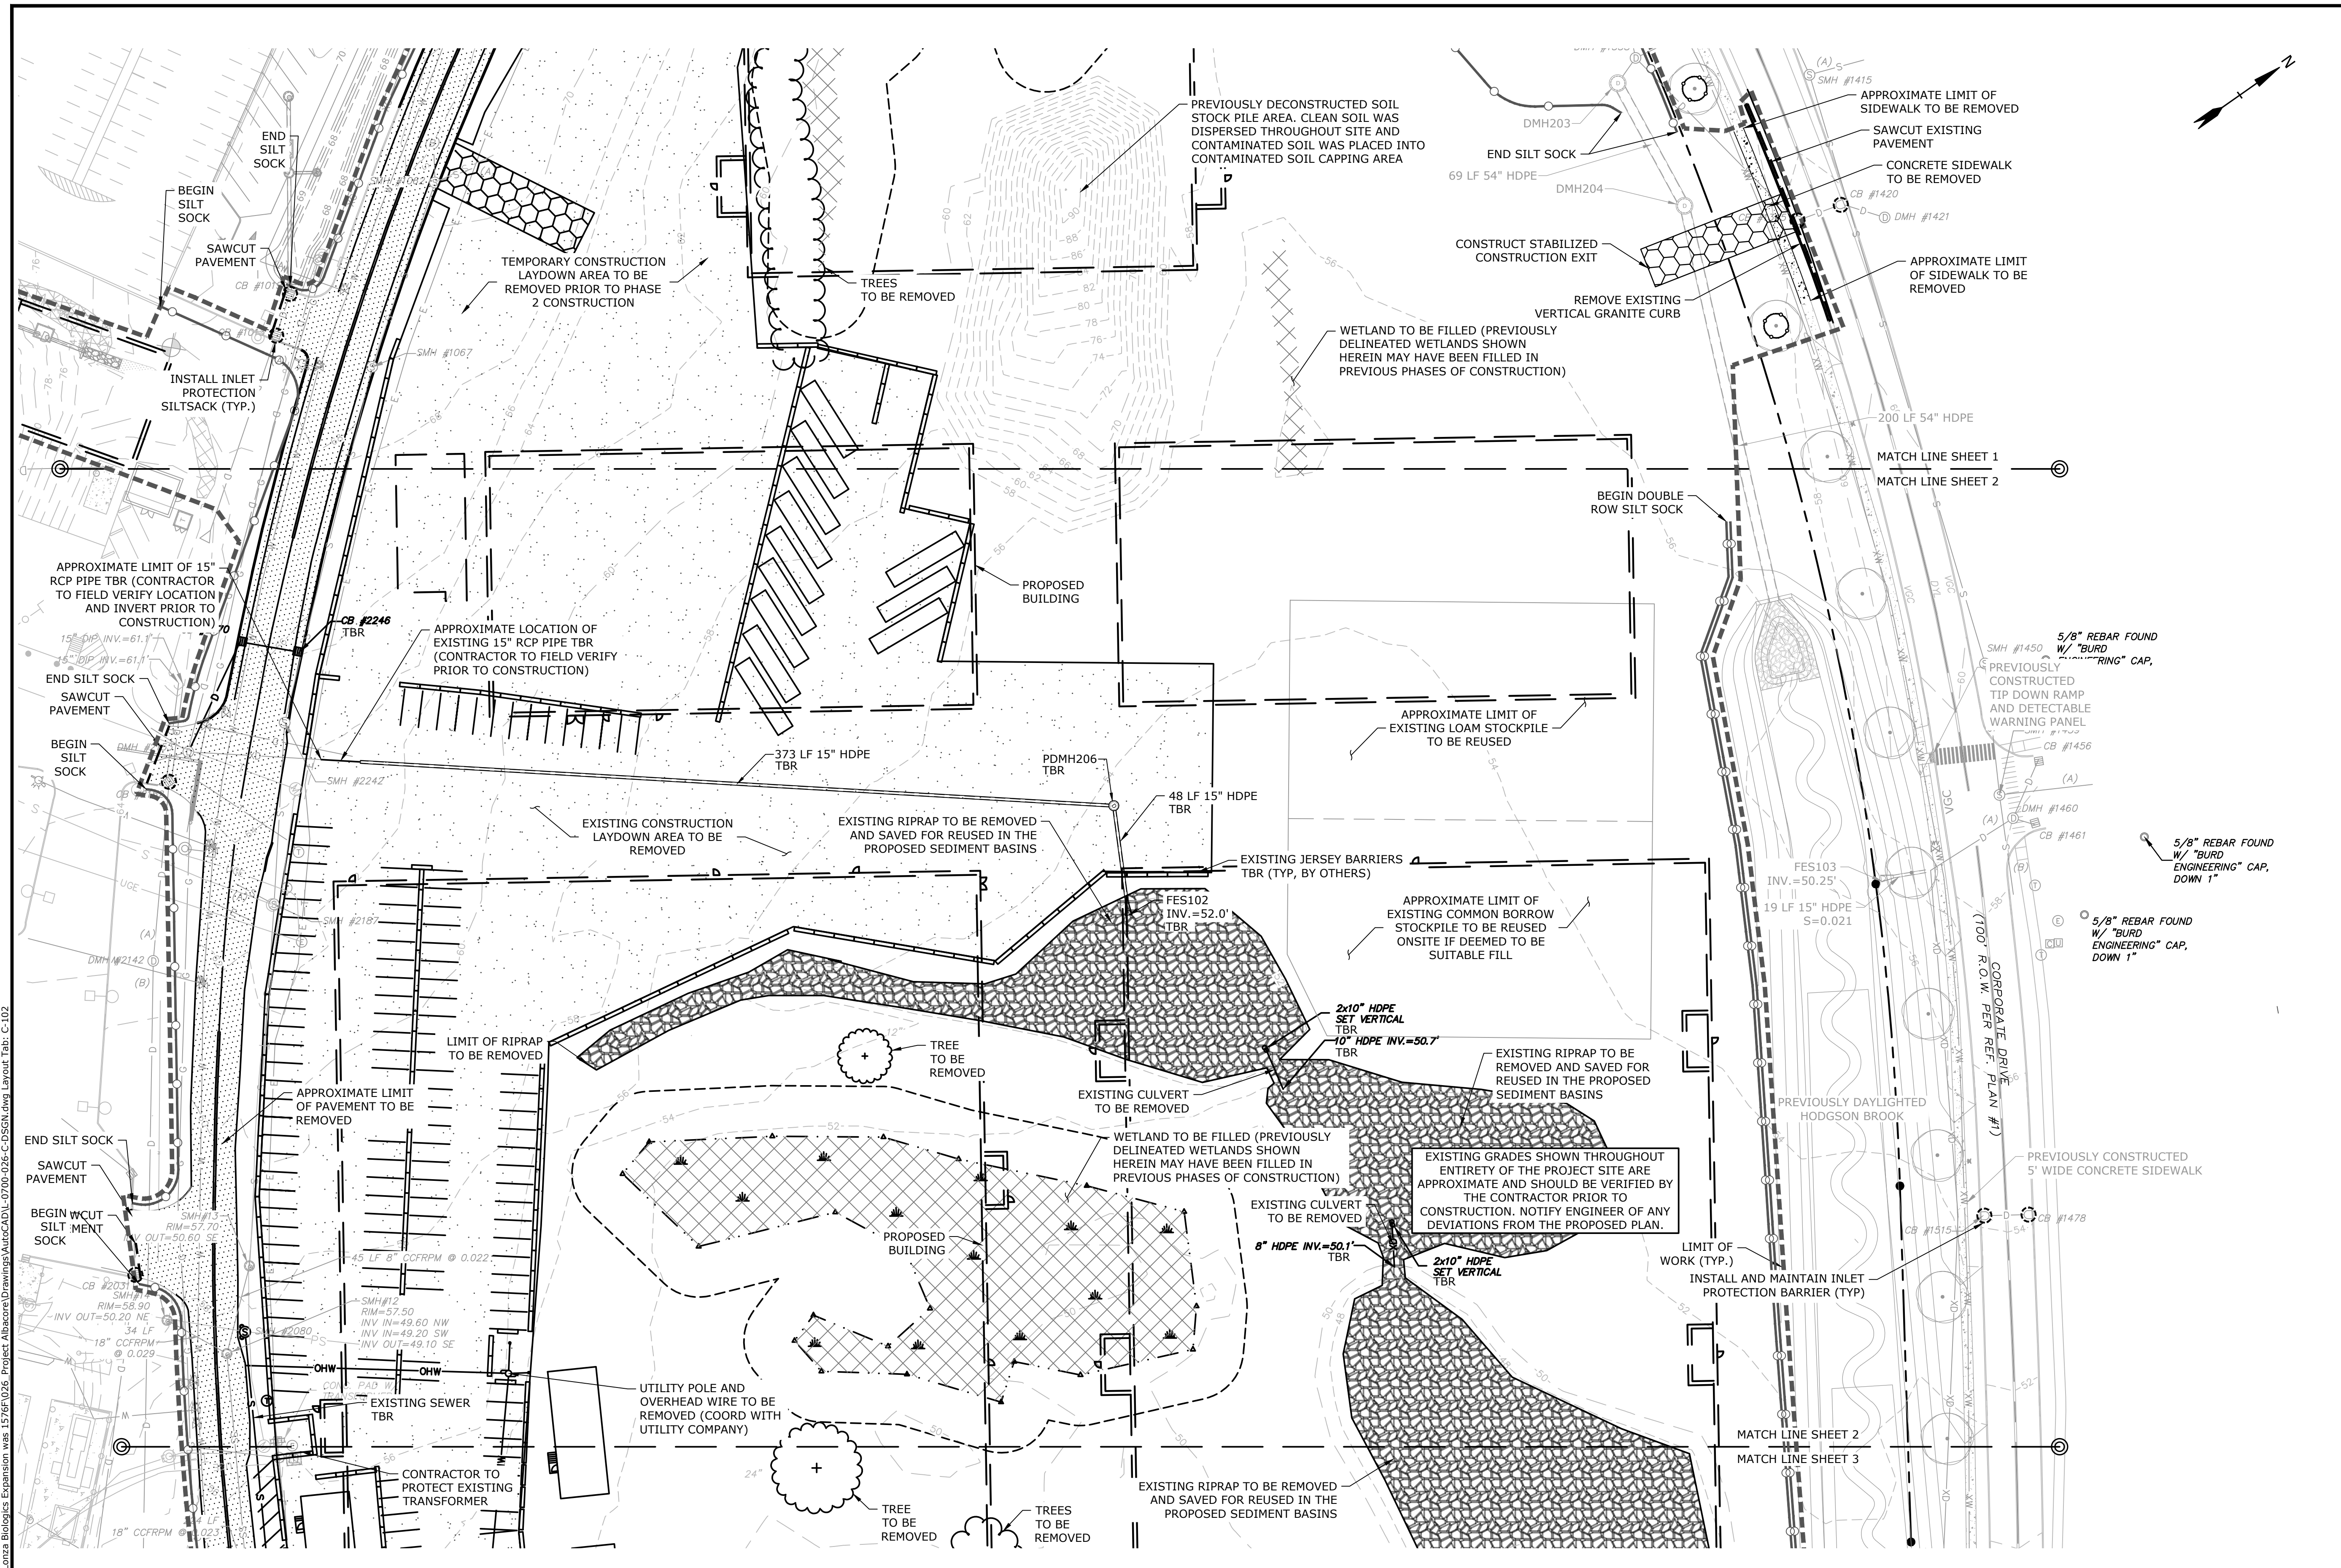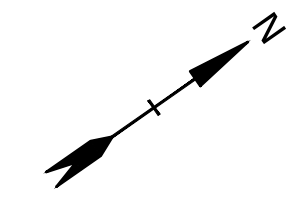Portsmouth, New Hampshire

MARK	DATE	DESCRIPTION
N	11/9/2023	Revised P.B. Submission
M	9/27/2023	P.B. Submission
L	9/1/2022	Issued for Construction
K	5/27/2022	Issued for Bid
J	5/23/2022	Third Party Rev. Comments
I	4/26/2022	Revised PB Stipulations

PROJECT NO:	L-0700-013
DATE:	04/03/2018
FILE:	L-0700-026-C-DSGN.dwg
DRAWN BY:	CJK
CHECKED:	NAH
APPROVED:	PMC



SEE SHEET C-101 FOR LEGEND AND DEMOLITION NOTES

DEMOLITION PLAN




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C-102

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Proposed Industrial Development

Lonza Biologics

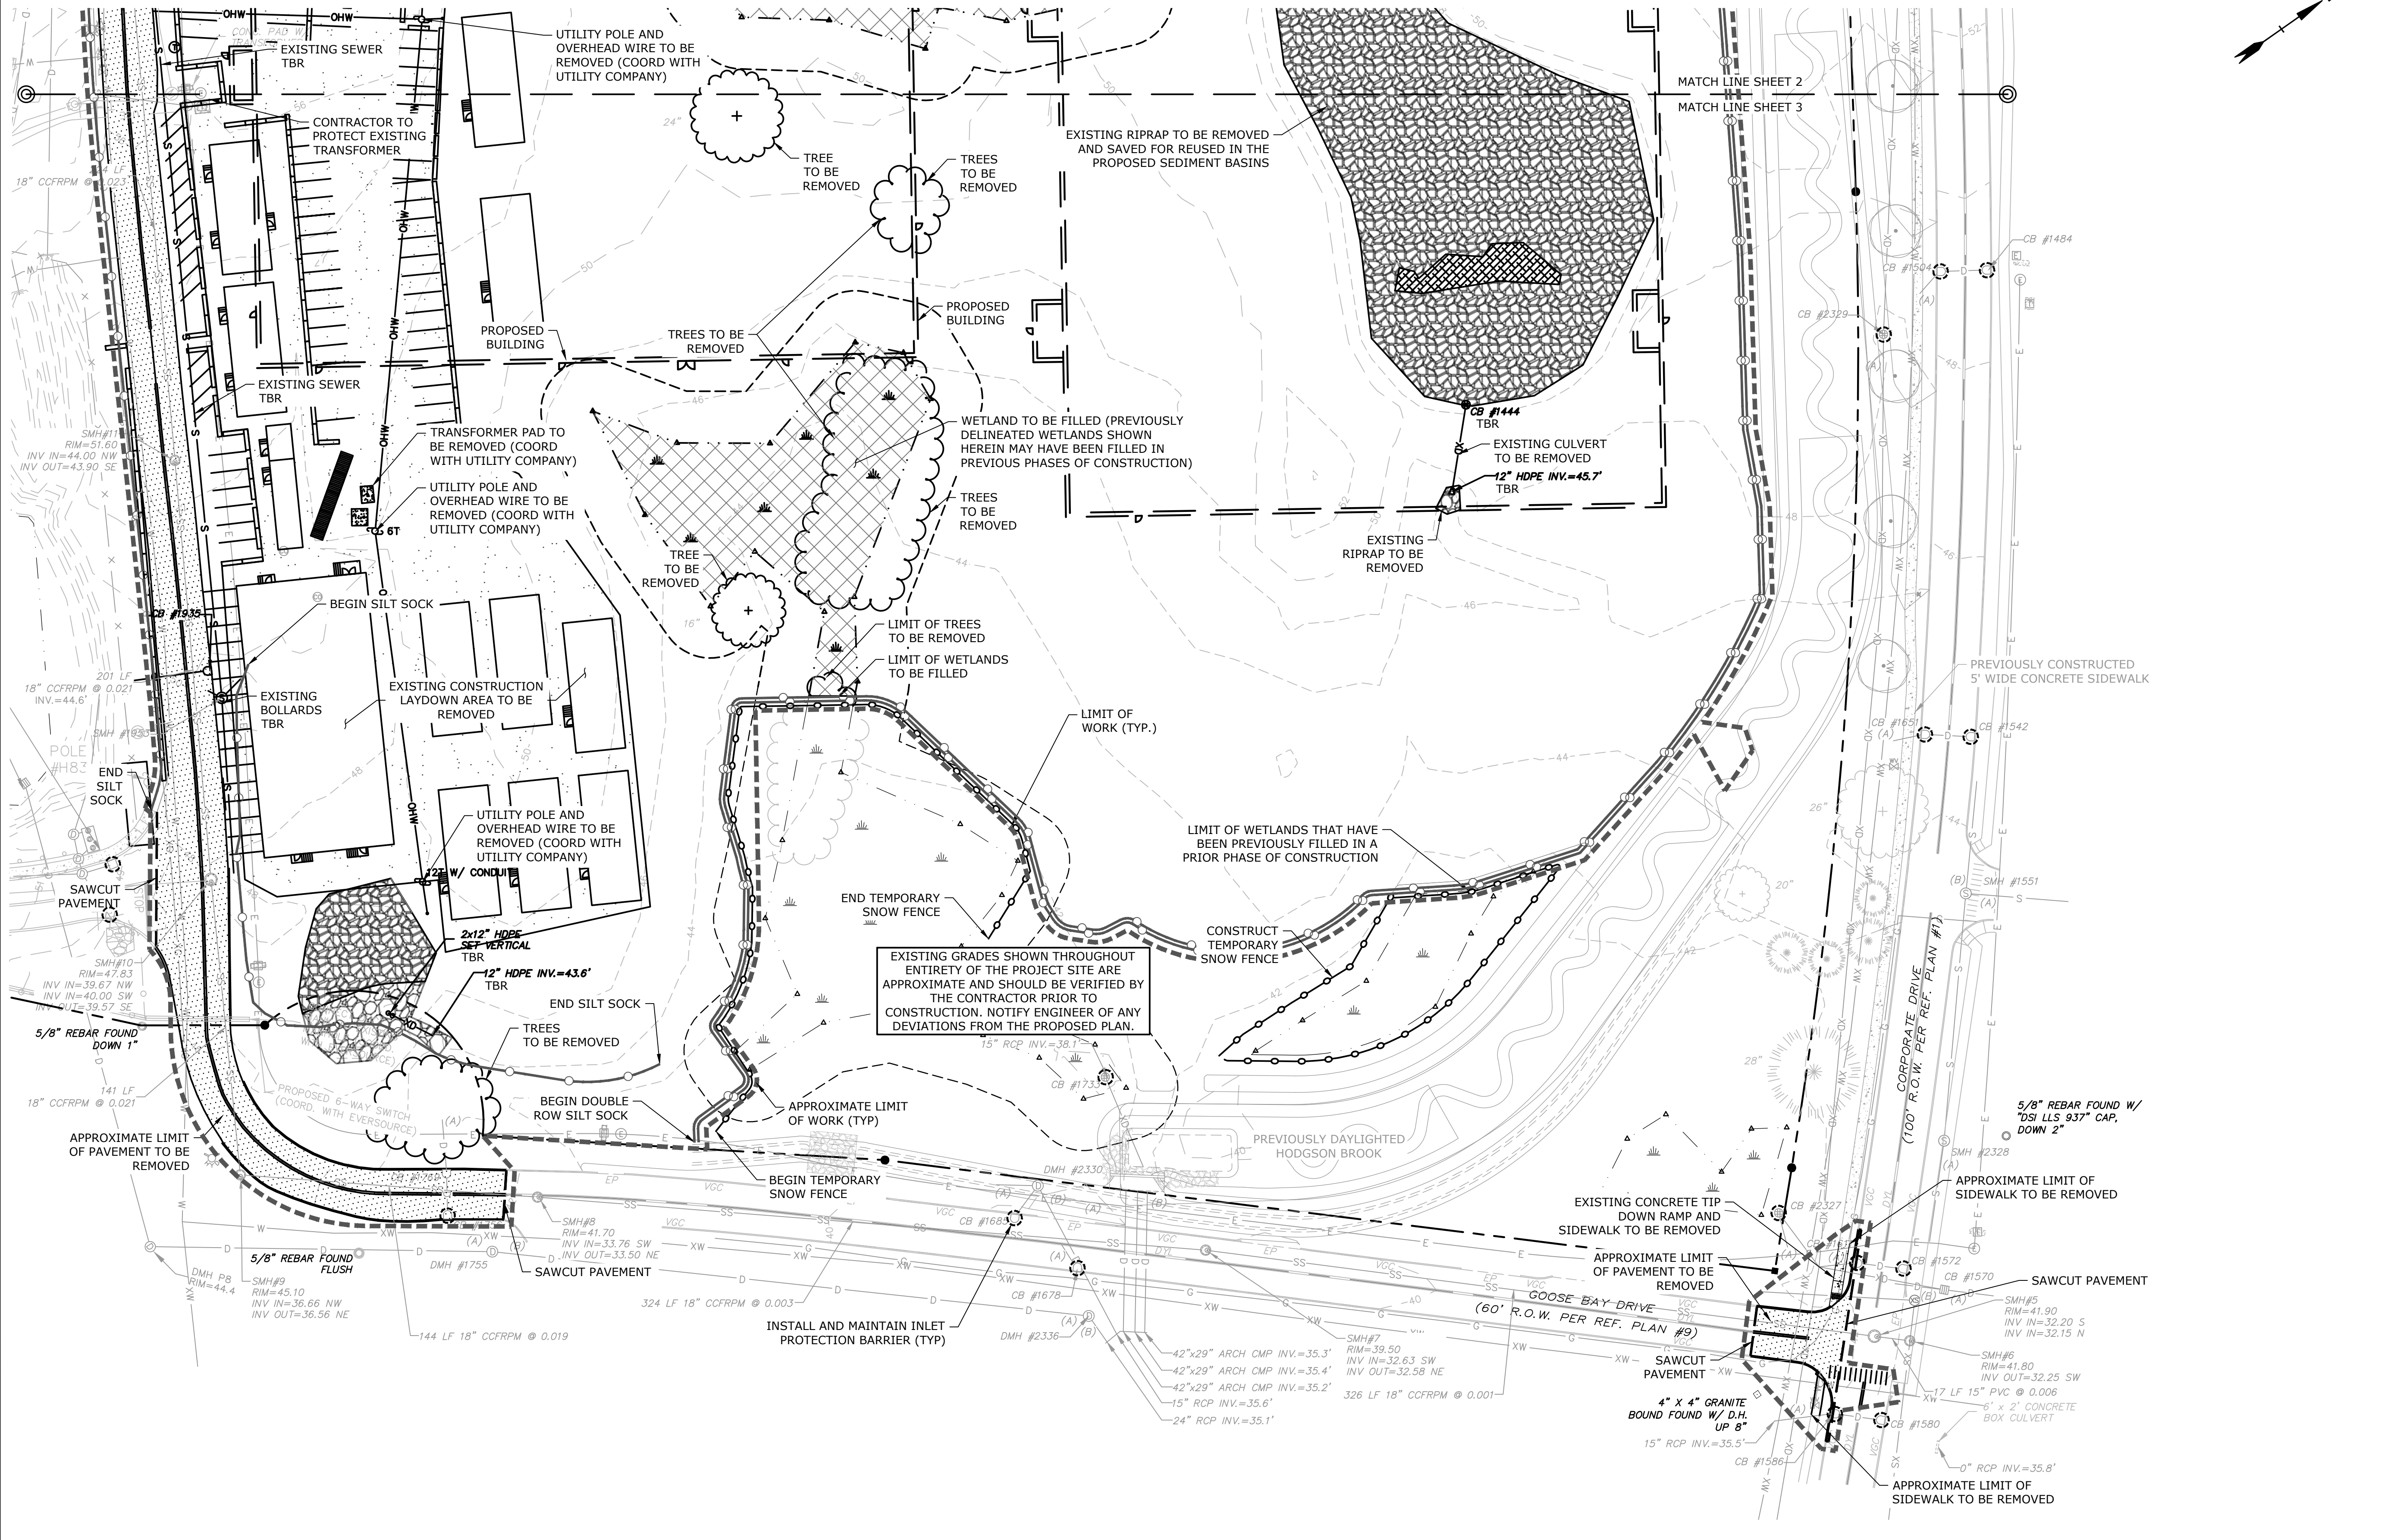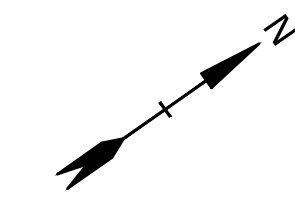Portsmouth, New Hampshire


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M	9/27/2023	P.B. Submission
L	9/1/2022	Issued for Construction
K	5/27/2022	Issued for Bid
J	5/23/2022	Third Party Rev. Comments
I	4/26/2022	Revised PB Stipulations
MARK	DATE	DESCRIPTION

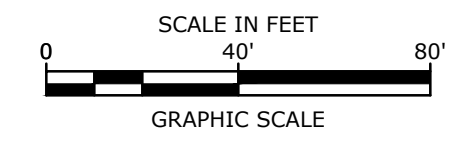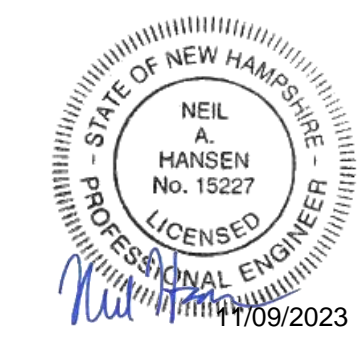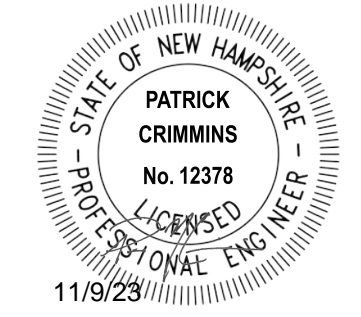PROJECT NO:	L-0700-013
DATE:	04/03/2018
FILE:	L-0700-026-C-DSGN.dwg
DRAWN BY:	CHK
CHECKED:	NAH
APPROVED:	PMC

SEE SHEET C-101 FOR LEGEND AND DEMOLITION NOTES

DEMOLITION PLAN

SCALE: AS SHOWN

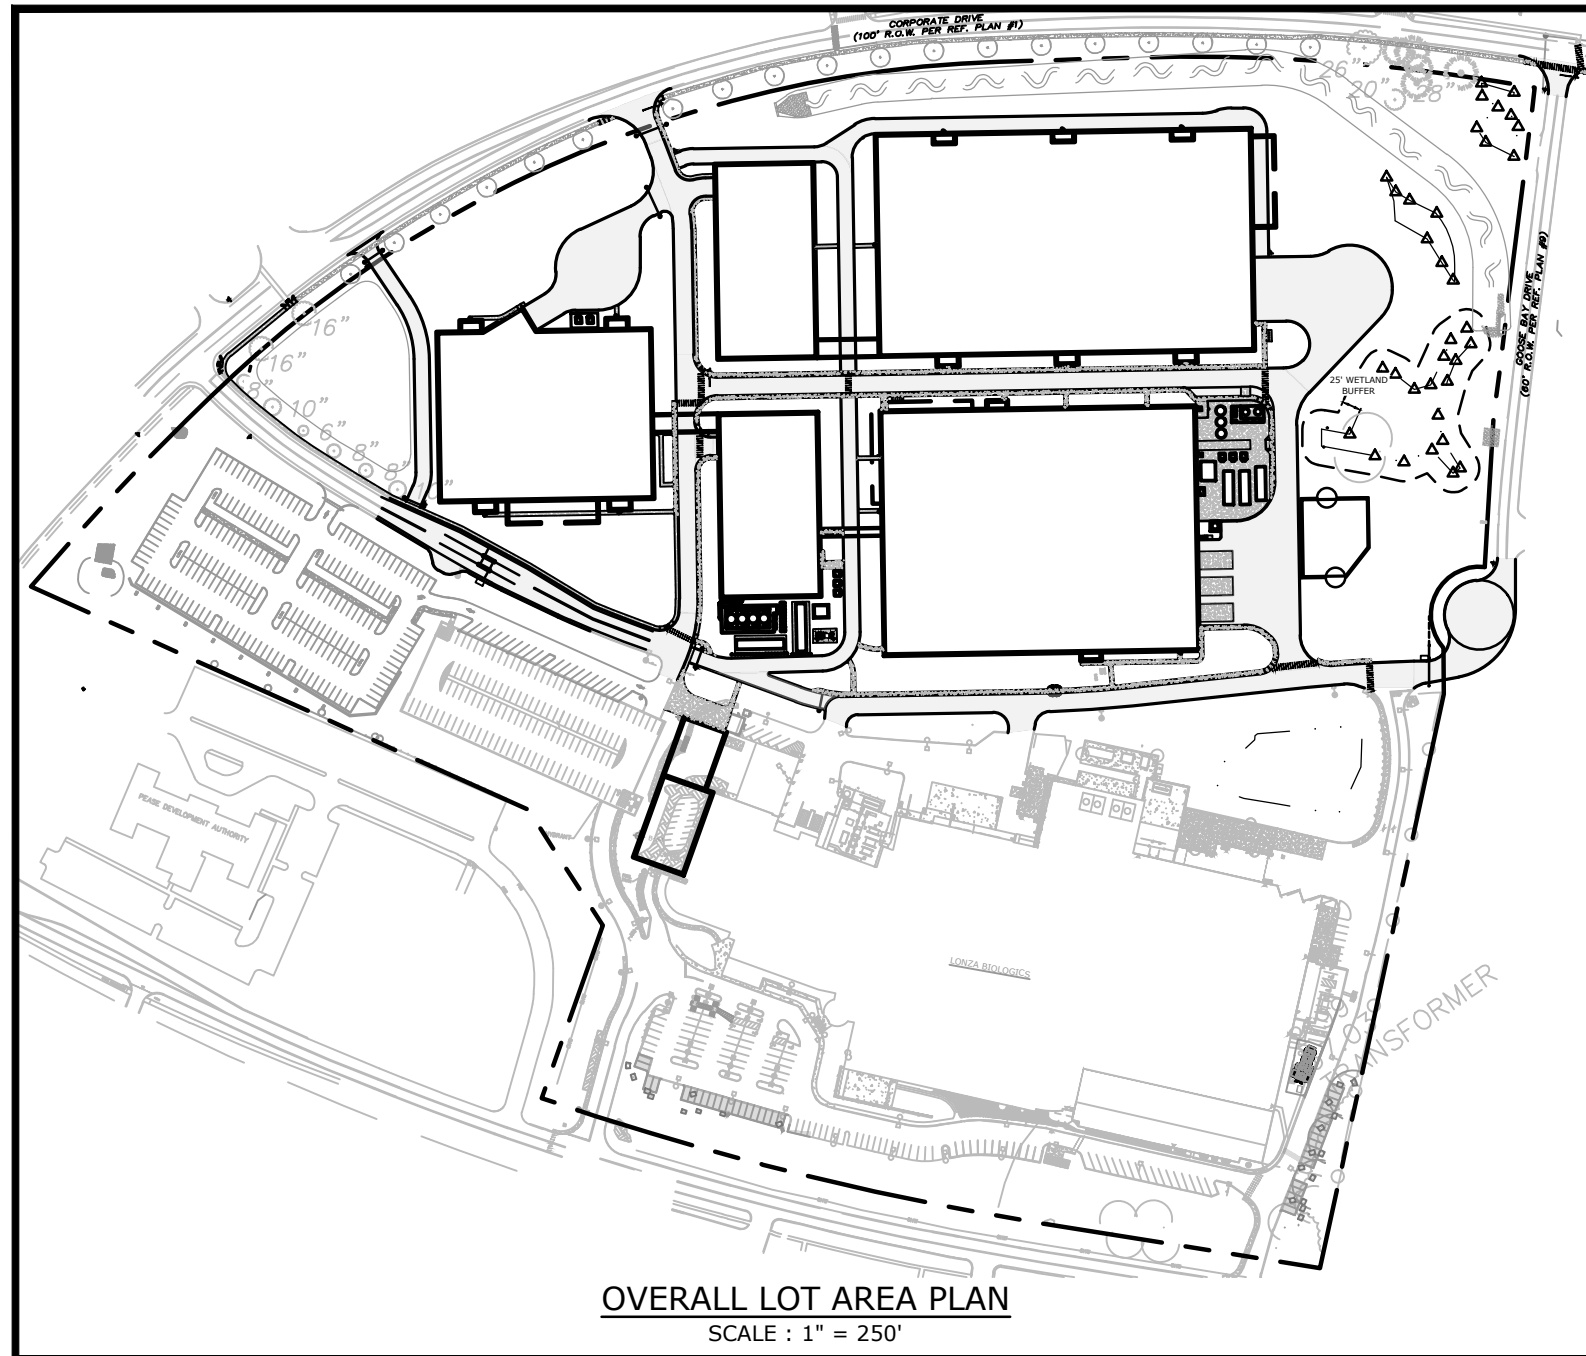

OVERALL LOT AREA PLAN
SCALE: 1" = 250'

SITE DATA
 LOCATION: TAX MAP 305, LOTS 1 & 2
 70 & 80 CORPORATE DRIVE
 PORTSMOUTH, NH
 TAX MAP 305, LOT 6
 101 INTERNATIONAL DRIVE
 PORTSMOUTH, NH
 ZONING DISTRICT: AIRPORT, BUSINESS & COMMERCIAL (ABC)
DIMENSIONAL REQUIREMENTS:






MINIMUM LOT AREA:	REQUIRED 5 AC	PROVIDED 43.4± AC
MINIMUM STREET FRONTAGE:	200 FT	1,038 FT
MINIMUM FRONT YARD SETBACK:	70 FT	70 FT
SIDE SETBACK:	30 FT	30 FT
REAR SETBACK:	50 FT	51 FT
MINIMUM OPEN SPACE:	25 %	43.3± %

MAXIMUM STRUCTURE HEIGHT SHALL NOT EXCEED FAA CRITERIA.

PARKING REQUIREMENTS:

REQUIRED PARKING
 2 SPACES PER 3 EMPLOYEES ON LARGEST SHIFT
 990 EXISTING EMPLOYEES 660 SPACES
 1000 ANTICIPATED EMPLOYEES 666 SPACES
 TOTAL REQUIRED: 1,326 SPACES

PARKING PROVIDED
 EXISTING SPACES: 801 SPACES
 PROPOSED PARKING GARAGE #1: 700 SPACES
 TOTAL: 1,501 SPACES

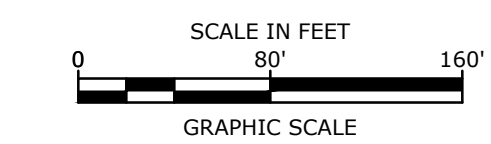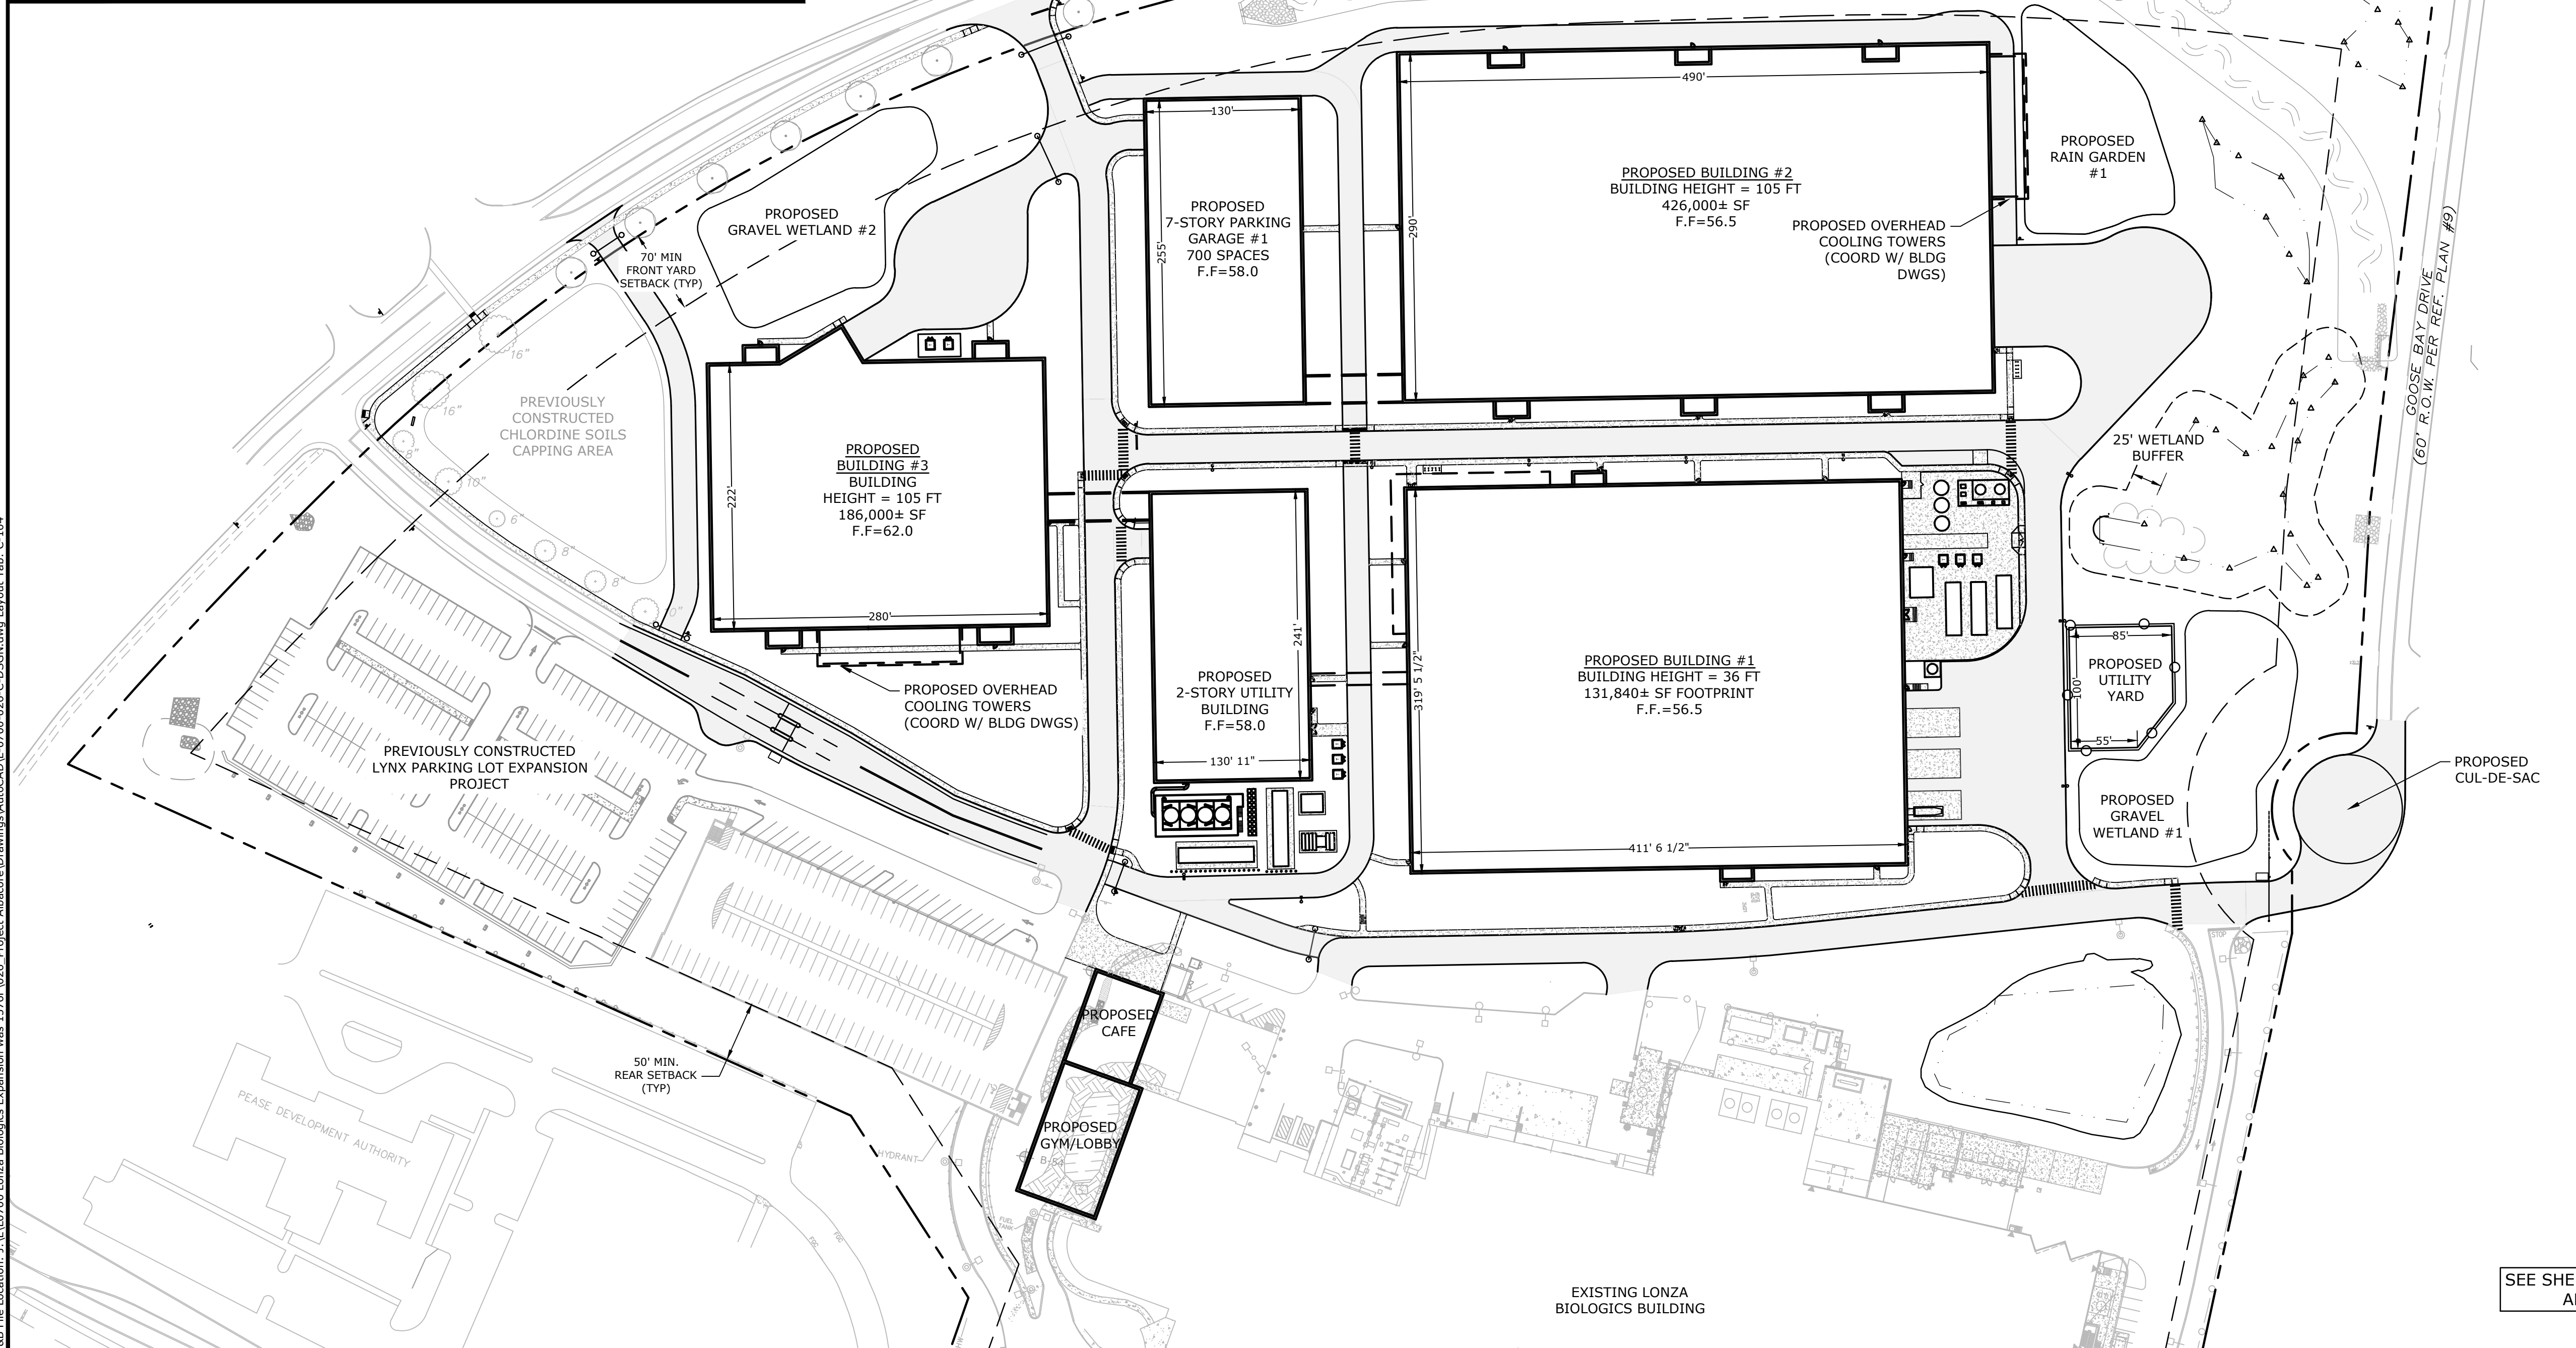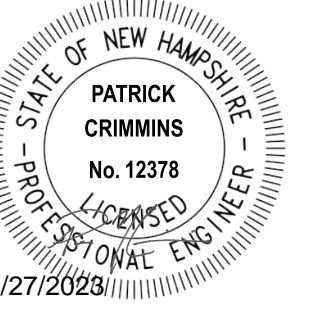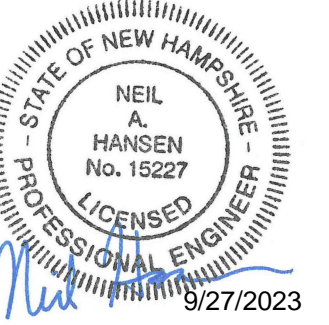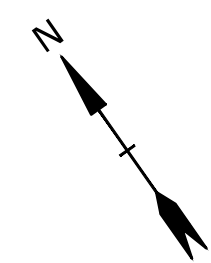

Proposed Industrial Development

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PROJECT NO:	L-0700-013
DATE:	04/03/2018
FILE:	L-0700-026-C-DSGN.dwg
DRAWN BY:	CJK
CHECKED BY:	NAH
APPROVED BY:	PMC

MASTER SITE PLAN

SCALE: AS SHOWN

SEE SHEET C-105 FOR LEGEND AND SITE NOTES





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SITE NOTES:

1. STRIPE PARKING AREAS AS SHOWN, INCLUDING PARKING SPACES, STOP BARS, ADA SYMBOLS, PAINTED ISLANDS, CROSS WALKS, ARROWS, LEGENDS AND CENTERLINES (ALL MARKINGS EXCEPT CENTERLINE AND MEDIAN ISLANDS TO BE CONSTRUCTED USING WHITE TRAFFIC PAINT. CENTERLINE AND MEDIAN ISLANDS TO BE CONSTRUCTED USING YELLOW TRAFFIC PAINT. ALL TRAFFIC PAINT SHALL MEET THE REQUIREMENTS OF AASHTO M248 TYPE "F").
2. ALL PAVEMENT MARKINGS AND SIGNS TO CONFORM TO "MANUAL ON UNIFORM TRAFFIC CONTROL DEVICES", "STANDARD ALPHABETS FOR HIGHWAY SIGNS AND PAVEMENT MARKINGS", AND THE AMERICANS WITH DISABILITIES ACT REQUIREMENTS, LATEST EDITIONS.
3. SEE DETAILS FOR PARKING STALL MARKINGS, ADA SYMBOLS, SIGNS AND SIGN POSTS.
4. CENTERLINES SHALL BE FOUR (4) INCH WIDE YELLOW LINES. STOP BARS SHALL BE EIGHTEEN (18) INCHES WIDE.
5. PAINTED ISLANDS SHALL BE FOUR (4) INCH WIDE DIAGONAL LINES AT 3'-0" O.C. BORDERED BY FOUR (4) INCH WIDE LINES.
6. THE CONTRACTOR SHALL EMPLOY A NEW HAMPSHIRE LICENSED SURVEYOR TO DETERMINE ALL LINES AND GRADES.
7. CLEAN AND COAT VERTICAL FACE OF EXISTING PAVEMENT AT SAWCUT LINE WITH RS-1 EMULSION IMMEDIATELY PRIOR TO PLACING NEW BITUMINOUS CONCRETE.
8. ALL MATERIALS AND CONSTRUCTION SHALL CONFORM WITH APPLICABLE FEDERAL, STATE AND/OR TOWN CODES & SPECIFICATIONS.
9. COORDINATE ALL WORK WITHIN PUBLIC RIGHT OF WAY WITH THE CITY OF PORTSMOUTH AND PEASE DEVELOPMENT AUTHORITY.
10. CONTRACTOR TO SUBMIT AS-BUILT PLANS IN DIGITAL FORMAT (.DWG AND .PDF FILES) ON DISK TO THE OWNER AND ENGINEER UPON COMPLETION OF THE PROJECT. AS-BUILTS SHALL BE PREPARED AND CERTIFIED BY A NEW HAMPSHIRE LICENSED LAND SURVEYOR.
11. CONTRACTOR SHALL COORDINATE WITH THE BUILDING DRAWINGS FOR ALL CONCRETE PADS & SIDEWALKS ADJACENT TO BUILDING.
12. ALL WORK SHALL CONFORM TO THE CITY OF PORTSMOUTH DEPARTMENT OF PUBLIC WORKS, STANDARD SPECIFICATIONS AND WITH THE STATE OF NEW HAMPSHIRE DEPARTMENT OF TRANSPORTATION, "STANDARD SPECIFICATIONS OF ROAD AND BRIDGE CONSTRUCTION", CURRENT EDITION.
13. CONTRACTOR TO PROVIDE BACKFILL AND COMPACTION AT CURB LINE AFTER CONCRETE FORMS FOR SIDEWALKS AND PADS HAVE BEEN STRIPPED. COORDINATE WITH BUILDING CONTRACTOR.
14. ALL LIGHT POLE BASES NOT PROTECTED BY A RAISED CURB SHALL BE PAINTED YELLOW.
15. ALL DIMENSIONS ARE TO THE FACE OF CURB UNLESS OTHERWISE NOTED.
16. UPON COMPLETION OF CONSTRUCTION AND PRIOR TO ISSUANCE OF CERTIFICATE OF OCCUPANCY AND RELEASE OF BOND, THE APPLICANT SHALL SUBMIT A LETTER TO THE PDA, SIGNED AND STAMPED BY A PROFESSIONAL ENGINEER, STATING CONSTRUCTION HAS BEEN COMPLETED IN CONFORMANCE WITH THE APPROVED PLANS.
17. FIRE LANES AND FIRE DEPARTMENT CONNECTION POINTS SHALL BE KEPT CLEAR AT ALL TIMES, INCLUDING DURING WINTER CONDITIONS.
18. FINAL NUMBER OF DOORS AND LOCATION OF DOORS TO BE APPROVED BY BUILDING AND FIRE DEPARTMENTS.
19. COORDINATE ALL WORK ADJACENT TO BUILDING WITH BUILDING CONTRACTOR.
20. SUBMISSION OF A MINIMUM OF TWO 7460-1'S TO THE FAA WILL BE REQUIRED FOR THE CONSTRUCTION OF THE BUILDING AND TEMPORARY USE OF A CRANE. ALLOW A MINIMUM OF 45 DAYS FOR PROCESSING.
21. COORDINATE FINAL CONSTRUCTION LAYDOWN PARKING LAYOUT WITH OWNER PRIOR TO CONSTRUCTION.
22. COORDINATE FINAL GATE TYPE WITH OWNER PRIOR TO CONSTRUCTION. COORDINATE GATE ELECTRICAL REQUIREMENTS WITH BUILDING DWGS AND ELECTRICAL DESIGN.
23. COORDINATE THE RECONSTRUCTION OF GOOSE BAY DRIVE AND CORPORATE DRIVE INTERSECTION WITH THE CITY OF PORTSMOUTH.
24. ALL GATES SHALL BE EQUIPPED WITH KNOX BOXES. COORDINATE WITH THE CITY OF PORTSMOUTH FIRE DEPARTMENT.

LEGEND

	MATCH LINE
	PROPOSED PROPERTY LINE
	PROPOSED SETBACK LINE
	PROPOSED LIMIT OF WORK
	PROPOSED GRANITE CURB
	PROPOSED PAVEMENT SECTION
	PROPOSED GRAVEL SECTION
	PROPOSED CONCRETE
CONST	CONSTRUCT
BLDG	BUILDING
TYP	TYPICAL
COORD	COORDINATE
30'R	PROPOSED CURB RADIUS
VGC	VERTICAL GRANITE CURB
SGC	SLOPED GRANITE CURB
ROW	RIGHT OF WAY
DSYL	DOUBLE SOLID YELLOW LINE
SSWL	SINGLE SOLID WHITE LINE

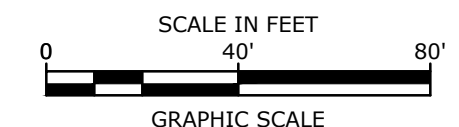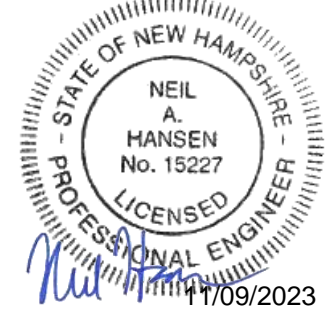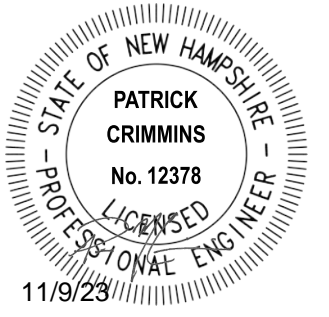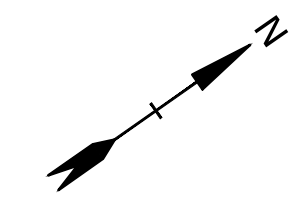

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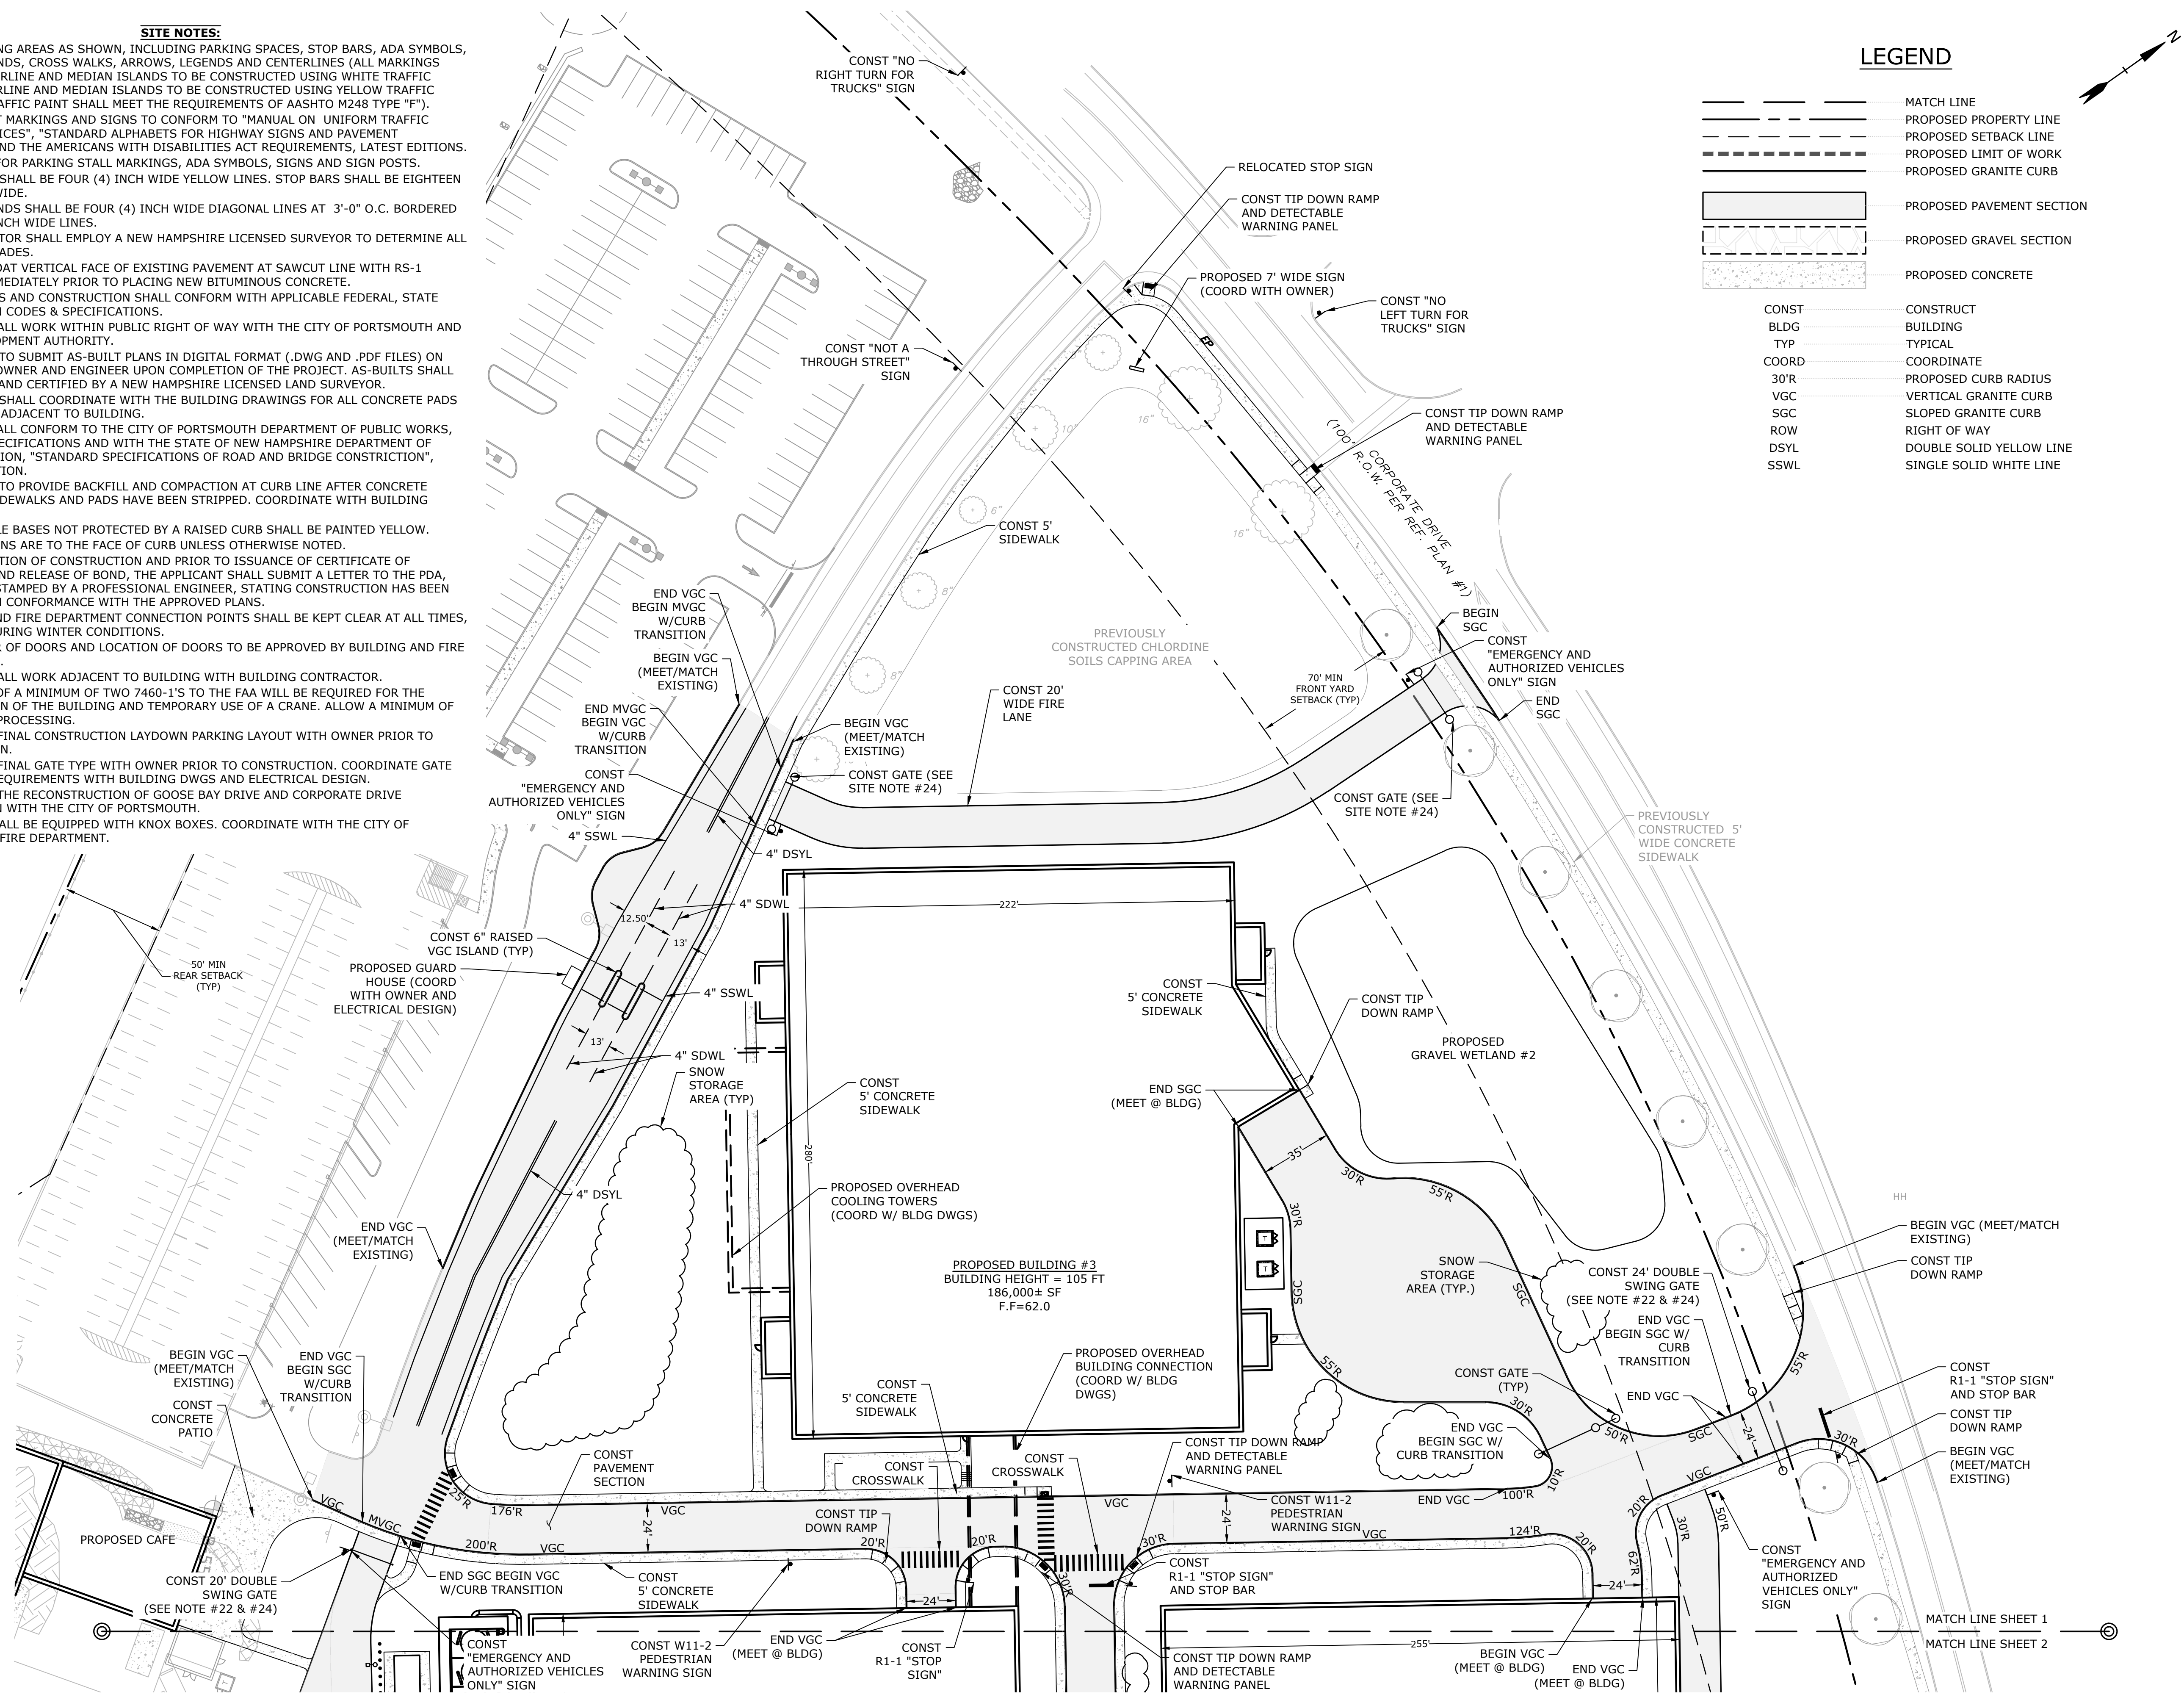
Proposed Industrial Development






Lonza Biologics

Portsmouth, New Hampshire

N	11/9/2023	Revised P.B. Submission
M	9/27/2023	P.B. Submission
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J	5/23/2022	Third Party Rev. Comments
I	4/26/2022	Revised PB Stipulations
MARK	DATE	DESCRIPTION
PROJECT NO:	L-0700-013	
DATE:	04/03/2018	
FILE:	L-0700-026-C-DSGN.dwg	
DRAWN BY:	CJK	
CHECKED:	NAH	
APPROVED:	PMC	

SITE PLAN
SCALE: AS SHOWN
C-105



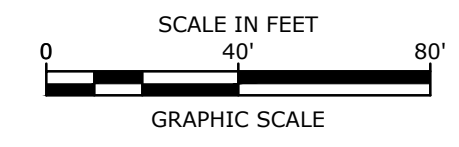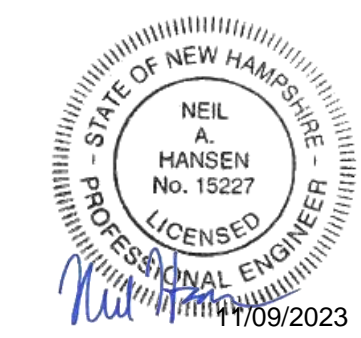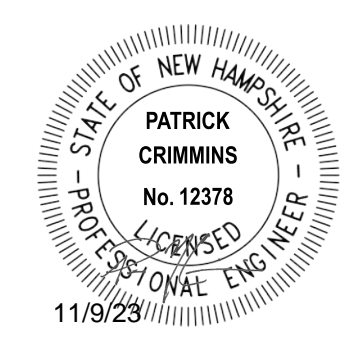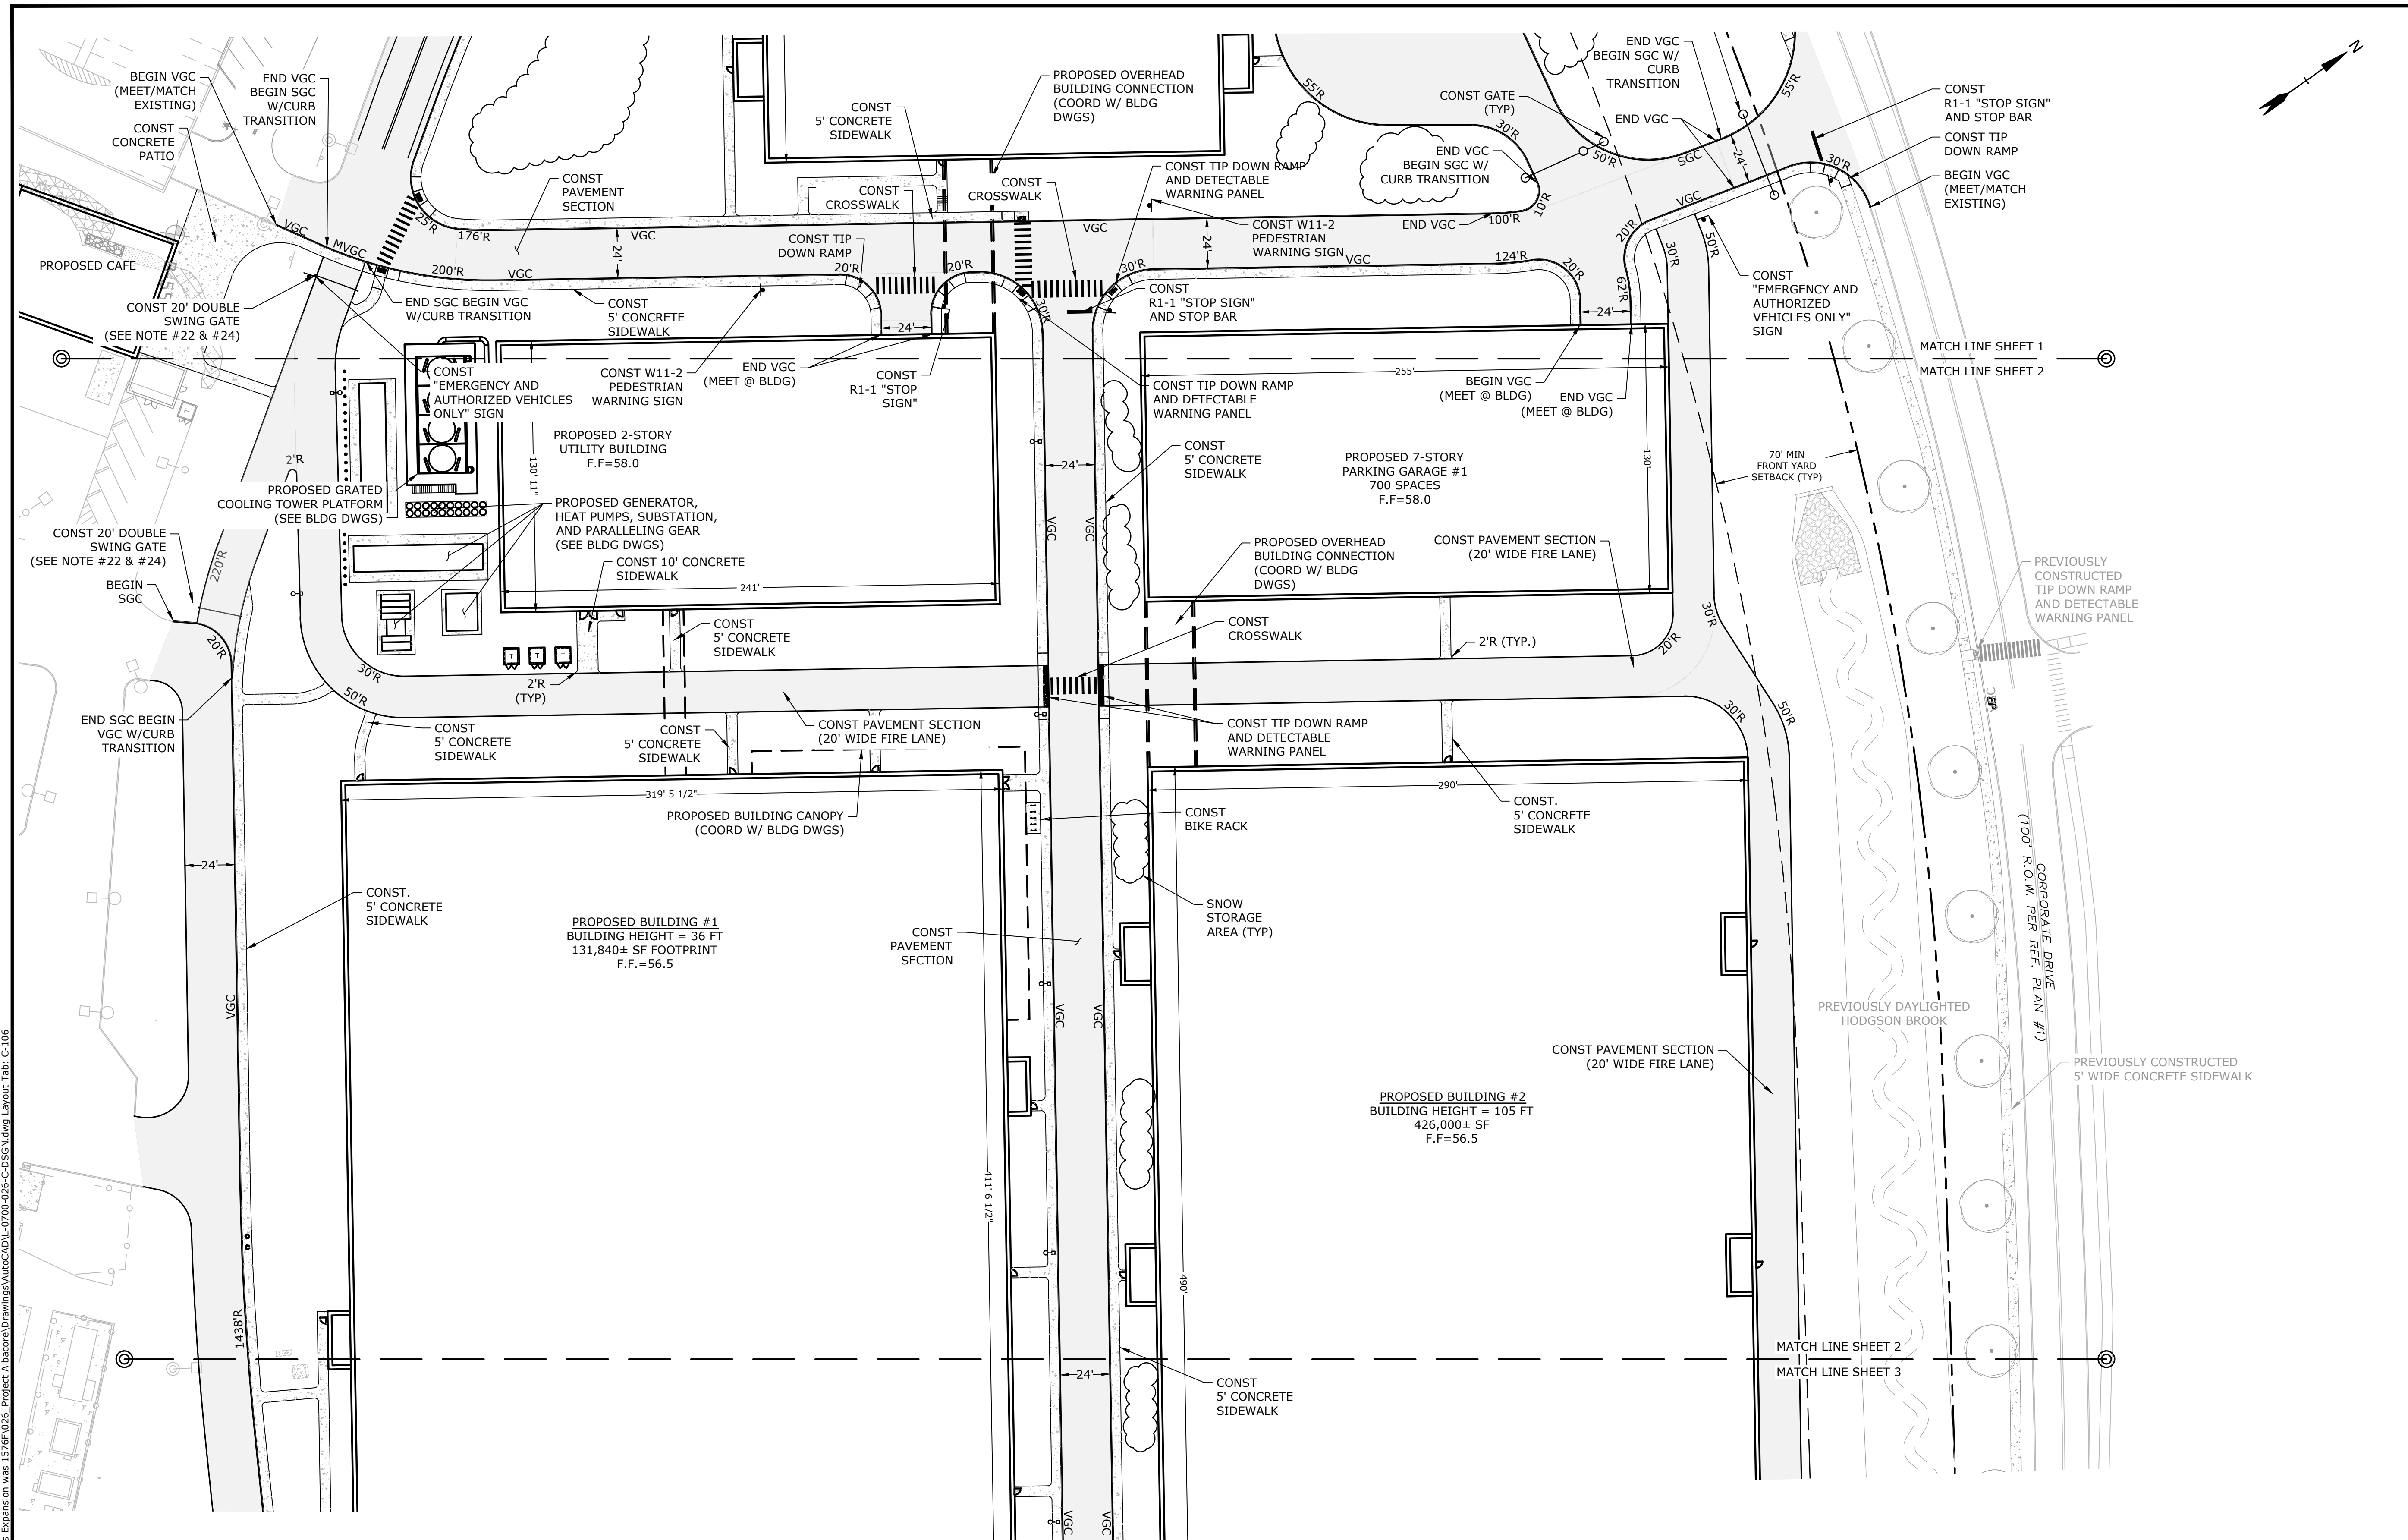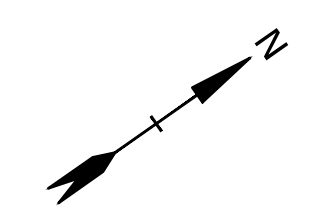

Proposed Industrial Development

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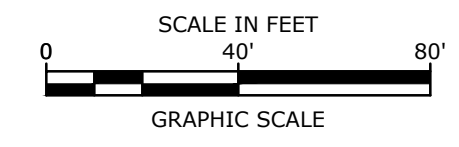
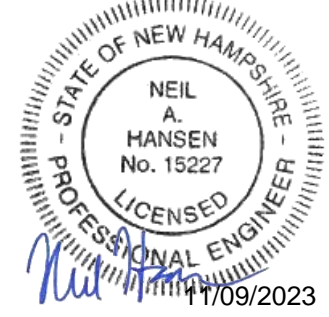
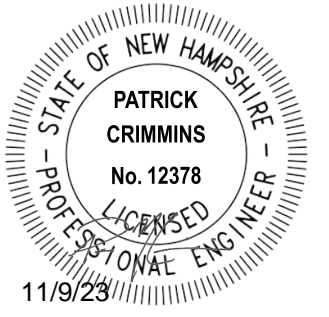
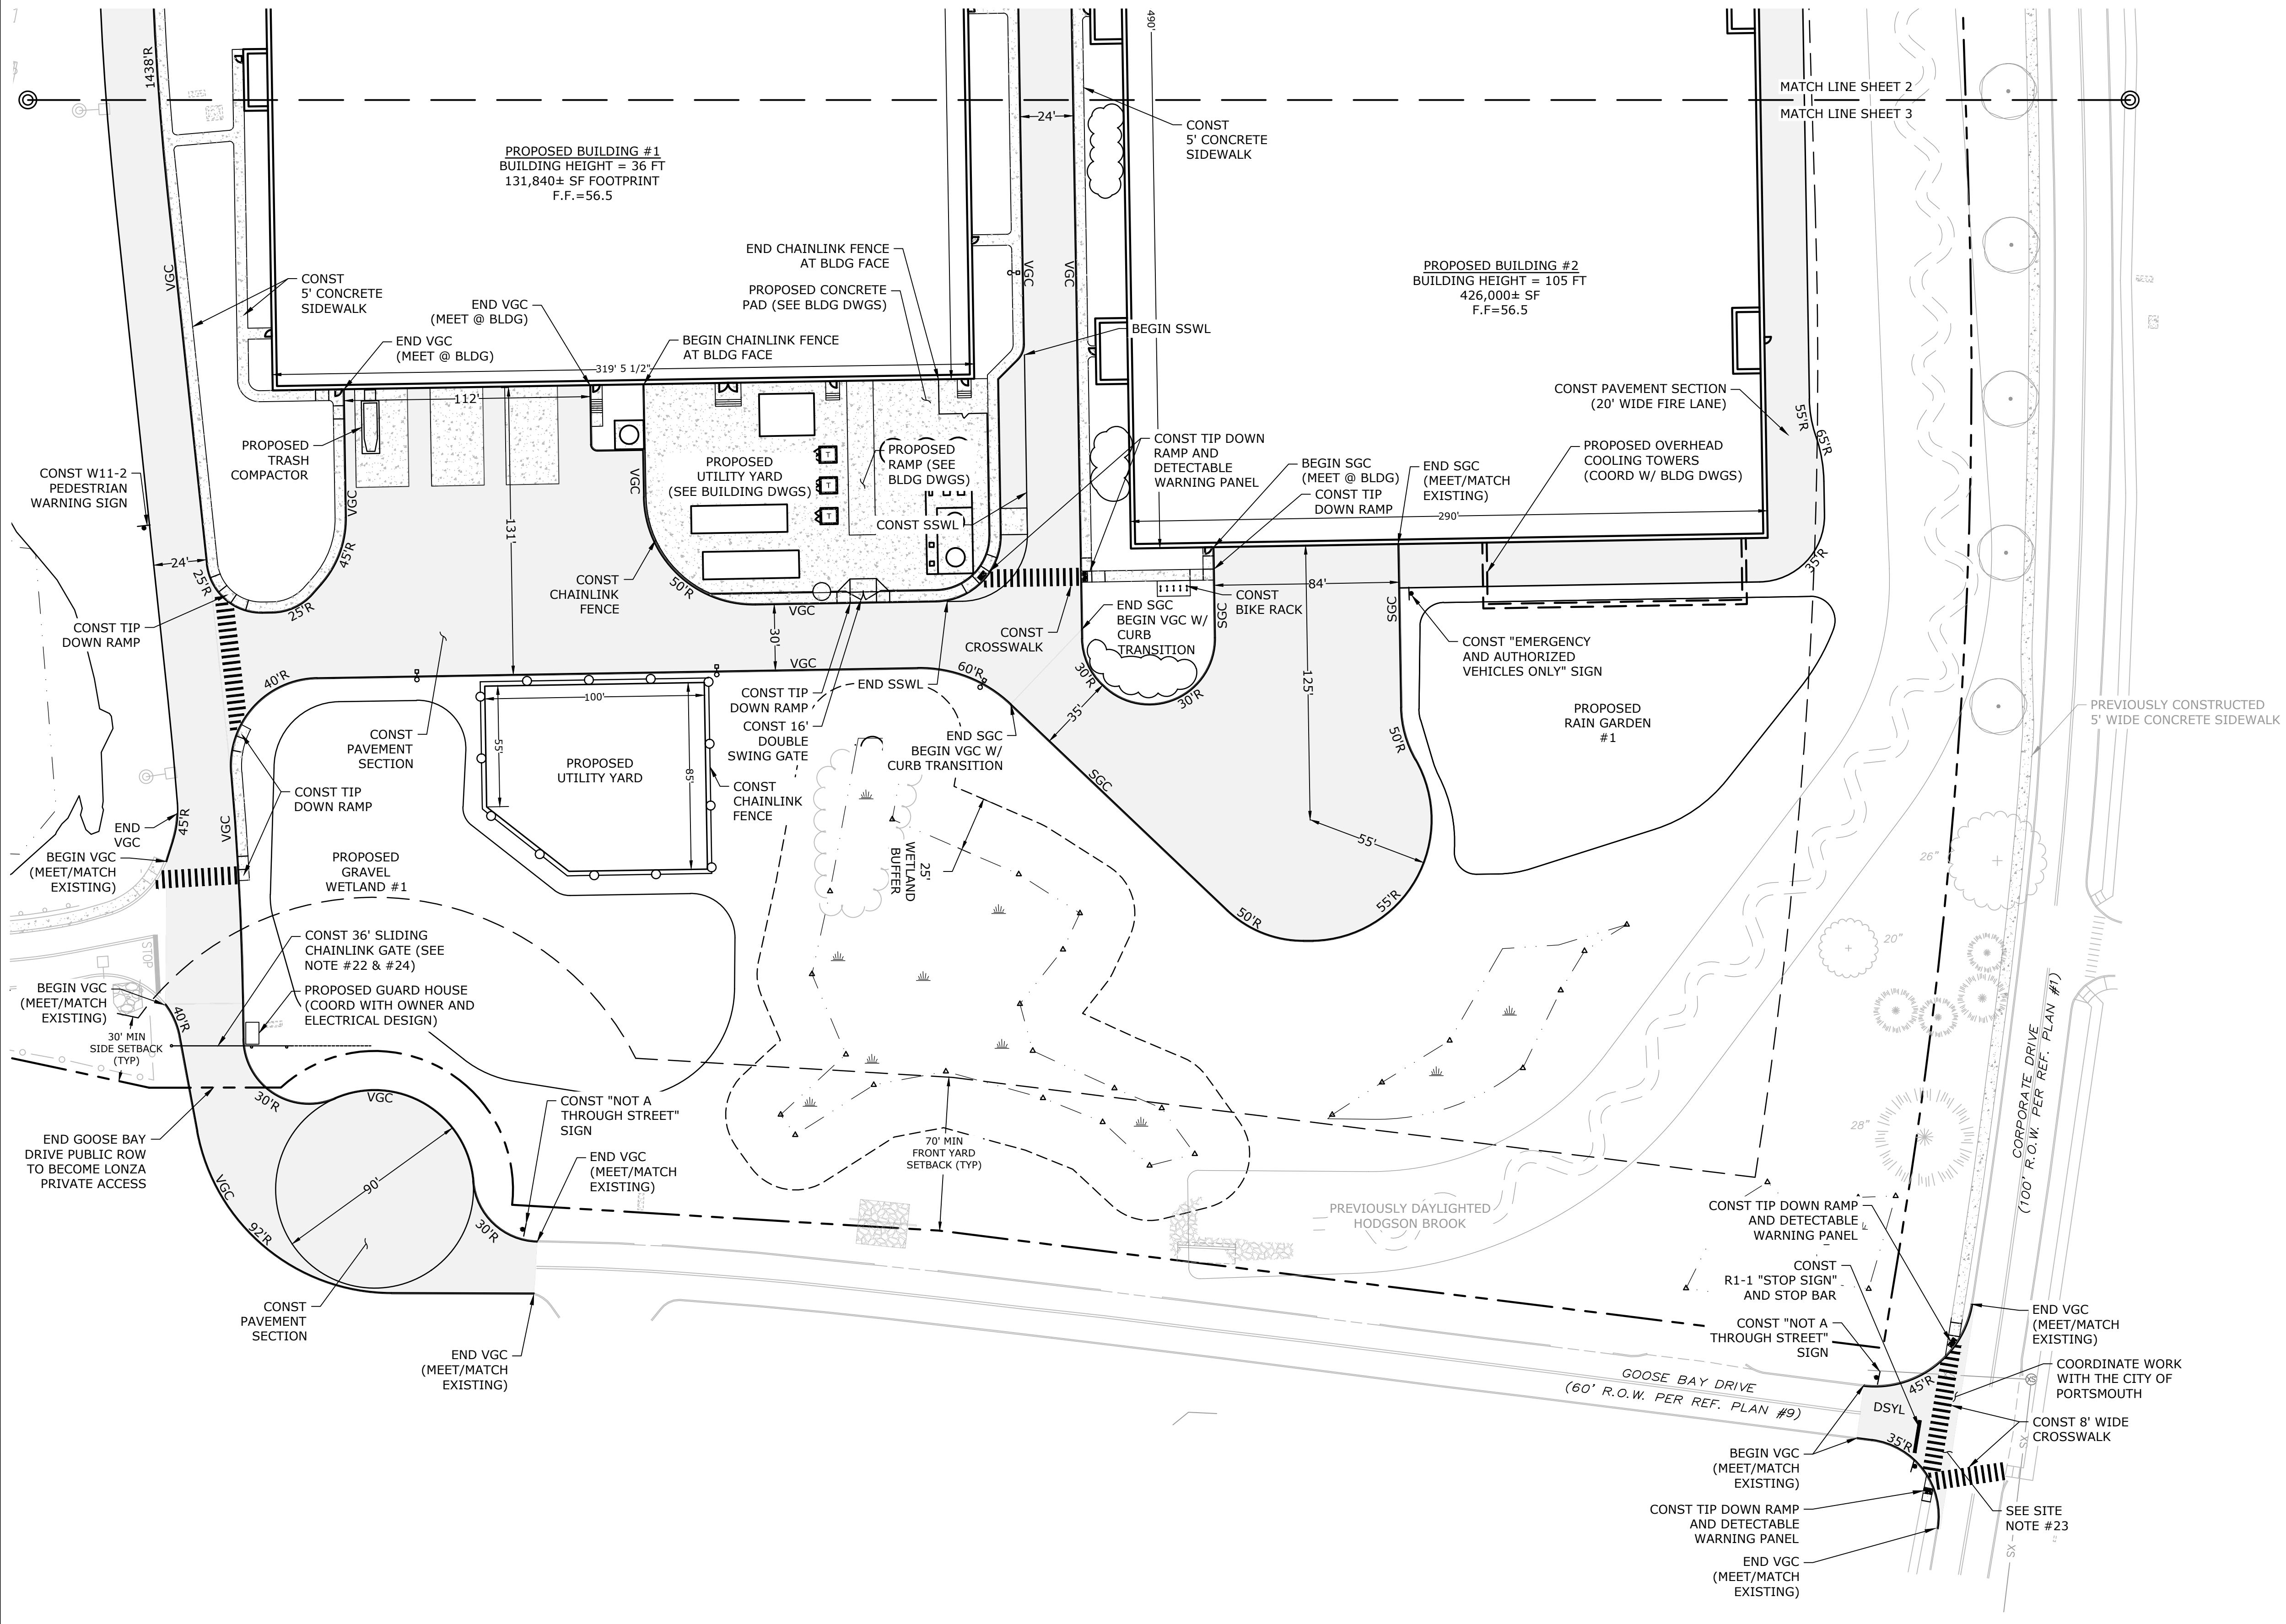
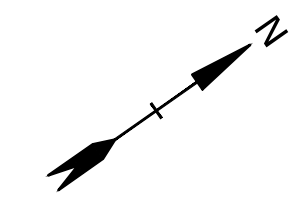
SEE SHEET C-105 FOR LEGEND AND SITE NOTES

SITE PLAN

SCALE: AS SHOWN

C-106

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Proposed Industrial Development

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J	5/23/2022	Third Party Rev. Comments
I	4/26/2022	Revised PB Stipulations

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FILE:	L-0700-026-C-DSGN.dwg
DRAWN BY:	CJK
CHECKED:	NAH
APPROVED:	PMC




SITE PLAN

SCALE: AS SHOWN

C-107

SEE SHEET C-105 FOR LEGEND AND SITE NOTES

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Proposed Industrial Development
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Portsmouth, New Hampshire
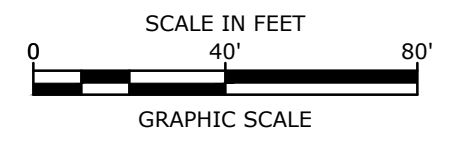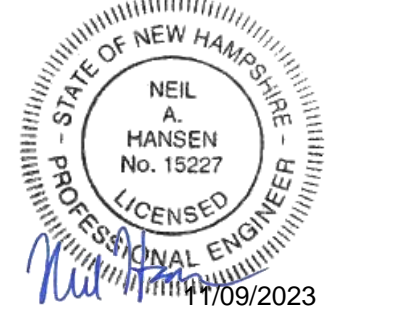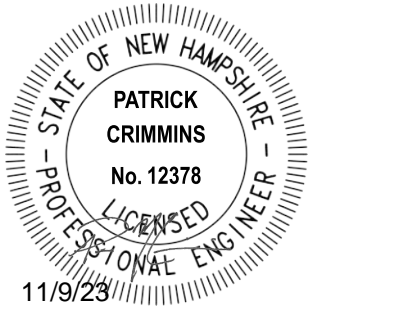
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FILE:	L-0700-026-C-DSGN.dwg
DRAWN BY:	CIK
CHECKED:	NAH
APPROVED:	PMC

GRADING, DRAINAGE & EROSION CONTROL PLAN

SCALE: AS SHOWN

GRADING AND DRAINAGE NOTES:


1. COMPACTION REQUIREMENTS:
 - BELOW PAVED OR CONCRETE AREAS 95%
 - TRENCH BEDDING MATERIAL AND SAND BLANKET BACKFILL 95%
 - BELOW LOAM AND SEED AREAS 90%
2. ALL STORM DRAINAGE PIPES SHALL BE HIGH DENSITY POLYETHYLENE (HANCOR HI-Q, ADS N-12 OR APPROVED EQUAL), UNLESS OTHERWISE SPECIFIED.
3. SEE UTILITIES PLAN FOR ALL SITE UTILITY INFORMATION.
4. ADJUST ALL MANHOLES, CATCHBASINS, CURB BOXES, ETC. WITHIN LIMITS OF WORK TO FINISH GRADE.
5. CONTRACTOR SHALL PROVIDE A FINISH PAVEMENT SURFACE AND LAWN AREAS FREE OF LOW SPOTS AND PONDING AREAS. CRITICAL AREAS INCLUDE BUILDING ENTRANCES, EXITS, RAMPS AND LOADING DOCK AREAS ADJACENT TO THE BUILDING.
6. CONTRACTOR SHALL THOROUGHLY CLEAN ALL CATCHBASINS AND DRAIN LINES, WITHIN THE LIMIT OF WORK, OF SEDIMENT IMMEDIATELY UPON COMPLETION OF CONSTRUCTION.
7. ALL MATERIALS AND CONSTRUCTION SHALL CONFORM WITH APPLICABLE FEDERAL, STATE AND LOCAL CODES.
8. ALL DISTURBED AREAS NOT TO BE PAVED OR OTHERWISE TREATED SHALL RECEIVE 6" LOAM, SEED FERTILIZER AND MULCH.
9. ALL STORM DRAIN CONSTRUCTION SHALL BE IN ACCORDANCE WITH THE NHDOT STANDARD SPECIFICATIONS FOR HIGHWAYS AND BRIDGES, LATEST EDITION.
10. ALL PROPOSED CATCHBASINS SHALL BE EQUIPPED WITH OIL/GAS SEPARATOR HOODS AND 4' SUMPS.
11. CONTRACTOR TO SUBMIT AS-BUILT PLANS IN DIGITAL FORMAT (.DWG AND .PDF FILES) ON DISK TO THE OWNER AND ENGINEER UPON COMPLETION OF THE PROJECT. AS-BUILTS SHALL BE PREPARED AND CERTIFIED BY A NEW HAMPSHIRE LICENSED LAND SURVEYOR.
12. CONTRACTOR SHALL COORDINATE WITH THE PROJECT SURVEYOR FOR BENCHMARK AND CONTROL POINTS PRIOR TO CONSTRUCTION.
13. ALL WORK SHALL CONFORM TO THE CITY OF PORTSMOUTH DEPARTMENT OF PUBLIC WORKS, STANDARD SPECIFICATIONS, AND WITH THE STATE OF NEW HAMPSHIRE DEPARTMENT OF TRANSPORTATION, "STANDARD SPECIFICATIONS OF ROAD AND BRIDGE CONSTRUCTION", CURRENT EDITION.
14. PER COORDINATION WITH THE PDA, GROUNDWATER DISCHARGE FROM THE PROPOSED FOUNDATION DRAIN AND UNDER-SLAB DRAIN OF BUILDING 1 AND THE CENTRAL UTILITY BUILDING WILL BE CONNECTED TO THE ONSITE DRAINAGE SYSTEM. IF TREATMENT OF THE GROUNDWATER DISCHARGE IS DETERMINED TO BE REQUIRED DURING THE BUILDING PERMITTING PROCESS AND RE-INTEGRATION IS NOT PERMITTED, A CARBON FILTRATION SYSTEM WILL BE NEEDED.

EROSION CONTROL NOTES:






1. INSTALL EROSION CONTROL BARRIERS AS SHOWN AS FIRST ORDER OF WORK.
2. SEE GENERAL EROSION CONTROL NOTES ON DETAIL SHEETS.
3. PROVIDE INLET PROTECTION AROUND ALL EXISTING AND PROPOSED CATCHBASIN INLETS WITHIN THE WORK LIMITS. MAINTAIN FOR THE DURATION OF THE PROJECT UNTIL PAVEMENT HAS BEEN INSTALLED.
4. INSTALL STABILIZED CONSTRUCTION ENTRANCES.
5. INSPECT INLET PROTECTION AND SILT FENCES DAILY AND AFTER EACH RAIN STORM OF 0.25 INCH OR GREATER. REPAIR/MODIFY PROTECTION AS NECESSARY TO MAXIMIZE EFFICIENCY OF FILTER. REPLACE ALL FILTERS WHEN SEDIMENT IS 1/3 THE FILTER HEIGHT.
6. ALL DISTURBED AREAS NOT TO BE PAVED OR OTHERWISE TREATED SHALL RECEIVE 6" LOAM, SEED, FERTILIZER AND MULCH.
7. CONSTRUCT EXCELSIOR MAT ON ALL SLOPES STEEPER THAN 3:1.
8. PRIOR TO ANY WORK OR SOIL DISTURBANCE COMMENCING ON THE SUBJECT PROPERTY, INCLUDING MOVING OF EARTH, THE APPLICANT SHALL INSTALL ALL EROSION AND SILTATION MITIGATION AND CONTROL MEASURES AS REQUIRED BY STATE AND LOCAL PERMITS AND APPROVALS.
9. CONTRACTOR SHALL BE RESPONSIBLE TO CONTROL DUST AND WIND EROSION THROUGHOUT THE CONSTRUCTION PERIOD. DUST CONTROL MEASURES SHALL INCLUDE, BUT NOT LIMITED TO, SPRINKLING WATER ON UNSTABLE SOILS SUBJECT TO ARID CONDITIONS.
10. THE CONTRACTOR SHALL REMOVE AND PROPERLY DISPOSE OF ALL TEMPORARY EROSION CONTROL DEVICES UPON COMPLETION OF CONSTRUCTION AND FINAL STABILIZATION.
11. ALL CATCHBASIN SUMPS AND PIPING SHALL BE THOROUGHLY CLEANED TO REMOVE ALL SEDIMENT AND DEBRIS AFTER THE PROJECT HAS BEEN PAVED.
12. TEMPORARY SOIL STOCKPILE SHALL BE SURROUNDED BY SILT FENCE AND SHALL BE STABILIZED BY TEMPORARY EROSION CONTROL SEEDING. STOCKPILE AREAS TO BE LOCATED AS FAR AS POSSIBLE FROM THE DELINEATED EDGE OF WETLAND.
13. SAFETY FENCING SHALL BE PROVIDED AROUND STOCKPILES OVER 10 FT.
14. CONCRETE TRUCKS WILL BE REQUIRED TO WASH OUT (IF NECESSARY) SHOOT ONLY WITHIN AREAS WHERE CONCRETE HAS BEEN PLACED. NO OTHER WASH OUT WILL BE ALLOWED.

LEGEND

---	MATCH LINE
---	PROPOSED PROPERTY LINE
---	PROPOSED CONTOUR LINE
---	PROPOSED DRAIN LINE (TYP)
---	PROPOSED SILT SOCK
○	INLET PROTECTION SILT SACK
○	PROPOSED CATCHBASIN
○	PROPOSED DOUBLE GRATE CATCHBASIN
○	PROPOSED DRAIN MANHOLE
---	CONSTRUCT
---	BLDG
---	TYP
---	COORD
---	RD
---	VF
---	TC
---	BC

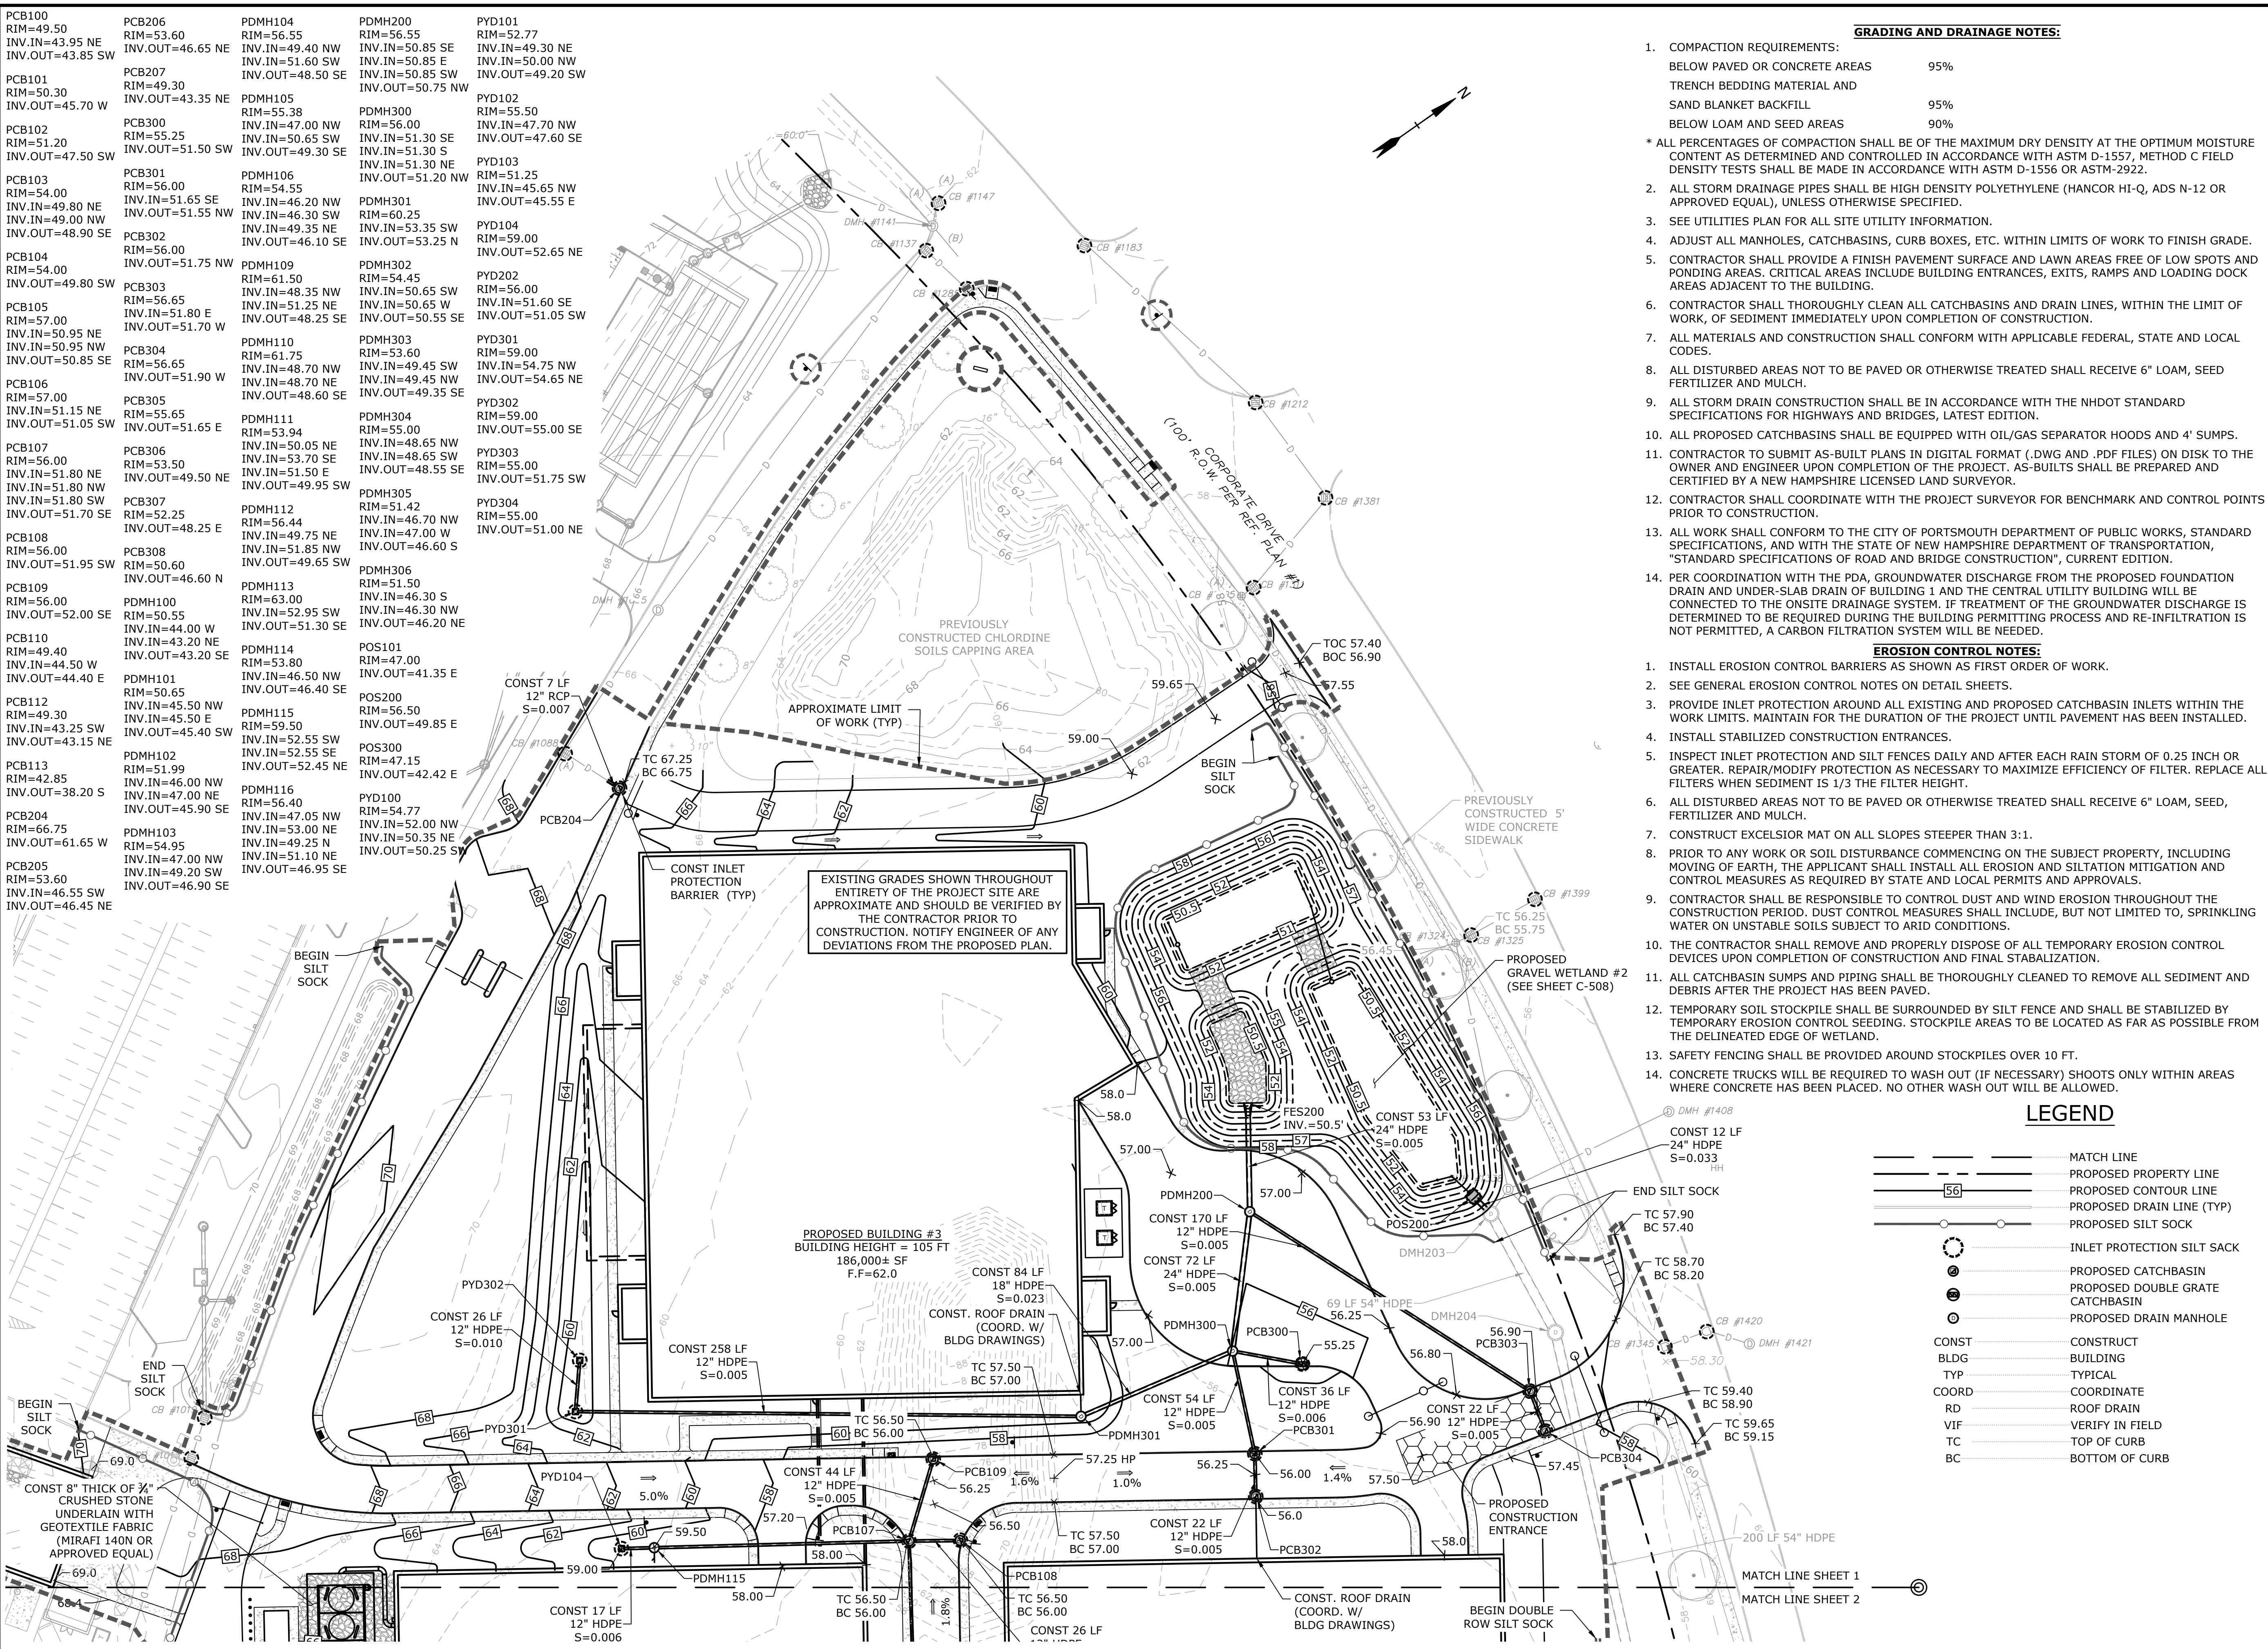

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EXISTING GRADES SHOWN THROUGHOUT ENTIRETY OF THE PROJECT SITE ARE APPROXIMATE AND SHOULD BE VERIFIED BY THE CONTRACTOR PRIOR TO CONSTRUCTION. NOTIFY ENGINEER OF ANY DEVIATIONS FROM THE PROPOSED PLAN.

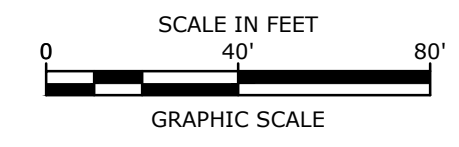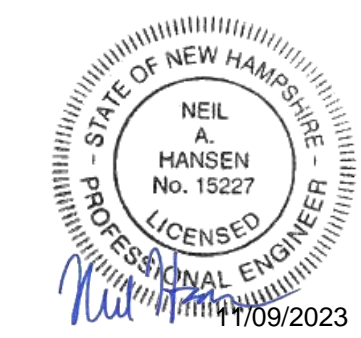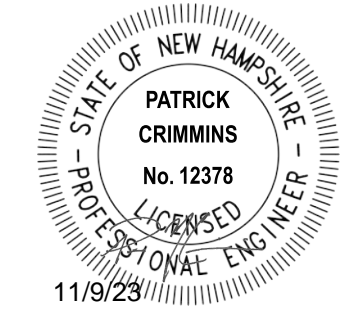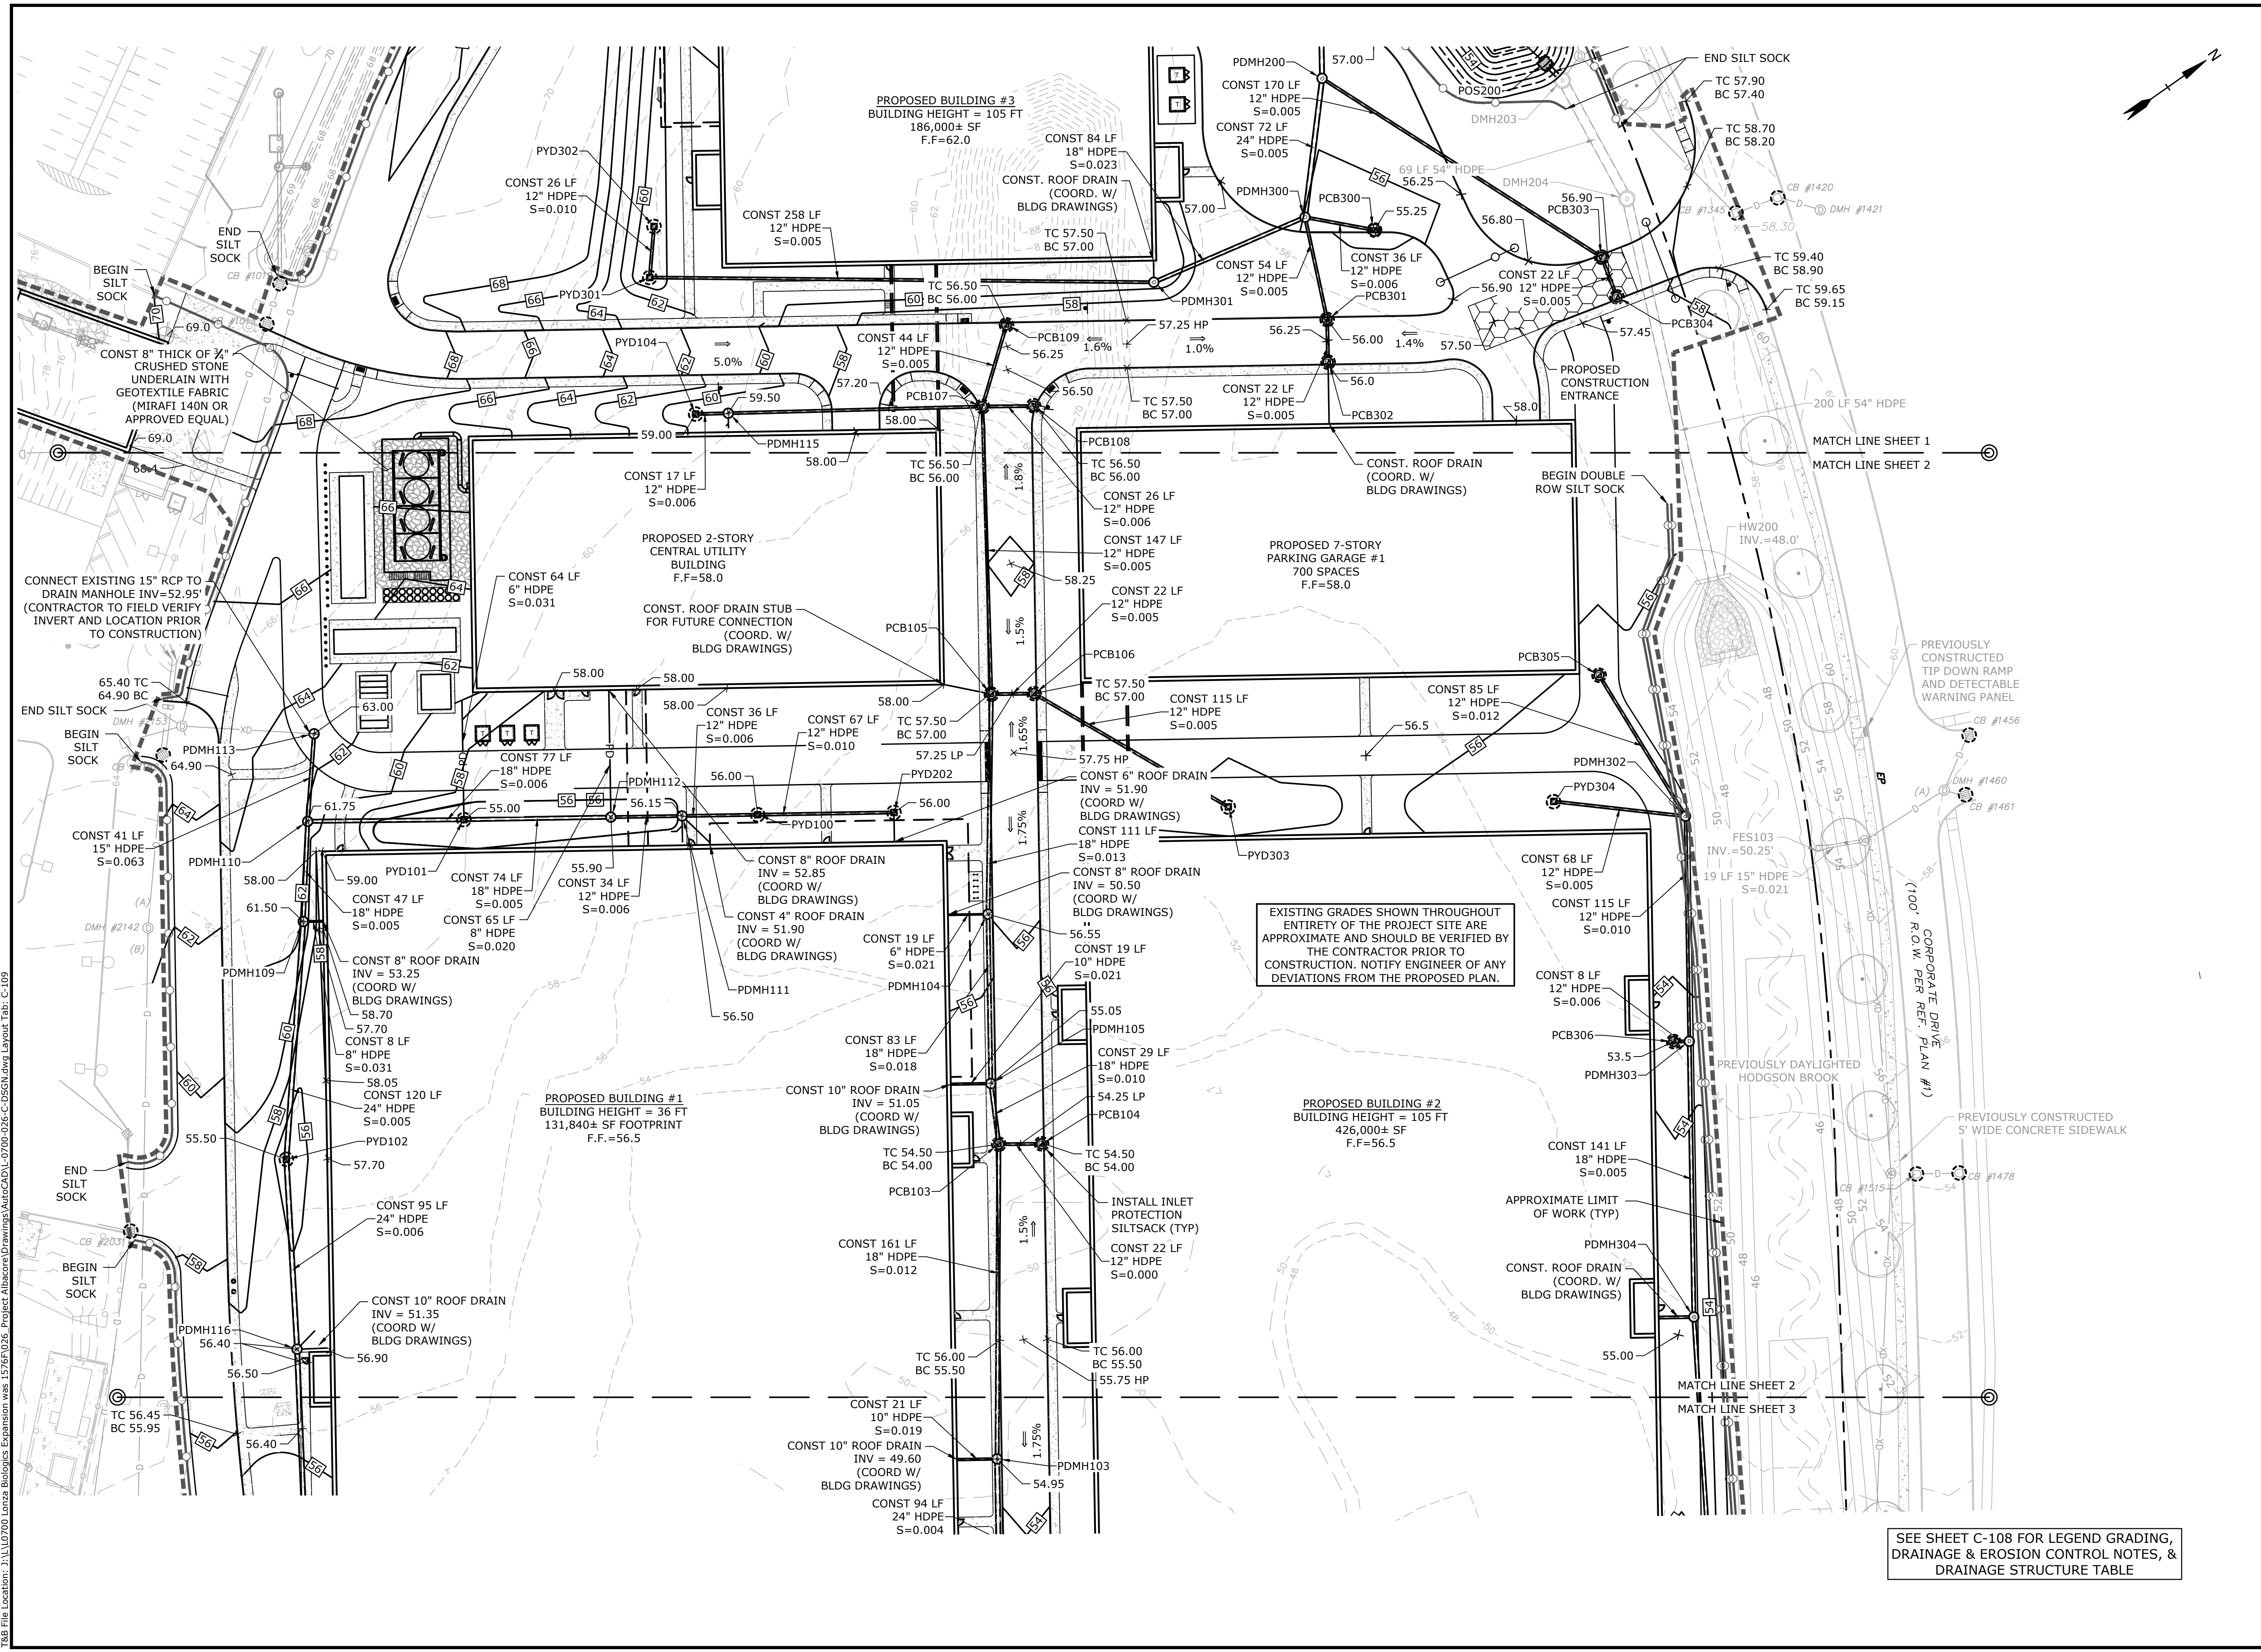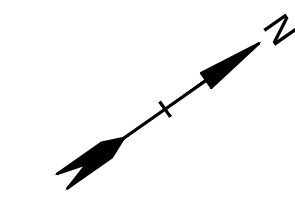Proposed Industrial Development

Lonza Biologics

Portsmouth, New Hampshire

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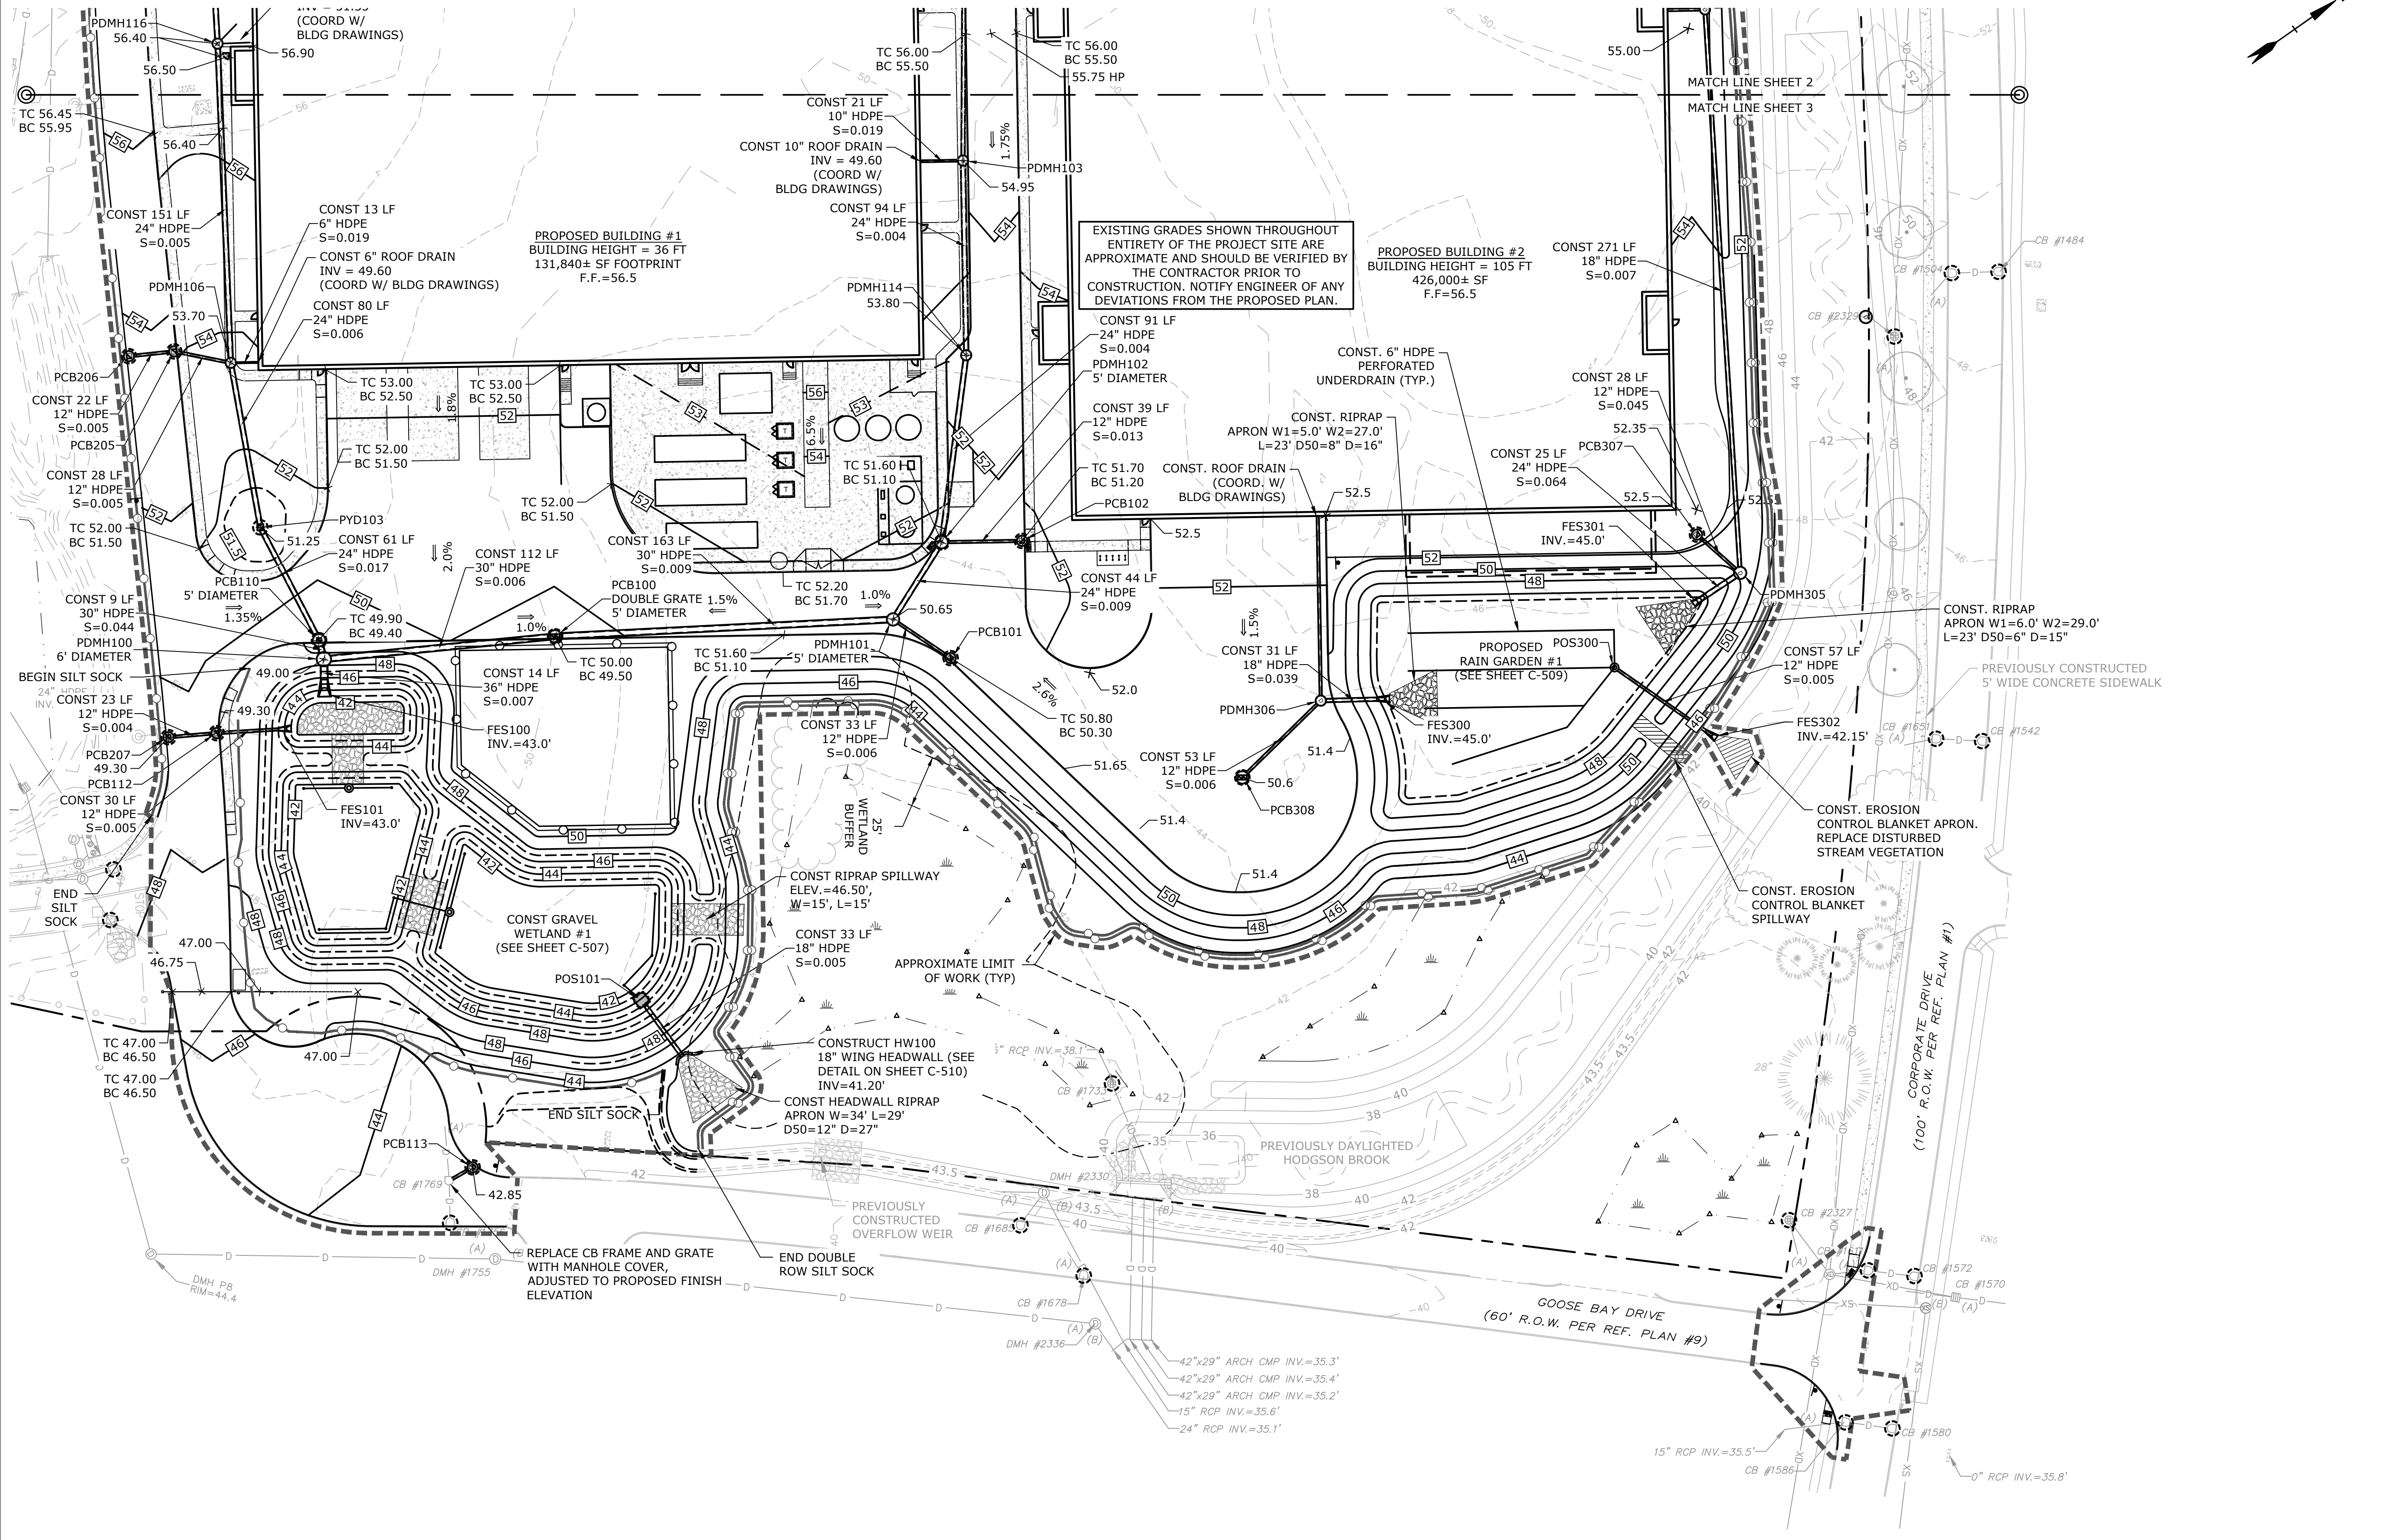
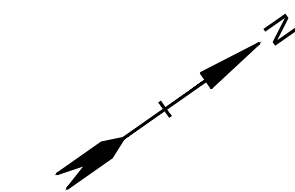
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DRAWN BY:	CIK
CHECKED:	NAH
APPROVED:	PMC

SEE SHEET C-108 FOR LEGEND GRADING, DRAINAGE & EROSION CONTROL NOTES, & DRAINAGE STRUCTURE TABLE




GRADING, DRAINAGE & EROSION CONTROL PLAN

SCALE: AS SHOWN

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GRADING, DRAINAGE & EROSION CONTROL PLAN

SCALE: AS SHOWN

C-110

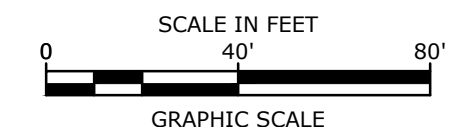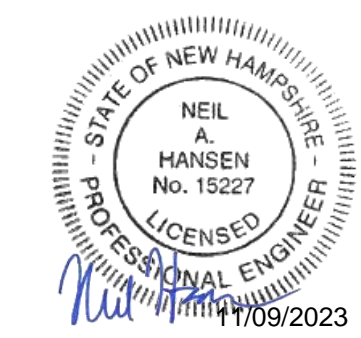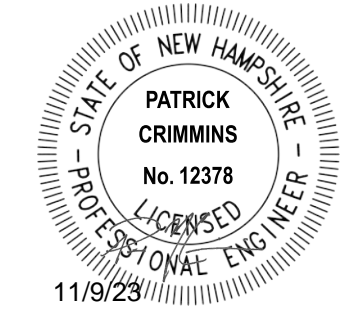SEE SHEET C-108 FOR LEGEND GRADING, DRAINAGE & EROSION CONTROL NOTES, & DRAINAGE STRUCTURE TABLE



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LEGEND

---	MATCH LINE
D	EXISTING STORM DRAIN
SS	EXISTING SANITARY SEWER
W	EXISTING WATER
G	EXISTING GAS
E	EXISTING UNDERGROUND ELECTRIC
OHW	EXISTING OVERHEAD UTILITY
---	PROPOSED STORM DRAIN
---	PROPOSED SANITARY SEWER
PW	PROPOSED WATER
G	PROPOSED GAS
---	PROPOSED UNDERGROUND ELECTRIC
---	PROPOSED UNDERGROUND COMMUNICATION
COM	EXISTING CATCHBASIN
⊙	EXISTING DRAIN MANHOLE
⊙	EXISTING SEWER MANHOLE
⊙	EXISTING HYDRANT
⊙	EXISTING WATER VALVE
⊙	EXISTING ELECTRIC MANHOLE
⊙	EXISTING TELEPHONE MANHOLE
⊙	PROPOSED CATCHBASIN
⊙	PROPOSED DOUBLE GRATE CATCHBASIN
⊙	PROPOSED DRAIN MANHOLE
⊙	PROPOSED SEWER MANHOLE
⊙	PROPOSED WATER VALVE
⊙	PROPOSED FDC CONNECTION
⊙	PROPOSED HYDRANT
⊙	PROPOSED GAS VALVE
⊙	PROPOSED ELECTRIC MANHOLE
⊙	PROPOSED TRANSFORMER PAD
⊙	PROPOSED LIGHT POLE BASE
CONST	CONSTRUCT
BLDG	BUILDING
TYP	TYPICAL
COORD	COORDINATE
VIF	VERIFY IN FIELD
DI	DUCTILE IORN
COM	COMMUNICATION
FRP	FIBERGLASS REINFORCED POLYMER MORTAR PIPE

UTILITY NOTES:

- THE LOCATIONS OF EXISTING UNDERGROUND UTILITIES ARE APPROXIMATE AND THE LOCATIONS ARE NOT GUARANTEED BY THE OWNER OR ENGINEER. IT IS THE CONTRACTOR'S RESPONSIBILITY TO LOCATE ALL UTILITIES, ANTICIPATE CONFLICTS, REPAIR EXISTING UTILITIES, AND RELOCATE EXISTING UTILITIES REQUIRED TO COMPLETE THE WORK AT NO ADDITIONAL COST TO THE OWNER.
- COORDINATE ALL UTILITY WORK WITH APPROPRIATE UTILITY COMPANY.
NATURAL GAS - UNITIL
WATER - CITY OF PORTSMOUTH DPW
SEWER - CITY OF PORTSMOUTH DPW
ELECTRIC - EVERSOURCE
COMMUNICATIONS - FAIRPOINT, COMCAST, FIRSTLIGHT
- SEE EXISTING CONDITIONS PLAN FOR BENCHMARK INFORMATION.
- SEE GRADING, DRAINAGE & EROSION CONTROL PLAN FOR PROPOSED GRADING AND EROSION CONTROL MEASURES.
- ALL WATER MAIN INSTALLATIONS SHALL BE CLASS 52, CEMENT LINED DUCTILE IRON PIPE.
- ALL WATER MAIN INSTALLATIONS SHALL BE PRESSURE TESTED AND CHLORINATED AFTER CONSTRUCTION PRIOR TO ACTIVATING THE SYSTEM. CONTRACTOR SHALL COORDINATE CHLORINATION AND TESTING WITH THE CITY OF PORTSMOUTH WATER DEPARTMENT.
- ALL SEWER PIPE SHALL BE FIBERGLASS REINFORCED POLYMER MORTAR (FRP) PIPE UNLESS OTHERWISE STATED.
- ALL WORK WITHIN PORTSMOUTH ROWS SHALL BE COORDINATED WITH CITY OF PORTSMOUTH AND THE PEASE DEVELOPMENT AUTHORITY.
- CONTRACTOR SHALL MAINTAIN UTILITY SERVICES TO ABUTTING PROPERTIES THROUGHOUT CONSTRUCTION.
- CONNECTIONS TO EXISTING WATER MAIN SHALL BE CONSTRUCTED TO CITY OF PORTSMOUTH STANDARDS.
- EXISTING UTILITIES TO BE REMOVED SHALL BE CAPPED AT THE MAIN AND MEET THE CITY OF PORTSMOUTH DEPARTMENT OF PUBLIC WORKS STANDARDS FOR CAPPING OF WATER AND SEWER SERVICES.
- ALL ELECTRICAL MATERIAL WORKMANSHIP SHALL CONFORM TO THE NATIONAL ELECTRIC CODE, LATEST EDITION, AND ALL APPLICABLE STATE AND LOCAL CODES.
- THE EXACT LOCATION OF NEW UTILITY SERVICES AND CONNECTIONS SHALL BE COORDINATED WITH THE BUILDING DRAWINGS AND THE UTILITY COMPANIES.
- ADJUST ALL MANHOLES, CATCH BASINS, CURB BOXES, ETC. WITHIN LIMITS OF WORK TO FINISH GRADE.
- ALL UNDERGROUND CONDUITS SHALL HAVE NYLON PULL ROPES TO FACILITATE PULLING CABLES.
- THE CONTRACTOR SHALL OBTAIN, PAY FOR, AND COMPLY WITH ALL REQUIRED PERMITS, ARRANGE FOR ALL INSPECTIONS, AND SUBMIT COPIES OF ACCEPTANCE CERTIFICATES TO THE OWNER PRIOR TO THE COMPLETION OF THIS PROJECT.
- THE CONTRACTOR SHALL PROVIDE AND INSTALL ALL MANHOLES, BOXES, FITTINGS, CONNECTORS, COVER PLATES, AND OTHER MISCELLANEOUS ITEMS NOT NECESSARILY DETAILED ON THESE DRAWINGS TO RENDER INSTALLATION OF UTILITIES COMPLETE AND OPERATIONAL.
- CONTRACTOR SHALL PROVIDE EXCAVATION, BEDDING, BACKFILL AND COMPACTION FOR NATURAL GAS SERVICES.
- A 10-FOOT MINIMUM EDGE TO EDGE HORIZONTAL SEPARATION SHALL BE PROVIDED BETWEEN ALL WATER AND SANITARY SEWER LINES. AN 18-INCH MINIMUM OUTSIDE TO OUTSIDE VERTICAL SEPARATION SHALL BE PROVIDED AT ALL WATER/SANITARY SEWER CROSSINGS.
- THE CONTRACTOR SHALL CONTACT "DIG-SAFE" 72 HOURS PRIOR TO COMMENCING CONSTRUCTION. THE CONTRACTOR SHALL HAVE THE "DIG-SAFE" NUMBER ON SITE AT ALL TIMES.
- CONTRACTOR TO SUBMIT AS-BUILT PLANS IN DIGITAL FORMAT (.DWG AND .PDF FILES) ON DISK TO THE OWNER AND ENGINEER UPON COMPLETION OF THE PROJECT. AS-BUILTS SHALL BE PREPARED AND CERTIFIED BY A NEW HAMPSHIRE LICENSED LAND SURVEYOR.
- SAWCUT AND REMOVE PAVEMENT AND CONSTRUCT PAVEMENT TRENCH PATCH FOR ALL PROPOSED UTILITIES LOCATED IN EXISTING PAVEMENT AREAS TO REMAIN.
- HYDRANTS, GATE VALVES, FITTINGS, ETC. SHALL MEET THE REQUIREMENTS OF THE CITY OF PORTSMOUTH AND THE PEASE DEVELOPMENT AUTHORITY.
- COORDINATE TESTING OF SEWER CONSTRUCTION WITH THE CITY OF PORTSMOUTH.
- ALL SEWER PIPE WITH LESS THAN 6' OF COVER IN PAVED AREAS OR LESS THAN 4' OF COVER IN UNPAVED AREAS SHALL BE INSULATED.
- CONTRACTOR SHALL COORDINATE ALL ELECTRIC WORK INCLUDING BUT NOT LIMITED TO: CONDUIT CONSTRUCTION, MANHOLE CONSTRUCTION, UTILITY POLE CONSTRUCTION, OVERHEAD WIRE RELOCATION, AND TRANSFORMER CONSTRUCTION WITH POWER COMPANY.
- CONTRACTOR SHALL PHASE UTILITY CONSTRUCTION, PARTICULARLY WATER MAIN AND GAS MAIN CONSTRUCTION, AS TO MAINTAIN CONTINUOUS SERVICE TO ABUTTING PROPERTIES. CONTRACTOR SHALL COORDINATE TEMPORARY SERVICES TO ABUTTERS WITH THE UTILITY COMPANY AND AFFECTED ABUTTER.
- SITE LIGHTING SPECIFICATIONS, CONDUIT LAYOUT AND CIRCUITRY FOR PROPOSED SITE LIGHTING AND SIGN ILLUMINATION SHALL BE PROVIDED BY THE PROJECT ELECTRICAL ENGINEER.
- CONTRACTOR SHALL CONSTRUCT ALL UTILITIES AND DRAINS TO WITHIN 10' OF THE FOUNDATION WALLS AND CONNECT THESE TO SERVICE STUBS FROM THE BUILDING.
- EXISTING SEWER MAIN AND STRUCTURES IN GOOSE BAY DRIVE ARE BASED ON A PROPOSED DESIGN BY UNDERWOOD ENGINEERS, DATED JULY 28, 2017, AND WAS CONSTRUCTED IN SUMMER 2018. THE PROPOSED ON-SITE SEWER DESIGN ELEVATIONS ARE BASED ON THE UNDERWOOD PLAN DURING CONSTRUCTION. THE CONTRACTOR SHALL COORDINATE SEWER CONSTRUCTION WITH THE CITY OF PORTSMOUTH, AND VERIFY ALL INVERTS PRIOR TO CONSTRUCTION.
- LOCATION SHOWN IS APPROXIMATE ONLY. FINAL DESIGN OF NATURAL GAS SERVICE TO BE COMPLETED BY UNITIL. WORK IN CORPORATE DRIVE MAY NEED TO BE COMPLETED IN CONJUNCTION WITH FUTURE RECONSTRUCTION OF CORPORATE DRIVE. COORDINATE WITH CITY OF PORTSMOUTH AND UNITIL.
- LOCATION AND TYPE SHOWN IS APPROXIMATE ONLY. FINAL DESIGN OF ELECTRIC SERVICE AND ASSOCIATED INFRASTRUCTURE TO BE COMPLETED BY EVERSOURCE. WORK IN CORPORATE DRIVE MAY NEED TO BE COMPLETED IN CONJUNCTION WITH FUTURE RECONSTRUCTION OF CORPORATE DRIVE. COORDINATE WITH CITY OF PORTSMOUTH AND EVERSOURCE.
- FINAL LOCATION OF ALL WATER METER AND VALVES SHALL BE COORDINATED WITH THE CITY OF PORTSMOUTH DPW PRIOR TO CONSTRUCTION.
- FINAL LOCATION OF FIRE HYDRANTS, FIRE DEPARTMENT CONNECTIONS AND DRY STAND PIPES WILL BE COORDINATED WITH THE BUILDING DRAWINGS AND APPROVED BY THE PORTSMOUTH FIRE DEPARTMENT PRIOR TO CONSTRUCTION.
- THE APPLICANT SHALL HAVE A SITE SURVEY CONDUCTED BY A RADIO COMMUNICATIONS CARRIER APPROVED BY THE CITY'S COMMUNICATIONS DIVISION. THE RADIO COMMUNICATIONS CARRIER MUST BE FAMILIAR AND CONVERSANT WITH THE POLICE AND RADIO CONFIGURATION. IF THE SITE SURVEY INDICATES IT IS NECESSARY TO INSTALL A SIGNAL REPEATER EITHER ON OR NEAR THE PROPOSED PROJECT, THOSE COSTS SHALL BE THE RESPONSIBILITY OF THE PROPERTY OWNER. THE OWNER SHALL COORDINATE WITH THE SUPERVISOR OF RADIO COMMUNICATIONS FOR THE CITY.
- CONTRACTOR SHALL PERFORM TEST PITS TO VERIFY INVERT ELEVATIONS IN FIELD PRIOR TO CONSTRUCTION AND SHALL NOTIFY ENGINEER IF ELEVATION DIFFERS FROM PLAN.
- CONTRACTOR SHALL DISPOSE OF ASBESTOS CEMENT PIPES IN ACCORDANCE WITH ALL FEDERAL, STATE, AND LOCAL REGULATIONS SHOULD ANY BE FOUND DURING CONSTRUCTION.

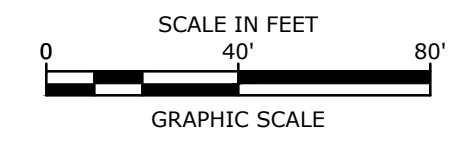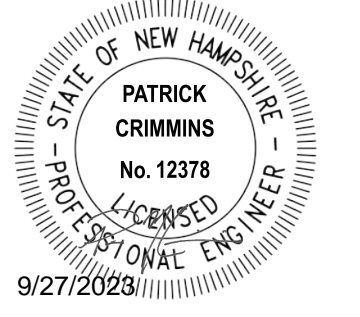

Proposed Industrial Development

Lonza Biologics

Portsmouth, New Hampshire

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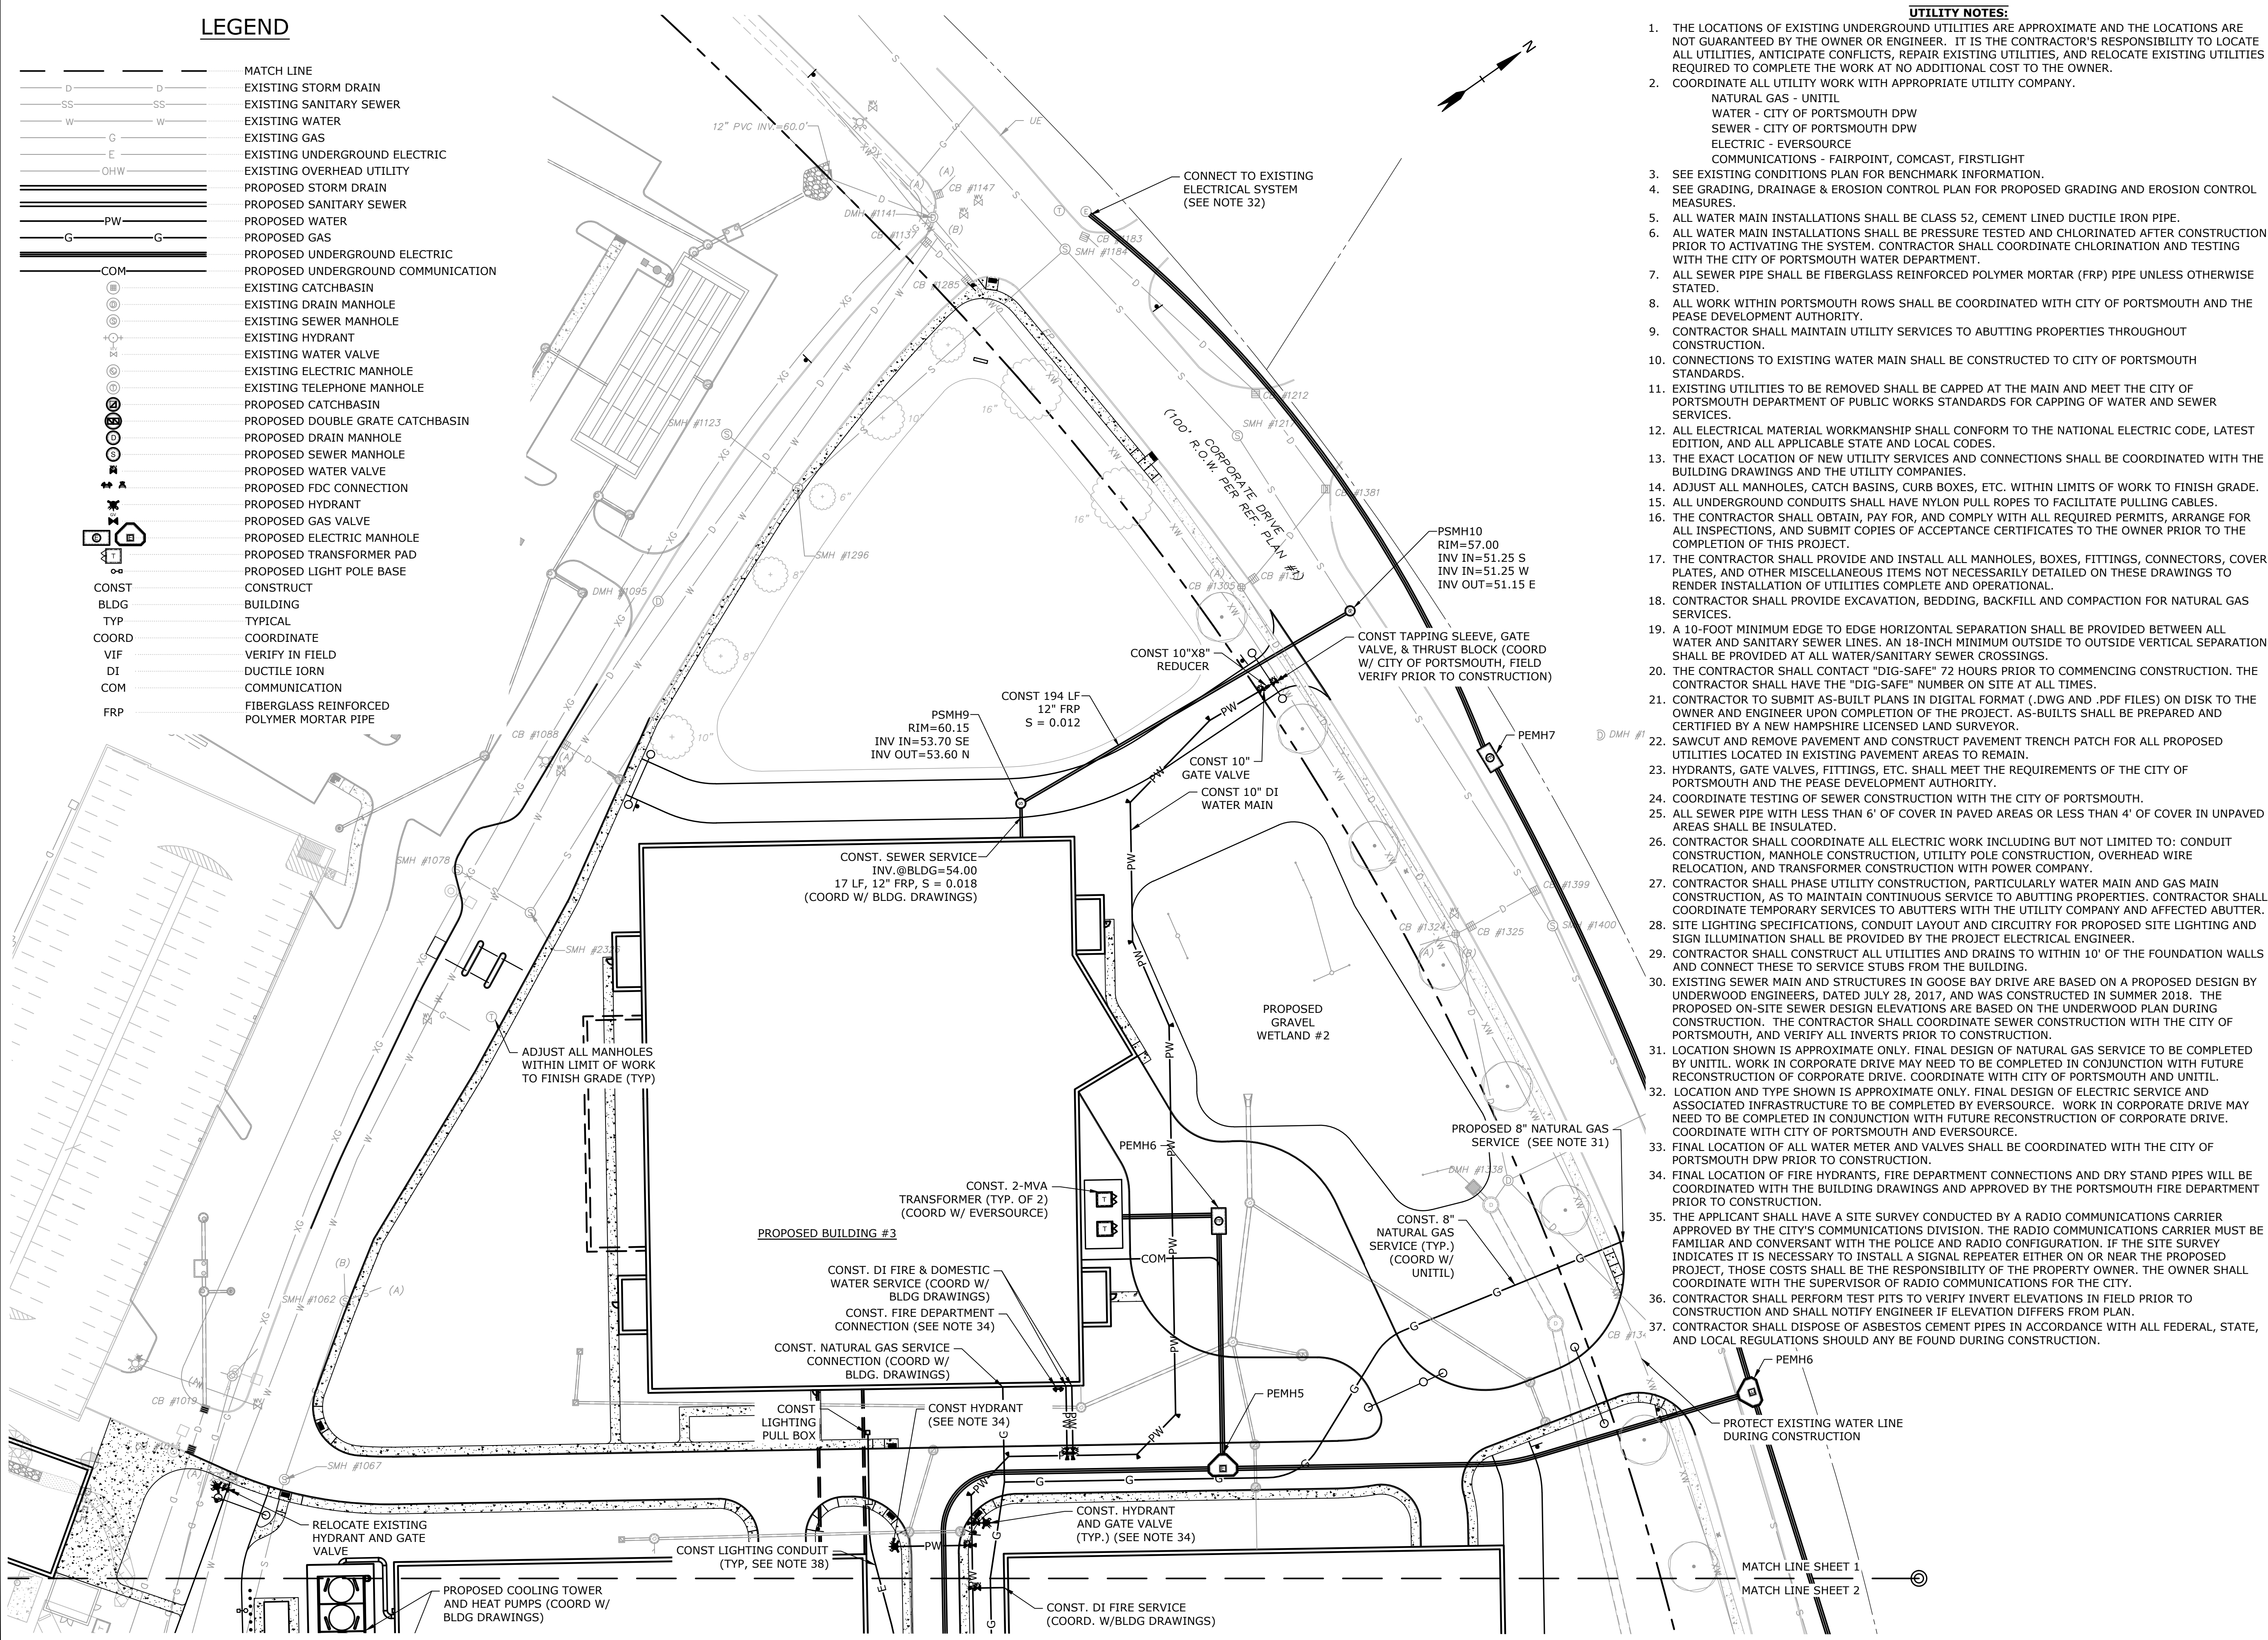
PROJECT NO:	L-0700-013
DATE:	04/03/2018
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APPROVED:	PMC






UTILITIES PLAN

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C-111

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Portsmouth, New Hampshire

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J	5/23/2022	Third Party Rev. Comments
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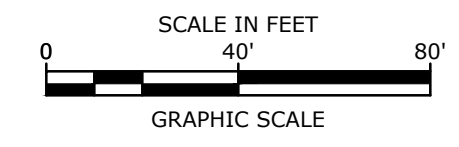
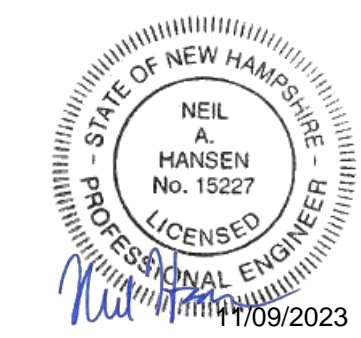
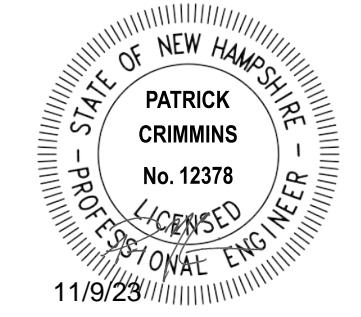
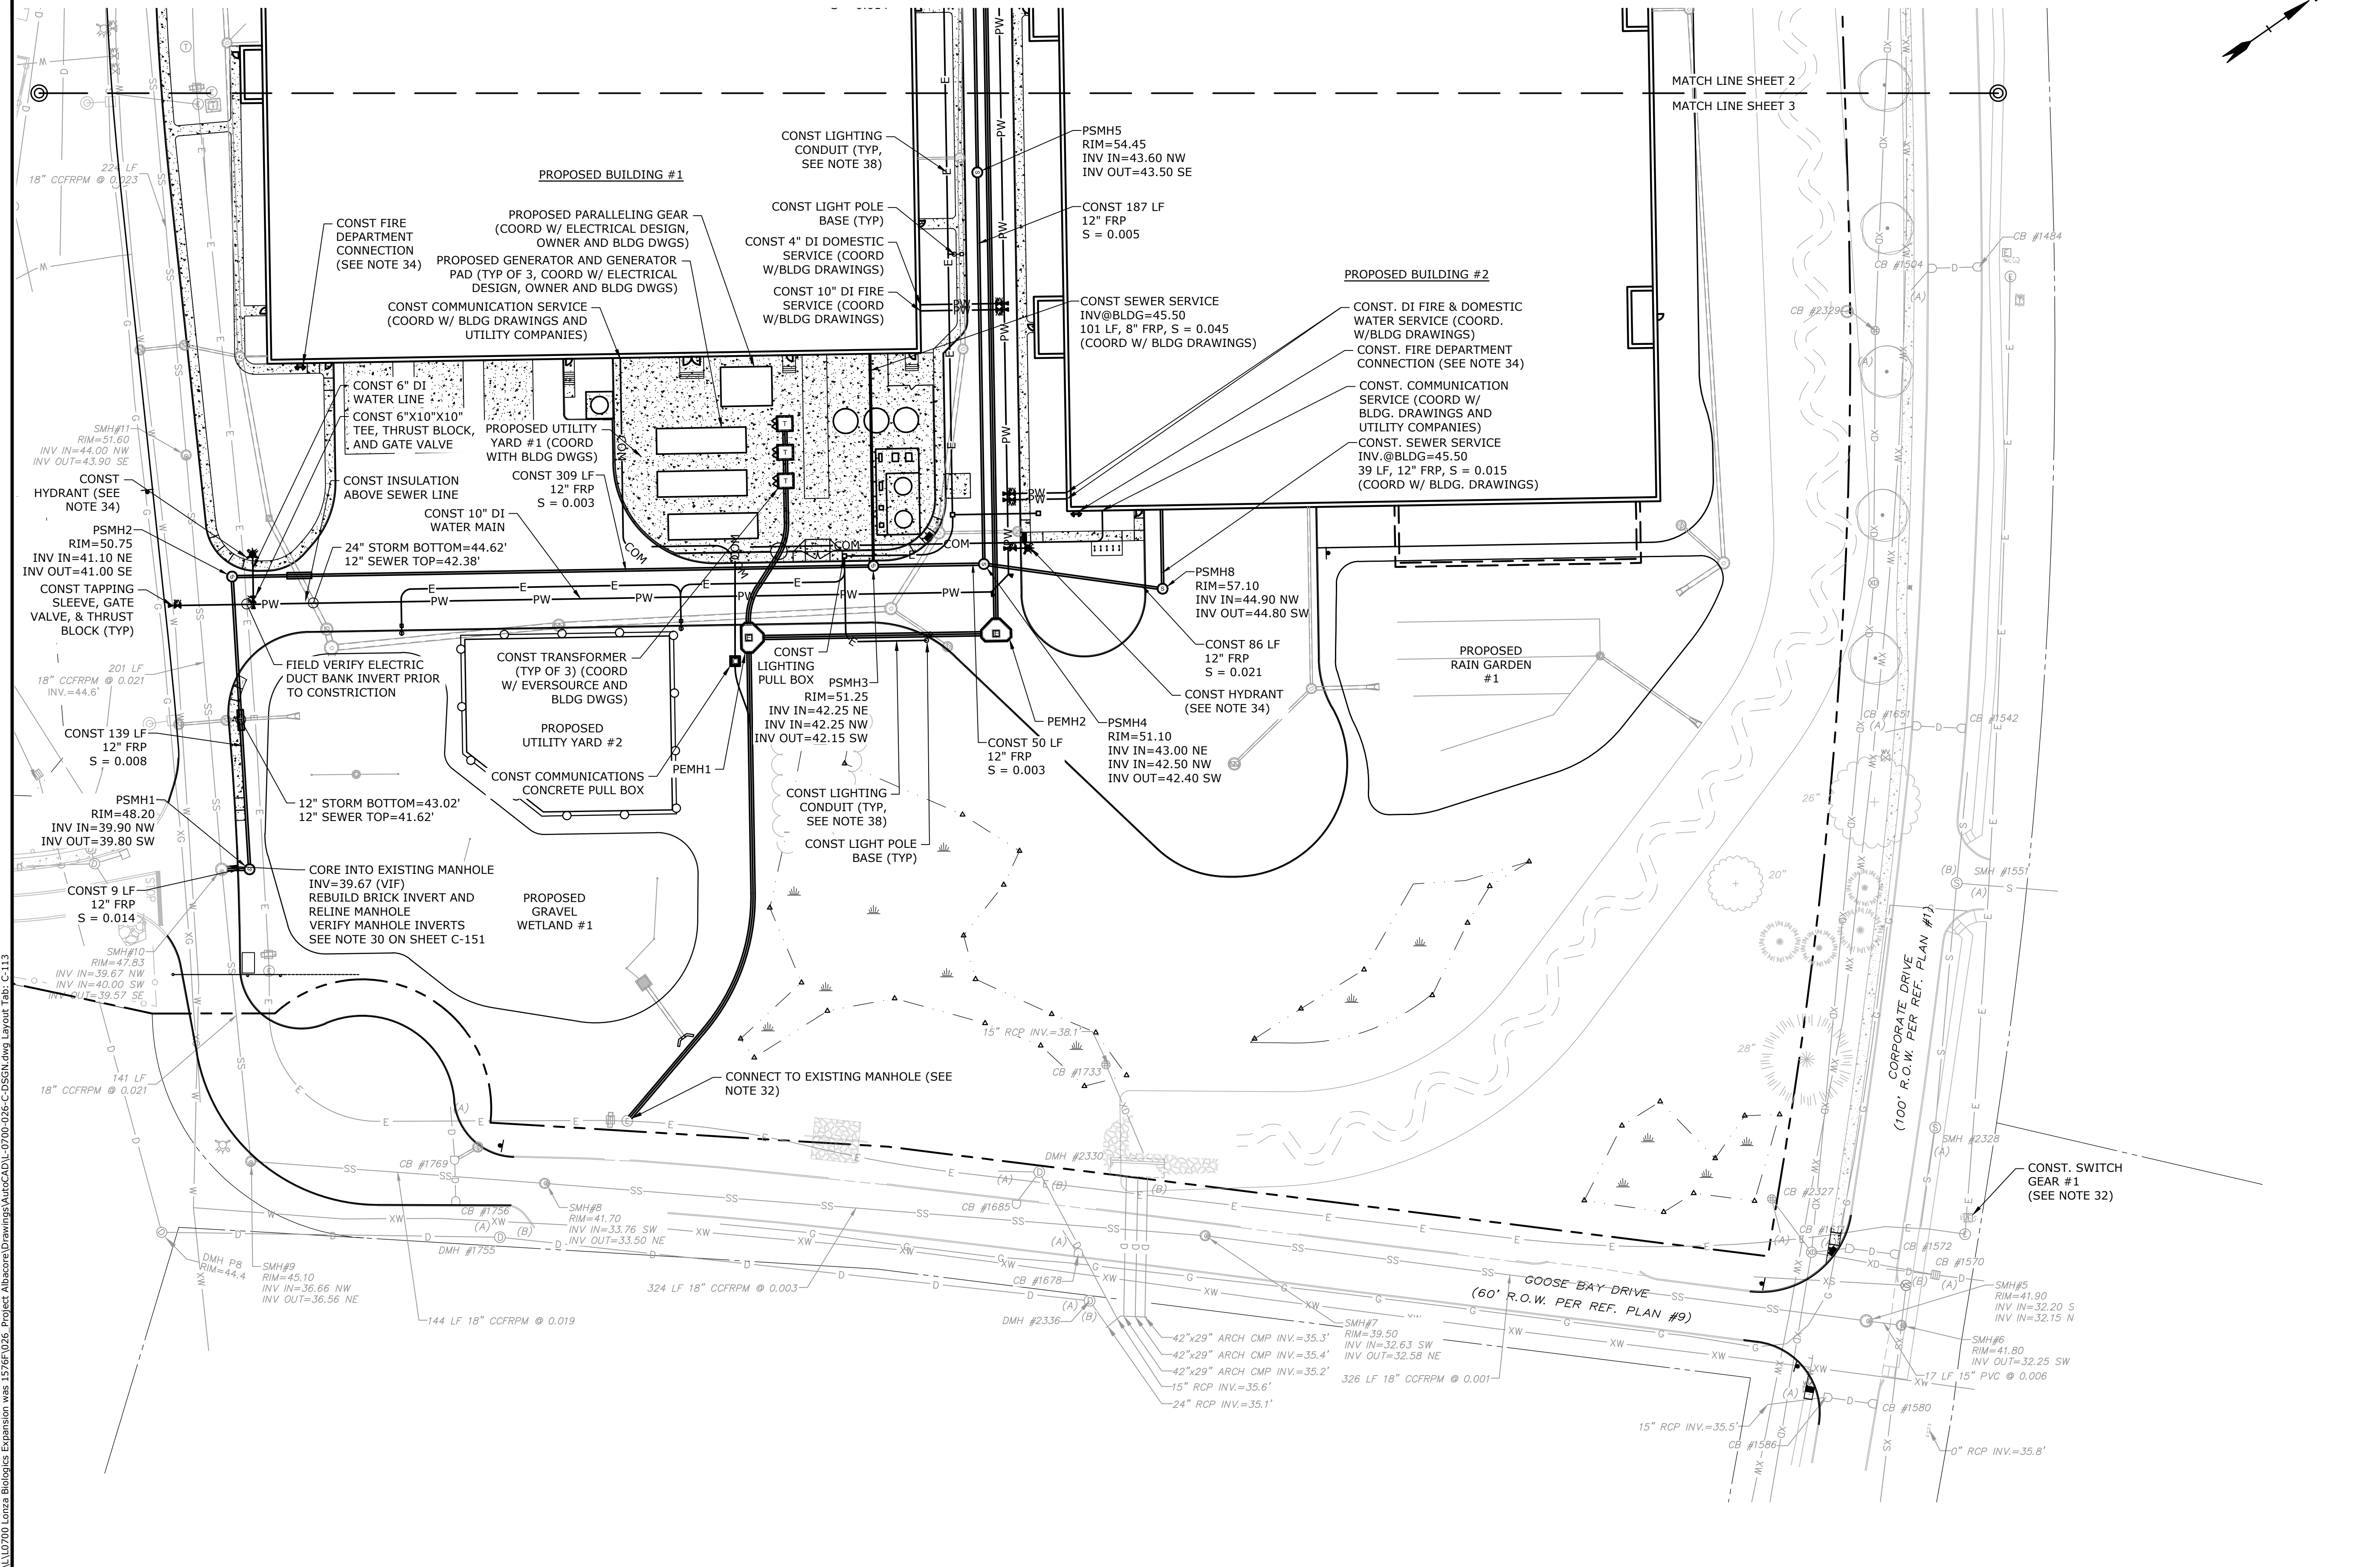
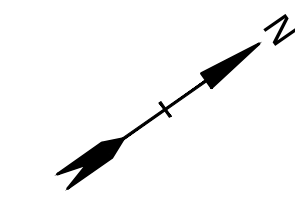
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CHECKED:	NAH
APPROVED:	PMC

UTILITIES PLAN
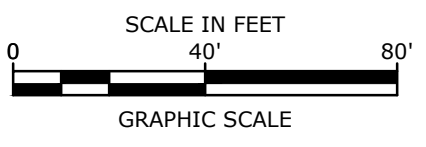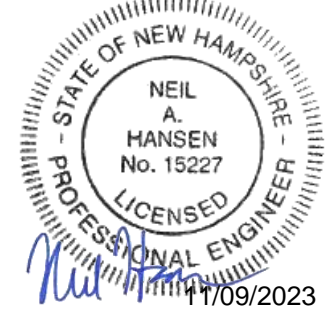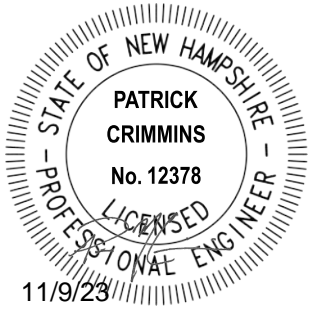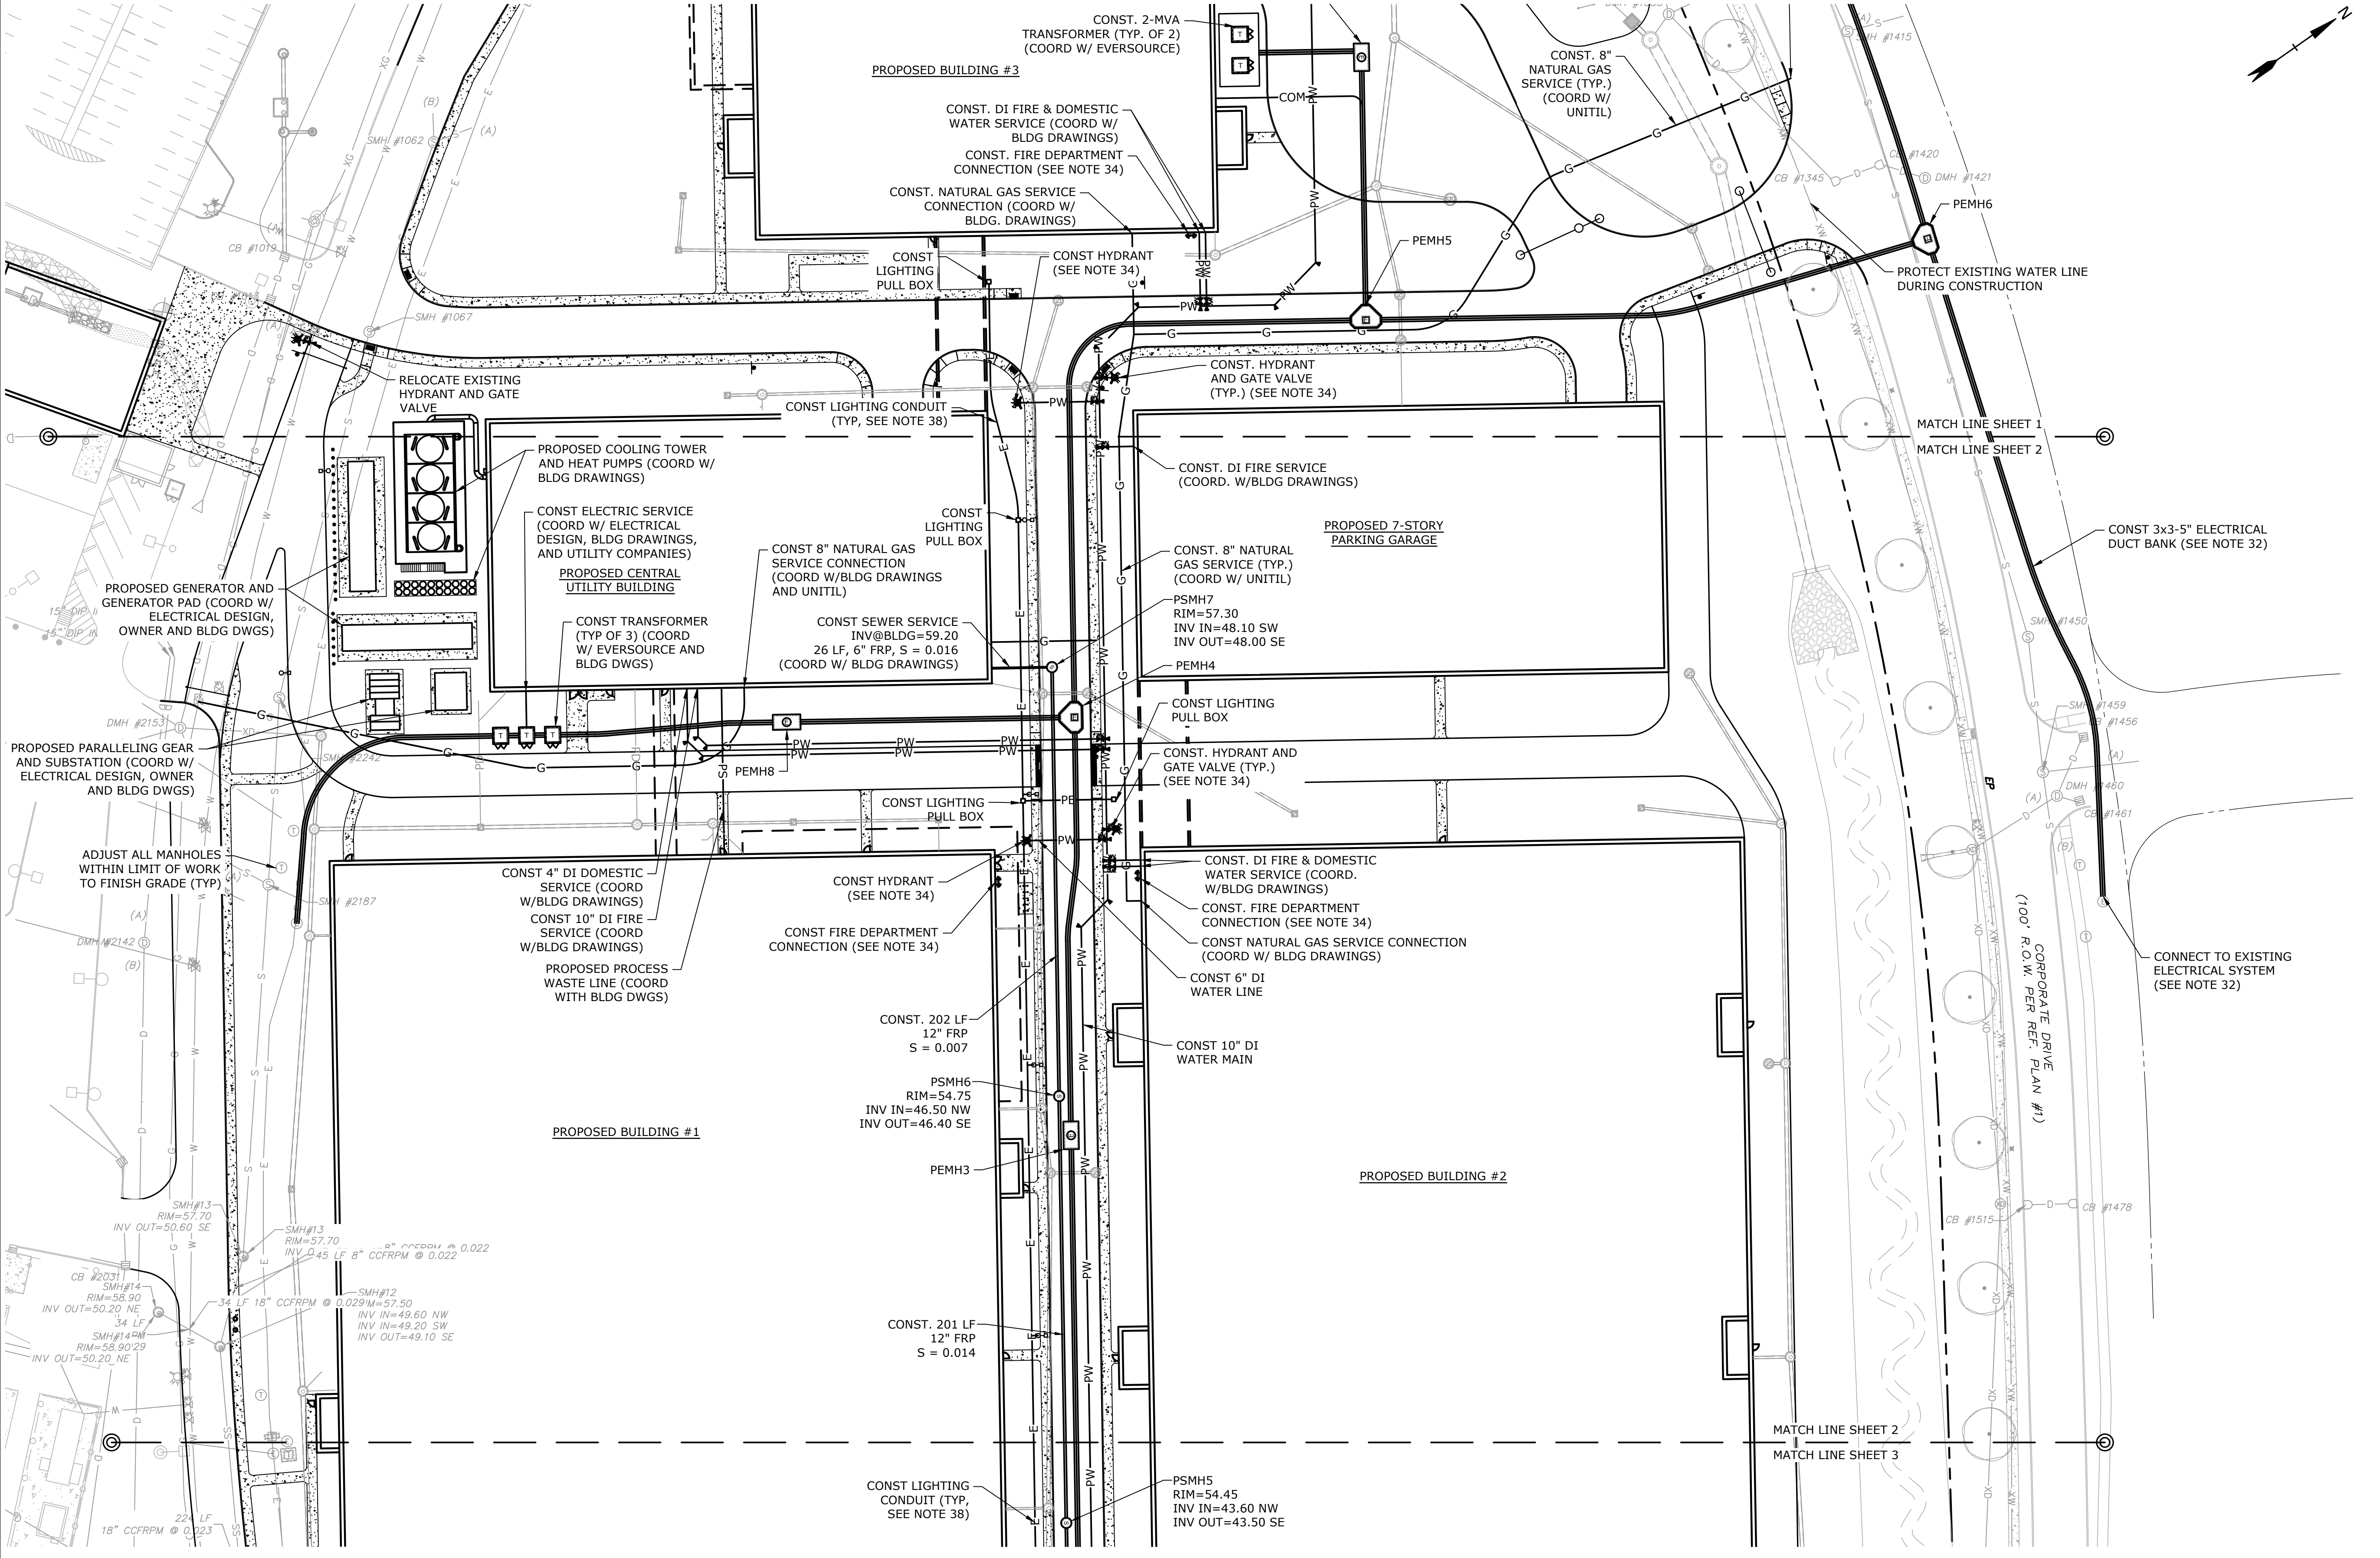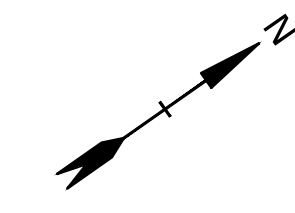
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SEE SHEET C-111 FOR UTILITY NOTES AND LEGEND



Proposed Industrial Development

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Portsmouth, New Hampshire

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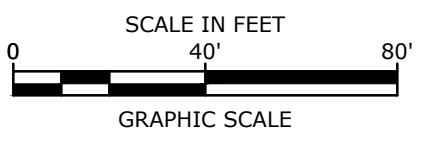
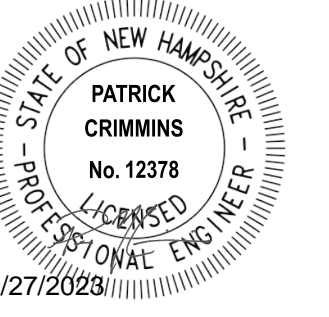
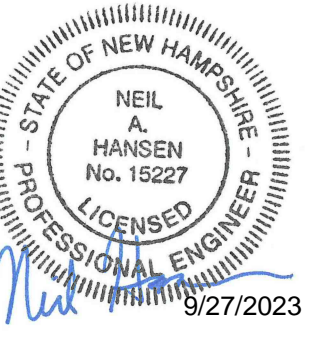
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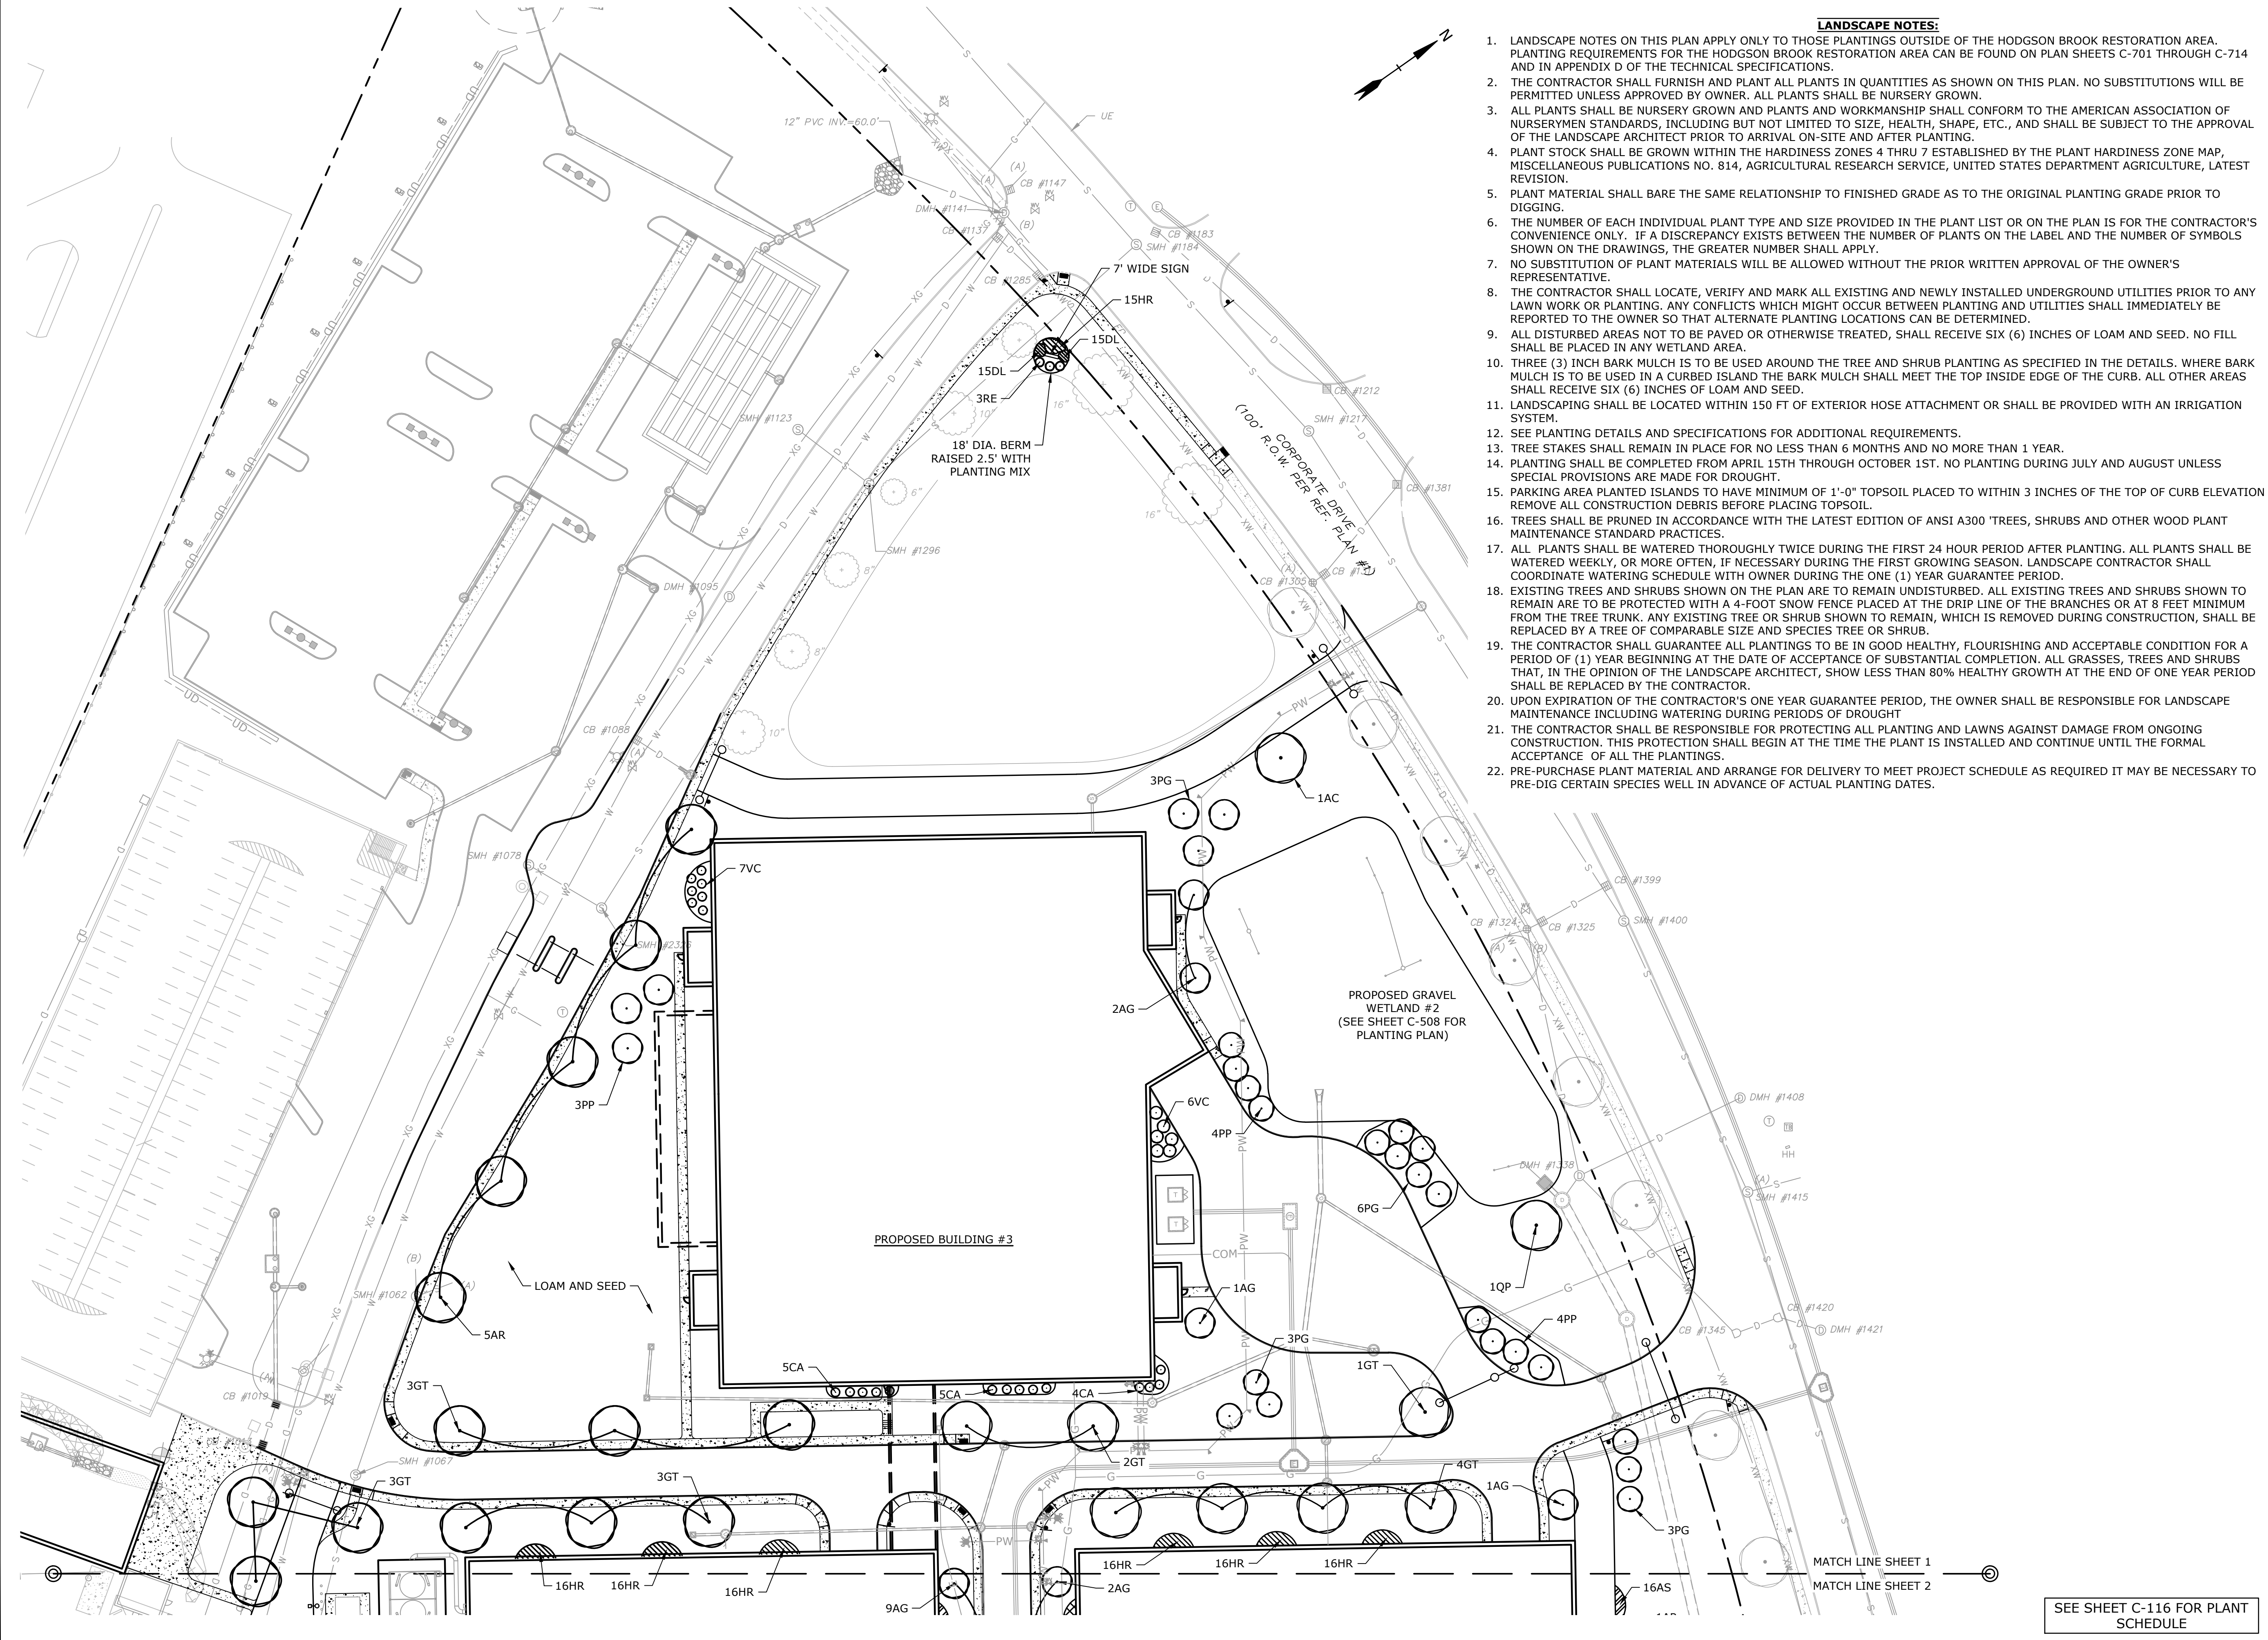
C-113

SEE SHEET C-111 FOR UTILITY NOTES AND LEGEND

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- LANDSCAPE NOTES:**
- LANDSCAPE NOTES ON THIS PLAN APPLY ONLY TO THOSE PLANTINGS OUTSIDE OF THE HODGSON BROOK RESTORATION AREA. PLANTING REQUIREMENTS FOR THE HODGSON BROOK RESTORATION AREA CAN BE FOUND ON PLAN SHEETS C-701 THROUGH C-714 AND IN APPENDIX D OF THE TECHNICAL SPECIFICATIONS.
 - THE CONTRACTOR SHALL FURNISH AND PLANT ALL PLANTS IN QUANTITIES AS SHOWN ON THIS PLAN. NO SUBSTITUTIONS WILL BE PERMITTED UNLESS APPROVED BY OWNER. ALL PLANTS SHALL BE NURSERY GROWN.
 - ALL PLANTS SHALL BE NURSERY GROWN AND PLANTS AND WORKMANSHIP SHALL CONFORM TO THE AMERICAN ASSOCIATION OF NURSERYMEN STANDARDS, INCLUDING BUT NOT LIMITED TO SIZE, HEALTH, SHAPE, ETC., AND SHALL BE SUBJECT TO THE APPROVAL OF THE LANDSCAPE ARCHITECT PRIOR TO ARRIVAL ON-SITE AND AFTER PLANTING.
 - PLANT STOCK SHALL BE GROWN WITHIN THE HARDINESS ZONES 4 THRU 7 ESTABLISHED BY THE PLANT HARDINESS ZONE MAP, MISCELLANEOUS PUBLICATIONS NO. 814, AGRICULTURAL RESEARCH SERVICE, UNITED STATES DEPARTMENT AGRICULTURE, LATEST REVISION.
 - PLANT MATERIAL SHALL BARE THE SAME RELATIONSHIP TO FINISHED GRADE AS TO THE ORIGINAL PLANTING GRADE PRIOR TO DIGGING.
 - THE NUMBER OF EACH INDIVIDUAL PLANT TYPE AND SIZE PROVIDED IN THE PLANT LIST OR ON THE PLAN IS FOR THE CONTRACTOR'S CONVENIENCE ONLY. IF A DISCREPANCY EXISTS BETWEEN THE NUMBER OF PLANTS ON THE LABEL AND THE NUMBER OF SYMBOLS SHOWN ON THE DRAWINGS, THE GREATER NUMBER SHALL APPLY.
 - NO SUBSTITUTION OF PLANT MATERIALS WILL BE ALLOWED WITHOUT THE PRIOR WRITTEN APPROVAL OF THE OWNER'S REPRESENTATIVE.
 - THE CONTRACTOR SHALL LOCATE, VERIFY AND MARK ALL EXISTING AND NEWLY INSTALLED UNDERGROUND UTILITIES PRIOR TO ANY LAWN WORK OR PLANTING. ANY CONFLICTS WHICH MIGHT OCCUR BETWEEN PLANTING AND UTILITIES SHALL IMMEDIATELY BE REPORTED TO THE OWNER SO THAT ALTERNATE PLANTING LOCATIONS CAN BE DETERMINED.
 - ALL DISTURBED AREAS NOT TO BE PAVED OR OTHERWISE TREATED, SHALL RECEIVE SIX (6) INCHES OF LOAM AND SEED. NO FILL SHALL BE PLACED IN ANY WETLAND AREA.
 - THREE (3) INCH BARK MULCH IS TO BE USED AROUND THE TREE AND SHRUB PLANTING AS SPECIFIED IN THE DETAILS. WHERE BARK MULCH IS TO BE USED IN A CURBED ISLAND THE BARK MULCH SHALL MEET THE TOP INSIDE EDGE OF THE CURB. ALL OTHER AREAS SHALL RECEIVE SIX (6) INCHES OF LOAM AND SEED.
 - LANDSCAPING SHALL BE LOCATED WITHIN 150 FT OF EXTERIOR HOSE ATTACHMENT OR SHALL BE PROVIDED WITH AN IRRIGATION SYSTEM.
 - SEE PLANTING DETAILS AND SPECIFICATIONS FOR ADDITIONAL REQUIREMENTS.
 - TREE STAKES SHALL REMAIN IN PLACE FOR NO LESS THAN 6 MONTHS AND NO MORE THAN 1 YEAR.
 - PLANTING SHALL BE COMPLETED FROM APRIL 15TH THROUGH OCTOBER 1ST. NO PLANTING DURING JULY AND AUGUST UNLESS SPECIAL PROVISIONS ARE MADE FOR DROUGHT.
 - PARKING AREA PLANTED ISLANDS TO HAVE MINIMUM OF 1'-0" TOPSOIL PLACED TO WITHIN 3 INCHES OF THE TOP OF CURB ELEVATION REMOVE ALL CONSTRUCTION DEBRIS BEFORE PLACING TOPSOIL.
 - TREES SHALL BE PRUNED IN ACCORDANCE WITH THE LATEST EDITION OF ANSI A300 'TREES, SHRUBS AND OTHER WOOD PLANT MAINTENANCE STANDARD PRACTICES.
 - ALL PLANTS SHALL BE WATERED THOROUGHLY TWICE DURING THE FIRST 24 HOUR PERIOD AFTER PLANTING. ALL PLANTS SHALL BE WATERED WEEKLY, OR MORE OFTEN, IF NECESSARY DURING THE FIRST GROWING SEASON. LANDSCAPE CONTRACTOR SHALL COORDINATE WATERING SCHEDULE WITH OWNER DURING THE ONE (1) YEAR GUARANTEE PERIOD.
 - EXISTING TREES AND SHRUBS SHOWN ON THE PLAN ARE TO REMAIN UNDISTURBED. ALL EXISTING TREES AND SHRUBS SHOWN TO REMAIN ARE TO BE PROTECTED WITH A 4-FOOT SNOW FENCE PLACED AT THE DRIP LINE OF THE BRANCHES OR AT 8 FEET MINIMUM FROM THE TREE TRUNK. ANY EXISTING TREE OR SHRUB SHOWN TO REMAIN, WHICH IS REMOVED DURING CONSTRUCTION, SHALL BE REPLACED BY A TREE OF COMPARABLE SIZE AND SPECIES TREE OR SHRUB.
 - THE CONTRACTOR SHALL GUARANTEE ALL PLANTINGS TO BE IN GOOD HEALTHY, FLOURISHING AND ACCEPTABLE CONDITION FOR A PERIOD OF (1) YEAR BEGINNING AT THE DATE OF ACCEPTANCE OF SUBSTANTIAL COMPLETION. ALL GRASSES, TREES AND SHRUBS THAT, IN THE OPINION OF THE LANDSCAPE ARCHITECT, SHOW LESS THAN 80% HEALTHY GROWTH AT THE END OF ONE YEAR PERIOD SHALL BE REPLACED BY THE CONTRACTOR.
 - UPON EXPIRATION OF THE CONTRACTOR'S ONE YEAR GUARANTEE PERIOD, THE OWNER SHALL BE RESPONSIBLE FOR LANDSCAPE MAINTENANCE INCLUDING WATERING DURING PERIODS OF DROUGHT.
 - THE CONTRACTOR SHALL BE RESPONSIBLE FOR PROTECTING ALL PLANTING AND LAWNS AGAINST DAMAGE FROM ONGOING CONSTRUCTION. THIS PROTECTION SHALL BEGIN AT THE TIME THE PLANT IS INSTALLED AND CONTINUE UNTIL THE FORMAL ACCEPTANCE OF ALL THE PLANTINGS.
 - PRE-PURCHASE PLANT MATERIAL AND ARRANGE FOR DELIVERY TO MEET PROJECT SCHEDULE AS REQUIRED IT MAY BE NECESSARY TO PRE-DIG CERTAIN SPECIES WELL IN ADVANCE OF ACTUAL PLANTING DATES.



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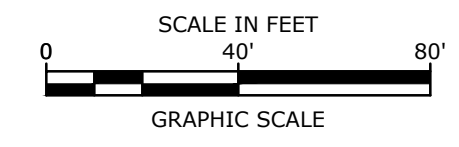
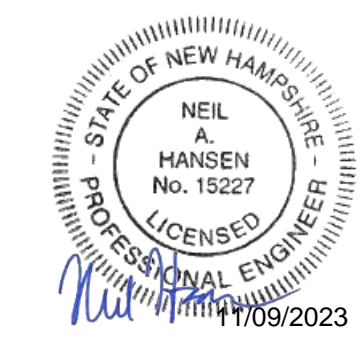
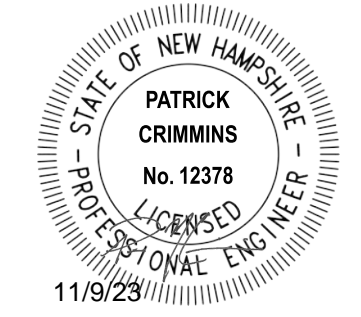
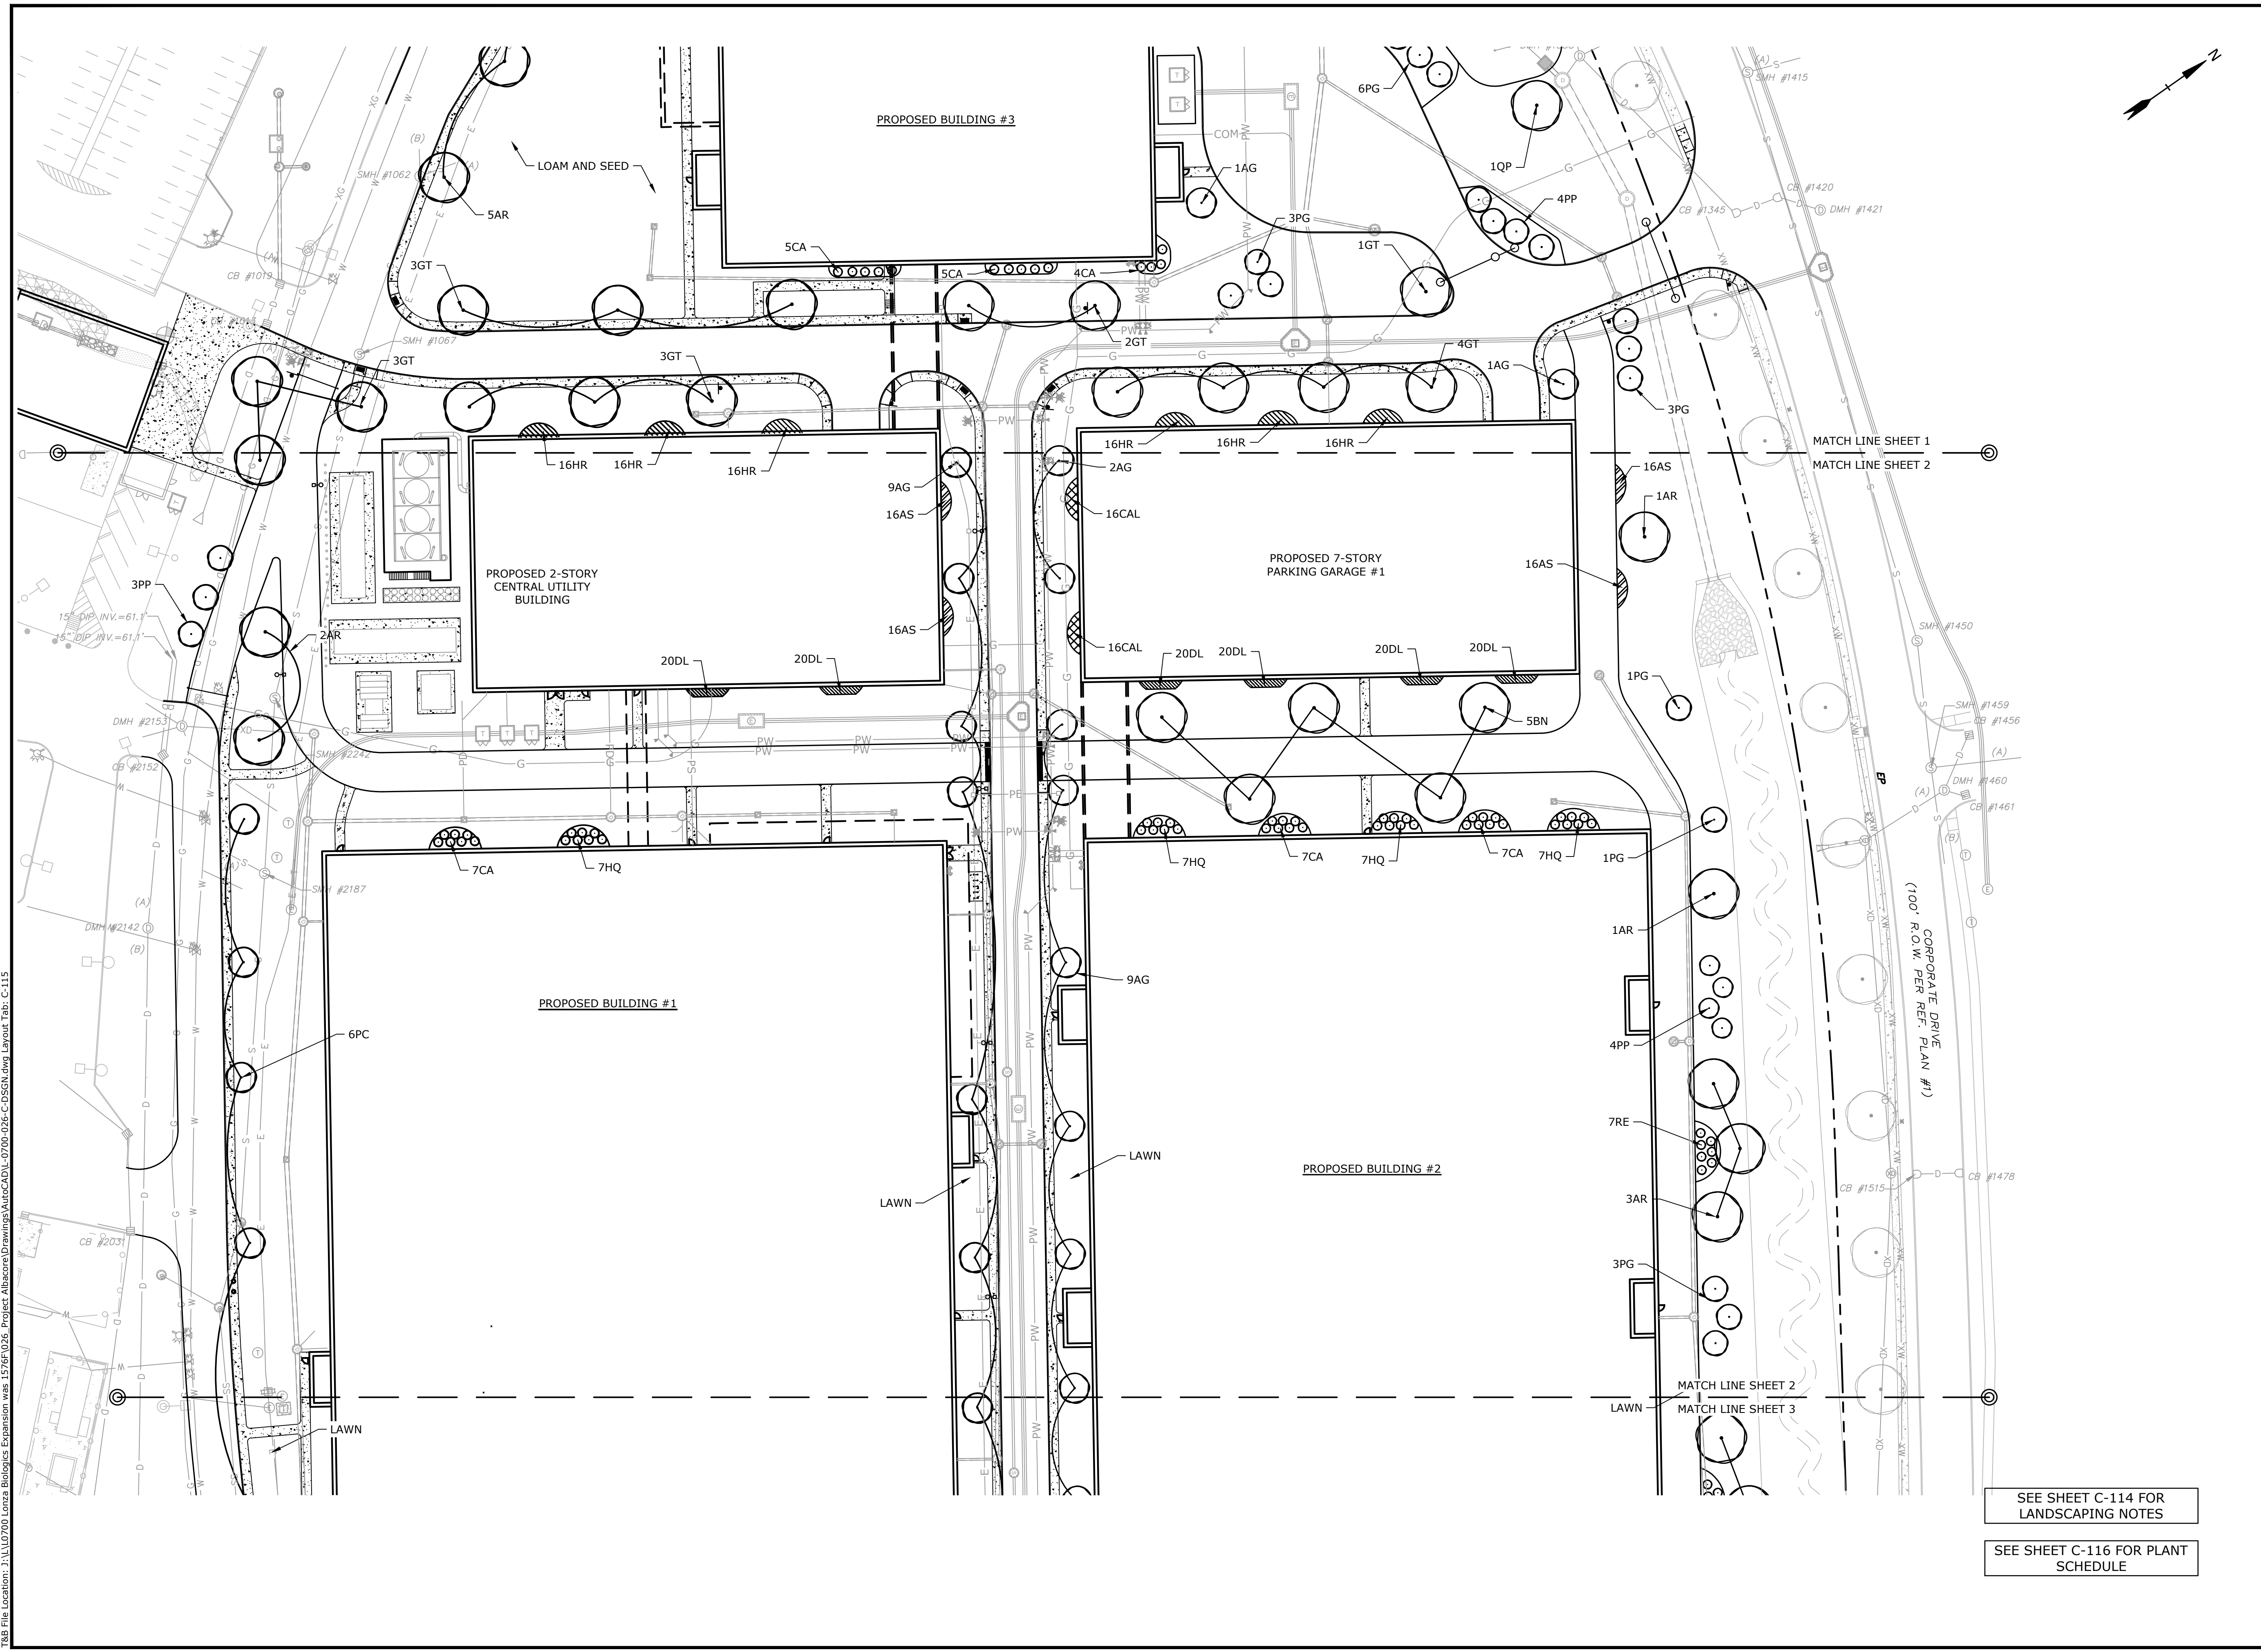
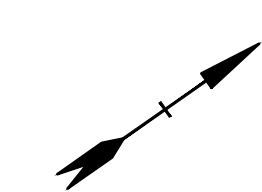
LANDSCAPE PLAN

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C-114

SEE SHEET C-116 FOR PLANT SCHEDULE

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Proposed Industrial Development

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LANDSCAPE PLAN



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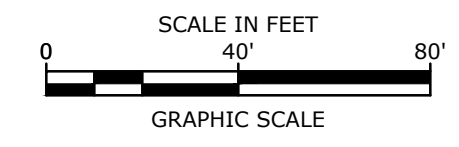
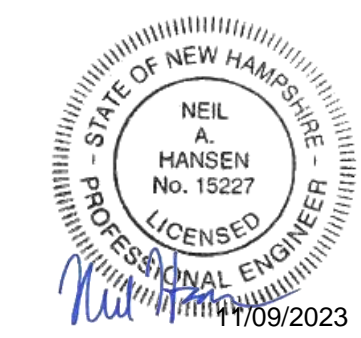
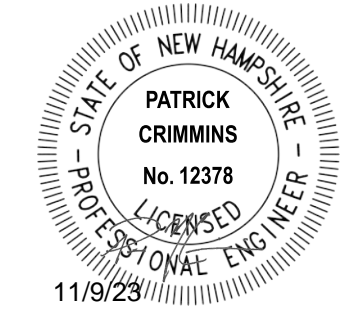
SEE SHEET C-114 FOR LANDSCAPING NOTES

SEE SHEET C-116 FOR PLANT SCHEDULE

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SEE SHEET C-114 FOR LANDSCAPING NOTES



Proposed Industrial Development
Lonza Biologics

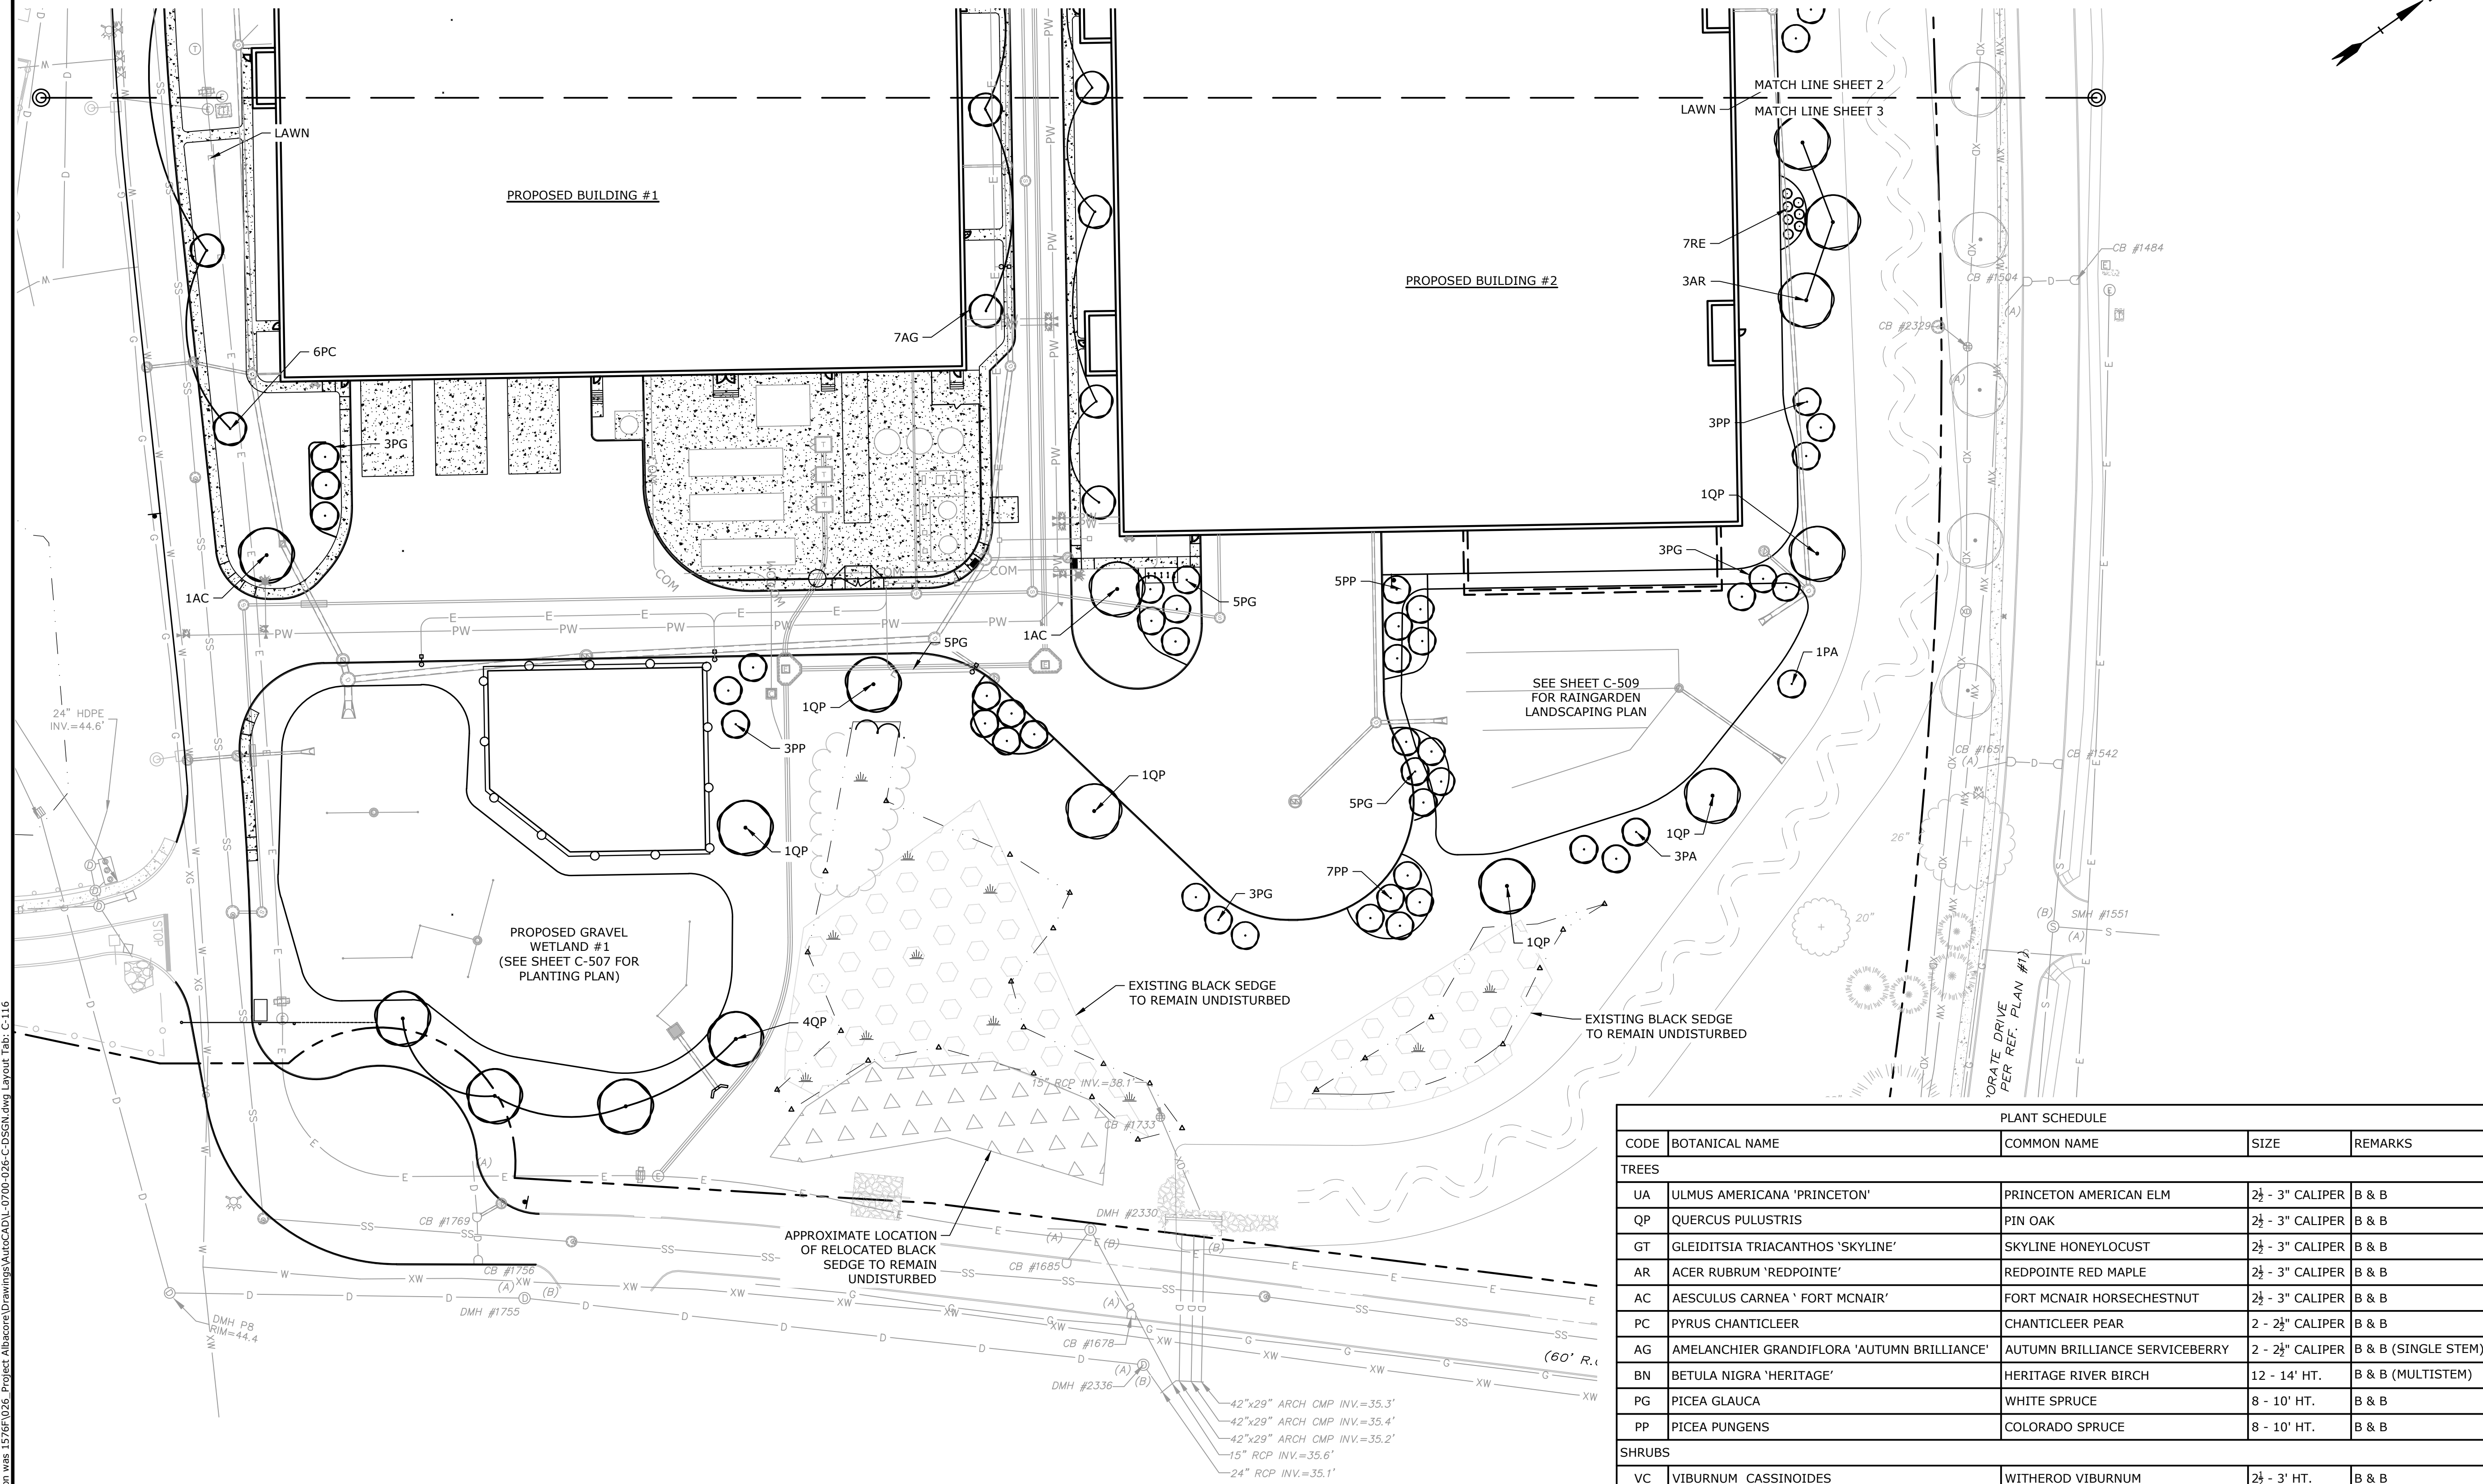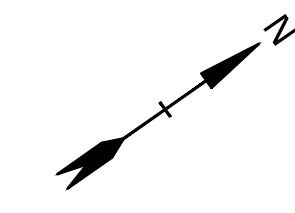Portsmouth, New Hampshire

PLANT SCHEDULE				
CODE	BOTANICAL NAME	COMMON NAME	SIZE	REMARKS
TREES				
UA	ULMUS AMERICANA 'PRINCETON'	PRINCETON AMERICAN ELM	2½ - 3" CALIPER	B & B
QP	QUERCUS PULSTRIS	PIN OAK	2½ - 3" CALIPER	B & B
GT	GLEIDITSIA TRIACANTHOS 'SKYLINE'	SKYLINE HONEYLOCUST	2½ - 3" CALIPER	B & B
AR	ACER RUBRUM 'REDPOINTE'	REDPOINTE RED MAPLE	2½ - 3" CALIPER	B & B
AC	AESCULUS CARNEA 'FORT MCNAIR'	FORT MCNAIR HORSECHESTNUT	2½ - 3" CALIPER	B & B
PC	PYRUS CHANTICLEER	CHANTICLEER PEAR	2 - 2½" CALIPER	B & B
AG	AMELANCHIER GRANDIFLORA 'AUTUMN BRILLIANCE'	AUTUMN BRILLIANCE SERVICEBERRY	2 - 2½" CALIPER	B & B (SINGLE STEM)
BN	BETULA NIGRA 'HERITAGE'	HERITAGE RIVER BIRCH	12 - 14' HT.	B & B (MULTISTEM)
PG	PICEA GLAUCA	WHITE SPRUCE	8 - 10' HT.	B & B
PP	PICEA PUNGENS	COLORADO SPRUCE	8 - 10' HT.	B & B
SHRUBS				
VC	VIBURNUM CASSINOIDES	WITHEROD VIBURNUM	2½ - 3' HT.	B & B
RE	RHODODENDRON 'ENGLISH ROSEUM'	ENGLISH ROSEUM RHODODENDRON	2½ - 3' HT.	B & B
CA	CLETHERA ALNIFOLIA	SUMMERSWEET CLETHERA	7 GALLON	CONTAINER
HQ	HYDRANGEA QUERCIFOLIA 'SNOW QUEEN'	SNOW QUEEN OAKLEAF HYDRANGEA	2½ - 3' HT.	B & B
GROUNDCOVERS & PERENNIALS				
DL	HEMEROCALLIS 'STELLA DORO'	STELLA DORO DAYLILY	2 GALLON	CONTAINER
HR	HOSTA 'ROYAL STANDARD'	ROYAL STANDARD HOSTA	2 GALLON	CONTAINER
AS	ASTILBE 'VISIONS IN PINK'	VISIONS IN PINK ASTILBE	2 GALLON	CONTAINER
CAL	CALAMAGROSTIS 'KARL FOERSTER'	KARL FOERSTER FEATHER REED GRASS	3 GALLON	CONTAINER



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N	11/9/2023	Revised P.B. Submission
M	9/27/2023	P.B. Submission
L	9/1/2022	Issued for Construction
K	5/27/2022	Issued for Bid
J	5/23/2022	Third Party Rev. Comments
I	4/26/2022	Revised PB Stipulations

PROJECT NO: L-0700-013
 DATE: 04/03/2018
 FILE: L-0700-026-C-DSGN.dwg
 DRAWN BY: CJK
 CHECKED: NAH
 APPROVED: PMC


LANDSCAPE PLAN

SCALE: AS SHOWN

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 Plot Date: Thursday, November 09, 2023 Plotted By: Neil A. Hansen
 P&E File Location: J:\L-0700\Lonza Biologics Expansion.was 12/26/2026 Project Abstract\Drawings\AutoCAD\0700-026-C-DSGN.dwg Layout Tab: C-116

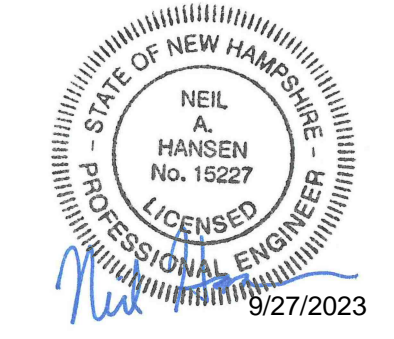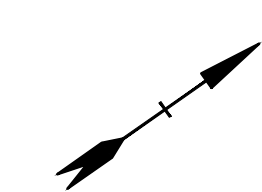

Symbol	Qty	Label	Arrangement	Description	MANUFACTURER
☐	6	S3	Single	MRM-LED-091-S1L-3-UNV-DIM-30-70CRI-CXX / 450 B3 S11G 20 S GA 48C (20' AFG)	LSI INDUSTRIES, INC.
☐	7	S4	Single	MRM-LED-091-S1L-PT-UNV-DIM-30-70CRI-CXX / 450-B3-S11G-20-S-GA-48C (20' AFG)	LSI INDUSTRIES, INC.
☐	5	S5-1	Single	MRM-LED-091-S1L-5W-UNV-DIM-30-70CRI-CXX / 450 B3 S11G 20 S GA 48C (20' AFG)	LSI INDUSTRIES, INC.
☐	7	W3	Single	XMM-3-LED-12L-30-UE-CXX / WALL MTD 20' AFG	LSI INDUSTRIES, INC.
☐	22	W4	Single	XMM-PT-LED-12L-30-UE-CXX / WALL MTD 20' AFG	LSI INDUSTRIES, INC.

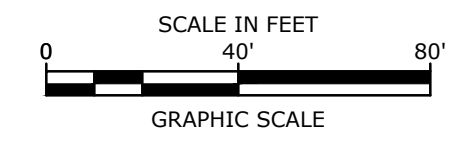

Proposed Industrial Development

Lonza Biologics

Portsmouth, New Hampshire

MARK	DATE	DESCRIPTION
M	9/27/2023	P.B. Submission
L	7/17/2023	Amended Site Plan Review
K	5/5/2023	Phase 1B Issued for Bid
J	3/15/2023	Phase 1B Issued for Preliminary Pricing
I	1/9/2023	Admin. Approval Submission
H	12/10/2021	Planning Board Stipulation
G	8/19/2019	Admin. Approval Submission
F	11/6/2018	P.B. Submission


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DATE:	04/03/2018
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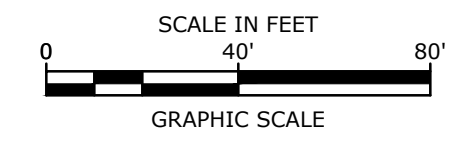
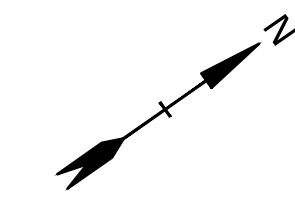
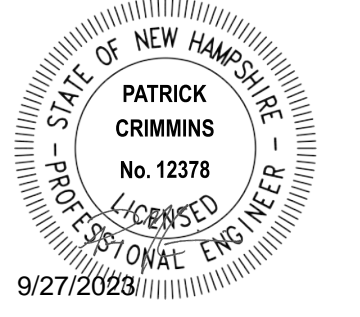
PHOTOMETRIC LIGHTING PLAN

SCALE: AS SHOWN

C-117

Last Save Date: September 27, 2023 1:36 PM By: CKRZCUIK
 Plot Date: Wednesday, September 27, 2023 Plotted By: Colter Krzucik
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Proposed Industrial Development

Lonza Biologics

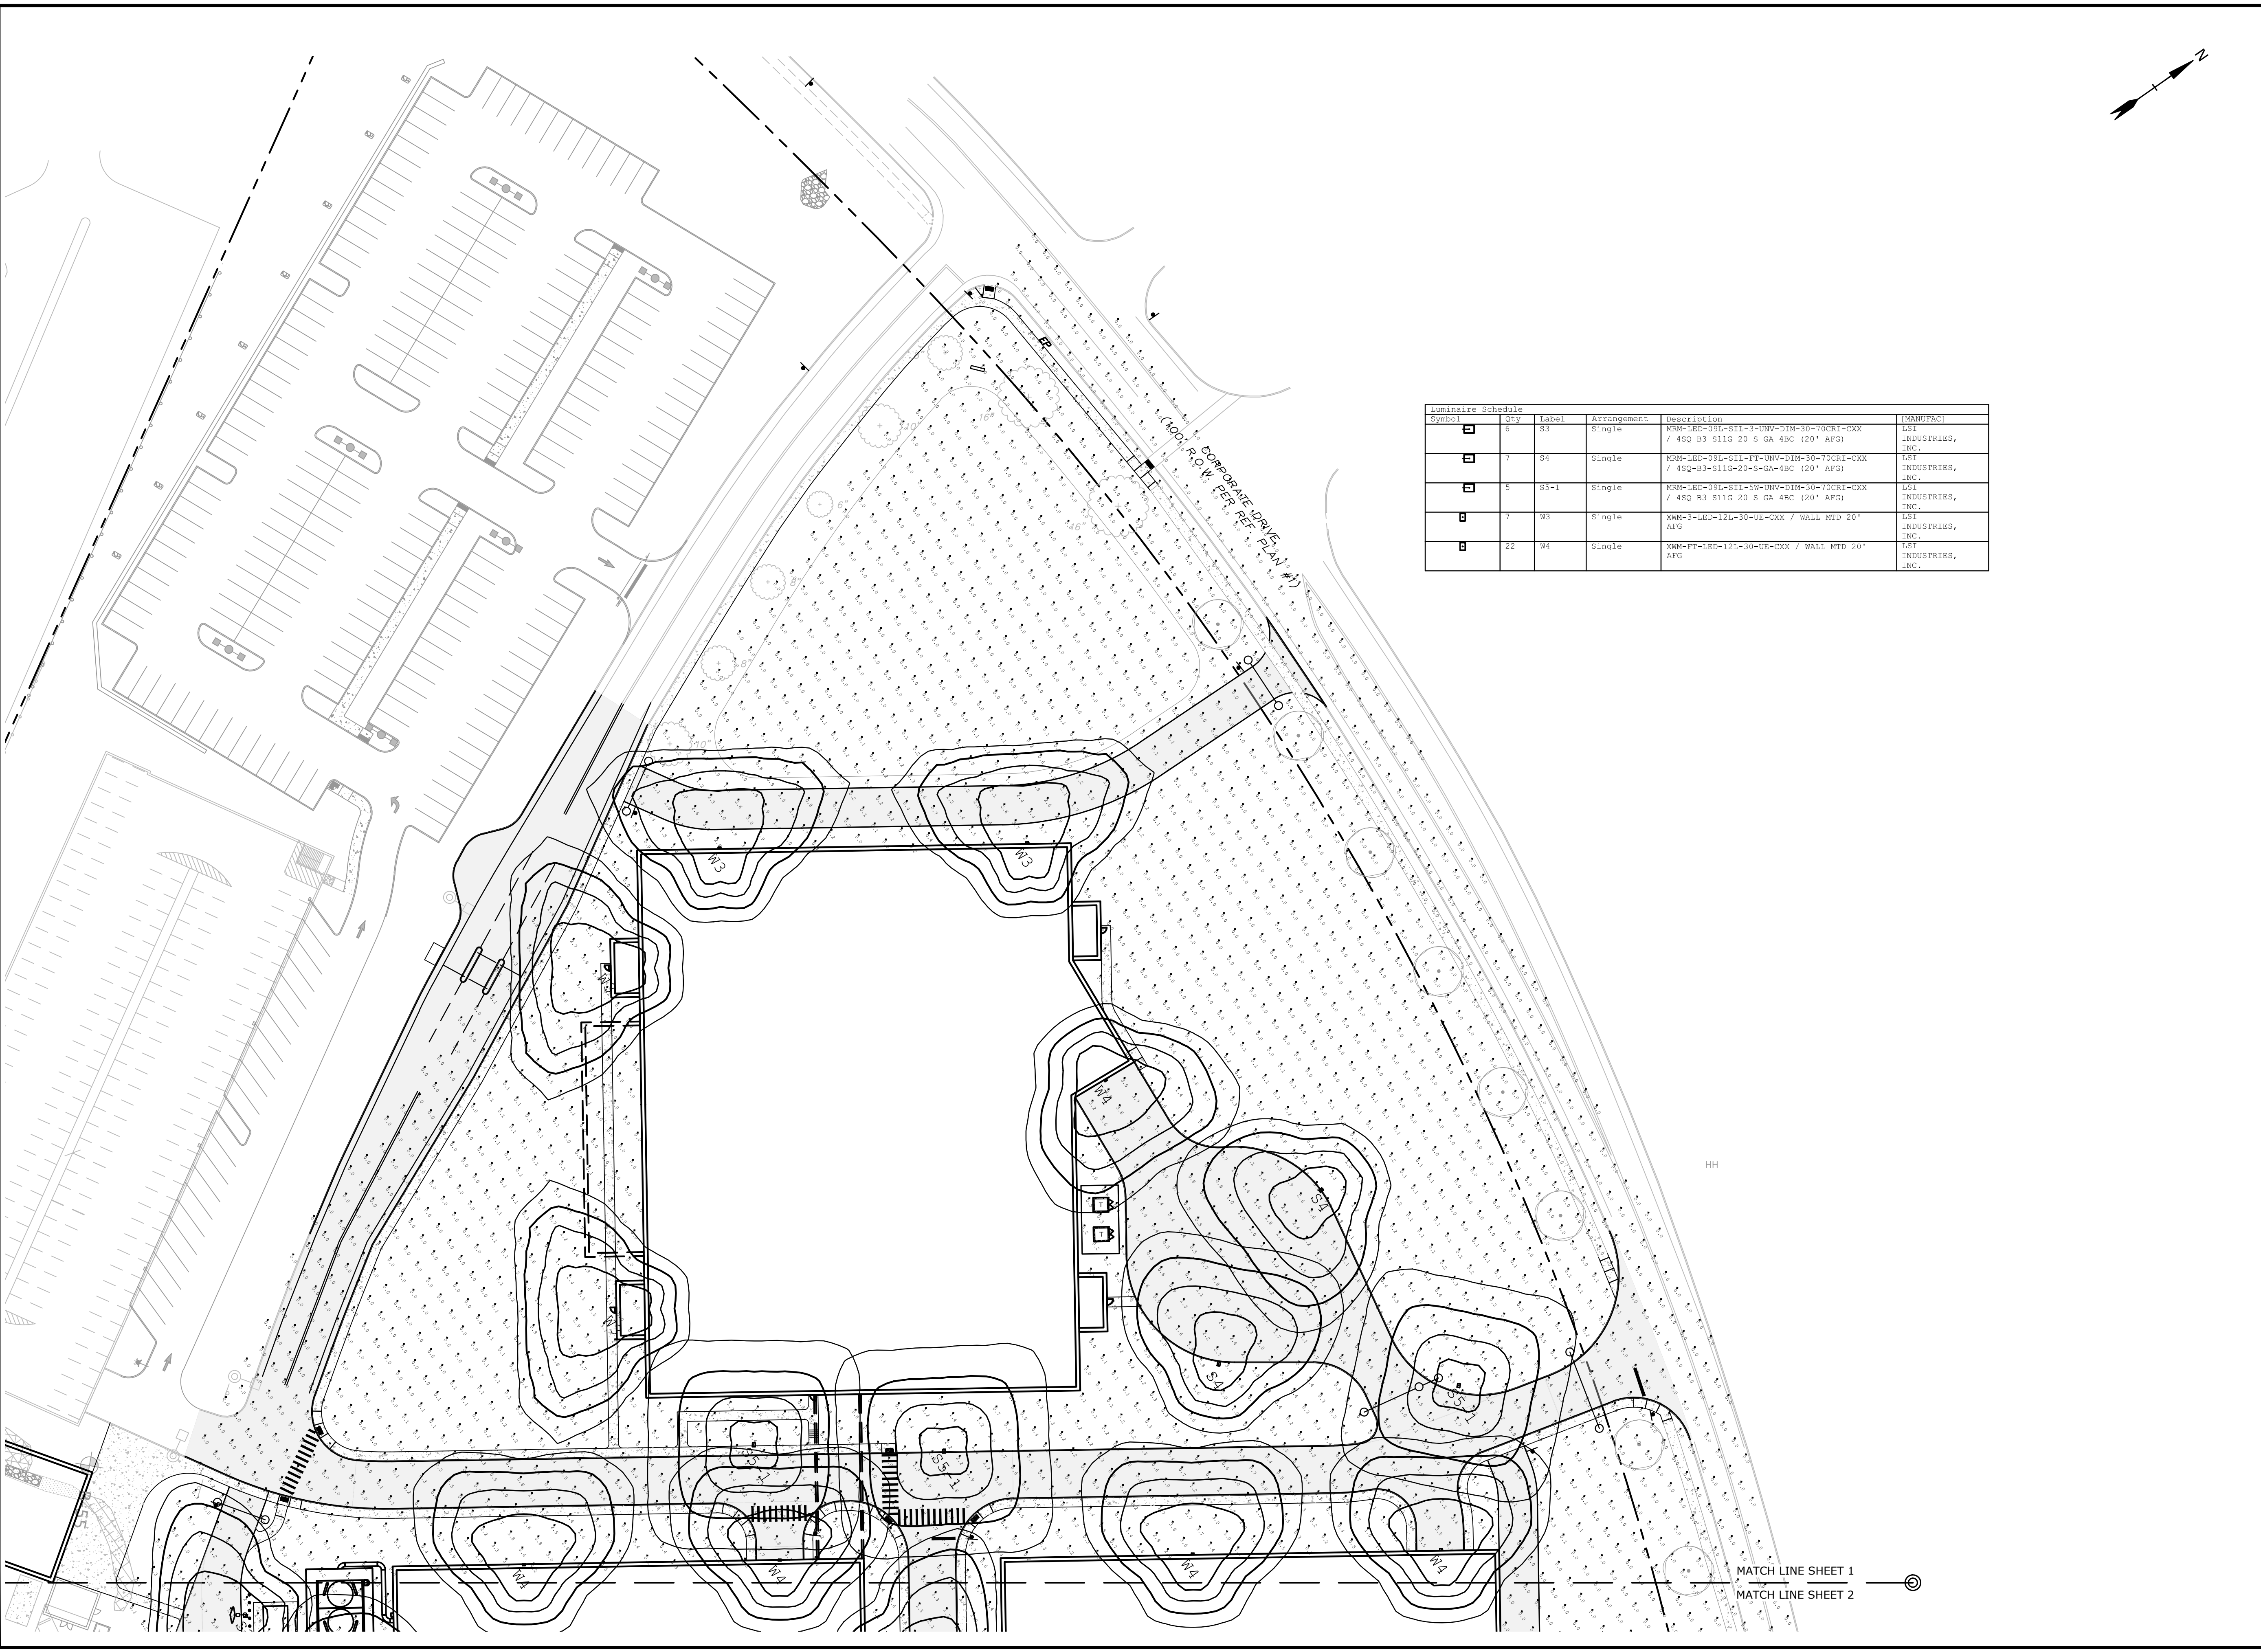Portsmouth, New Hampshire

MARK	DATE	DESCRIPTION
M	9/27/2023	P.B. Submission
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H	12/10/2021	Planning Board Stipulation
G	8/19/2019	Admin. Approval Submission
F	11/6/2018	P.B. Submission


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DATE: 04/03/2018

FILE: L-0700-026-C-DSGN.dwg
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APPROVED: PMC

PHOTOMETRIC LIGHTING PLAN






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Symbol	Qty	Label	Arrangement	Description	MANUFACT
☐	6	S3	Single	MRR-LED-09L-S11-3-UNV-DIM-30-70CRI-CXX / 450 B3 S11G 20 S GA 4BC (20' AFG)	LSI INDUSTRIES, INC.
☐	7	S4	Single	MRR-LED-09L-S11-FT-UNV-DIM-30-70CRI-CXX / 450 B3 S11G 20 S GA 4BC (20' AFG)	LSI INDUSTRIES, INC.
☐	5	SS-1	Single	MRR-LED-09L-S11-5W-UNV-DIM-30-70CRI-CXX / 450 B3 S11G 20 S GA 4BC (20' AFG)	LSI INDUSTRIES, INC.
☐	7	W3	Single	XWM-3-LED-12L-30-UE-CXX / WALL MTD 20' AFG	LSI INDUSTRIES, INC.
☐	22	W4	Single	XWM-PT-LED-12L-30-UE-CXX / WALL MTD 20' AFG	LSI INDUSTRIES, INC.

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 Plot Date: Wednesday, September 27, 2023 Plotted By: Colter Krzucik
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Proposed Industrial Development

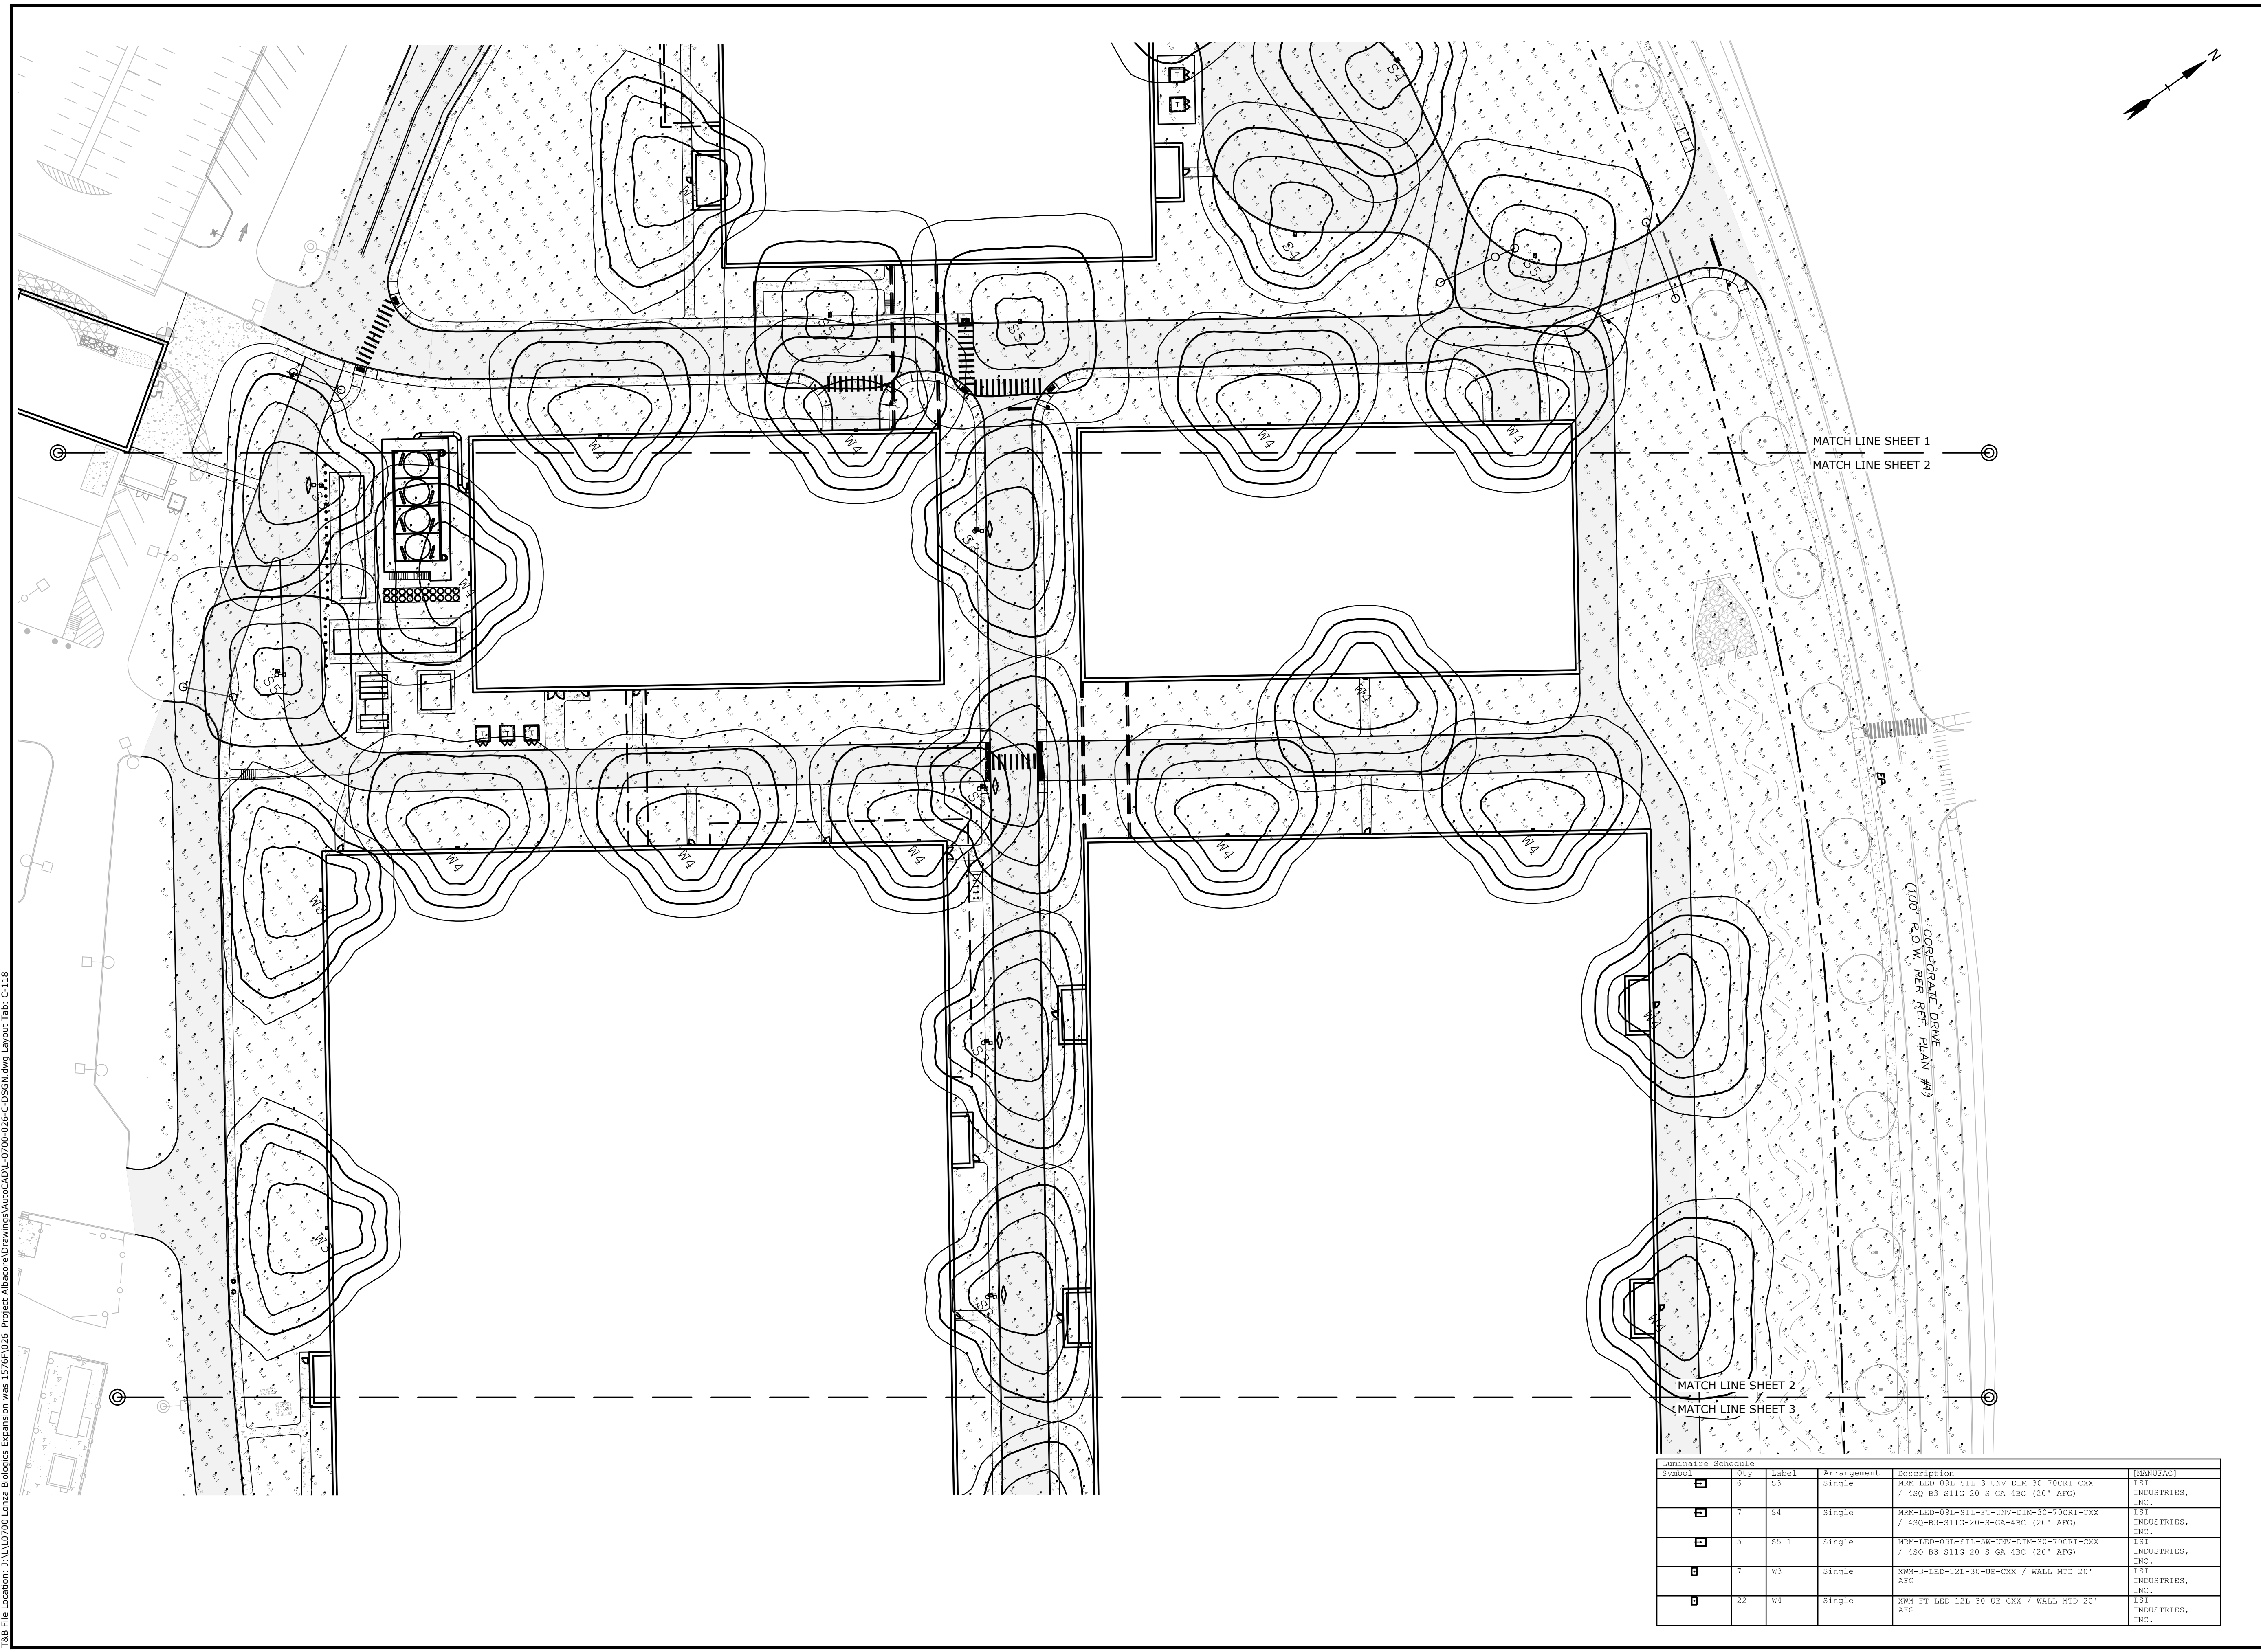Lonza Biologics

Portsmouth, New Hampshire

MARK	DATE	DESCRIPTION
M	9/27/2023	P.B. Submission
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G	8/19/2019	Admin. Approval Submission
F	11/6/2018	P.B. Submission

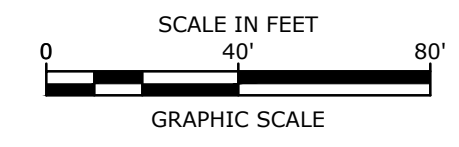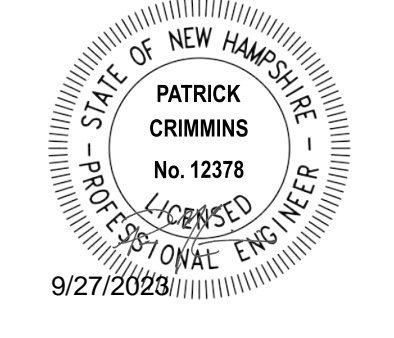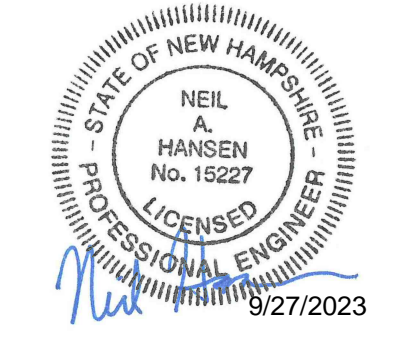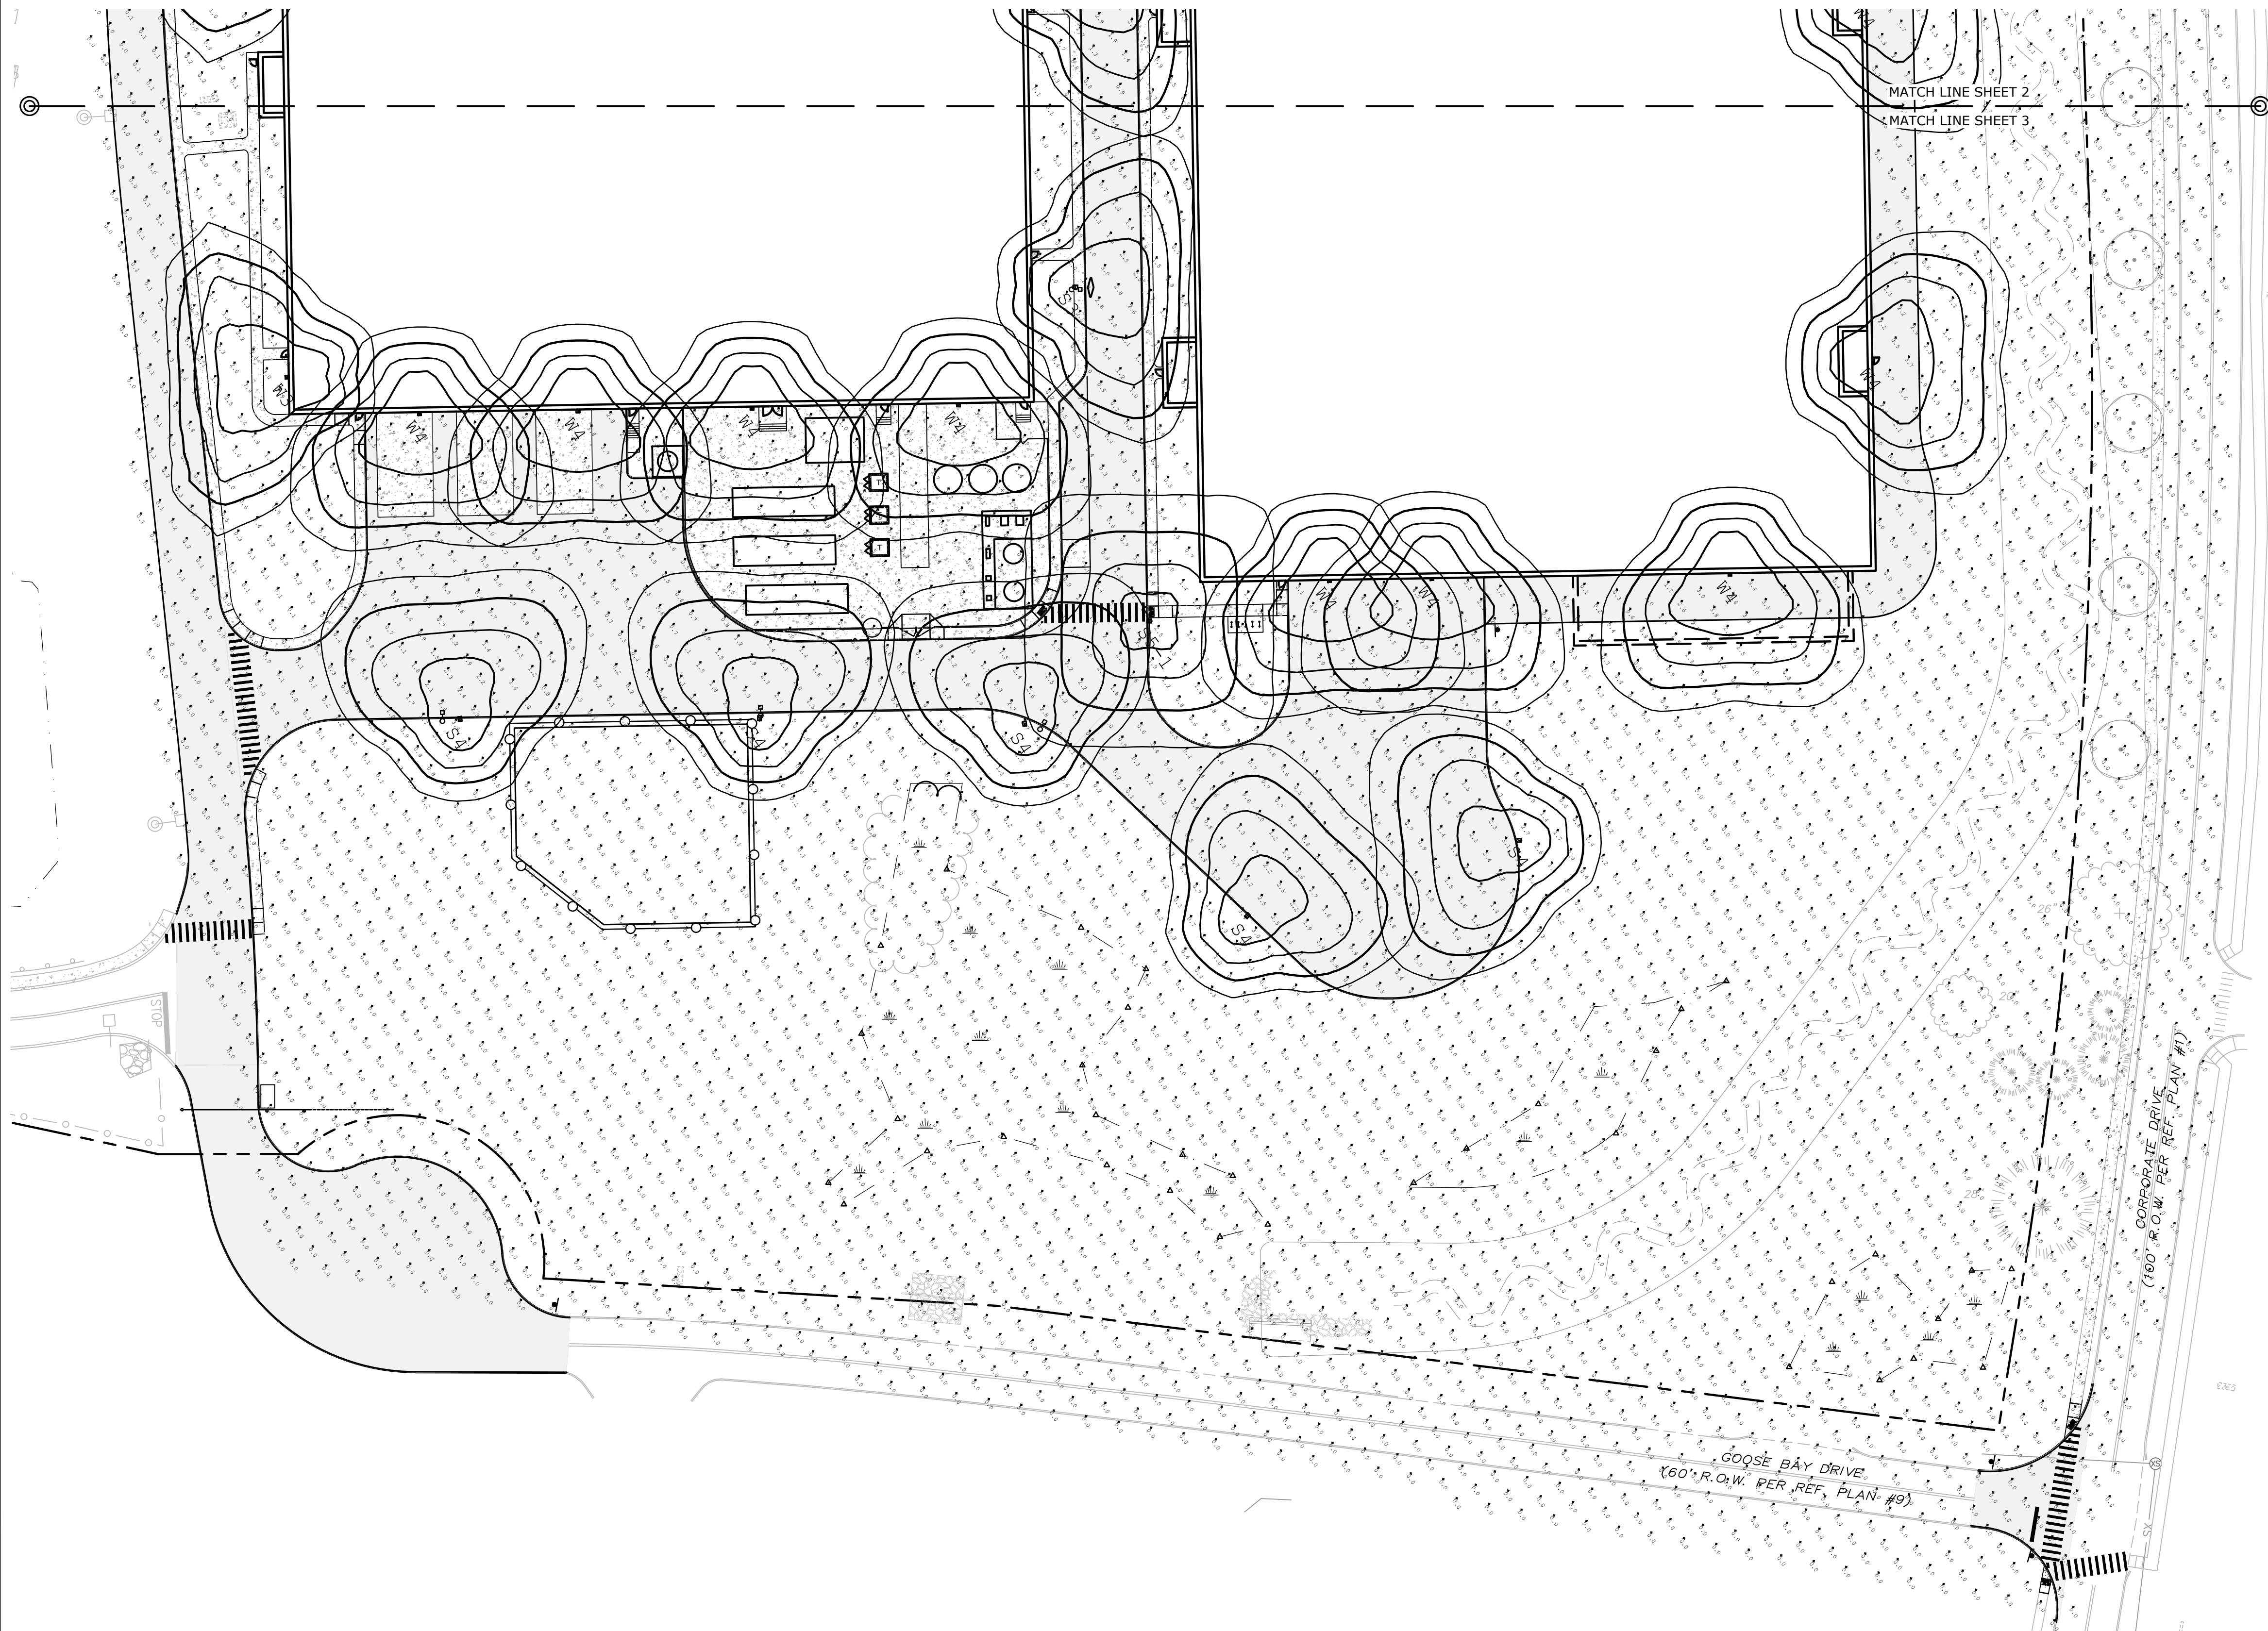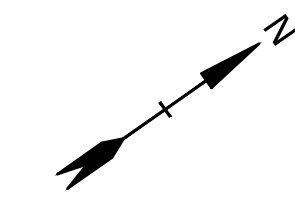PROJECT NO: L-0700-013
DATE: 04/03/2018

FILE: L-0700-026-C-DSGN.dwg
DRAWN BY: CJK
CHECKED: NAH
APPROVED: PMC

PHOTOMETRIC LIGHTING PLAN

SCALE: AS SHOWN

Symbol	Qty	Label	Arrangement	Description	MANUFACT
☐	6	S3	Single	MRR-LED-09L-S11-3-UNV-DIM-30-70CRI-CXX / 450 B3 S11G 20 S GA 4BC (20' AFG)	LSI INDUSTRIES, INC.
☐	7	S4	Single	MRR-LED-09L-S11-FT-UNV-DIM-30-70CRI-CXX / 450 B3 S11G 20 S GA 4BC (20' AFG)	LSI INDUSTRIES, INC.
☐	5	SS-1	Single	MRR-LED-09L-S11-5W-UNV-DIM-30-70CRI-CXX / 450 B3 S11G 20 S GA 4BC (20' AFG)	LSI INDUSTRIES, INC.
☐	7	W3	Single	XWM-3-LED-12L-30-UE-CXX / WALL MTD 20' AFG	LSI INDUSTRIES, INC.
☐	22	W4	Single	XWM-PT-LED-12L-30-UE-CXX / WALL MTD 20' AFG	LSI INDUSTRIES, INC.

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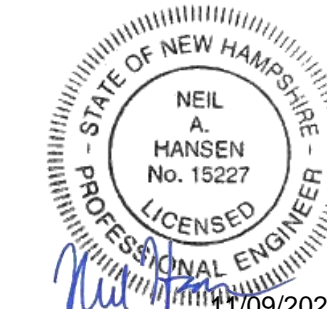
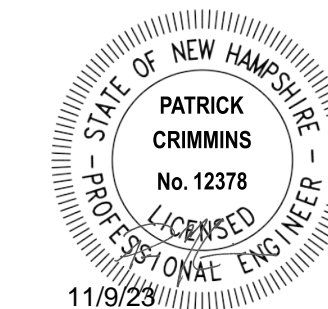
PHASE 2 PLAN SET

APRIL 3, 2018

REVISED: NOVEMBER 9, 2023







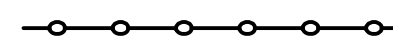








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	PHASE 2 PLAN SET COVER SHEET	11/9/2023
C-161	PHASE 2 DEMOLITION PLAN	9/27/2023
C-162	PHASE 2 DEMOLITION PLAN	11/9/2023
C-163	PHASE 2 DEMOLITION PLAN	11/9/2023
C-163.1	PHASE 2 PRE-CONSTRUCTION LAYOUT PLAN	11/9/2023
C-164	PHASE 2 OVERALL SITE PLAN	11/9/2023
C-165	PHASE 2 SITE PLAN	11/9/2023
C-166	PHASE 2 SITE PLAN	11/9/2023
C-167	PHASE 2 SITE PLAN	11/9/2023
C-168	PHASE 2 GRADING, DRAINAGE & EROSION CONTROL PLAN	11/9/2023
C-169	PHASE 2 GRADING, DRAINAGE & EROSION CONTROL PLAN	11/9/2023
C-170	PHASE 2 GRADING, DRAINAGE & EROSION CONTROL PLAN	11/9/2023
C-171	PHASE 2 UTILITIES PLAN	11/9/2023
C-172	PHASE 2 UTILITIES PLAN	11/9/2023
C-173	PHASE 2 UTILITIES PLAN	11/9/2023
C-174	PHASE 2 LANDSCAPE PLAN	11/9/2023
C-175	PHASE 2 LANDSCAPE PLAN	11/9/2023
C-176	PHASE 2 LANDSCAPE PLAN	11/9/2023
C-177	PHASE 2 PHOTOMETRIC LIGHTING PLAN	11/9/2023
C-178	PHASE 2 PHOTOMETRIC LIGHTING PLAN	11/9/2023
C-179	PHASE 2 PHOTOMETRIC LIGHTING PLAN	9/27/2023
8-046-1-1110	FIRST FLOOR PLAN - CUB	8/24/2023
8-046-1-2002	BUILDING ELEVATIONS (E-W) - CUB	8/24/2023
8-046-1-2003	BUILDING ELEVATIONS (N-S) - CUB	9/18/2023
8-070-1-1110	FIRST FLOOR PLAN - BL1	8/24/2023
8-070-1-2001	OVERALL BUILDINGS ELEVATIONS	7/12/2023
8-070-1-2002	BUILDING ELEVATIONS (E-W) - BL1	8/24/2023
8-070-1-2003	BUILDING ELEVATIONS (N-S) - BL1	8/24/2023
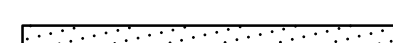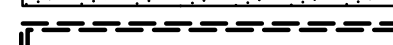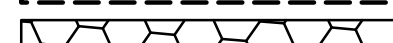
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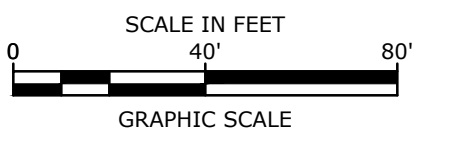
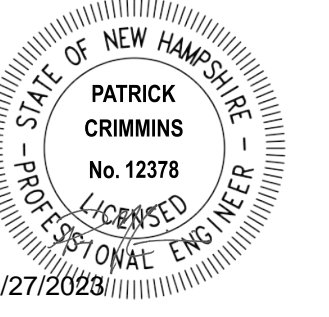
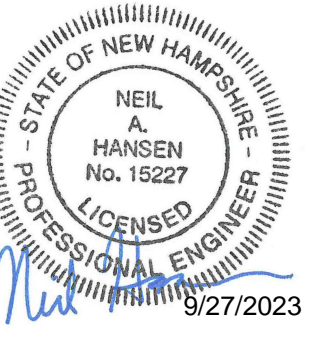
COMPLETE SET 28 SHEETS

LEGEND


-  APPROXIMATE LIMIT OF PROPOSED SAW CUT
-  LIMIT OF WORK
-  TREELINE TO BE REMOVED
-  APPROXIMATE LIMIT OF PAVEMENT TO BE REMOVED
-  LOCATION OF PROPOSED BUILDING
-  PROPOSED CONSTRUCTION ENTRANCE
-  PROPOSED SILT SOCK
-  PROPOSED TEMPORARY SNOW FENCE
-  PROPOSED TREE PROTECTION
-  PROPOSED INLET PROTECTION BARRIER
-  TBR TO BE REMOVED
-  BLDG TO BE REMOVED
-  TYP TYPICAL
-  COORD COORDINATE
-  CONST CONSTRUCT

DEMOLITION NOTES:

1. THE LOCATIONS OF UNDERGROUND UTILITIES ARE APPROXIMATE AND THE LOCATIONS ARE NOT GUARANTEED BY THE OWNER OR THE ENGINEER. IT IS THE CONTRACTOR'S RESPONSIBILITY TO LOCATE ALL UTILITIES, ANTICIPATE CONFLICTS, REPAIR EXISTING UTILITIES AND RELOCATE EXISTING UTILITIES REQUIRED TO COMPLETE THE WORK.
2. THE CONTRACTOR SHALL VERIFY LOCATION OF ALL EXISTING UTILITIES. CALL DIG SAFE AT LEAST 72 HOURS PRIOR TO THE COMMENCEMENT OF ANY DEMOLITION/CONSTRUCTION ACTIVITIES.
3. ALL MATERIALS SCHEDULED TO BE REMOVED SHALL BECOME THE PROPERTY OF THE CONTRACTOR UNLESS OTHERWISE SPECIFIED. THE CONTRACTOR SHALL DISPOSE OF ALL MATERIALS OFF-SITE IN ACCORDANCE WITH ALL FEDERAL, STATE, AND LOCAL REGULATIONS, ORDINANCES AND CODES EXCEPT AS SPECIFIED IN NOTE #25.
4. COORDINATE REMOVAL, RELOCATION, DISPOSAL OR SALVAGE OF UTILITIES WITH THE OWNER AND APPROPRIATE UTILITY COMPANY.
5. ANY EXISTING WORK OR PROPERTY DAMAGED OR DISRUPTED BY CONSTRUCTION/ DEMOLITION ACTIVITIES SHALL BE REPLACED OR REPAIRED TO MATCH ORIGINAL EXISTING CONDITIONS BY THE CONTRACTOR AT NO ADDITIONAL COST TO THE OWNER.
6. SAW CUT AND REMOVE PAVEMENT ONE (1) FOOT OFF PROPOSED EDGE OF PAVEMENT OR EXISTING CURB LINE IN ALL AREAS WHERE PAVEMENT TO BE REMOVED ABUTS EXISTING PAVEMENT OR CONCRETE TO REMAIN.
7. IT IS THE CONTRACTOR'S RESPONSIBILITY TO FAMILIARIZE THEMSELVES WITH THE CONDITIONS OF ALL OF THE PERMIT APPROVALS.
8. THE CONTRACTOR SHALL OBTAIN AND PAY FOR ADDITIONAL PERMITS, NOTICES AND FEES NECESSARY TO COMPLETE THE WORK AND ARRANGE FOR AND PAY FOR NECESSARY INSPECTIONS AND APPROVALS FROM THE AUTHORITIES HAVING JURISDICTION.
9. THE CONTRACTOR SHALL BE RESPONSIBLE FOR ALL DEMOLITION AND OFF-SITE DISPOSAL OF MATERIALS REQUIRED TO COMPLETE THE WORK, EXCEPT FOR WORK NOTED TO BE COMPLETED BY OTHERS AND AS SPECIFIED IN NOTE #25.
10. UTILITIES SHALL BE TERMINATED AT THE MAIN LINE PER UTILITY COMPANY AND THE CITY OF PORTSMOUTH STANDARDS. THE CONTRACTOR SHALL REMOVE ALL ABANDONED UTILITIES LOCATED WITHIN THE LIMITS OF WORK.
11. CONTRACTOR SHALL VERIFY ORIGIN OF ALL DRAINS AND UTILITIES PRIOR TO REMOVAL/TERMINATION TO DETERMINE IF DRAINS OR UTILITY IS ACTIVE, AND SERVICES ANY ON OR OFF-SITE STRUCTURE TO REMAIN. THE CONTRACTOR SHALL NOTIFY ENGINEER IMMEDIATELY OF ANY SUCH UTILITY FOUND AND SHALL MAINTAIN THESE UTILITIES UNTIL PERMANENT SOLUTION IS IN PLACE.
12. PAVEMENT REMOVAL LIMITS ARE SHOWN FOR CONTRACTOR'S CONVENIENCE. ADDITIONAL PAVEMENT REMOVAL MAY BE REQUIRED DEPENDING ON THE CONTRACTOR'S OPERATION. CONTRACTOR TO VERIFY FULL LIMITS OF PAVEMENT REMOVAL PRIOR TO BID.
13. THE CONTRACTOR SHALL REMOVE AND DISPOSE OF ALL EXISTING STRUCTURES, CONCRETE PADS, UTILITIES AND PAVEMENT WITHIN THE WORK LIMITS SHOWN UNLESS SPECIFICALLY IDENTIFIED TO REMAIN. ITEMS TO BE REMOVED INCLUDE BUT ARE NOT LIMITED TO: CONCRETE, PAVEMENT, CURBS, LIGHTING, MANHOLES, CATCH BASINS, UNDER GROUND PIPING, POLES, STAIRS, SIGNS, FENCES, RAMPS, WALLS, BOLLARDS, BUILDING SLABS, FOUNDATION, TREES AND LANDSCAPING.
14. COORDINATE ALL WORK WITHIN THE PUBLIC RIGHT OF WAYS WITH THE CITY OF PORTSMOUTH AND PEASE DEVELOPMENT AUTHORITY.
15. REMOVE TREES AND BRUSH AS REQUIRED FOR COMPLETION OF WORK. CONTRACTOR SHALL GRUB AND REMOVE ALL STUMPS WITHIN LIMITS OF WORK AND DISPOSE OF OFF SITE IN ACCORDANCE WITH FEDERAL, STATE, AND LOCAL LAWS AND REGULATIONS.
16. CONTRACTOR SHALL PROTECT ALL PROPERTY MONUMENTATION THROUGHOUT DEMOLITION AND CONSTRUCTION OPERATIONS. SHOULD ANY MONUMENTATION BE DISTURBED BY THE CONTRACTOR, THE CONTRACTOR SHALL EMPLOY A NEW HAMPSHIRE LICENSED SURVEYOR TO REPLACE DISTURBED MONUMENTS.
17. PROVIDE INLET PROTECTION BARRIERS AT ALL CATCH BASINS/CURB INLETS WITHIN CONSTRUCTION LIMITS AS WELL AS CATCH BASINS/CURB INLETS THAT MAY RECEIVE RUNOFF FROM CONSTRUCTION ACTIVITIES. INLET PROTECTION BARRIERS SHALL BE MAINTAINED FOR THE DURATION OF THE PROJECT. INLET PROTECTION BARRIERS SHALL BE "HIGH FLOW SILT SACK" BY ACF ENVIRONMENTAL OR EQUAL. INSPECT BARRIERS WEEKLY AND AFTER EACH RAIN EVENT OF 0.25 INCHES OR GREATER. CONTRACTOR SHALL COMPLETE A MAINTENANCE INSPECTION REPORT AFTER EACH INSPECTION. SEDIMENT DEPOSITS SHALL BE REMOVED AFTER EACH STORM EVENT OR MORE OFTEN IF THE FABRIC BECOMES CLOGGED OR SEDIMENT HAS ACCUMULATED TO 1/3 THE DESIGN DEPTH OF THE BARRIER.
18. THE CONTRACTOR SHALL PHASE DEMOLITION AND CONSTRUCTION AS REQUIRED TO PROVIDE CONTINUOUS SERVICE TO EXISTING BUSINESSES THROUGHOUT THE CONSTRUCTION PERIOD. EXISTING BUSINESS SERVICES INCLUDE, BUT ARE NOT LIMITED TO ELECTRICAL, COMMUNICATION, FIRE PROTECTION, DOMESTIC WATER AND SEWER SERVICES. TEMPORARY SERVICES, IF REQUIRED, SHALL COMPLY WITH ALL FEDERAL, STATE, LOCAL AND UTILITY COMPANY STANDARDS. CONTRACTOR SHALL PROVIDE DETAILED CONSTRUCTION SCHEDULE TO OWNER PRIOR TO ANY DEMOLITION/CONSTRUCTION ACTIVITIES.
19. EROSION CONTROL MEASURES SHALL BE INSTALLED PRIOR TO THE START OF ANY CLEARING OR DEMOLITION ACTIVITIES.
20. THE CONTRACTOR SHALL PAY ALL COSTS NECESSARY FOR TEMPORARY PARTITIONING, BARRICADING, FENCING, SECURITY AND SAFETY DEVICES REQUIRED FOR THE MAINTENANCE OF A CLEAN AND SAFE CONSTRUCTION SITE.
21. SAW CUT AND REMOVE PAVEMENT AND CONSTRUCT PAVEMENT TRENCH PATCH FOR ALL UTILITIES TO BE REMOVED AND PROPOSED UTILITIES LOCATED IN EXISTING PAVEMENT AREAS TO REMAIN.
22. THE CONTRACTOR SHALL ACQUIRE A PDA DIG PERMIT BEFORE ANY EARTH DISTURBANCE CAN TAKE PLACE. ALLOW 7 CALENDAR DAYS FOR PROCESSING.
23. ALL MONITORING WELLS WITHIN LIMIT OF WORK SHALL BE PROTECTED DURING CONSTRUCTION. IF ANY MONITORING WELL NEEDS TO BE REMOVED OR ADJUSTED THIS WORK SHALL BE COORDINATED WITH THE PEASE DEVELOPMENT AUTHORITY.
24. CONTRACTOR SHALL COORDINATE WITH THE PROJECT SURVEYOR FOR BENCHMARK AND CONTROL POINTS PRIOR TO CONSTRUCTION.
25. ALL EXCESS SOIL RESULTING FROM THE CONSTRUCTION SHALL REMAIN ON SITE. COORDINATE WITH OWNER AND PEASE DEVELOPMENT AUTHORITY ON FINAL LOCATION OF EXCESS MATERIALS.
26. BEFORE ANY DEWATERING IS PERFORMED, COORDINATION BETWEEN THE OWNER, CONTRACTOR, PDA, NHDES AND THE AIR FORCE IS REQUIRED TO DETERMINE PROPER PROCEDURES AND PERMITTING REQUIRED. AT A MINIMUM A NHDES TEMPORARY DISCHARGE PERMIT IS REQUIRED.



Last Save Date: September 27, 2023 1:36 PM By: CKRZCUIK
 Plot Date: Wednesday, September 27, 2023 Plotted By: Colter Krzucik
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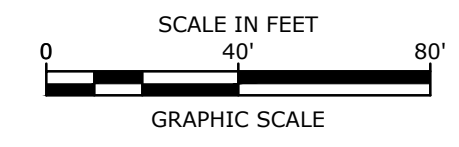
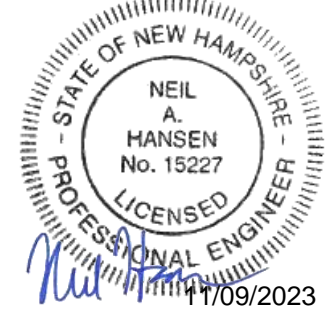
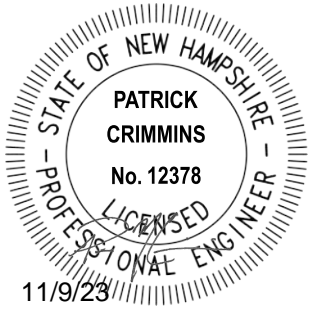
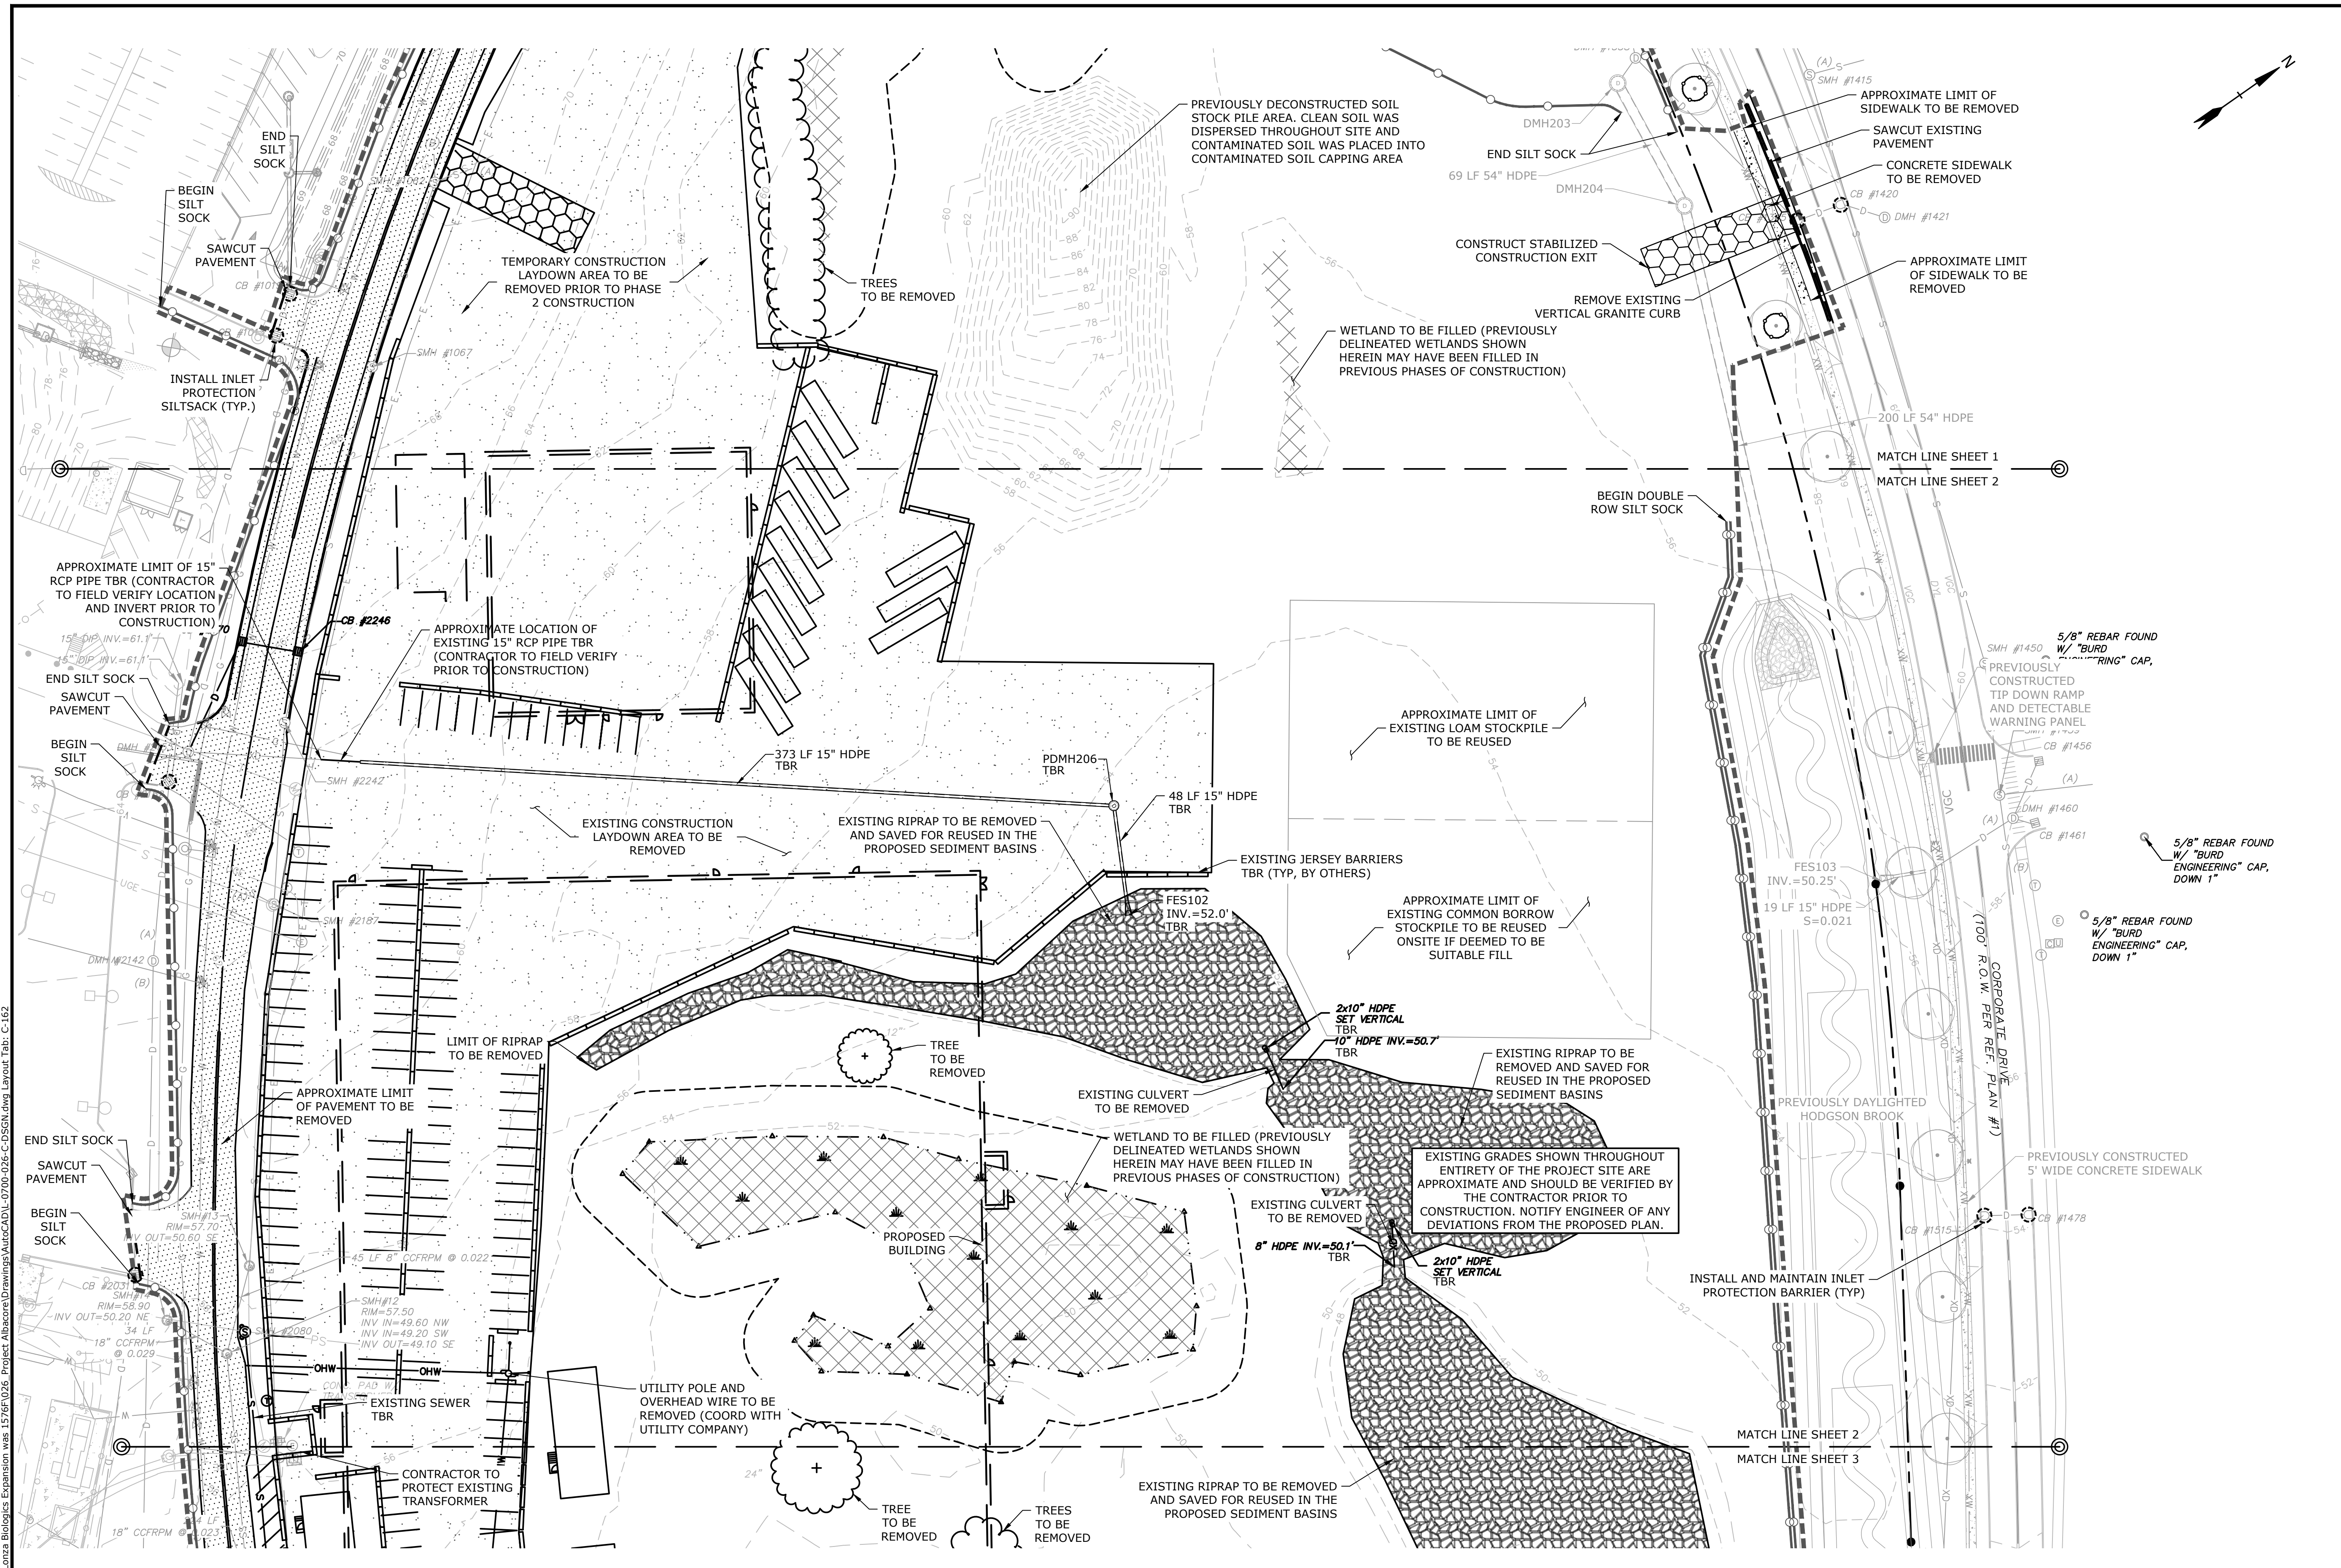
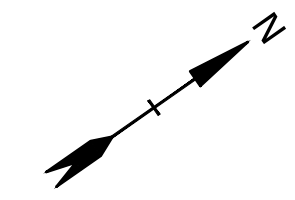
Proposed Industrial Development
Lonza Biologics
 Portsmouth, New Hampshire

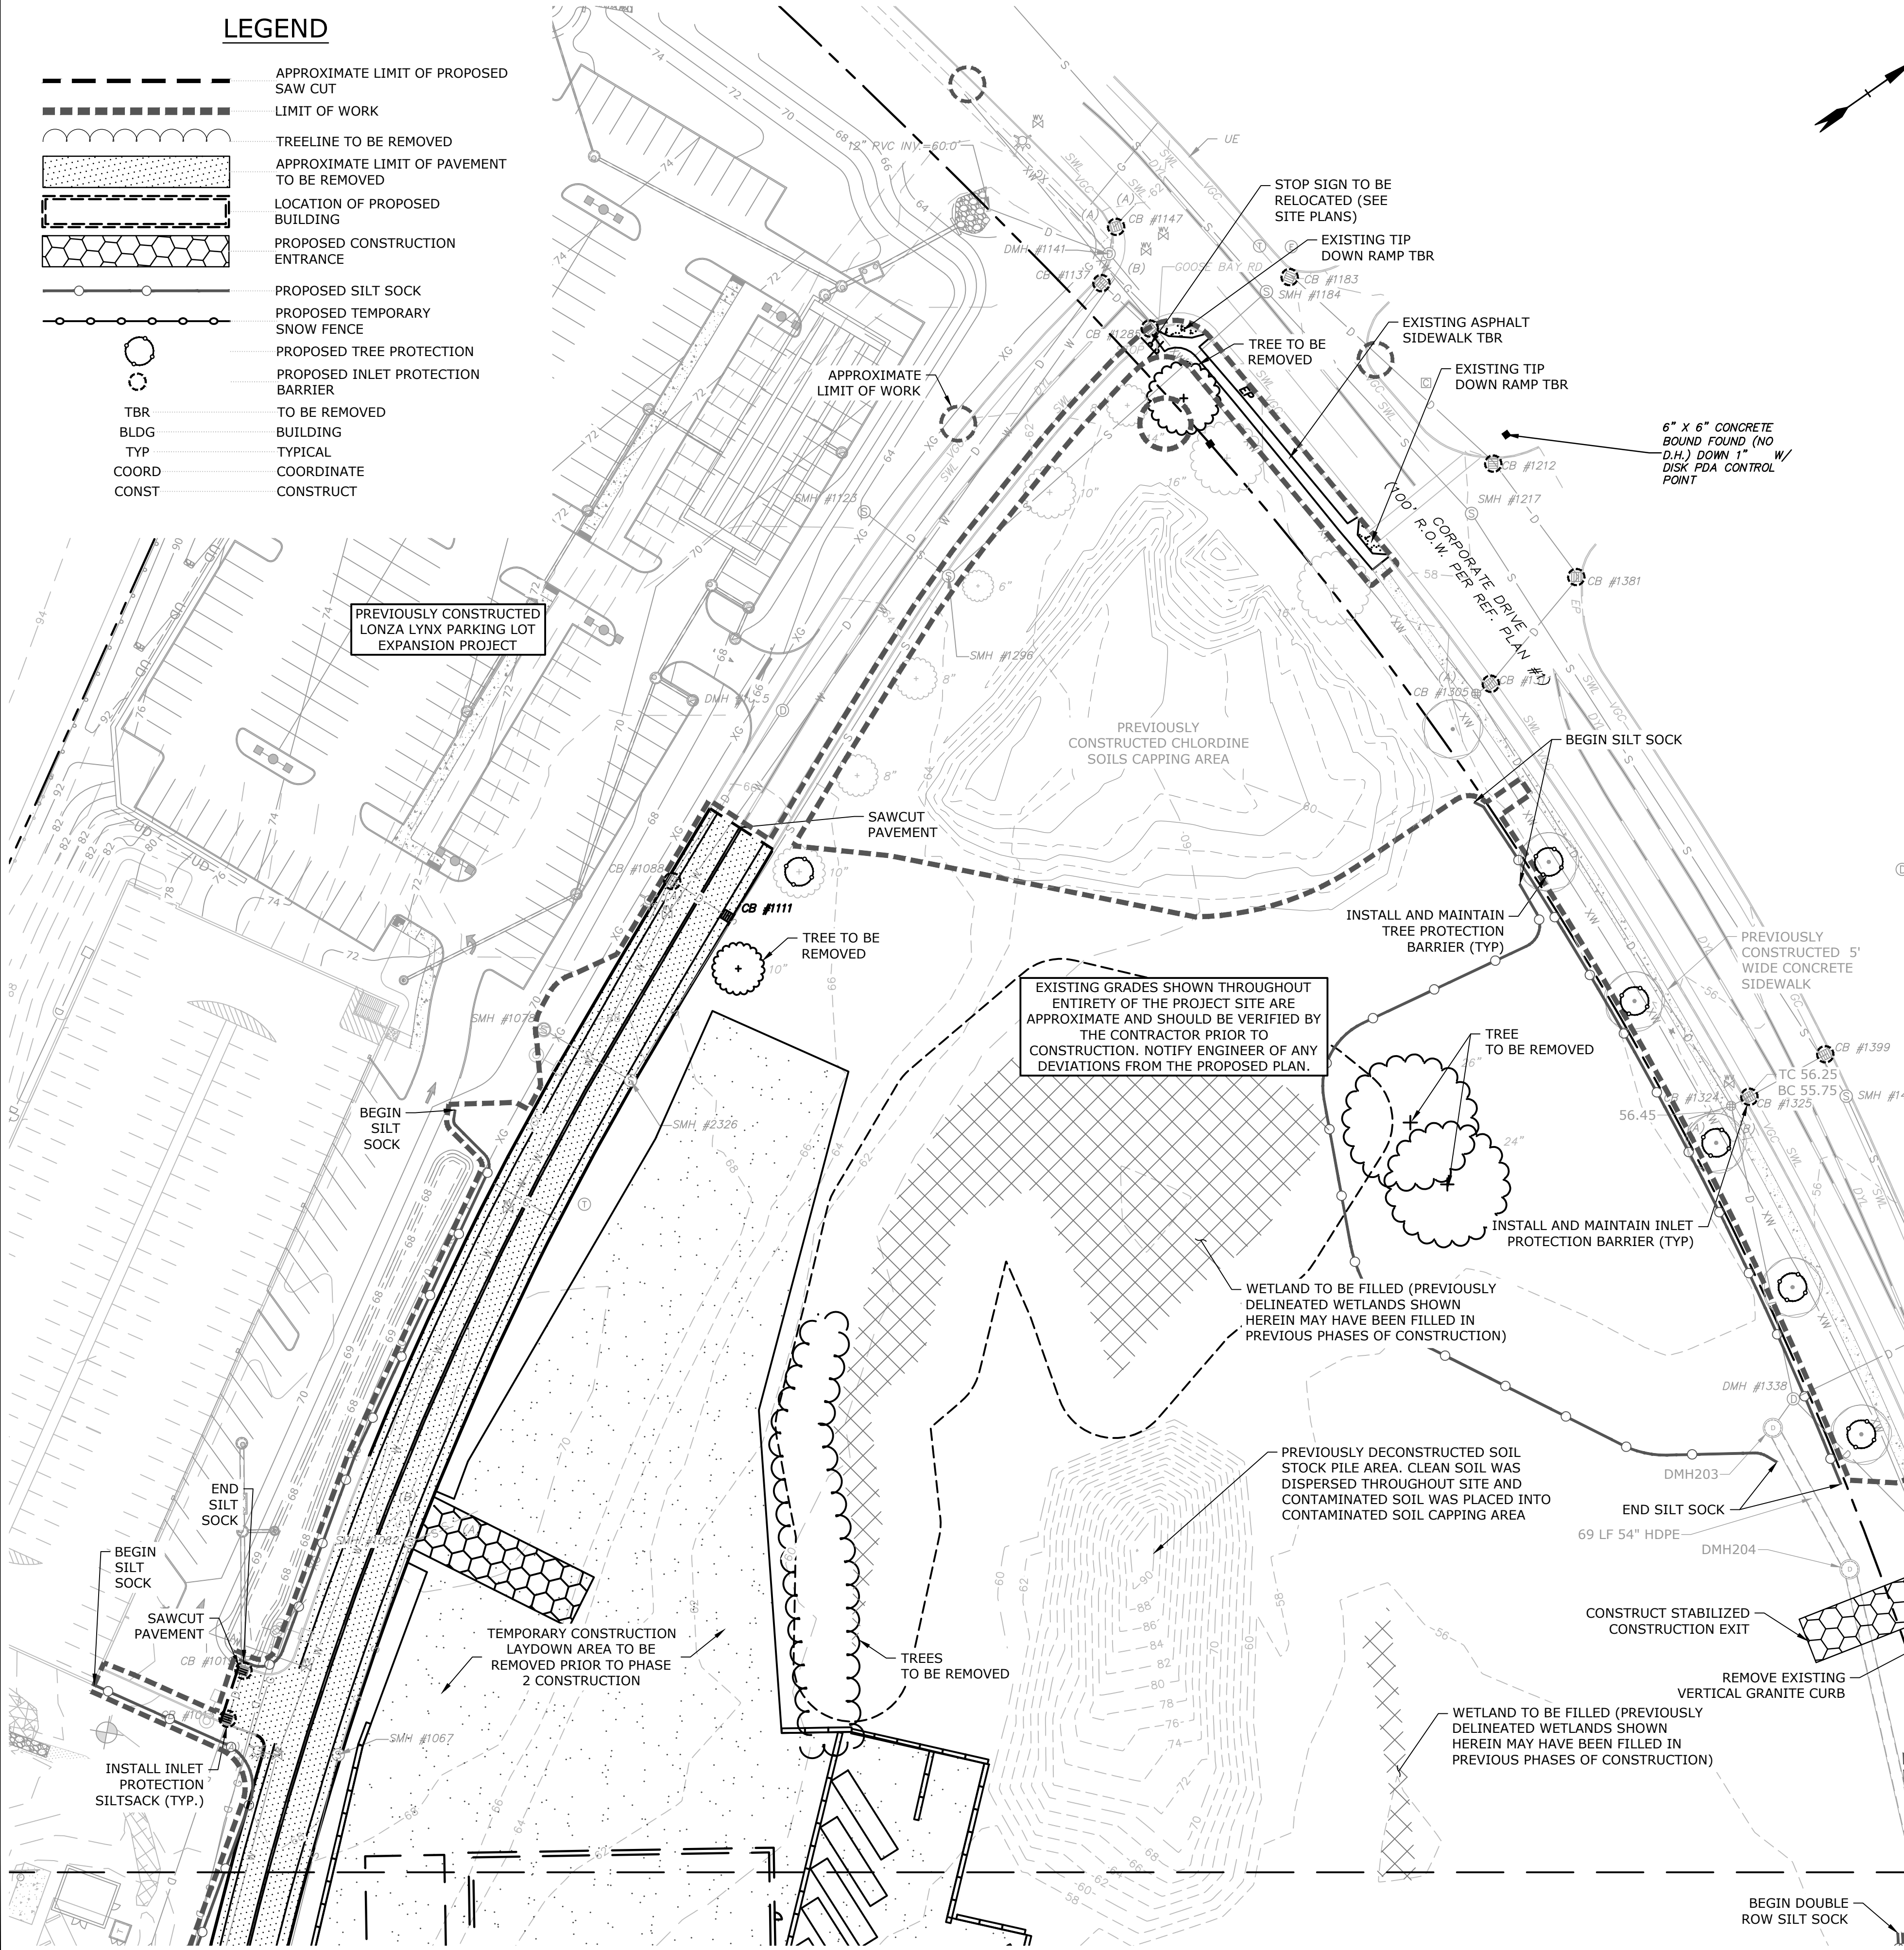MARK	DATE	DESCRIPTION
M	9/27/2023	P.B. Submission
L	7/17/2023	Amended Site Plan Review
K	5/5/2023	Phase 1B Issued for Bid
J	3/15/2023	Phase 1B Issued for Preliminary Pricing
I	1/9/2023	Admin. Approval Submission
H	12/10/2021	Planning Board Stipulation
G	8/19/2019	Admin. Approval Submission
F	11/6/2018	P.B. Submission

PROJECT NO:	L-0700-013
DATE:	04/03/2018
FILE:	L-0700-026-C-DSGN.dwg
DRAWN BY:	CJK
CHECKED:	NAH
APPROVED:	PMC

PHASE 2 DEMOLITION PLAN

SCALE: AS SHOWN
C-161



Proposed Industrial Development

Lonza Biologics

Portsmouth, New Hampshire

MARK	DATE	DESCRIPTION
N	11/9/2023	Revised P.B. Submission
M	9/27/2023	P.B. Submission
L	9/1/2022	Issued for Construction
K	5/27/2022	Issued for Bid
J	5/23/2022	Third Party Rev. Comments
I	4/26/2022	Revised PB Stipulations

PROJECT NO:	L-0700-013
DATE:	04/03/2018
FILE:	L-0700-026-C-DSGN.dwg
DRAWN BY:	CJK
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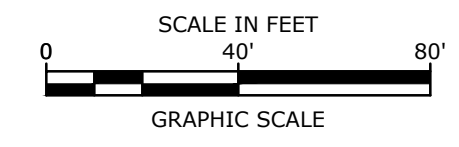
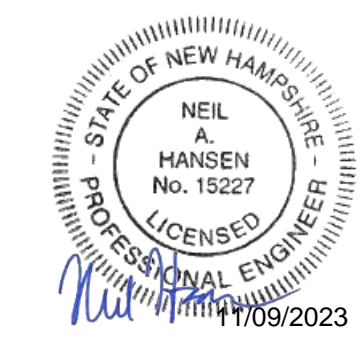
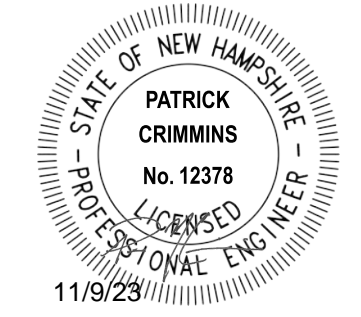
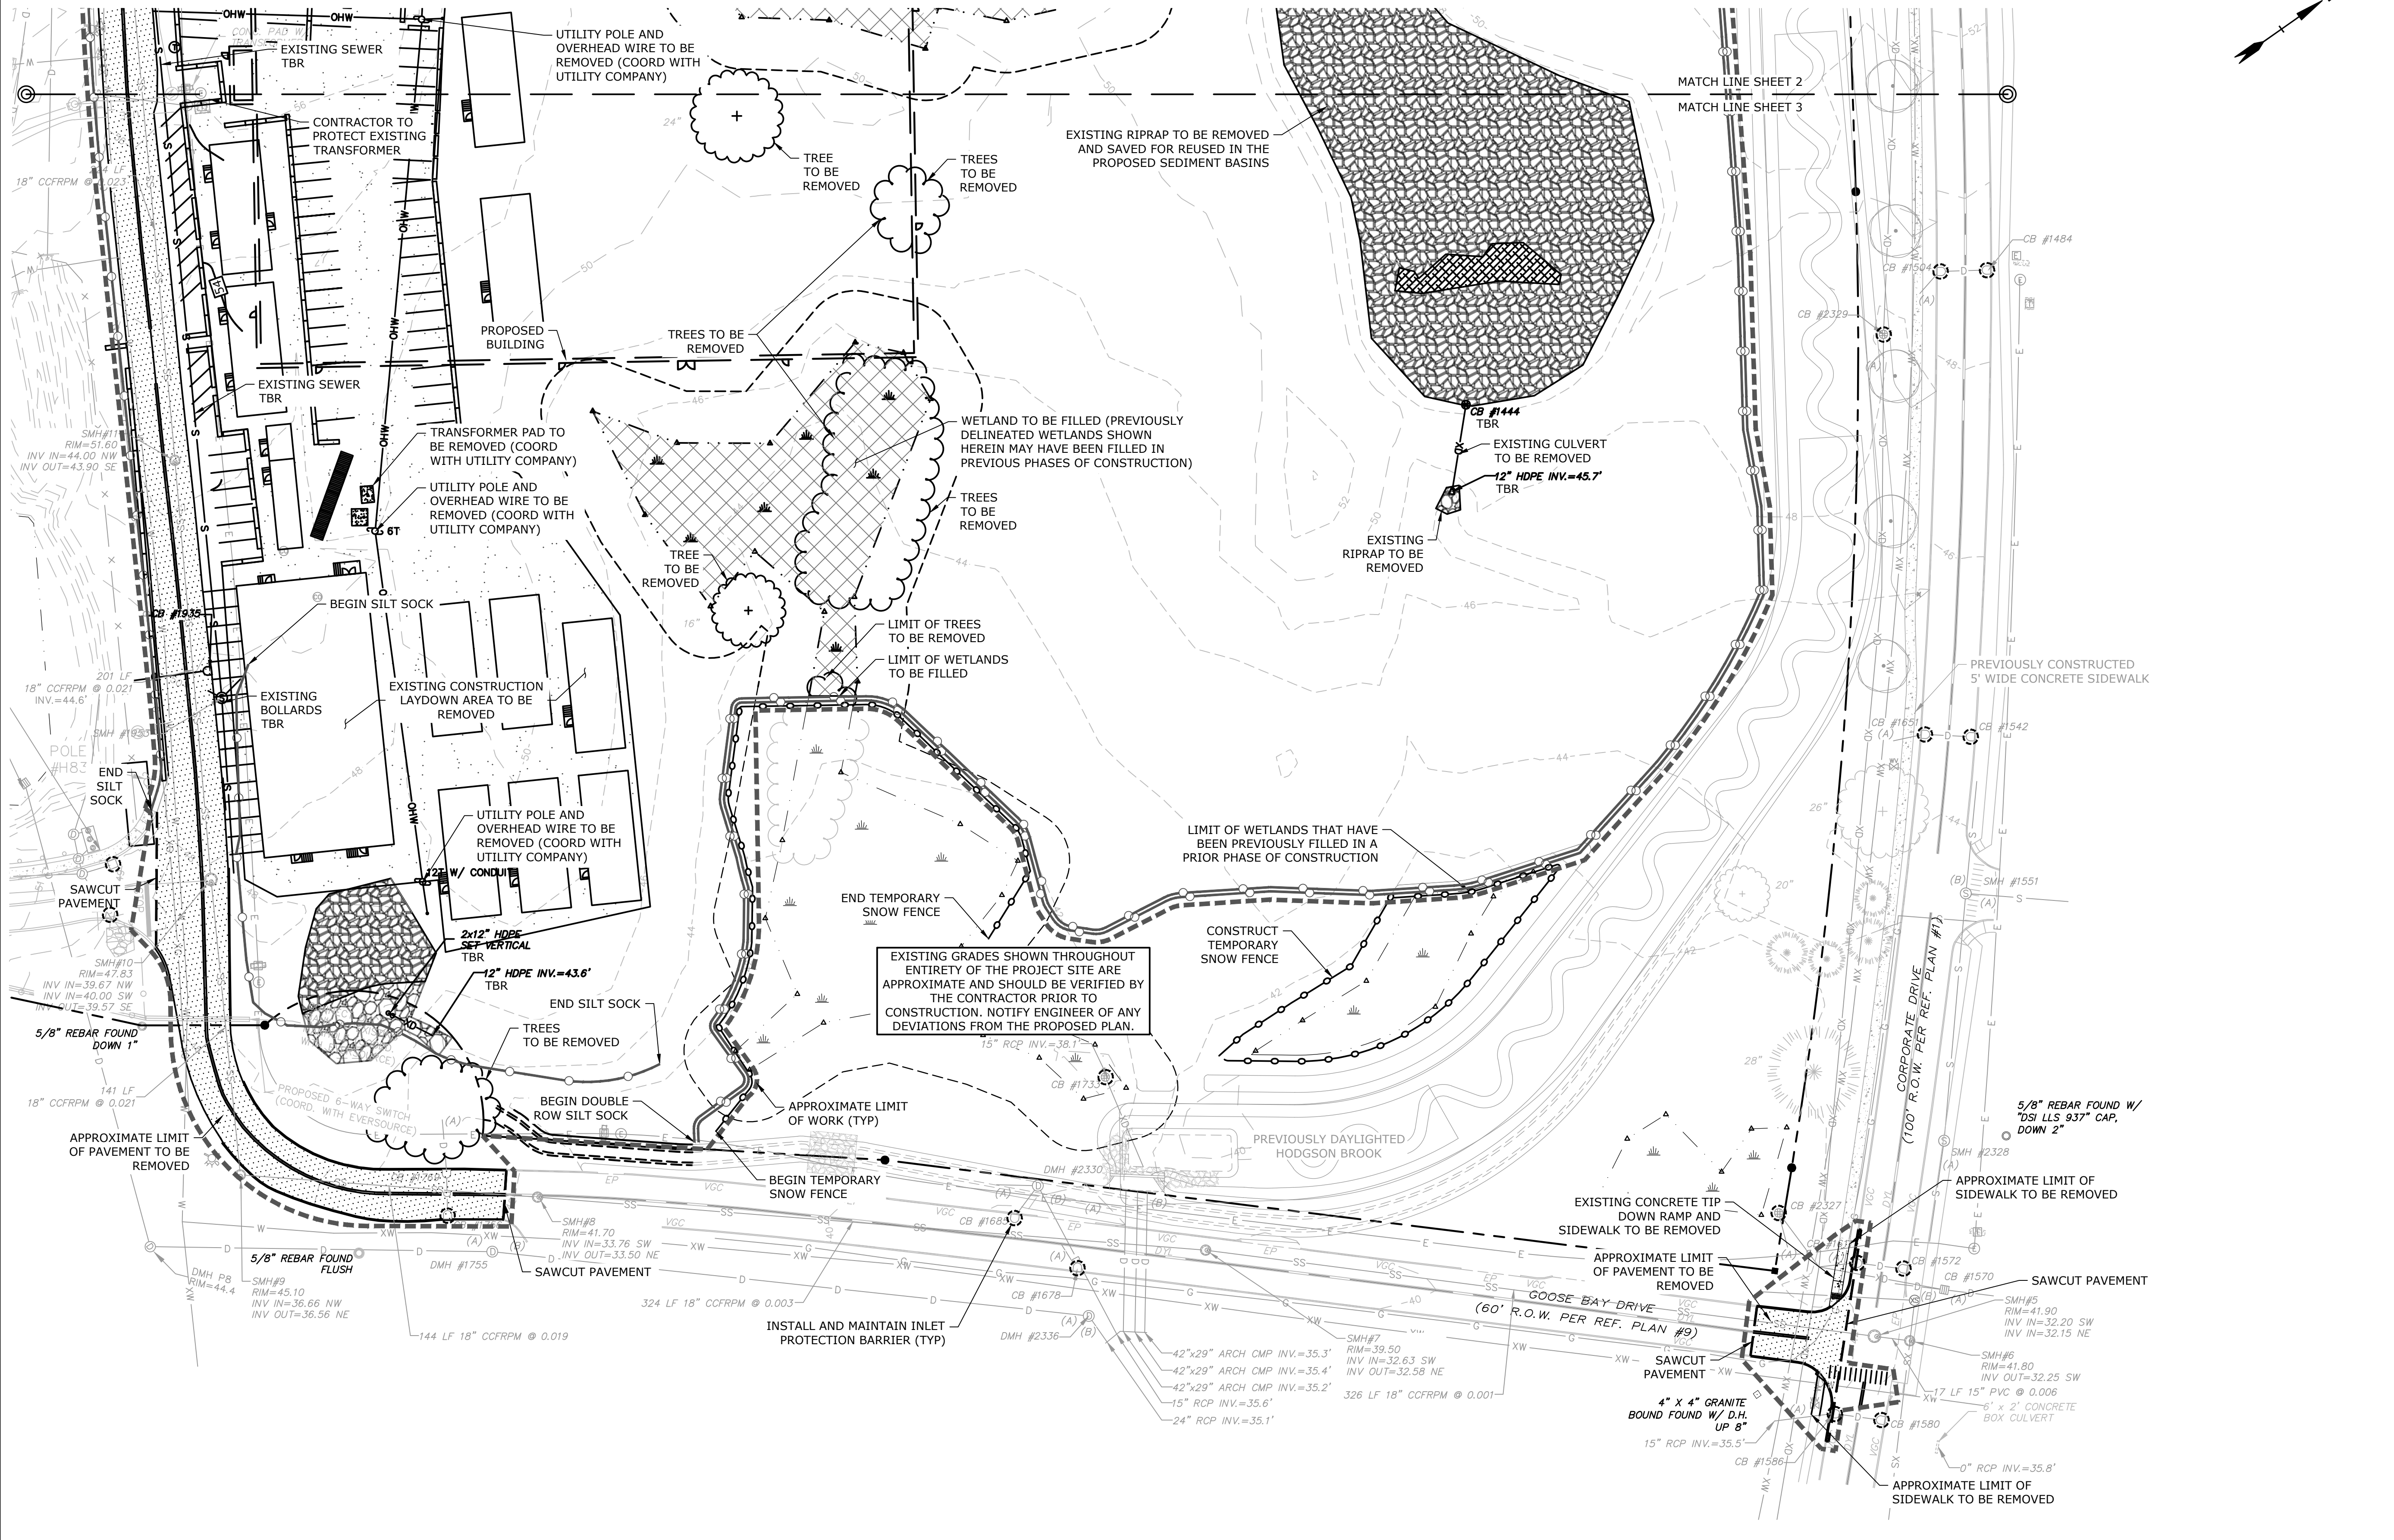
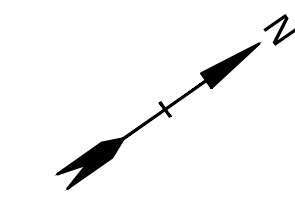
PHASE 2 DEMOLITION PLAN

SCALE: AS SHOWN

C-162

Last Save Date: November 9, 2023 11:03 AM By: NAHANSEN
 Plot Date: Thursday, November 09, 2023 Plotted By: Neil A. Hansen
 File Location: J:\L-0700\Lonza Biologics Expansion\1276\026 - Project Abstract\Drawings\AutoCAD\1-0700-026-C-DSGN.dwg Layout Tab: C-162

SEE SHEET C-161 FOR LEGEND AND DEMOLITION NOTES



Proposed Industrial Development

Lonza Biologics

Portsmouth, New Hampshire

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K	5/27/2022	Issued for Bid
J	5/23/2022	Third Party Rev. Comments
I	4/26/2022	Revised PB Stipulations





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DATE:	04/03/2018
FILE:	L-0700-026-C-DSGN.dwg
DRAWN BY:	CHK
CHECKED:	NAH
APPROVED:	PMC

SEE SHEET C-161 FOR LEGEND AND DEMOLITION NOTES

PHASE 2
DEMOLITION PLAN

SCALE: AS SHOWN

Last Save Date: November 9, 2023 11:03 AM By: MAHANSEN
 Plot Date: Thursday, November 09, 2023 Plotted By: Neil A. Hansen
 P&E File Location: J:\L0700\Lonza Biologics Expansion.was 15760.026 Project Abstract: Drawings\AutoCAD\0700-026-C-DSGN.dwg Layout Tab: C-163

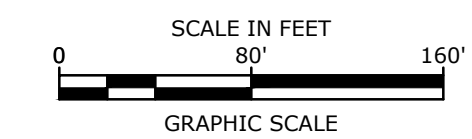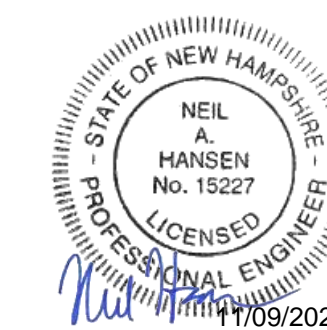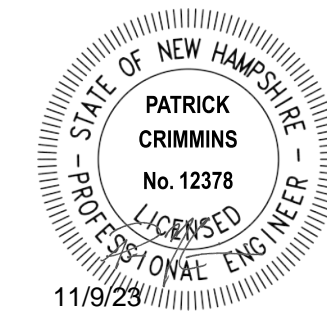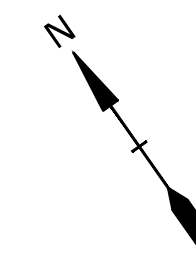

Proposed Industrial Development

Lonza Biologics

Portsmouth, New Hampshire

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J	5/23/2022	Third Party Rev. Comments
I	4/26/2022	Revised PB Stipulations
MARK	DATE	DESCRIPTION


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DATE:	04/03/2018
FILE:	L-0700-026-C-DSGN.dwg
DRAWN BY:	CJK
CHECKED BY:	NAH
APPROVED:	PMC

**PHASE 2
PRE-CONSTRUCTION
LAYOUT PLAN**


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C-163.1

Last Save Date: November 9, 2023 11:03 AM By: NAHANSEN
 Plot Date: Thursday, November 09, 2023 Plotted By: Neil A. Hansen
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SEE SHEET C-501 FOR
EROSION CONTROL NOTES
AND DETAILS

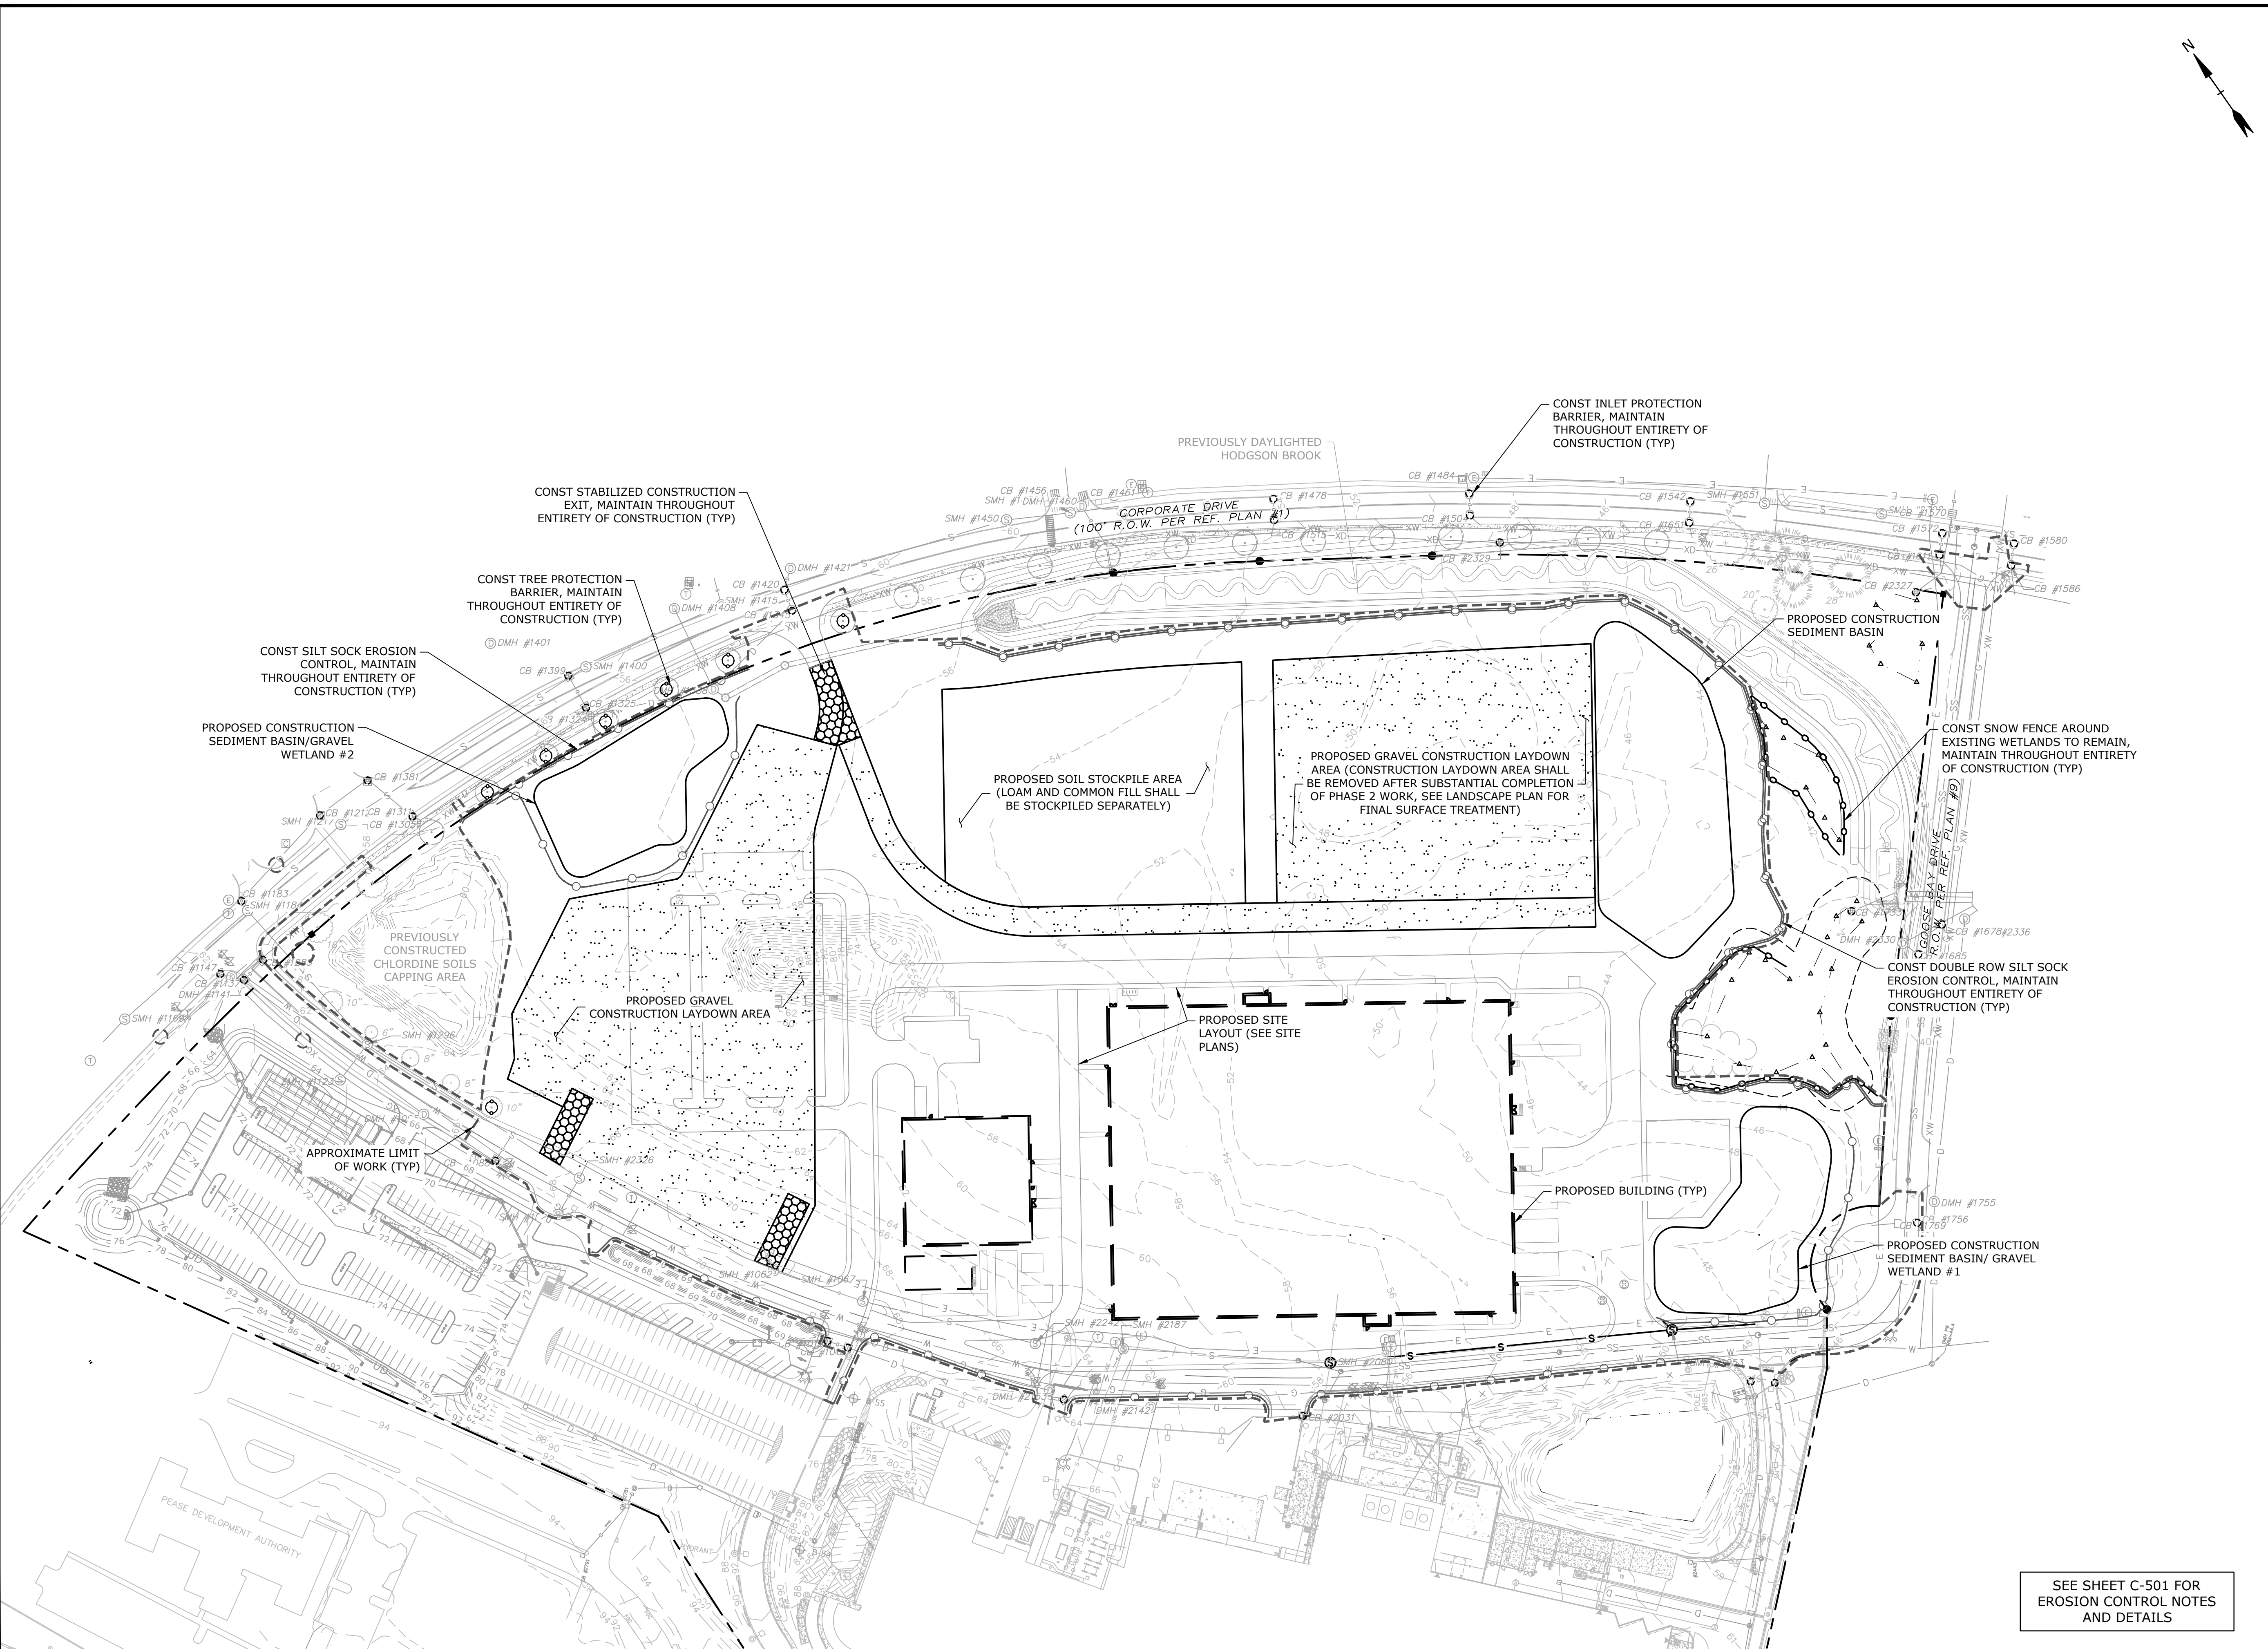

SITE DATA

LOCATION: TAX MAP 305, LOTS 1 & 2
70 & 80 CORPORATE DRIVE
PORTSMOUTH, NH

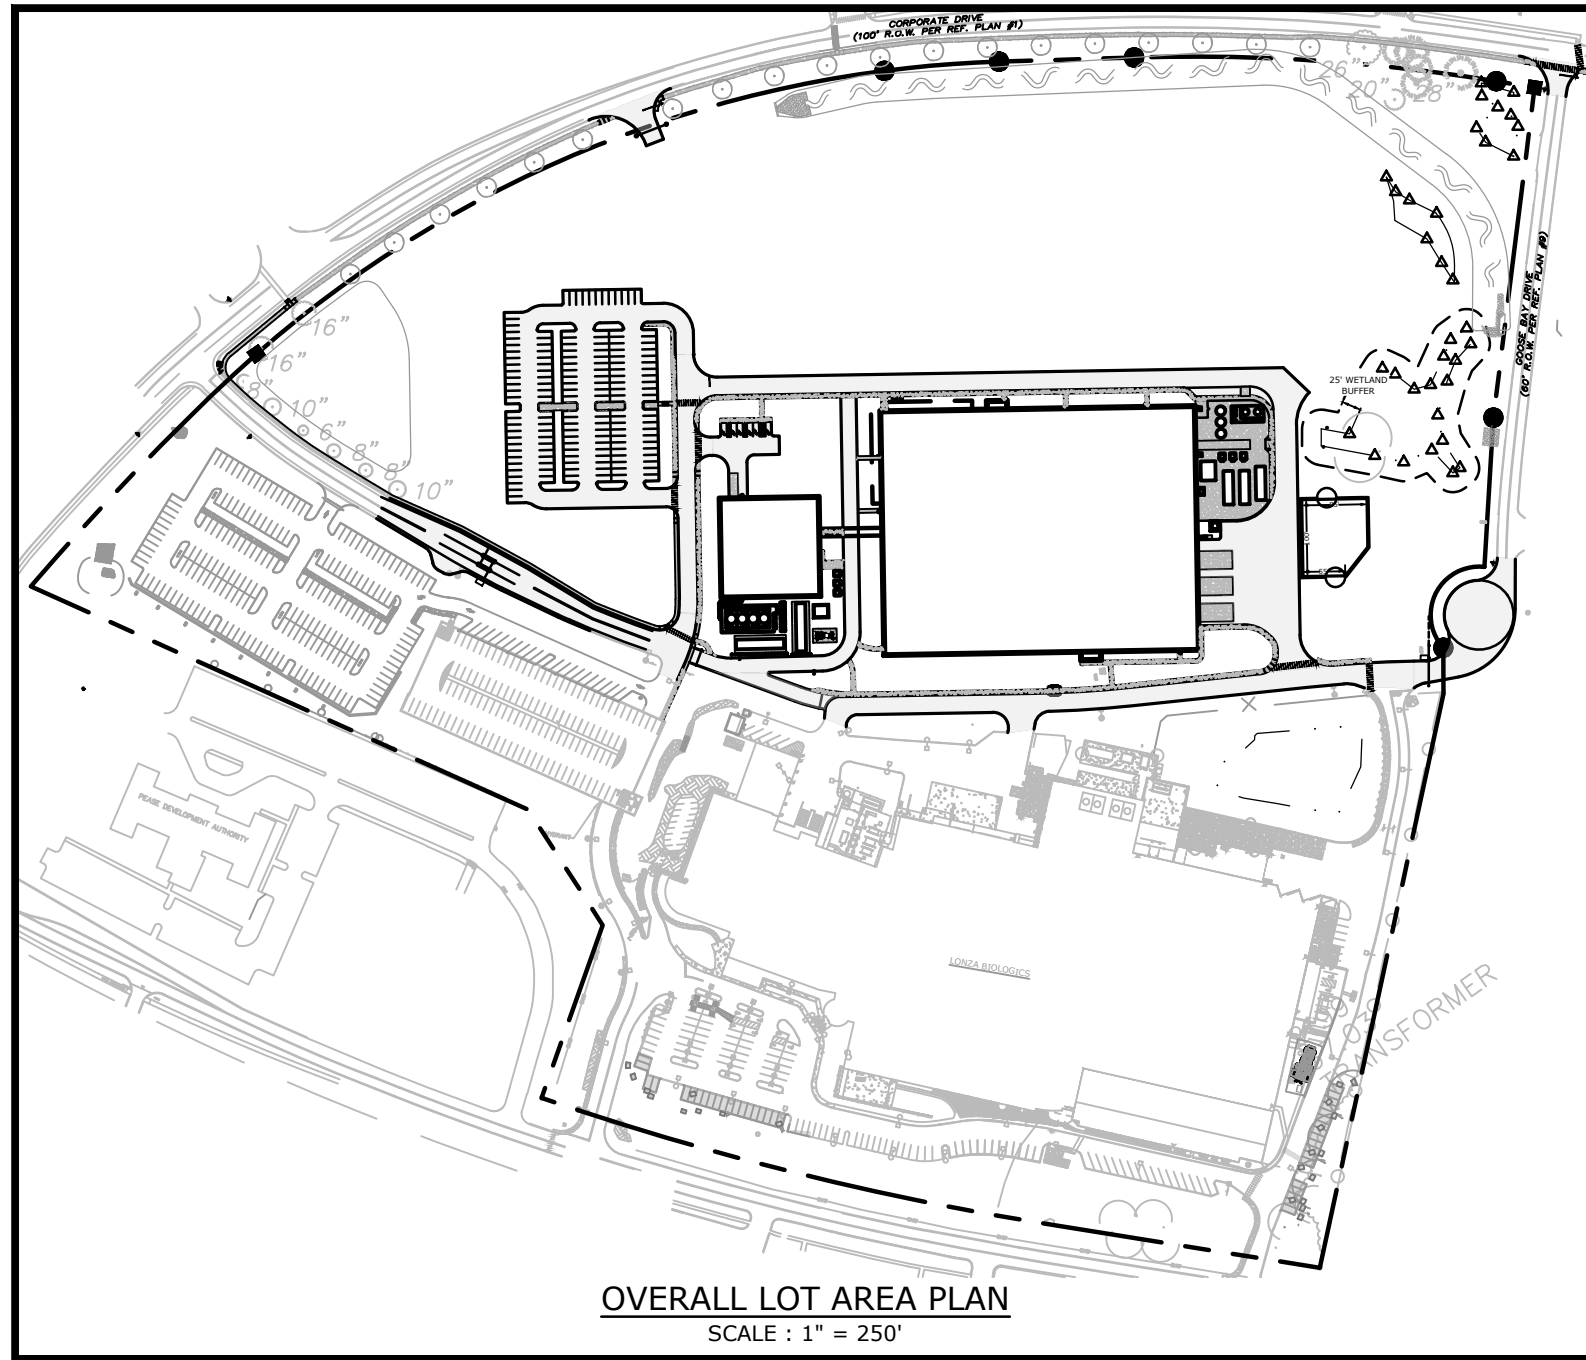TAX MAP 305, LOT 6
101 INTERNATIONAL DRIVE
PORTSMOUTH, NH

ZONING DISTRICT: AIRPORT, BUSINESS & COMMERCIAL (ABC)

DIMENSIONAL REQUIREMENTS:






	REQUIRED	PROVIDED
MINIMUM LOT AREA:	5 AC	43.4± AC
MINIMUM STREET FRONTAGE:	200 FT	1,038 FT
MINIMUM FRONT YARD SETBACK:	70 FT	70 FT
SIDE SETBACK	30 FT	30 FT
REAR SETBACK	50 FT	51 FT
MINIMUM OPEN SPACE	25 %	59.9± %

MAXIMUM STRUCTURE HEIGHT SHALL NOT EXCEED FAA CRITERIA.

PARKING REQUIREMENTS:

REQUIRED PARKING	PROVIDED
2 SPACES PER 3 EMPLOYEES ON LARGEST SHIFT	801 SPACES
990 EXISTING EMPLOYEES	156 SPACES
180 ANTICIPATED EMPLOYEES	120 SPACES
TOTAL REQUIRED:	957 SPACES

PARKING PROVIDED	TOTAL:
EXISTING SPACES:	801 SPACES
PROPOSED SURFACE PARKING:	156 SPACES
TOTAL:	957 SPACES

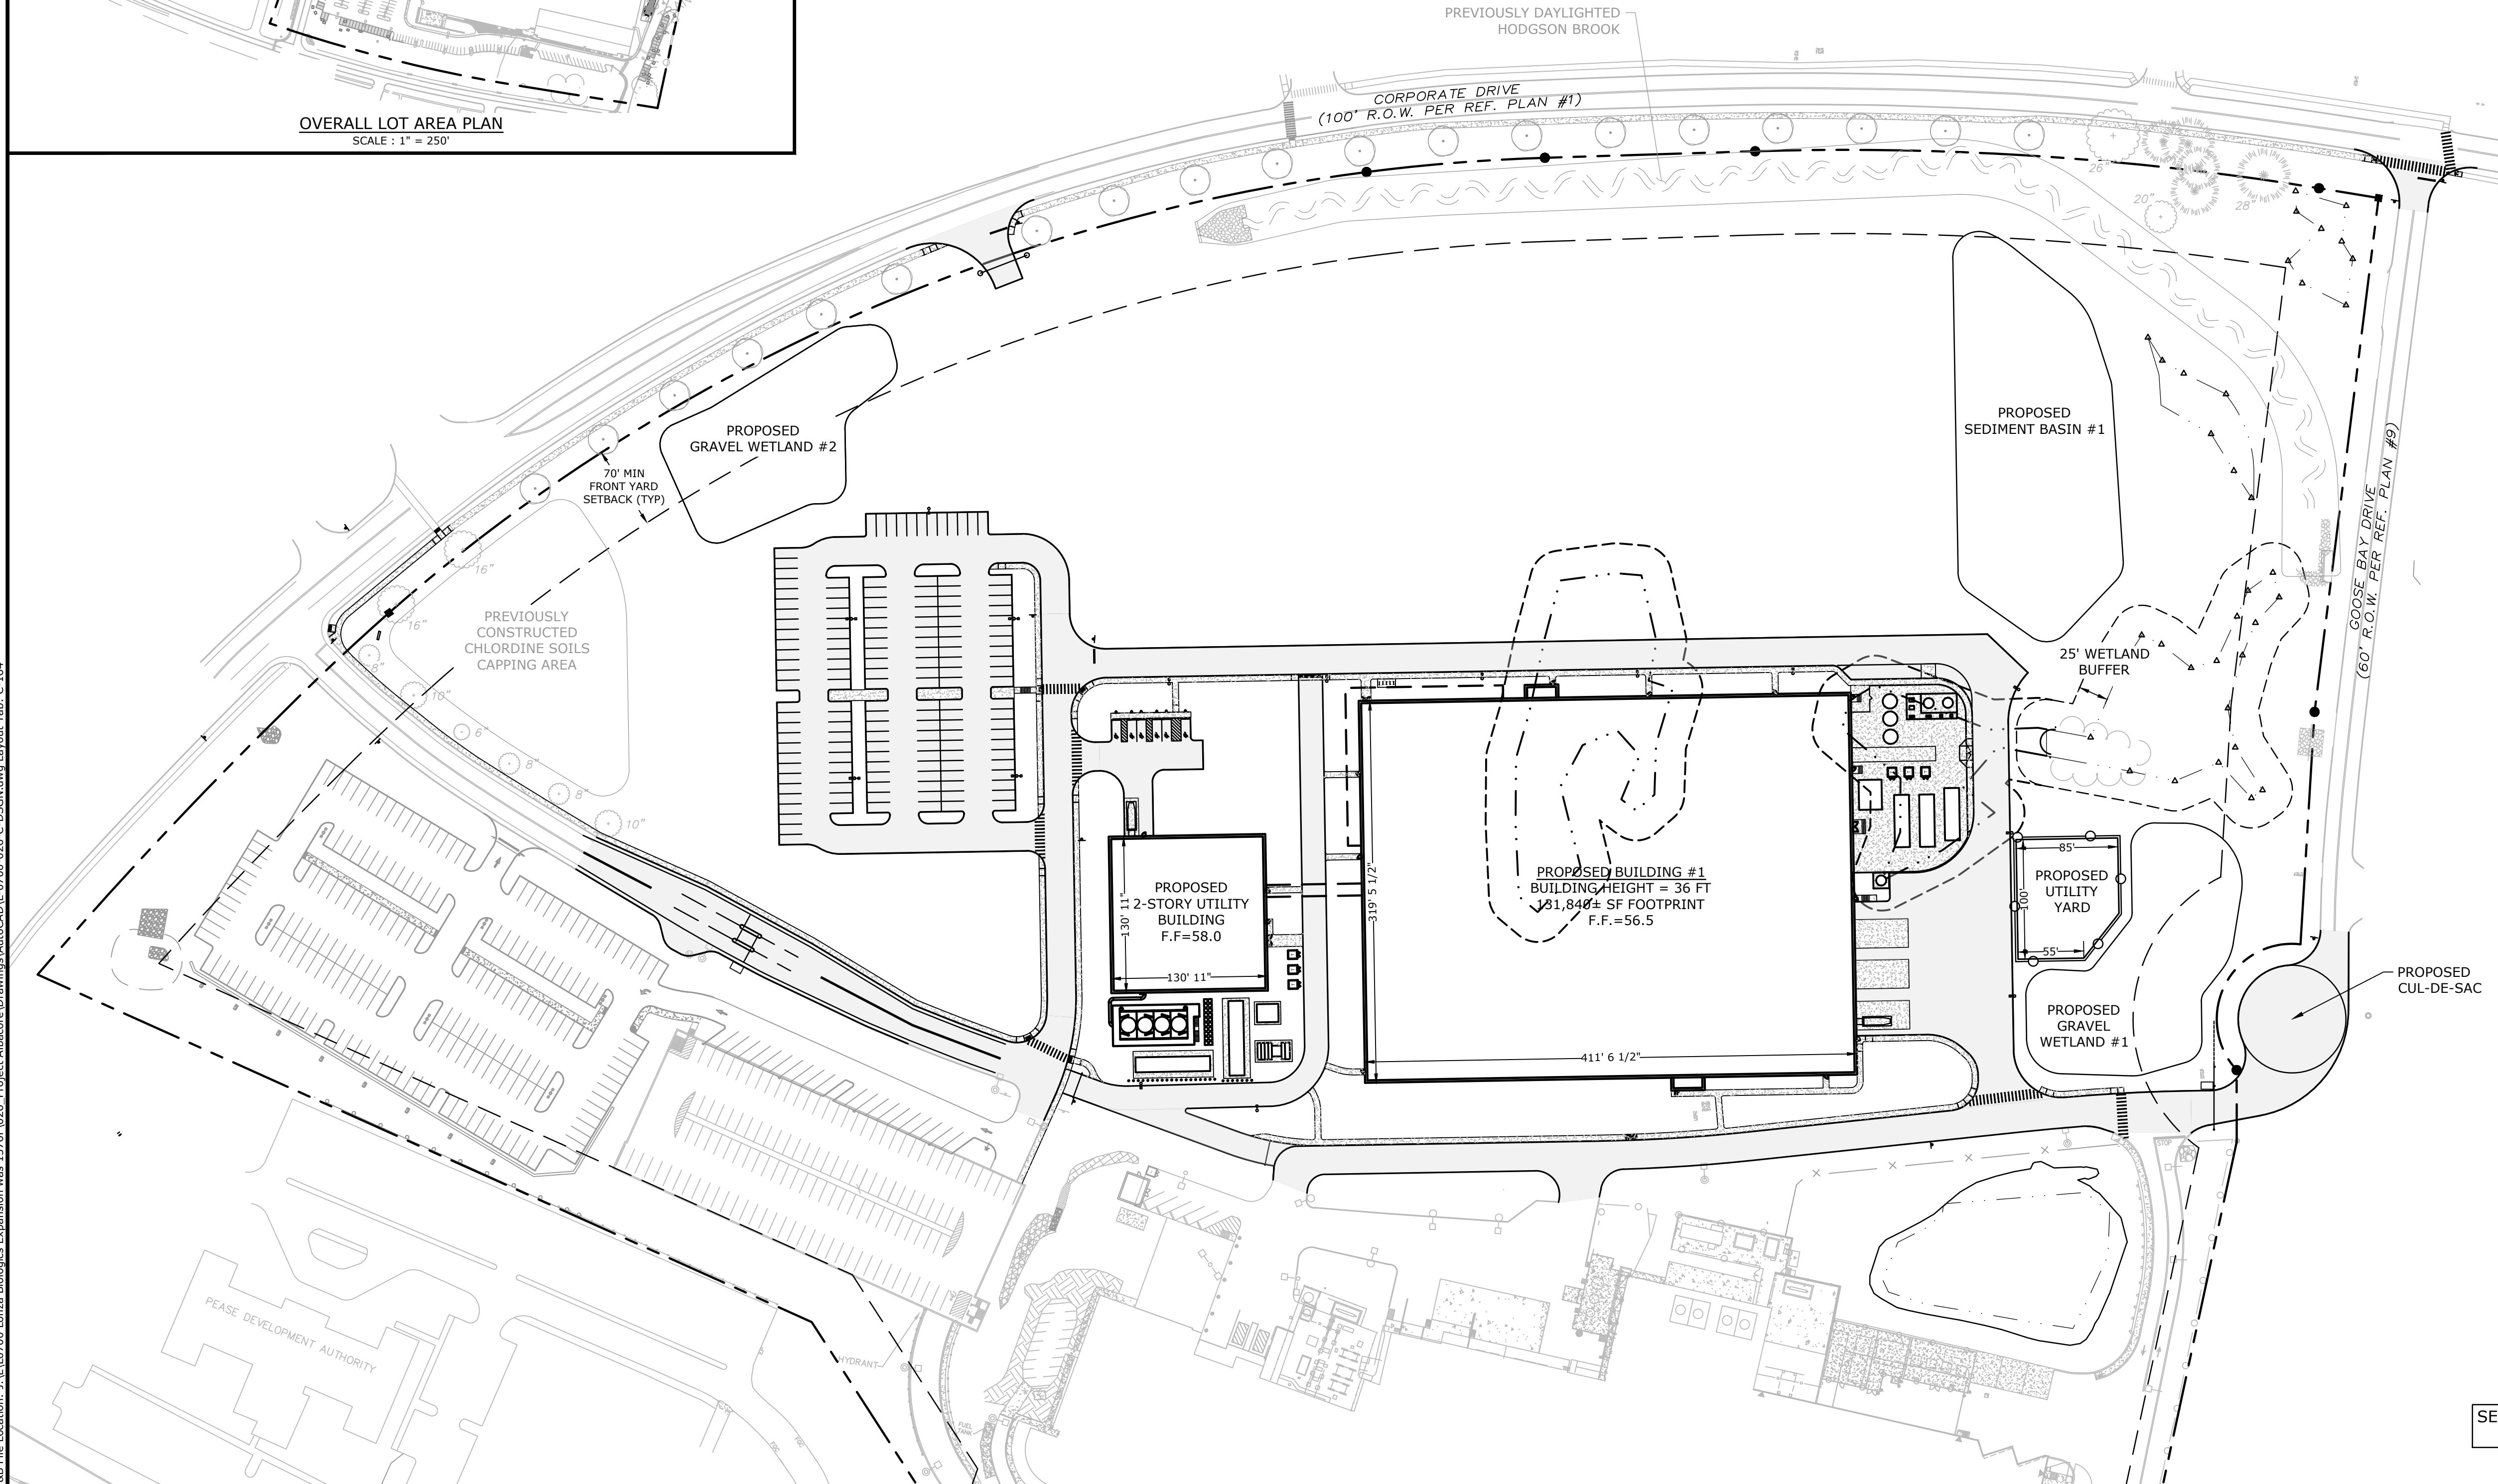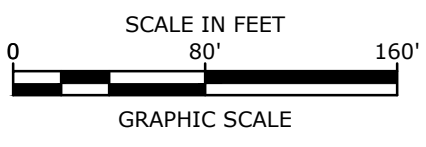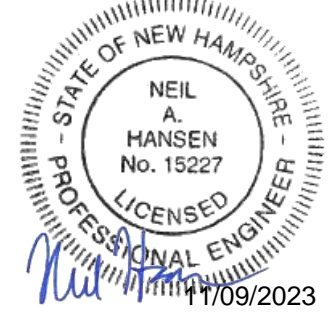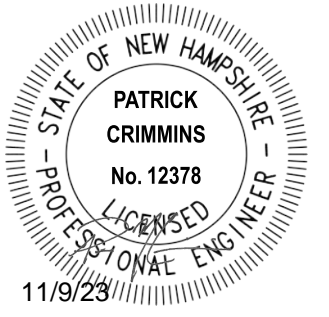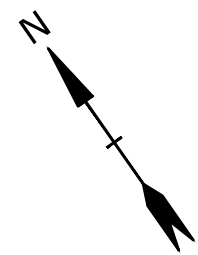

Proposed Industrial Development

Lonza Biologics

Portsmouth,
New Hampshire

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I	4/26/2022	Revised PB Stipulations


PROJECT NO:	L-0700-013
DATE:	04/03/2018
FILE:	L-0700-026-C-DSGN.dwg
DRAWN BY:	CIJ
CHECKED BY:	NAH
APPROVED:	PMC

PHASE 2 OVERALL SITE PLAN

SCALE: AS SHOWN




SEE SHEET C-165 FOR LEGEND AND SITE NOTES

Last Save Date: November 9, 2023 11:03 AM By: NAHANSEN
 Plot Date: Thursday, November 09, 2023 Plotted By: Neil A. Hansen
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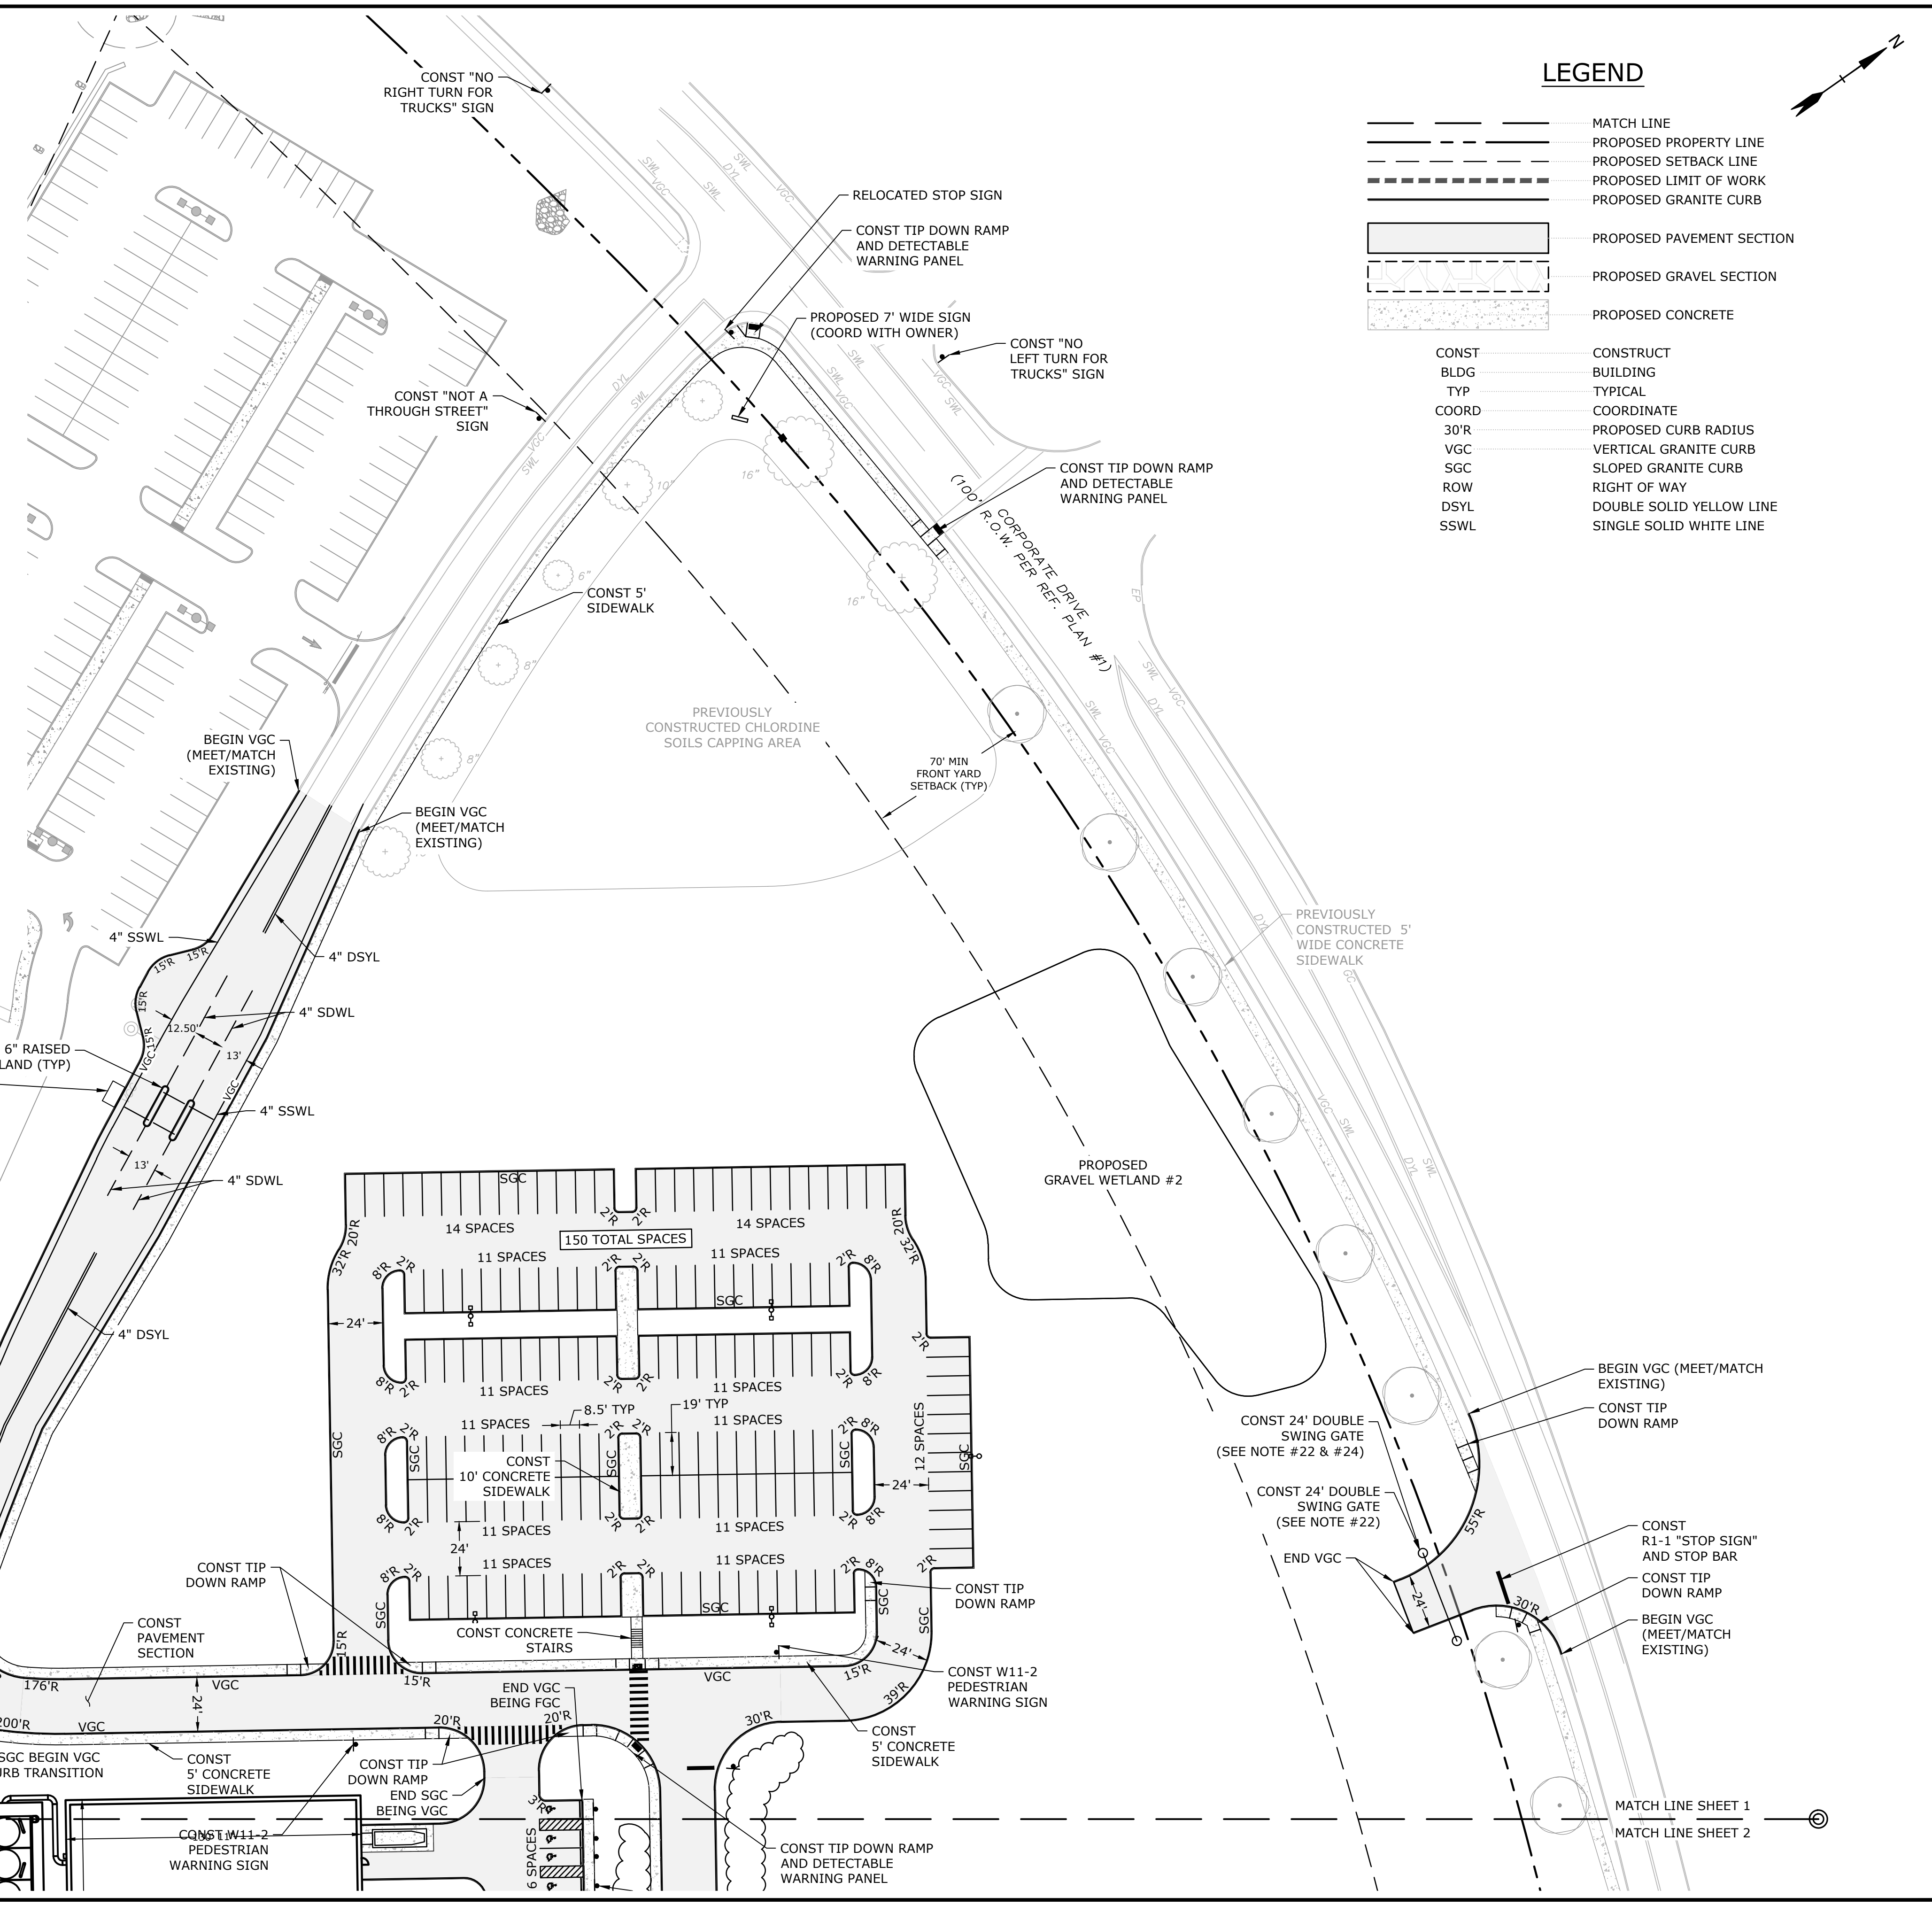


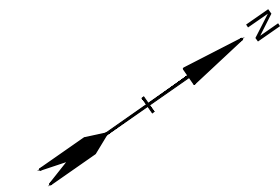LEGEND

- MATCH LINE
- PROPOSED PROPERTY LINE
- PROPOSED SETBACK LINE
- PROPOSED LIMIT OF WORK
- PROPOSED GRANITE CURB
- PROPOSED PAVEMENT SECTION
- PROPOSED GRAVEL SECTION
- PROPOSED CONCRETE
- CONST _____ CONSTRUCT
- BLDG _____ BUILDING
- TYP _____ TYPICAL
- COORD _____ COORDINATE
- 30'R _____ PROPOSED CURB RADIUS
- VGC _____ VERTICAL GRANITE CURB
- SGC _____ SLOPED GRANITE CURB
- ROW _____ RIGHT OF WAY
- DSYL _____ DOUBLE SOLID YELLOW LINE
- SSWL _____ SINGLE SOLID WHITE LINE

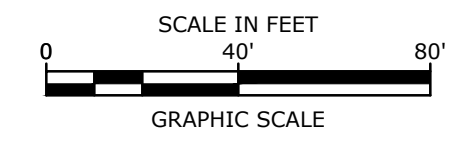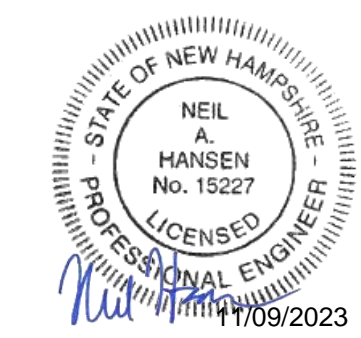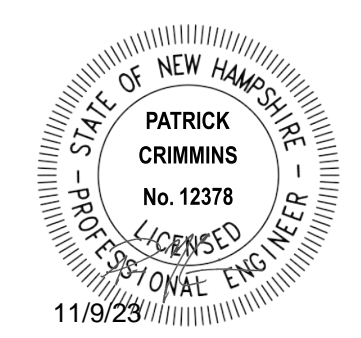

- SITE NOTES:**
1. STRIPE PARKING AREAS AS SHOWN, INCLUDING PARKING SPACES, STOP BARS, ADA SYMBOLS, PAINTED ISLANDS, CROSS WALKS, ARROWS, LEGENDS AND CENTERLINES (ALL MARKINGS EXCEPT CENTERLINE AND MEDIAN ISLANDS TO BE CONSTRUCTED USING WHITE TRAFFIC PAINT. CENTERLINE AND MEDIAN ISLANDS TO BE CONSTRUCTED USING YELLOW TRAFFIC PAINT. ALL TRAFFIC PAINT SHALL MEET THE REQUIREMENTS OF AASHTO M248 TYPE "F").
 2. ALL PAVEMENT MARKINGS AND SIGNS TO CONFORM TO "MANUAL ON UNIFORM TRAFFIC CONTROL DEVICES", "STANDARD ALPHABETS FOR HIGHWAY SIGNS AND PAVEMENT MARKINGS", AND THE AMERICANS WITH DISABILITIES ACT REQUIREMENTS, LATEST EDITIONS.
 3. SEE DETAILS FOR PARKING STALL MARKINGS, ADA SYMBOLS, SIGNS AND SIGN POSTS.
 4. CENTERLINES SHALL BE FOUR (4) INCH WIDE YELLOW LINES. STOP BARS SHALL BE EIGHTEEN (18) INCHES WIDE.
 5. PAINTED ISLANDS SHALL BE FOUR (4) INCH WIDE DIAGONAL LINES AT 3'-0" O.C. BORDERED BY FOUR (4) INCH WIDE LINES.
 6. THE CONTRACTOR SHALL EMPLOY A NEW HAMPSHIRE LICENSED SURVEYOR TO DETERMINE ALL LINES AND GRADES.
 7. CLEAN AND COAT VERTICAL FACE OF EXISTING PAVEMENT AT SAWCUT LINE WITH RS-1 EMULSION IMMEDIATELY PRIOR TO PLACING NEW BITUMINOUS CONCRETE.
 8. ALL MATERIALS AND CONSTRUCTION SHALL CONFORM WITH APPLICABLE FEDERAL, STATE AND/OR TOWN CODES & SPECIFICATIONS.
 9. COORDINATE ALL WORK WITHIN PUBLIC RIGHT OF WAY WITH THE CITY OF PORTSMOUTH AND PEASE DEVELOPMENT AUTHORITY.
 10. CONTRACTOR TO SUBMIT AS-BUILT PLANS IN DIGITAL FORMAT (.DWG AND .PDF FILES) ON DISK TO THE OWNER AND ENGINEER UPON COMPLETION OF THE PROJECT. AS-BUILTS SHALL BE PREPARED AND CERTIFIED BY A NEW HAMPSHIRE LICENSED LAND SURVEYOR.
 11. CONTRACTOR SHALL COORDINATE WITH THE BUILDING DRAWINGS FOR ALL CONCRETE PADS & SIDEWALKS ADJACENT TO BUILDING.
 12. ALL WORK SHALL CONFORM TO THE CITY OF PORTSMOUTH DEPARTMENT OF PUBLIC WORKS, STANDARD SPECIFICATIONS AND WITH THE STATE OF NEW HAMPSHIRE DEPARTMENT OF TRANSPORTATION, "STANDARD SPECIFICATIONS OF ROAD AND BRIDGE CONSTRUCTION", CURRENT EDITION.
 13. CONTRACTOR TO PROVIDE BACKFILL AND COMPACTION AT CURB LINE AFTER CONCRETE FORMS FOR SIDEWALKS AND PADS HAVE BEEN STRIPPED. COORDINATE WITH BUILDING CONTRACTOR.
 14. ALL LIGHT POLE BASES NOT PROTECTED BY A RAISED CURB SHALL BE PAINTED YELLOW.
 15. ALL DIMENSIONS ARE TO THE FACE OF CURB UNLESS OTHERWISE NOTED.
 16. UPON COMPLETION OF CONSTRUCTION AND PRIOR TO ISSUANCE OF CERTIFICATE OF OCCUPANCY AND RELEASE OF BOND, THE APPLICANT SHALL SUBMIT A LETTER TO THE PDA, SIGNED AND STAMPED BY A PROFESSIONAL ENGINEER, STATING CONSTRUCTION HAS BEEN COMPLETED IN CONFORMANCE WITH THE APPROVED PLANS.
 17. FIRE LANES AND FIRE DEPARTMENT CONNECTION POINTS SHALL BE KEPT CLEAR AT ALL TIMES, INCLUDING DURING WINTER CONDITIONS.
 18. FINAL NUMBER OF DOORS AND LOCATION OF DOORS TO BE APPROVED BY BUILDING AND FIRE DEPARTMENTS.
 19. COORDINATE ALL WORK ADJACENT TO BUILDING WITH BUILDING CONTRACTOR.
 20. SUBMISSION OF A MINIMUM OF TWO 7460-1'S TO THE FAA WILL BE REQUIRED FOR THE CONSTRUCTION OF THE BUILDING AND TEMPORARY USE OF A CRANE. ALLOW A MINIMUM OF 45 DAYS FOR PROCESSING.
 21. COORDINATE FINAL CONSTRUCTION LAYDOWN PARKING LAYOUT WITH OWNER PRIOR TO CONSTRUCTION.
 22. COORDINATE FINAL GATE TYPE WITH OWNER PRIOR TO CONSTRUCTION. COORDINATE GATE ELECTRICAL REQUIREMENTS WITH BUILDING DWGS AND ELECTRICAL DESIGN.
 23. COORDINATE THE RECONSTRUCTION OF GOOSE BAY DRIVE AND CORPORATE DRIVE INTERSECTION WITH THE CITY OF PORTSMOUTH.
 24. ALL GATES SHALL BE EQUIPPED WITH KNOX BOXES. COORDINATE WITH THE CITY OF PORTSMOUTH FIRE DEPARTMENT.



Proposed Industrial Development

Lonza Biologics

Portsmouth, New Hampshire

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L	9/1/2022	Issued for Construction
K	5/27/2022	Issued for Bid
J	5/23/2022	Third Party Rev. Comments
I	4/26/2022	Revised PB Stipulations






PROJECT NO:	L-0700-013
DATE:	04/03/2018
FILE:	L-0700-026-C-DSGN.dwg
DRAWN BY:	CJK
CHECKED:	NAH
APPROVED:	PMC

PHASE 2 SITE PLAN

SCALE: AS SHOWN

C-165

Last Save Date: November 9, 2023 11:03 AM By: NAHANSEN
 Plot Date: Thursday, November 09, 2023 Plotted By: Neil A. Hansen
 P&E File Location: J:\L-0700\Lonza Biologics Expansion.was 15767.026 Project Abstract\Drawings\AutoCAD\L-0700-026-C-DSGN.dwg Layout Tab: C-165

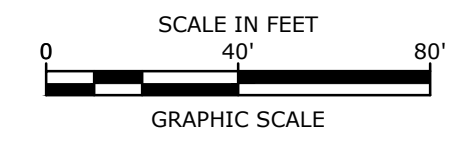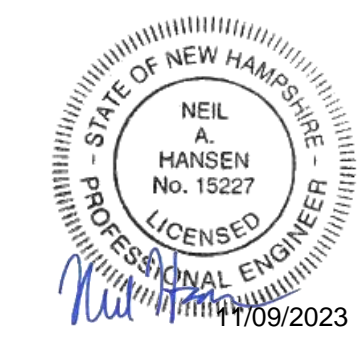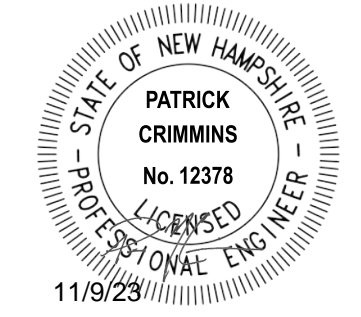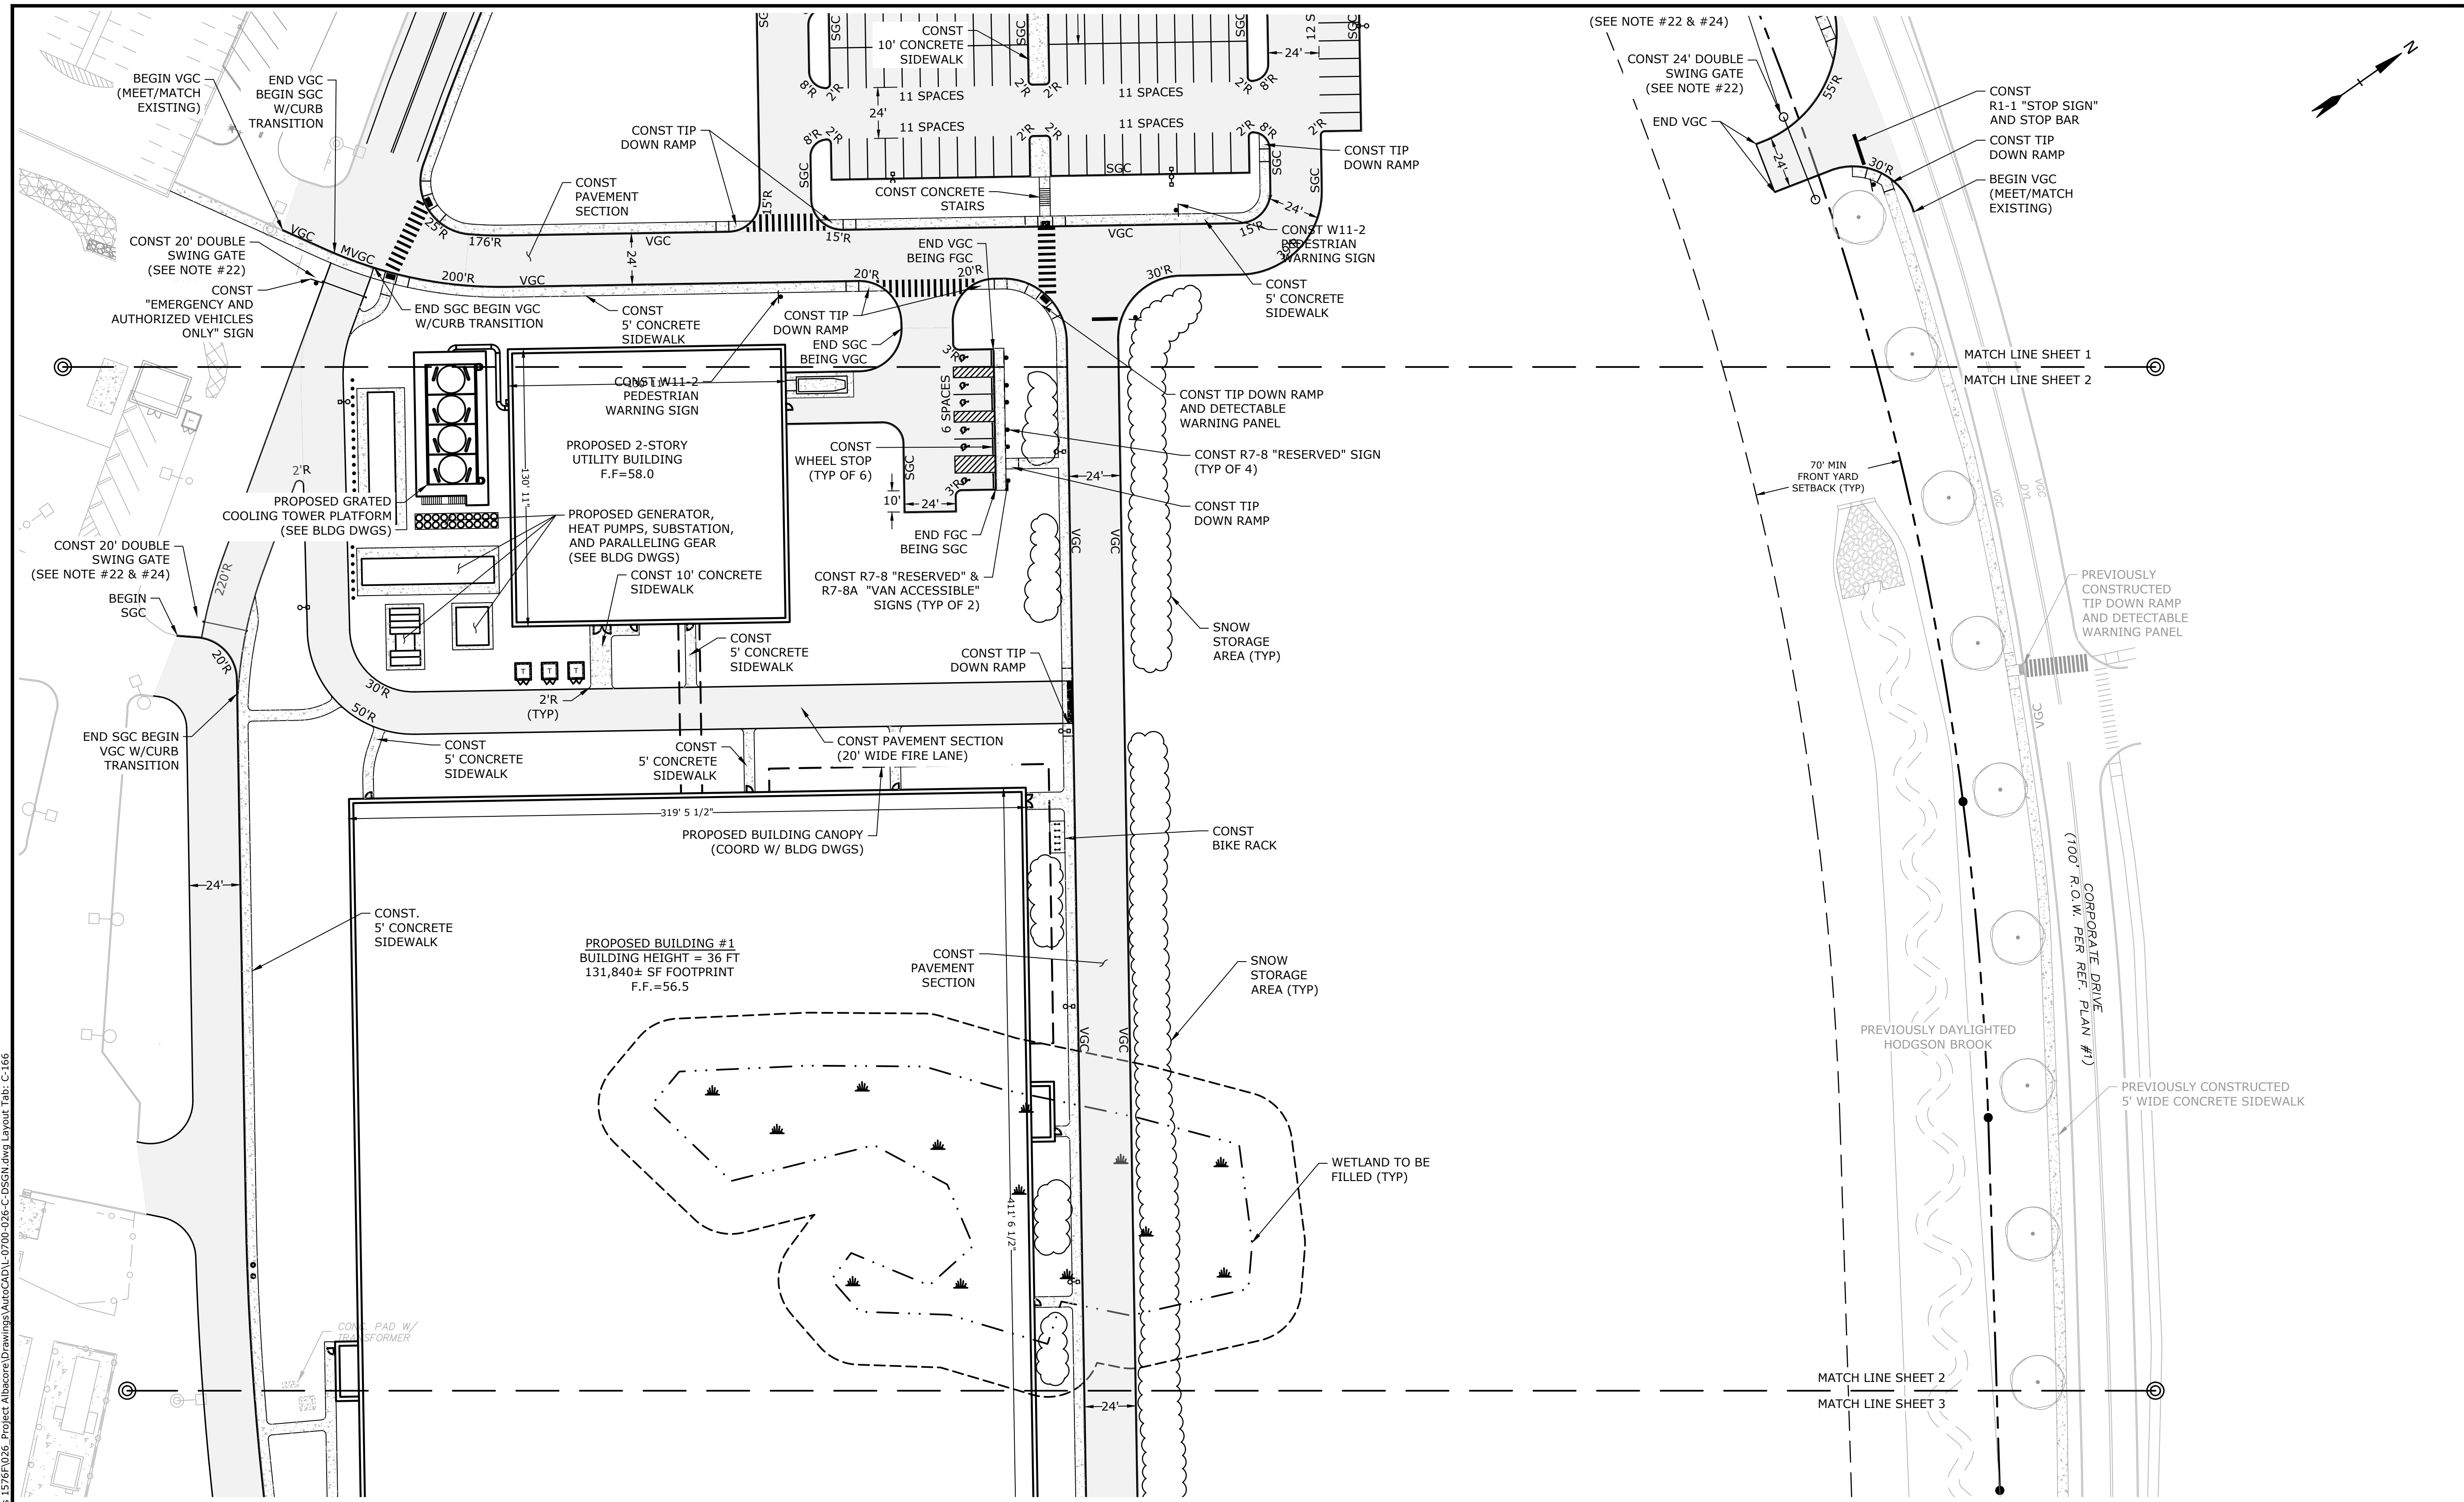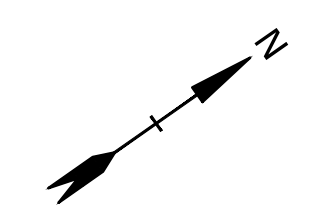

Proposed Industrial Development

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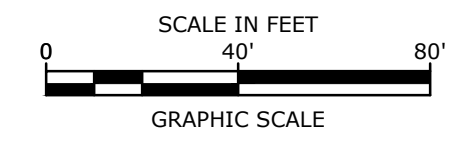
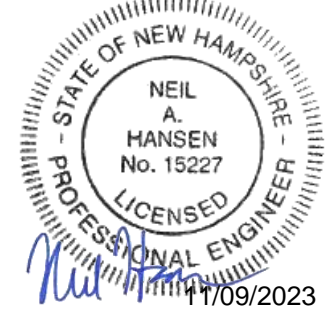
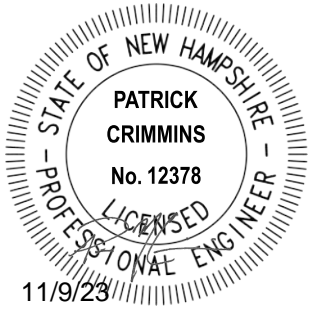
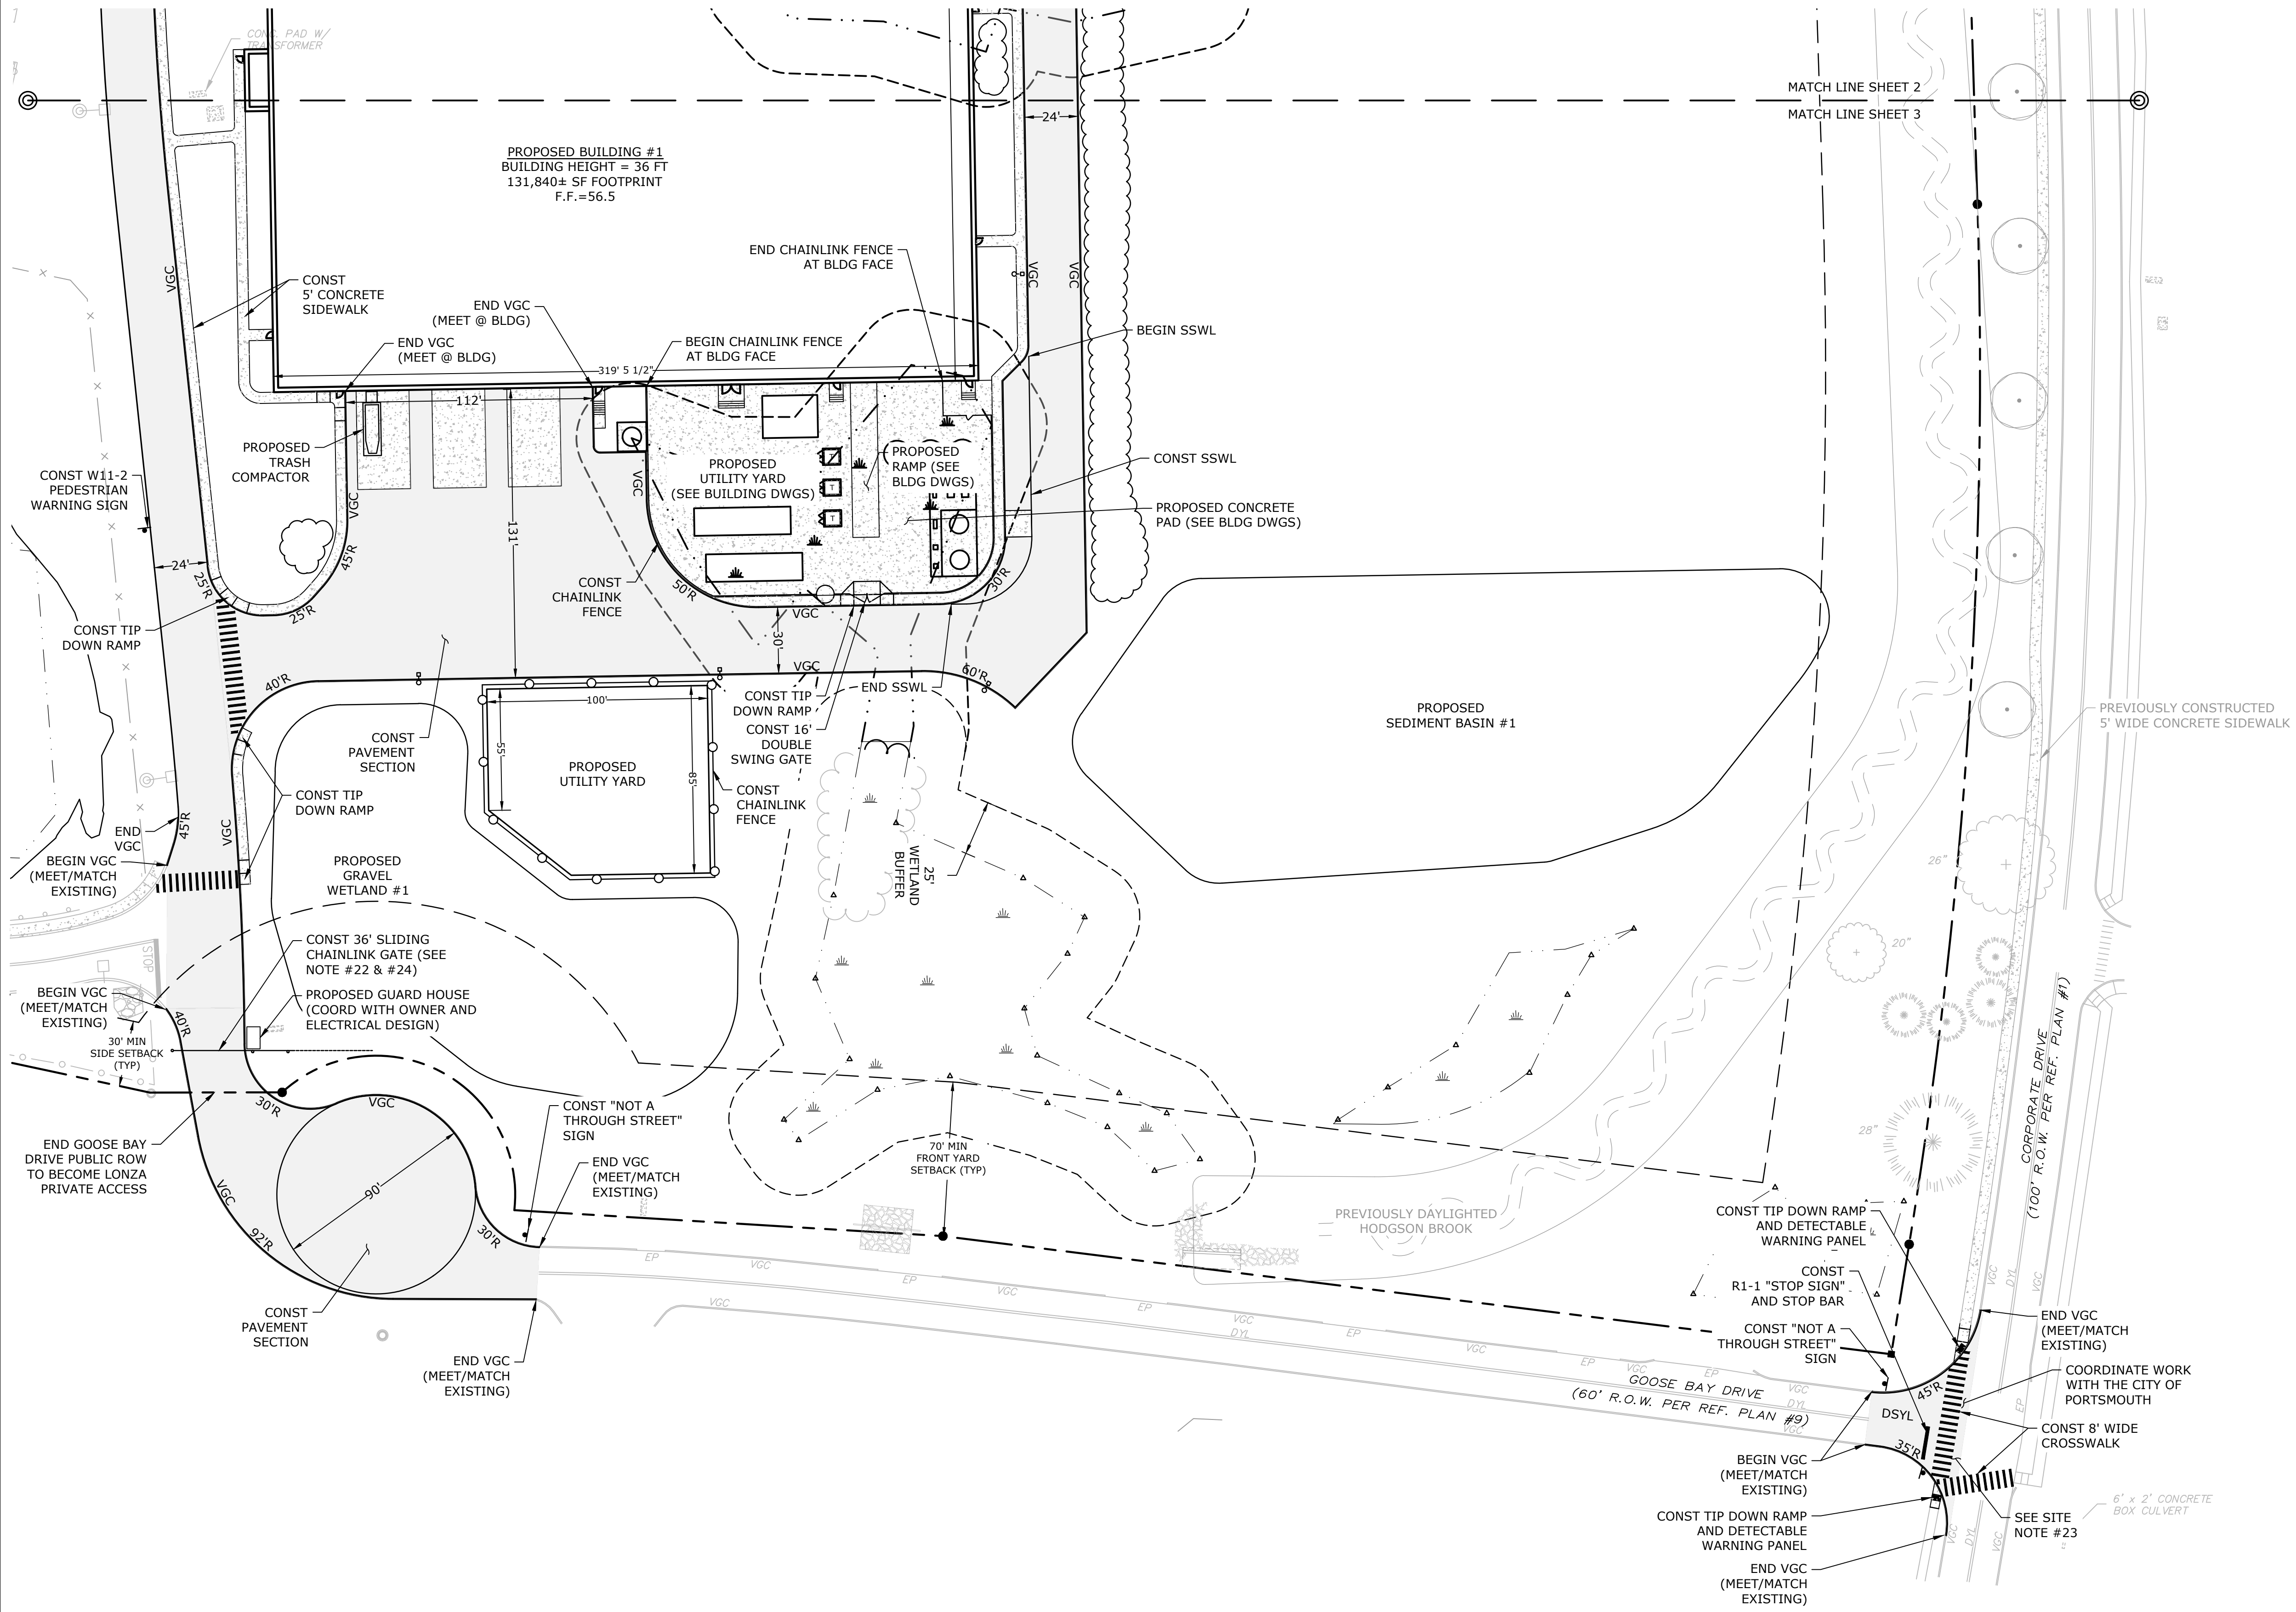
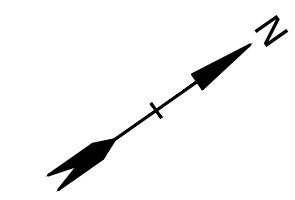
PHASE 2 SITE PLAN

SCALE: AS SHOWN

C-166

SEE SHEET C-165 FOR LEGEND AND SITE NOTES

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 Plot Date: Thursday, November 09, 2023 Plotted By: Neil A. Hansen
 P&E File Location: J:\0700 Lonza Biologics Expansion.was 12/08/2026 Project Subarea Drawings\AutoCAD\0700-026-C-DSGN.dwg Layout Tab: C-166



Proposed Industrial Development

Lonza Biologics

Portsmouth, New Hampshire

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PROJECT NO:	L-0700-013
DATE:	04/03/2018
FILE:	L-0700-026-C-DSGN.dwg
DRAWN BY:	CIK
CHECKED:	NAH
APPROVED:	PMC



PHASE 2 SITE PLAN

SCALE: AS SHOWN

C-167

SEE SHEET C-165 FOR LEGEND AND SITE NOTES

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 Plot Date: Thursday, November 09, 2023 Plotted By: Neil A. Hansen
 P&E File Location: J:\L0700\Lonza Biologics Expansion.was 12/20/2026 Project Subarea Drawings\AutoCAD\0700-026-C-DSGN.dwg Layout Tab: C-167

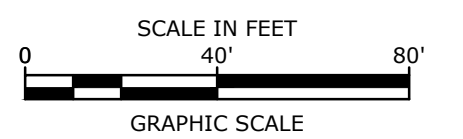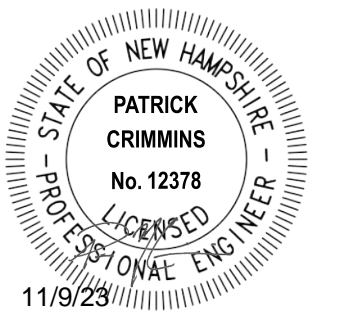

Proposed Industrial Development

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DRAWN BY:	CIJ
CHECKED:	NAH
APPROVED:	PMC

PHASE 2 GRADING, DRAINAGE & EROSION CONTROL PLAN

SCALE: AS SHOWN

GRADING AND DRAINAGE NOTES:


1. COMPACTION REQUIREMENTS:
BELOW PAVED OR CONCRETE AREAS 95%
TRENCH BEDDING MATERIAL AND SAND BLANKET BACKFILL 95%
BELOW LOAM AND SEED AREAS 90%
* ALL PERCENTAGES OF COMPACTION SHALL BE OF THE MAXIMUM DRY DENSITY AT THE OPTIMUM MOISTURE CONTENT AS DETERMINED AND CONTROLLED IN ACCORDANCE WITH ASTM D-1557, METHOD C FIELD DENSITY TESTS SHALL BE MADE IN ACCORDANCE WITH ASTM D-1556 OR ASTM-2922.
2. ALL STORM DRAINAGE PIPES SHALL BE HIGH DENSITY POLYETHYLENE (HANCOR HI-Q, ADS N-12 OR APPROVED EQUAL), UNLESS OTHERWISE SPECIFIED.
3. SEE UTILITIES PLAN FOR ALL SITE UTILITY INFORMATION.
4. ADJUST ALL MANHOLES, CATCHBASINS, CURB BOXES, ETC. WITHIN LIMITS OF WORK TO FINISH GRADE.
5. CONTRACTOR SHALL PROVIDE A FINISH PAVEMENT SURFACE AND LAWN AREAS FREE OF LOW SPOTS AND PONDING AREAS. CRITICAL AREAS INCLUDE BUILDING ENTRANCES, EXITS, RAMPS AND LOADING DOCK AREAS ADJACENT TO THE BUILDING.
6. CONTRACTOR SHALL THOROUGHLY CLEAN ALL CATCHBASINS AND DRAIN LINES, WITHIN THE LIMIT OF WORK, OF SEDIMENT IMMEDIATELY UPON COMPLETION OF CONSTRUCTION.
7. ALL MATERIALS AND CONSTRUCTION SHALL CONFORM WITH APPLICABLE FEDERAL, STATE AND LOCAL CODES.
8. ALL DISTURBED AREAS NOT TO BE PAVED OR OTHERWISE TREATED SHALL RECEIVE 6" LOAM, SEED FERTILIZER AND MULCH.
9. ALL STORM DRAIN CONSTRUCTION SHALL BE IN ACCORDANCE WITH THE NHDOT STANDARD SPECIFICATIONS FOR HIGHWAYS AND BRIDGES, LATEST EDITION.
10. ALL PROPOSED CATCHBASINS SHALL BE EQUIPPED WITH OIL/GAS SEPARATOR HOODS AND 4' SUMPS.
11. CONTRACTOR TO SUBMIT AS-BUILT PLANS IN DIGITAL FORMAT (.DWG AND .PDF FILES) ON DISK TO THE OWNER AND ENGINEER UPON COMPLETION OF THE PROJECT. AS-BUILTS SHALL BE PREPARED AND CERTIFIED BY A NEW HAMPSHIRE LICENSED LAND SURVEYOR.
12. CONTRACTOR SHALL COORDINATE WITH THE PROJECT SURVEYOR FOR BENCHMARK AND CONTROL POINTS PRIOR TO CONSTRUCTION.
13. ALL WORK SHALL CONFORM TO THE CITY OF PORTSMOUTH DEPARTMENT OF PUBLIC WORKS, STANDARD SPECIFICATIONS, AND WITH THE STATE OF NEW HAMPSHIRE DEPARTMENT OF TRANSPORTATION, "STANDARD SPECIFICATIONS OF ROAD AND BRIDGE CONSTRUCTION", CURRENT EDITION.
14. PER COORDINATION WITH THE PDA, GROUNDWATER DISCHARGE FROM THE PROPOSED FOUNDATION DRAIN AND UNDER-SLAB DRAIN OF BUILDING 1 AND THE CENTRAL UTILITY BUILDING WILL BE CONNECTED TO THE ONSITE DRAINAGE SYSTEM. IF TREATMENT OF THE GROUNDWATER DISCHARGE IS DETERMINED TO BE REQUIRED DURING THE BUILDING PERMITTING PROCESS AND RE-INFILTRATION IS NOT PERMITTED, A CARBON FILTRATION SYSTEM WILL BE NEEDED.

EROSION CONTROL NOTES:

1. INSTALL EROSION CONTROL BARRIERS AS SHOWN AS FIRST ORDER OF WORK.
2. SEE GENERAL EROSION CONTROL NOTES ON DETAIL SHEETS.
3. PROVIDE INLET PROTECTION AROUND ALL EXISTING AND PROPOSED CATCHBASIN INLETS WITHIN THE WORK LIMITS. MAINTAIN FOR THE DURATION OF THE PROJECT UNTIL PAVEMENT HAS BEEN INSTALLED.
4. INSTALL STABILIZED CONSTRUCTION ENTRANCES.
5. INSPECT INLET PROTECTION AND SILT FENCES DAILY AND AFTER EACH RAIN STORM OF 0.25 INCH OR GREATER. REPAIR/MODIFY PROTECTION AS NECESSARY TO MAXIMIZE EFFICIENCY OF FILTER. REPLACE ALL FILTERS WHEN SEDIMENT IS 1/3 THE FILTER HEIGHT.
6. ALL DISTURBED AREAS NOT TO BE PAVED OR OTHERWISE TREATED SHALL RECEIVE 6" LOAM, SEED, FERTILIZER AND MULCH.
7. CONSTRUCT EXCELSIOR MAT ON ALL SLOPES STEEPER THAN 3:1.
8. PRIOR TO ANY WORK OR SOIL DISTURBANCE COMMENCING ON THE SUBJECT PROPERTY, INCLUDING MOVING OF EARTH, THE APPLICANT SHALL INSTALL ALL EROSION AND SILTATION MITIGATION AND CONTROL MEASURES AS REQUIRED BY STATE AND LOCAL PERMITS AND APPROVALS.
9. CONTRACTOR SHALL BE RESPONSIBLE TO CONTROL DUST AND WIND EROSION THROUGHOUT THE CONSTRUCTION PERIOD. DUST CONTROL MEASURES SHALL INCLUDE, BUT NOT LIMITED TO, SPRINKLING WATER ON UNSTABLE SOILS SUBJECT TO ARID CONDITIONS.
10. THE CONTRACTOR SHALL REMOVE AND PROPERLY DISPOSE OF ALL TEMPORARY EROSION CONTROL DEVICES UPON COMPLETION OF CONSTRUCTION AND FINAL STABILIZATION.
11. ALL CATCHBASIN SUMPS AND PIPING SHALL BE THOROUGHLY CLEANED TO REMOVE ALL SEDIMENT AND DEBRIS AFTER THE PROJECT HAS BEEN PAVED.
12. TEMPORARY SOIL STOCKPILE SHALL BE SURROUNDED BY SILT FENCE AND SHALL BE STABILIZED BY TEMPORARY EROSION CONTROL SEEDING. STOCKPILE AREAS TO BE LOCATED AS FAR AS POSSIBLE FROM THE DELINEATED EDGE OF WETLAND.
13. SAFETY FENCING SHALL BE PROVIDED AROUND STOCKPILES OVER 10 FT.
14. CONCRETE TRUCKS WILL BE REQUIRED TO WASH OUT (IF NECESSARY) SHOOT ONLY WITHIN AREAS WHERE CONCRETE HAS BEEN PLACED. NO OTHER WASH OUT WILL BE ALLOWED.






LEGEND

---	MATCH LINE
---	PROPOSED PROPERTY LINE
---	PROPOSED CONTOUR LINE
---	PROPOSED DRAIN LINE (TYP)
---	PROPOSED SILT SOCK
○	INLET PROTECTION SILT SACK
○	PROPOSED CATCHBASIN
○	PROPOSED DOUBLE GRATE CATCHBASIN
○	PROPOSED DRAIN MANHOLE
---	CONST
---	BLDG
---	BUILDING
---	TYP
---	COORD
---	RD
---	ROOF DRAIN
---	VIF
---	VERIFY IN FIELD
---	TC
---	TOP OF CURB
---	BC
---	BOTTOM OF CURB

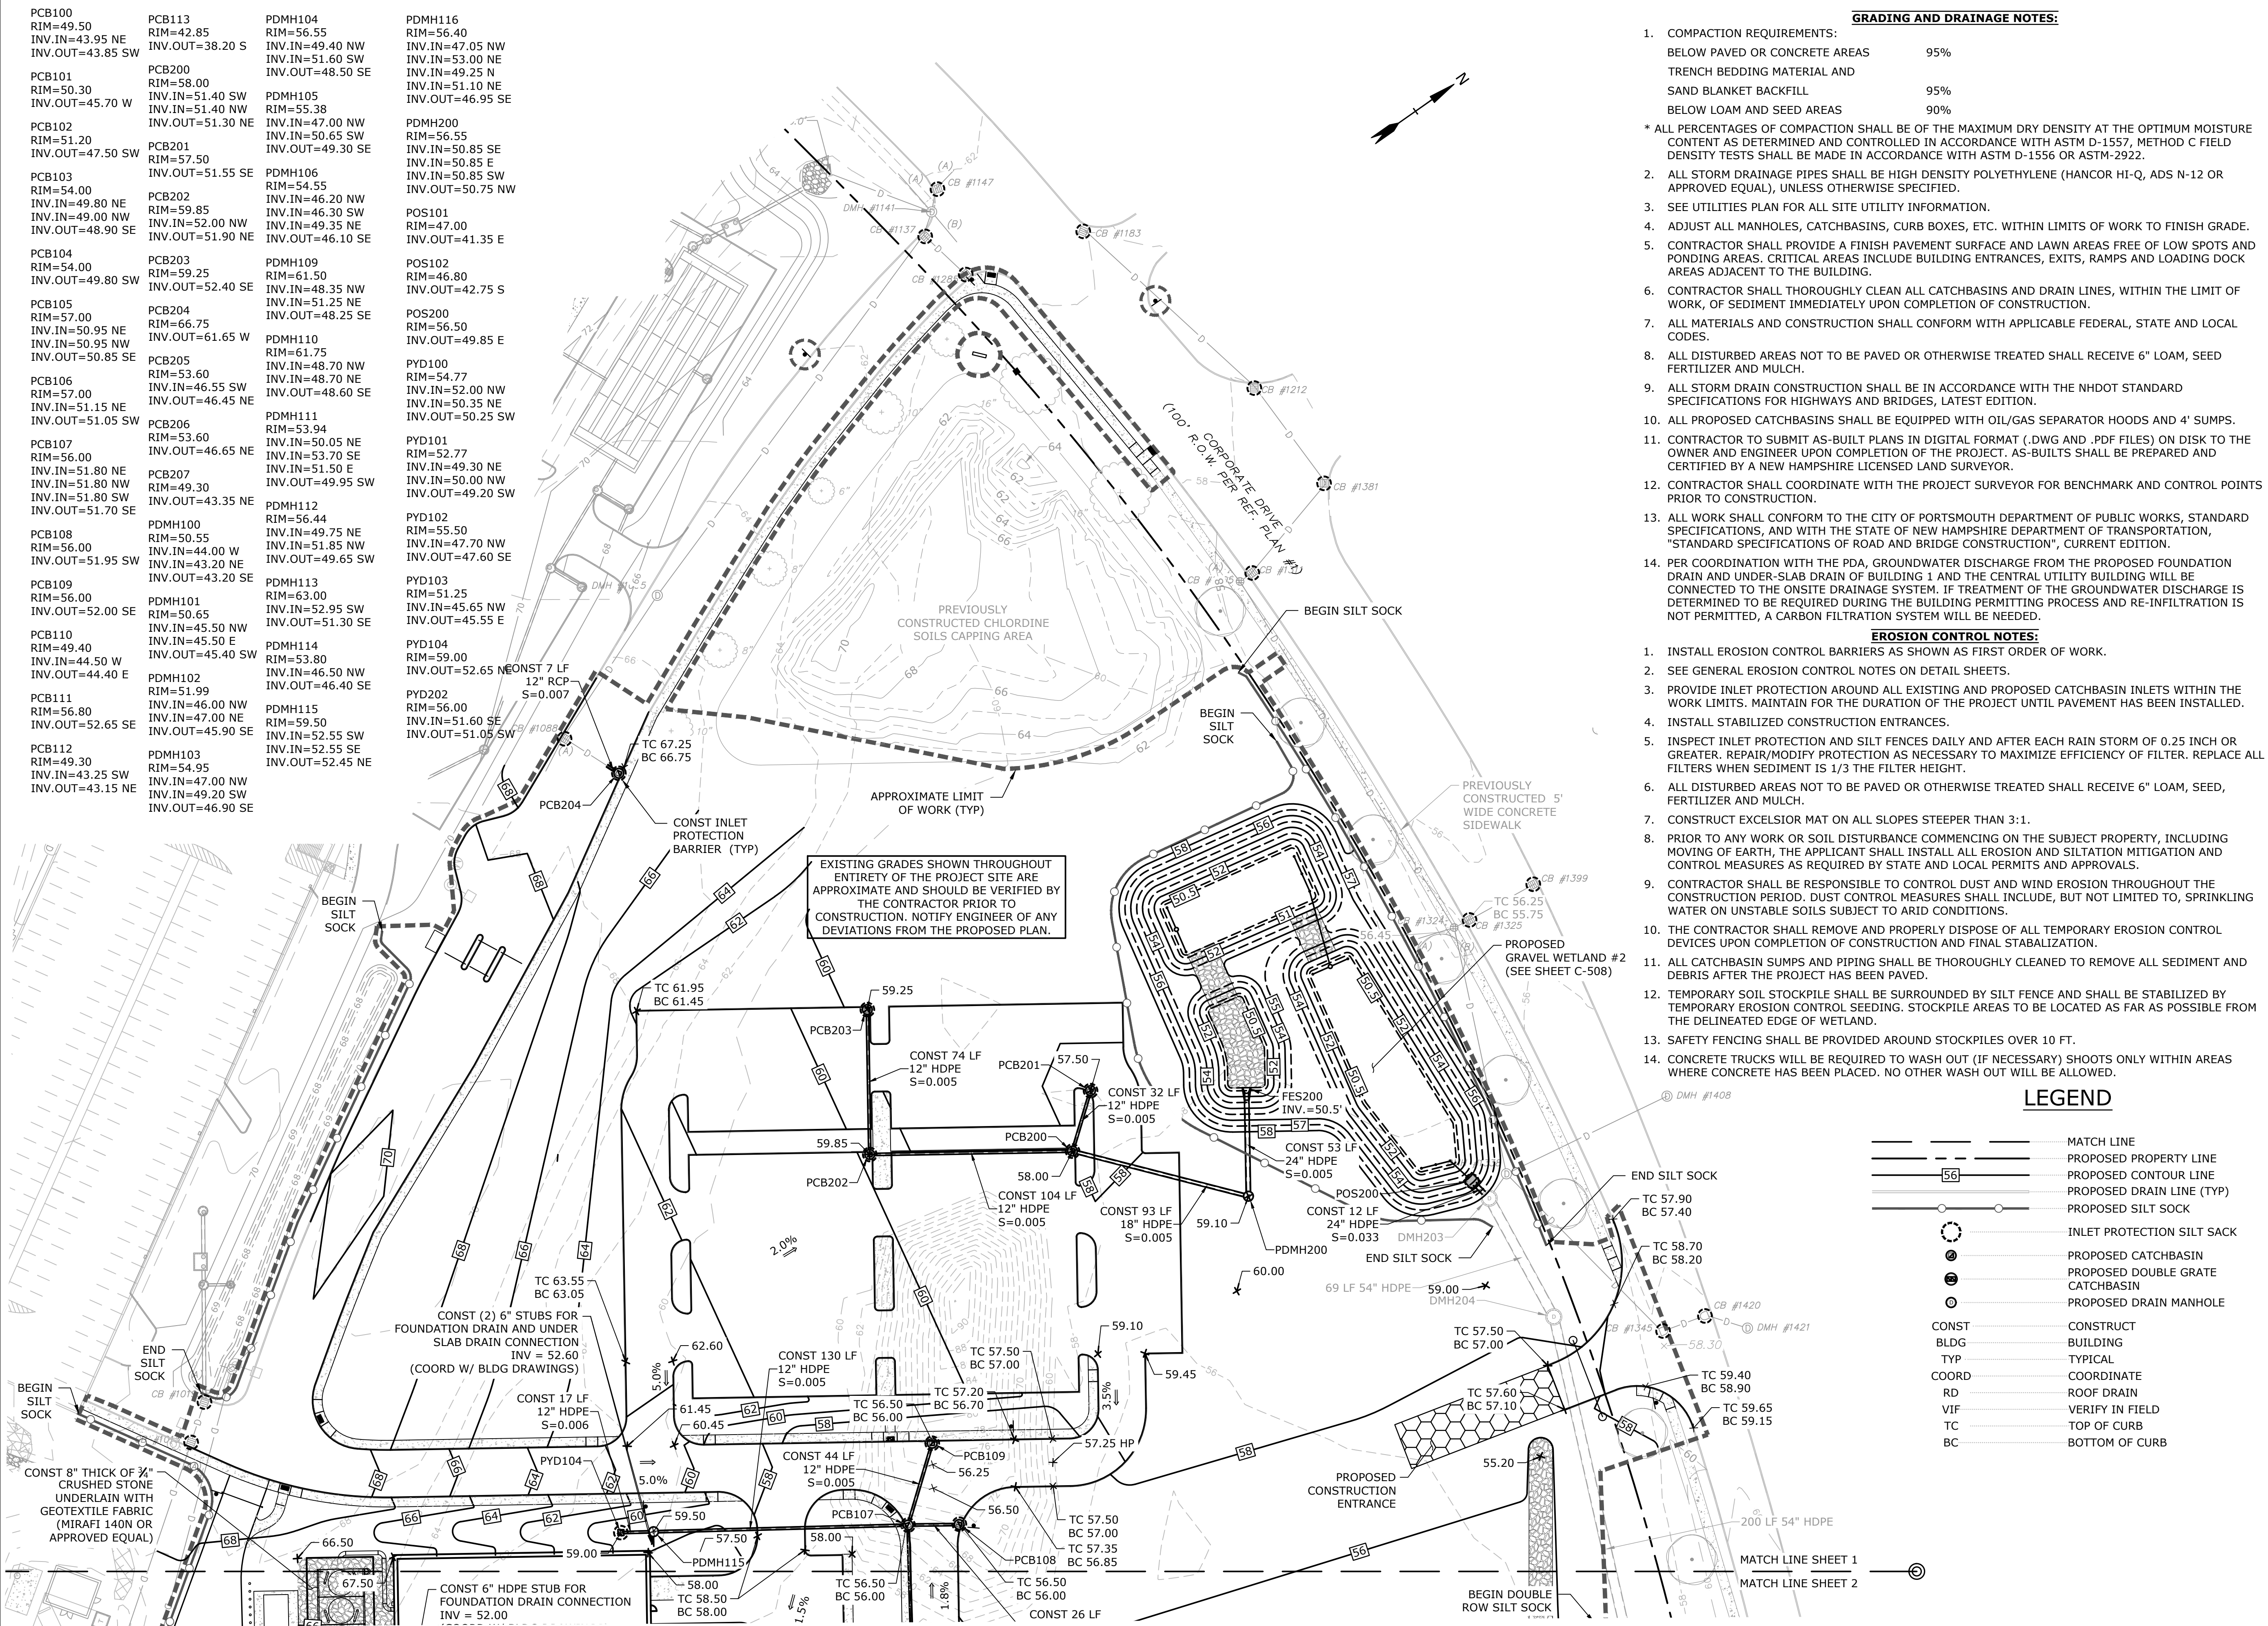

EXISTING GRADES SHOWN THROUGHOUT ENTIRETY OF THE PROJECT SITE ARE APPROXIMATE AND SHOULD BE VERIFIED BY THE CONTRACTOR PRIOR TO CONSTRUCTION. NOTIFY ENGINEER OF ANY DEVIATIONS FROM THE PROPOSED PLAN.

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Proposed Industrial Development
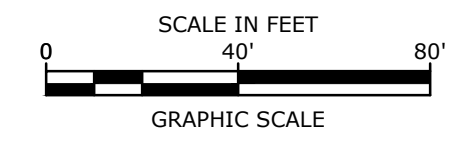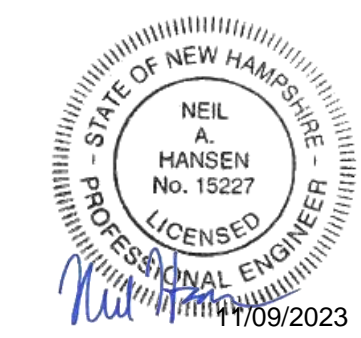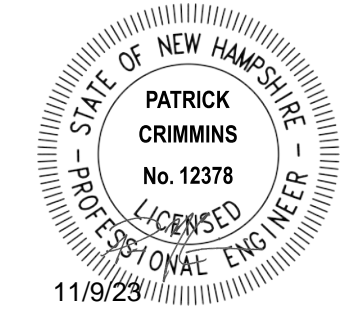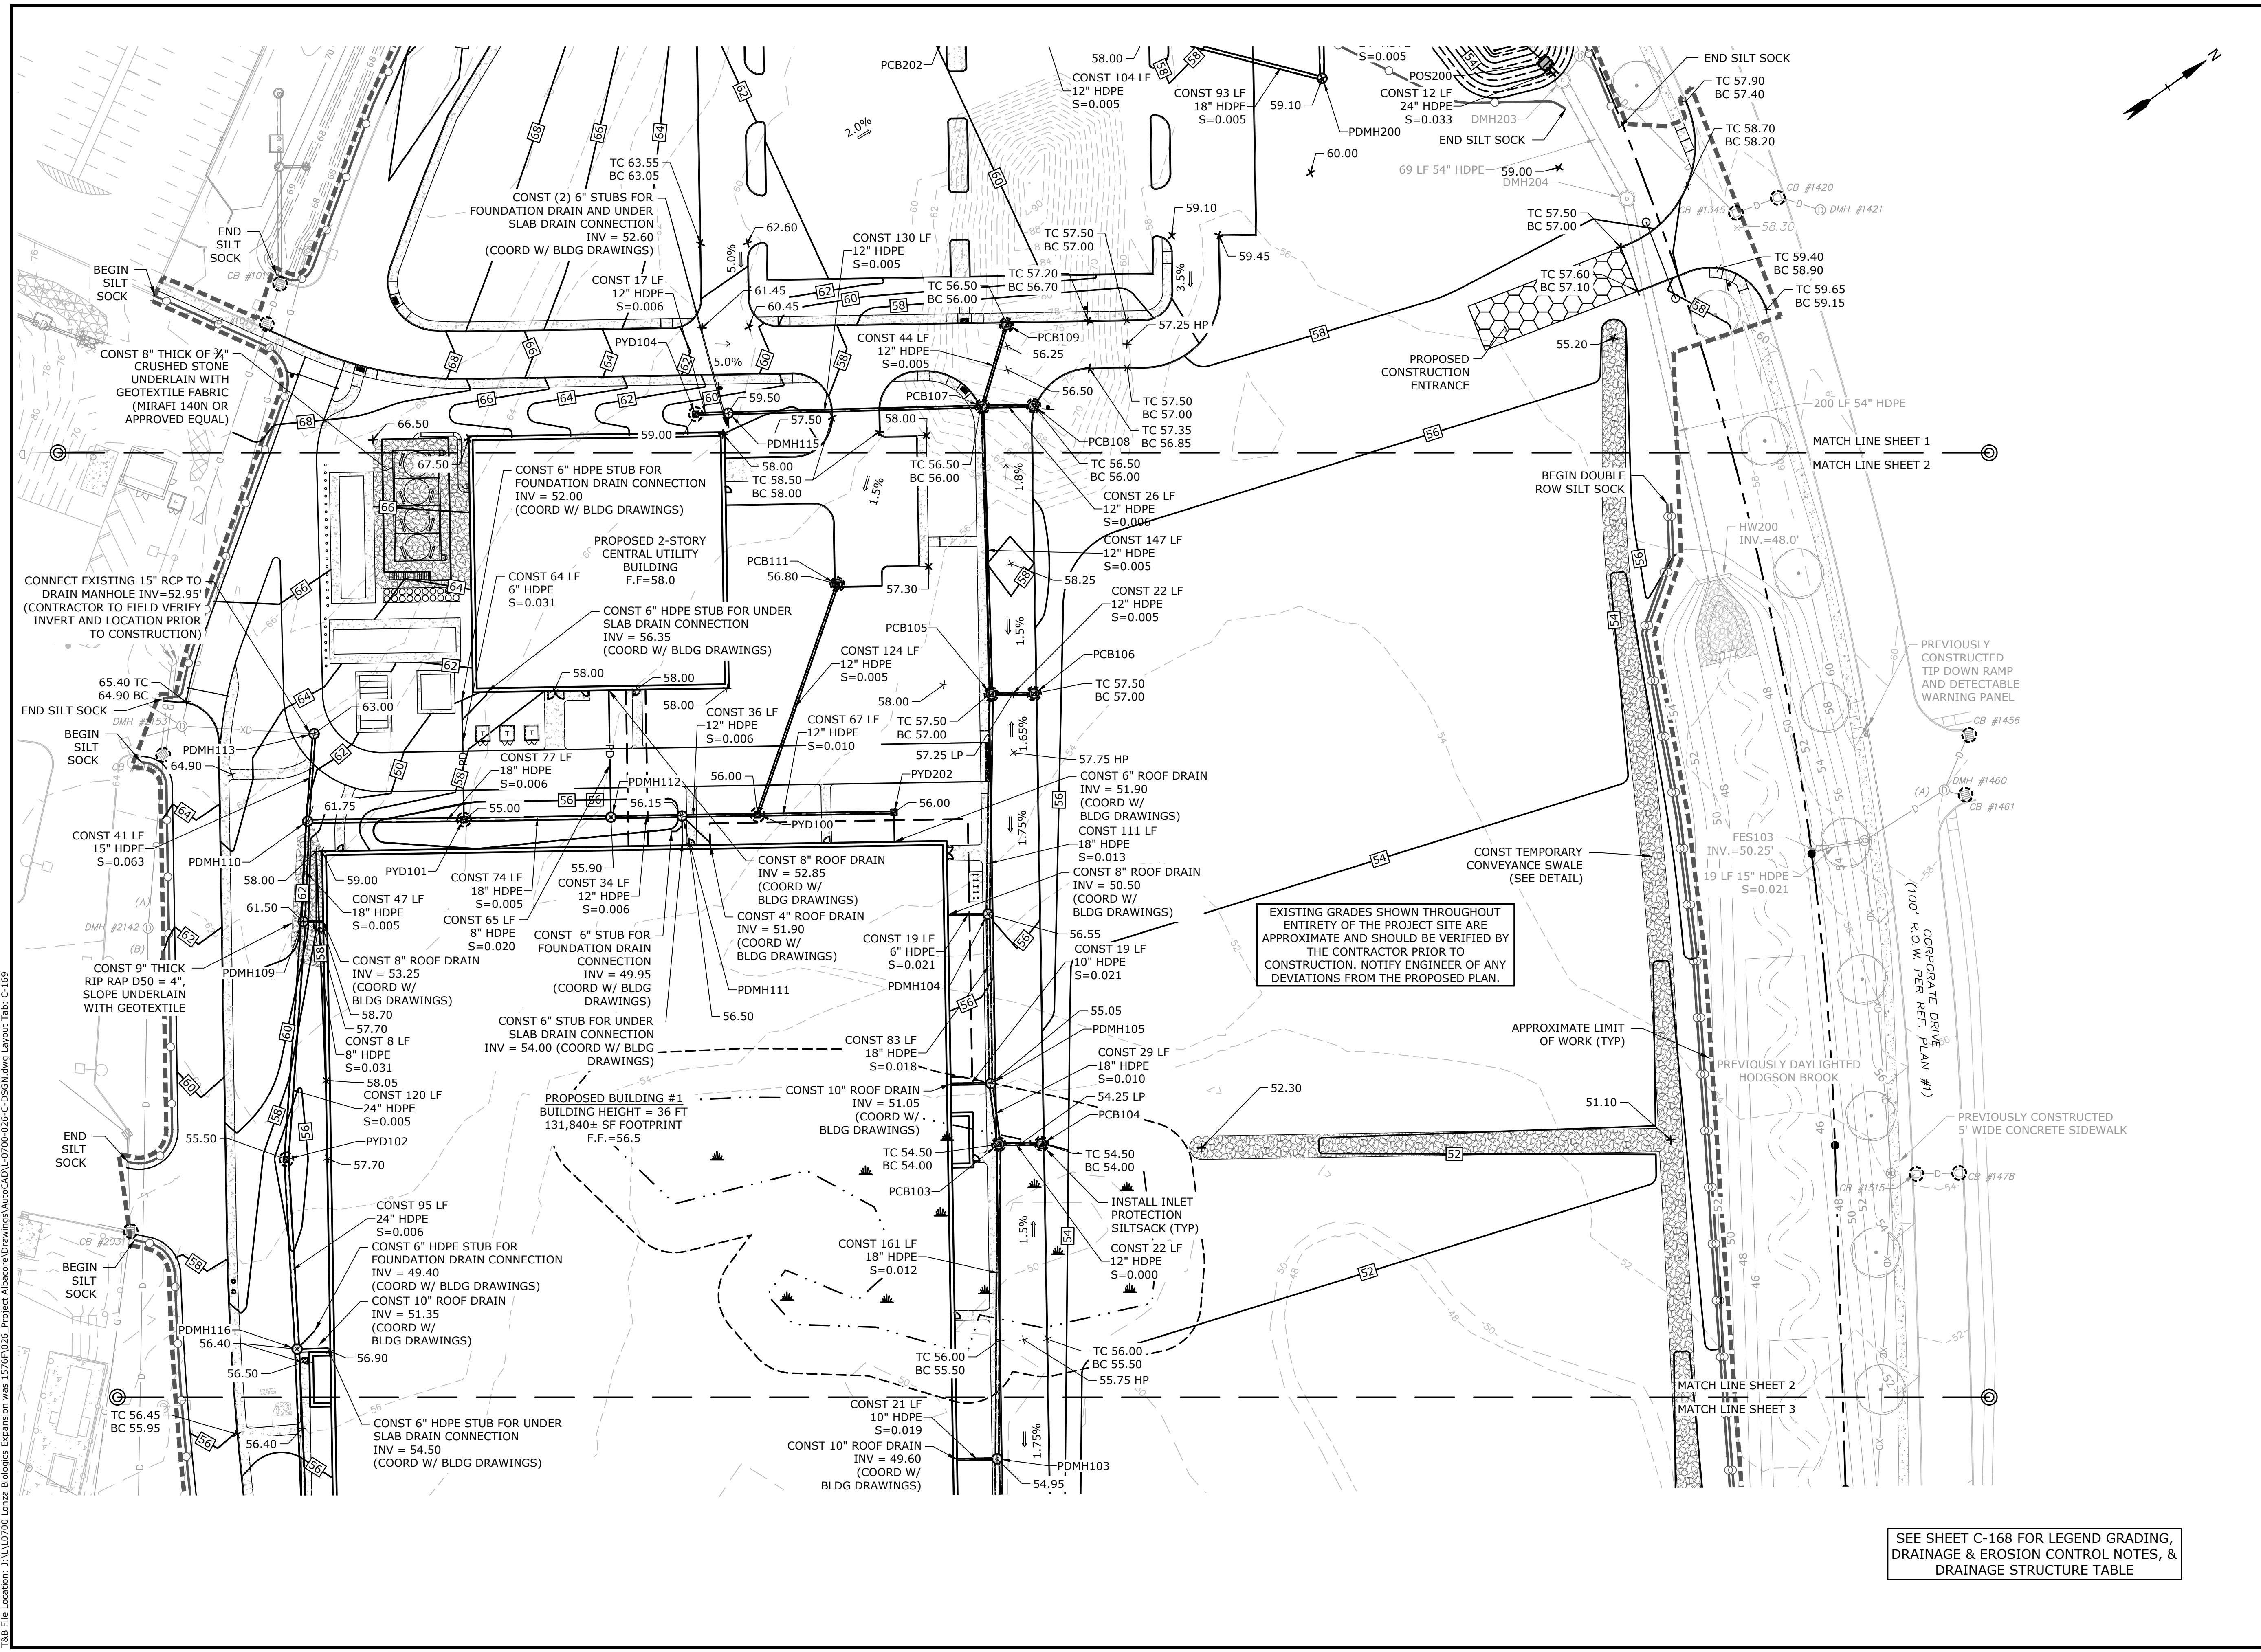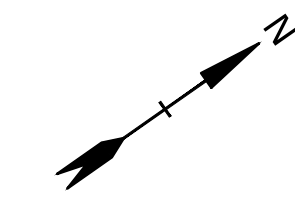
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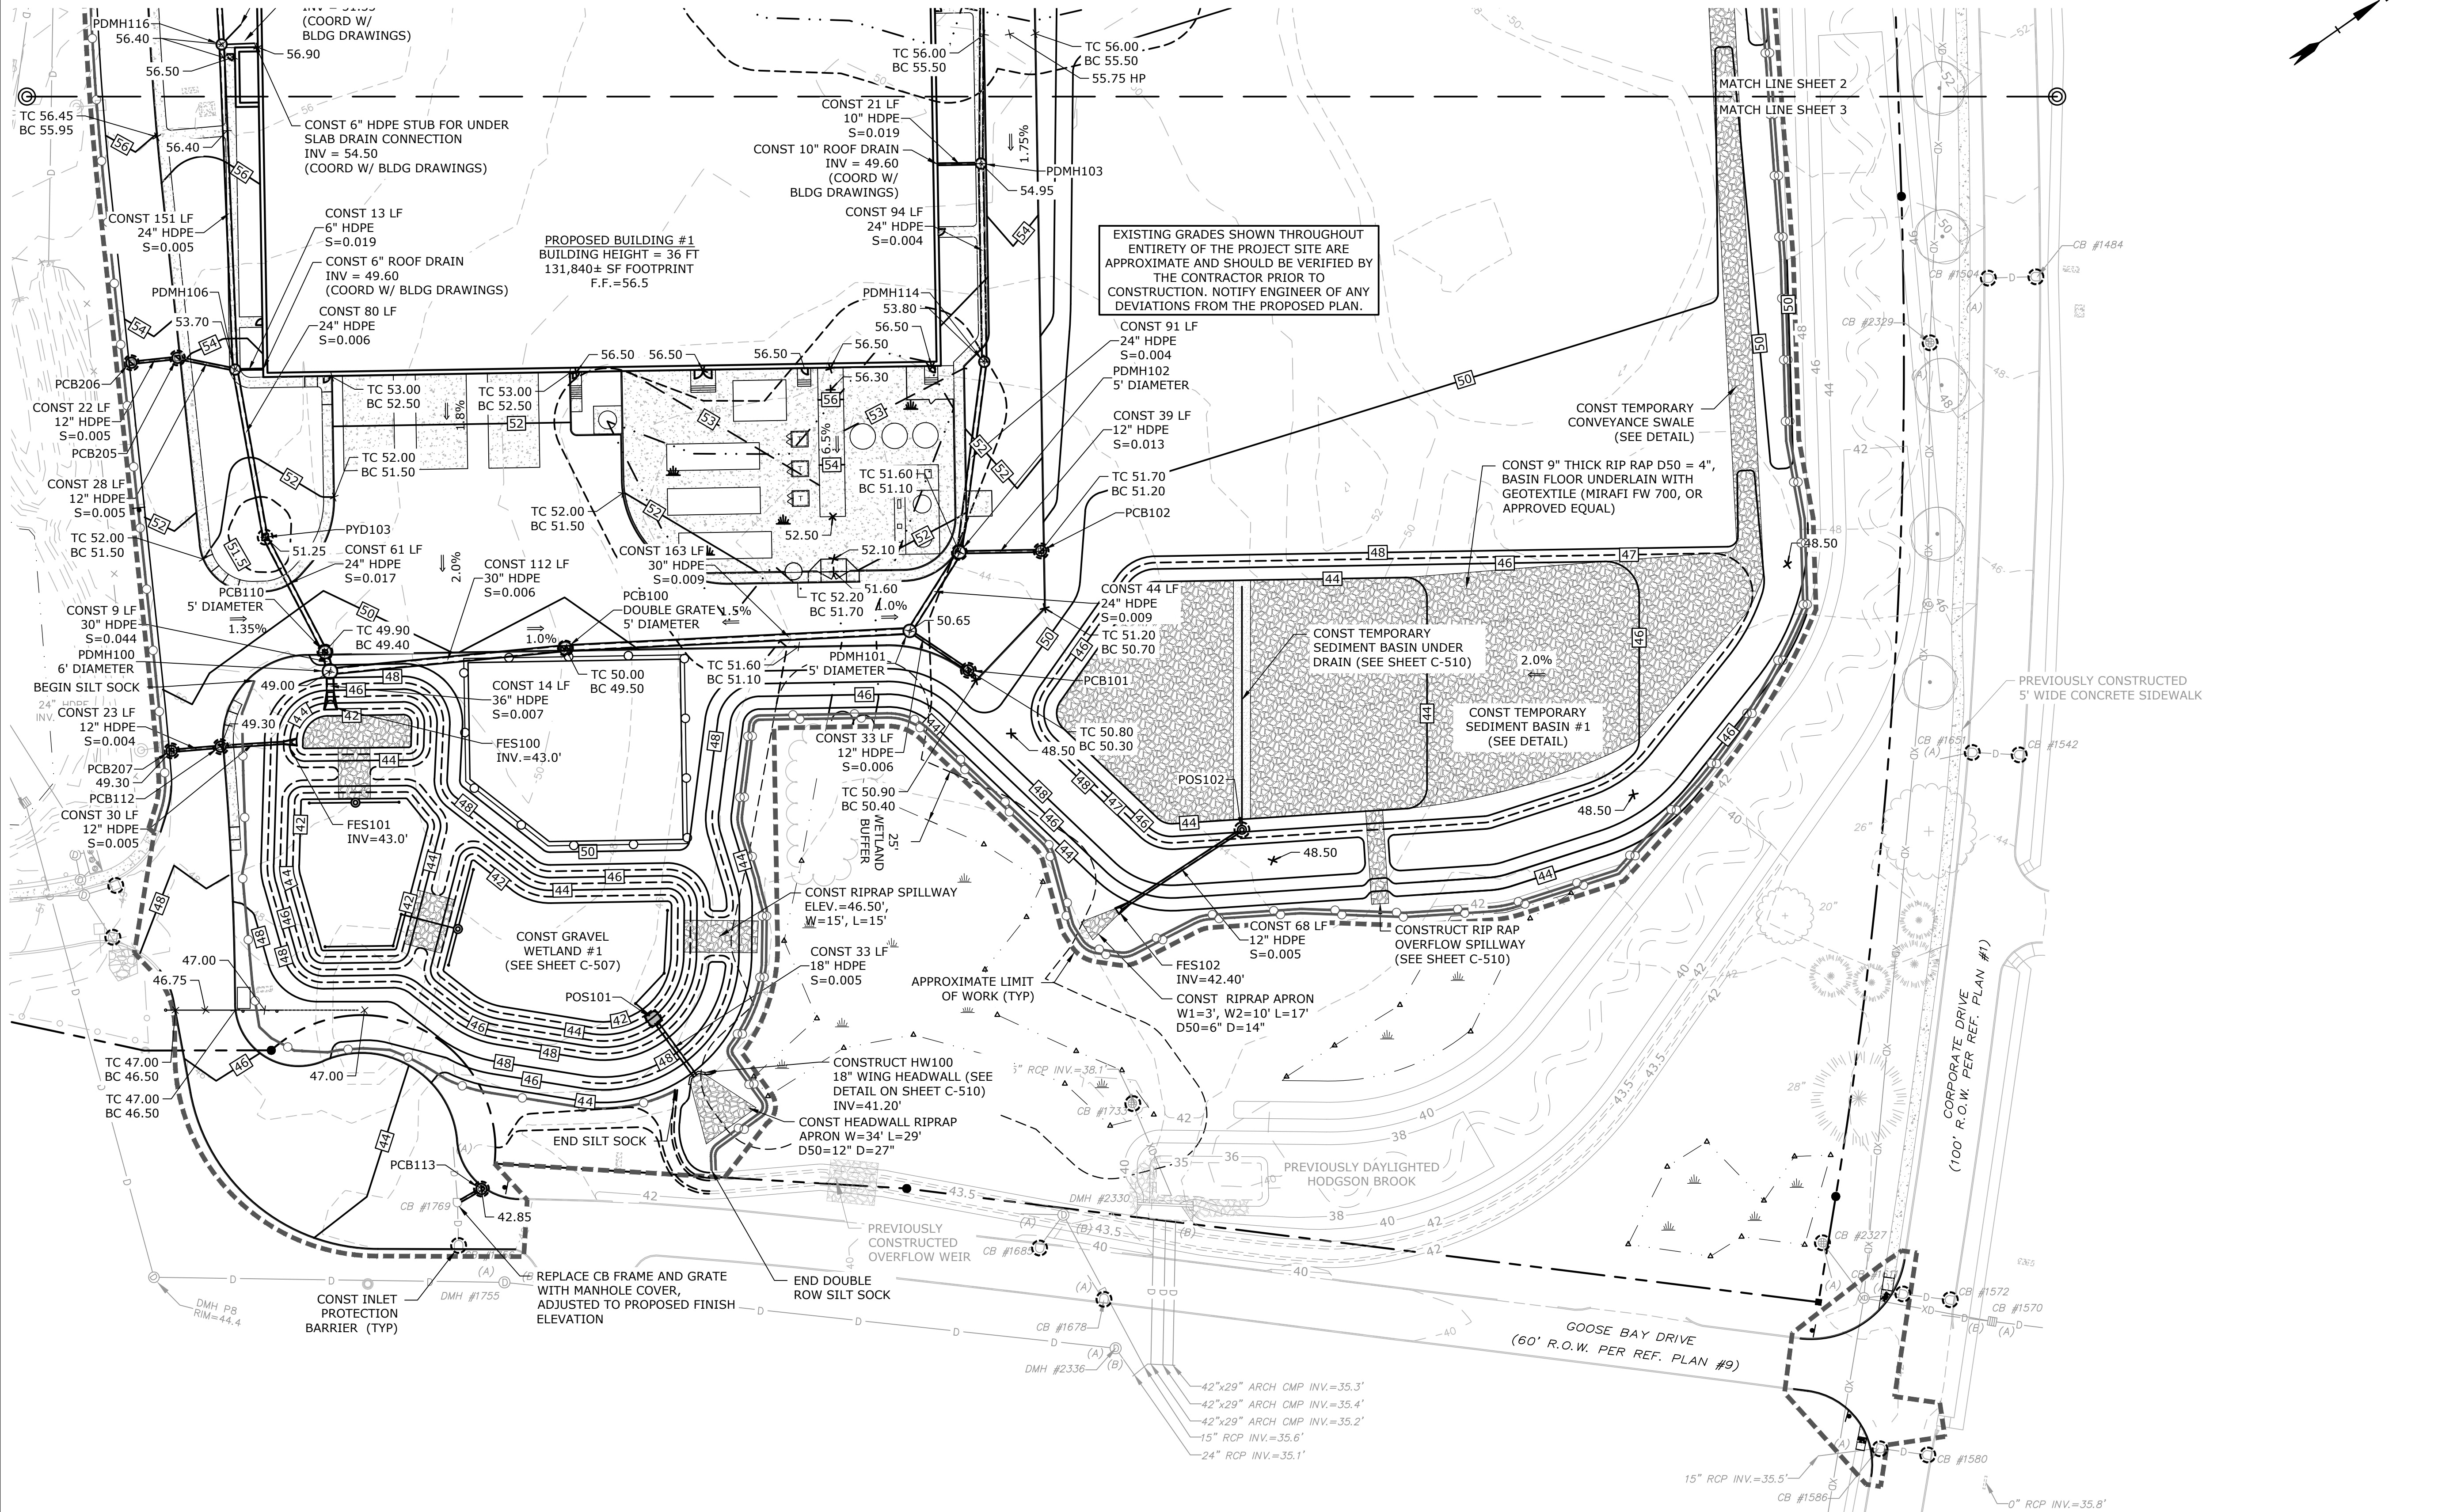
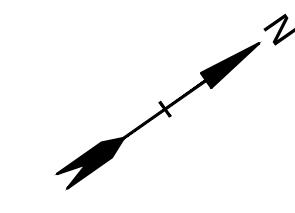
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APPROVED:	PMC




SEE SHEET C-168 FOR LEGEND GRADING, DRAINAGE & EROSION CONTROL NOTES, & DRAINAGE STRUCTURE TABLE

PHASE 2
GRADING, DRAINAGE & EROSION CONTROL PLAN
SCALE: AS SHOWN

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 CHECKED: NAH
 APPROVED: PMC

PHASE 2
 GRADING, DRAINAGE &
 EROSION CONTROL PLAN
 SCALE: AS SHOWN

SEE SHEET C-168 FOR LEGEND GRADING, DRAINAGE & EROSION CONTROL NOTES, & DRAINAGE STRUCTURE TABLE

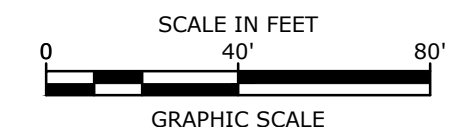
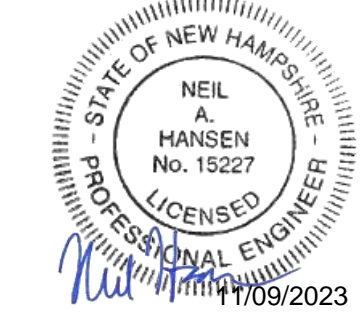
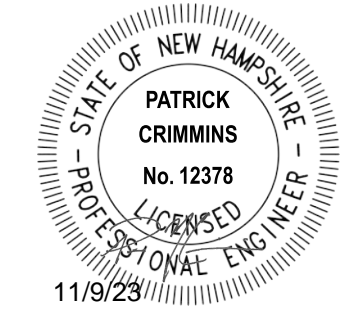
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LEGEND

---	MATCH LINE
D	EXISTING STORM DRAIN
SS	EXISTING SANITARY SEWER
W	EXISTING WATER
G	EXISTING GAS
E	EXISTING UNDERGROUND ELECTRIC
OHW	EXISTING OVERHEAD UTILITY
---	PROPOSED STORM DRAIN
---	PROPOSED SANITARY SEWER
PW	PROPOSED WATER
G	PROPOSED GAS
---	PROPOSED UNDERGROUND ELECTRIC
---	PROPOSED UNDERGROUND COMMUNICATION
COM	EXISTING CATCHBASIN
⊙	EXISTING DRAIN MANHOLE
⊙	EXISTING SEWER MANHOLE
⊙	EXISTING HYDRANT
⊙	EXISTING WATER VALVE
⊙	EXISTING ELECTRIC MANHOLE
⊙	EXISTING TELEPHONE MANHOLE
⊙	PROPOSED CATCHBASIN
⊙	PROPOSED DOUBLE GRATE CATCHBASIN
⊙	PROPOSED DRAIN MANHOLE
⊙	PROPOSED SEWER MANHOLE
⊙	PROPOSED WATER VALVE
⊙	PROPOSED FDC CONNECTION
⊙	PROPOSED HYDRANT
⊙	PROPOSED GAS VALVE
⊙	PROPOSED ELECTRIC MANHOLE
⊙	PROPOSED TRANSFORMER PAD
⊙	PROPOSED LIGHT POLE BASE
CONST	CONSTRUCT
BLDG	BUILDING
TYP	TYPICAL
COORD	COORDINATE
VIF	VERIFY IN FIELD
DI	DUCTILE IORN
COM	COMMUNICATION
FRP	FIBERGLASS REINFORCED POLYMER MORTAR PIPE

UTILITY NOTES:

- THE LOCATIONS OF EXISTING UNDERGROUND UTILITIES ARE APPROXIMATE AND THE LOCATIONS ARE NOT GUARANTEED BY THE OWNER OR ENGINEER. IT IS THE CONTRACTOR'S RESPONSIBILITY TO LOCATE ALL UTILITIES, ANTICIPATE CONFLICTS, REPAIR EXISTING UTILITIES, AND RELOCATE EXISTING UTILITIES REQUIRED TO COMPLETE THE WORK AT NO ADDITIONAL COST TO THE OWNER.
- COORDINATE ALL UTILITY WORK WITH APPROPRIATE UTILITY COMPANY.
NATURAL GAS - UNITIL
WATER - CITY OF PORTSMOUTH DPW
SEWER - CITY OF PORTSMOUTH DPW
ELECTRIC - EVERSOURCE
COMMUNICATIONS - FAIRPOINT, COMCAST, FIRSTLIGHT
- SEE EXISTING CONDITIONS PLAN FOR BENCHMARK INFORMATION.
- SEE GRADING, DRAINAGE & EROSION CONTROL PLAN FOR PROPOSED GRADING AND EROSION CONTROL MEASURES.
- ALL WATER MAIN INSTALLATIONS SHALL BE CLASS 52, CEMENT LINED DUCTILE IRON PIPE.
- ALL WATER MAIN INSTALLATIONS SHALL BE PRESSURE TESTED AND CHLORINATED AFTER CONSTRUCTION PRIOR TO ACTIVATING THE SYSTEM. CONTRACTOR SHALL COORDINATE CHLORINATION AND TESTING WITH THE CITY OF PORTSMOUTH WATER DEPARTMENT.
- ALL SEWER PIPE SHALL BE FIBERGLASS REINFORCED POLYMER MORTAR (FRP) PIPE UNLESS OTHERWISE STATED.
- ALL WORK WITHIN PORTSMOUTH ROWS SHALL BE COORDINATED WITH CITY OF PORTSMOUTH AND THE PEASE DEVELOPMENT AUTHORITY.
- CONTRACTOR SHALL MAINTAIN UTILITY SERVICES TO ABUTTING PROPERTIES THROUGHOUT CONSTRUCTION.
- CONNECTIONS TO EXISTING WATER MAIN SHALL BE CONSTRUCTED TO CITY OF PORTSMOUTH STANDARDS.
- EXISTING UTILITIES TO BE REMOVED SHALL BE CAPPED AT THE MAIN AND MEET THE CITY OF PORTSMOUTH DEPARTMENT OF PUBLIC WORKS STANDARDS FOR CAPPING OF WATER AND SEWER SERVICES.
- ALL ELECTRICAL MATERIAL WORKMANSHIP SHALL CONFORM TO THE NATIONAL ELECTRIC CODE, LATEST EDITION, AND ALL APPLICABLE STATE AND LOCAL CODES.
- THE EXACT LOCATION OF NEW UTILITY SERVICES AND CONNECTIONS SHALL BE COORDINATED WITH THE BUILDING DRAWINGS AND THE UTILITY COMPANIES.
- ADJUST ALL MANHOLES, CATCH BASINS, CURB BOXES, ETC. WITHIN LIMITS OF WORK TO FINISH GRADE.
- ALL UNDERGROUND CONDUITS SHALL HAVE NYLON PULL ROPES TO FACILITATE PULLING CABLES.
- THE CONTRACTOR SHALL OBTAIN, PAY FOR, AND COMPLY WITH ALL REQUIRED PERMITS, ARRANGE FOR ALL INSPECTIONS, AND SUBMIT COPIES OF ACCEPTANCE CERTIFICATES TO THE OWNER PRIOR TO THE COMPLETION OF THIS PROJECT.
- THE CONTRACTOR SHALL PROVIDE AND INSTALL ALL MANHOLES, BOXES, FITTINGS, CONNECTORS, COVER PLATES, AND OTHER MISCELLANEOUS ITEMS NOT NECESSARILY DETAILED ON THESE DRAWINGS TO RENDER INSTALLATION OF UTILITIES COMPLETE AND OPERATIONAL.
- CONTRACTOR SHALL PROVIDE EXCAVATION, BEDDING, BACKFILL AND COMPACTION FOR NATURAL GAS SERVICES.
- A 10-FOOT MINIMUM EDGE TO EDGE HORIZONTAL SEPARATION SHALL BE PROVIDED BETWEEN ALL WATER AND SANITARY SEWER LINES. AN 18-INCH MINIMUM OUTSIDE TO OUTSIDE VERTICAL SEPARATION SHALL BE PROVIDED AT ALL WATER/SANITARY SEWER CROSSINGS.
- THE CONTRACTOR SHALL CONTACT "DIG-SAFE" 72 HOURS PRIOR TO COMMENCING CONSTRUCTION. THE CONTRACTOR SHALL HAVE THE "DIG-SAFE" NUMBER ON SITE AT ALL TIMES.
- CONTRACTOR TO SUBMIT AS-BUILT PLANS IN DIGITAL FORMAT (.DWG AND .PDF FILES) ON DISK TO THE OWNER AND ENGINEER UPON COMPLETION OF THE PROJECT. AS-BUILTS SHALL BE PREPARED AND CERTIFIED BY A NEW HAMPSHIRE LICENSED LAND SURVEYOR.
- SAWCUT AND REMOVE PAVEMENT AND CONSTRUCT PAVEMENT TRENCH PATCH FOR ALL PROPOSED UTILITIES LOCATED IN EXISTING PAVEMENT AREAS TO REMAIN.
- HYDRANTS, GATE VALVES, FITTINGS, ETC. SHALL MEET THE REQUIREMENTS OF THE CITY OF PORTSMOUTH AND THE PEASE DEVELOPMENT AUTHORITY.
- COORDINATE TESTING OF SEWER CONSTRUCTION WITH THE CITY OF PORTSMOUTH.
- ALL SEWER PIPE WITH LESS THAN 6' OF COVER IN PAVED AREAS OR LESS THAN 4' OF COVER IN UNPAVED AREAS SHALL BE INSULATED.
- CONTRACTOR SHALL COORDINATE ALL ELECTRIC WORK INCLUDING BUT NOT LIMITED TO: CONDUIT CONSTRUCTION, MANHOLE CONSTRUCTION, UTILITY POLE CONSTRUCTION, OVERHEAD WIRE RELOCATION, AND TRANSFORMER CONSTRUCTION WITH POWER COMPANY.
- CONTRACTOR SHALL PHASE UTILITY CONSTRUCTION, PARTICULARLY WATER MAIN AND GAS MAIN CONSTRUCTION, AS TO MAINTAIN CONTINUOUS SERVICE TO ABUTTING PROPERTIES. CONTRACTOR SHALL COORDINATE TEMPORARY SERVICES TO ABUTTERS WITH THE UTILITY COMPANY AND AFFECTED ABUTTER.
- SITE LIGHTING SPECIFICATIONS, CONDUIT LAYOUT AND CIRCUITRY FOR PROPOSED SITE LIGHTING AND SIGN ILLUMINATION SHALL BE PROVIDED BY THE PROJECT ELECTRICAL ENGINEER.
- CONTRACTOR SHALL CONSTRUCT ALL UTILITIES AND DRAINS TO WITHIN 10' OF THE FOUNDATION WALLS AND CONNECT THESE TO SERVICE STUBS FROM THE BUILDING.
- EXISTING SEWER MAIN AND STRUCTURES IN GOOSE BAY DRIVE ARE BASED ON A PROPOSED DESIGN BY UNDERWOOD ENGINEERS, DATED JULY 28, 2017, AND WAS CONSTRUCTED IN SUMMER 2018. THE PROPOSED ON-SITE SEWER DESIGN ELEVATIONS ARE BASED ON THE UNDERWOOD PLAN DURING CONSTRUCTION. THE CONTRACTOR SHALL COORDINATE SEWER CONSTRUCTION WITH THE CITY OF PORTSMOUTH, AND VERIFY ALL INVERTS PRIOR TO CONSTRUCTION.
- LOCATION SHOWN IS APPROXIMATE ONLY. FINAL DESIGN OF NATURAL GAS SERVICE TO BE COMPLETED BY UNITIL. WORK IN CORPORATE DRIVE MAY NEED TO BE COMPLETED IN CONJUNCTION WITH FUTURE RECONSTRUCTION OF CORPORATE DRIVE. COORDINATE WITH CITY OF PORTSMOUTH AND UNITIL.
- LOCATION AND TYPE SHOWN IS APPROXIMATE ONLY. FINAL DESIGN OF ELECTRIC SERVICE AND ASSOCIATED INFRASTRUCTURE TO BE COMPLETED BY EVERSOURCE. WORK IN CORPORATE DRIVE MAY NEED TO BE COMPLETED IN CONJUNCTION WITH FUTURE RECONSTRUCTION OF CORPORATE DRIVE. COORDINATE WITH CITY OF PORTSMOUTH AND EVERSOURCE.
- FINAL LOCATION OF ALL WATER METER AND VALVES SHALL BE COORDINATED WITH THE CITY OF PORTSMOUTH DPW PRIOR TO CONSTRUCTION.
- FINAL LOCATION OF FIRE HYDRANTS, FIRE DEPARTMENT CONNECTIONS AND DRY STAND PIPES WILL BE COORDINATED WITH THE BUILDING DRAWINGS AND APPROVED BY THE PORTSMOUTH FIRE DEPARTMENT PRIOR TO CONSTRUCTION.
- THE APPLICANT SHALL HAVE A SITE SURVEY CONDUCTED BY A RADIO COMMUNICATIONS CARRIER APPROVED BY THE CITY'S COMMUNICATIONS DIVISION. THE RADIO COMMUNICATIONS CARRIER MUST BE FAMILIAR AND CONVERSANT WITH THE POLICE AND RADIO CONFIGURATION. IF THE SITE SURVEY INDICATES IT IS NECESSARY TO INSTALL A SIGNAL REPEATER EITHER ON OR NEAR THE PROPOSED PROJECT, THOSE COSTS SHALL BE THE RESPONSIBILITY OF THE PROPERTY OWNER. THE OWNER SHALL COORDINATE WITH THE SUPERVISOR OF RADIO COMMUNICATIONS FOR THE CITY.
- CONTRACTOR SHALL PERFORM TEST PITS TO VERIFY INVERT ELEVATIONS IN FIELD PRIOR TO CONSTRUCTION AND SHALL NOTIFY ENGINEER IF ELEVATION DIFFERS FROM PLAN.
- CONTRACTOR SHALL DISPOSE OF ASBESTOS CEMENT PIPES IN ACCORDANCE WITH ALL FEDERAL, STATE, AND LOCAL REGULATIONS SHOULD ANY BE FOUND DURING CONSTRUCTION.

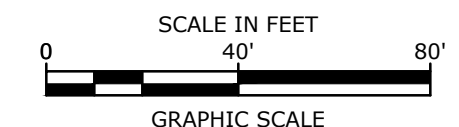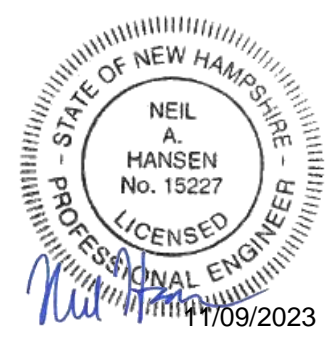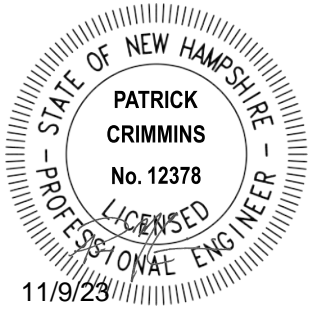

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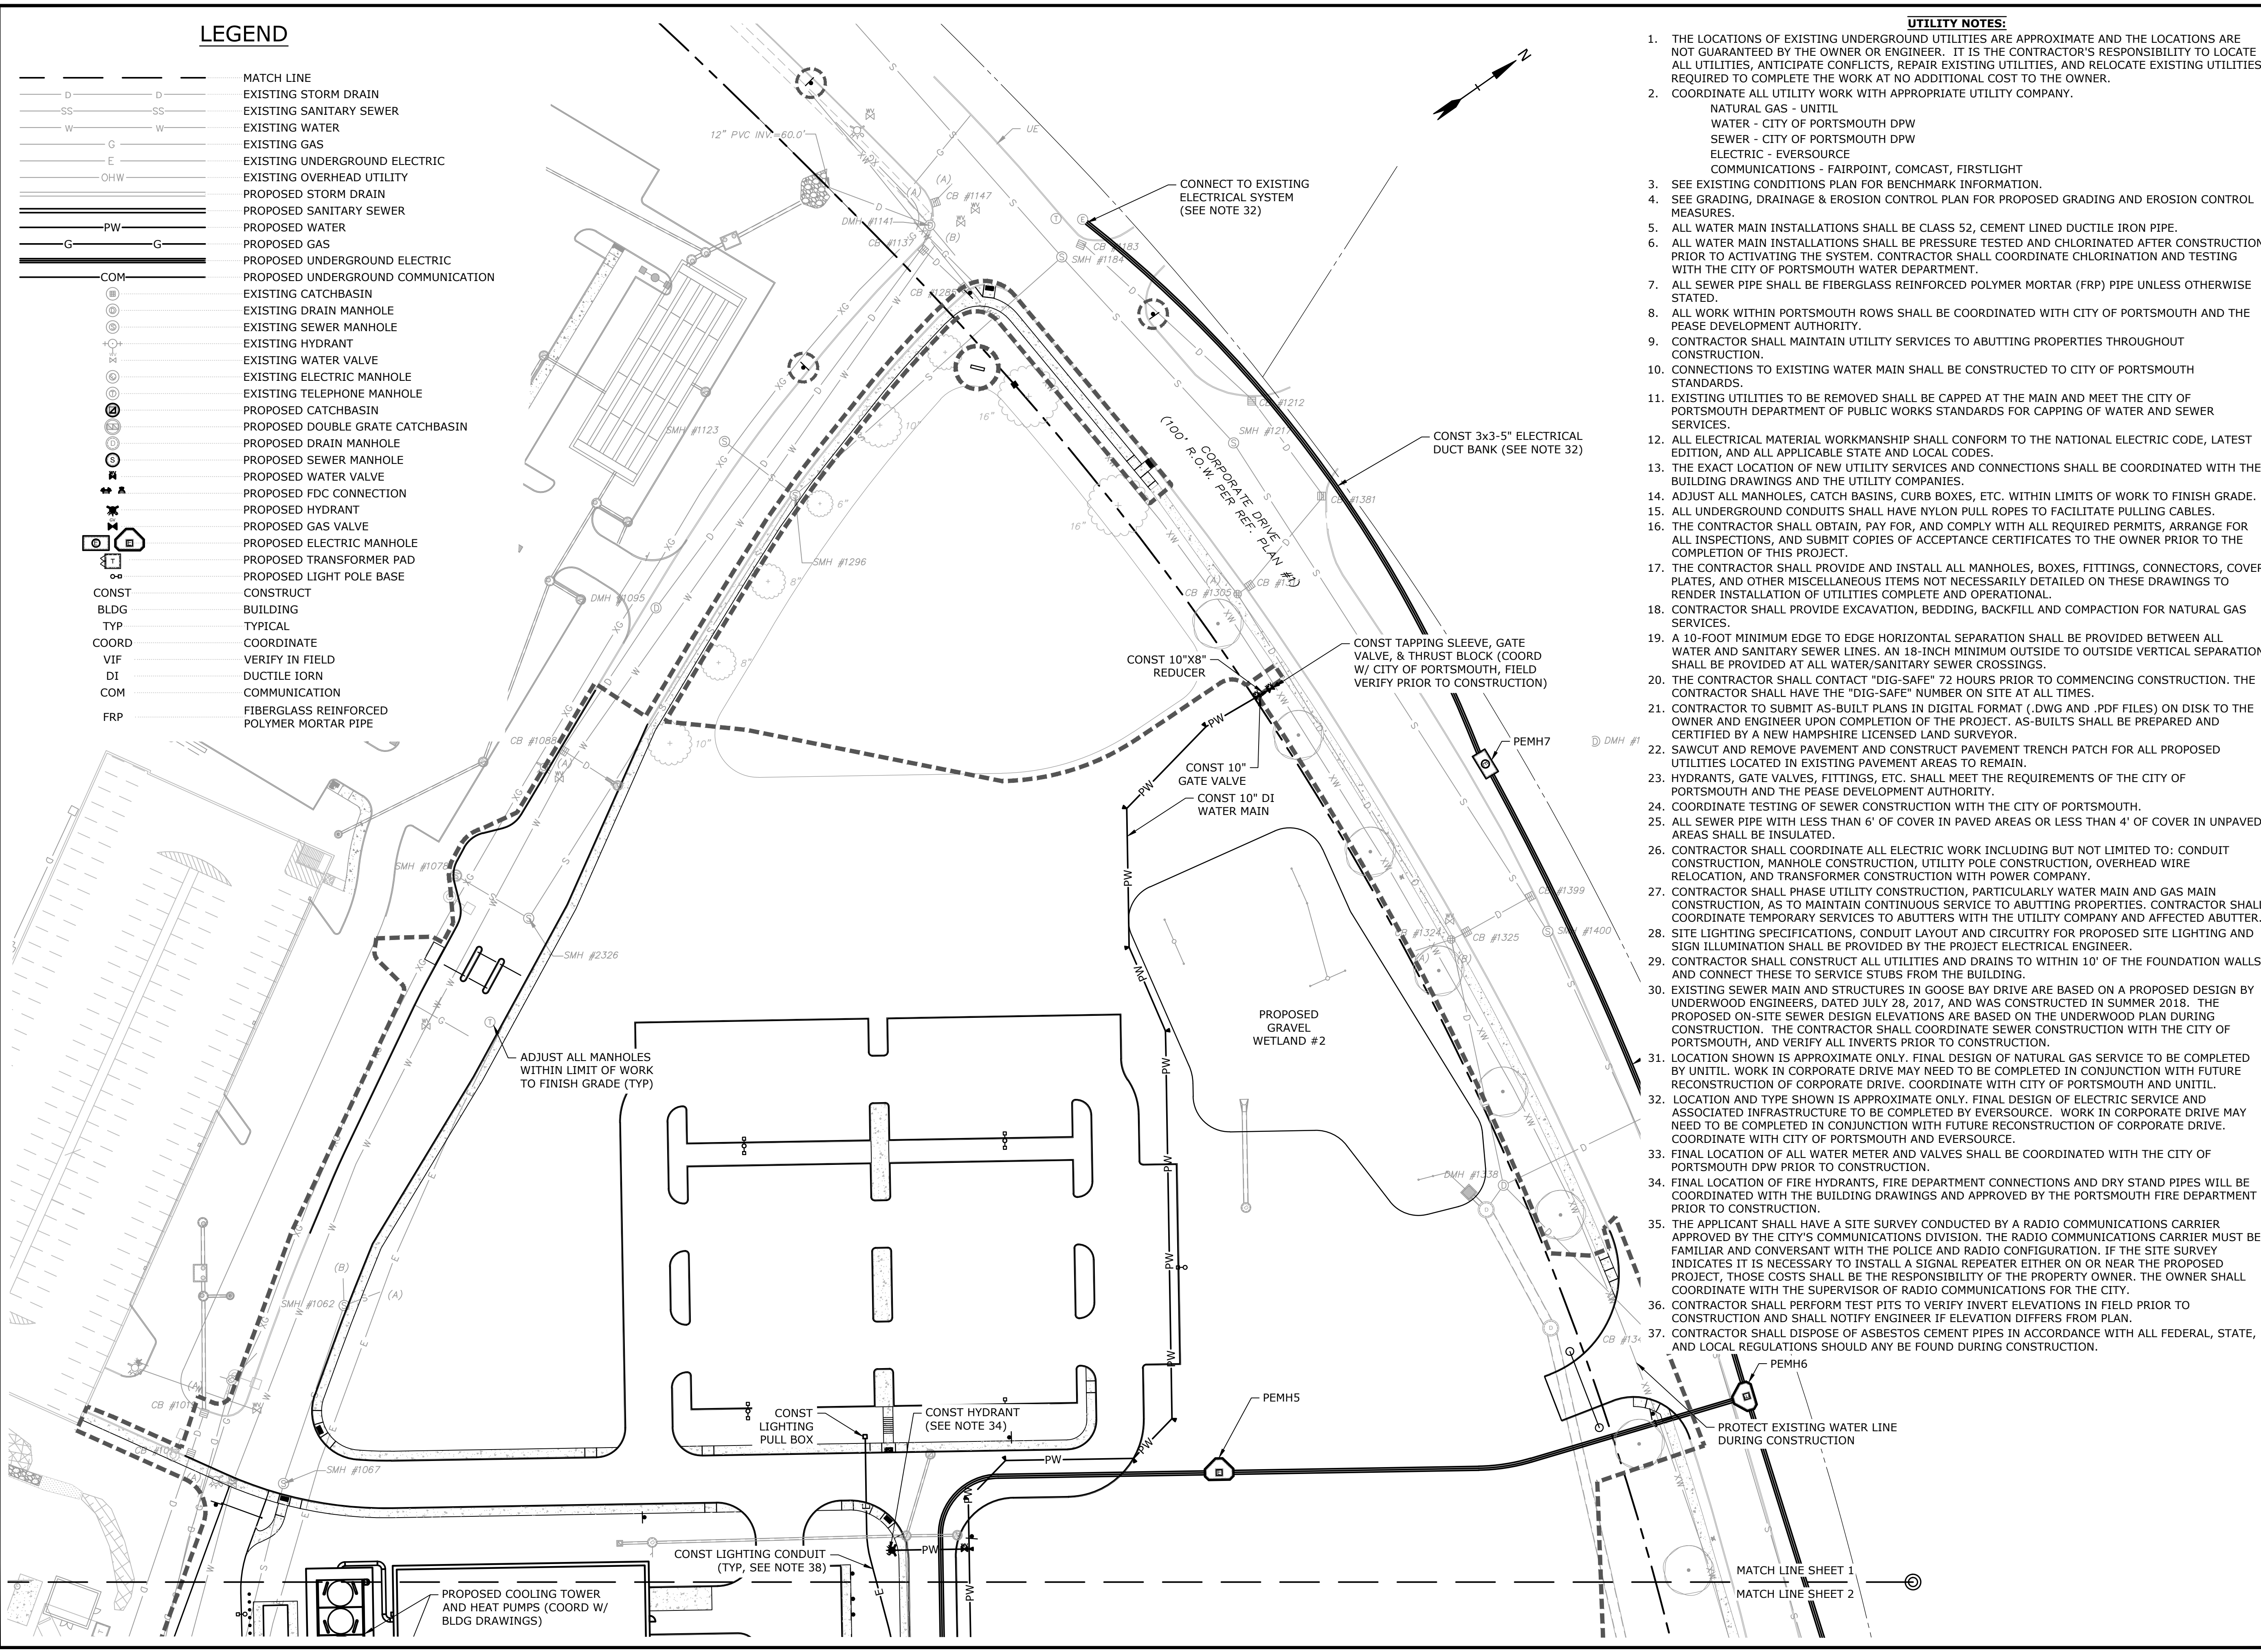
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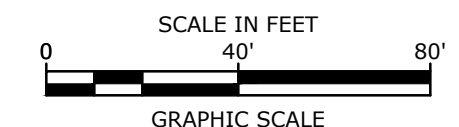
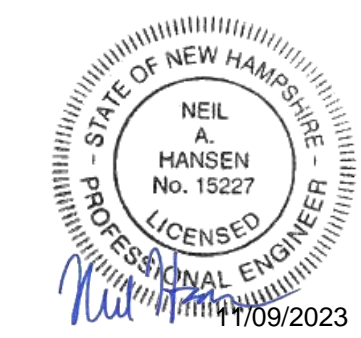
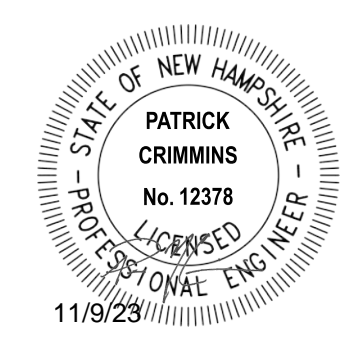
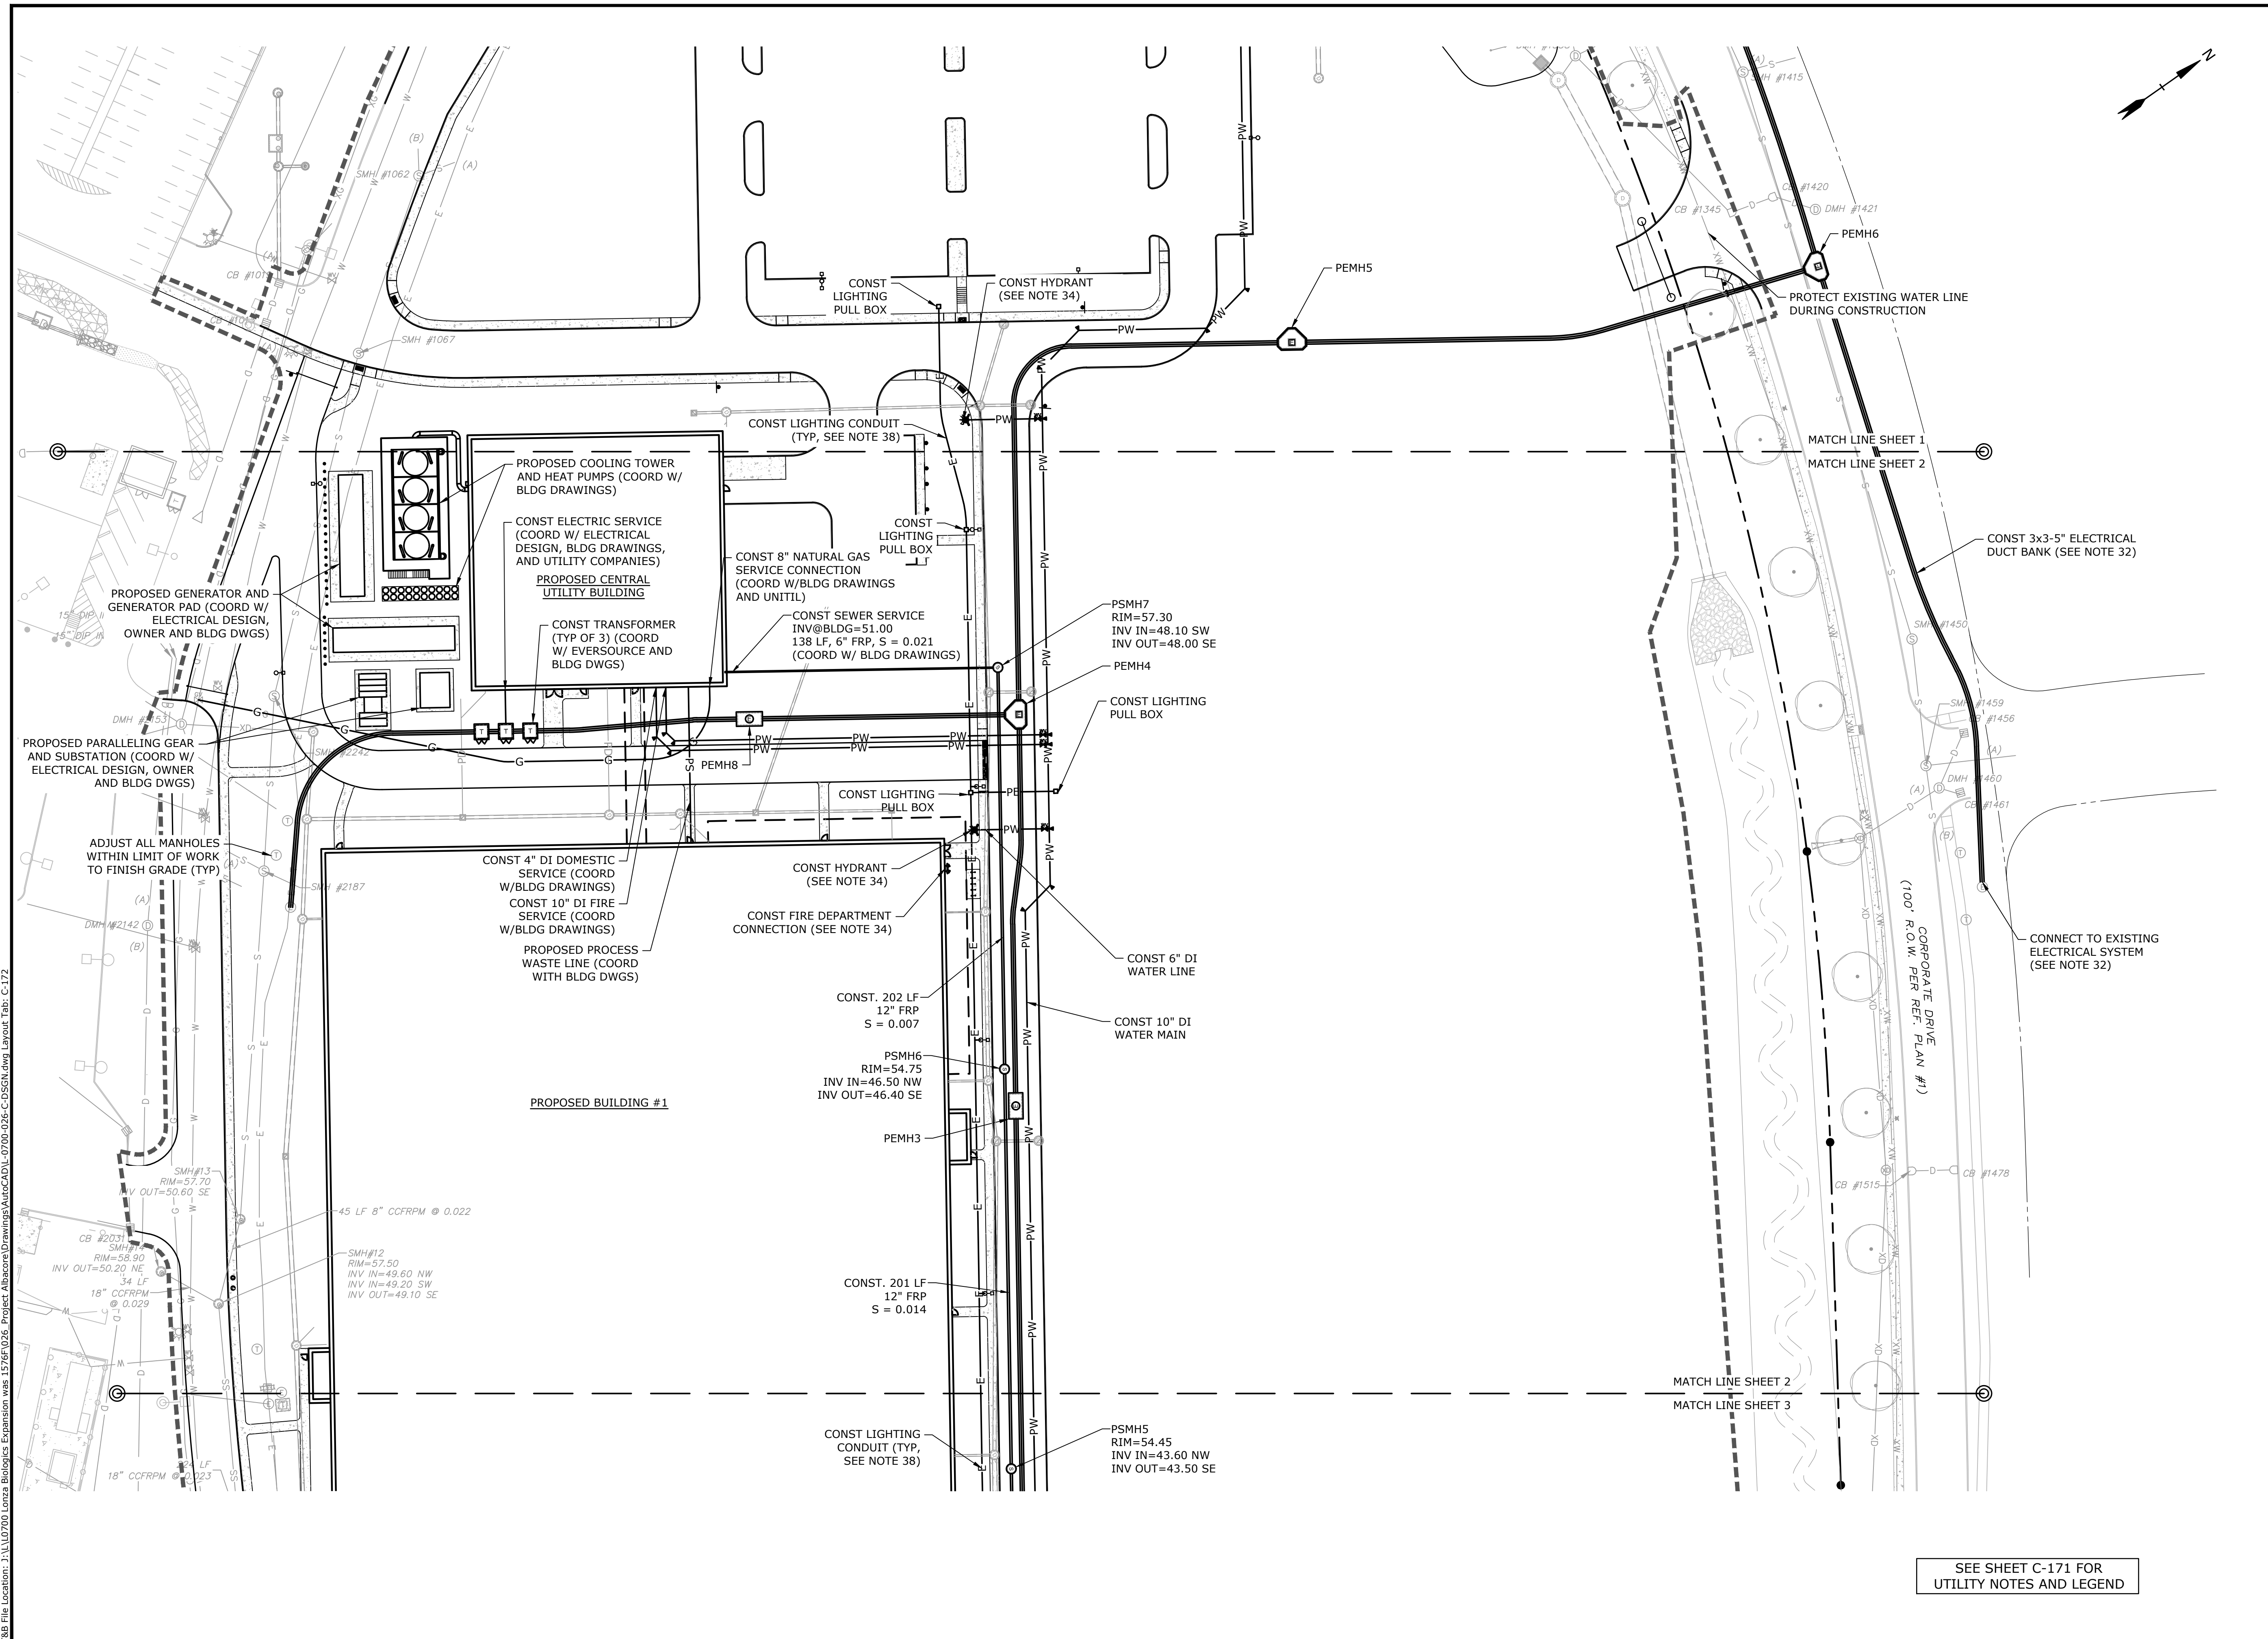
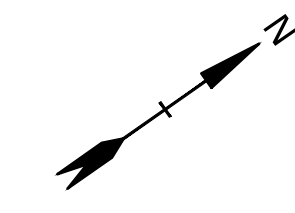
PHASE 2 UTILITIES PLAN

SCALE: AS SHOWN

C-171

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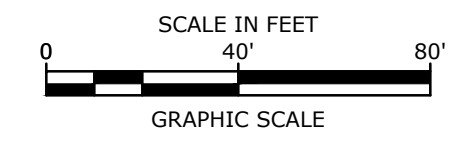
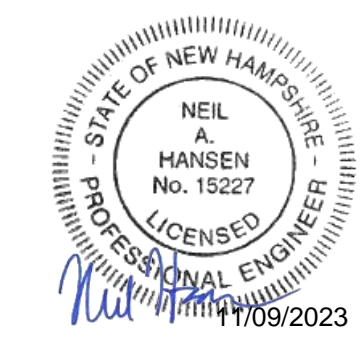
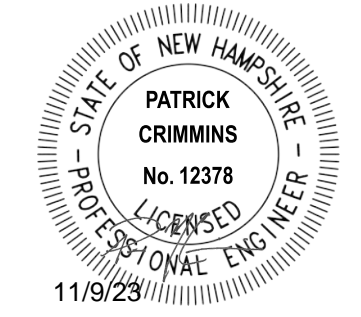
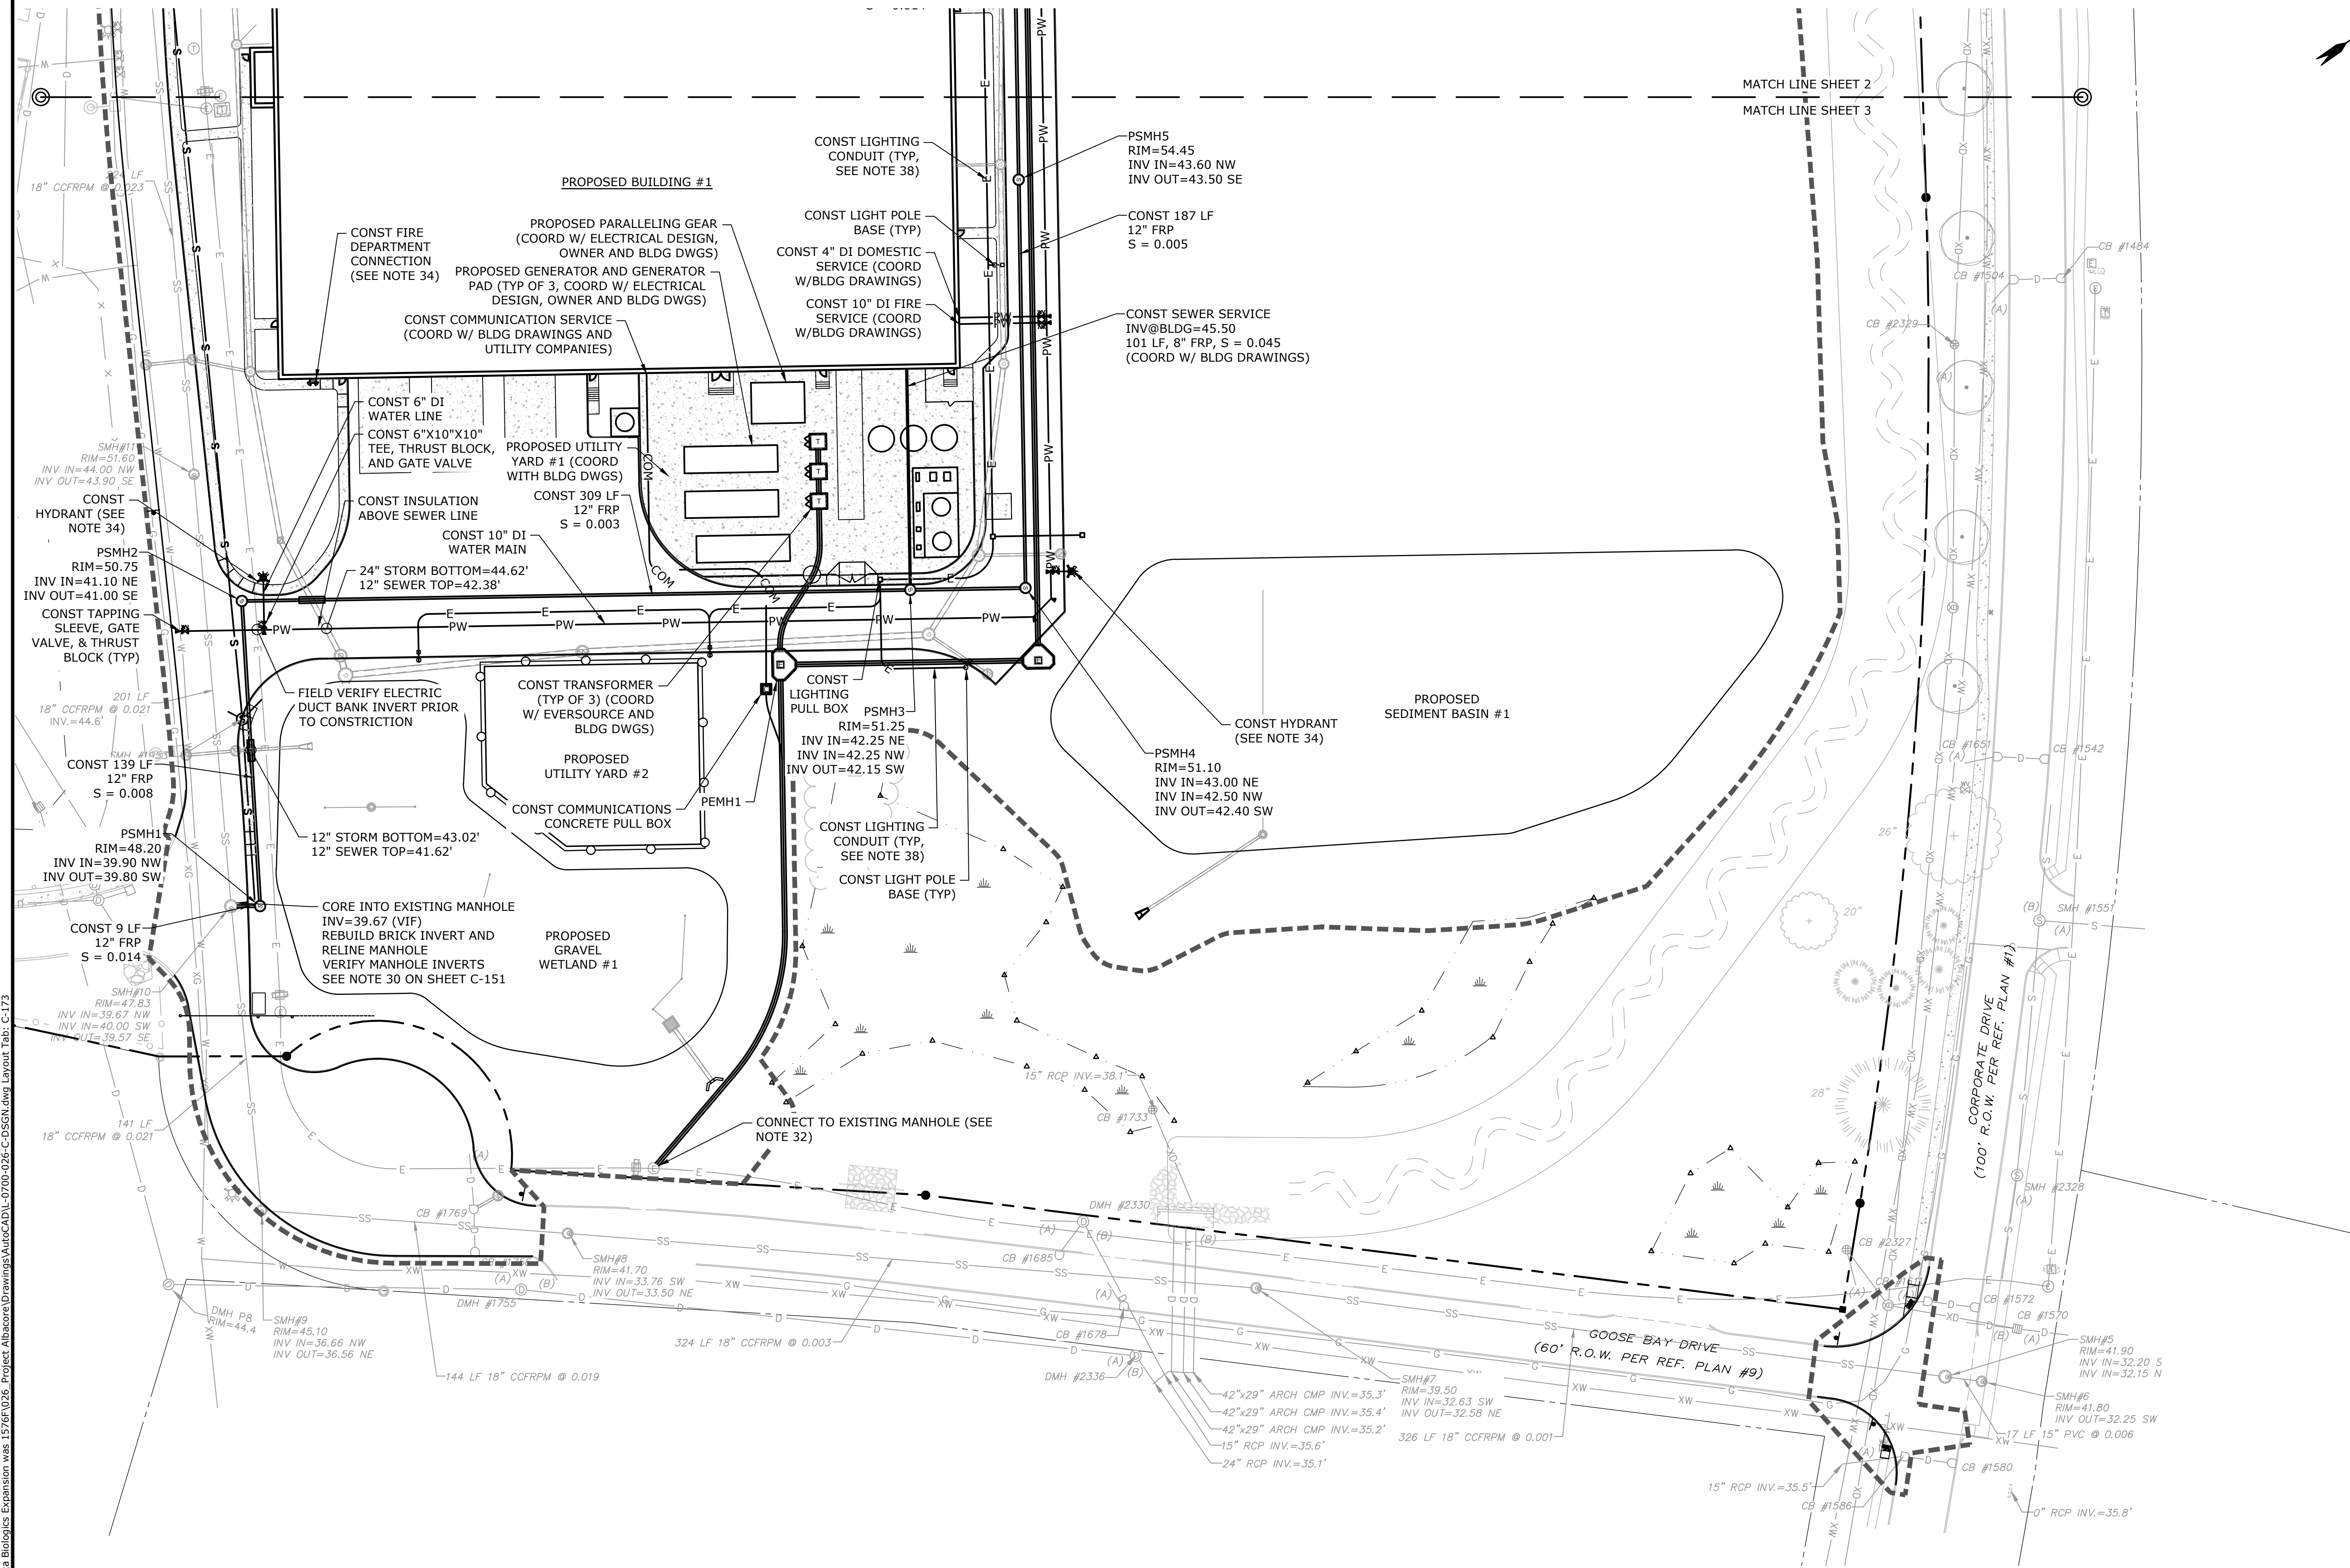
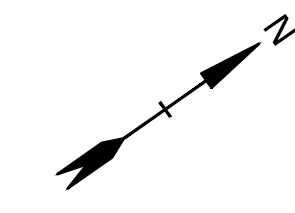
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CHECKED:	NAH
APPROVED:	PMC

PHASE 2 UTILITIES PLAN

SCALE: AS SHOWN

SEE SHEET C-171 FOR UTILITY NOTES AND LEGEND

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J	5/23/2022	Third Party Rev. Comments
I	4/26/2022	Revised PB Stipulations
MARK	DATE	DESCRIPTION

PROJECT NO:	L-0700-013
DATE:	04/03/2018
FILE:	L-0700-026-C-DSGN.dwg
DRAWN BY:	CHK
CHECKED:	NAH
APPROVED:	PMC

PHASE 2 UTILITIES PLAN





SCALE: AS SHOWN

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SEE SHEET C-171 FOR UTILITY NOTES AND LEGEND

Last Save Date: November 9, 2023 11:03 AM By: NAHANSEN
 Plot Date: Thursday, November 09, 2023 Plotted By: Neil A. Hansen
 P&E File Location: J:\L0700\Lonza Biologics Expansion.was 12/26/2026 Project Abstract: Drawings\AutoCAD\L-0700-026-C-DSGN.dwg Layout Tab: C-173

- LANDSCAPE NOTES:**
- LANDSCAPE NOTES ON THIS PLAN APPLY ONLY TO THOSE PLANTINGS OUTSIDE OF THE HODGSON BROOK RESTORATION AREA. PLANTING REQUIREMENTS FOR THE HODGSON BROOK RESTORATION AREA CAN BE FOUND ON PLAN SHEETS C-701 THROUGH C-714 AND IN APPENDIX D OF THE TECHNICAL SPECIFICATIONS.
 - THE CONTRACTOR SHALL FURNISH AND PLANT ALL PLANTS IN QUANTITIES AS SHOWN ON THIS PLAN. NO SUBSTITUTIONS WILL BE PERMITTED UNLESS APPROVED BY OWNER. ALL PLANTS SHALL BE NURSERY GROWN.
 - ALL PLANTS SHALL BE NURSERY GROWN AND PLANTS AND WORKMANSHIP SHALL CONFORM TO THE AMERICAN ASSOCIATION OF NURSERYMEN STANDARDS, INCLUDING BUT NOT LIMITED TO SIZE, HEALTH, SHAPE, ETC., AND SHALL BE SUBJECT TO THE APPROVAL OF THE LANDSCAPE ARCHITECT PRIOR TO ARRIVAL ON-SITE AND AFTER PLANTING.
 - PLANT STOCK SHALL BE GROWN WITHIN THE HARDINESS ZONES 4 THRU 7 ESTABLISHED BY THE PLANT HARDINESS ZONE MAP, MISCELLANEOUS PUBLICATIONS NO. 814, AGRICULTURAL RESEARCH SERVICE, UNITED STATES DEPARTMENT AGRICULTURE, LATEST REVISION.
 - PLANT MATERIAL SHALL BARE THE SAME RELATIONSHIP TO FINISHED GRADE AS TO THE ORIGINAL PLANTING GRADE PRIOR TO DIGGING.
 - THE NUMBER OF EACH INDIVIDUAL PLANT TYPE AND SIZE PROVIDED IN THE PLANT LIST OR ON THE PLAN IS FOR THE CONTRACTOR'S CONVENIENCE ONLY. IF A DISCREPANCY EXISTS BETWEEN THE NUMBER OF PLANTS ON THE LABEL AND THE NUMBER OF SYMBOLS SHOWN ON THE DRAWINGS, THE GREATER NUMBER SHALL APPLY.
 - NO SUBSTITUTION OF PLANT MATERIALS WILL BE ALLOWED WITHOUT THE PRIOR WRITTEN APPROVAL OF THE OWNER'S REPRESENTATIVE.
 - THE CONTRACTOR SHALL LOCATE, VERIFY AND MARK ALL EXISTING AND NEWLY INSTALLED UNDERGROUND UTILITIES PRIOR TO ANY LAWN WORK OR PLANTING. ANY CONFLICTS WHICH MIGHT OCCUR BETWEEN PLANTING AND UTILITIES SHALL IMMEDIATELY BE REPORTED TO THE OWNER SO THAT ALTERNATE PLANTING LOCATIONS CAN BE DETERMINED.
 - ALL DISTURBED AREAS NOT TO BE PAVED OR OTHERWISE TREATED, SHALL RECEIVE SIX (6) INCHES OF LOAM AND SEED. NO FILL SHALL BE PLACED IN ANY WETLAND AREA.
 - THREE (3) INCH BARK MULCH IS TO BE USED AROUND THE TREE AND SHRUB PLANTING AS SPECIFIED IN THE DETAILS. WHERE BARK MULCH IS TO BE USED IN A CURBED ISLAND THE BARK MULCH SHALL MEET THE TOP INSIDE EDGE OF THE CURB. ALL OTHER AREAS SHALL RECEIVE SIX (6) INCHES OF LOAM AND SEED.
 - LANDSCAPING SHALL BE LOCATED WITHIN 150 FT OF EXTERIOR HOSE ATTACHMENT OR SHALL BE PROVIDED WITH AN IRRIGATION SYSTEM.
 - SEE PLANTING DETAILS AND SPECIFICATIONS FOR ADDITIONAL REQUIREMENTS.
 - TREE STAKES SHALL REMAIN IN PLACE FOR NO LESS THAN 6 MONTHS AND NO MORE THAN 1 YEAR.
 - PLANTING SHALL BE COMPLETED FROM APRIL 15TH THROUGH OCTOBER 1ST. NO PLANTING DURING JULY AND AUGUST UNLESS SPECIAL PROVISIONS ARE MADE FOR DROUGHT.
 - PARKING AREA PLANTED ISLANDS TO HAVE MINIMUM OF 1'-0" TOPSOIL PLACED TO WITHIN 3 INCHES OF THE TOP OF CURB ELEVATION REMOVE ALL CONSTRUCTION DEBRIS BEFORE PLACING TOPSOIL.
 - TREES SHALL BE PRUNED IN ACCORDANCE WITH THE LATEST EDITION OF ANSI A300 'TREES, SHRUBS AND OTHER WOOD PLANT MAINTENANCE STANDARD PRACTICES.
 - ALL PLANTS SHALL BE WATERED THOROUGHLY TWICE DURING THE FIRST 24 HOUR PERIOD AFTER PLANTING. ALL PLANTS SHALL BE WATERED WEEKLY, OR MORE OFTEN, IF NECESSARY DURING THE FIRST GROWING SEASON. LANDSCAPE CONTRACTOR SHALL COORDINATE WATERING SCHEDULE WITH OWNER DURING THE ONE (1) YEAR GUARANTEE PERIOD.
 - EXISTING TREES AND SHRUBS SHOWN ON THE PLAN ARE TO REMAIN UNDISTURBED. ALL EXISTING TREES AND SHRUBS SHOWN TO REMAIN ARE TO BE PROTECTED WITH A 4-FOOT SNOW FENCE PLACED AT THE DRIP LINE OF THE BRANCHES OR AT 8 FEET MINIMUM FROM THE TREE TRUNK. ANY EXISTING TREE OR SHRUB SHOWN TO REMAIN, WHICH IS REMOVED DURING CONSTRUCTION, SHALL BE REPLACED BY A TREE OF COMPARABLE SIZE AND SPECIES TREE OR SHRUB.
 - THE CONTRACTOR SHALL GUARANTEE ALL PLANTINGS TO BE IN GOOD HEALTHY, FLOURISHING AND ACCEPTABLE CONDITION FOR A PERIOD OF (1) YEAR BEGINNING AT THE DATE OF ACCEPTANCE OF SUBSTANTIAL COMPLETION. ALL GRASSES, TREES AND SHRUBS THAT, IN THE OPINION OF THE LANDSCAPE ARCHITECT, SHOW LESS THAN 80% HEALTHY GROWTH AT THE END OF ONE YEAR PERIOD SHALL BE REPLACED BY THE CONTRACTOR.
 - UPON EXPIRATION OF THE CONTRACTOR'S ONE YEAR GUARANTEE PERIOD, THE OWNER SHALL BE RESPONSIBLE FOR LANDSCAPE MAINTENANCE INCLUDING WATERING DURING PERIODS OF DROUGHT
 - THE CONTRACTOR SHALL BE RESPONSIBLE FOR PROTECTING ALL PLANTING AND LAWNS AGAINST DAMAGE FROM ONGOING CONSTRUCTION. THIS PROTECTION SHALL BEGIN AT THE TIME THE PLANT IS INSTALLED AND CONTINUE UNTIL THE FORMAL ACCEPTANCE OF ALL THE PLANTINGS.
 - PRE-PURCHASE PLANT MATERIAL AND ARRANGE FOR DELIVERY TO MEET PROJECT SCHEDULE AS REQUIRED IT MAY BE NECESSARY TO PRE-DIG CERTAIN SPECIES WELL IN ADVANCE OF ACTUAL PLANTING DATES.

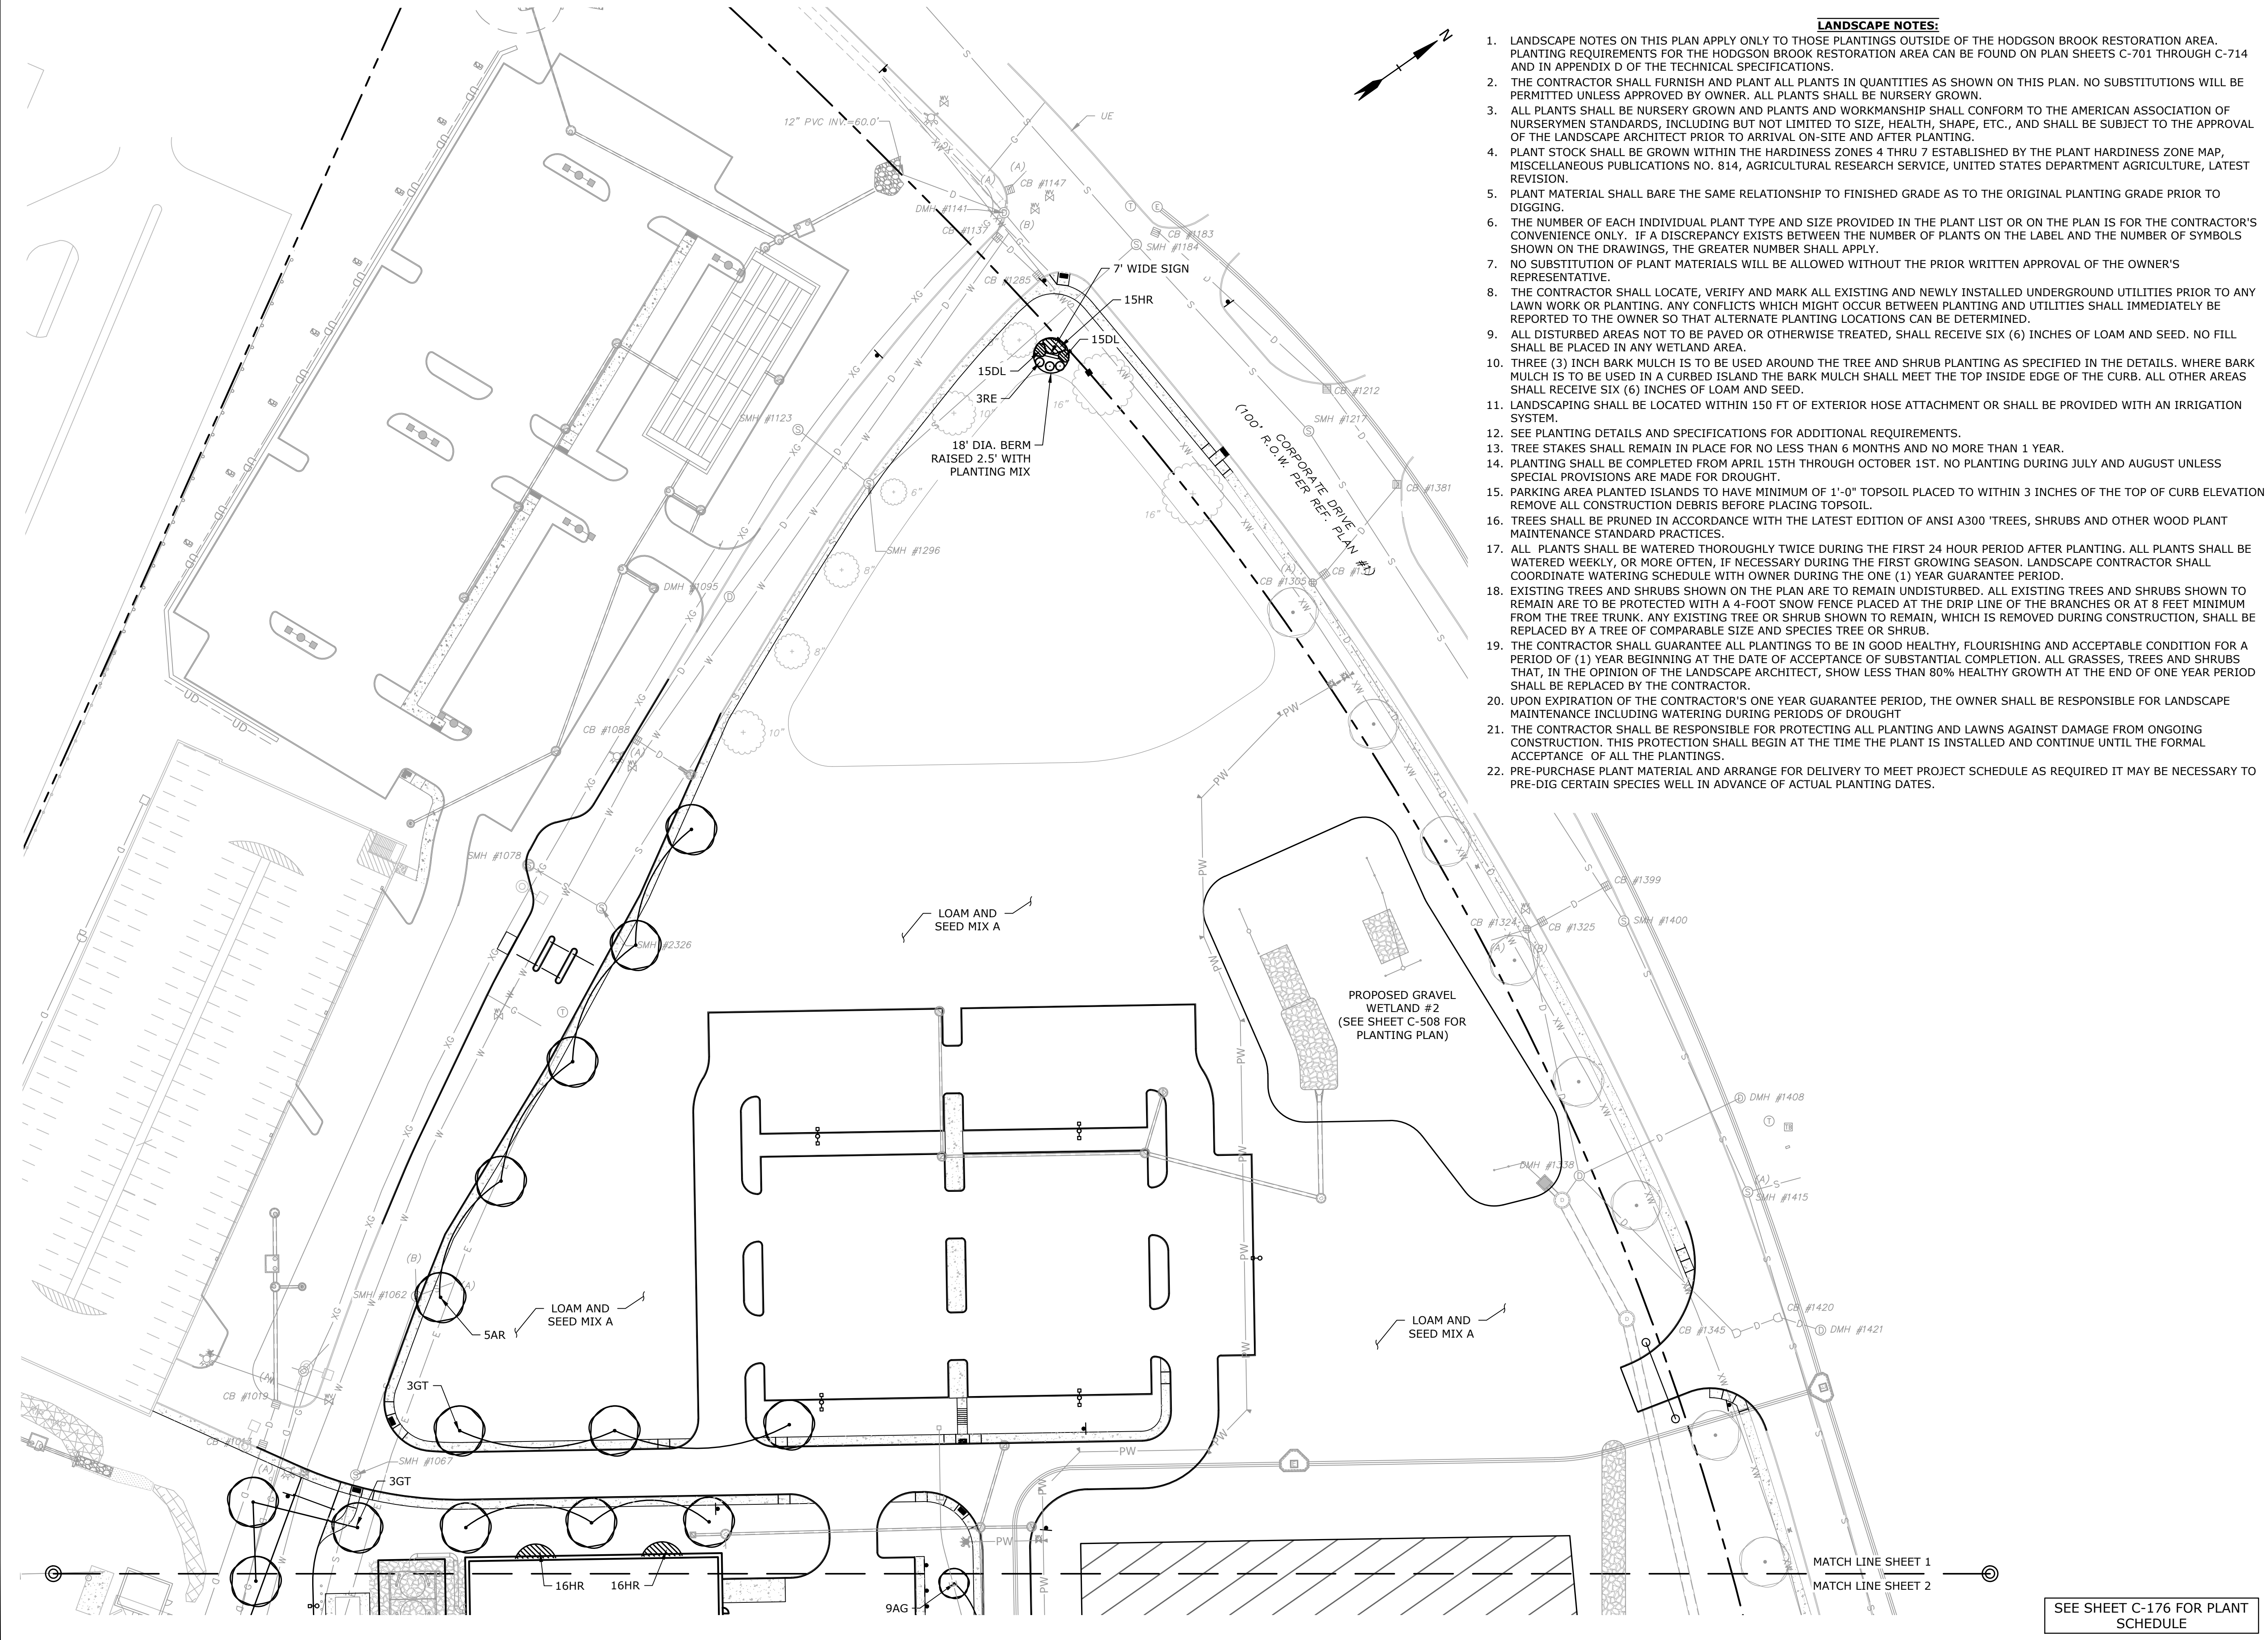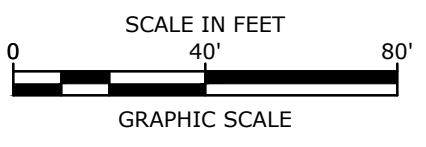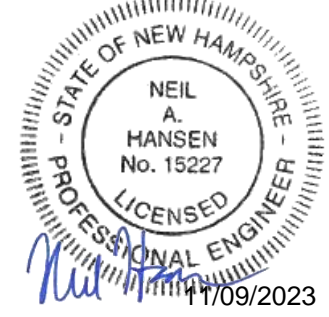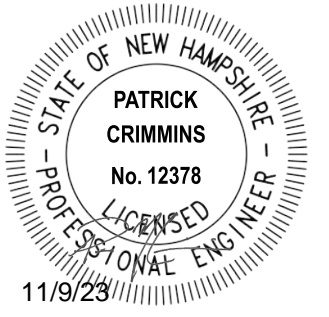

Proposed Industrial Development

Lonza Biologics

Portsmouth, New Hampshire

N	11/9/2023	Revised P.B. Submission
M	9/27/2023	P.B. Submission
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I	4/26/2022	Revised PB Stipulations
MARK	DATE	DESCRIPTION

PROJECT NO:	L-0700-013
DATE:	04/03/2018
FILE:	L-0700-026-C-DSGN.dwg
DRAWN BY:	CJK
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APPROVED:	PMC






PHASE 2 LANDSCAPE PLAN

SCALE: AS SHOWN

C-174

Last Save Date: November 9, 2023 11:03 AM By: NAHANSEN
 Plot Date: Thursday, November 09, 2023 Plotted By: Neil A. Hansen
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SEE SHEET C-176 FOR PLANT SCHEDULE

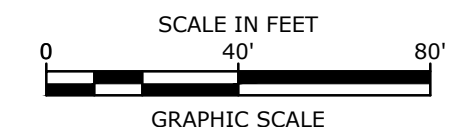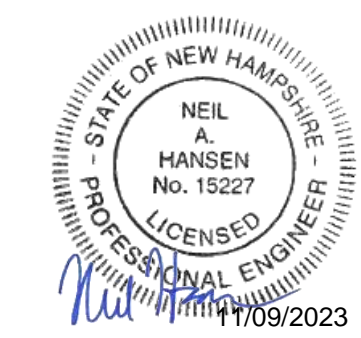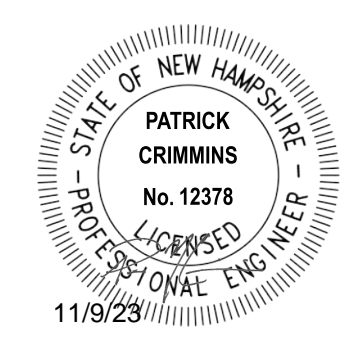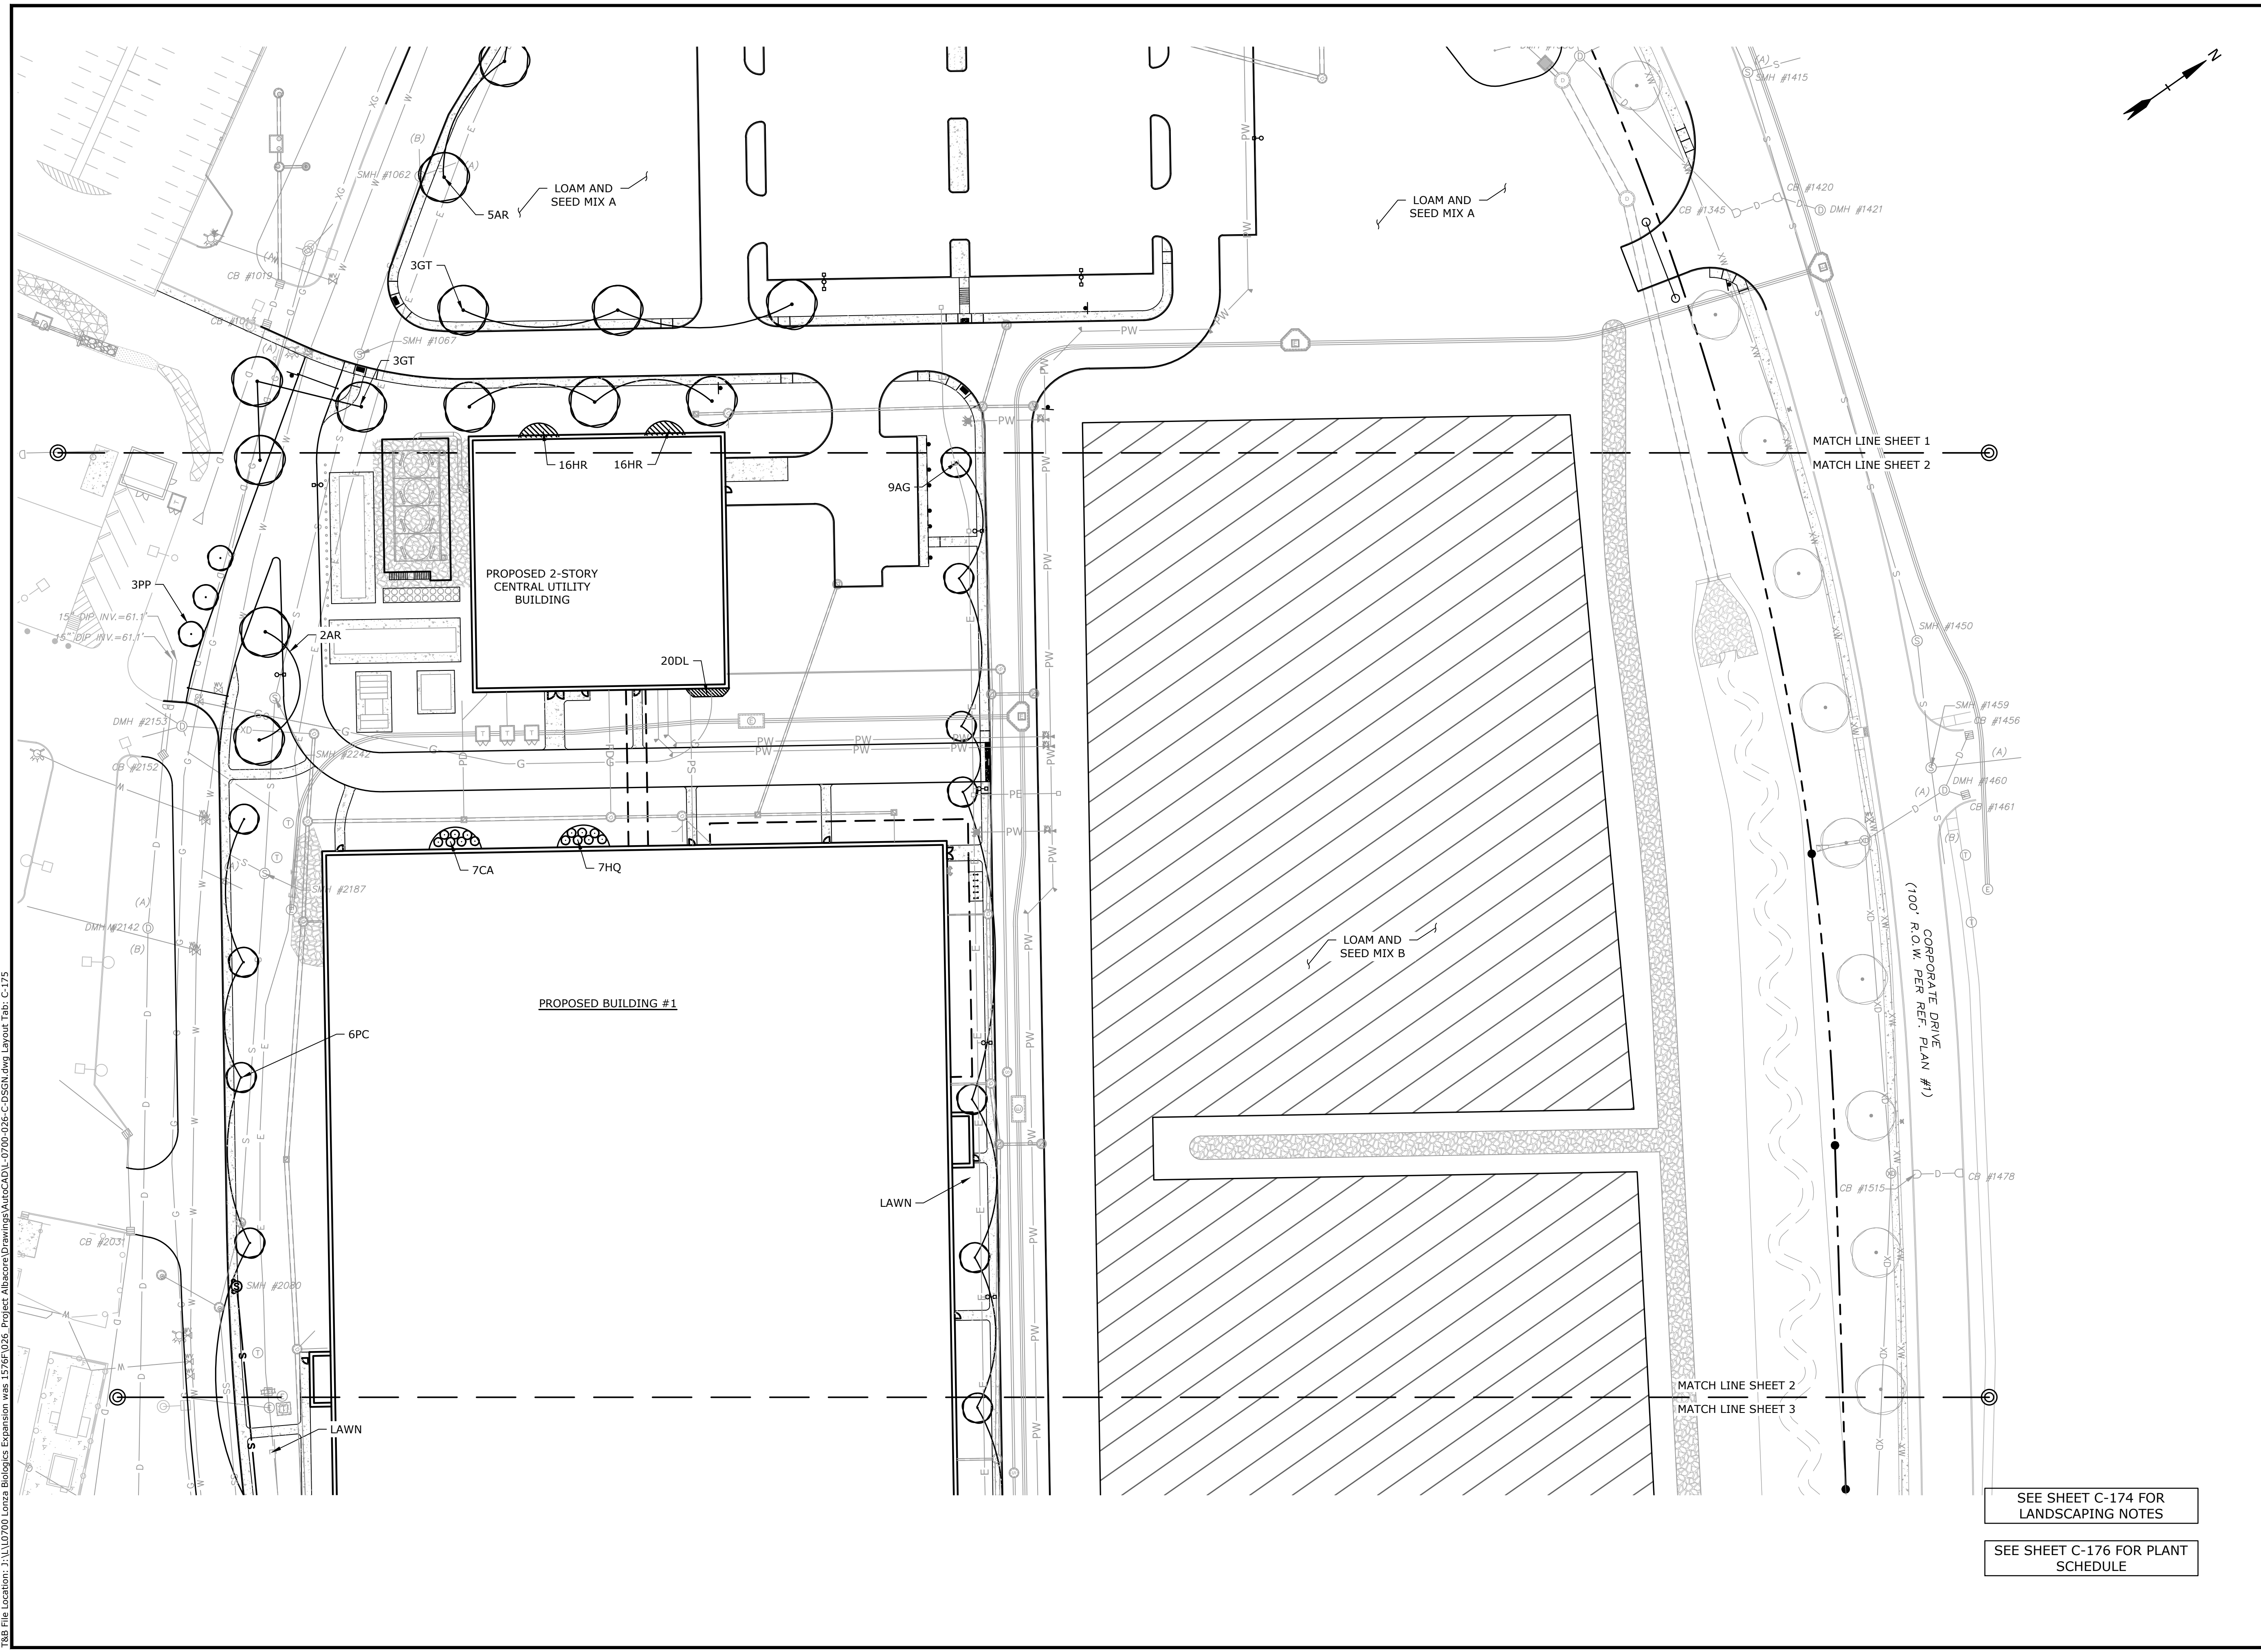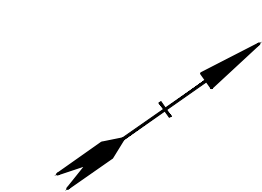

Proposed Industrial Development

Lonza Biologics

Portsmouth, New Hampshire

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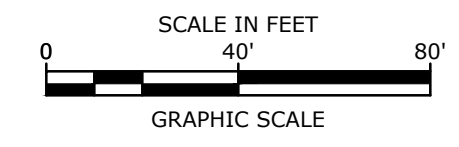
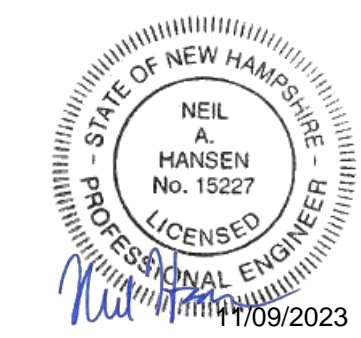
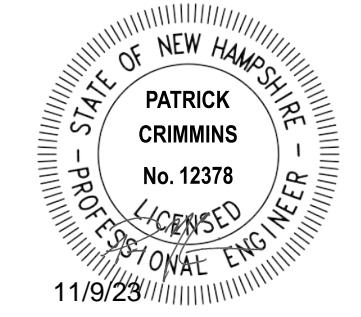
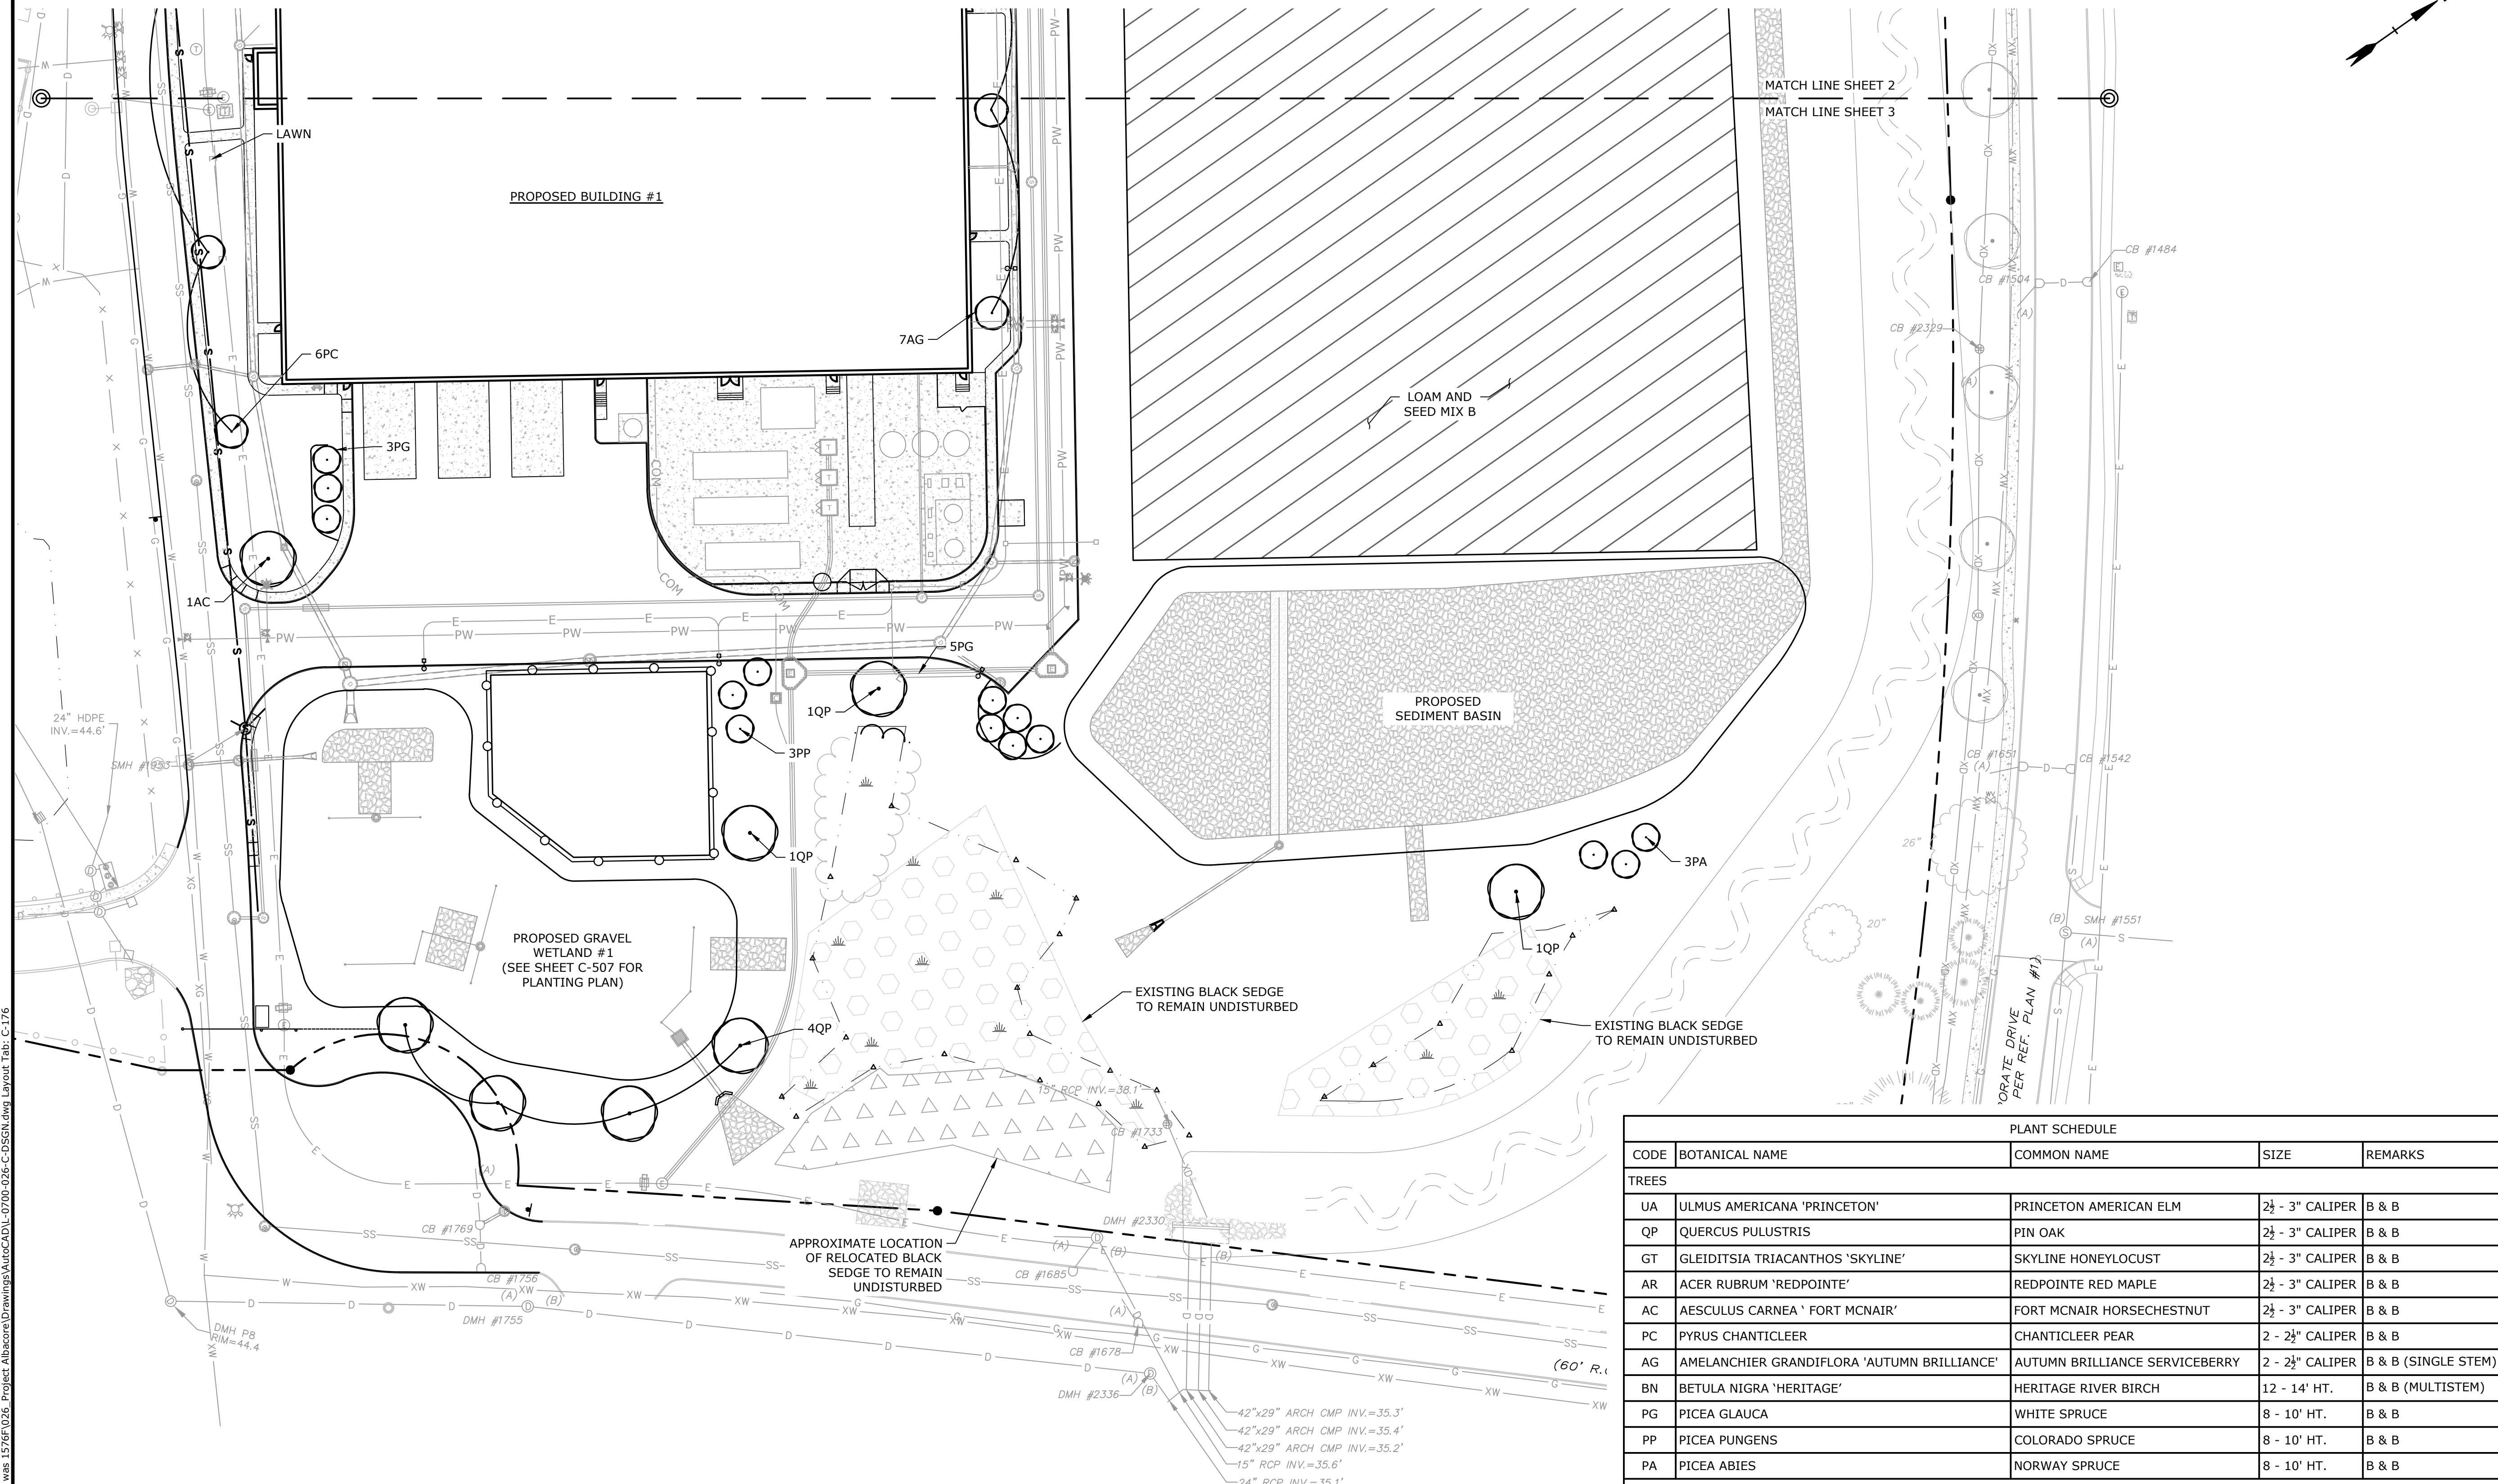
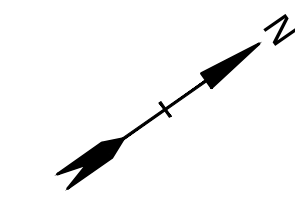
PHASE 2 LANDSCAPE PLAN

SCALE: AS SHOWN

SEE SHEET C-174 FOR LANDSCAPING NOTES

SEE SHEET C-176 FOR PLANT SCHEDULE

Last Save Date: November 9, 2023 11:03 AM By: NAHANSEN
 Plot Date: Thursday, November 09, 2023 Plotted By: Neil A. Hansen
 P&E File Location: J:\L-0700-Lonza Biologics Expansion.was 12/26/2026 Project Subarea: Drawings\AutoCAD\L-0700-026-C-DSGN.dwg Layout Tab: C-175



Proposed Industrial Development
Lonza Biologics

Portsmouth, New Hampshire

PLANT SCHEDULE				
CODE	BOTANICAL NAME	COMMON NAME	SIZE	REMARKS
TREES				
UA	ULMUS AMERICANA 'PRINCETON'	PRINCETON AMERICAN ELM	2½ - 3" CALIPER	B & B
QP	QUERCUS PULUSTRIS	PIN OAK	2½ - 3" CALIPER	B & B
GT	GLEIDITSIA TRIACANTHOS 'SKYLINE'	SKYLINE HONEYLOCUST	2½ - 3" CALIPER	B & B
AR	ACER RUBRUM 'REDPOINTE'	REDPOINTE RED MAPLE	2½ - 3" CALIPER	B & B
AC	AESCULUS CARNEA 'FORT MCNAIR'	FORT MCNAIR HORSECHESTNUT	2½ - 3" CALIPER	B & B
PC	PYRUS CHANTICLEER	CHANTICLEER PEAR	2 - 2½" CALIPER	B & B
AG	AMELANCHIER GRANDIFLORA 'AUTUMN BRILLIANCE'	AUTUMN BRILLIANCE SERVICEBERRY	2 - 2½" CALIPER	B & B (SINGLE STEM)
BN	BETULA NIGRA 'HERITAGE'	HERITAGE RIVER BIRCH	12 - 14' HT.	B & B (MULTISTEM)
PG	PICEA GLAUCA	WHITE SPRUCE	8 - 10' HT.	B & B
PP	PICEA PUNGENS	COLORADO SPRUCE	8 - 10' HT.	B & B
PA	PICEA ABIES	NORWAY SPRUCE	8 - 10' HT.	B & B
SHRUBS				
VC	VIBURNUM CASSINOIDES	WITHEROD VIBURNUM	2½ - 3' HT.	B & B
RE	RHODODENDRON 'ENGLISH ROSEUM'	ENGLISH ROSEUM RHODODENDRON	2½ - 3' HT.	B & B
CA	CLETHERA ALNIFOLIA	SUMMERSWEET CLETHERA	7 GALLON	CONTAINER
HQ	HYDRANGEA QUERCIFOLIA 'SNOW QUEEN'	SNOW QUEEN OAKLEAF HYDRANGEA	2½ - 3' HT.	B & B
GROUNDCOVERS & PERENNIALS				
DL	HEMEROCALLIS 'STELLA DORO'	STELLA DORO DAYLILY	2 GALLON	CONTAINER
HR	HOSTA 'ROYAL STANDARD'	ROYAL STANDARD HOSTA	2 GALLON	CONTAINER
AS	ASTILBE 'VISIONS IN PINK'	VISIONS IN PINK ASTILBE	2 GALLON	CONTAINER
CAL	CALAMAGROSTIS 'KARL FOERSTER'	KARL FOERSTER FEATHER REED GRASS	3 GALLON	CONTAINER

- SEED MIX NOTES**
- SEED MIX "A" SHALL CONTAIN THE FOLLOWING SEED REQUIREMENTS AND BE APPLIED AT A RATE OF 40LB/AC OR APPROVED EQUAL.

SEED MIX	% BY WEIGHT
"REBEL II" TALL FESCUE	70%
"PALMER" PERENNIAL RYEGRASS	20%
"BARON" KENTUCKY BLUEGRASS	10%
 - SEED MIX "B" SHALL BE NEW ENGLAND CONSERVATION/WILDLIFE MIX OR APPROVED EQUAL APPLIED AT A RATE OF 25LB/AC.



SEE SHEET C-174 FOR LANDSCAPING NOTES

Last Save Date: November 9, 2023 11:03 AM By: NAHANSEN
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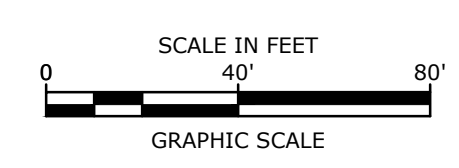
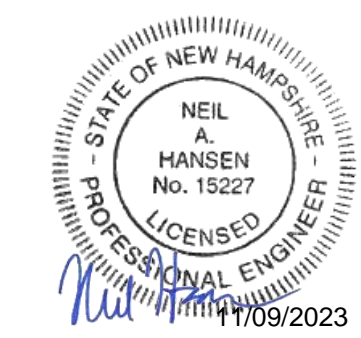
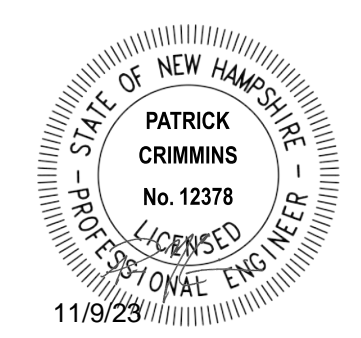
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 DRAWN BY: CJK
 CHECKED: NAH
 APPROVED: PMC

PHASE 2 LANDSCAPE PLAN
 SCALE: AS SHOWN
C-176



Symbol	Qty	Label	Arrangement	Description	(MANUFAC)
[Symbol]	4	P3-2	Back-Back	XMM-LED-12L-S1L-5W-UNV-DIM-30-70CRI-CXX / 48Q B3 S11G 20 D180 GA 4BC (20' AFG)	LSI INDUSTRIES, INC.
[Symbol]	7	S3	Single	MRM-LED-09L-S1L-1-UNV-DIM-30-70CRI-CXX / 48Q B3 S11G 20 S GA 4BC (20' AFG)	LSI INDUSTRIES, INC.
[Symbol]	3	S4	Single	MRM-LED-09L-S1L-FT-UNV-DIM-30-70CRI-CXX / 48Q-B3-S11G-20-S-GA-4BC (20' AFG)	LSI INDUSTRIES, INC.
[Symbol]	1	S5-1	Single	MRM-LED-09L-S1L-5W-UNV-DIM-30-70CRI-CXX / 48Q B3 S11G 20 S GA 4BC (20' AFG)	LSI INDUSTRIES, INC.
[Symbol]	9	W3	Single	XMM-3-LED-12L-30-UE-CXX / WALL MTD 20' AFG	LSI INDUSTRIES, INC.
[Symbol]	10	W4	Single	XMM-FT-LED-12L-30-UE-CXX / WALL MTD 20' AFG	LSI INDUSTRIES, INC.

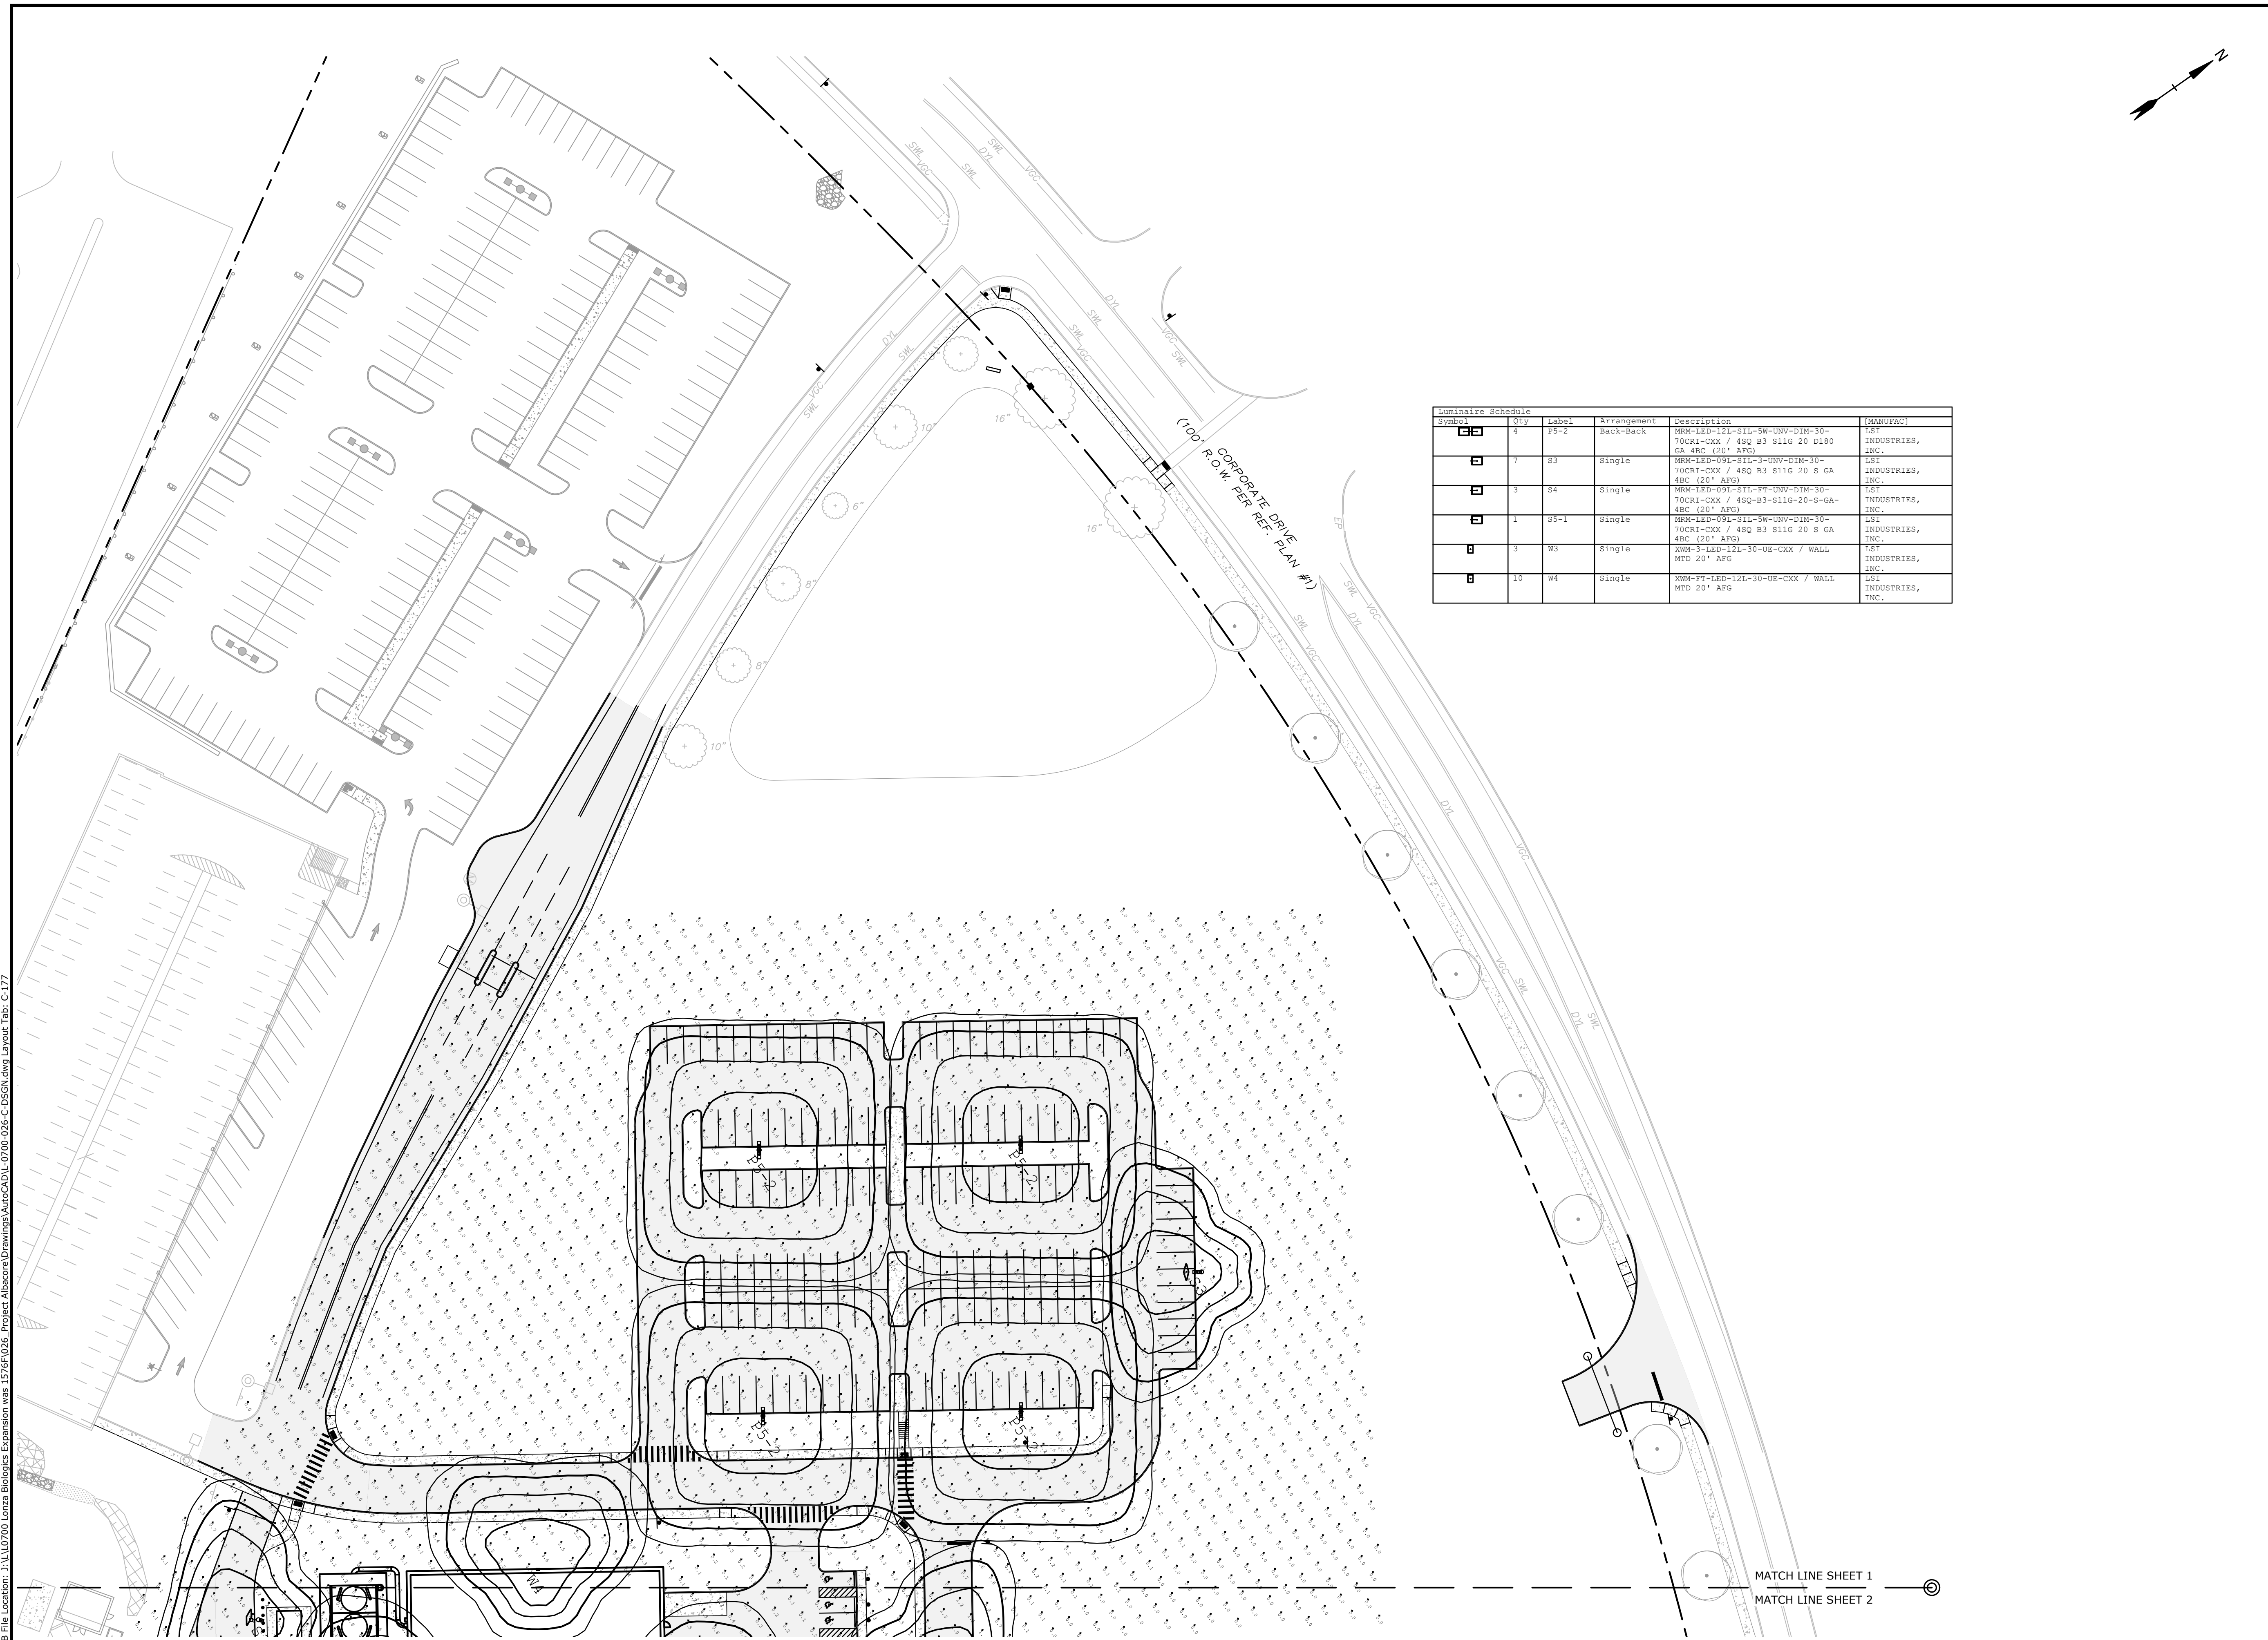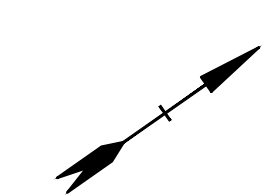

Proposed Industrial Development

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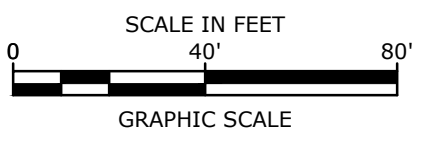
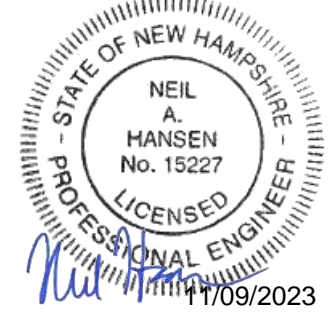
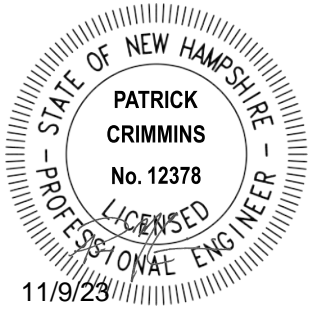
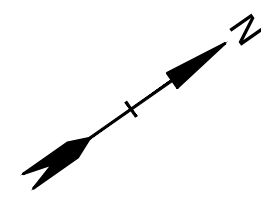
PHASE 2 PHOTOMETRIC LIGHTING PLAN

SCALE: AS SHOWN

C-177

Last Save Date: November 9, 2023 11:03 AM By: NAHANSEN
 Plot Date: Thursday, November 09, 2023 Plotted By: Neil A. Hansen
 P&E File Location: L:\0700 Lonza Biologics Expansion.was 12/26/2026 Project Subarea Drawings\AutoCAD\0700-026-C-DSGN.dwg Layout Tab: C-177

MATCH LINE SHEET 1
MATCH LINE SHEET 2



Proposed Industrial Development

Lonza Biologics

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MARK	DATE	DESCRIPTION


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DATE: 04/03/2018

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DRAWN BY: CJK
CHECKED: NAH
APPROVED: PMC

PHASE 2 PHOTOMETRIC LIGHTING PLAN





SCALE: AS SHOWN

C-178

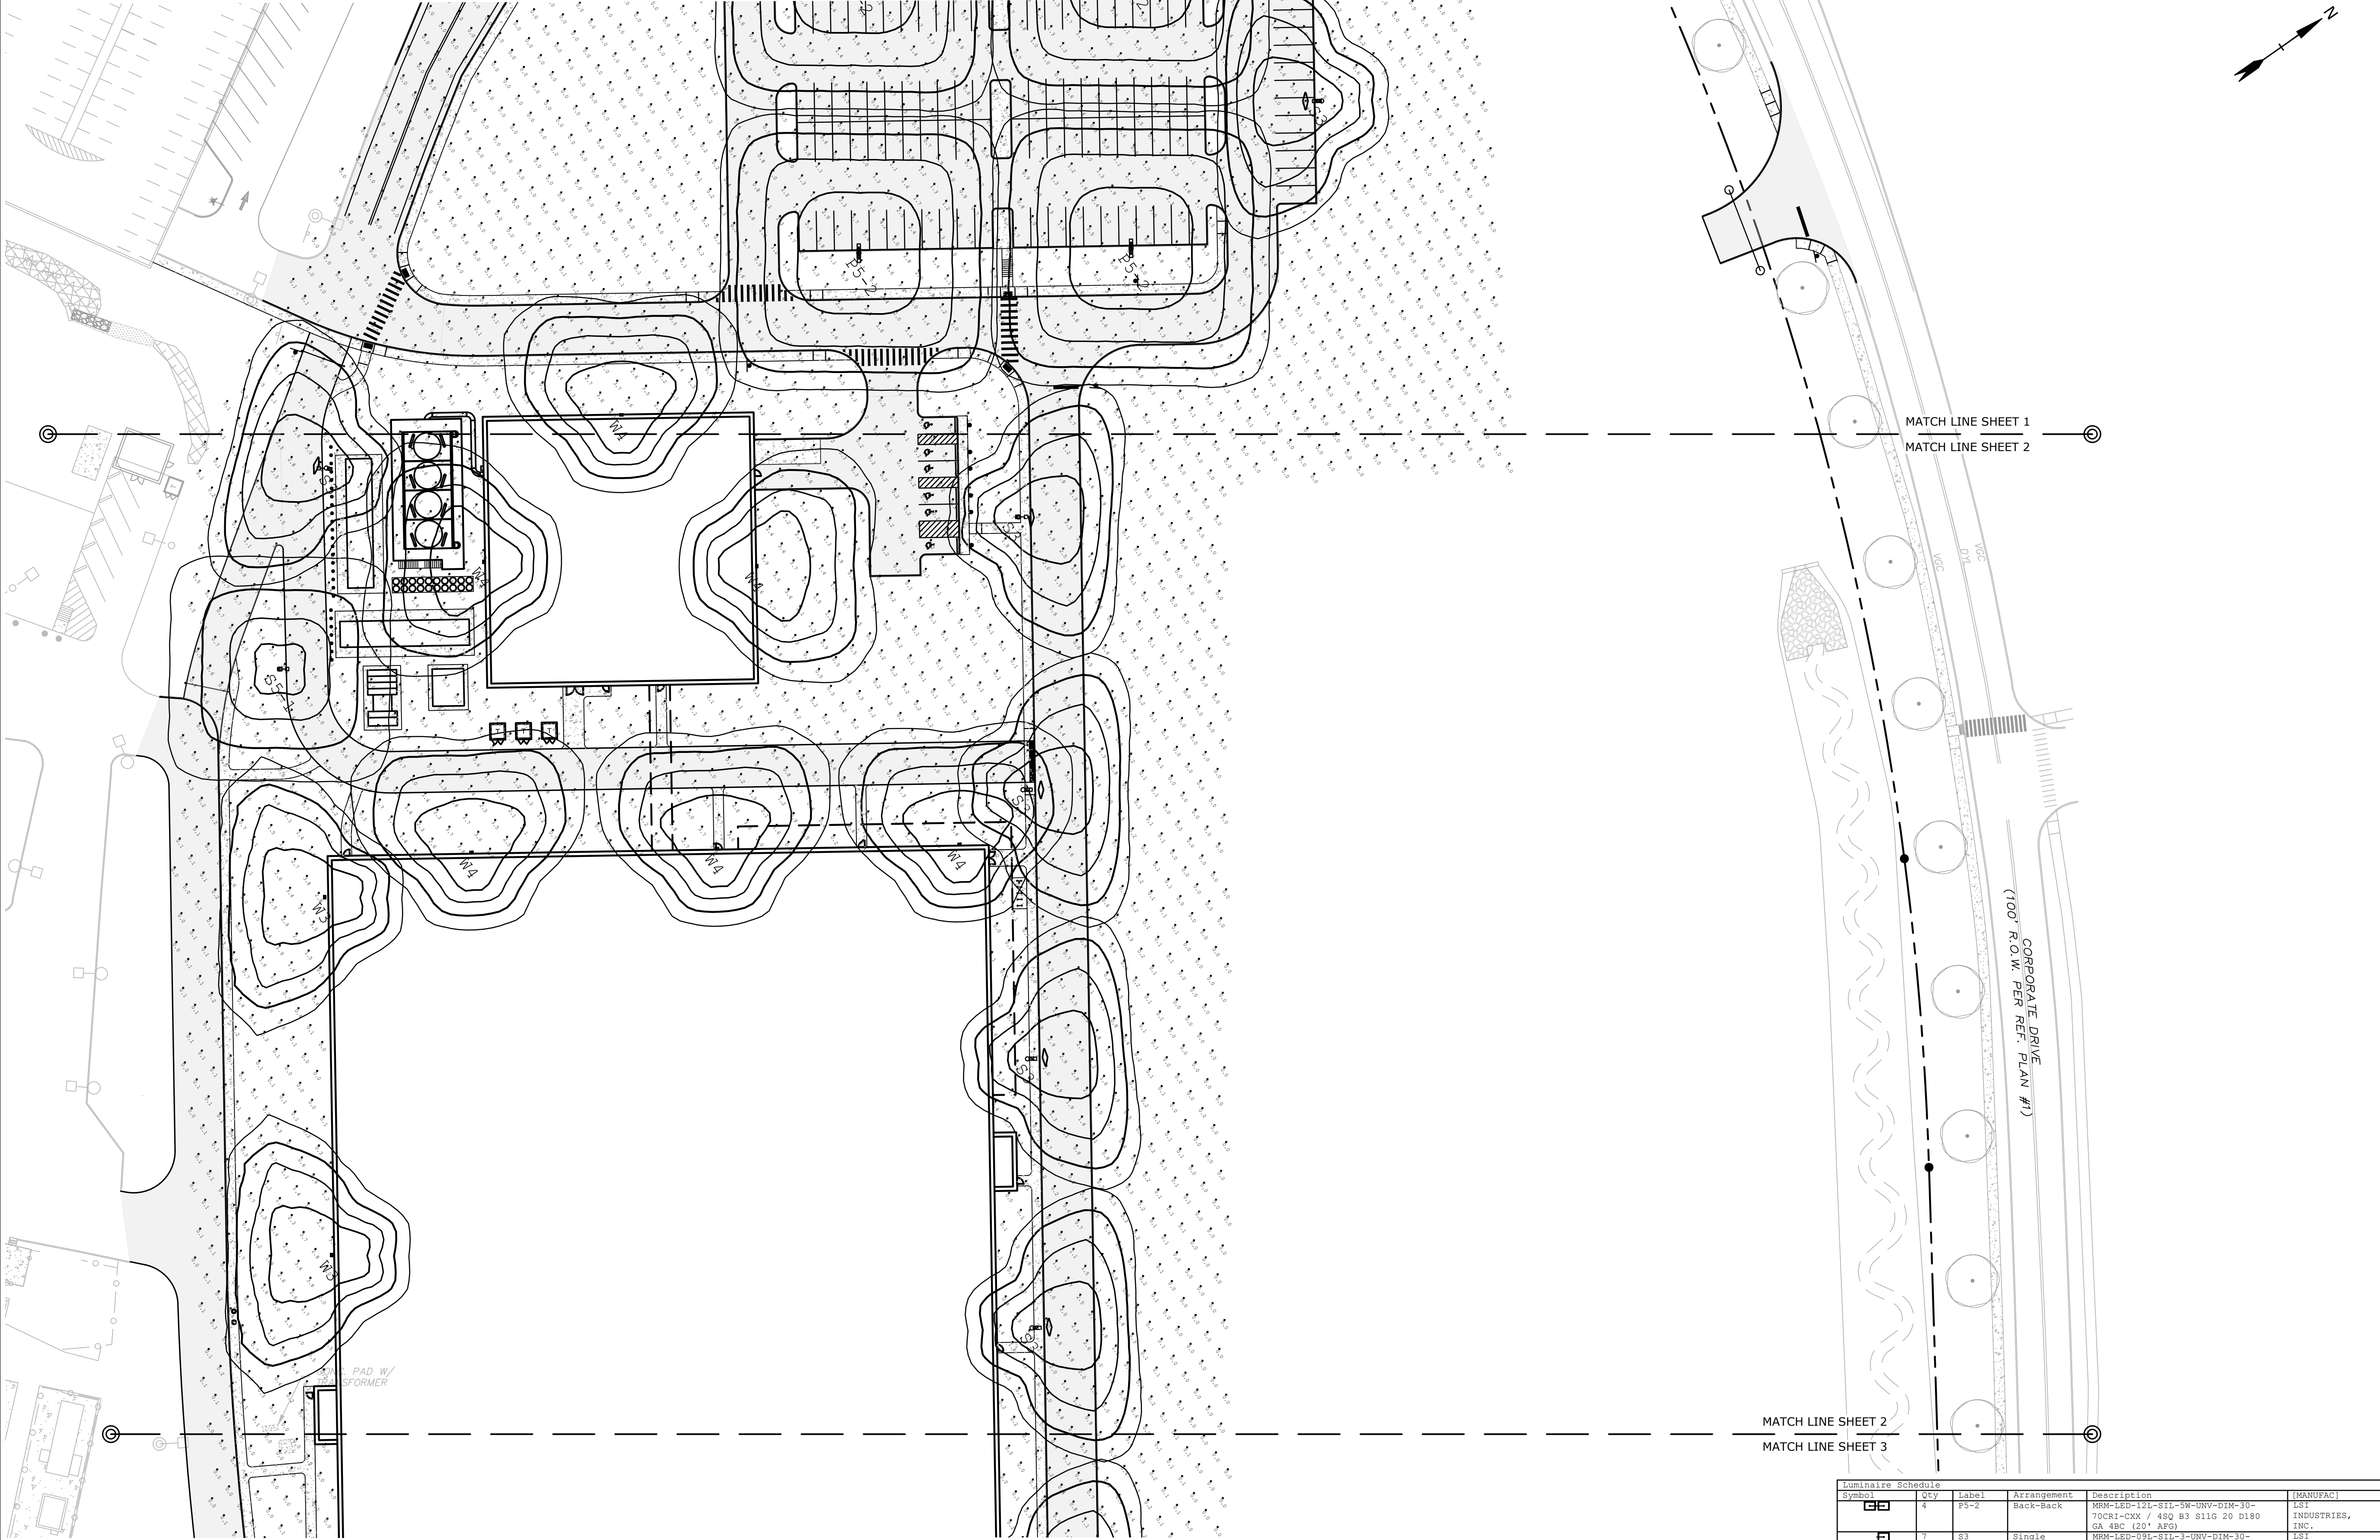

Symbol	Qty	Label	Arrangement	Description	MANUFAC
[Symbol]	4	P3-2	Back-Back	MM-LED-12L-81L-5W-UNV-DIM-30-70CRI-CXX / 48Q B3 S11G 20 D180 GA 4BC (20' AFG)	LSI INDUSTRIES, INC.
[Symbol]	7	S3	Single	MM-LED-12L-81L-3-UNV-DIM-30-70CRI-CXX / 48Q B3 S11G 20 S GA 4BC (20' AFG)	LSI INDUSTRIES, INC.
[Symbol]	3	S4	Single	MM-LED-12L-81L-5W-UNV-DIM-30-70CRI-CXX / 48Q-B3-S11G-20-S-GA-4BC (20' AFG)	LSI INDUSTRIES, INC.
[Symbol]	1	S5-1	Single	MM-LED-12L-81L-5W-UNV-DIM-30-70CRI-CXX / 48Q B3 S11G 20 S GA 4BC (20' AFG)	LSI INDUSTRIES, INC.
[Symbol]	3	W3	Single	XMM-3-LED-12L-30-UB-CXX / WALL MTD 20' AFG	LSI INDUSTRIES, INC.
[Symbol]	10	W4	Single	XMM-FT-LED-12L-30-UB-CXX / WALL MTD 20' AFG	LSI INDUSTRIES, INC.

Last Save Date: November 9, 2023 11:03 AM By: NAHANSEN
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Proposed Industrial Development

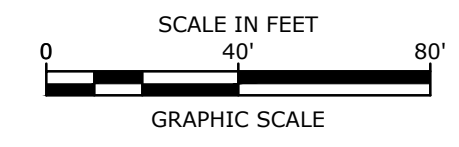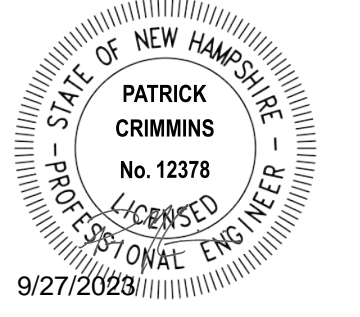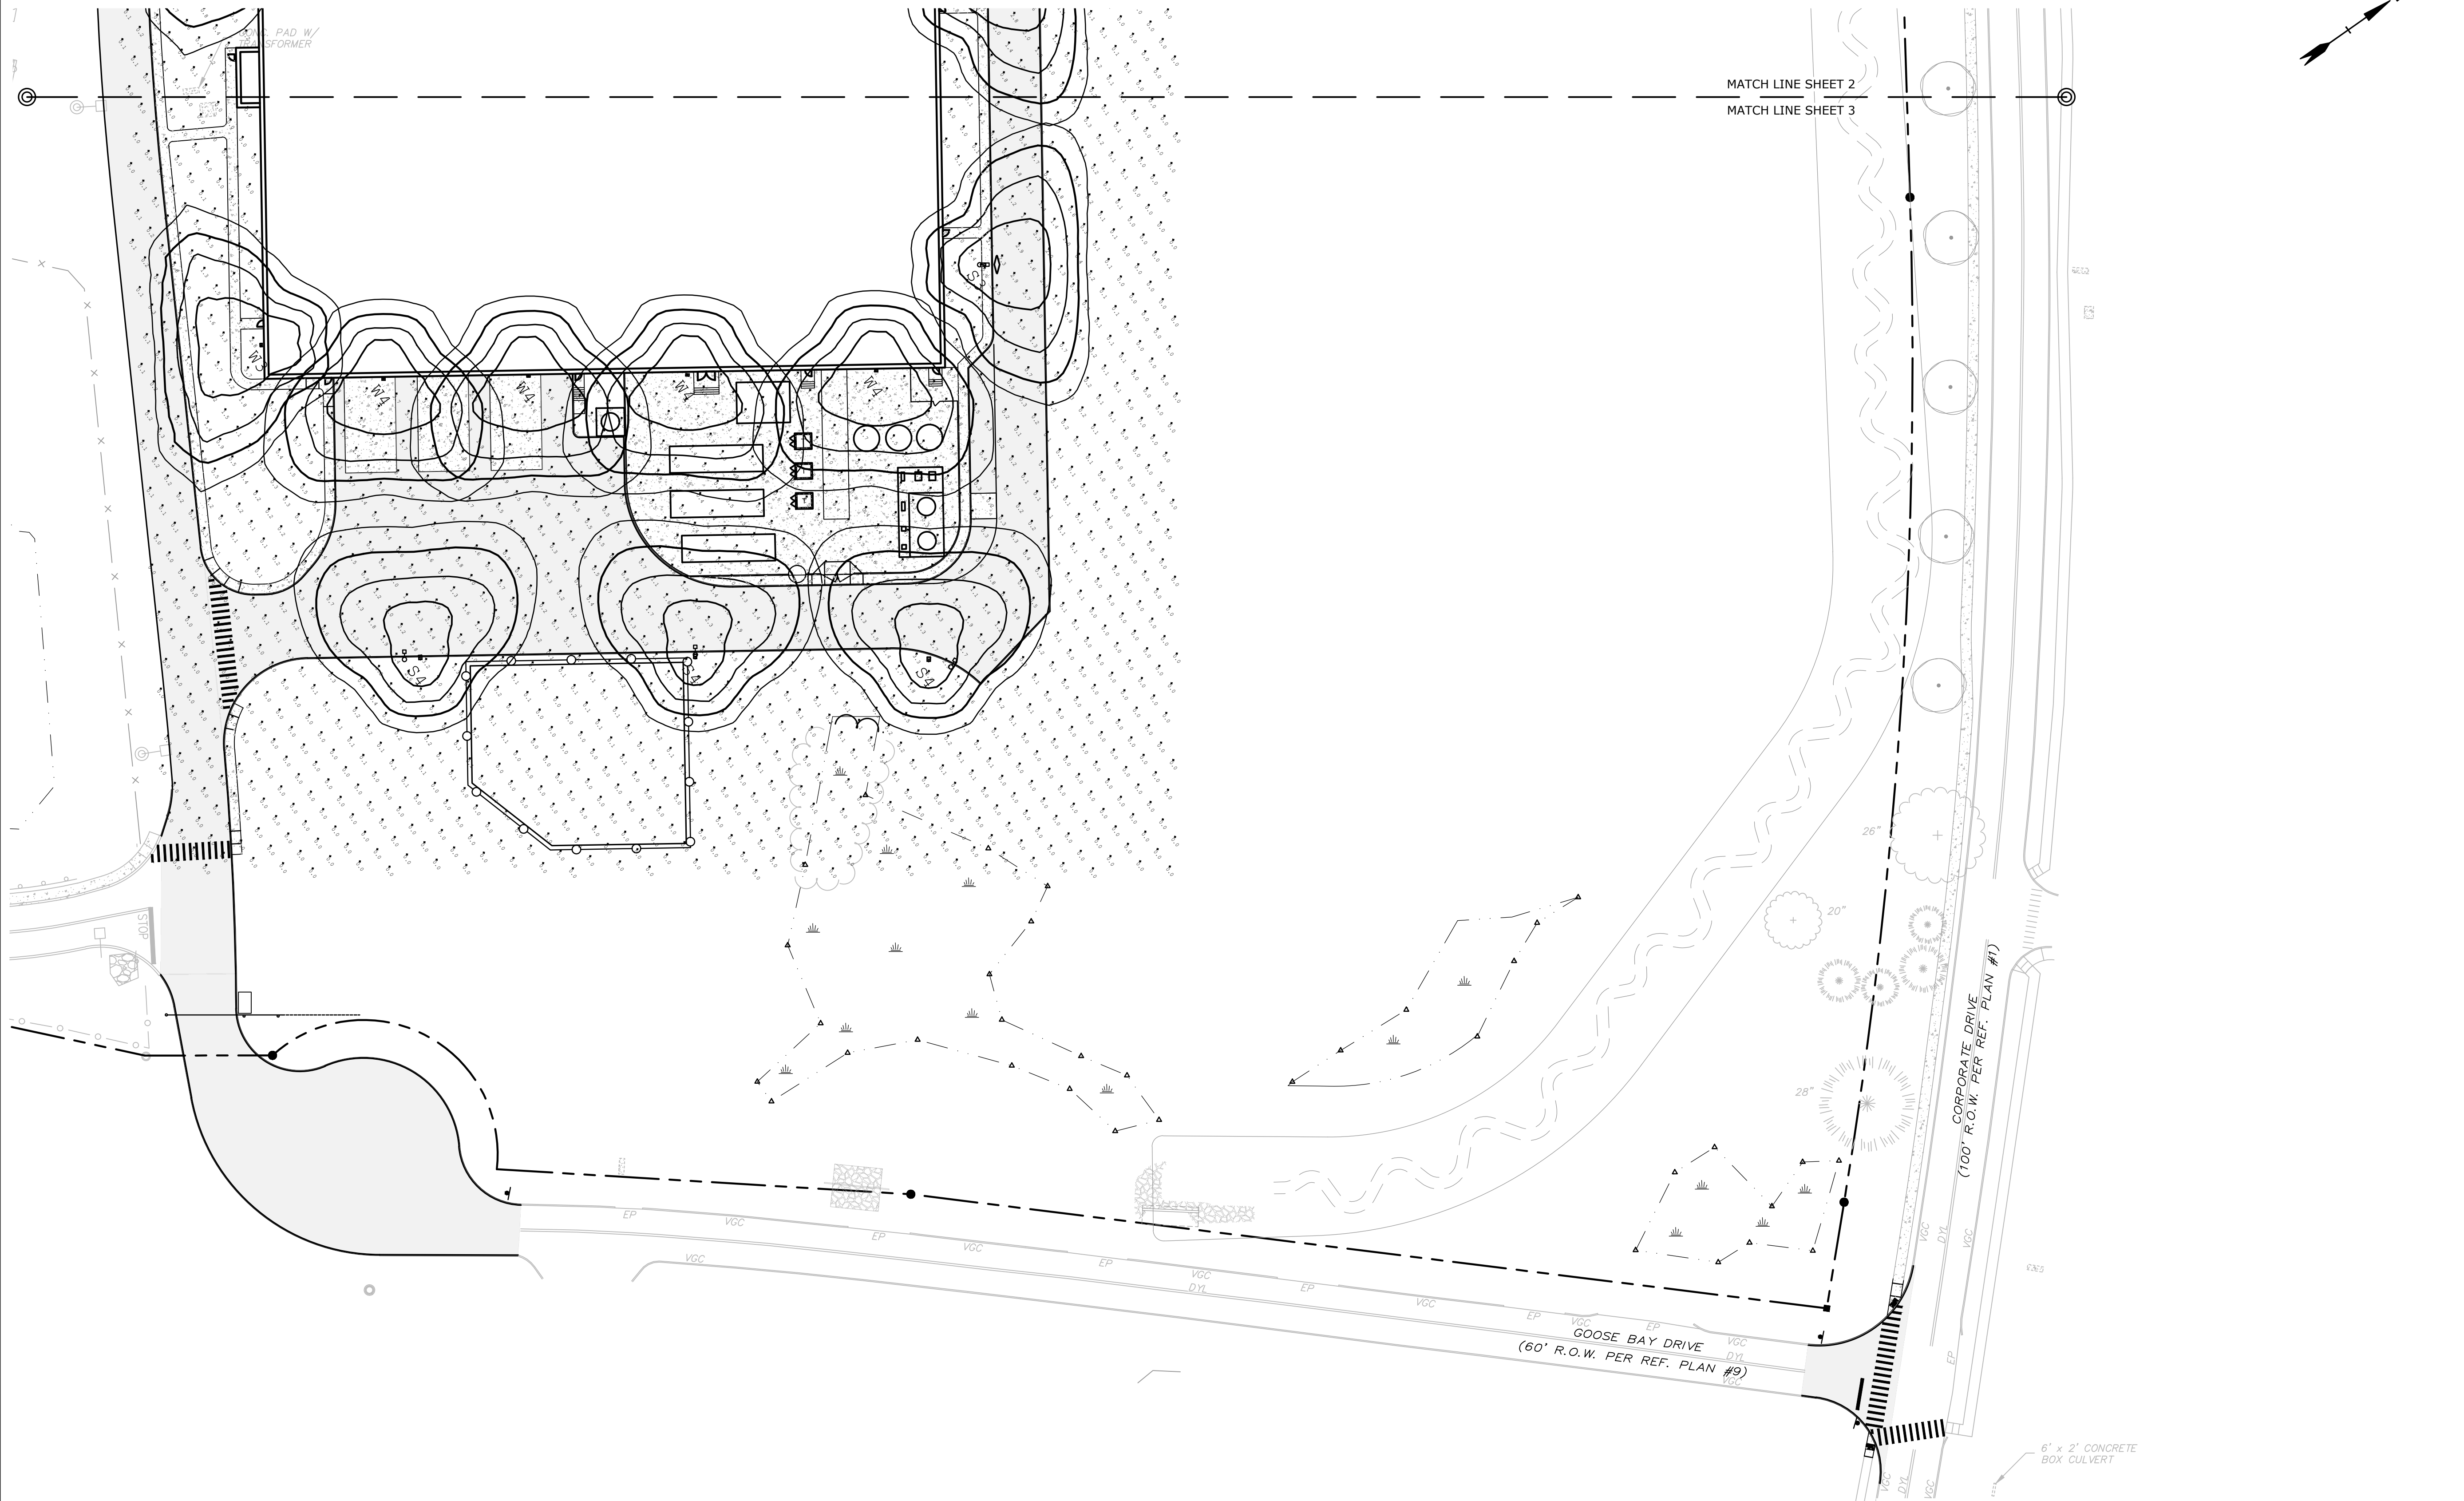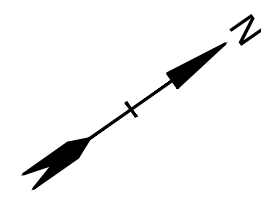Lonza Biologics

Portsmouth, New Hampshire

M	9/27/2023	P.B. Submission
L	7/17/2023	Amended Site Plan Review
K	5/5/2023	Phase 1B Issued for Bid
J	3/15/2023	Phase 1B Issued for Preliminary Pricing
I	1/9/2023	Admin. Approval Submission
H	12/10/2021	Planning Board Stipulation
G	8/19/2019	Admin. Approval Submission
F	11/6/2018	P.B. Submission

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FILE: L-0700-026-C-DSGN.dwg
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CHECKED: NAH
APPROVED: PMC

PHASE 2 PHOTOMETRIC LIGHTING PLAN

SCALE: AS SHOWN

Last Save Date: September 27, 2023 1:36 PM By: CKRZCUHK
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Symbol	Qty	Label	Arrangement	Description	(MANUFAC)
[Symbol]	4	P3-2	Back-Back	MRM-LED-12L-81L-5W-UNV-DIM-30-70CRI-CXX / 48Q B3 S11G 20 D180 GA 4BC (20' AFG)	LSI INDUSTRIES, INC.
[Symbol]	7	S3	Single	MRM-LED-12L-81L-3-UNV-DIM-30-70CRI-CXX / 48Q B3 S11G 20 S GA 4BC (20' AFG)	LSI INDUSTRIES, INC.
[Symbol]	3	S4	Single	MRM-LED-12L-81L-5W-UNV-DIM-30-70CRI-CXX / 48Q-B3-S11G-20-S-GA-4BC (20' AFG)	LSI INDUSTRIES, INC.
[Symbol]	1	S5-1	Single	MRM-LED-12L-81L-5W-UNV-DIM-30-70CRI-CXX / 48Q B3 S11G 20 S GA 4BC (20' AFG)	LSI INDUSTRIES, INC.
[Symbol]	3	W3	Single	XWM-3-LED-12L-30-UB-CXX / WALL MTD 20' AFG	LSI INDUSTRIES, INC.
[Symbol]	10	W4	Single	XWM-PT-LED-12L-30-UB-CXX / WALL MTD 20' AFG	LSI INDUSTRIES, INC.

NEW WORK SHEET NOTES
 NO CROSS BRACING (TYP)


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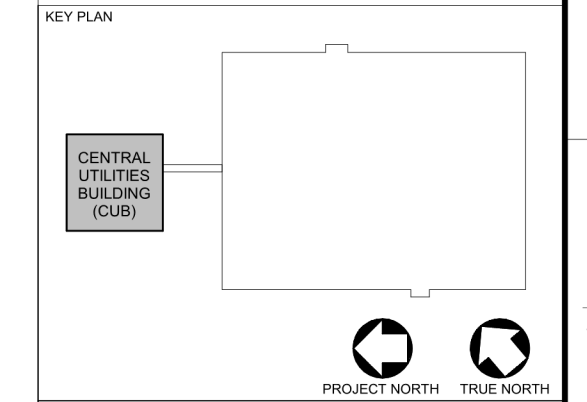
REVISION	DATE	DESCRIPTION	BY
A	16-MAR-23	DESIGN BUILD BID ISSUE (90% DD)	SBS
B	16-JUNE-23	CUB BID ISSUE (90% DD)	SBS
C	30-JUNE-23	PERMIT ISSUE	SBS
D	12-AUG-23	CONSTRUCTION ISSUE	SBS
1	24-AUG-23	BULLETIN NO. 1	SC

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LONZA ALBACORE PROJECT




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REF FILES	ENGINEER
	ARCHITECT
	DESIGNER

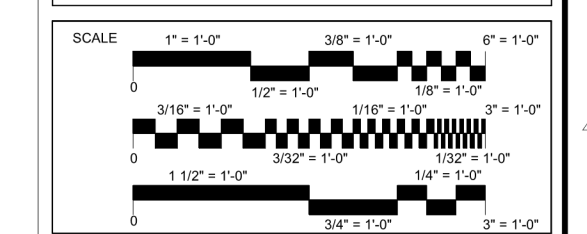

NOTE: APPLY SPRAYED-ON CEMENTITIOUS FIREPROOFING TO ALL STRUCTURAL FRAMING ELEMENTS (COLUMNS, CROSS BRACINGS AND BEAMS)

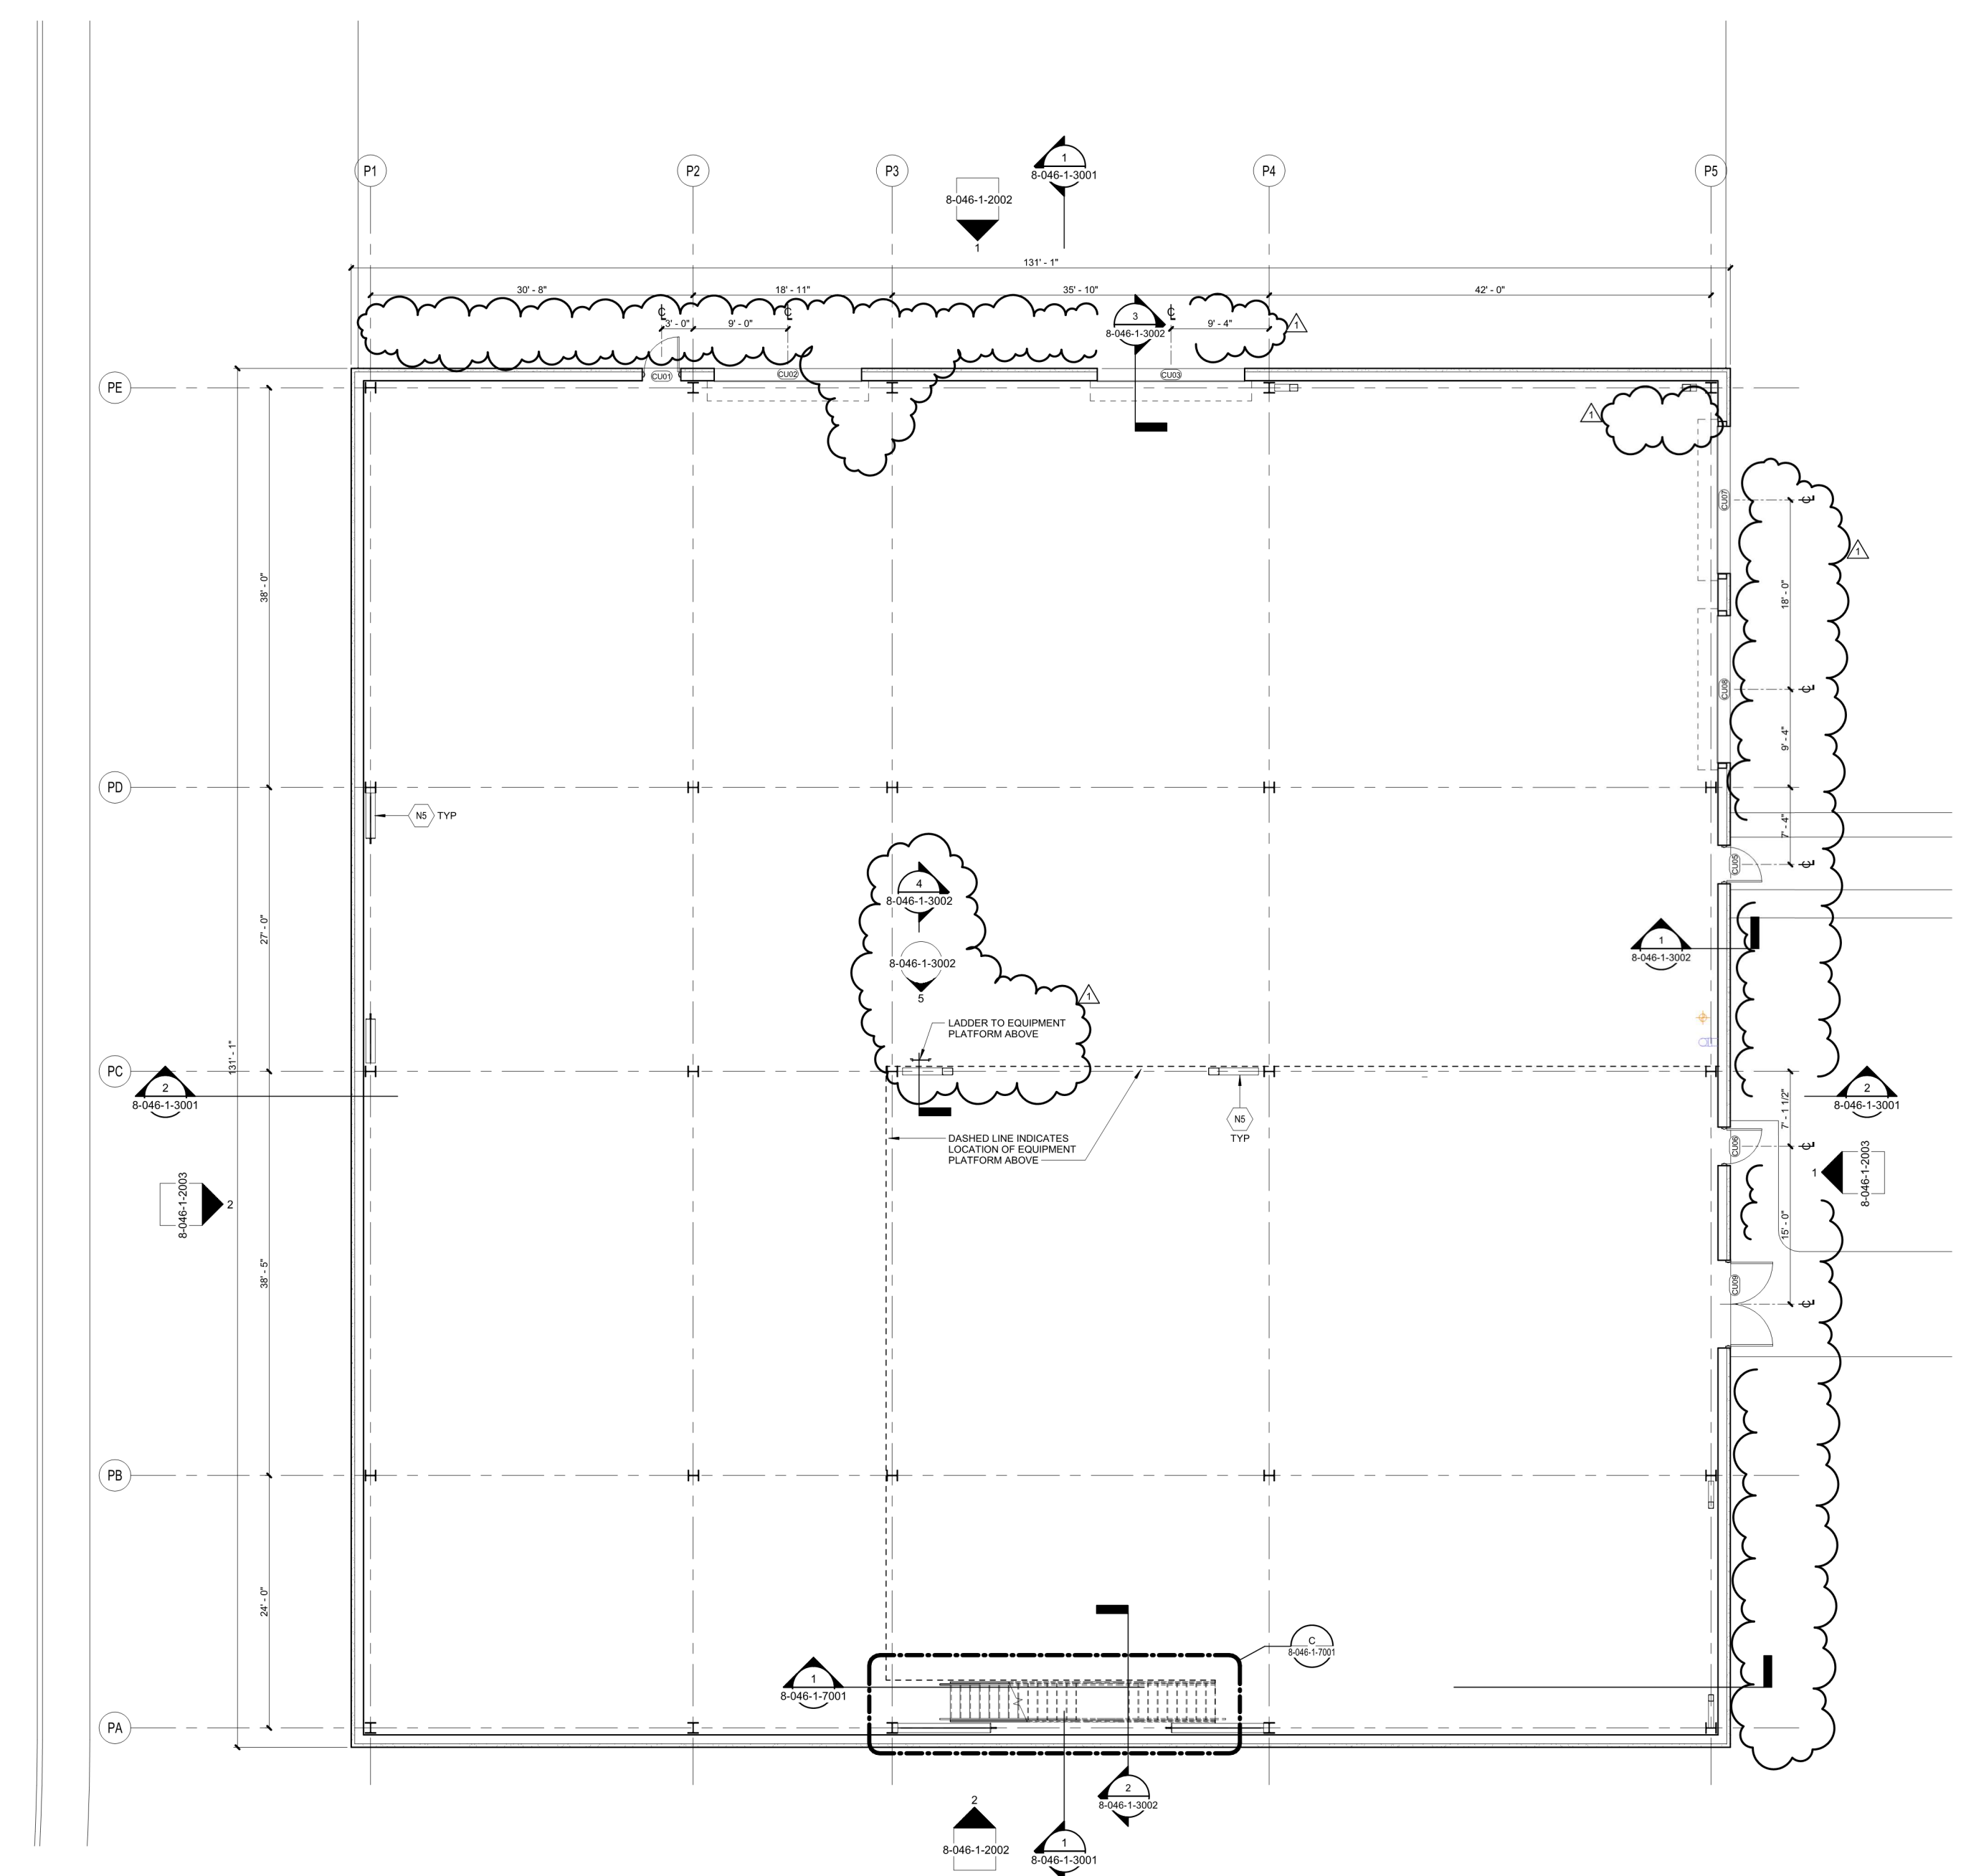

A FIRST FLOOR PLAN - CUB
 8-046-1-110 1/8" = 1'-0"

Reserved for Master Stamp Block

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 F: 1 (603) 354-9252
 www.lonza.com

SEAL: [Professional Engineer Seal for Frank No. 64187, State of New Hampshire]

DRAWING TITLE
FIRST FLOOR PLAN - CUB

Drawn By	Date Drawn	Project Number	PKID Number	DWG Filename	Revision
AD		MAD23047.01			1
Checked By	Date Checked	Scale	AS NOTED	Drawing Number	
JMJ				8-046-1-1110	

Tags: [Blank]

8/24/2023 7:52:26 AM
 Autodesk Civil 3D 2014 - 2017 - Lonza - Albacore23045_ARCH_Lonza.rvt

LEGEND

IMP1 :
 4" THICK INSULATED METAL PANELS TO HAVE MIN. R VALUE OF 33.5
 COLOR: MATT PURPLE, R153 G148 B176, 15% TINT - EMBOSSED EXTERIOR
 FINISH OF 22-GAUGE G-90 GALVANIZED STEEL WITH PVDF AND SMP ZINC
 EXTERIOR COATINGS

IMP2 :
 4" THICK INSULATED METAL PANELS TO HAVE MIN. R VALUE OF 33.5
 COLOR: MATT PURPLE, R153 G148 B176, 150% TINT - EMBOSSED EXTERIOR
 FINISH OF 22-GAUGE G-90 GALVANIZED STEEL WITH PVDF AND SMP ZINC
 EXTERIOR COATINGS

LV :
 - 4" STORM-RESISTANT LOUVER - SEE SHEET 8-046-A-5002

GL1 :
 1" THICK IMPACT RESISTANT INSULATED LAMINATED GLASS OB: 1/2" BLUE
 SOLARSBAN 60 #2 SURFACE 1/2 INCH (1 W/90% ARGON FILL) INTERLAYER 1/4"
 CLEAR AS MANUFACTURED BY VITRO AMERICA OR APPROVED EQUAL .
 PRIOR FABRICATION AND INSTALLATION THE CONTRACTOR SHALL SUBMIT
 SAMPLES FOR ARCHITECT APPROVAL. U VALUE:0.25

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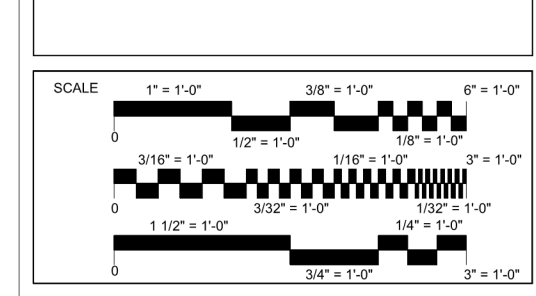
30 Corporate Drive, Suite 130
 Burlington, MA 01803
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 FAX: (781) 848-5508

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REVISION	DATE	DESCRIPTION	BY
A	16-MAR-23	DESIGN BUILD BID ISSUE (90% DD)	SPS
B	16-JUNE-23	CUB BID ISSUE (90% DD)	SPS
C	30-JUNE-23	PERMIT ISSUE	SPS
D	12-AUG-23	CONSTRUCTION ISSUE	SPS
1	24-AUG-23	BULLETIN NO. 1	SC

CLIENT



LONZA ALBACORE PROJECT




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REF FILES	ENGINEER
	ARCHITECT
	DESIGNER



1 EAST ELEVATION - CUB.
 8-046-1-2002 1/8" = 1'-0"

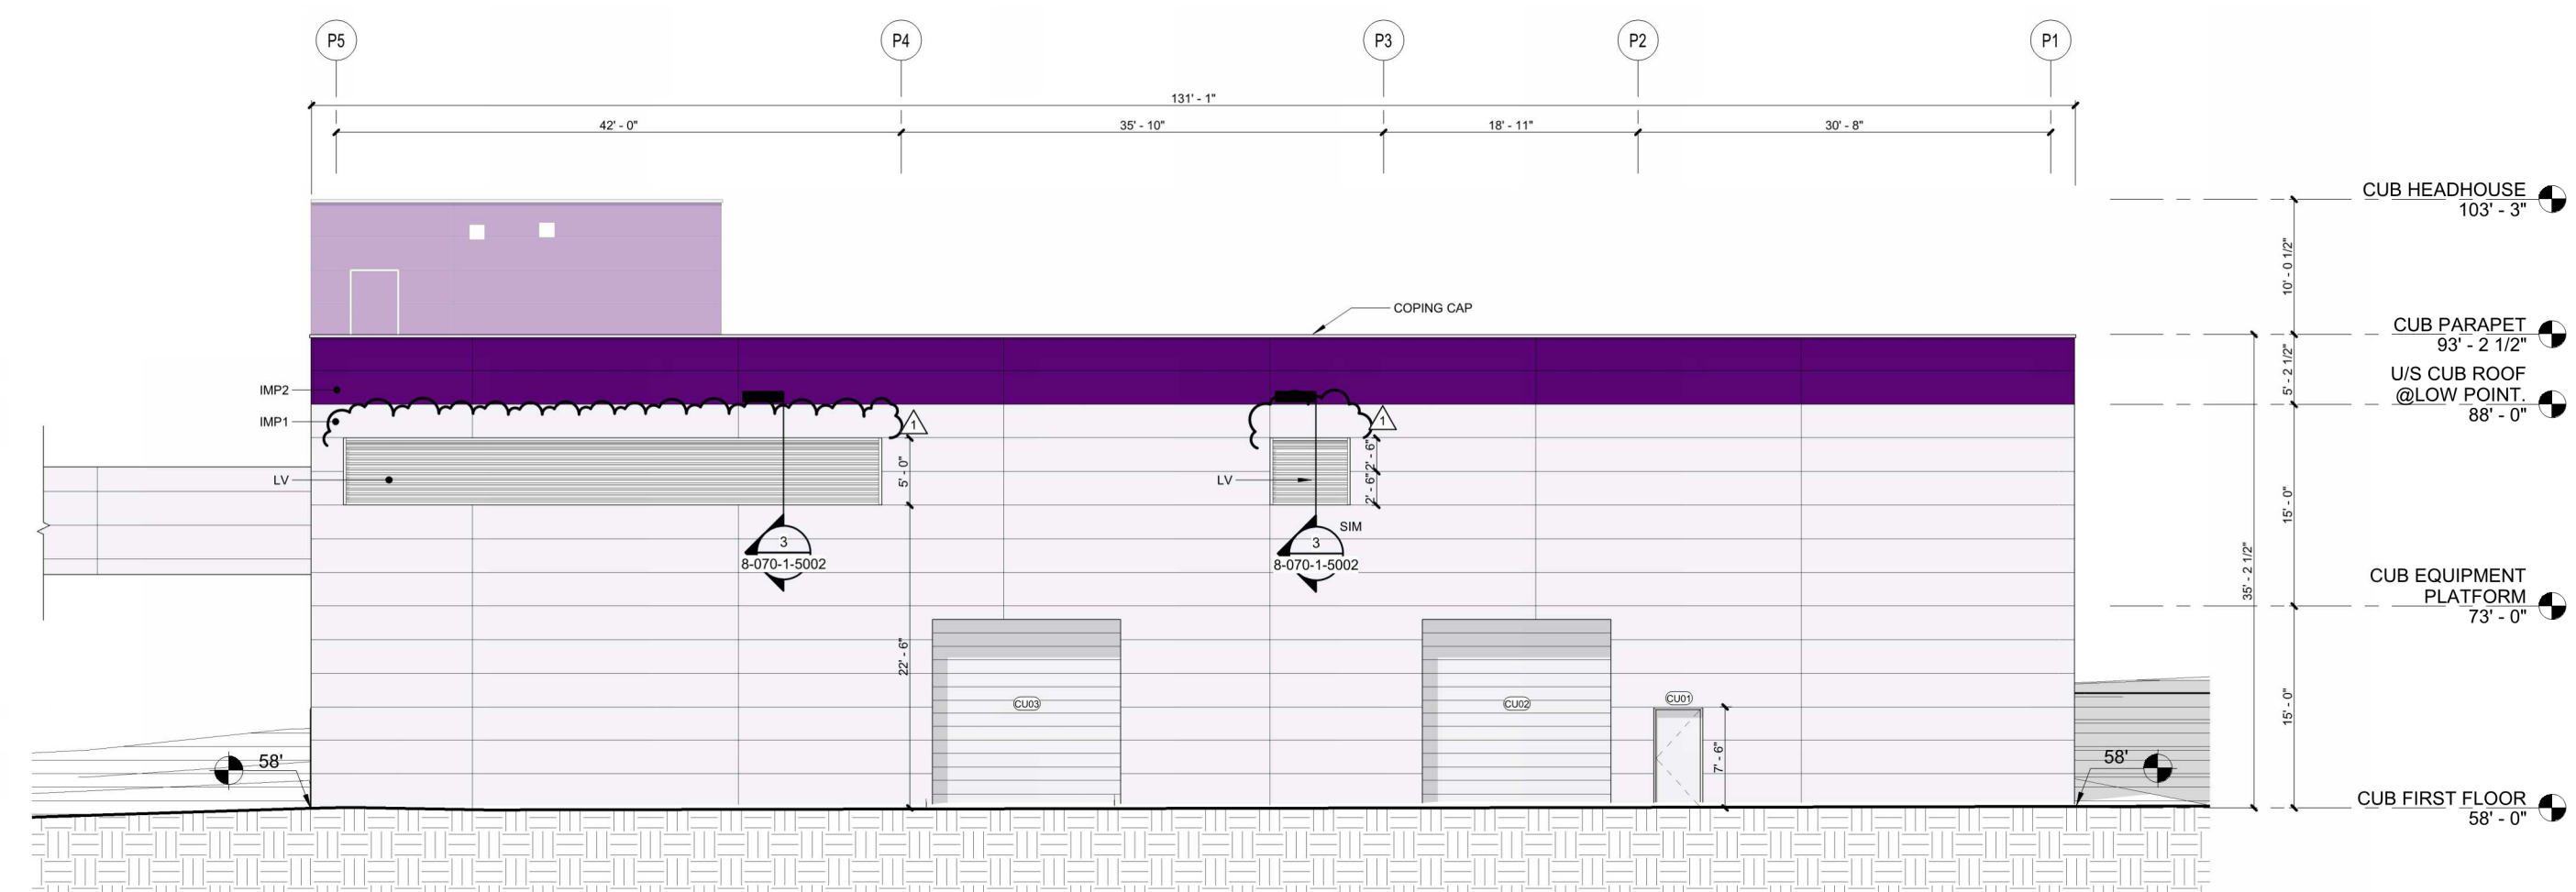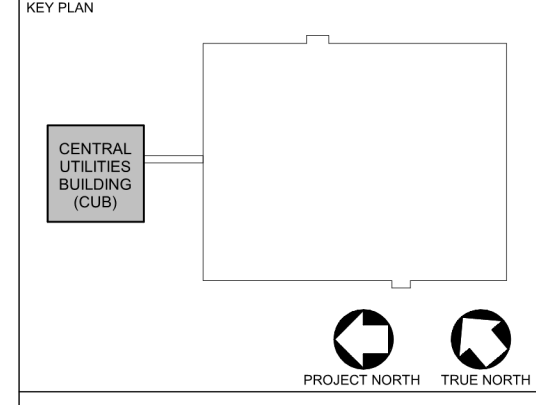

2 WEST ELEVATION - CUB.
 8-046-1-2002 1/8" = 1'-0"
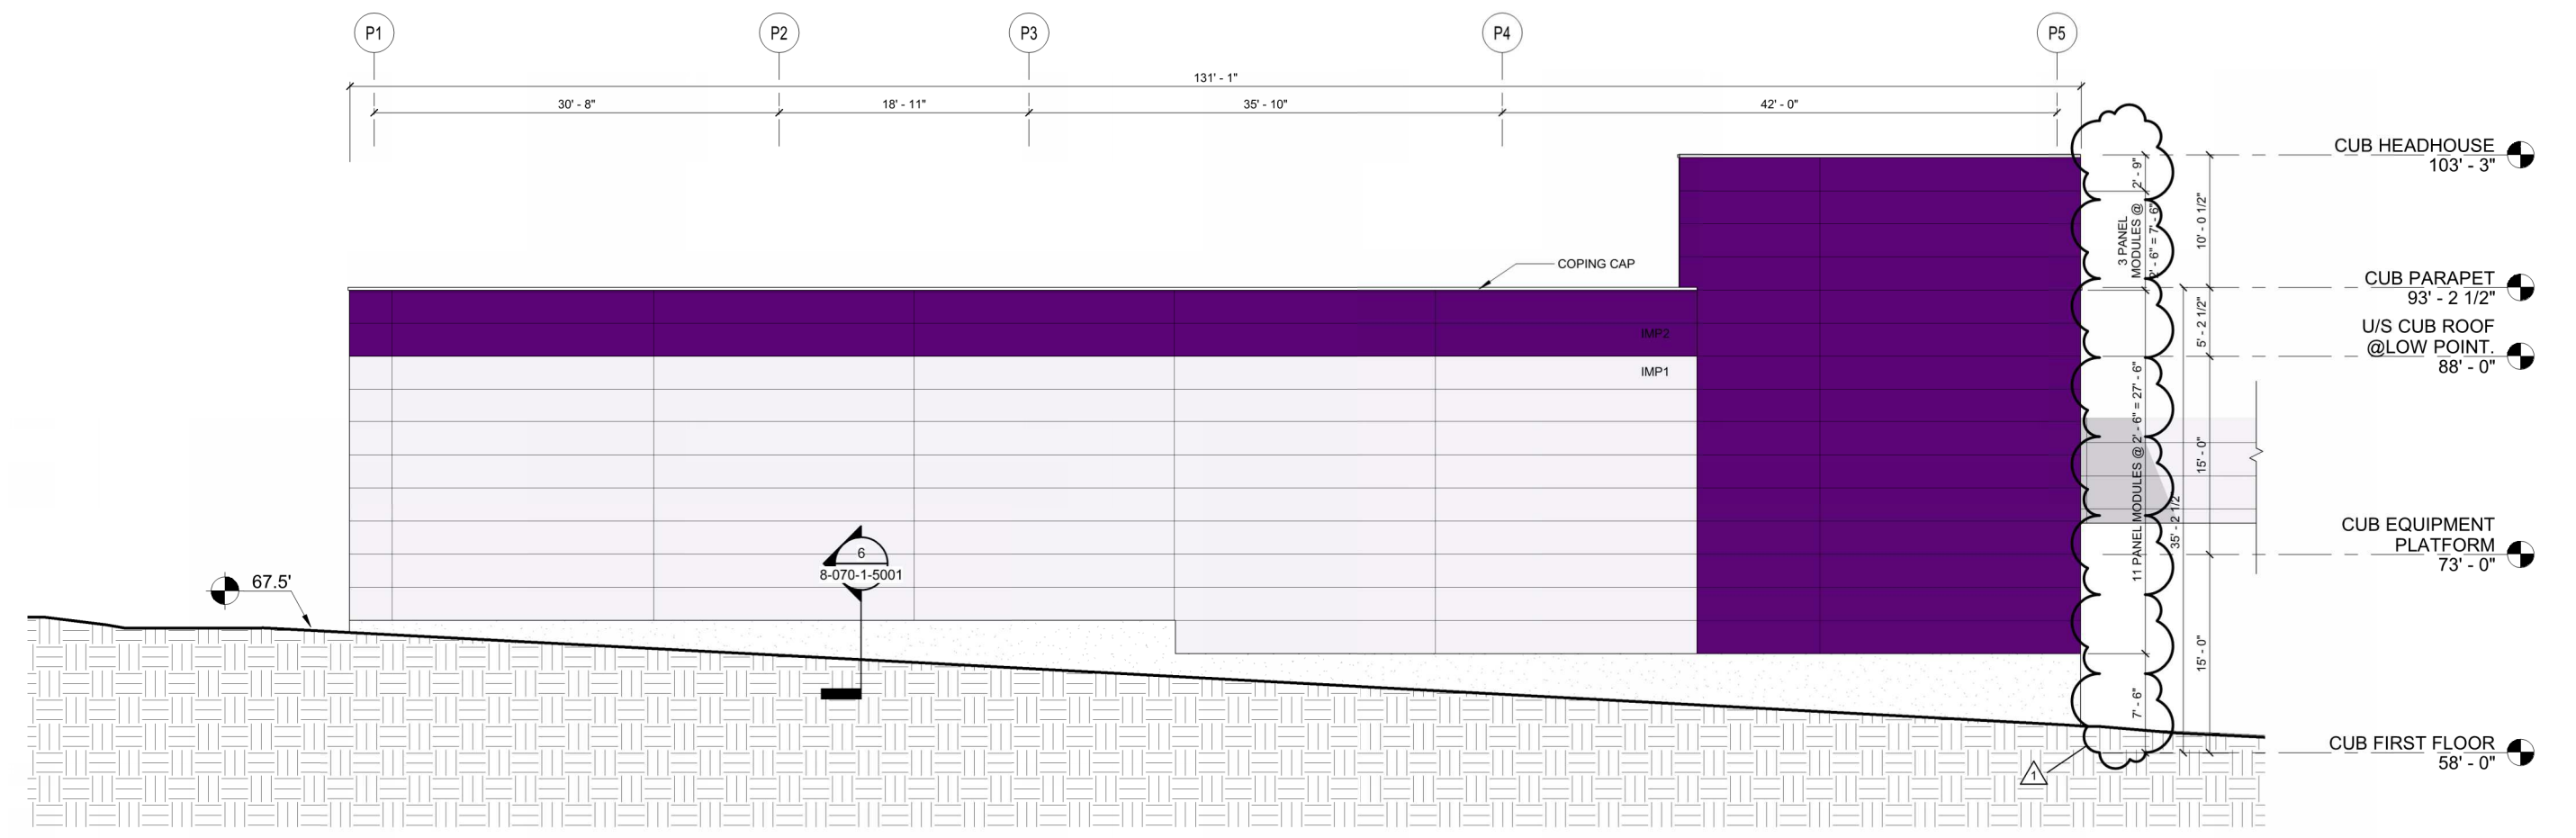
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DATE: 24-AUG-23

FRANK J. SHERIDAN
 No. 64187
 STATE OF NEW HAMPSHIRE

DRAWING TITLE
BUILDING ELEVATIONS - CUB

Drawn By	Date Drawn	Project Number	PKID Number	DWG Filename	Revision
AD		MAD23047.01			1
Checked By	Date Checked	Scale	AS NOTED	Drawing Number	
JIMJ				8-046-1-2002	

LEGEND

IMP1 :
4" THICK INSULATED METAL PANELS TO HAVE MIN. R VALUE OF 33.5
COLOR: PURPLE, R245 G243 B248 (5% TINT OF R56 G5 B119)

IMP2 :
4" THICK INSULATED METAL PANELS TO HAVE MIN. R VALUE OF 33.5
COLOR: DEEP PURPLE, R56 G5 B119.

LV :
- 4" STORM-RESISTANT LOUVER - SEE SHEET 8-046-A-5002


GL1 :
1" THICK IMPACT RESISTANT INSULATED LAMINATED GLASS OB: 1/2" BLUE SOLARBAN 70 XL SURFACE 1/2 INCH (W/90% ARGON FILL) INTERLAYER 1/4" CLEAR AS MANUFACTURED BY VITRO AMERICA OR APPROVED EQUAL. PRIOR FABRICATION AND INSTALLATION THE CONTRACTOR SHALL SUBMIT SAMPLES FOR ARCHITECT APPROVAL. U VALUE:0.25

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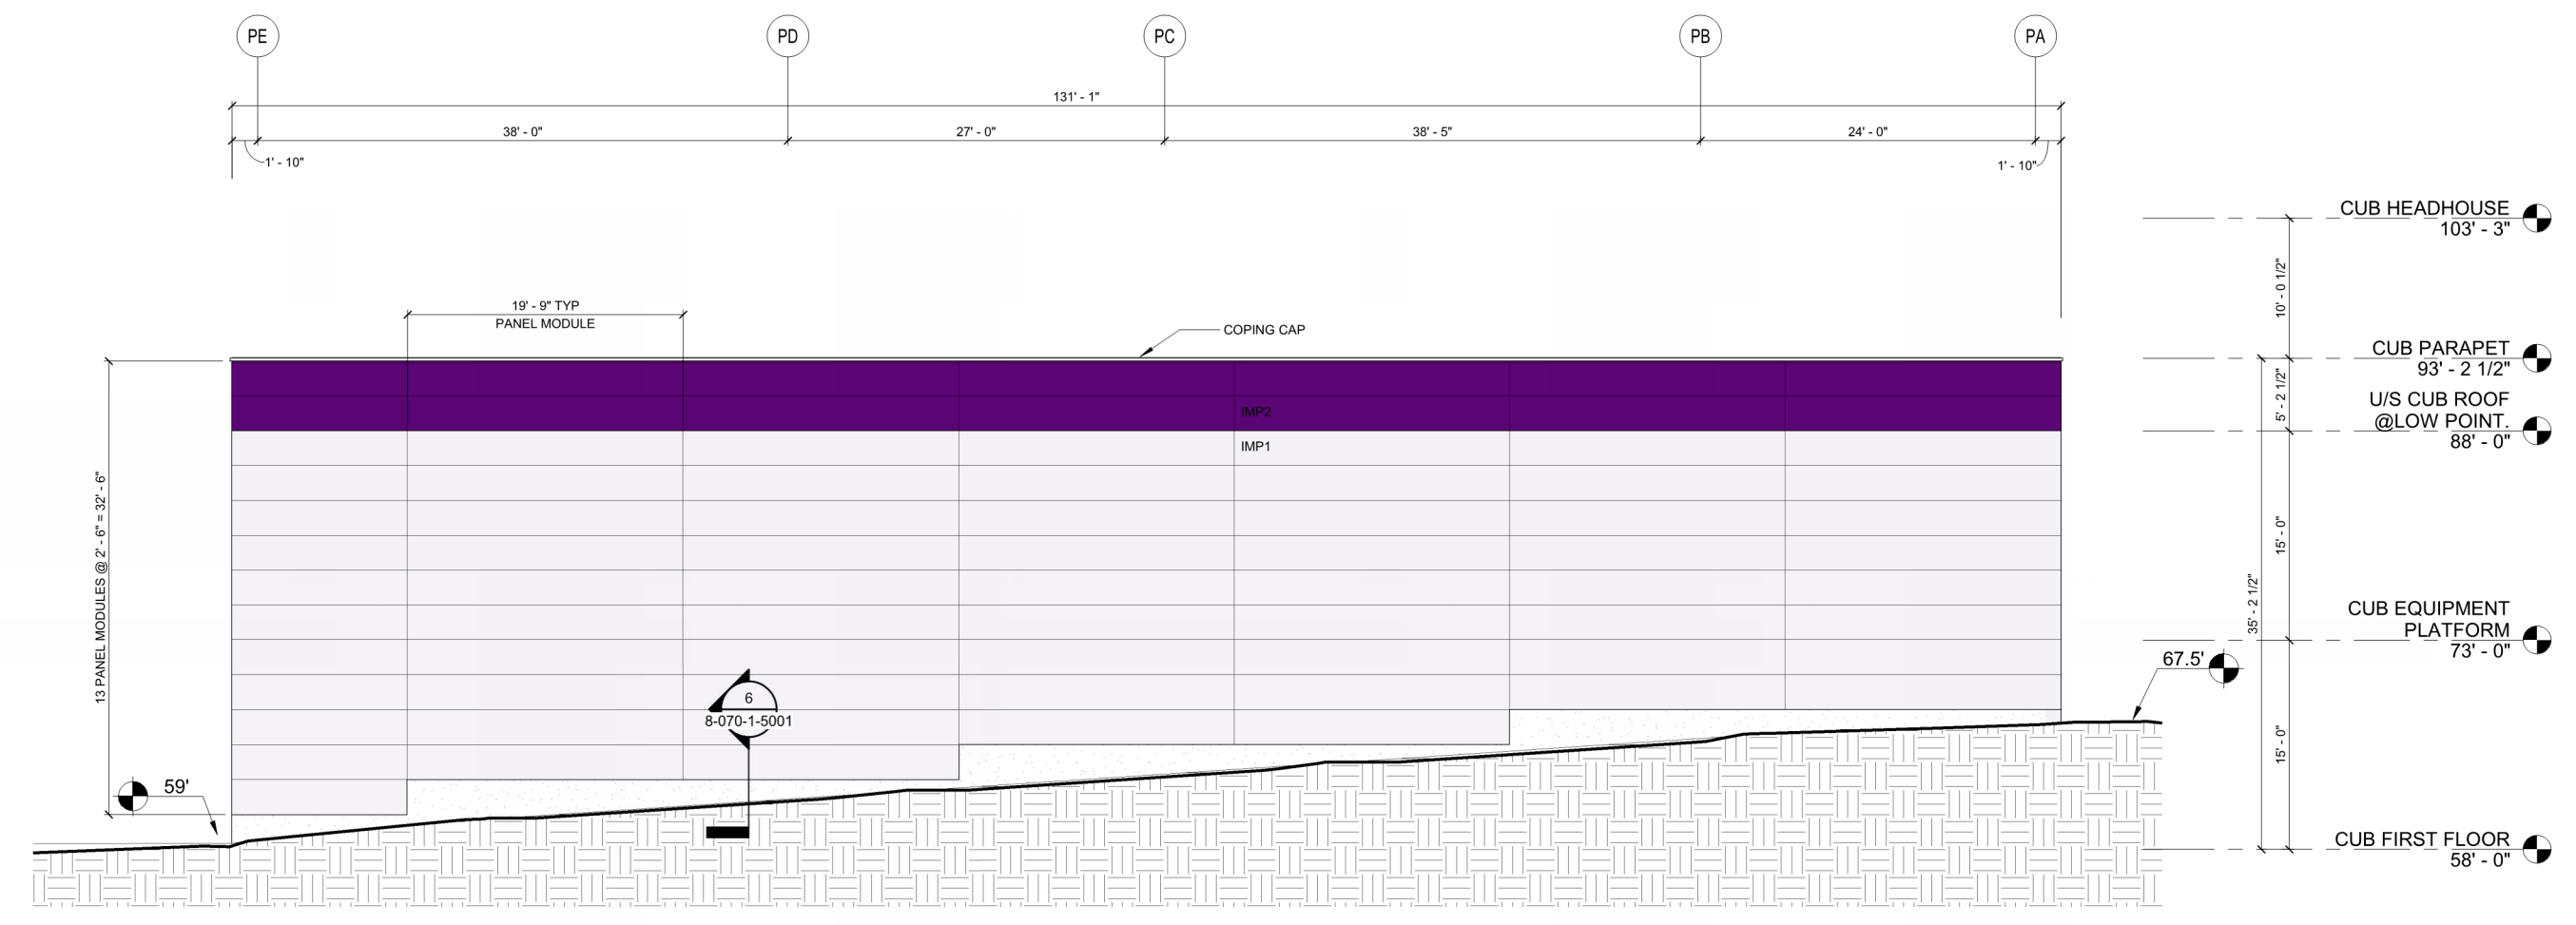
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REVISION	DATE	DESCRIPTION	BY
A	16-MAR-23	DESIGN BUILD BID ISSUE (90% DD)	SBS
B	16-JUNE-23	CUB BID ISSUE (90% DD)	SBS
C	30-JUNE-23	PERMIT ISSUE	SBS
D	15-AUG-23	CONSTRUCTION NO. 2	SBS
E	12-JULY-23	CONSTRUCTION ISSUE	SBS
1	24-AUG-23	BULLETIN NO. 1	SC
2	18-SEP-23	BULLETIN NO. 2	SC




1 SOUTH ELEVATION - CUB
8-046-1-2003 1/8" = 1'-0"

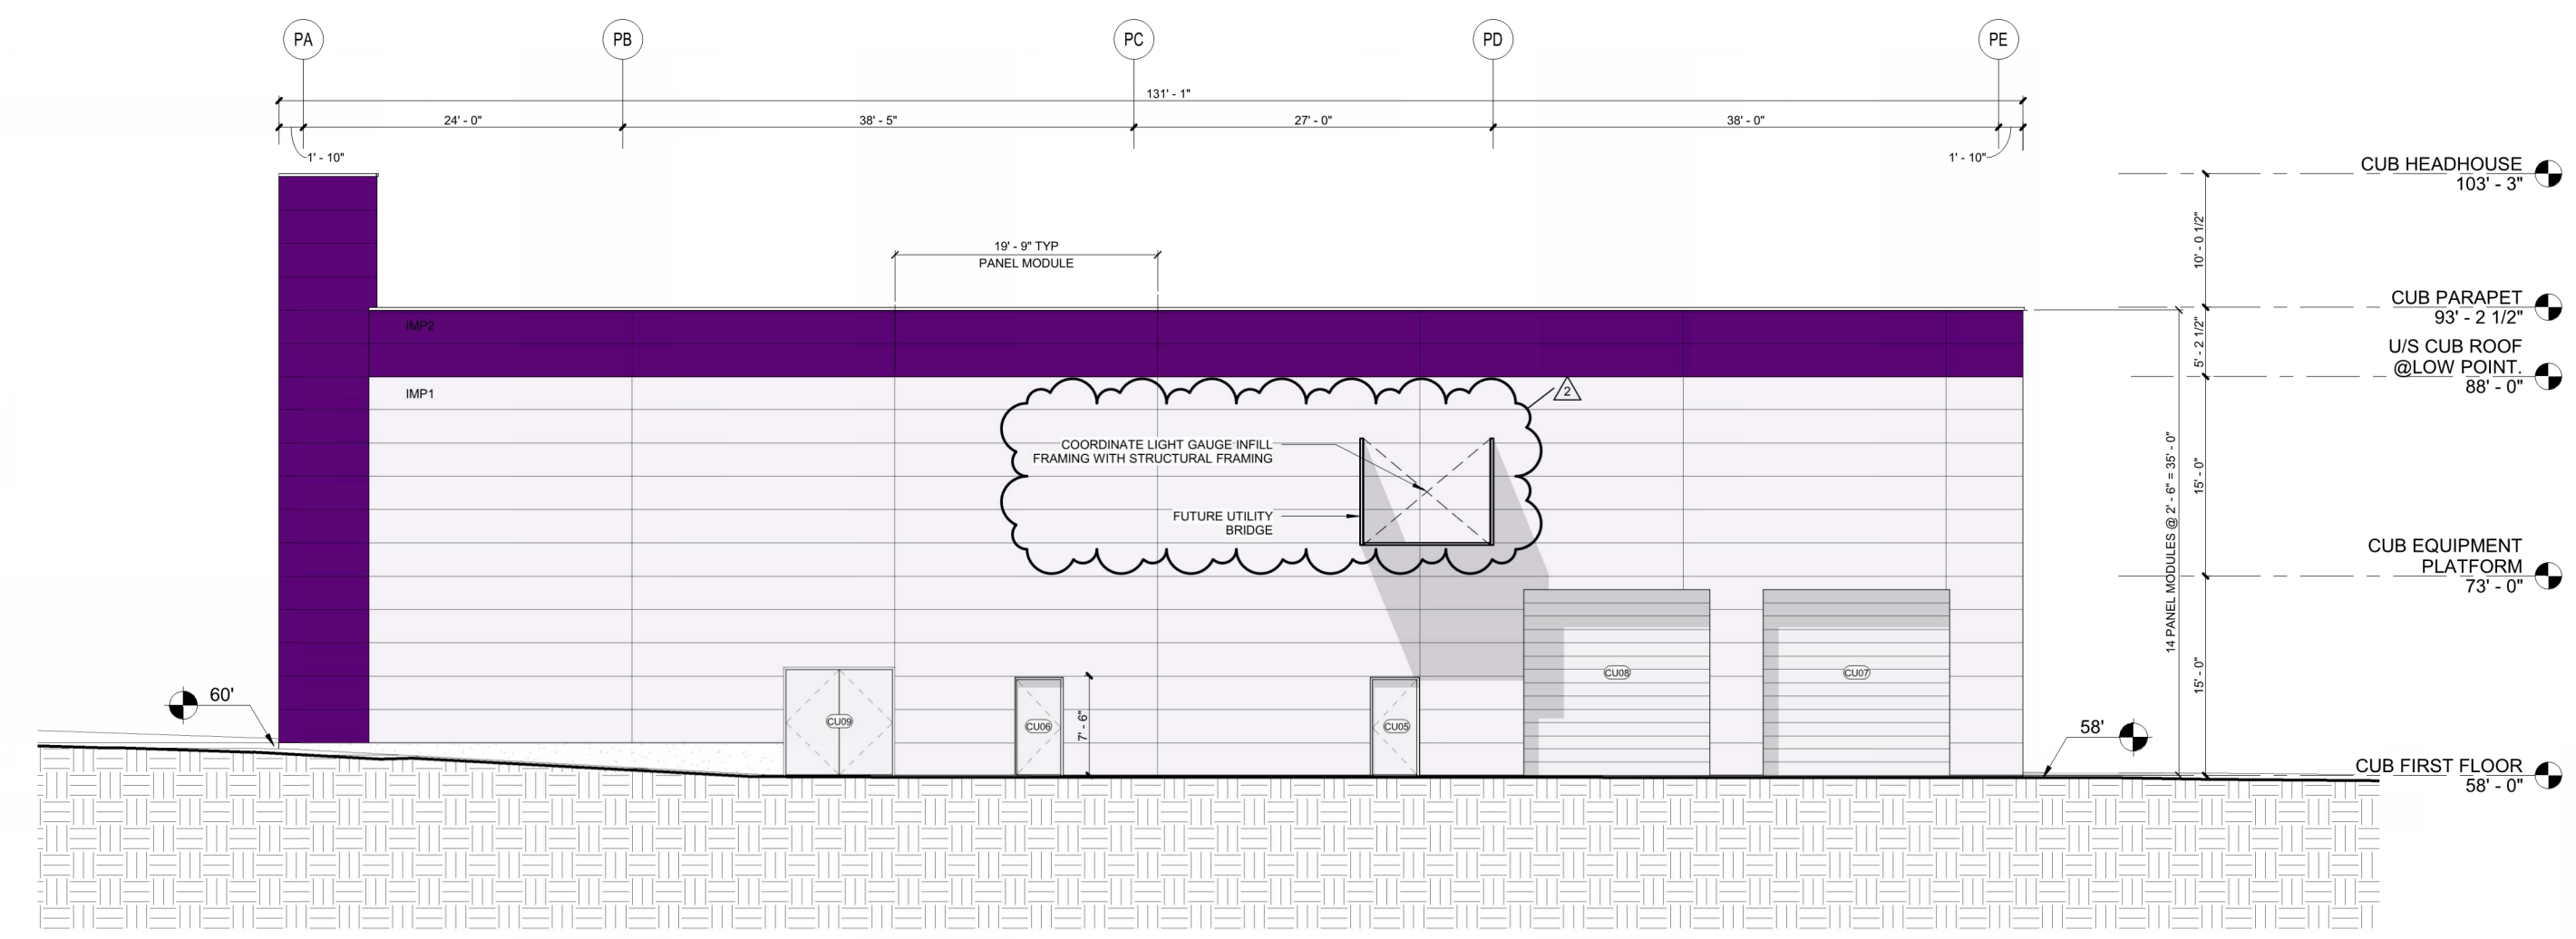


2 NORTH ELEVATION - CUB
8-046-1-2003 1/8" = 1'-0"

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XREF FILES	ENGINEER
	ARCHITECT
	DESIGNER

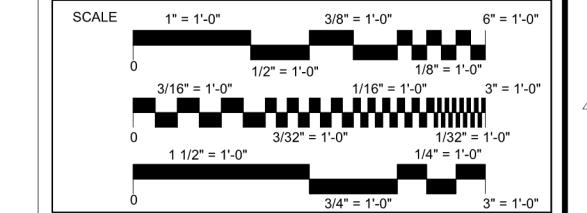

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FRANCE
No. 04187

DATE: 18-SEP-23

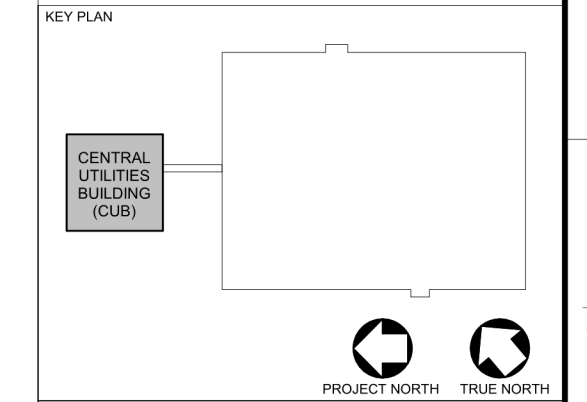DRAWING TITLE		BUILDING ELEVATIONS - CUB	
Drawn By	Date Drawn	Project Number	PKID Number
AD		MAD22435 01	
Checked By	Date Checked	Scale	Drawing Number
JMJ		AS NOTED	8-046-1-2003
			Revision
			2

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- NEW WORK SHEET NOTES**
- N2 UPPER CANOPY - REFER TO SHEET 8-070-A-5004
 - N5 CROSS BRACING (TYP)
 - N6 FOR WINDOW DETAILS REFER TO ELEVATIONS AND SHEET 8-046-A-5001
 - N7 LOADING DOCK CANOPY ABOVE - REFER TO SHEET 8-070-A-5005
 - N8 BIOWASTE PRT. 22FT DEEP - REFER TO STRUCTURAL DRAWINGS FOR MORE INFORMATION
 - N9 TYP. DETAIL FOR ALL EXTERIOR STAIRS
 - N10 REMOVABLE PANELS
 - N17 OVERFLOW ROOF SCUPPER

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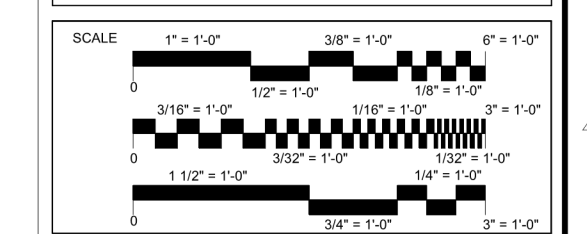
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REVISION	DATE	DESCRIPTION	BY
A	16-MAR-23	DESIGN BUILD BID ISSUE (30% DD)	SBS
B	20-JUNE-23	BID ISSUE (50% DD)	SBS
C	20-JUNE-23	PERMIT ISSUE	SBS
D	10-SEP-23	CONSTRUCTION NO. 2	SBS
E	12-JULY-23	CONSTRUCTION ISSUE	SBS
F	28-AUG-23	BULLETIN NO. 1	SC

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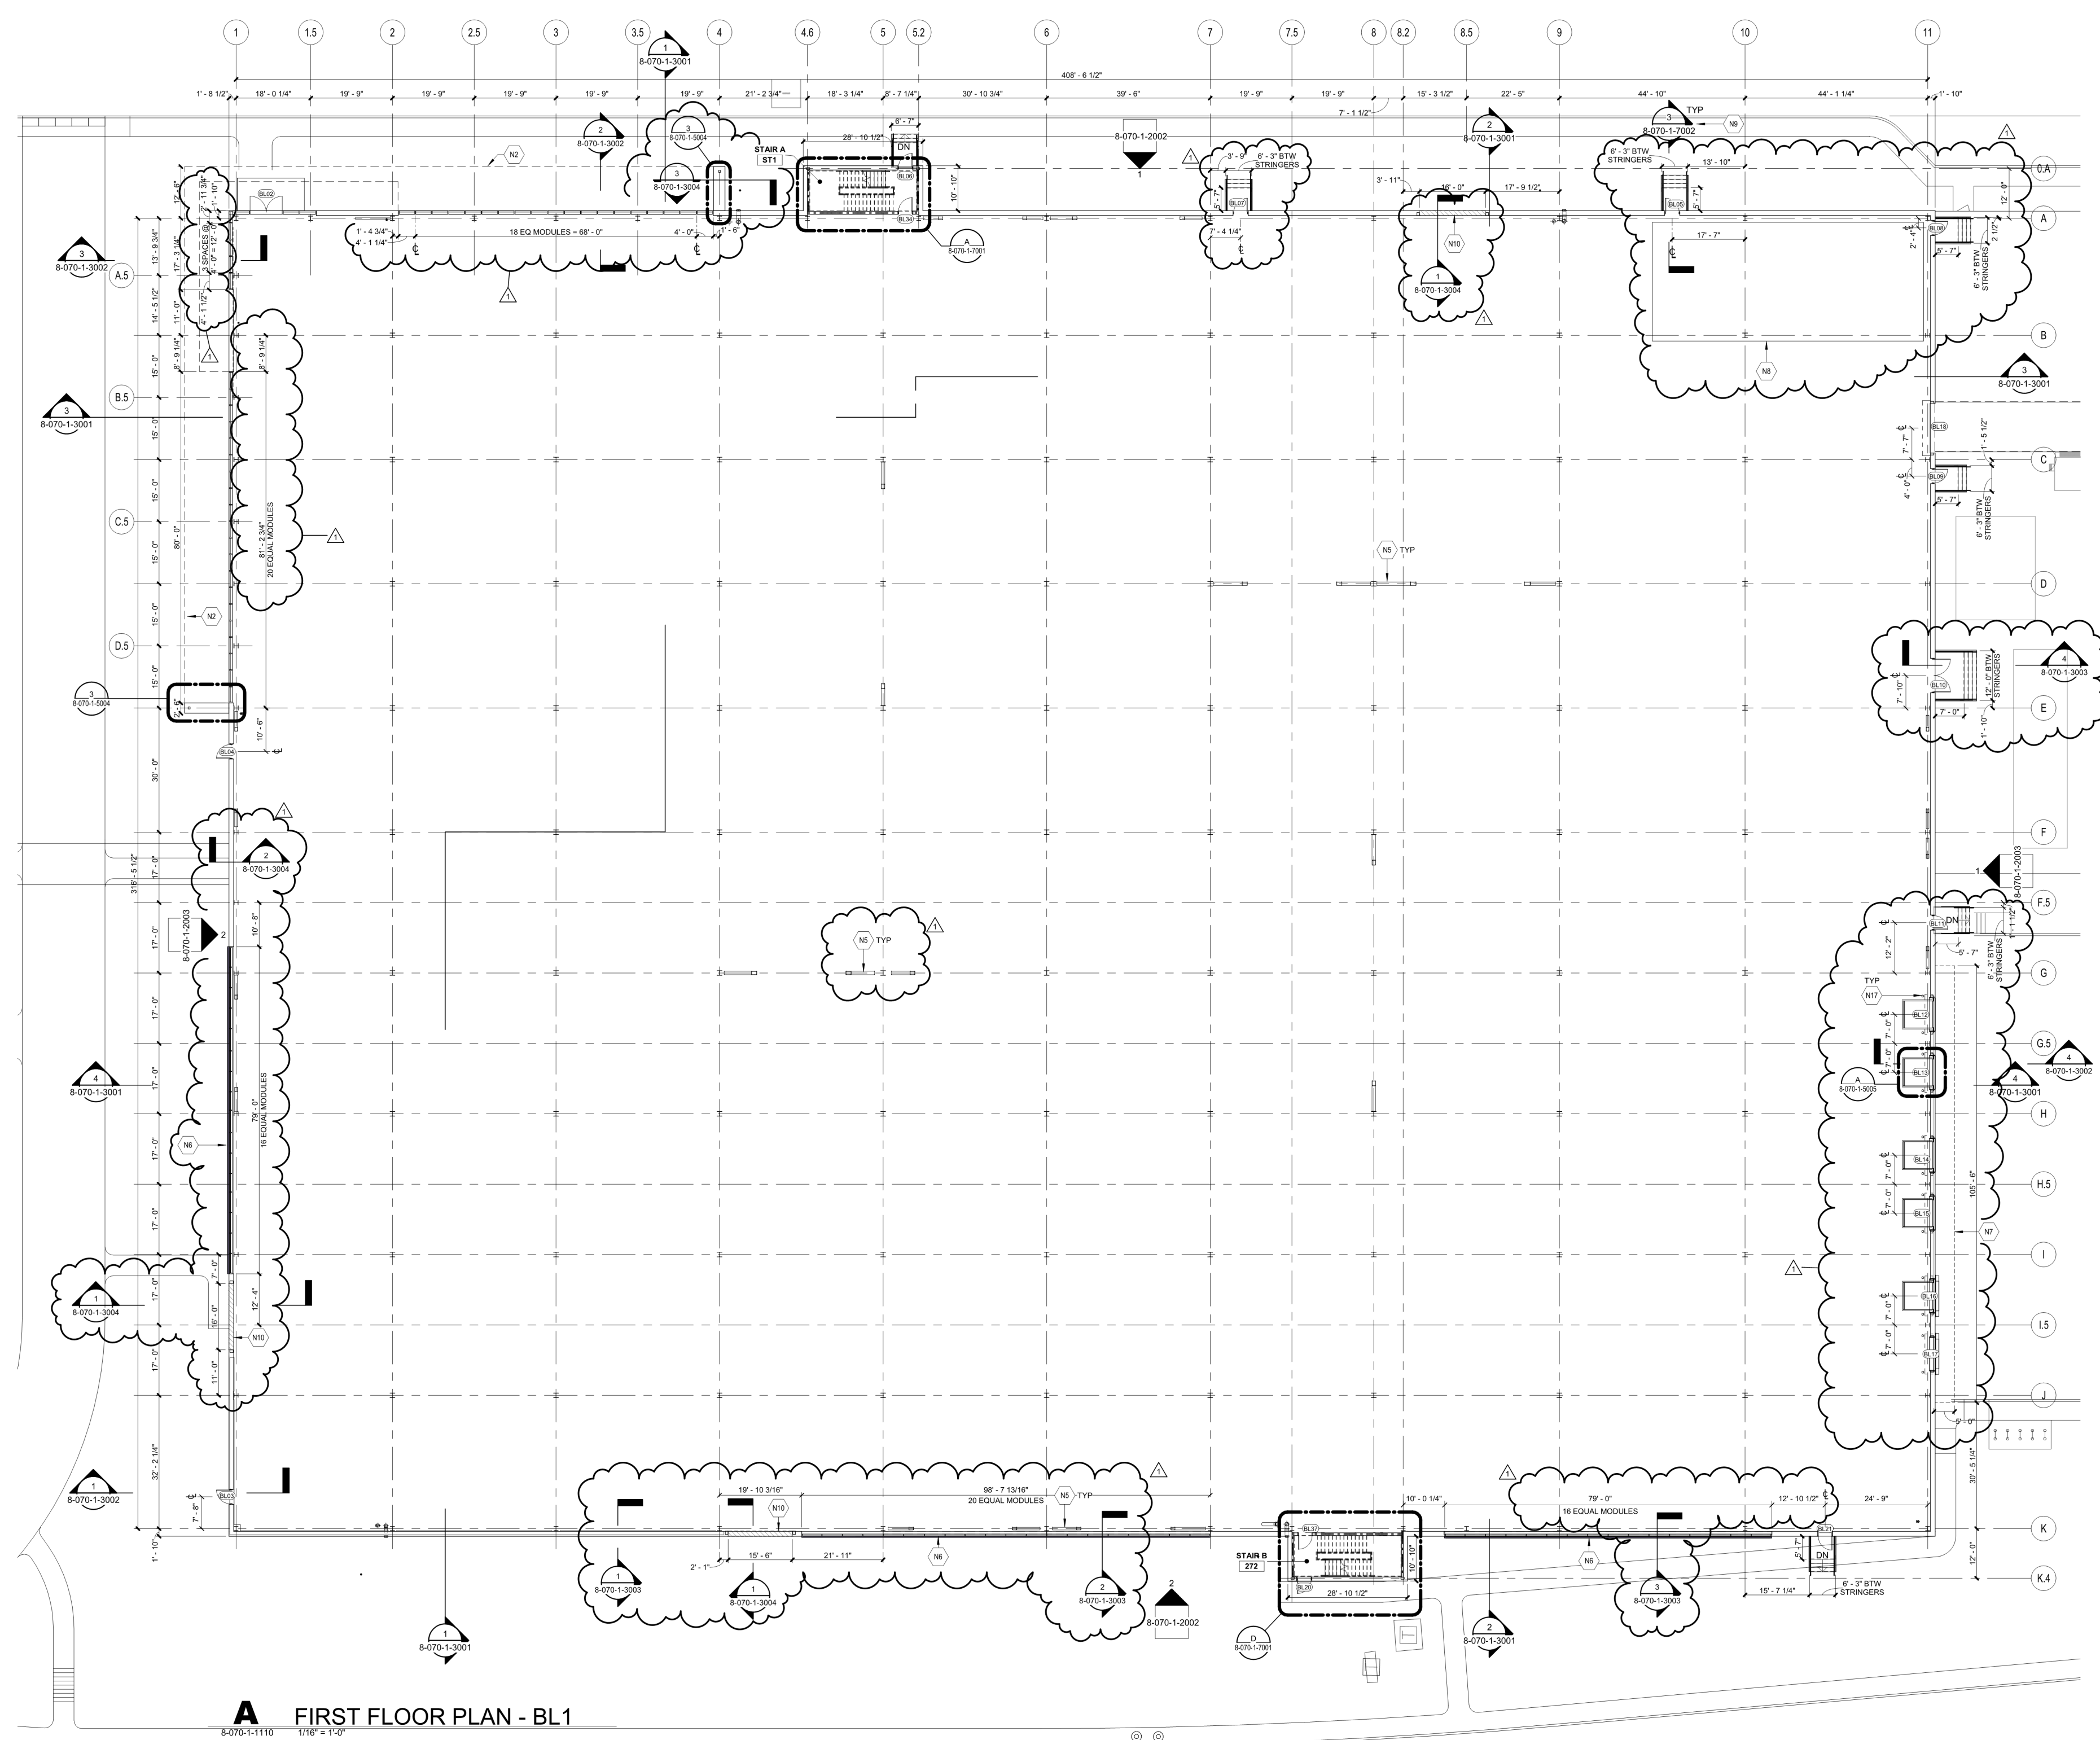
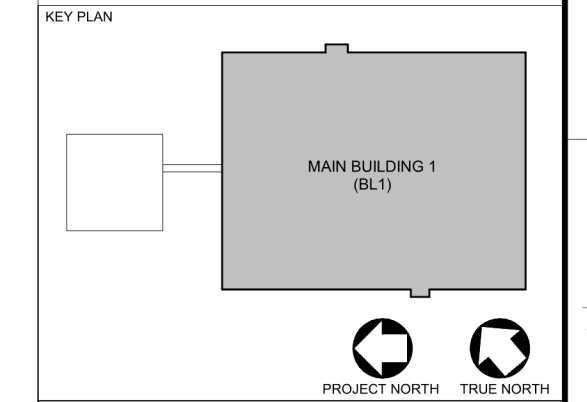
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REF FILES	ENGINEER
	ARCHITECT
	DESIGNER



A FIRST FLOOR PLAN - BL1
 8-070-1-1110 1/16" = 1'-0"

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DRAWING TITLE
FIRST FLOOR PLAN - BL1

Drawn By	Date Drawn	Project Number	PKID Number	DWG Filename	Revision
AD		MAD23047.01			1
Checked By	Date Checked	Scale	AS NOTED	Drawing Number	
JIMJ				8-070-1-1110	

DATE: 24-AUG-23


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NOTE: FOR THE ELEVATION'S DESCRIPTION REFER TO NEXT TWO SHEETS - 8-070-A-2002 AND 8-070-A-2003

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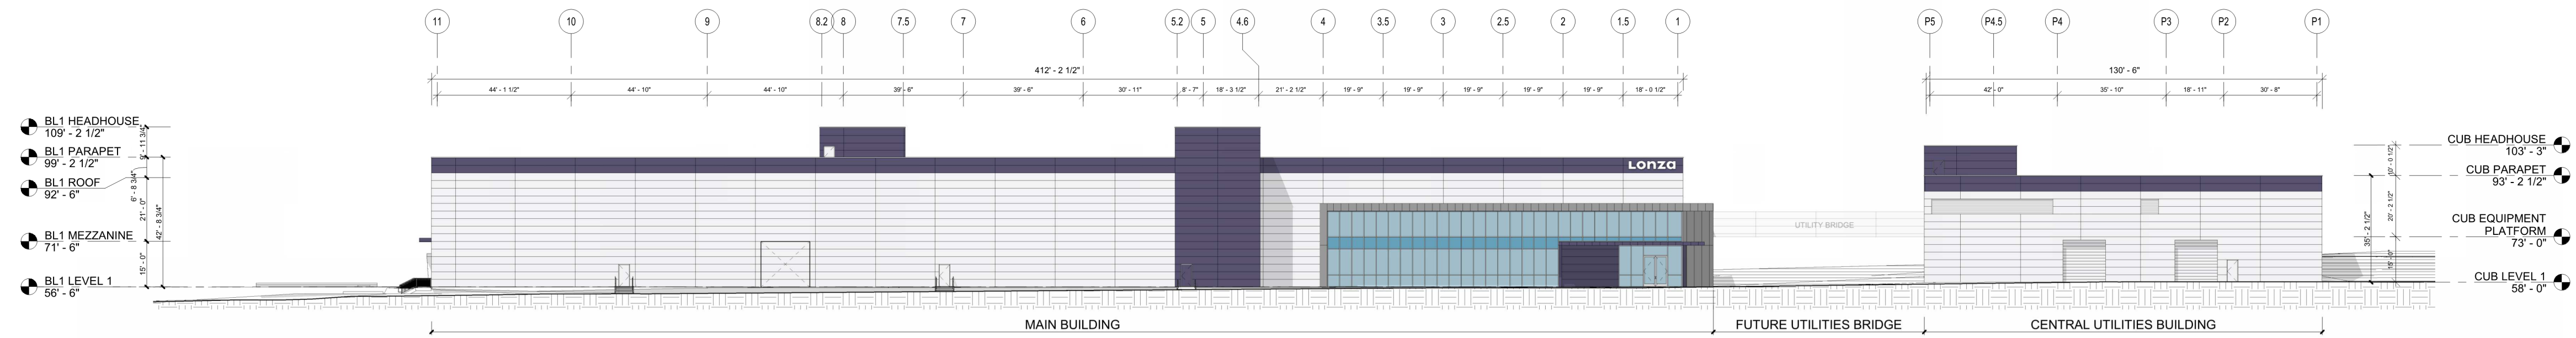
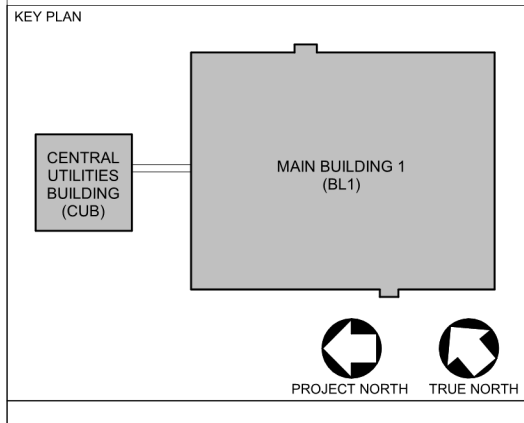
REVISION	DATE	DESCRIPTION	BY
A	15-MAR-23	DESIGN BUILD BID ISSUE (30% DD)	SHS
B	20-JUNE-23	BID ISSUE (60% DD)	SHS
C	20-JUNE-23	PERMIT ISSUE	SHS
D	12-AUG-23	CONSTRUCTION ISSUE	SHS

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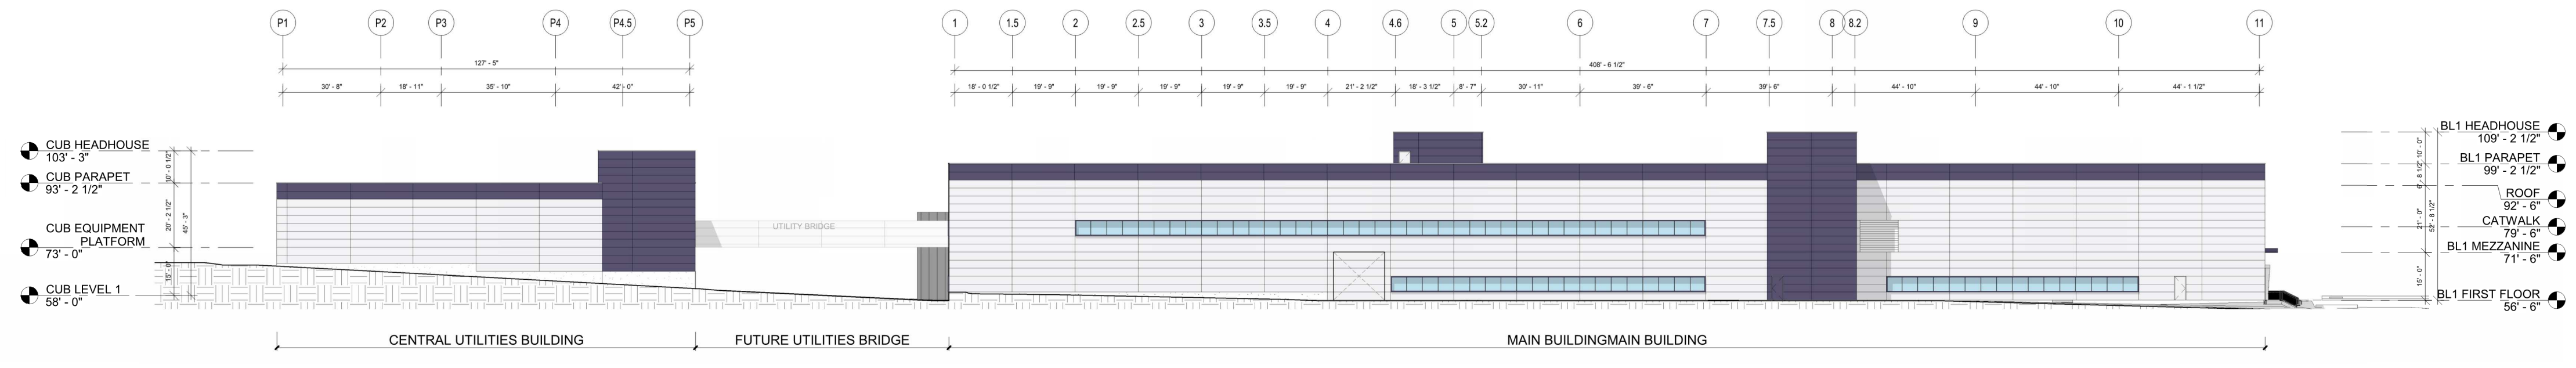


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PREP FILE(S)	ENGINEER
	ARCHITECT
	DESIGNER

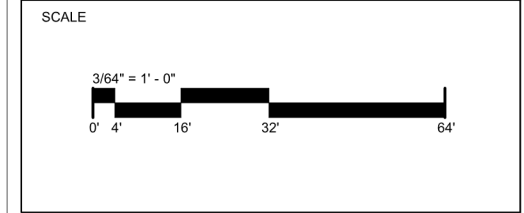


1 EAST BUILDINGS ELEVATIONS
 8-070-1-2001 3/64" = 1'-0"



2 WEST BUILDINGS ELEVATIONS
 8-070-1-2001 3/64" = 1'-0"

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 for
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 Stamp
 Block

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Lonza		DRAWING TITLE	
Lonza Biologics, Inc. 100 International Drive Portsmouth, NH USA T: 1 (603) 354-6100 F: 1 (603) 354-9252 www.lonza.com		OVERALL BUILDINGS ELEVATIONS	
Drawn By	Date Drawn	Project Number	Revision
AD		MAD23047.01	0
Checked By	Date Checked	Scale	DWG Filename
JMJ		3/64" = 1'-0"	8-070-1-2001

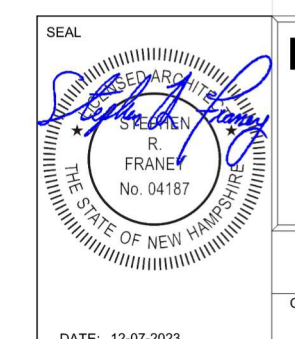LEGEND

IMP1:
4" THICK INSULATED METAL PANELS TO HAVE MIN. R VALUE OF 33.5
COLOR: PURPLE, R245 G243 B248 (5% TINT OF R56 G5 B119)

IMP2:
4" THICK INSULATED METAL PANELS TO HAVE MIN. R VALUE OF 33.5
COLOR: DEEP PURPLE, R56 G5 B119

CW:
THERMALLY BROKEN CURTAIN WALL SYSTEM EQUAL TO 1600 WALL SYSTEM
1 BY KAWNEER OR APPROVED EQUAL (HURRICANE IMPACT RESISTANT).

GL1:
1" THICK IMPACT RESISTANT INSULATED LAMINATED GLASS. 08. 1/2" BLUE SOLARBAN 70 XL SURFACE 1/2 INCH (W/90% ARGON FILL) INTERLAYER 1/4" CLEAR AS MANUFACTURED BY VITRO AMERICA OR APPROVED EQUAL. PRIOR FABRICATION AND INSTALLATION THE CONTRACTOR SHALL SUBMIT SAMPLES FOR ARCHITECT APPROVAL. U VALUE:0.25

GL2:
1" THICK IMPACT RESISTANT INSULATED (INSULATION & BACKPAN ARE REQUIRED) LAMINATED SPANDREL GLASS 3-1870 08. 1/2" SOLAR GRAY + 1/2 INCH (W/90% ARGON FILL) INTERLAYER 1/4" CLEAR AS MANUFACTURED BY VITRO AMERICA OR APPROVED EQUAL. PRIOR FABRICATION AND INSTALLATION THE CONTRACTOR SHALL SUBMIT SAMPLES FOR ARCHITECT APPROVAL. U VALUE:0.25


ROOF: WHITE EPDM ROOF SYSTEM - R VALUE OF 44

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REVISION	DATE	DESCRIPTION	BY
A	16-MAR-23	DESIGN BUILD BID ISSUE (30% DD)	SPS
B	30-JUNE-23	BID ISSUE (50% DD)	SPS
C	30-JUNE-23	PERMIT ISSUE	SPS
D	10-AUG-23	CONSTRUCTION NO. 2	SPS
E	12-JULY-23	CONSTRUCTION ISSUE	SPS
F	28-AUG-23	BULLETIN NO. 1	SC

CLIENT




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REF FILE(S)	ENGINEER
	ARCHITECT
	DESIGNER

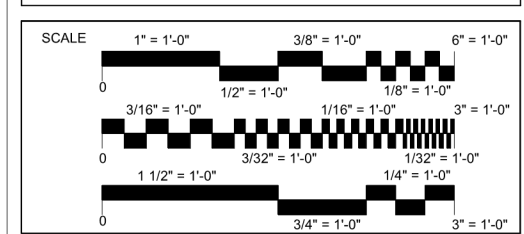


NEW WORK SHEET NOTES

N2 UPPER CANOPY - REFER TO SHEET 8-070-A-5004.

N3 LOWER CANOPY - REFER TO SHEET 8-070-A-5004.

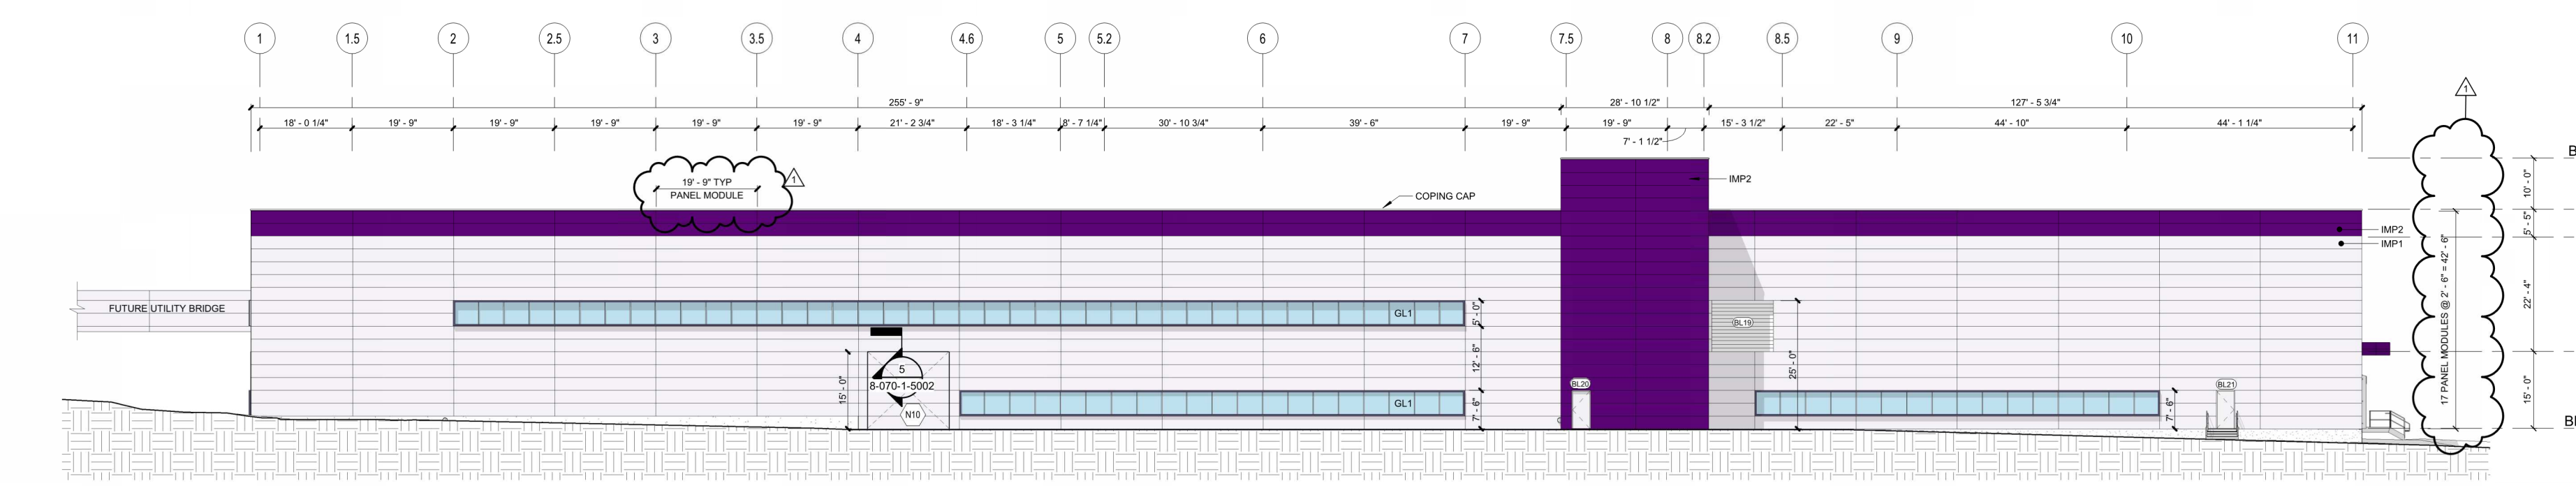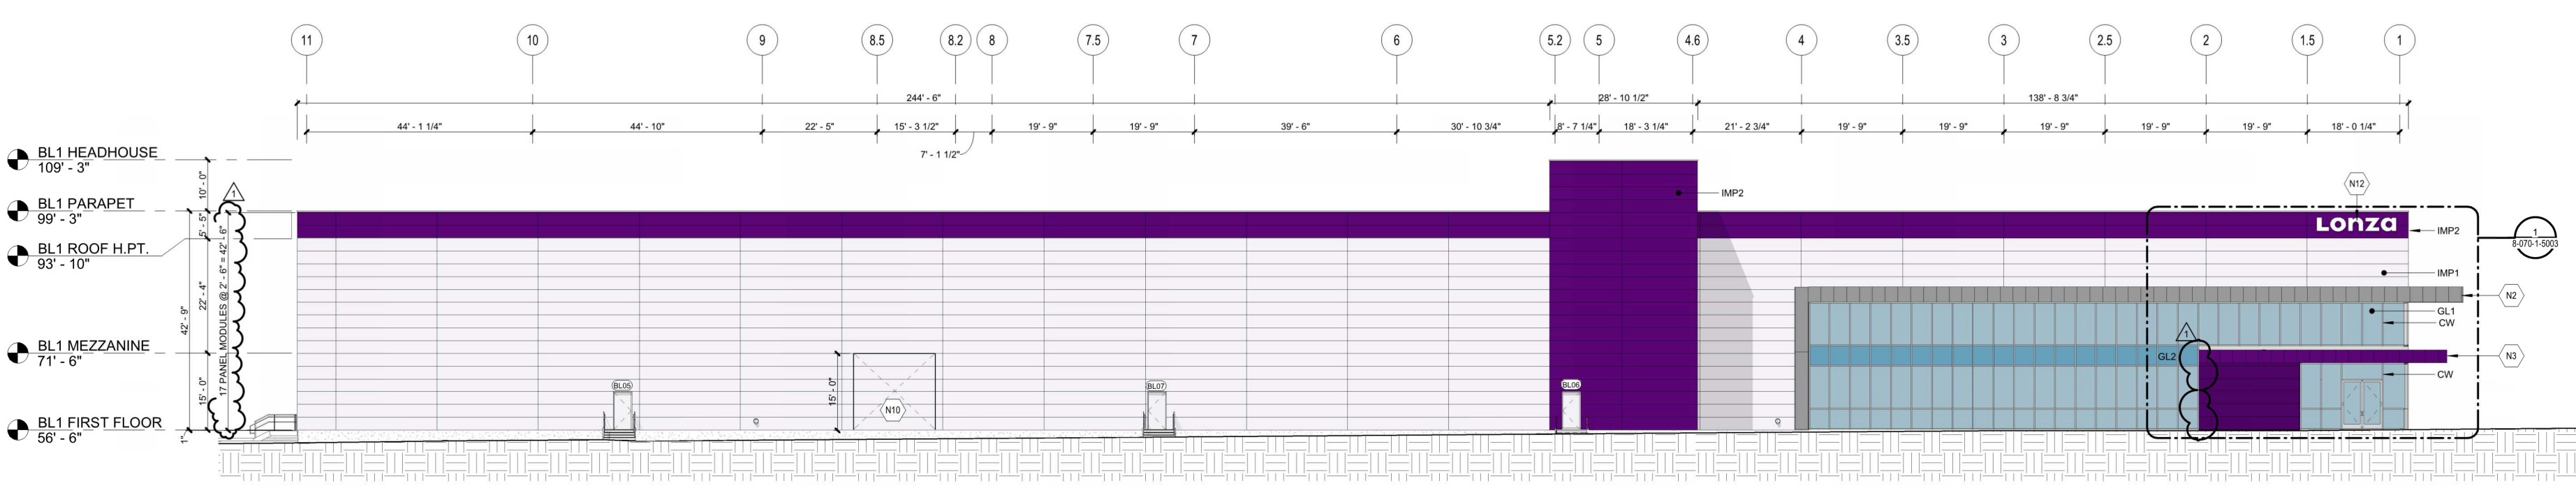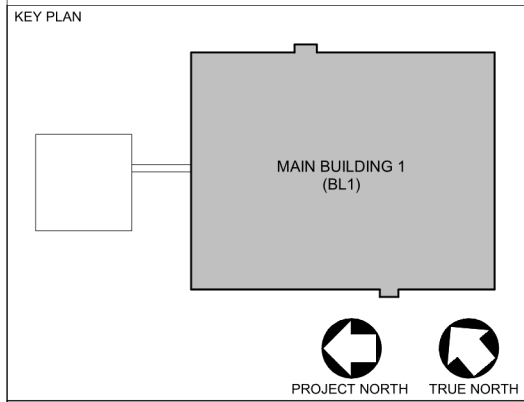N10 REMOVABLE PANELS.

N12 CLEAR FINISH, CORROSION-PROOF WHITE ALUMINUM SIGN.

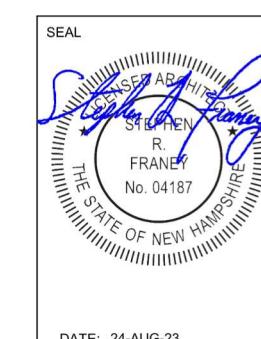

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DRAWING TITLE

BUILDING ELEVATIONS - BL1

Drawn By	Date Drawn	Project Number	P&ID Number	DWG Filename	Revision
AD		MAD23047.01			1
Checked By	Date Checked	Scale	Drawing Number		
JIMJ		AS NOTED	8-070-1-2002		

ISSUED FOR CONSTRUCTION

LEGEND

IMP1 :
4" THICK INSULATED METAL PANELS TO HAVE MIN. R VALUE OF 33.5
COLOR: PURPLE, R245 G243 B248 (5% TINT OF R56 G5 B119)

IMP2 :
4" THICK INSULATED METAL PANELS TO HAVE MIN. R VALUE OF 33.5
COLOR: DEEP PURPLE, R56 G5 B119

CW :
THERMALLY BROKEN CURTAIN WALL SYSTEM EQUAL TO 1600 WALL SYSTEM
1 BY KAWNEER OR APPROVED EQUAL (HURRICANE IMPACT RESISTANT).

GL1 :
1" THICK IMPACT RESISTANT LAMINATED GLASS 08: 3/4" BLUE SOLARBAN 70 XL SURFACE 1/2 INCH (W/90% ARGON FILL) INTERLAYER 1/4" CLEAR AS MANUFACTURED BY VITRO AMERICA OR APPROVED EQUAL .
PRIOR FABRICATION AND INSTALLATION THE CONTRACTOR SHALL SUBMIT SAMPLES FOR ARCHITECT APPROVAL U VALUE:0.25


GL2 :
1" THICK IMPACT RESISTANT INSULATED (INSULATION & BACKPAN ARE REQUIRED) LAMINATED SPANDREL GLASS 3-1870 08: 1/2 SOLAR GRAY + 1/2 INCH (W/90% ARGON FILL) INTERLAYER 1/4" CLEAR AS MANUFACTURED BY VITRO AMERICA OR APPROVED EQUAL .
PRIOR FABRICATION AND INSTALLATION THE CONTRACTOR SHALL SUBMIT SAMPLES FOR ARCHITECT APPROVAL U VALUE:0.25

ROOF: WHITE EPDM ROOF SYSTEM - R VALUE OF 44

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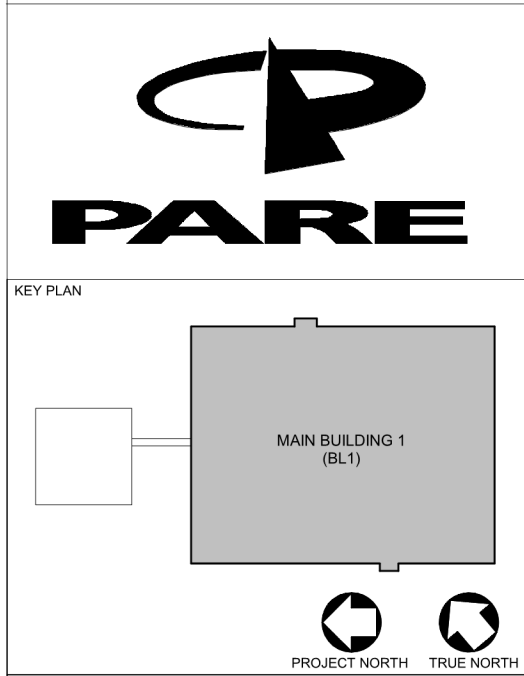
REVISION	DATE	DESCRIPTION	BY
A	15-MAR-23	DESIGN BUILD BID ISSUE (30% DD)	SPS
B	20-JUNE-23	BID ISSUE (50% DD)	SPS
C	20-JUNE-23	PERMIT ISSUE	SPS
D	10-AUG-23	CONSTRUCTION NO. 2	SPS
E	12-JULY-23	CONSTRUCTION ISSUE	SPS
F	28-AUG-23	BULLETIN NO. 1	SC

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LONZA ALBACORE PROJECT

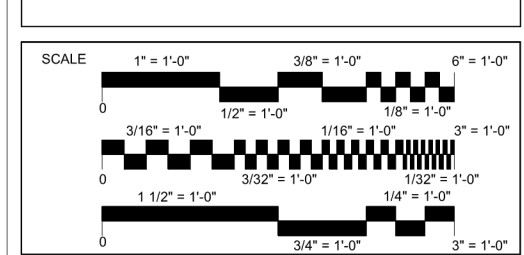


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XREF FILES: ENGINEER, ARCHITECT, DESIGNER




NEW WORK SHEET NOTES

N2 UPPER CANOPY - REFER TO SHEET 8-070-A-5004.
N3 LOWER CANOPY - REFER TO SHEET 8-070-A-5004.
N10 REMOVABLE PANELS.

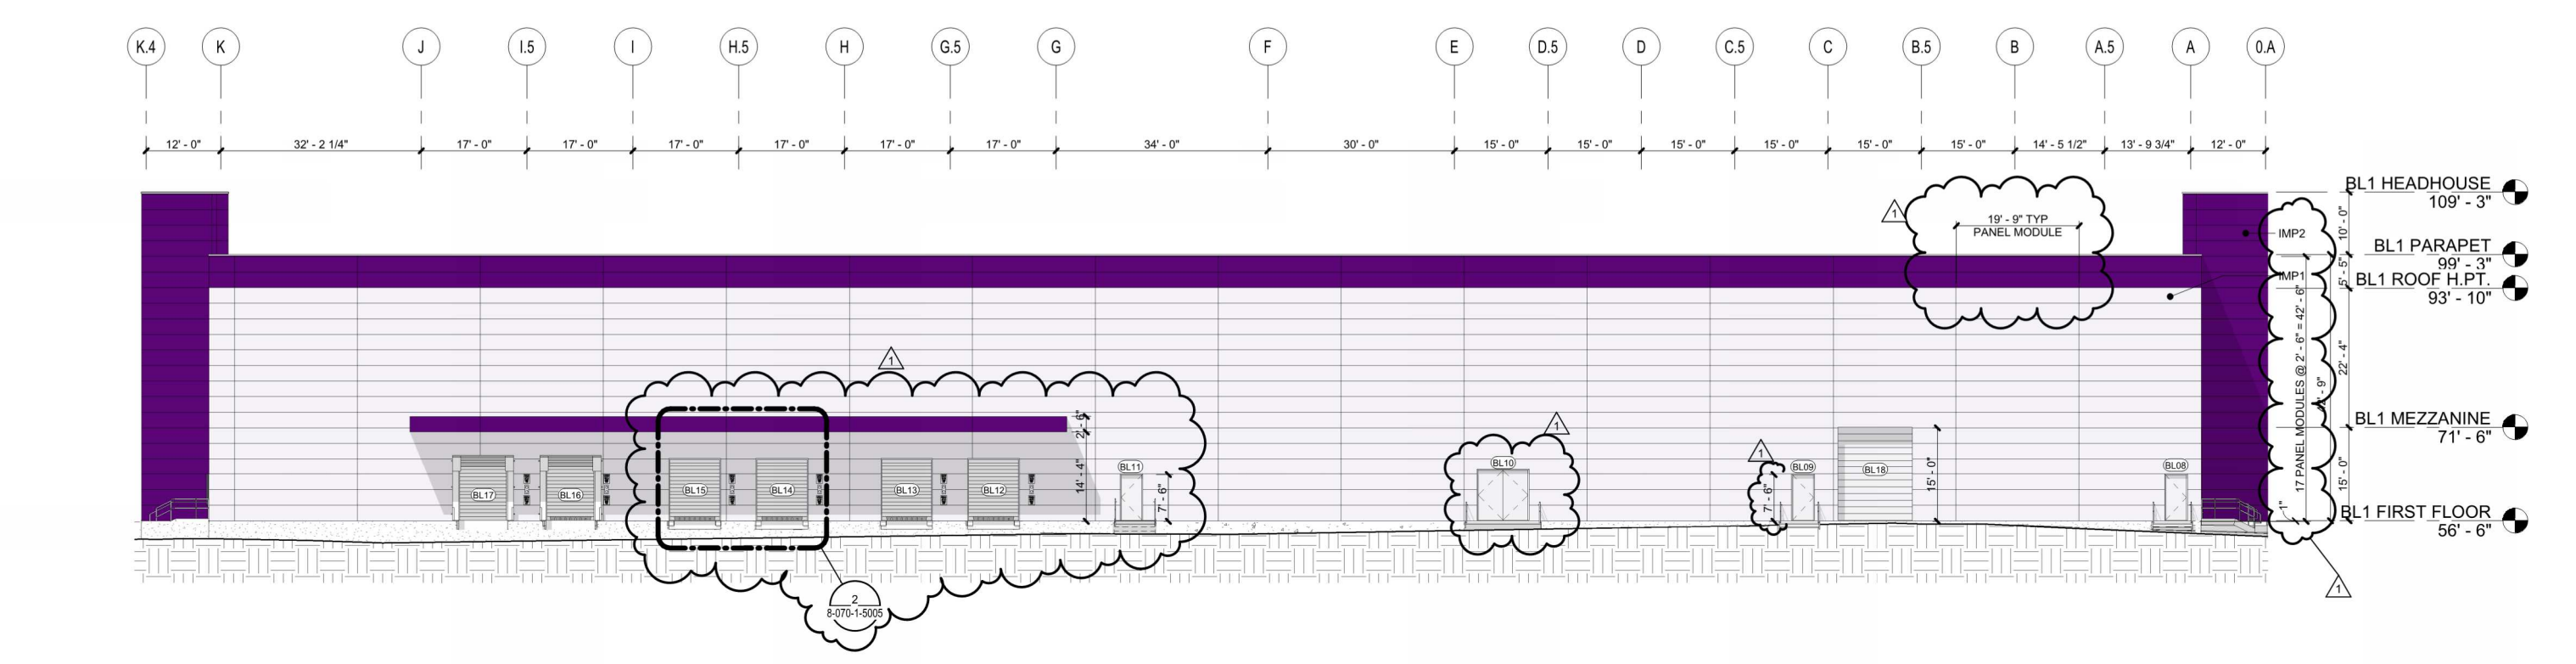


1 SOUTH ELEVATION - BL1.
8-070-1-2003 1/16" = 1'-0"

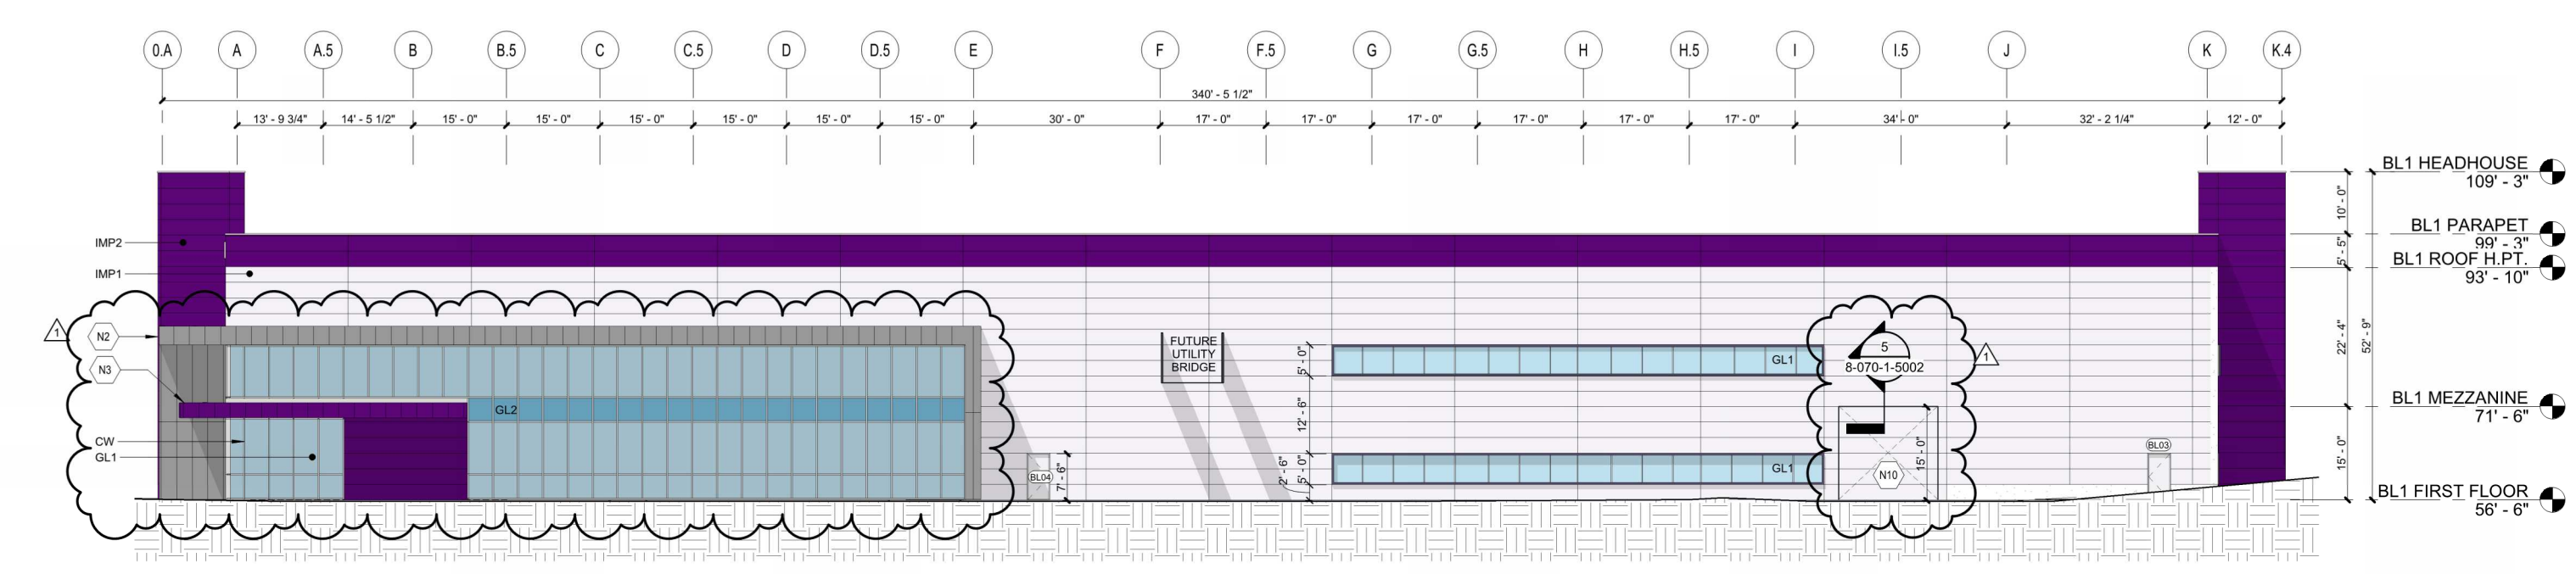

2 NORTH ELEVATION - BL1.
8-070-1-2003 1/16" = 1'-0"

ISSUED FOR CONSTRUCTION

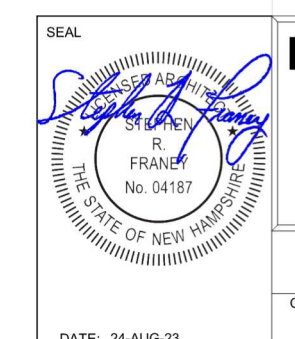

Lonza
Lonza Biologics, Inc.
107 International Drive
Parsippany, NJ USA
P: 1 (803) 354-6100
F: 1 (803) 354-9252
www.lonza.com

DRAWING TITLE
BUILDING ELEVATIONS - BL1

Drawn By	Date Drawn	Project Number	P&ID Number	DWG Filename	Revision
AD		MAD23047.01			1
Checked By	Date Checked	Scale	Drawing Number		
JIMJ		AS NOTED	8-070-1-2003		


DETAILS PLAN SET

APRIL 3, 2018

REVISED: NOVEMBER 9, 2023

LIST OF DRAWINGS		
SHEET NO.	SHEET TITLE	LAST REVISED
	DETAILS COVER SHEET	11/9/2023
C-501	EROSION CONTROL NOTES & DETAILS SHEET	9/27/2023
C-502	DETAILS SHEET	11/9/2023
C-503	DETAILS SHEET	11/9/2023
C-504	DETAILS SHEET	9/27/2023
C-505	DETAILS SHEET	9/27/2023
C-506	DETAILS SHEET	9/27/2023
C-507	DETAILS SHEET	9/27/2023
C-508	DETAILS SHEET	9/27/2023
C-509	DETAILS SHEET	11/9/2023
C-510	DETAILS SHEET	9/27/2023
C-511	DETAILS SHEET	9/27/2023
C-512	DETAILS SHEET	9/27/2023

Last Save Date: November 2, 2023 4:27 PM By: NATHANSEN
Plot Date: Thursday, November 09, 2023 Plotted By: Neil A. Hansen
P&E File Location: J:\U700 Lanza Biologicals Expansion.was 12767.026 - Project Abstract\Drawings\AutoCAD\0700-026-C-COUR.dwg Layout Tab: DETAILS-CS

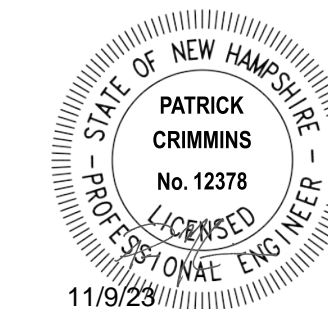

COMPLETE SET 13 SHEETS

GENERAL PROJECT INFORMATION

PROJECT LESSOR: PEASE DEVELOPMENT AUTHORITY
 55 INTERNATIONAL DRIVE
 PORTSMOUTH, NH 03801
 PROJECT OWNER/ APPLICANT: LONZA BIOLOGICS
 101 INTERNATIONAL DRIVE
 PORTSMOUTH, NH 03801
 PROJECT ADDRESS: 70 & 80 CORPORATE DRIVE
 PORTSMOUTH, NH 03801
 PROJECT LATITUDE: 43°-04'-59.0"N
 PROJECT LONGITUDE: 71°-48'-09.7"W

PROJECT DESCRIPTION

THE PROJECT CONSISTS OF THE EXPANSION OF LONZA BIOLOGICS, WHICH INCLUDES THE CONSTRUCTION OF 4 PROPOSED BUILDINGS, 1 PARKING GARAGE, AND ASSOCIATED SITE IMPROVEMENTS.

DISTURBED AREA

THE TOTAL AREA TO BE DISTURBED IS APPROXIMATELY 21.3 ACRES.

SOIL CHARACTERISTICS

BASED ON THE HIGH INTENSITY SOIL SURVEY PREPARED BY GOVE ENVIRONMENTAL SERVICES, INC. IN DECEMBER 2015, THE SITE SOILS VARY FROM WELL DRAINED TO VERY POORLY DRAINED AND PRIMARILY CONSIST OF SOMEWHAT POORLY DRAINED SOILS.

NAME OF RECEIVING WATERS

THE STORM WATER RUNOFF WILL ULTIMATELY DISCHARGE INTO HODGSON BROOK

CONSTRUCTION SEQUENCE OF MAJOR ACTIVITIES:

- CUT AND CLEAR TREES.
- CONSTRUCT TEMPORARY AND PERMANENT SEDIMENT, EROSION AND DETENTION CONTROL FACILITIES. EROSION, SEDIMENT AND DETENTION MEASURES SHALL BE INSTALLED PRIOR TO ANY EARTH MOVING OPERATIONS THAT WILL INFLUENCE STORMWATER RUNOFF SUCH AS:
 - NEW CONSTRUCTION
 - CONTROL OF DUST
 - NEARNESS OF CONSTRUCTION SITE TO RECEIVING WATERS
 - CONSTRUCTION DURING LATE WINTER AND EARLY SPRING
- ALL PERMANENT DITCHES, SWALES, DETENTION, RETENTION AND SEDIMENTATION BASINS TO BE STABILIZED USING THE VEGETATIVE AND NON-STRUCTURAL BMPS PRIOR TO DIRECTING RUNOFF TO THEM.
- CLEAR AND DISPOSE OF DEBRIS.
- CONSTRUCT TEMPORARY CULVERTS AND DIVERSION CHANNELS AS REQUIRED.
- GRADE AND GRAVEL ROADWAYS AND PARKING AREAS - ALL ROADS AND PARKING AREA SHALL BE STABILIZED WITHIN 72 HOURS OF ACHIEVING FINISHED GRADE.
- BEGIN PERMANENT AND TEMPORARY SEEDING AND MULCHING. ALL CUT AND FILL SLOPES SHALL BE SEEDED AND MULCHED WITHIN 72 HOURS OF ACHIEVING FINISHED GRADE.
- DAILY, OR AS REQUIRED, CONSTRUCT TEMPORARY BERMS, DRAINS, DITCHES, PERIMETER EROSION CONTROL MEASURES, SEDIMENT TRAPS, ETC., MULCH AND SEED AS REQUIRED.
- SEDIMENT TRAPS AND/OR BASINS SHALL BE USED AS NECESSARY TO CONTAIN RUNOFF UNTIL SOILS ARE STABILIZED.
- FINISH PAVING ALL ROADWAYS AND PARKING LOTS.
- INSPECT AND MAINTAIN ALL EROSION AND SEDIMENT CONTROL MEASURES.
- COMPLETE PERMANENT SEEDING AND LANDSCAPING.
- REMOVE TRAPPED SEDIMENTS FROM COLLECTOR DEVICES AS APPROPRIATE AND THEN REMOVE TEMPORARY EROSION CONTROL MEASURES.

SPECIAL CONSTRUCTION NOTES:

- THE CONSTRUCTION SEQUENCE MUST LIMIT THE DURATION AND AREA OF DISTURBANCE.
- THE PROJECT IS TO BE MANAGED IN A MANNER THAT MEETS THE REQUIREMENTS AND INTENT OF RSA 430:53 AND CHAPTER AGR 3800 RELATIVE TO INVASIVE SPECIES.

EROSION CONTROL NOTES:

- ALL EROSION CONTROL MEASURES AND PRACTICES SHALL CONFORM TO THE "NEW HAMPSHIRE STORMWATER MANUAL VOLUME 3: EROSION AND SEDIMENT CONTROLS DURING CONSTRUCTION" PREPARED BY THE NHDES.
- PRIOR TO ANY WORK OR SOIL DISTURBANCE, CONTRACTOR SHALL SUBMIT SHOP DRAWINGS FOR EROSION CONTROL MEASURES AS REQUIRED IN THE PROJECT MANUAL.
- CONTRACTOR SHALL INSTALL TEMPORARY EROSION CONTROL BARRIERS, INCLUDING HAY BALES, SILT FENCES, MULCH BERMS, SILT SACKS AND SILT SOCKS AS SHOWN IN THESE DRAWINGS AS THE FIRST ORDER OF WORK.
- SILT SACK INLET PROTECTION SHALL BE INSTALLED IN ALL EXISTING AND PROPOSED CATCH BASIN INLETS WITHIN THE WORK LIMITS AND BE MAINTAINED FOR THE DURATION OF THE PROJECT.
- PERIMETER CONTROLS INCLUDING SILT FENCES, MULCH BERM, SILT SOCK, AND/OR HAY BALE BARRIERS SHALL BE MAINTAINED FOR THE DURATION OF THE PROJECT UNTIL NON-PAVED AREAS HAVE BEEN STABILIZED.
- THE CONTRACTOR SHALL REMOVE AND PROPERLY DISPOSE OF ALL TEMPORARY EROSION CONTROL DEVICES UPON COMPLETION OF CONSTRUCTION.
- ALL DISTURBED AREAS NOT OTHERWISE BEING TREATED SHALL RECEIVE 6" LOAM, SEED AND FERTILIZER.
- INSPECT ALL INLET PROTECTION AND PERIMETER CONTROLS WEEKLY AND AFTER EACH RAIN STORM OF 0.25 INCH OR GREATER. REPAIR/MODIFY PROTECTION AS NECESSARY TO MAXIMIZE EFFICIENCY OF FILTER. REPLACE ALL FILTERS WHEN SEDIMENT IS 1/3 THE FILTER HEIGHT.
- CONSTRUCT EROSION CONTROL BLANKETS ON ALL SLOPES STEEPER THAN 3:1.

STABILIZATION:

- AN AREA SHALL BE CONSIDERED STABLE WHEN ONE OF THE FOLLOWING HAS OCCURRED:
 - BASE COURSE GRAVELS HAVE BEEN INSTALLED IN AREAS TO BE PAVED;
 - A MINIMUM OF 85% VEGETATED GROWTH HAS BEEN ESTABLISHED;
 - A MINIMUM OF 3" OF NON-EROSIVE MATERIAL SUCH AS STONE OR RIPRAP HAS BEEN INSTALLED;
 - EROSION CONTROL BLANKETS HAVE BEEN PROPERLY INSTALLED.;
 - IN AREAS TO BE PAVED, "STABLE" MEANS THAT BASE COURSE GRAVELS MEETING THE REQUIREMENTS OF NHDOT STANDARD FOR ROAD AND BRIDGE CONSTRUCTION, 2016, ITEM 304.2 HAVE BEEN INSTALLED.
- WINTER STABILIZATION PRACTICES:
 - ALL PROPOSED VEGETATED AREAS THAT DO NOT EXHIBIT A MINIMUM OF 85 PERCENT VEGETATIVE GROWTH BY OCTOBER 15, OR WHICH ARE DISTURBED AFTER OCTOBER 15, SHALL BE STABILIZED BY SEEDING AND INSTALLING EROSION CONTROL BLANKETS ON SLOPES GREATER THAN 3:1, AND SEEDING AND PLACING 3 TO 4 TONS OF MULCH PER ACRE, SECURED WITH ANCHORED NETTING, ELSEWHERE, THE INSTALLATION OF EROSION CONTROL BLANKETS OR MULCH AND NETTING SHALL NOT OCCUR OVER ACCUMULATED SNOW OR ON FROZEN GROUND AND SHALL BE COMPLETED IN ADVANCE OF THAW OR SPRING MELT EVENTS;
 - ALL DITCHES OR SWALES WHICH DO NOT EXHIBIT A MINIMUM OF 85 PERCENT VEGETATIVE GROWTH BY OCTOBER 15, OR WHICH ARE DISTURBED AFTER OCTOBER 15, SHALL BE STABILIZED TEMPORARILY WITH STONE OR EROSION CONTROL BLANKETS APPROPRIATE FOR THE DESIGN FLOW CONDITIONS;
 - AFTER NOVEMBER 15, INCOMPLETE ROAD OR PARKING SURFACES, WHERE WORK HAS STOPPED FOR THE WINTER SEASON, SHALL BE PROTECTED WITH A MINIMUM OF 3 INCHES OF CRUSHED GRAVEL PER NHDOT ITEM 304.3, OR IF CONSTRUCTION IS TO CONTINUE THROUGH THE WINTER SEASON BE CLEARED OF ANY ACCUMULATED SNOW AFTER EACH STORM EVENT;
- STABILIZATION SHALL BE INITIATED ON ALL LOAM STOCKPILES, AND DISTURBED AREAS, WHERE CONSTRUCTION ACTIVITY SHALL NOT OCCUR FOR MORE THAN TWENTY-ONE (21) CALENDAR DAYS BY THE FOURTEENTH (14TH) DAY AFTER CONSTRUCTION ACTIVITY HAS PERMANENTLY OR TEMPORARILY CEASED IN THAT AREA. STABILIZATION MEASURES TO BE USED INCLUDE:
 - TEMPORARY SEEDING;
 - MULCHING.

- ALL AREAS SHALL BE STABILIZED WITHIN 45 DAYS OF INITIAL DISTURBANCE.
- WHEN CONSTRUCTION ACTIVITY PERMANENTLY OR TEMPORARILY CEASES WITHIN 100 FEET OF NEARBY SURFACE WATERS OR DELINEATED WETLANDS, THE AREA SHALL BE STABILIZED WITHIN SEVEN (7) DAYS OR PRIOR TO A RAIN EVENT. ONCE CONSTRUCTION ACTIVITY CEASES PERMANENTLY IN AN THESE AREAS, SILT FENCES, MULCH BERMS, HAY BALE BARRIERS AND ANY EARTH/DIKES SHALL BE REMOVED ONCE PERMANENT MEASURES ARE ESTABLISHED.
- DURING CONSTRUCTION, RUNOFF WILL BE DIVERTED AROUND THE SITE WITH EARTH DIKES, PIPING OR STABILIZED CHANNELS WHERE POSSIBLE. SHEET RUNOFF FROM THE SITE WILL BE FILTERED THROUGH SILT FENCES, MULCH BERMS, HAY BALE BARRIERS, OR SILT SOCKS. ALL STORM DRAIN BASIN INLETS SHALL BE PROVIDED WITH FLARED END SECTIONS AND TRASH RACKS. THE SITE SHALL BE STABILIZED FOR THE WINTER BY NOVEMBER 15.

DUST CONTROL:

- THE CONTRACTOR SHALL BE RESPONSIBLE TO CONTROL DUST THROUGHOUT THE CONSTRUCTION PERIOD.
- DUST CONTROL METHODS SHALL INCLUDE, BUT BE NOT LIMITED TO SPRINKLING WATER ON EXPOSED AREAS, COVERING LOADED DUMP TRUCKS LEAVING THE SITE, AND TEMPORARY MULCHING.
- DUST CONTROL MEASURES SHALL BE UTILIZED SO AS TO PREVENT THE MIGRATION OF DUST FROM THE SITE TO ADJUTING AREAS.

STOCKPILES:

- LOCATE STOCKPILES A MINIMUM OF 50 FEET AWAY FROM CATCH BASINS, SWALES, AND CULVERTS.
- ALL STOCKPILES SHOULD BE SURROUNDED WITH TEMPORARY EROSION CONTROL MEASURES PRIOR TO THE ONSET OF PRECIPITATION.
- PERIMETER BARRIERS SHOULD BE MAINTAINED AT ALL TIMES, AND ADJUSTED AS NEEDED TO ACCOMMODATE THE DELIVERY AND REMOVAL OF MATERIALS FROM THE STOCKPILE. THE INTEGRITY OF THE BARRIER SHOULD BE INSPECTED AT THE END OF EACH WORKING DAY.
- PROTECT ALL STOCKPILES FROM STORMWATER RUN-OFF USING TEMPORARY EROSION CONTROL MEASURES SUCH AS BERMS, SILT SOCK, OR OTHER APPROVED PRACTICE TO PREVENT MIGRATION OF MATERIAL BEYOND THE IMMEDIATE CONFINES OF THE STOCKPILES.

OFF SITE VEHICLE TRACKING:

- THE CONTRACTOR SHALL CONSTRUCT STABILIZED CONSTRUCTION ENTRANCE(S) PRIOR TO ANY EXCAVATION ACTIVITIES.

VEGETATION:

- TEMPORARY GRASS COVER:
 - SEEDBED PREPARATION:
 - APPLY FERTILIZER AT THE RATE OF 600 POUNDS PER ACRE OF 10-10-10. APPLY LIMESTONE (EQUIVALENT TO 50 PERCENT CALCIUM PLUS MAGNESIUM OXIDE) AT A RATE OF THREE (3) TONS PER ACRE;
 - SEEDING:
 - UTILIZE ANNUAL RYE GRASS AT A RATE OF 40 LBS/ACRE;
 - WHERE THE SOIL HAS BEEN COMPACTED BY CONSTRUCTION OPERATIONS, LOOSEN SOIL TO A DEPTH OF TWO (2) INCHES BEFORE APPLYING FERTILIZER, LIME AND SEED;
 - APPLY SEED UNIFORMLY BY HAND, CYCLONE SEEDER, OR HYDROSEEDER (SLURRY INCLUDING SEED AND FERTILIZER). HYDROSEEDINGS, WHICH INCLUDE MULCH, MAY BE LEFT ON SOIL SURFACE. SEEDING RATES MUST BE INCREASED 10% WHEN HYDROSEEDING;
 - MAINTENANCE:
 - TEMPORARY SEEDING SHALL BE PERIODICALLY INSPECTED. AT A MINIMUM, 95% OF THE SOIL SURFACE SHOULD BE COVERED BY VEGETATION. IF ANY EVIDENCE OF EROSION OR SEDIMENTATION IS APPARENT, REPAIRS SHALL BE MADE AND OTHER TEMPORARY MEASURES USED IN THE INTERIM (MULCH, FILTER BARRIERS, CHECK DAMS, ETC.).
 - VEGETATIVE PRACTICE:
 - FOR PERMANENT MEASURES AND PLANTINGS:
 - LIMESTONE SHALL BE THOROUGHLY INCORPORATED INTO THE LOAM LAYER AT A RATE OF THREE (3) TONS PER ACRE IN ORDER TO PROVIDE A PH VALUE OF 5.5 TO 6.5;
 - FERTILIZER SHALL BE SPREAD ON THE TOP LAYER OF LOAM AND WORKED INTO THE SURFACE. FERTILIZER APPLICATION RATE SHALL BE 800 POUNDS PER ACRE OF 10-20-20 FERTILIZER;
 - SOIL CONDITIONERS AND FERTILIZER SHALL BE APPLIED AT THE RECOMMENDED RATES AND SHALL BE THOROUGHLY WORKED INTO THE LOAM. LOAM SHALL BE RAKED UNTIL THE SURFACE IS FINELY PULVERIZED, SMOOTH AND EVEN, AND THEN COMPACTED TO AN EVEN SURFACE CONFORMING TO THE REQUIRED LINES AND GRADES WITH APPROVED ROLLERS WEIGHING BETWEEN 4-1/2 POUNDS AND 5-1/2 POUNDS PER INCH OF WIDTH;
 - SEED SHALL BE SOWN AT THE RATE SHOWN BELOW. SOWING SHALL BE DONE ON A CALM, DRY DAY, PREFERABLY BY MACHINE, BUT IF BY HAND, ONLY BY EXPERIENCED WORKMEN. IMMEDIATELY BEFORE SEEDING, THE SOIL SHALL BE LIGHTLY RAKED. ONE HALF THE SEED SHALL BE SOWN IN ONE DIRECTION AND THE OTHER HALF AT RIGHT ANGLES TO THE ORIGINAL DIRECTION. IT SHALL BE LIGHTLY RAKED INTO THE SOIL TO A DEPTH NOT OVER 1/4 INCH AND ROLLED WITH A HAND ROLLER WEIGHING NOT OVER 100 POUNDS PER LINEAR FOOT OF WIDTH;
 - HAY MULCH SHALL BE APPLIED IMMEDIATELY AFTER SEEDING AS INDICATED ABOVE;
 - THE SURFACE SHALL BE WATERED AND KEPT MOIST WITH A FINE SPRAY AS REQUIRED, WITHOUT WASHING AWAY THE SOIL, UNTIL THE GRASS IS WELL ESTABLISHED. ANY AREAS WHICH ARE NOT SATISFACTORILY COVERED WITH GRASS SHALL BE RESEEDED, AND ALL NOXIOUS WEEDS REMOVED;
 - THE CONTRACTOR SHALL PROTECT AND MAINTAIN THE SEEDED AREAS UNTIL ACCEPTED;
 - A GRASS SEED MIXTURE CONTAINING THE FOLLOWING SEED REQUIREMENTS SHALL BE APPLIED AT A RATE OF 40 LB/AC OR APPROVED EQUAL:

SEED MIX	APPLICATION RATE
"REBEL II" TALL FESCUE	70%
"PALMER" PERENNIAL RYEGRASS	20%
"BARON" KENTUCKY BLUEGRASS	20%
- IN NO CASE SHALL THE WEED CONTENT EXCEED ONE (1) PERCENT BY WEIGHT. ALL SEED SHALL COMPLY WITH STATE AND FEDERAL SEED LAWS. SEEDING SHALL BE DONE NO LATER THAN SEPTEMBER 15. IN NO CASE SHALL SEEDING TAKE PLACE OVER SNOW.
- DORMANT SEEDING (SEPTEMBER 15 TO FIRST SNOWFALL):
 - FOLLOW PERMANENT MEASURES SLOPE, LIME, FERTILIZER AND GRADING REQUIREMENTS. APPLY SEED MIXTURE AT TWICE THE INDICATED RATE. APPLY MULCH AS INDICATED FOR PERMANENT MEASURES.

CONCRETE WASHOUT AREA:

- THE CONCRETE DELIVERY TRUCKS SHALL, WHENEVER POSSIBLE, USE WASHOUT FACILITIES AT THEIR OWN PLANT OR DISPATCH FACILITY;
- IF IT IS NECESSARY, SITE CONTRACTOR SHALL DESIGNATE SPECIFIC WASHOUT AREAS AND DESIGN FACILITIES TO HANDLE ANTICIPATED WASHOUT WATER;
- CONTRACTOR SHALL LOCATE WASHOUT AREAS AT LEAST 150 FEET AWAY FROM STORM DRAINS, SWALES AND SURFACE WATERS OR DELINEATED WETLANDS;
- INSPECT WASHOUT FACILITIES DAILY TO DETECT LEAKS OR TEARS AND TO IDENTIFY WHEN MATERIALS NEED TO BE REMOVED.

ALLOWABLE NON-STORMWATER DISCHARGES:

- THE FOLLOWING ARE THE ONLY NON-STORMWATER DISCHARGES ALLOWED. ALL OTHER NON-STORMWATER DISCHARGES ARE PROHIBITED ON SITE:
 - FIRE-FIGHTING ACTIVITIES;
 - FIRE HYDRANT FLUSHING;
 - WATERS USED TO WASH VEHICLES WHERE DETERGENTS ARE NOT USED;
 - WATER USED TO CONTROL DUST;
 - POTABLE WATER INCLUDING UNCONTAMINATED WATER LINE FLUSHING;
 - ROUTINE EXTERNAL BUILDING WASH DOWN WHERE DETERGENTS ARE NOT USED;
 - PAVEMENT WASH WATERS WHERE DETERGENTS ARE NOT USED;
 - UNCONTAMINATED AIR CONDITIONING/COMPRESSOR CONDENSATION;
 - UNCONTAMINATED GROUND WATER OR SPRING WATER;
 - FOUNDATION OR FOOTING DRAINS WHICH ARE UNCONTAMINATED;
 - LANDSCAPE IRRIGATION.

WASTE DISPOSAL:

- WASTE MATERIAL:
 - ALL WASTE MATERIALS SHALL BE COLLECTED AND STORED IN SECURELY LIDDED RECEPTACLES. ALL TRASH AND CONSTRUCTION DEBRIS FROM THE SITE SHALL BE DEPOSITED IN A DUMPSTER;
 - NO CONSTRUCTION WASTE MATERIALS SHALL BE BURIED ON SITE;
 - ALL PERSONNEL SHALL BE INSTRUCTED REGARDING THE CORRECT PROCEDURE FOR WASTE DISPOSAL BY THE SUPERINTENDENT.
- HAZARDOUS WASTE:
 - ALL HAZARDOUS WASTE MATERIALS SHALL BE DISPOSED OF IN THE MANNER SPECIFIED BY LOCAL OR STATE REGULATION OR BY THE MANUFACTURER;
 - SITE PERSONNEL SHALL BE INSTRUCTED IN THESE PRACTICES BY THE SUPERINTENDENT.
- SANITARY WASTE:
 - ALL SANITARY WASTE SHALL BE COLLECTED FROM THE PORTABLE UNITS A MINIMUM OF ONCE PER WEEK BY A LICENSED SANITARY WASTE MANAGEMENT CONTRACTOR.

SPILL PREVENTION:


- CONTRACTOR SHALL BE FAMILIAR WITH SPILL PREVENTION MEASURES REQUIRED BY LOCAL, STATE AND FEDERAL AGENCIES. AT A MINIMUM, CONTRACTOR SHALL FOLLOW THE BEST MANAGEMENT SPILL PREVENTION PRACTICES OUTLINED BELOW.
- THE FOLLOWING ARE THE MATERIAL MANAGEMENT PRACTICES THAT SHALL BE USED TO REDUCE THE RISK OF SPILLS OR OTHER ACCIDENTAL EXPOSURE OF MATERIALS AND SUBSTANCES DURING CONSTRUCTION TO STORMWATER RUNOFF:
 - GOOD HOUSEKEEPING - THE FOLLOWING GOOD HOUSEKEEPING PRACTICE SHALL BE FOLLOWED ON SITE DURING CONSTRUCTION:
 - ONLY SUFFICIENT AMOUNTS OF PRODUCTS TO DO THE JOB SHALL BE STORED ON SITE;
 - ALL MATERIALS STORED ON SITE SHALL BE STORED IN A NEAT, ORDERLY MANNER IN THEIR PROPER (ORIGINAL IF POSSIBLE) CONTAINERS AND, IF POSSIBLE, UNDER A ROOF OR OTHER ENCLOSURE;
 - MANUFACTURER'S RECOMMENDATIONS FOR PROPER USE AND DISPOSAL SHALL BE FOLLOWED;
 - THE SITE SUPERINTENDENT SHALL INSPECT DAILY TO ENSURE PROPER USE AND DISPOSAL OF MATERIALS;
 - SUBSTANCES SHALL NOT BE MIXED WITH ONE ANOTHER UNLESS RECOMMENDED BY THE MANUFACTURER;
 - WHENEVER POSSIBLE ALL OF A PRODUCT SHALL BE USED UP BEFORE DISPOSING OF THE CONTAINER.
 - HAZARDOUS PRODUCTS - THE FOLLOWING PRACTICES SHALL BE USED TO REDUCE THE RISKS ASSOCIATED WITH HAZARDOUS MATERIALS:
 - PRODUCTS SHALL BE KEPT IN THEIR ORIGINAL CONTAINERS UNLESS THEY ARE NOT RESEALABLE;
 - ORIGINAL LABELS AND MATERIAL SAFETY DATA SHALL BE RETAINED FOR IMPORTANT PRODUCT INFORMATION;
 - SURPLUS PRODUCT THAT MUST BE DISPOSING OF SHALL BE DISCARDED ACCORDING TO THE MANUFACTURER'S RECOMMENDED METHODS OF DISPOSAL.
 - PRODUCT SPECIFIC PRACTICES - THE FOLLOWING PRODUCT SPECIFIC PRACTICES SHALL BE FOLLOWED ON SITE:
 - PETROLEUM PRODUCTS:
 - ALL ON SITE VEHICLES SHALL BE MONITORED FOR LEAKS AND RECEIVE REGULAR PREVENTIVE MAINTENANCE TO REDUCE LEAKAGE;
 - PETROLEUM PRODUCTS SHALL BE STORED IN TIGHTLY SEALED CONTAINERS WHICH ARE CLEARLY LABELED. ANY ASPHALT BASED SUBSTANCES USED ON SITE SHALL BE APPLIED ACCORDING TO THE MANUFACTURER'S RECOMMENDATIONS.
 - FERTILIZERS:
 - FERTILIZERS USED SHALL BE APPLIED ONLY IN THE MINIMUM AMOUNTS DIRECTED BY THE SPECIFICATIONS;
 - ONCE APPLIED FERTILIZER SHALL BE WORKED INTO THE SOIL TO LIMIT EXPOSURE TO STORMWATER;
 - STORAGE SHALL BE IN A COVERED SHED OR ENCLOSED TRAILERS. THE CONTENTS OF ANY PARTIALLY USED BAGS OF FERTILIZER SHALL BE TRANSFERRED TO A SEALABLE PLASTIC BIN TO AVOID SPILLS.
 - PAINTS:
 - ALL CONTAINERS SHALL BE TIGHTLY SEALED AND STORED WHEN NOT REQUIRED FOR USE;
 - EXCESS PAINT SHALL NOT BE DISCHARGED TO THE STORM SEWER SYSTEM;
 - EXCESS PAINT SHALL BE DISPOSING OF PROPERLY ACCORDING TO MANUFACTURER'S INSTRUCTIONS OR STATE AND LOCAL REGULATIONS.
 - SPILL CONTROL PRACTICES - IN ADDITION TO GOOD HOUSEKEEPING AND MATERIAL MANAGEMENT PRACTICES DISCUSSED IN THE PREVIOUS SECTION, THE FOLLOWING PRACTICES SHALL BE FOLLOWED FOR SPILL PREVENTION AND CLEANUP:
 - MANUFACTURER'S RECOMMENDED METHODS FOR SPILL CLEANUP SHALL BE CLEARLY POSTED AND SITE PERSONNEL SHALL BE MADE AWARE OF THE PROCEDURES AND THE LOCATION OF THE INFORMATION AND CLEANUP SUPPLIES;
 - MATERIALS AND EQUIPMENT NECESSARY FOR SPILL CLEANUP SHALL BE KEPT IN THE MATERIAL STORAGE AREA ON SITE. EQUIPMENT AND MATERIALS SHALL INCLUDE BUT NOT BE LIMITED TO BROOMS, DUSTPANS, MOPS, RAGS, GLOVES, GOGGLES, KITTY LITTER, SAND, SAWDUST AND PLASTIC OR METAL TRASH CONTAINERS SPECIFICALLY FOR THIS PURPOSE;
 - ALL SPILLS SHALL BE CLEANED UP IMMEDIATELY AFTER DISCOVERY;
 - THE SPILL AREA SHALL BE KEPT WELL VENTILATED AND PERSONNEL SHALL WEAR APPROPRIATE PROTECTIVE CLOTHING TO PREVENT INJURY FROM CONTACT WITH A HAZARDOUS SUBSTANCE;
 - SPILLS OF TOXIC OR HAZARDOUS MATERIAL SHALL BE REPORTED TO THE APPROPRIATE LOCAL, STATE OR FEDERAL AGENCIES AS REQUIRED;
 - THE SITE SUPERINTENDENT RESPONSIBLE FOR DAY-TO-DAY SITE OPERATIONS SHALL BE THE SPILL PREVENTION AND CLEANUP COORDINATOR.
 - VEHICLE FUELING AND MAINTENANCE PRACTICE:
 - CONTRACTOR SHALL MAKE AN EFFORT TO PERFORM EQUIPMENT/VEHICAL FUELING AND MAINTENANCE AT AN OFF-SITE FACILITY;
 - CONTRACTOR SHALL PROVIDE AN ON-SITE FUELING AND MAINTENANCE AREA THAT IS CLEAN AND DRY;
 - IF POSSIBLE THE CONTRACTOR SHALL KEEP AREA COVERED;
 - CONTRACTOR SHALL KEEP A SPILL KIT AT THE FUELING AND MAINTENANCE AREA;
 - CONTRACTOR SHALL REGULARLY INSPECT VEHICLES FOR LEAKS AND DAMAGE;
 - CONTRACTOR SHALL USE DRIP PANS, DRIP CLOTHS, OR ABSORBENT PADS WHEN REPLACING SPENT FLUID.

EROSION CONTROL OBSERVATIONS AND MAINTENANCE PRACTICES

THIS PROJECT EXCEEDS ONE (1) ACRE OF DISTURBANCE AND THUS REQUIRES A SWPPP. THE SWPPP SHALL BE PREPARED BY THE CONTRACTOR. THE CONTRACTOR SHALL BE FAMILIAR WITH THE SWPPP AND KEEP AN UPDATED COPY OF THE SWPPP ONSITE AT ALL TIMES.

THE FOLLOWING REPRESENTS THE GENERAL OBSERVATION AND REPORTING PRACTICES THAT SHALL BE FOLLOWED AS PART OF THIS PROJECT:

- OBSERVATIONS OF THE PROJECT FOR COMPLIANCE WITH THE SWPPP SHALL BE MADE BY THE CONTRACTOR AT LEAST ONCE A WEEK OR WITHIN 24 HOURS OF A STORM 0.25 INCHES OR GREATER;
- AN OBSERVATION REPORT SHALL BE MADE AFTER EACH OBSERVATION AND DISTRIBUTED TO THE ENGINEER, THE OWNER, AND THE CONTRACTOR;
- A REPRESENTATIVE OF THE SITE CONTRACTOR, SHALL BE RESPONSIBLE FOR MAINTENANCE AND REPAIR ACTIVITIES;
- IF A REPAIR IS NECESSARY, IT SHALL BE INITIATED WITHIN 24 HOURS OF REPORT.

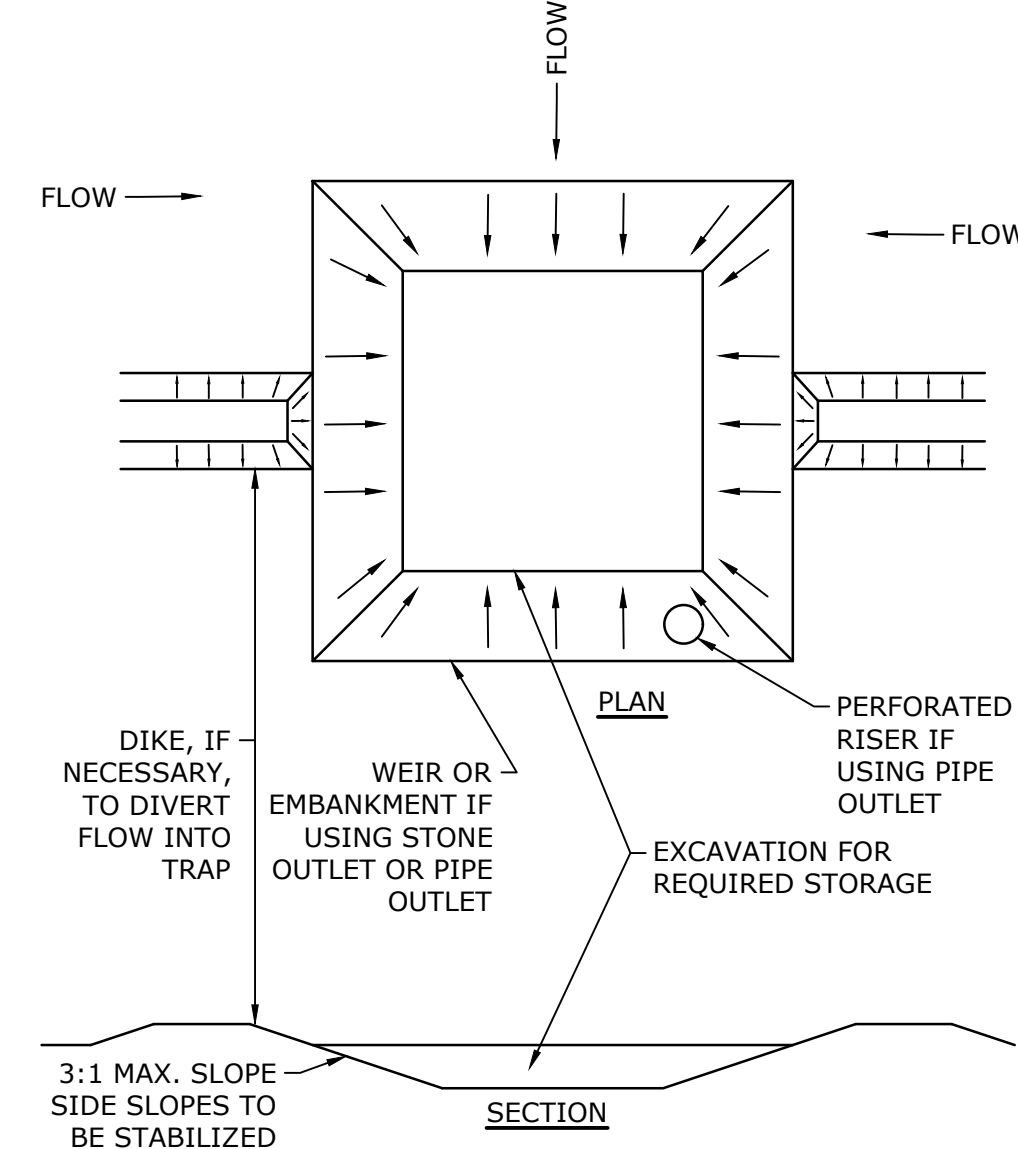


NOTES:

- THE TRAP SHALL BE INSTALLED AS CLOSE TO THE DISTURBED AREA AS POSSIBLE.
- THE MAXIMUM CONTRIBUTING AREA TO A SINGLE TRAP SHALL BE LESS THAN 5 ACRES.
- THE MINIMUM VOLUME OF THE TRAP SHALL BE 3,600 CUBIC FEET OF STORAGE FOR EACH ACRE OF DRAINAGE AREA.
- TRAP OUTLET SHALL BE MINIMUM OF ONE FOOT BELOW THE CREST OF THE TRAP.
- TRAP SHALL DISCHARGE TO A STABILIZED AREA.
- TRAP SHALL BE CLEANED WHEN 50 PERCENT OF THE ORIGINAL VOLUME IS FILLED.
- MATERIALS REMOVED FROM THE TRAP SHALL BE PROPERLY DISPOSING OF AND STABILIZED.

SEDIMENT TRAP

NO SCALE

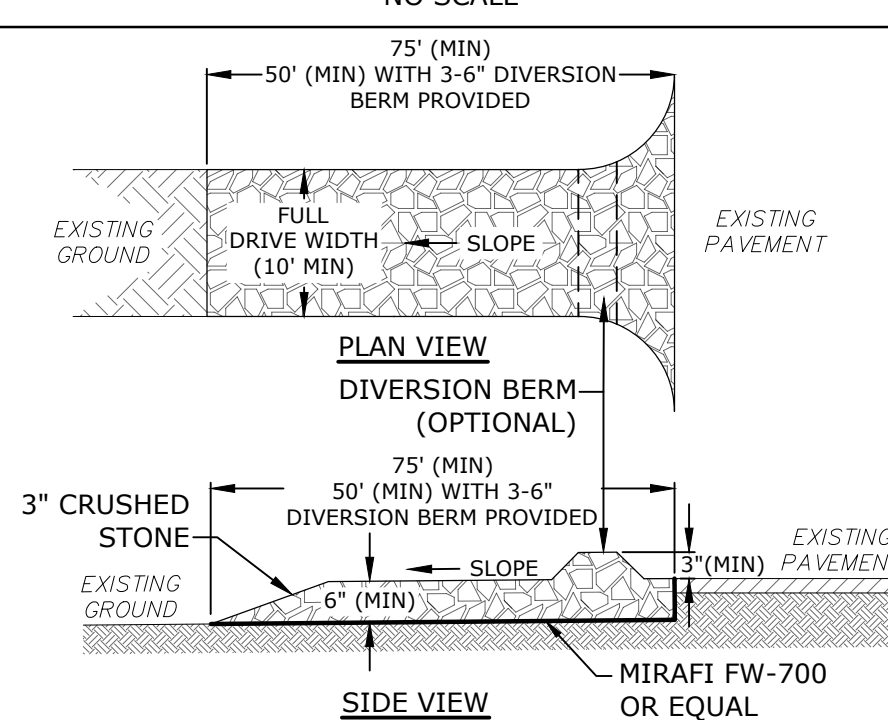


NOTES:

- THE ENTRANCE SHALL BE MAINTAINED IN A CONDITION WHICH WILL PREVENT TRACKING OF SEDIMENT FROM THE SITE. WHEN WASHING IS REQUIRED, IT SHALL BE DONE SO RUNOFF DRAINS INTO AN APPROVED SEDIMENT TRAPPING DEVICE. ALL SEDIMENT SHALL BE PREVENTED FROM ENTERING STORM DRAINS, DITCHES, OR WATERWAYS

STABILIZED CONSTRUCTION ENTRANCE

NO SCALE

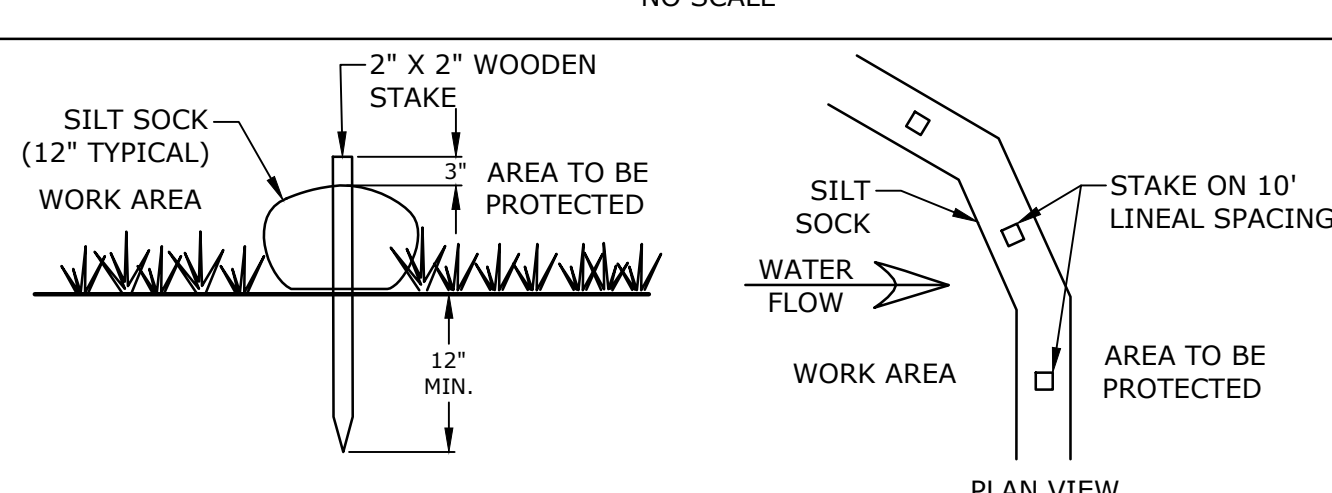


NOTES:

- SILT SOCK SHALL BE SILT SOCKS NATURAL ORIGINAL BY FILTREXX OR APPROVED EQUAL.
- INSTALL SILT SOCK IN ACCORDANCE WITH MANUFACTURER'S SPECIFICATIONS.

SILT SOCK

NO SCALE

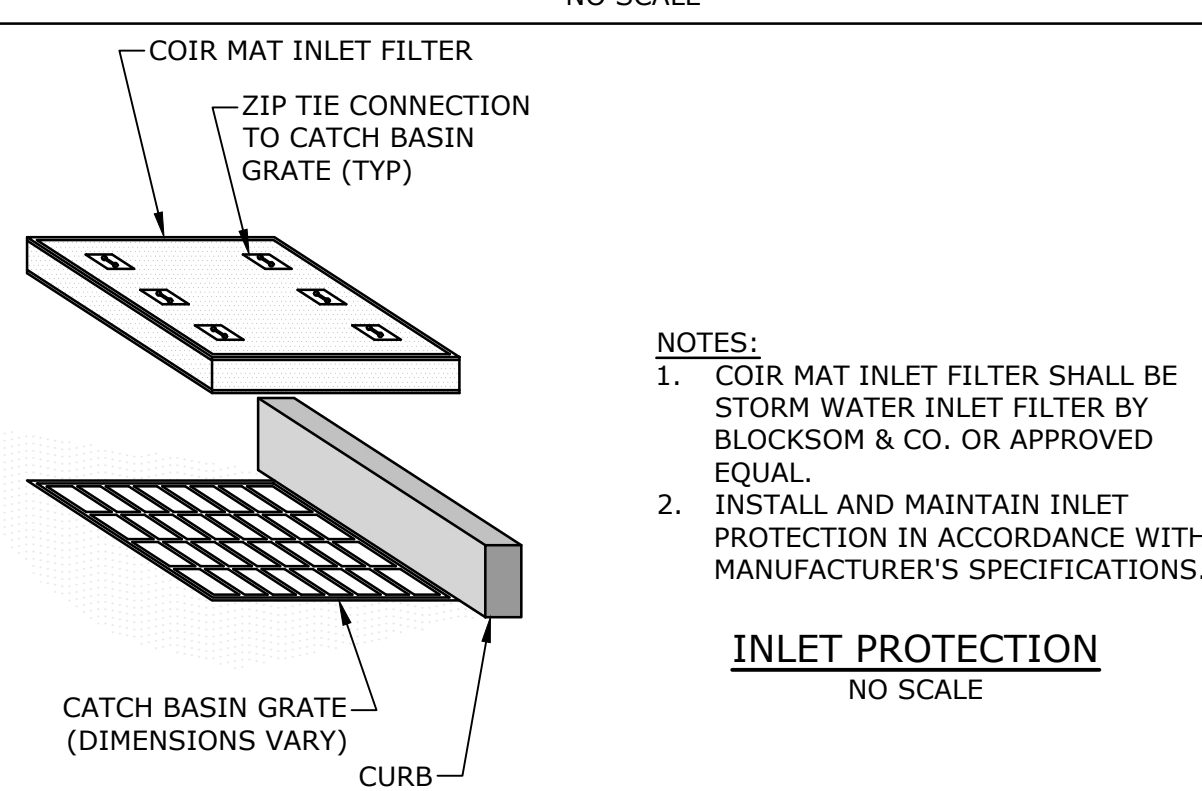


NOTES:

- COIR MAT INLET FILTER SHALL BE STORM WATER INLET FILTER BY BLOCKSOM & CO. OR APPROVED EQUAL.
- INSTALL AND MAINTAIN INLET PROTECTION IN ACCORDANCE WITH MANUFACTURER'S SPECIFICATIONS.

INLET PROTECTION

NO SCALE

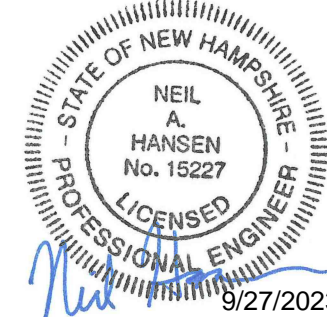

Proposed Industrial Development

Lonza Biologics

Portsmouth, New Hampshire



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L	7/17/2023	Amended Site Plan Review
K	5/5/2023	Phase 1B Issued for Bid
J	3/15/2023	Phase 1B Issued for Preliminary Pricing
I	1/9/2023	Admin. Approval Submission
H	12/10/2021	Planning Board Stipulation
G	8/19/2019	Admin. Approval Submission
F	11/6/2018	P.B. Submission
MARK	DATE	DESCRIPTION

PROJECT NO: L-0700-013
 DATE: 04/03/2018
 FILE: L-0700-026-C-DTLS.dwg
 DRAWN BY: CIK
 CHECKED BY: NAH
 APPROVED: PMC


EROSION CONTROL NOTES & DETAILS SHEET

SCALE: AS SHOWN

C-501

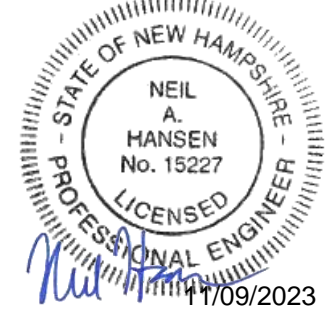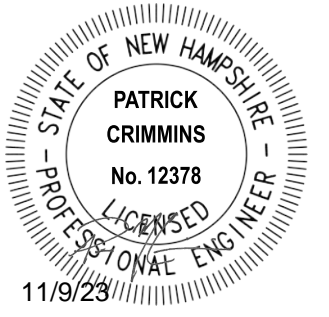


NHDOT ITEM No. 304.2 (GRAVEL)		NHDOT ITEM No. 304.3 (CRUSHED GRAVEL)	
SIEVE SIZE	% PASSING	SIEVE SIZE	% PASSING
6"	100	3"	100
#4	25-70	1"	95-100
#200	0-12	#4	55-85
		#200	27-52
			0-12

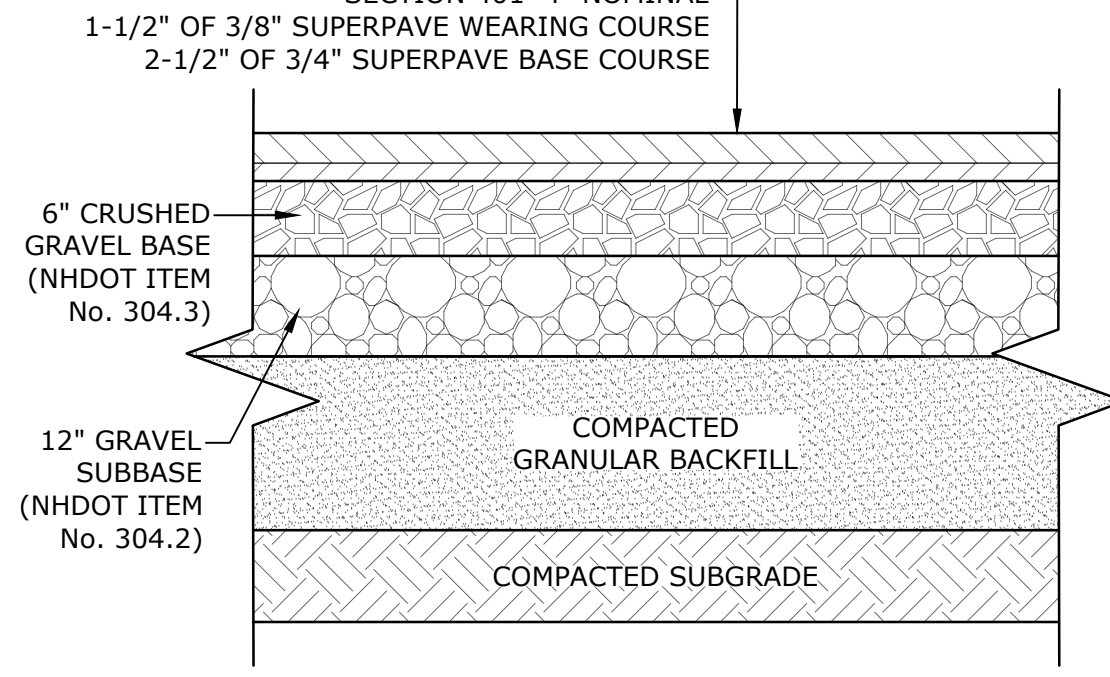

- NOTES:
- SEE SITE PLAN FOR PAVEMENT WIDTH AND LOCATION.
 - SEE GRADING, DRAINAGE AND EROSION CONTROL PLAN FOR PAVEMENT SLOPE AND CROSS-SLOPE.
 - A TACK COAT SHALL BE PLACED ON TOP OF BINDER COURSE PAVEMENT PRIOR TO PLACING WEARING COURSE.
 - FINAL PAVEMENT DESIGN TO BE DETERMINED BY GEOTECHNICAL ENGINEER.
 - NHDOT ITEM No. 304.2 MAY BE SUBSTITUTED FOR NHDOT ITEM No. 304.4, IF NHDOT ITEM No. 304.2 CAN NOT BE ACQUIRED.


TYPICAL PAVEMENT SECTION
NO SCALE

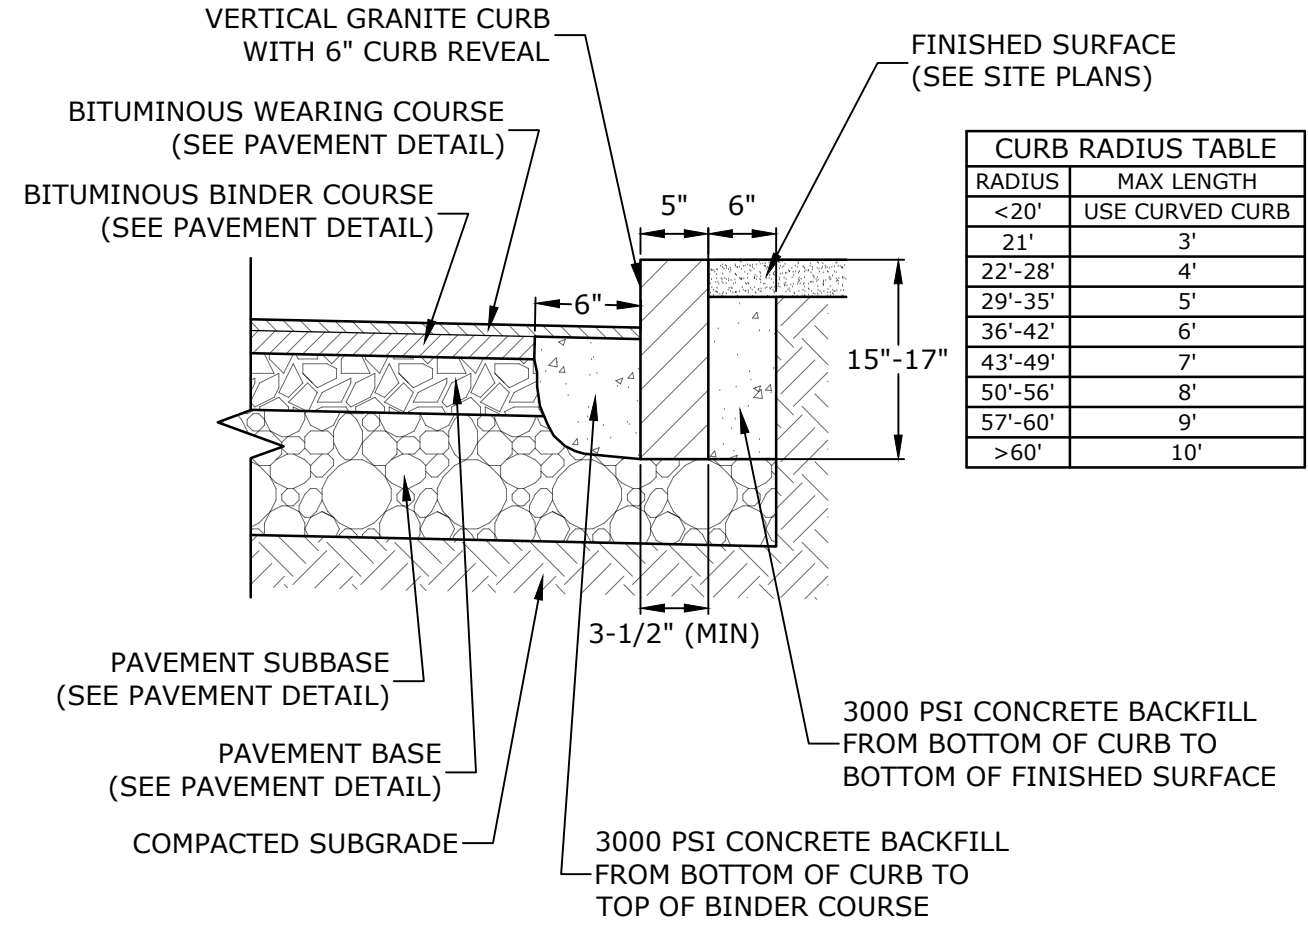

RADIUS	MAX LENGTH
<20'	USE CURVED CURB
21'	3'
22'-28'	4'
29'-35'	5'
36'-42'	6'
43'-49'	7'
50'-56'	8'
57'-60'	9'
>60'	10'

- NOTES:
- SEE SITE PLAN(S) FOR LIMITS OF VERTICAL GRANITE CURB (VGC).
 - ADJOINING STONES SHALL HAVE THE SAME OR APPROXIMATELY THE SAME LENGTH.
 - MINIMUM LENGTH OF STRAIGHT CURB STONES = 3'
 - MAXIMUM LENGTH OF STRAIGHT CURB STONES = 10'
 - MAXIMUM LENGTH OF STRAIGHT CURB STONES LAID ON CURVES (SEE TABLE).
 - ALL RADII 20 FEET AND SMALLER SHALL BE CONSTRUCTED USING CURVED SECTIONS.
 - JOINTS BETWEEN STONES SHALL HAVE A MAXIMUM SPACING OF 1/2" AND SHALL BE MORTARED.


VERTICAL GRANITE CURB
NO SCALE

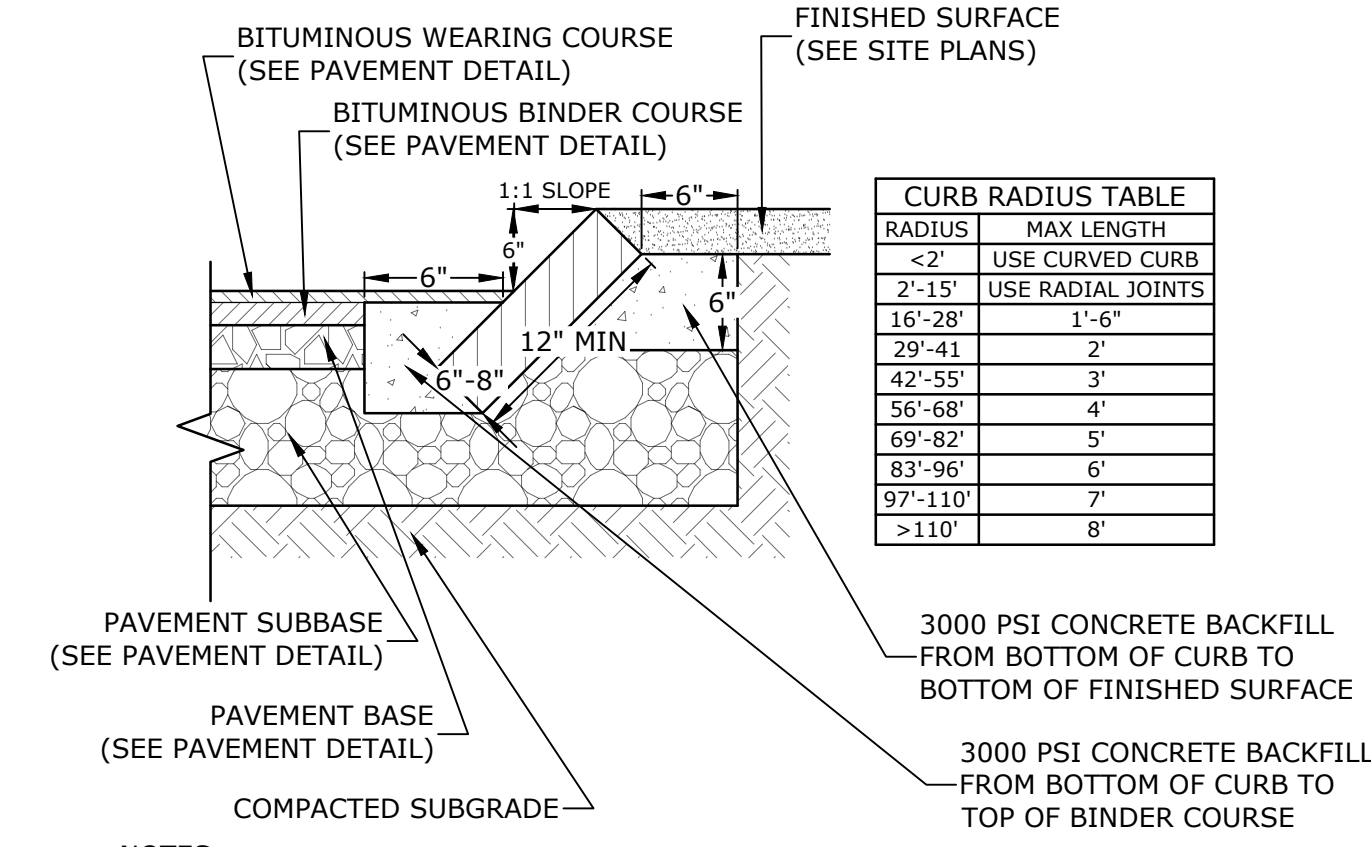

RADIUS	MAX LENGTH
<2'	USE CURVED CURB
2'-15'	USE RADIAL JOINTS
16'-28'	1'-6"
29'-41'	2'
42'-55'	3'
56'-68'	4'
69'-82'	5'
83'-96'	6'
97'-110'	7'
>110'	8'

- NOTES:
- SEE SITE PLAN(S) FOR LIMITS OF VERTICAL GRANITE CURB (VGC).
 - ADJOINING STONES SHALL HAVE THE SAME OR APPROXIMATELY THE SAME LENGTH.
 - MINIMUM LENGTH OF STRAIGHT CURB STONES = 18"
 - MAXIMUM LENGTH OF STRAIGHT CURB STONES = 8'
 - MAXIMUM LENGTH OF STRAIGHT CURB STONES LAID ON CURVES (SEE TABLE).
 - JOINTS BETWEEN STONES SHALL HAVE A MAXIMUM SPACING OF 1/2" AND SHALL BE MORTARED.

SLOPED GRANITE CURB
NO SCALE

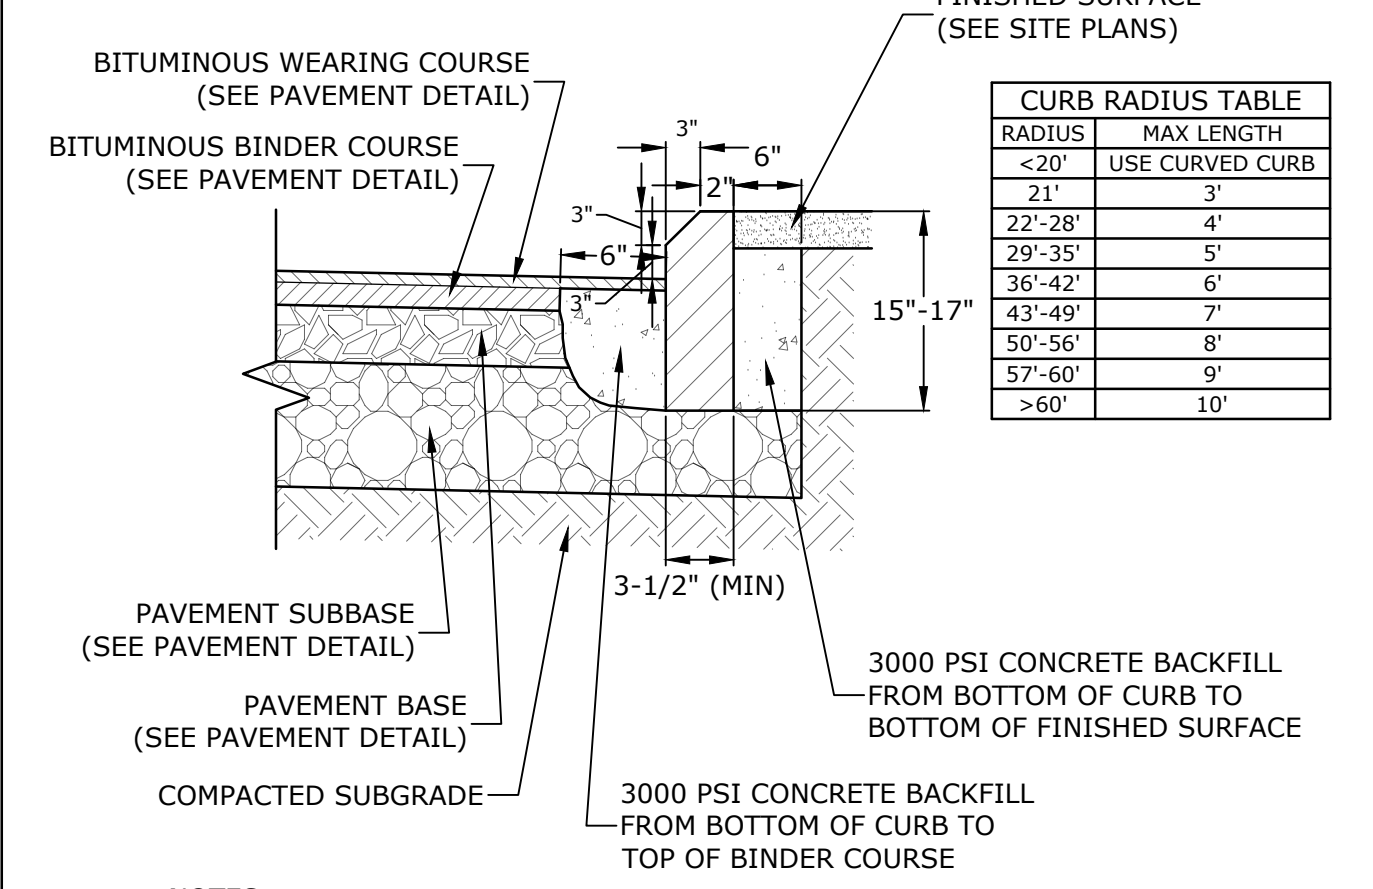


RADIUS	MAX LENGTH
<20'	USE CURVED CURB
21'	3'
22'-28'	4'
29'-35'	5'
36'-42'	6'
43'-49'	7'
50'-56'	8'
57'-60'	9'
>60'	10'

- NOTES:
- SEE SITE PLAN(S) FOR LIMITS OF MOUNTABLE VERTICAL GRANITE CURB (MVGC).
 - ADJOINING STONES SHALL HAVE THE SAME OR APPROXIMATELY THE SAME LENGTH.
 - MINIMUM LENGTH OF STRAIGHT CURB STONES = 3'
 - MAXIMUM LENGTH OF STRAIGHT CURB STONES = 10'
 - MAXIMUM LENGTH OF STRAIGHT CURB STONES LAID ON CURVES (SEE TABLE).
 - ALL RADII 20 FEET AND SMALLER SHALL BE CONSTRUCTED USING CURVED SECTIONS.
 - JOINTS BETWEEN STONES SHALL HAVE A MAXIMUM SPACING OF 1/2" AND SHALL BE MORTARED.


MOUNTABLE VERTICAL GRANITE CURB
NO SCALE

NHDOT ITEM No. 304.2 (GRAVEL)		NHDOT ITEM No. 304.3 (CRUSHED GRAVEL)	
SIEVE SIZE	% PASSING	SIEVE SIZE	% PASSING
6"	100	3"	100
#4	25-70	1"	95-100
#200	0-12	#4	55-85
		#200	27-52
			0-12

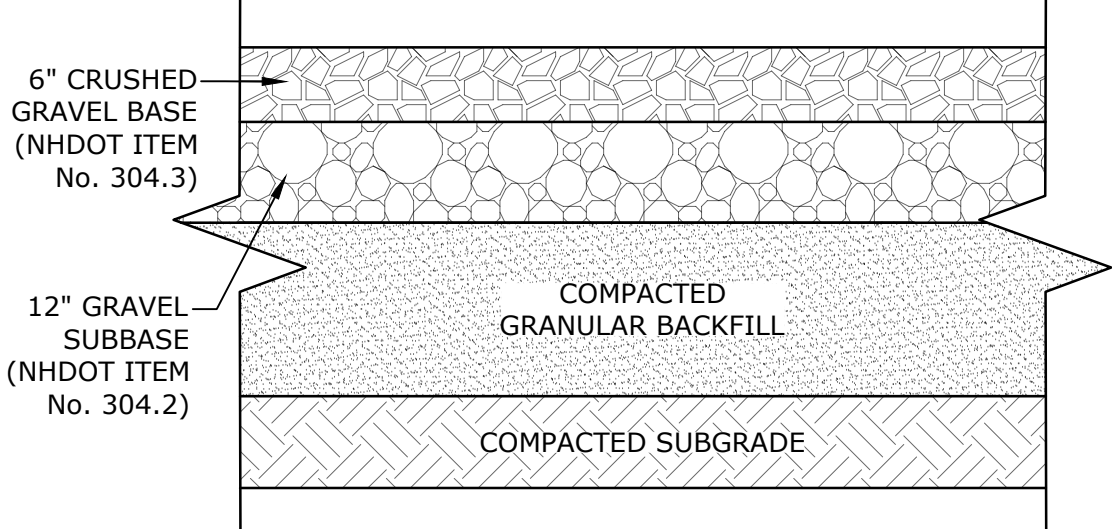


- NOTES:
- SEE SITE PLAN FOR GRAVEL WIDTH AND LOCATION.
 - SEE GRADING, DRAINAGE AND EROSION CONTROL PLAN FOR PAVEMENT SLOPE AND CROSS-SLOPE.
 - GRAVEL PARKING AREA DESIGN TO BE DETERMINED BY GEOTECHNICAL ENGINEER.
 - NHDOT ITEM No. 304.2 MAY BE SUBSTITUTED FOR NHDOT ITEM No. 304.4, IF NHDOT ITEM No. 304.2 CAN NOT BE ACQUIRED.

GRAVEL PARKING AREA SECTION
NO SCALE

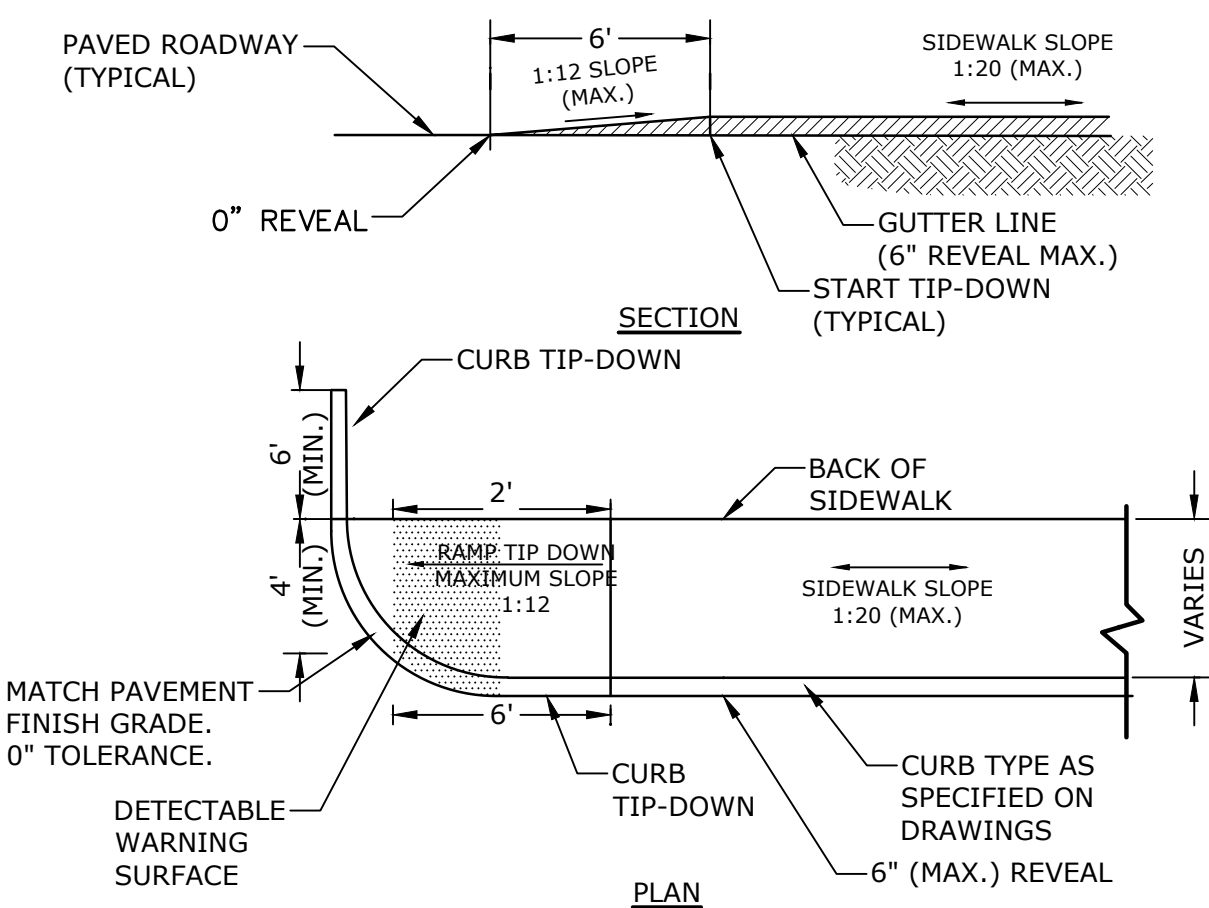


- NOTES:
- RAMPS SHALL BE CONSTRUCTED IN ACCORDANCE WITH THE AMERICANS WITH DISABILITIES ACT AND LOCAL AND STATE REQUIREMENTS.
 - PROVIDE 6" COMPACTED CRUSHED GRAVEL BASE BENEATH RAMPS.
 - DETECTABLE WARNING STRIP SHALL BE NENAH R-4984-36B-R4984007 24" X 36" CAST IRON ADA PLATE. INSTALL PER MANUFACTURER'S RECOMMENDATIONS.

CORNER TIP DOWN RAMP
NO SCALE

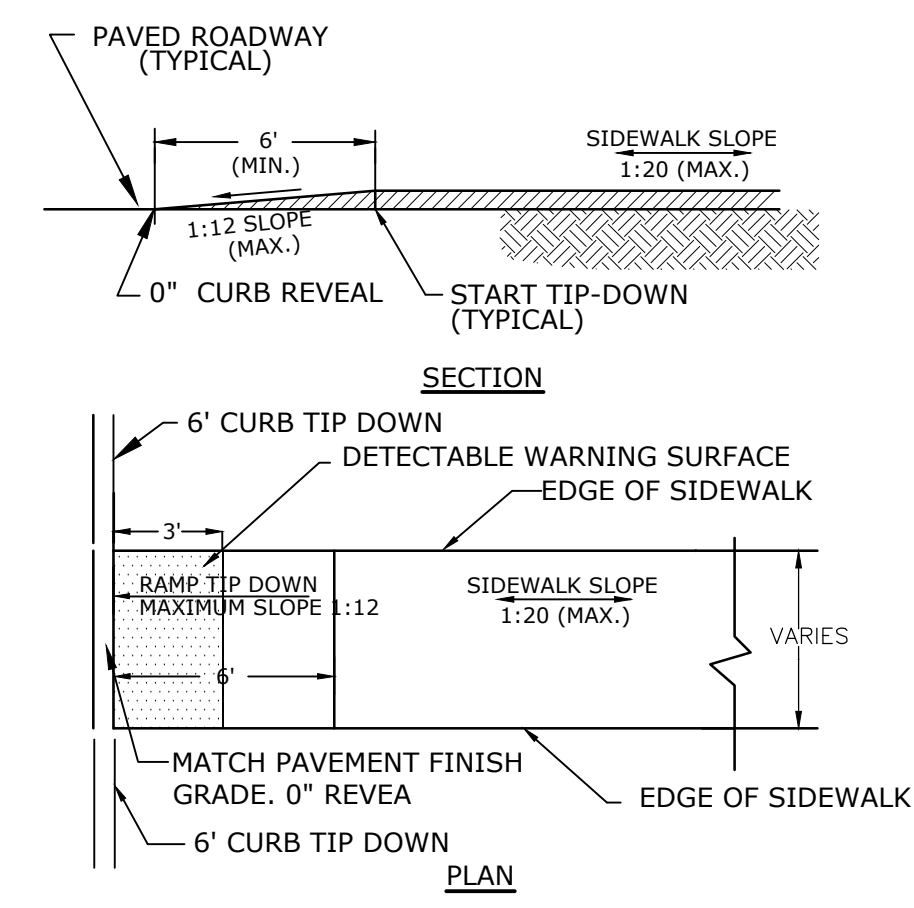


- NOTES:
- RAMPS SHALL BE CONSTRUCTED IN ACCORDANCE WITH THE AMERICANS WITH DISABILITIES ACT AND LOCAL AND STATE REQUIREMENTS.
 - PROVIDE 6" COMPACTED CRUSHED GRAVEL BASE BENEATH RAMPS.
 - DETECTABLE WARNING STRIP SHALL BE NENAH R-4984-36B-R4984007 24" X 36" CAST IRON ADA PLATE. INSTALL PER MANUFACTURER'S RECOMMENDATIONS.

SIDEWALK TIP-DOWN RAMP
NO SCALE

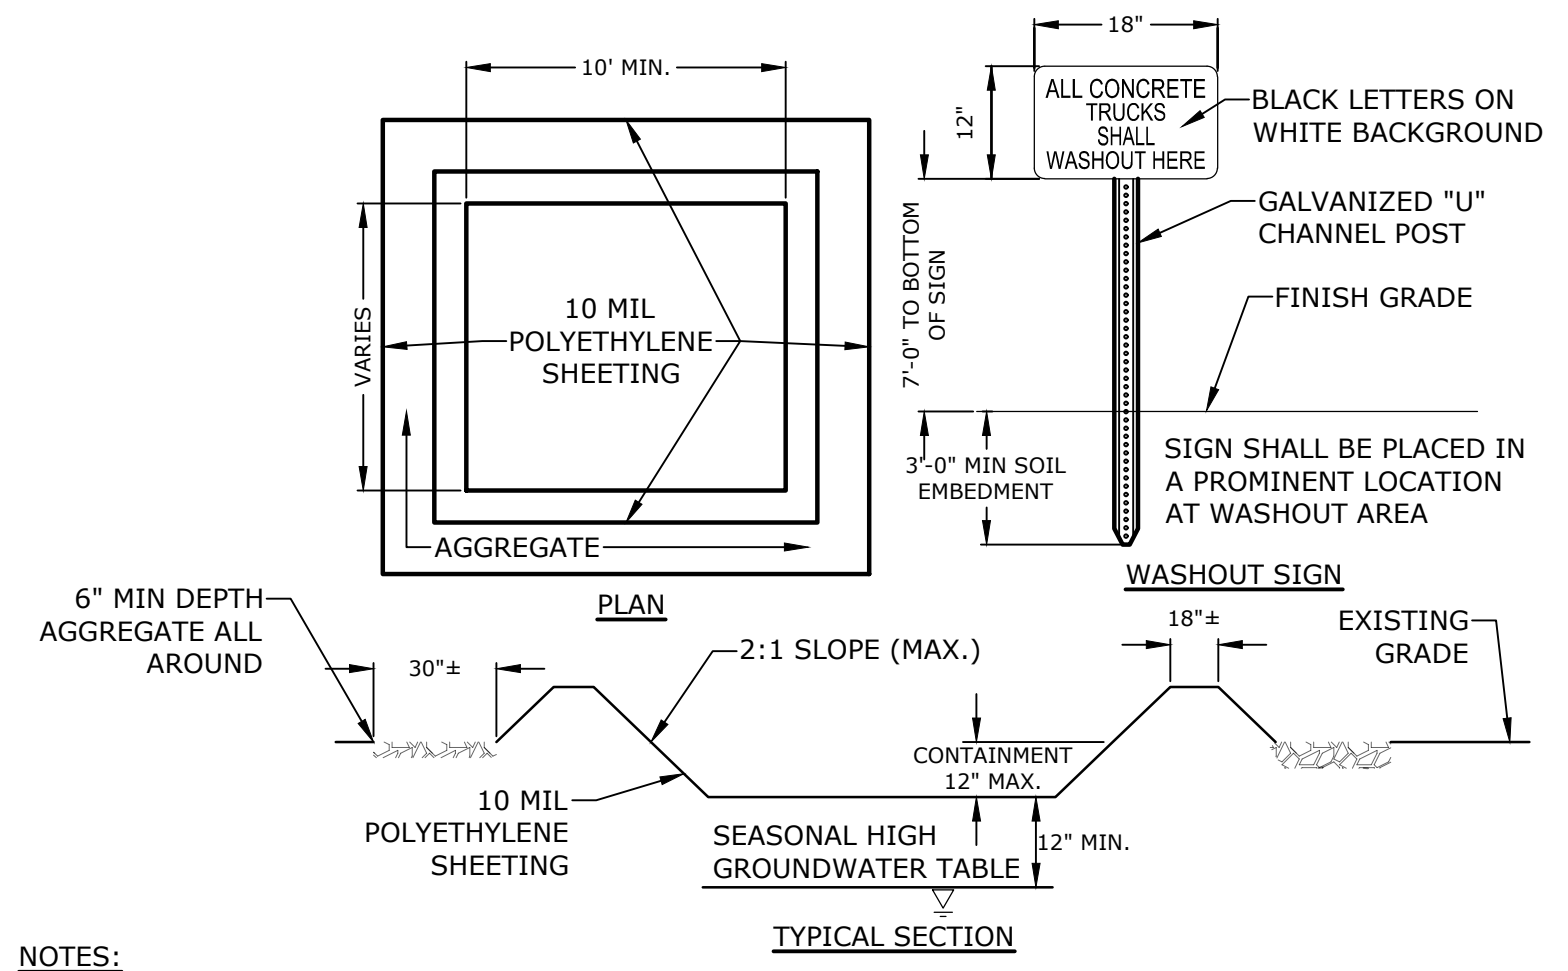


- NOTES:
- CONTAINMENT MUST BE STRUCTURALLY SOUND AND LEAK FREE AND CONTAIN ALL LIQUID WASTES.
 - CONTAINMENT DEVICES MUST BE OF SUFFICIENT QUANTITY OR VOLUME TO COMPLETELY CONTAIN THE LIQUID WASTES GENERATED.
 - WASHOUT MUST BE CLEANED OR NEW FACILITIES CONSTRUCTED AND READY TO USE ONCE WASHOUT IS 75% FULL.
 - WASHOUT AREA(S) SHALL BE INSTALLED IN A LOCATION EASILY ACCESSIBLE BY CONCRETE TRUCKS.
 - ONE OR MORE AREAS MAY BE INSTALLED ON THE CONSTRUCTION SITE AND MAY BE RELOCATED AS CONSTRUCTION PROGRESSES.
 - AT LEAST WEEKLY REMOVE ACCUMULATION OF SAND AND AGGREGATE AND DISPOSE OF PROPERLY.

CONCRETE WASHOUT AREA
NO SCALE

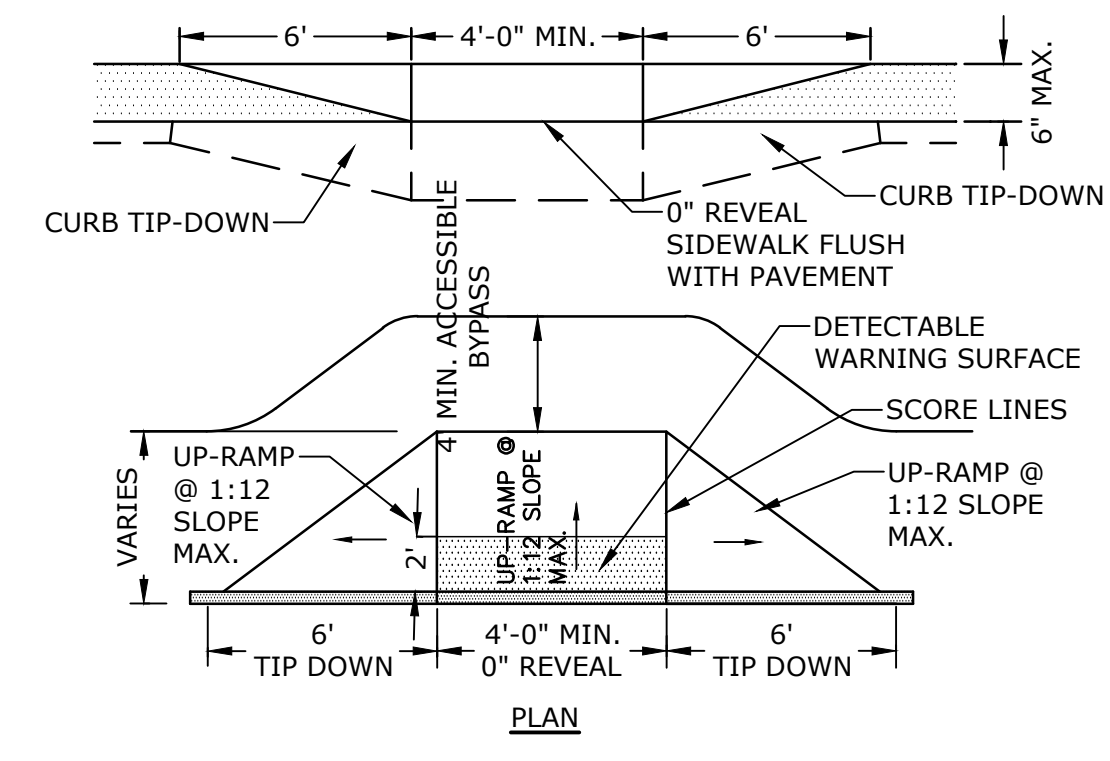


- NOTES:
- RAMPS SHALL BE CONSTRUCTED IN ACCORDANCE WITH THE AMERICANS WITH DISABILITIES ACT AND LOCAL AND STATE REQUIREMENTS.
 - PROVIDE 6" COMPACTED CRUSHED GRAVEL BASE BENEATH RAMPS.
 - DETECTABLE WARNING STRIP SHALL BE ADA SOLUTIONS, INC. CAST IN PLACE RAMP. INSTALL PER MANUFACTURER'S RECOMMENDATIONS.

CONCRETE WHEELCHAIR ACCESSIBLE RAMP
NO SCALE

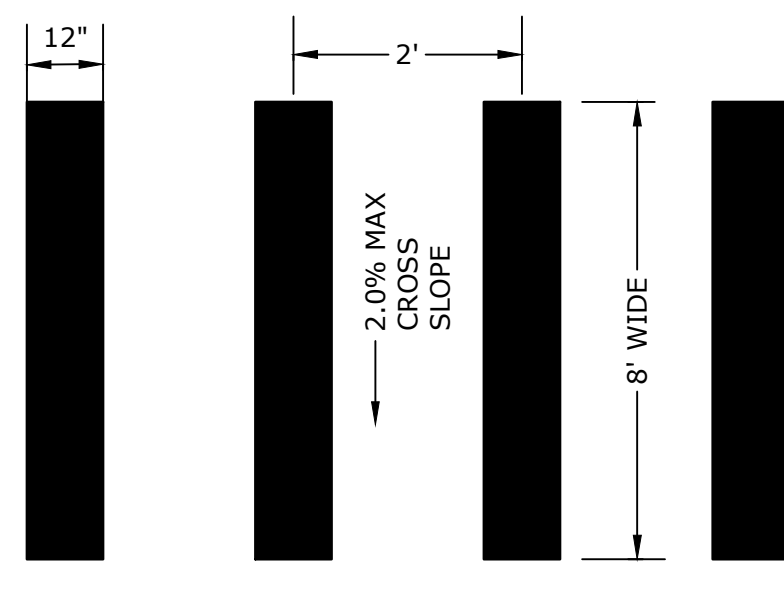


- NOTE:
- STRIPING SHALL BE CONSTRUCTED USING WHITE THERMO PLASTIC, REFLECTORIZED PAVEMENT MARKING MATERIAL MEETING THE REQUIREMENTS OF ASTM D 4505

CROSSWALK STRIPING
NO SCALE

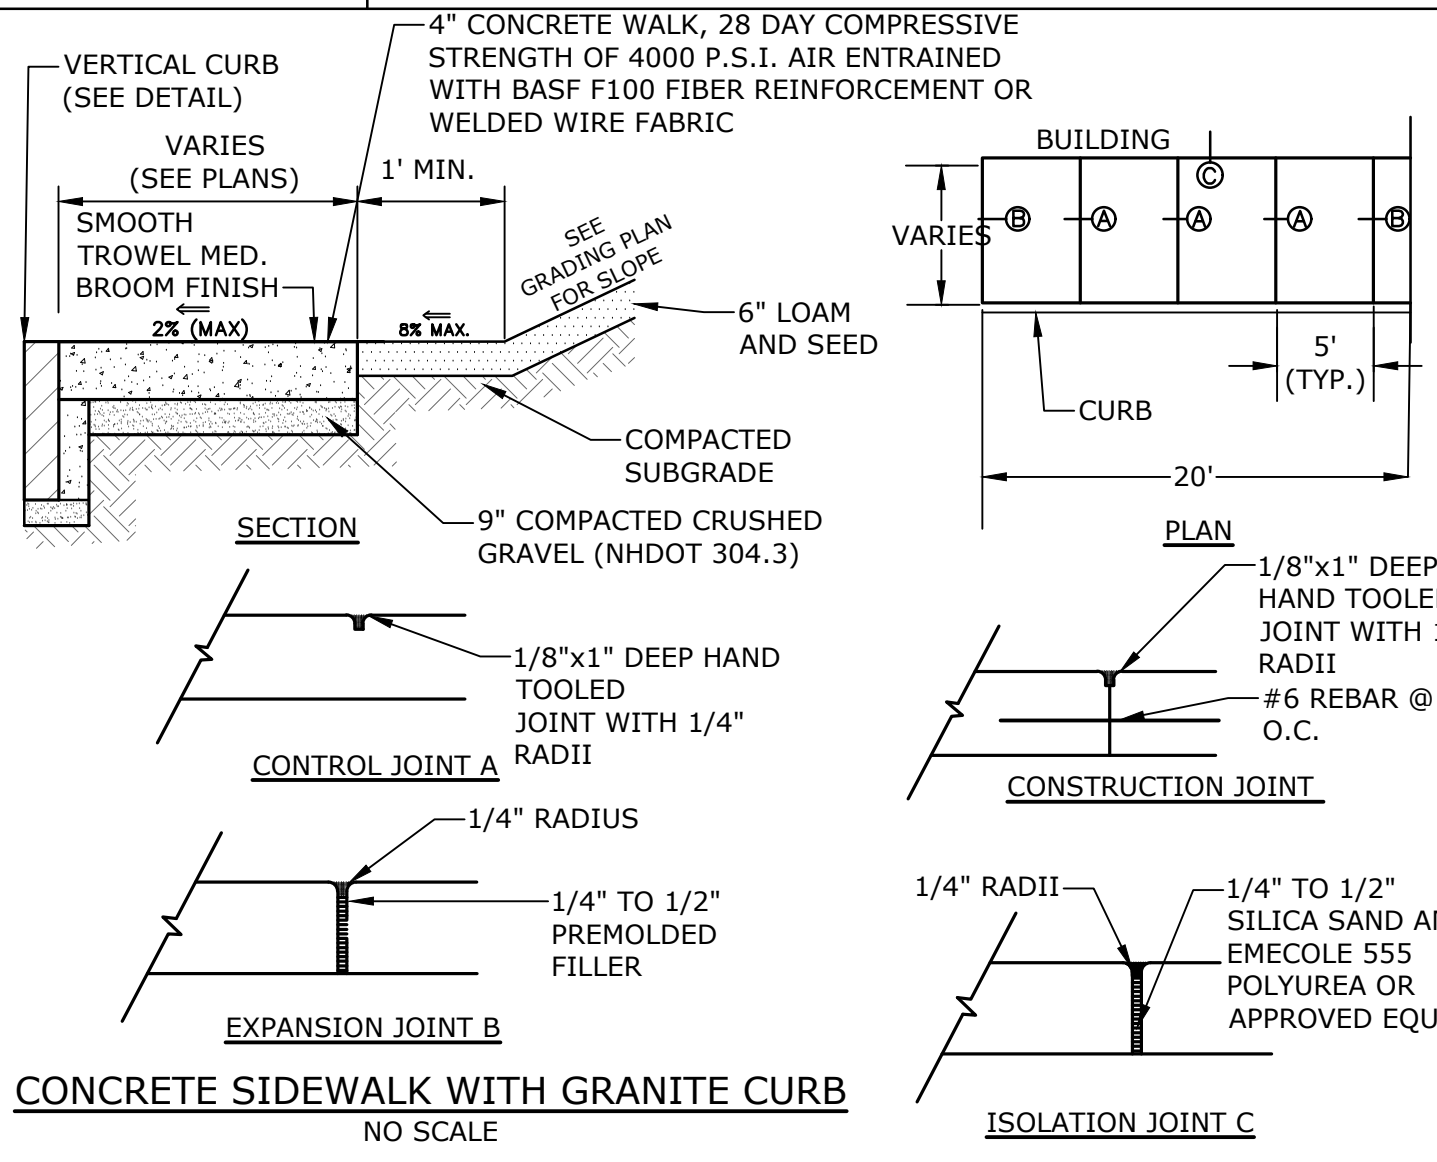

CONCRETE SIDEWALK WITH GRANITE CURB
NO SCALE

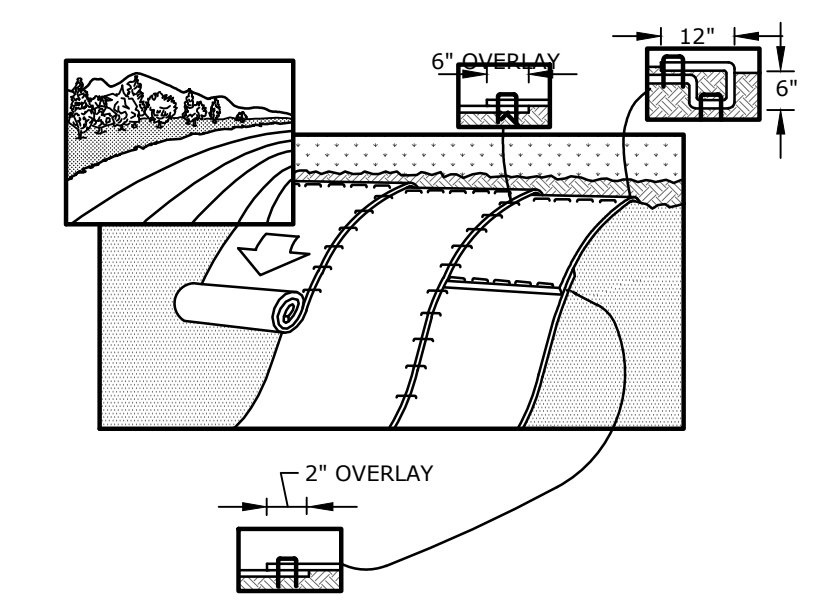

- NOTES:
- EROSION CONTROL BLANKET SHALL BE AN ALL NATURAL PRODUCT WITH NO PHOTO DEGRADABLE COMPONENTS, NORTH AMERICAN GREEN SC150BN OR APPROVED EQUAL.
 - STAKES SHALL BE BIODEGRADABLE BIOSTAKES OR ALL NATURAL WOOD ECOSTAKES OR APPROVED EQUAL. THE LENGTH OF STAKES SHALL BE BASED OFF OF THE MANUFACTURERS RECOMMENDATION.
 - PREPARE SOIL BEFORE INSTALLING BLANKETS, INCLUDING ANY NECESSARY APPLICATION OF LIME, COMPOST AND SEED.
 - INSTALL PER MANUFACTURER'S WRITTEN INSTRUCTION.

EROSION CONTROL BLANKET
NO SCALE

Proposed Industrial Development

Lonza Biologics

Portsmouth, New Hampshire

MARK	DATE	DESCRIPTION
N	11/9/2023	Revised P.B. Submission
M	9/27/2023	P.B. Submission
L	9/1/2022	Issued for Construction
K	5/27/2022	Issued for Bid
J	5/23/2022	Third Party Rev. Comments
I	4/26/2022	Revised PB Stipulations












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DATE:	04/03/2018
FILE:	L-0700-026-C-DTLS.dwg
DRAWN BY:	CHK
CHECKED:	NAH
APPROVED:	PMC

DETAILS SHEET

SCALE: AS SHOWN

C-502

Last Save Date: November 8, 2023 6:59 PM By: HANSEN
 Plot Date: Thursday, November 09, 2023 Plotted By: Neil A. Hansen
 File Location: J:\L-0700-Lonza Biologics Expansion.was 12/26/2026 Project AbstracteDrawingsAutoCADv...-0700-026-C-DTLS.dwg Layout: Tab: C-502

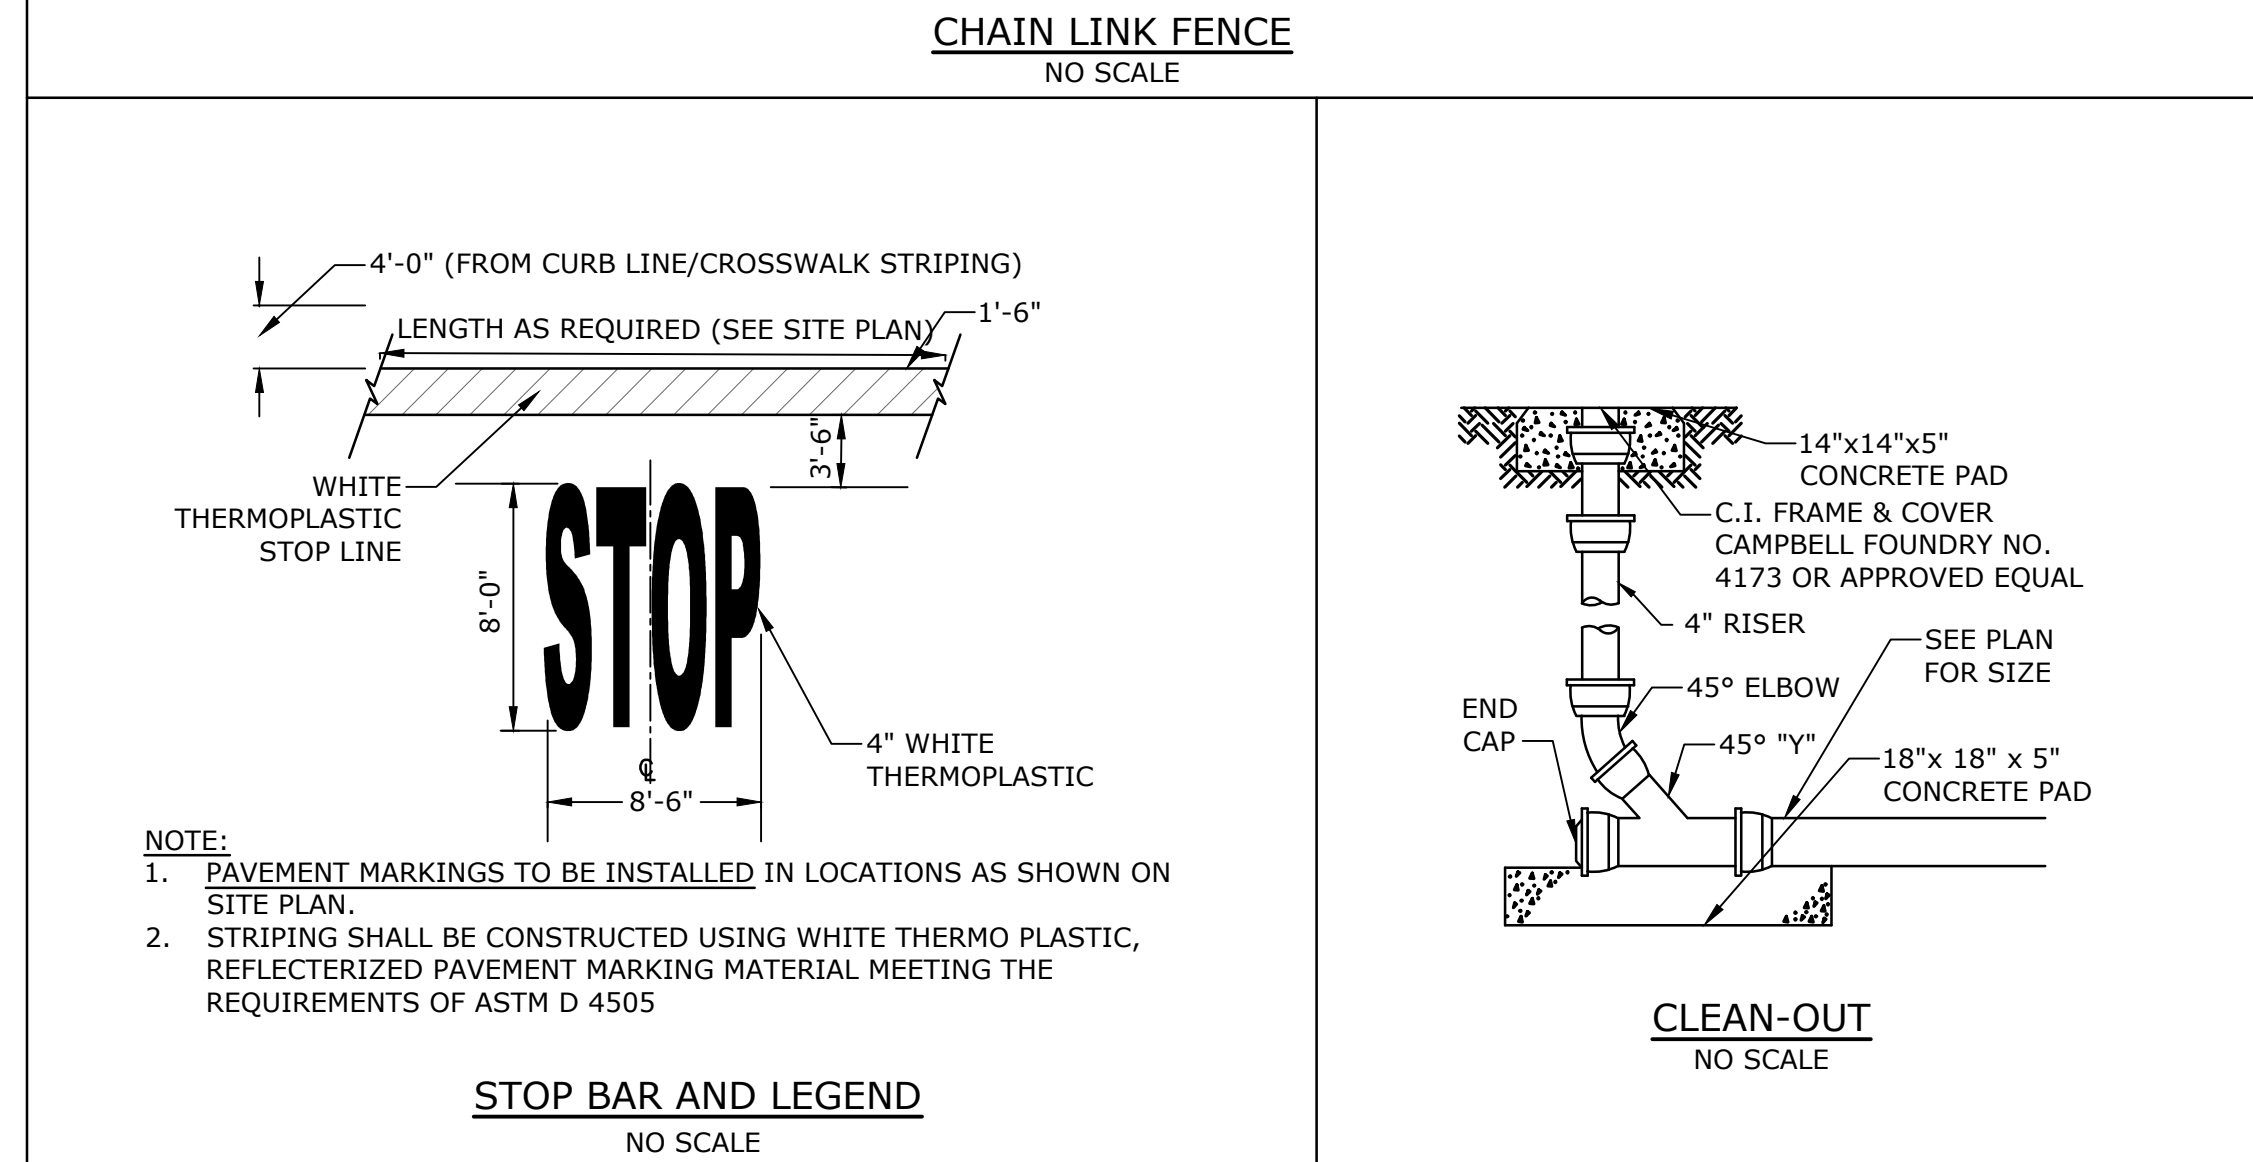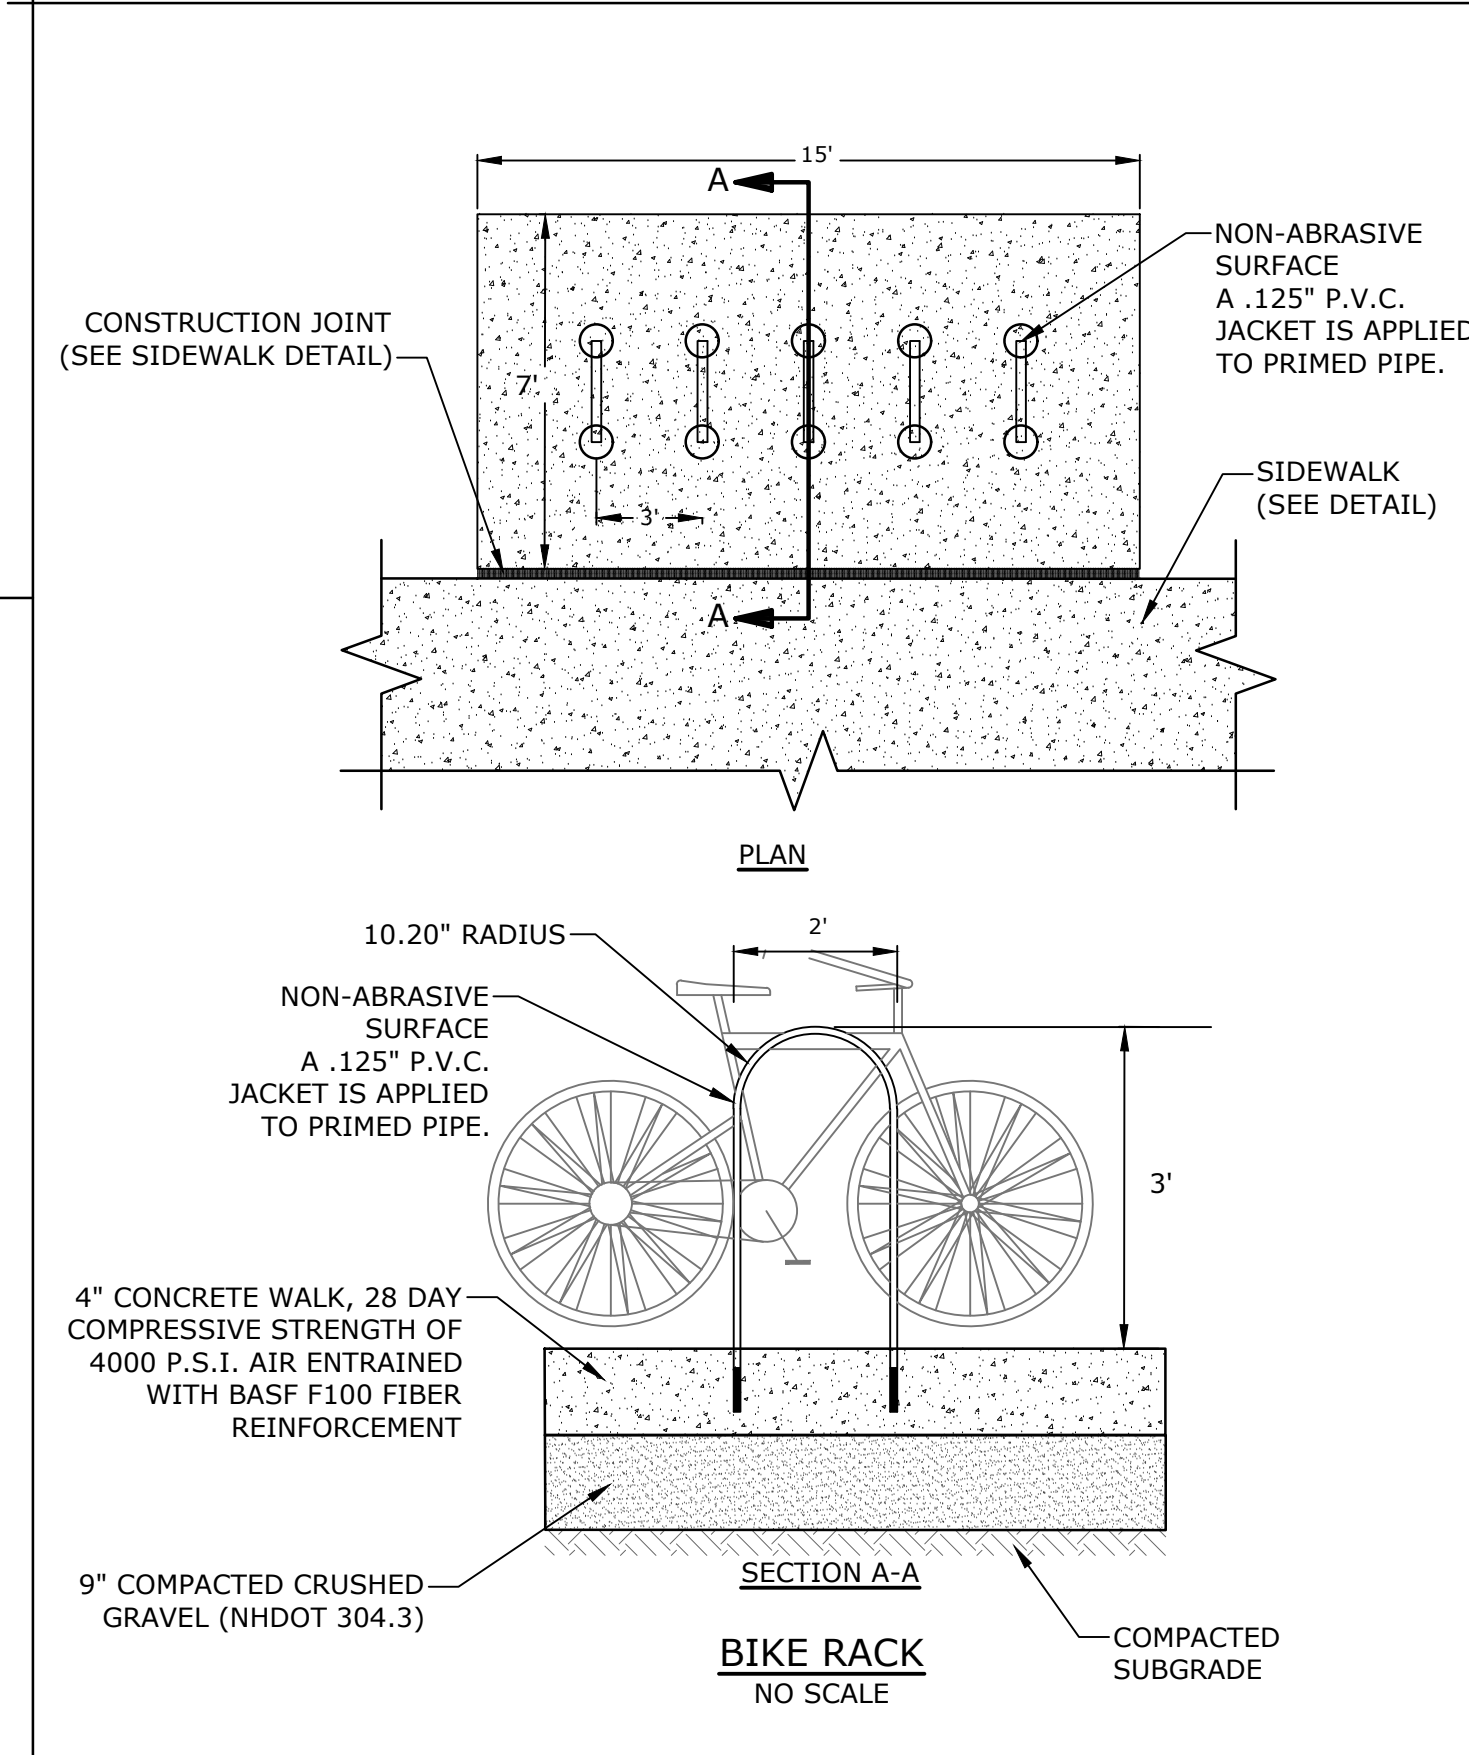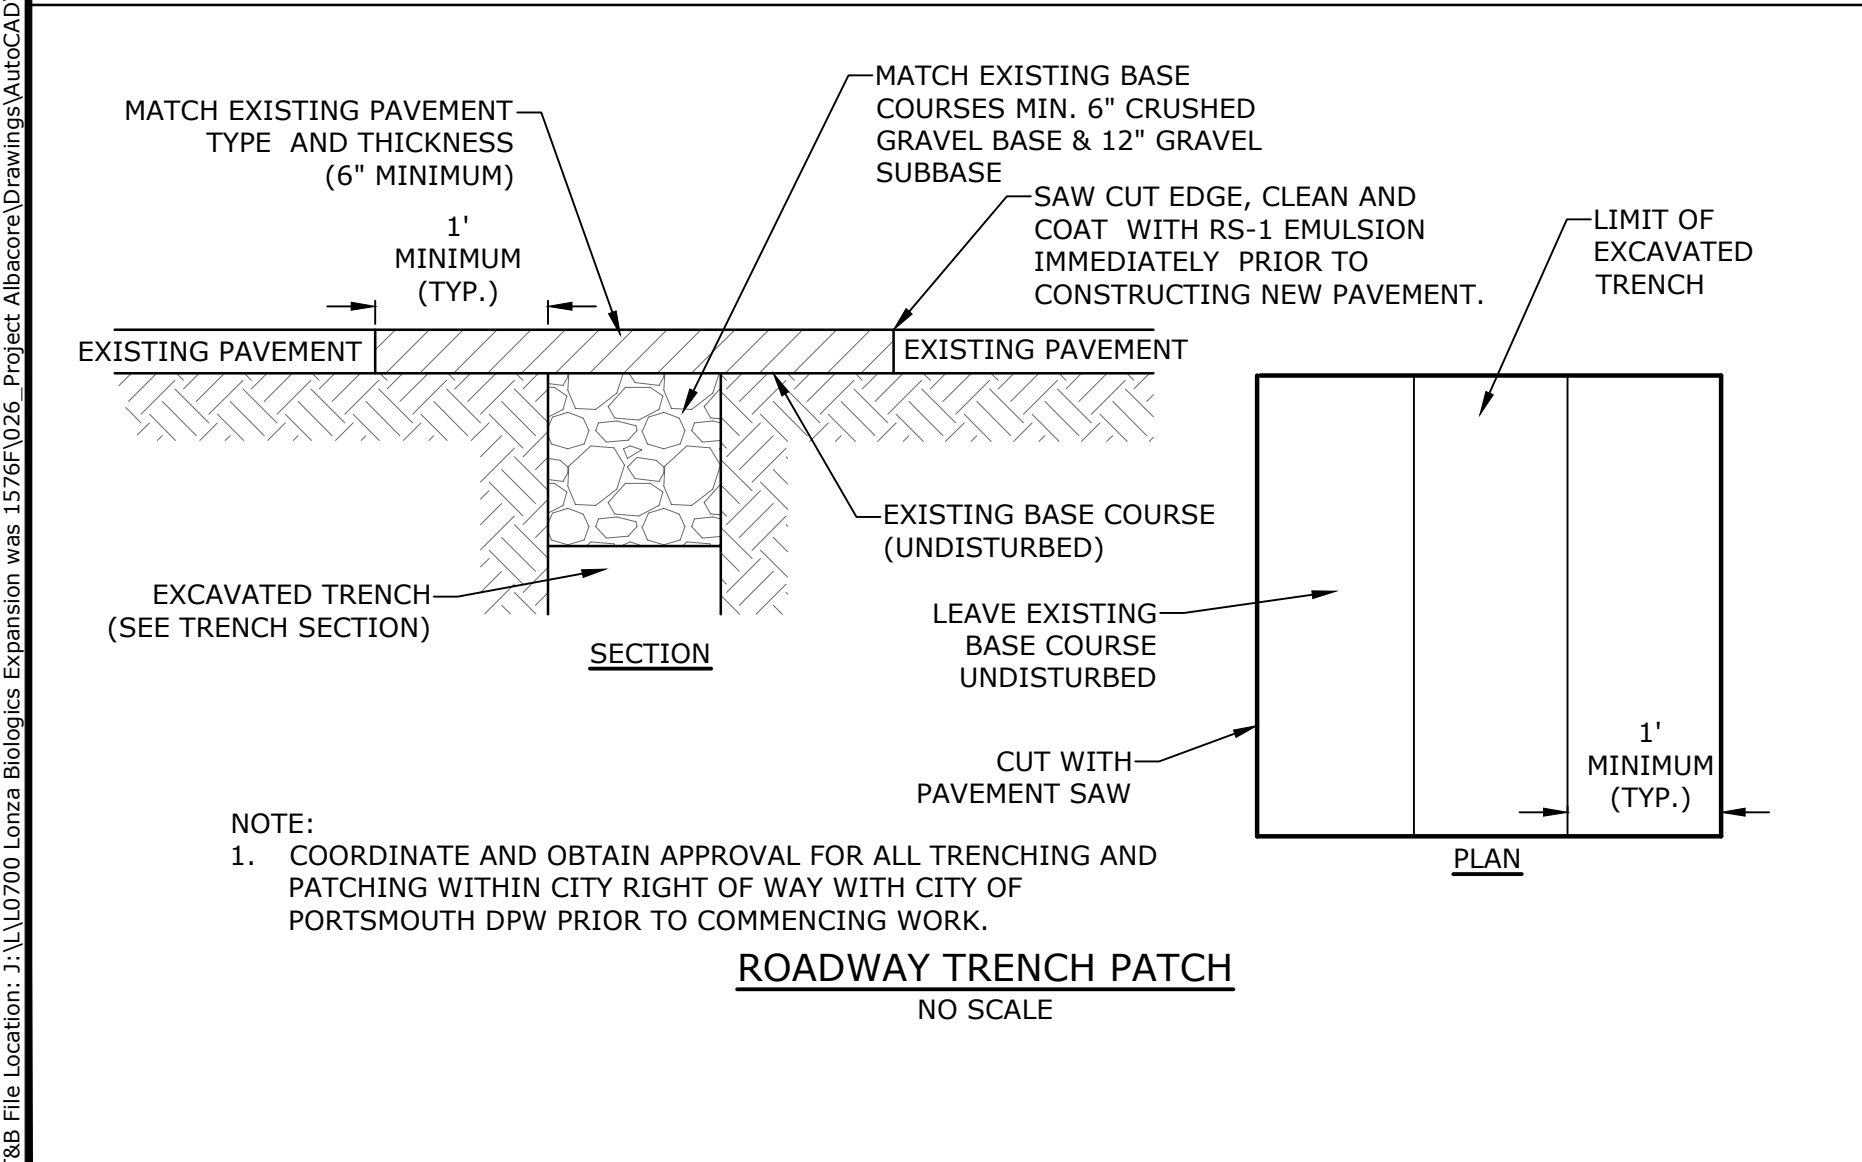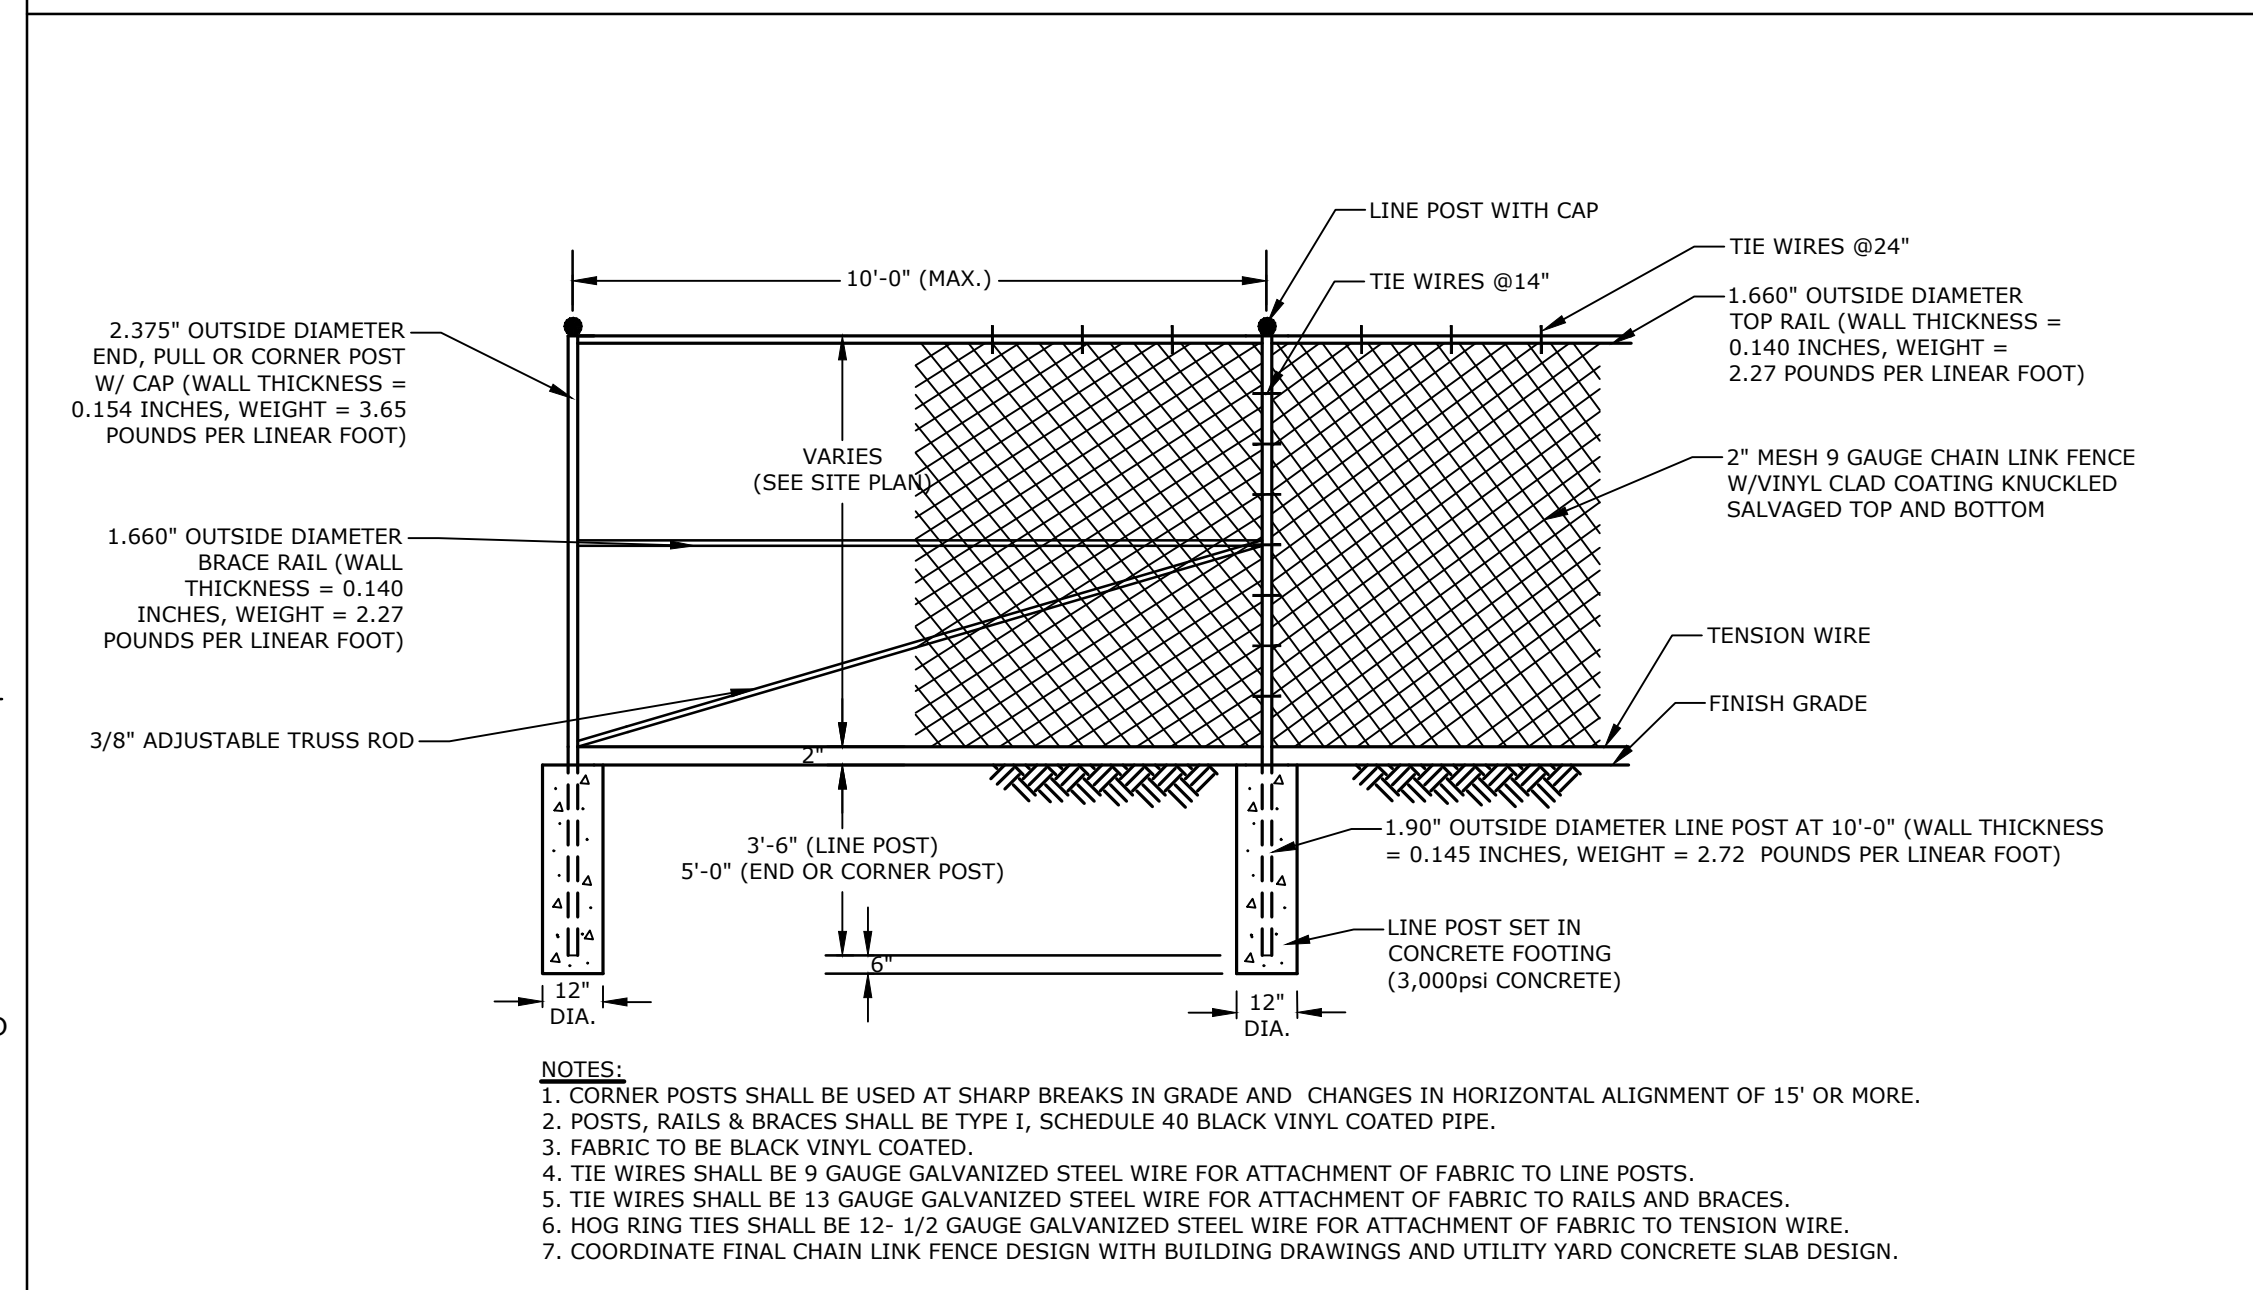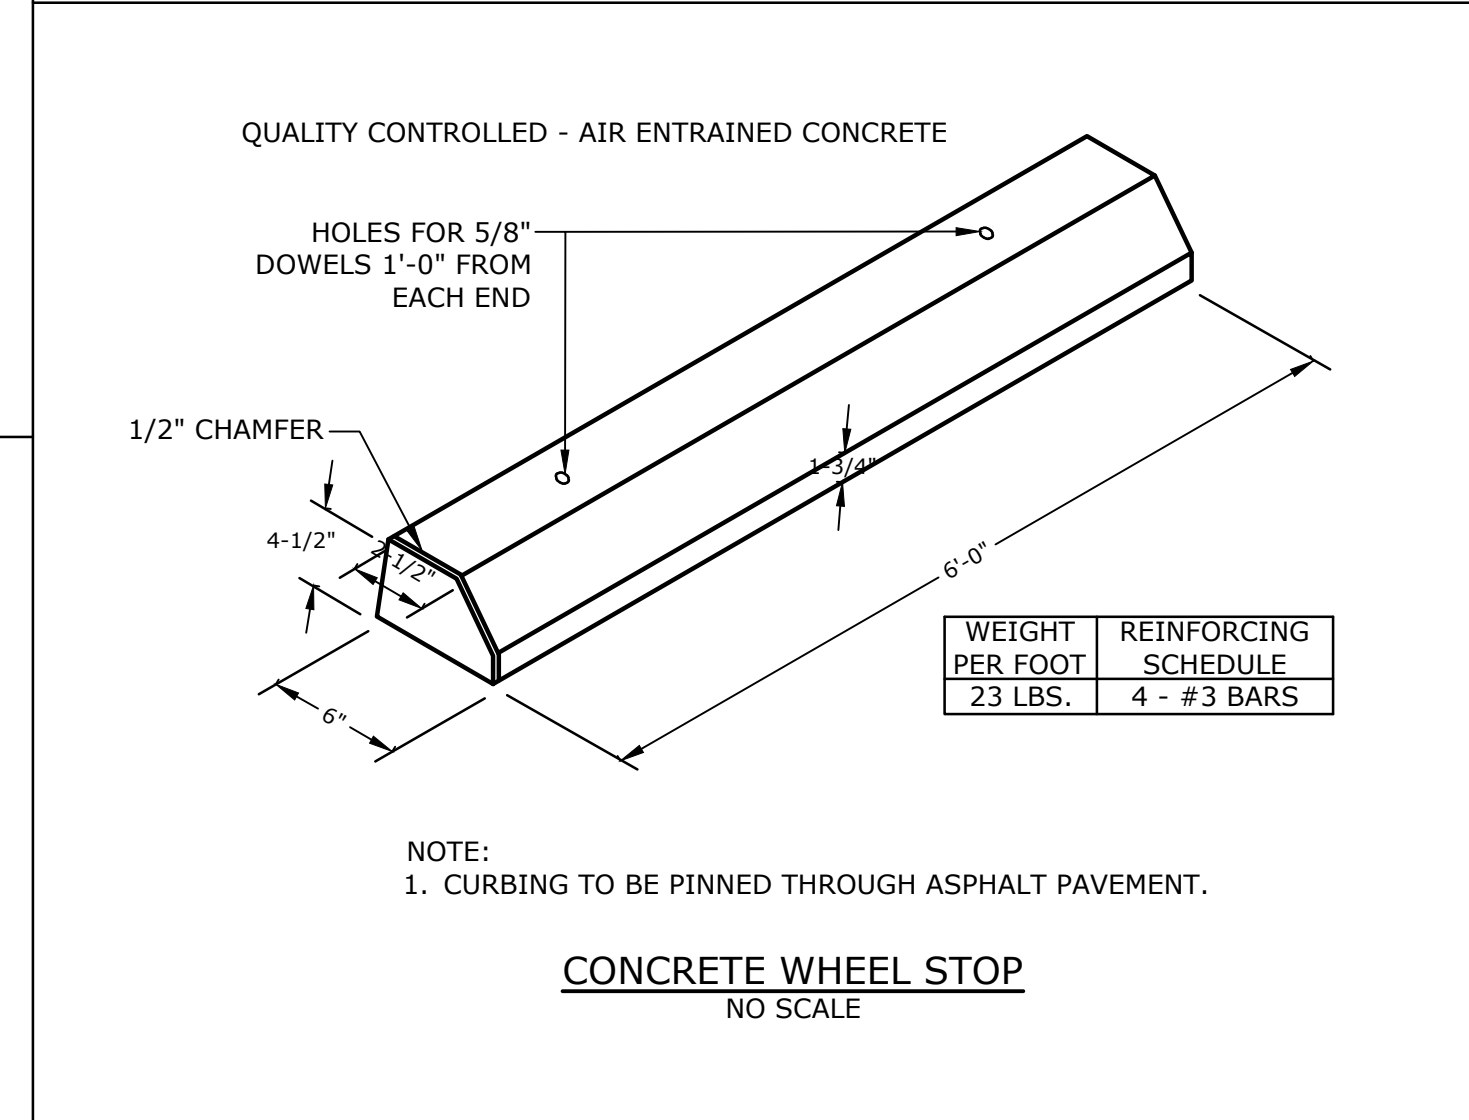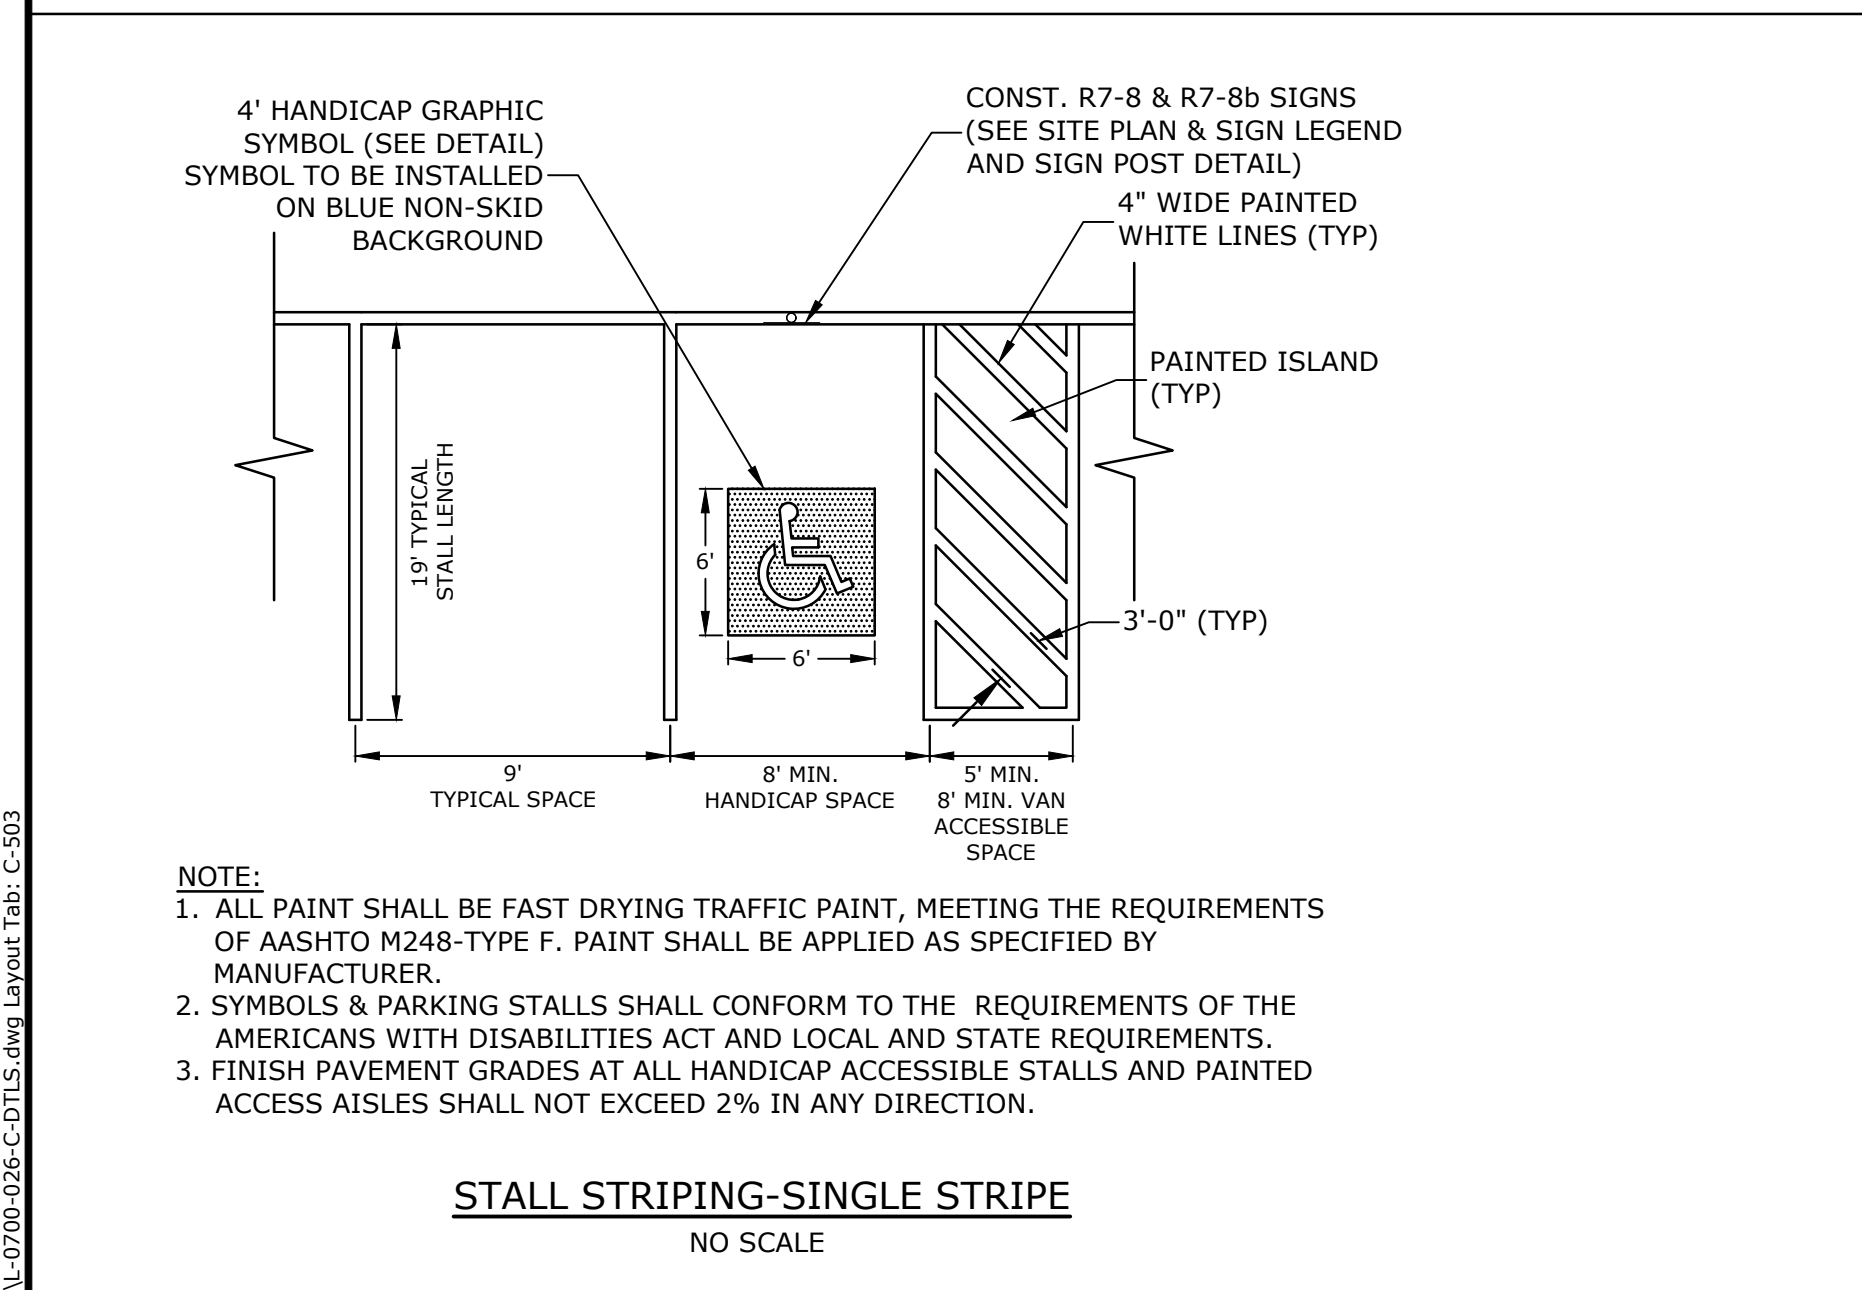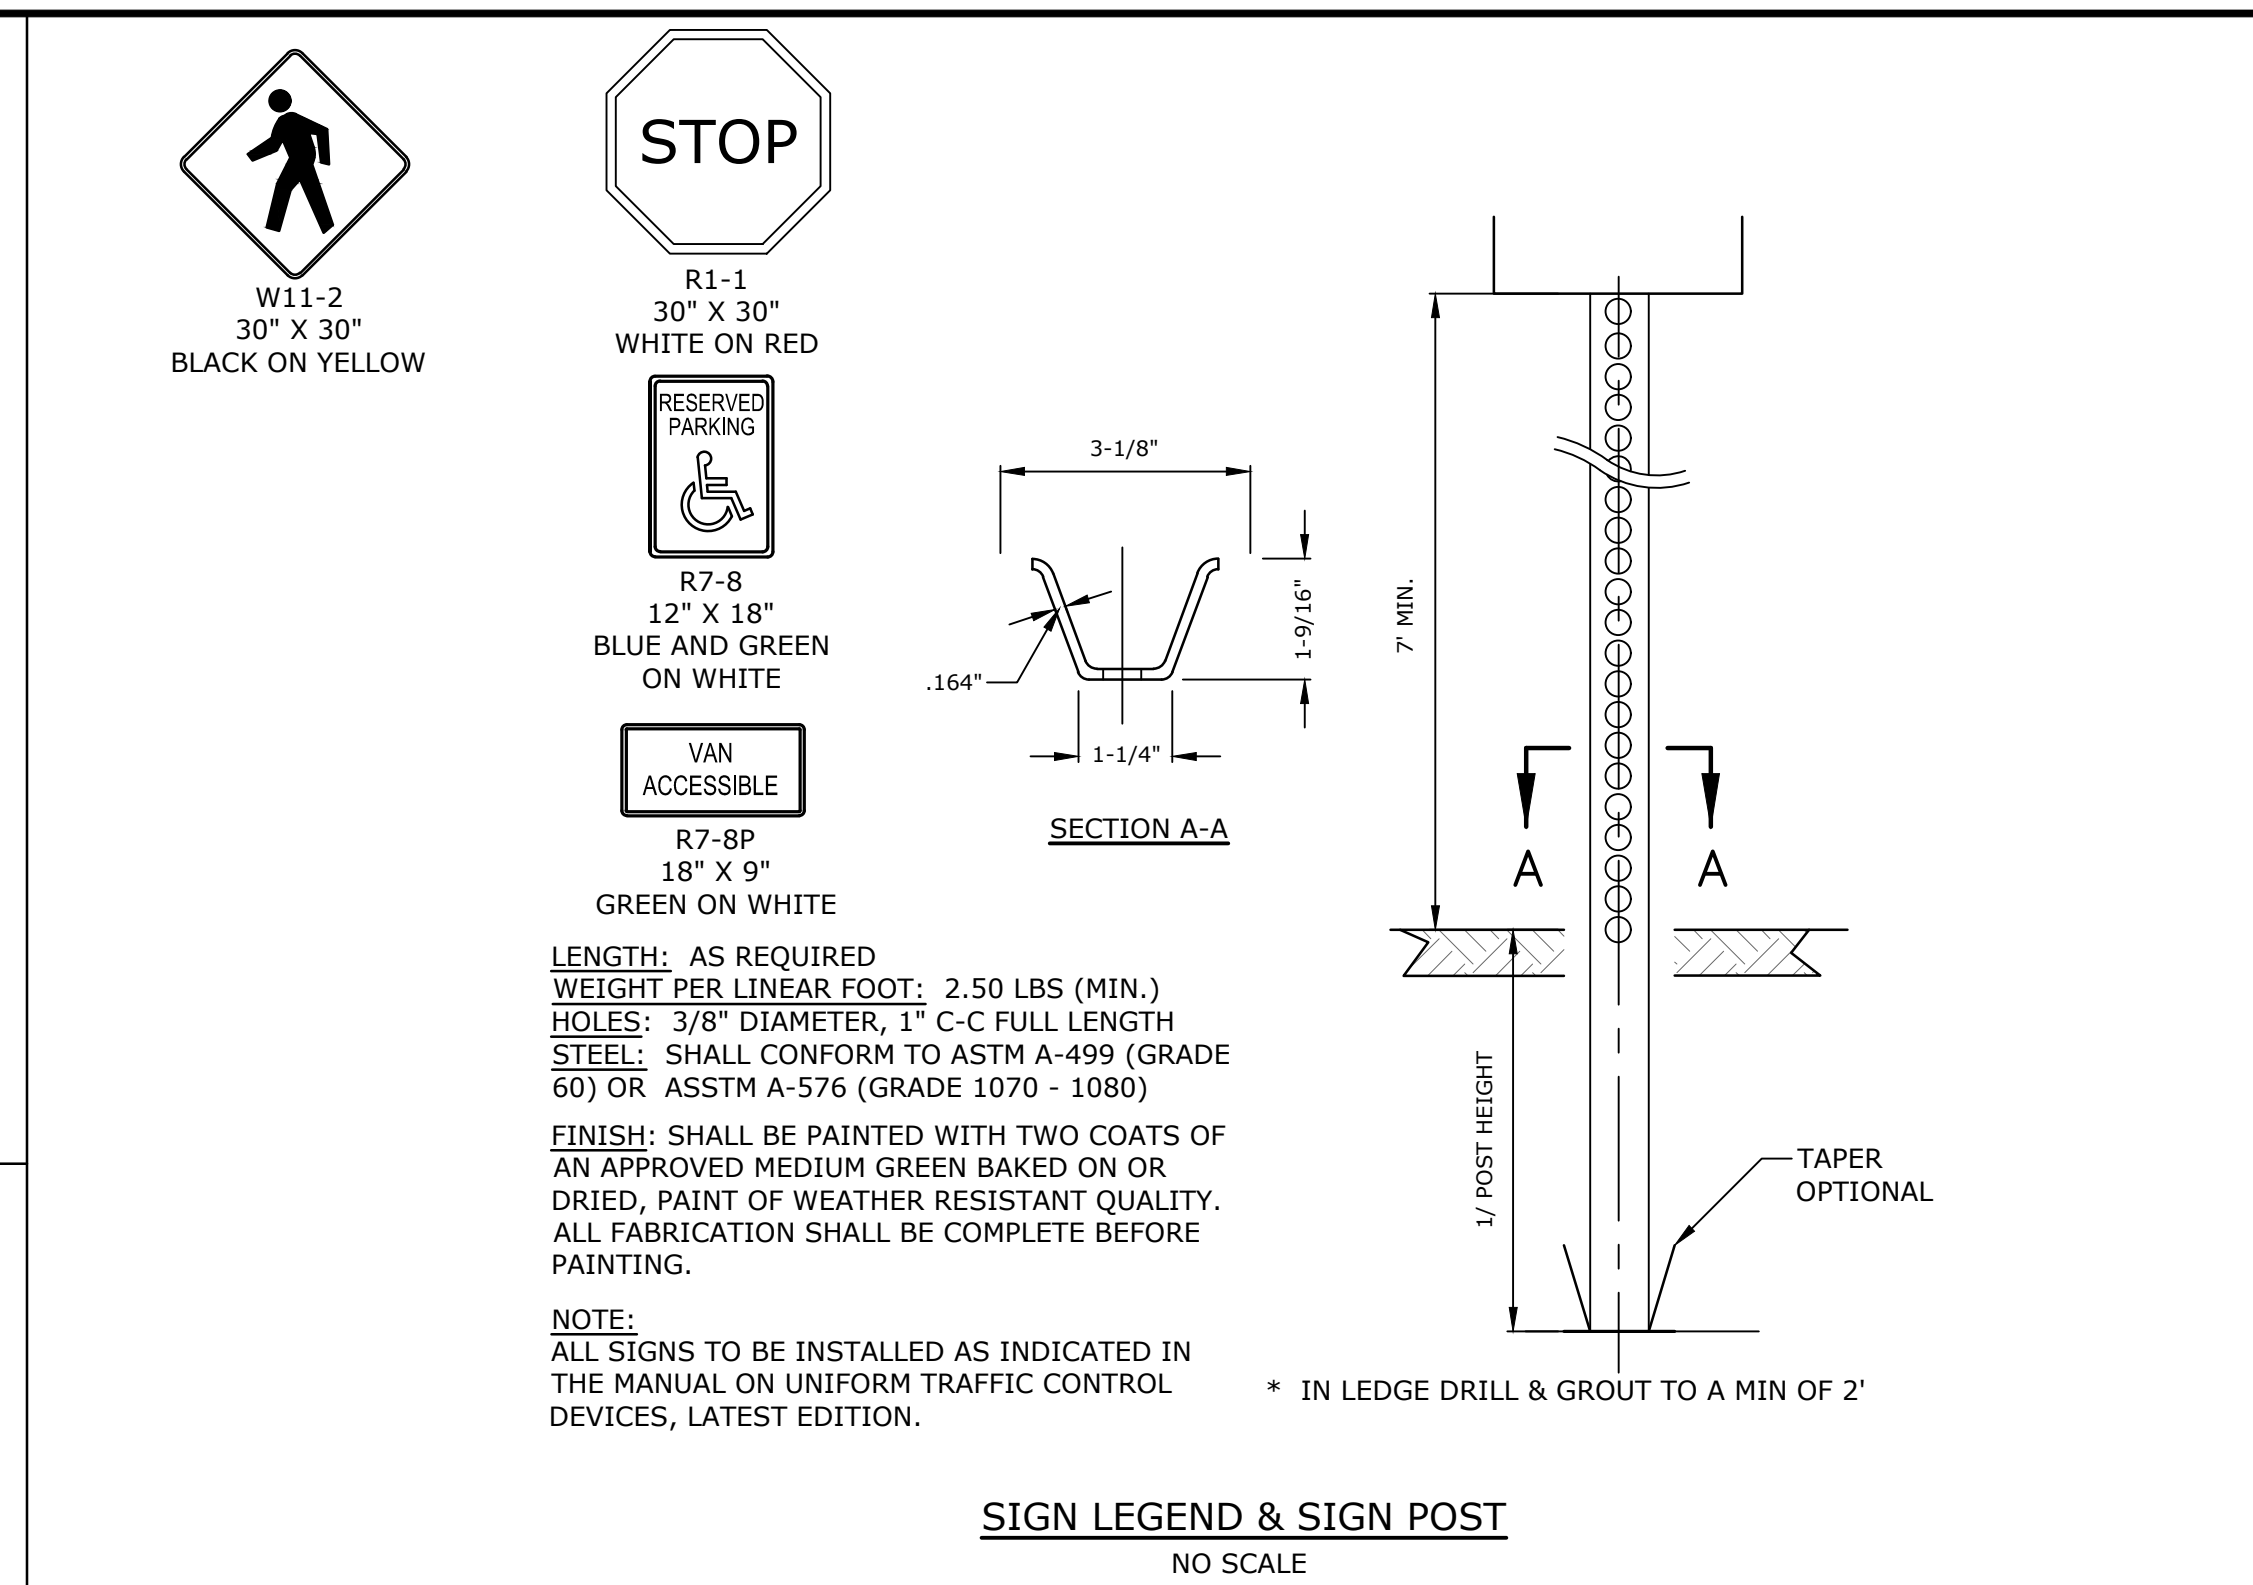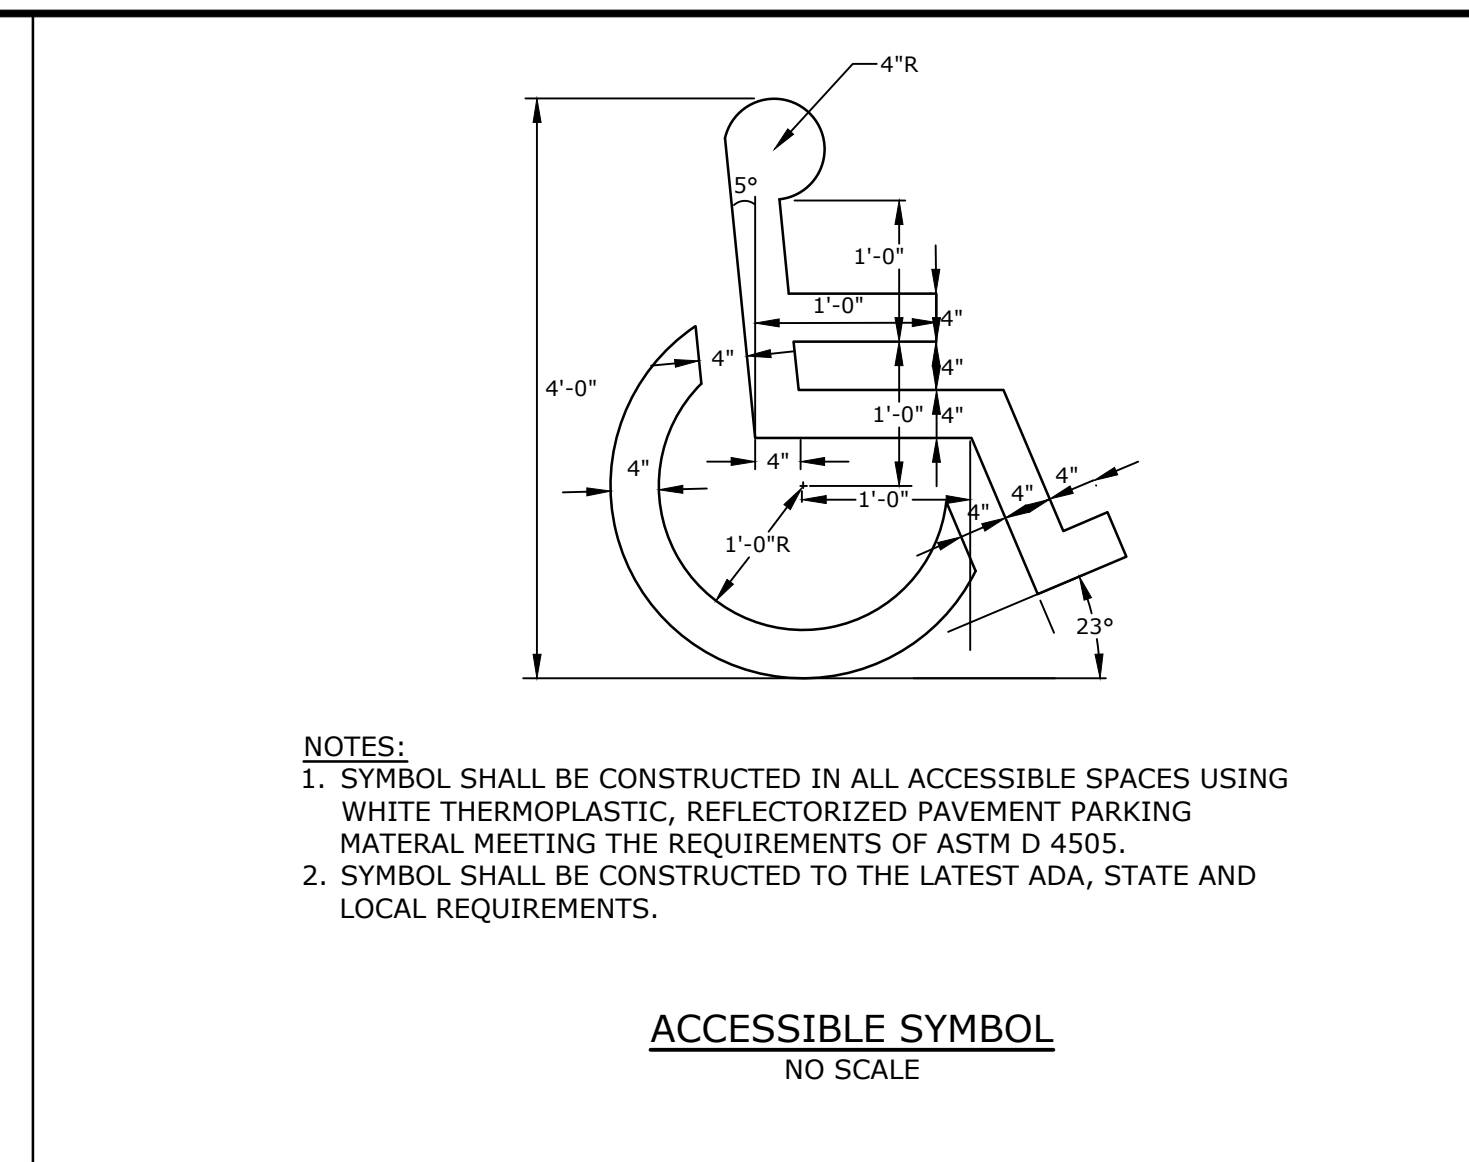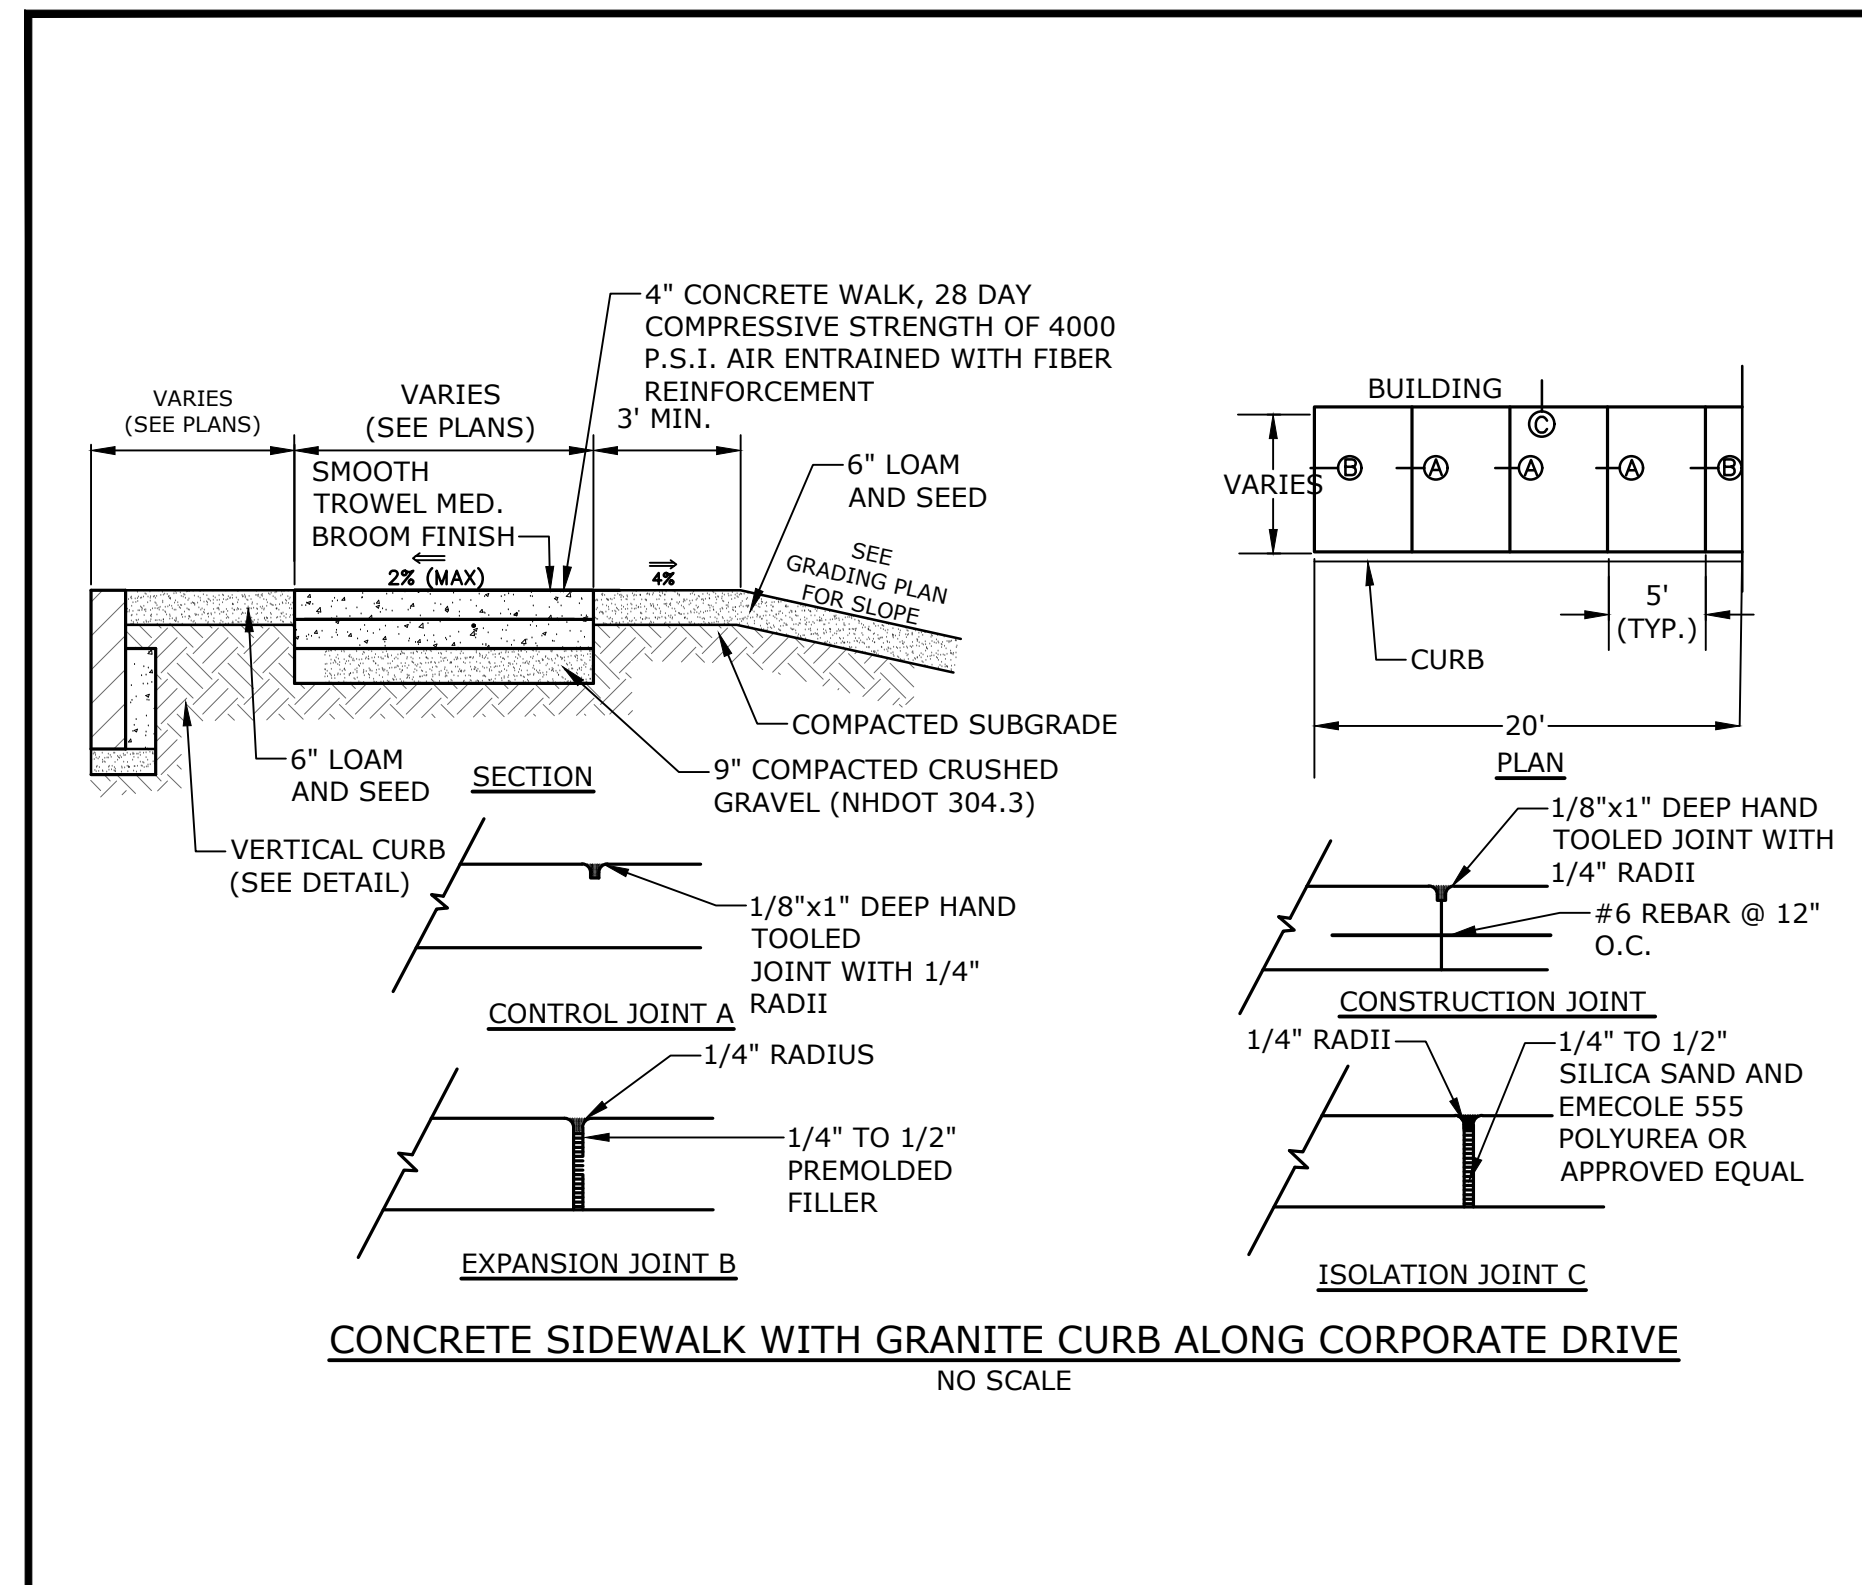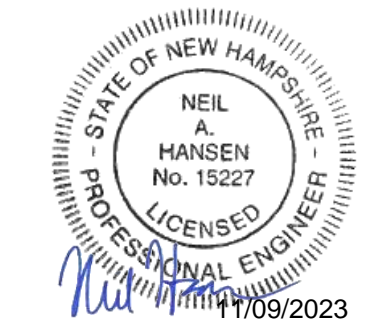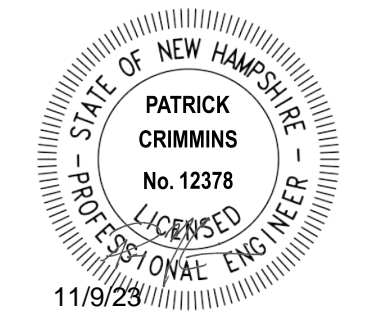

Proposed Industrial Development

Lonza Biologics

Portsmouth, New Hampshire


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MARK	DATE	DESCRIPTION
PROJECT NO:		L-0700-013
DATE:		04/03/2018
FILE: L-0700-026-C-DTLS.dwg		
DRAWN BY:		CJK
CHECKED:		NAH
APPROVED:		PMC

DETAILS SHEET

SCALE: AS SHOWN



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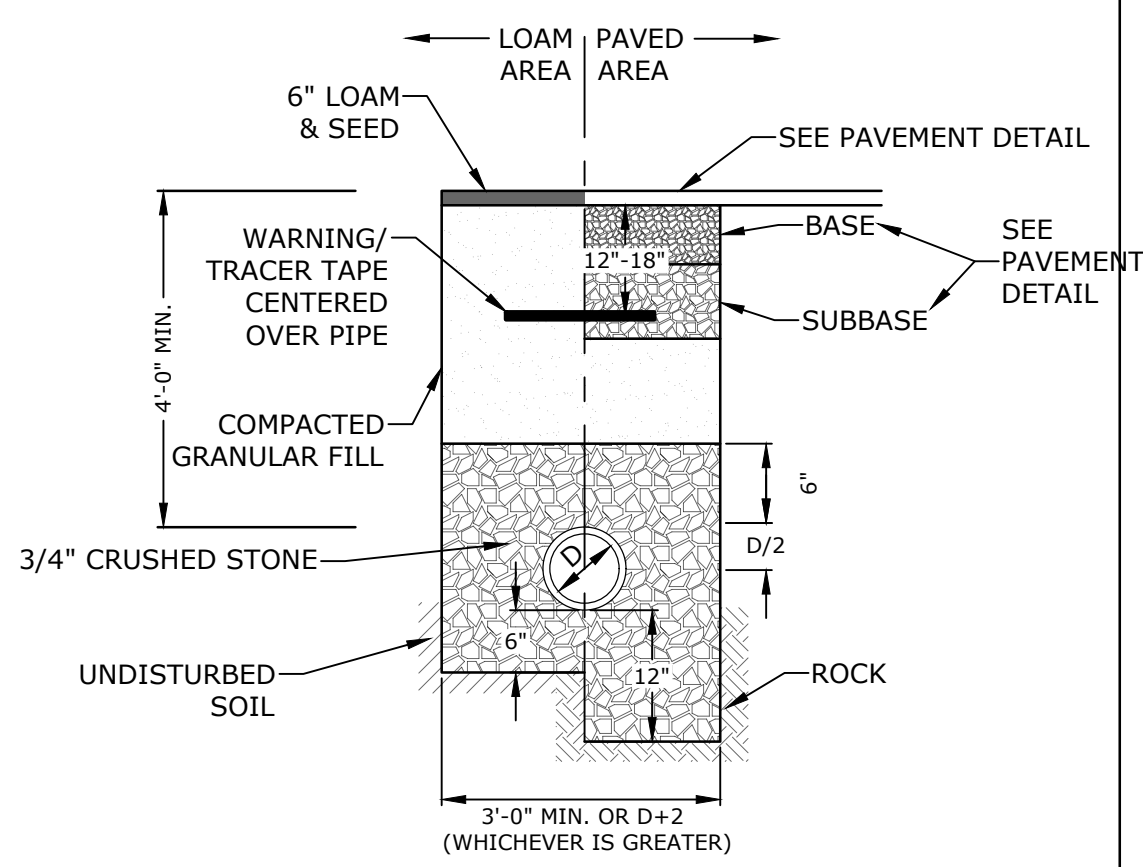


BERM STONE SIZE	
SIEVE DESIGNATION (US CUSTOMARY)	PERCENT BY WEIGHT PASSING SQUARE MESH SIEVES
12 IN	100
6 IN	84-100
3 IN	68-83
1 IN	42-55
NO. 4	8-12

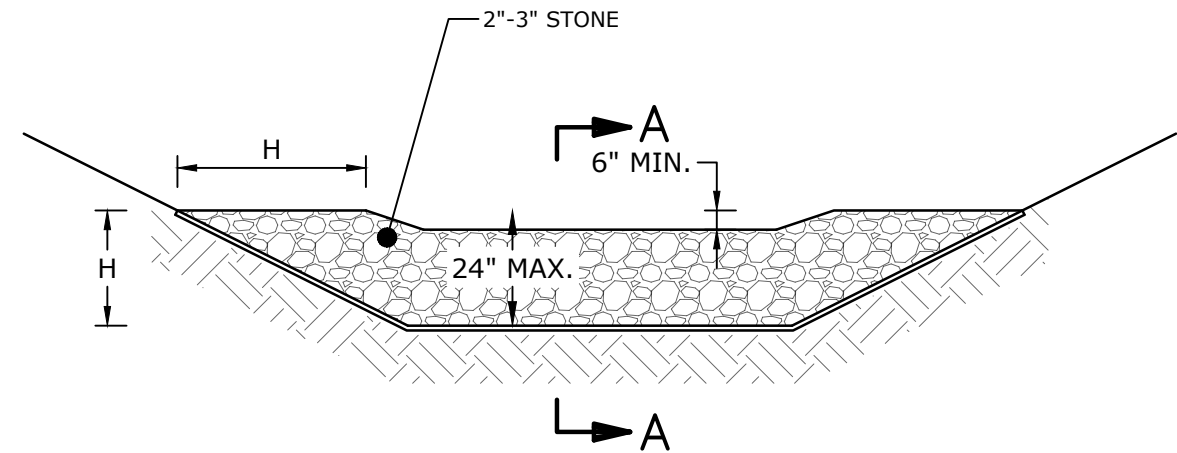- NOTES:
- CHECK DAMS SHOULD BE INSTALLED BEFORE RUNOFF IS DIRECTED TO THE SWALE OR DRAINAGE DITCH.
 - THE MAXIMUM CONTRIBUTING DRAINAGE AREA TO THE DAM SHOULD BE LESS THAN ONE ACRE.
 - THE CHECK DAM SHOULD NOT BE USED IN A FLOWING STREAM.
 - CHECK DAMS SHOWN ON THE DRAWINGS SHALL BE LEFT IN PLACE PERMANENTLY.
 - CHECK DAMS INSTALLED AS PART OF TEMPORARY EROSION CONTROL MEASURE SHALL BE REMOVED ONCE THE SWALE OR DITCH HAS BEEN STABILIZED:
 - IN TEMPORARY DITCHES AND SWALES, CHECK DAMS SHOULD BE REMOVED AND THE DITCH FILLED IN WHEN IT IS NO LONGER NEEDED.
 - IN PERMANENT STRUCTURES, CHECK DAMS SHOULD BE REMOVED WHEN PERMANENT LINING HAS BEEN ESTABLISHED. IF THE PERMANENT LINING IS VEGETATION, THEN THE CHECK DAM SHOULD BE RETAINED UNTIL THE GRASS HAS MATURED TO PROTECT THE DITCH OR SWALE. THE AREA BENEATH THE CHECK DAM MUST BE SEEDED AND MULCHED IMMEDIATELY AFTER REMOVAL.




STONE CHECK DAM NO SCALE

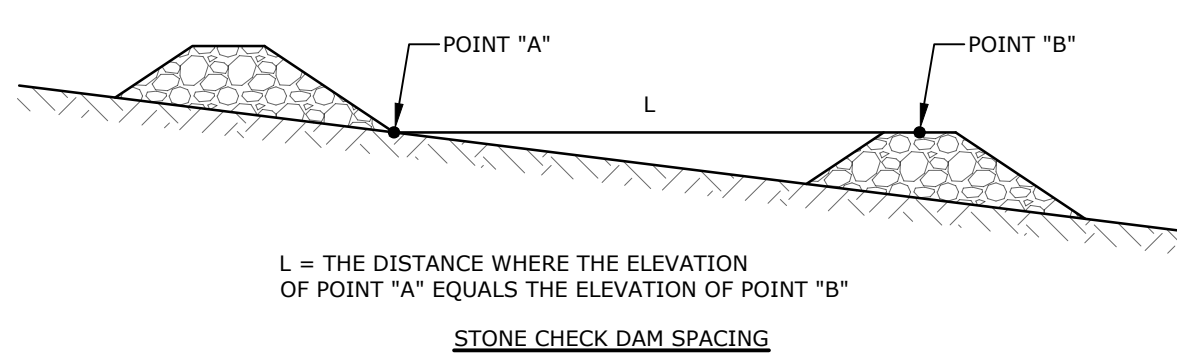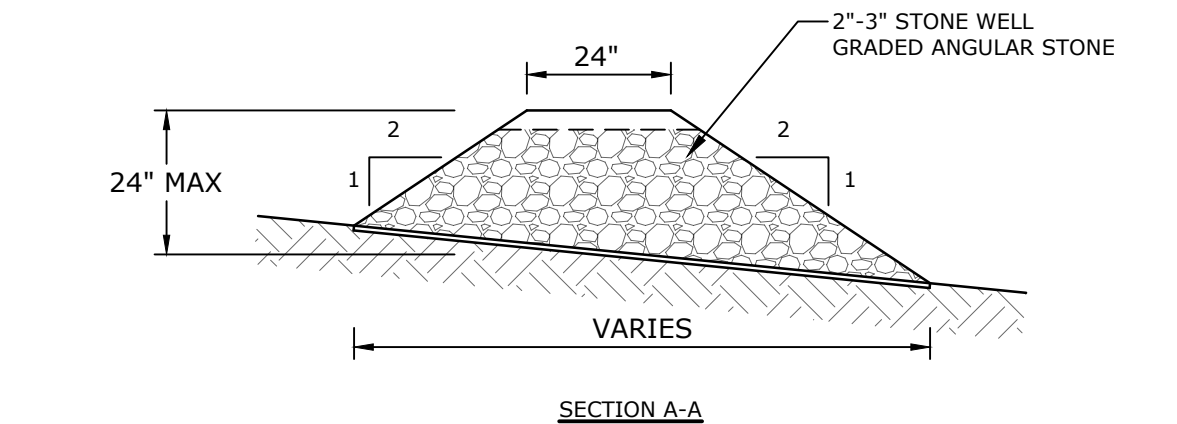


- NOTE:
- CRUSHED STONE BEDDING AND BACKFILL FOR FULL WIDTH OF THE TRENCH FROM 6" BELOW PIPE IN EARTH AND 12" BELOW PIPE IN ROCK UP TO 6" ABOVE TOP OF PIPE.
 - ALL UTILITIES SHALL BE INSTALLED PER THE INDIVIDUAL UTILITY COMPANY STANDARDS. COORDINATE ALL INSTALLATIONS WITH INDIVIDUAL UTILITY COMPANIES AND THE CITY OF PORTSMOUTH.

STORM DRAIN TRENCH NO SCALE

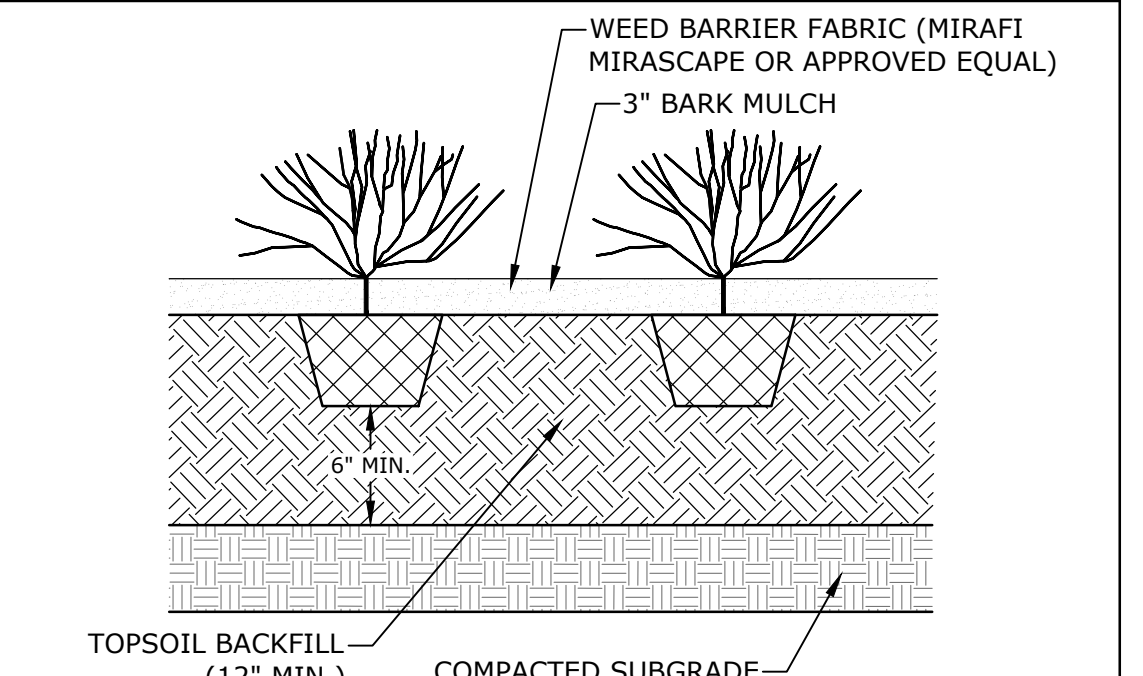


PERENNIAL PLANTING NO SCALE

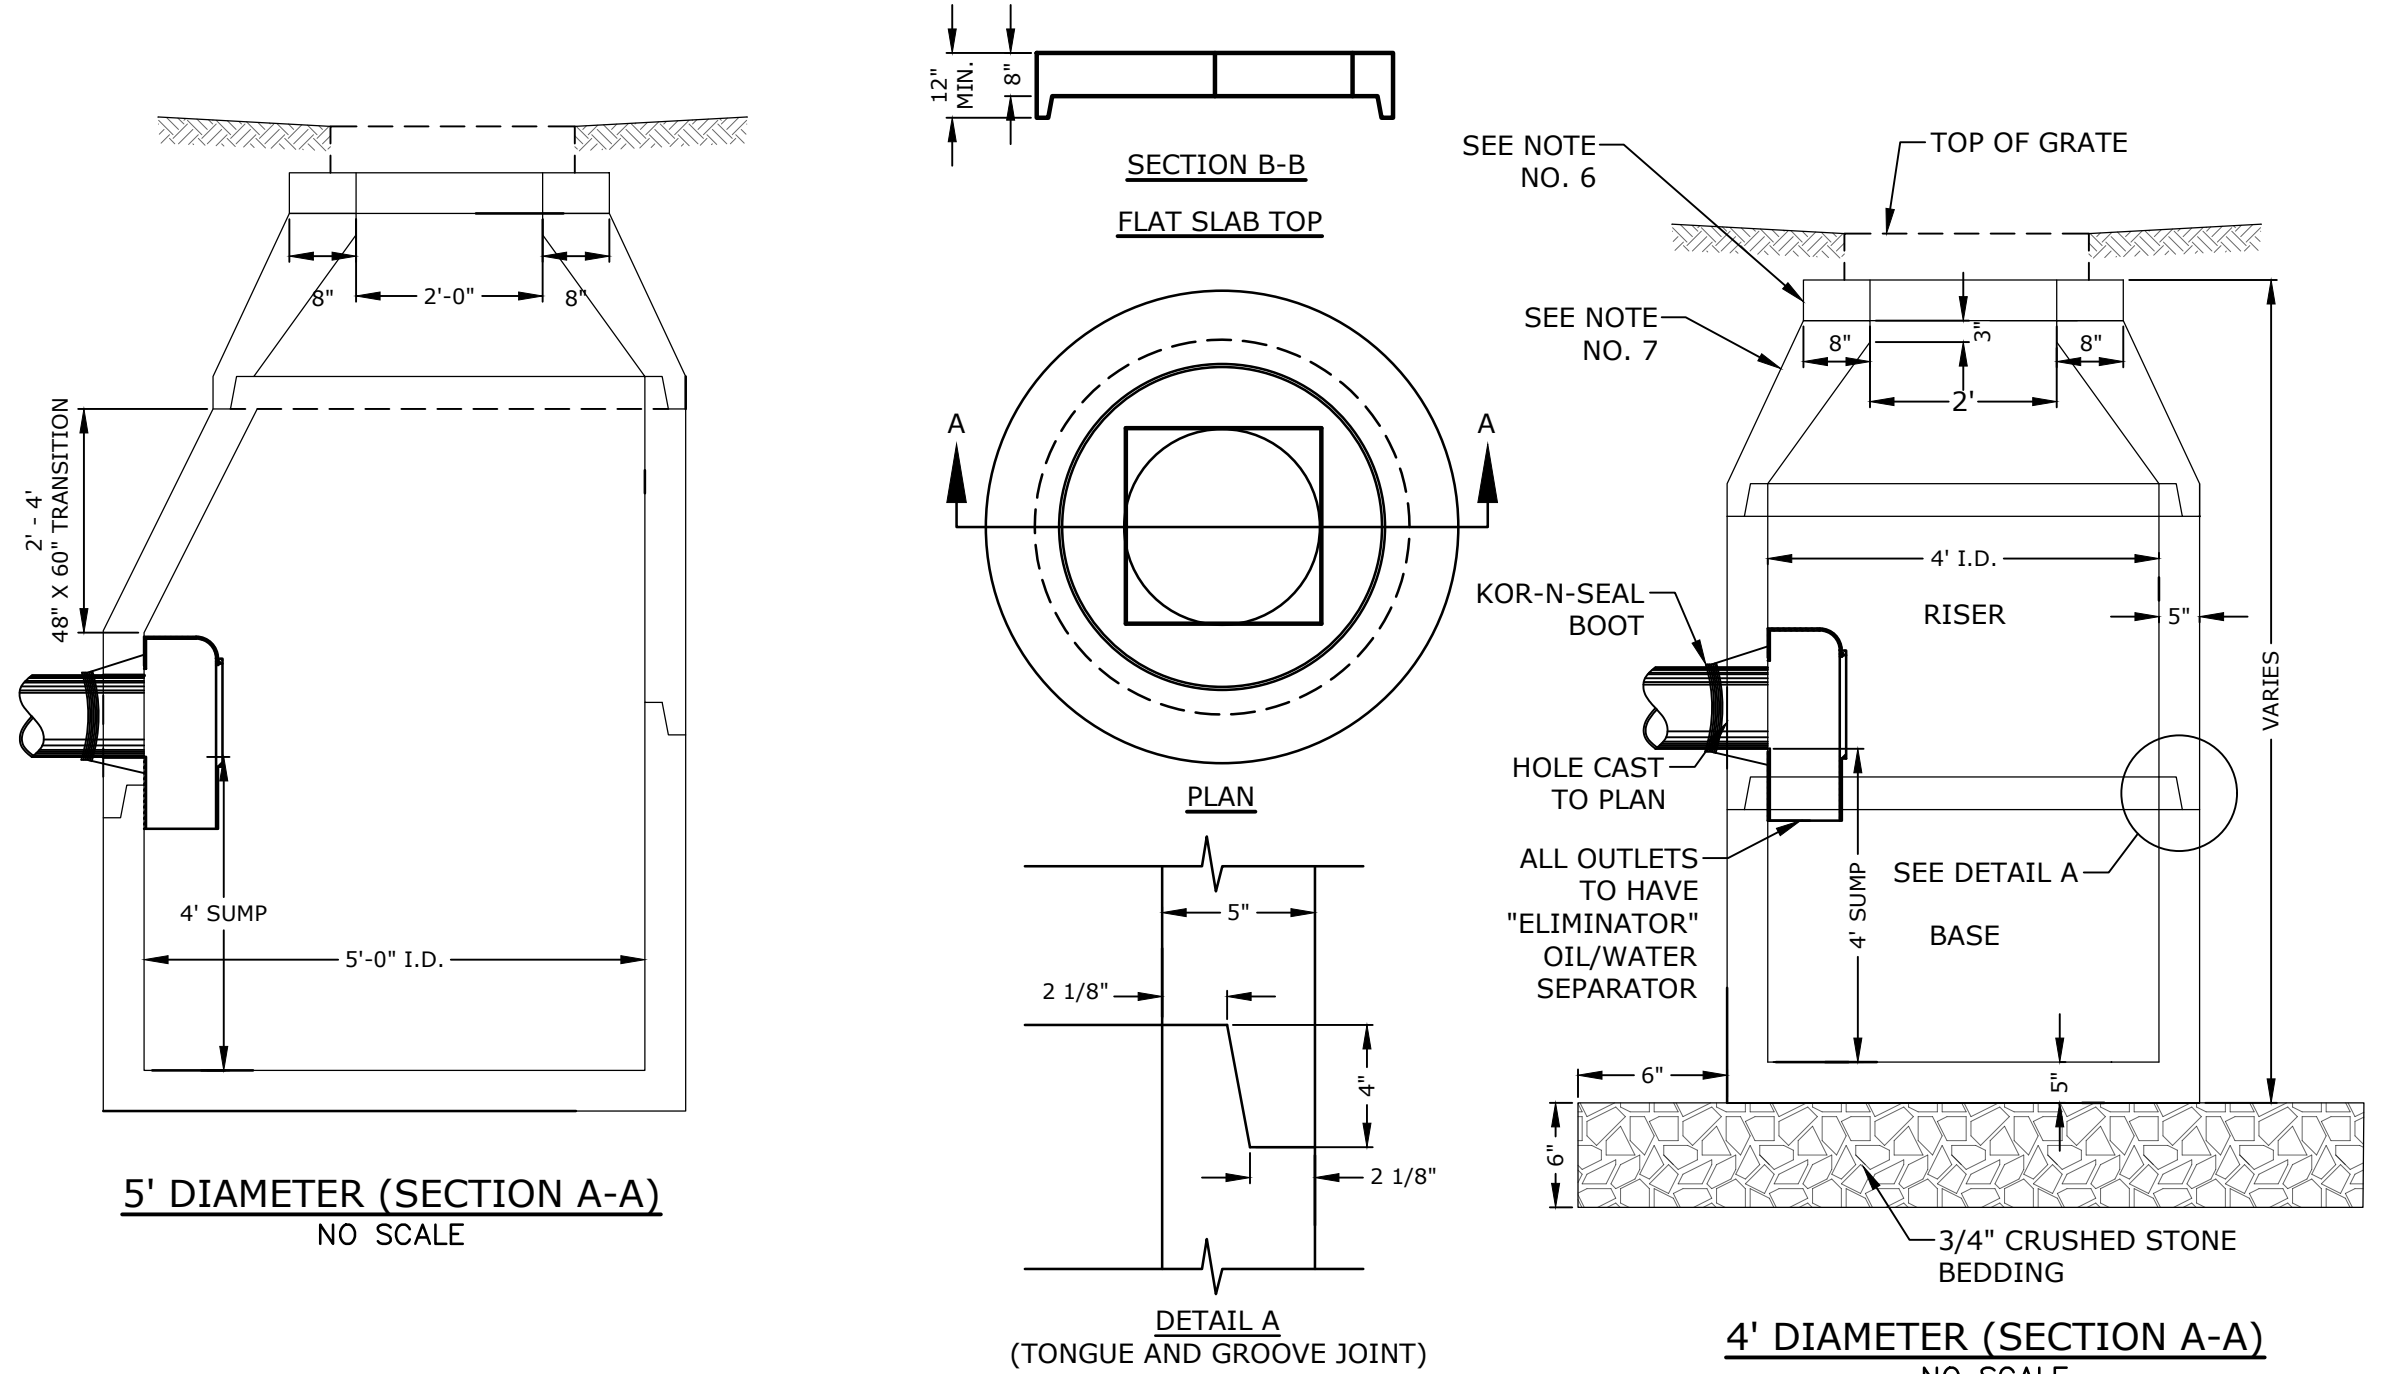


- NOTES:
- ALL SECTIONS SHALL BE CONCRETE CLASS AA(4000 psi).
 - CIRCUMFERENTIAL REINFORCEMENT SHALL BE 0.12 SQ. IN. PER LINEAR FT. IN ALL SECTIONS AND SHALL BE PLACED IN THE CENTER THIRD OF THE WALL.
 - THE TONGUE AND GROOVE OF THE JOINT SHALL CONTAIN ONE LINE OF CIRCUMFERENTIAL REINFORCEMENT EQUAL TO 0.12 SQ. IN. PER LINEAR FT.
 - RISERS OF 1', 2', 3' & 4' CAN BE USED TO REACH DESIRED DEPTH.
 - THE STRUCTURES SHALL BE DESIGNED FOR H2O LOADING.
 - FITTING FRAME TO GRADE MAY BE DONE WITH PREFABRICATED ADJUSTMENT RINGS OR CLAY BRICKS (2 COURSES MAX.).
 - CONE SECTIONS MAY BE EITHER CONCENTRIC OR ECCENTRIC, OR FLAT SLAB TOPS MAY BE USED WHERE PIPE WOULD OTHERWISE ENTER INTO THE CONE SECTION OF THE STRUCTURE AND WHERE PERMITTED.
 - PIPE ELEVATIONS SHOWN ON PLANS SHALL BE FIELD VERIFIED PRIOR TO PRECASTING.
 - OUTSIDE EDGES OF PIPES SHALL PROJECT NO MORE THAN 3" BEYOND INSIDE WALL OF STRUCTURE.
 - PRECAST SECTIONS SHALL HAVE A TONGUE AND GROOVE JOINT 4" HIGH AT AN 11° ANGLE CENTERED IN THE WIDTH OF THE WALL AND SHALL BE ASSEMBLED USING AN APPROVED FLEXIBLE SEALANT IN JOINTS.
 - THE TONGUE AND GROOVE JOINT SHALL BE SEALED WITH ONE STRIP OF BUTYL RUBBER SEALANT.
 - "ELIMINATOR" OIL/WATER SEPARATOR SHALL BE INSTALLED TIGHT TO INSIDE OF CATCHBASIN.


CATCH BASIN DETAIL NO SCALE

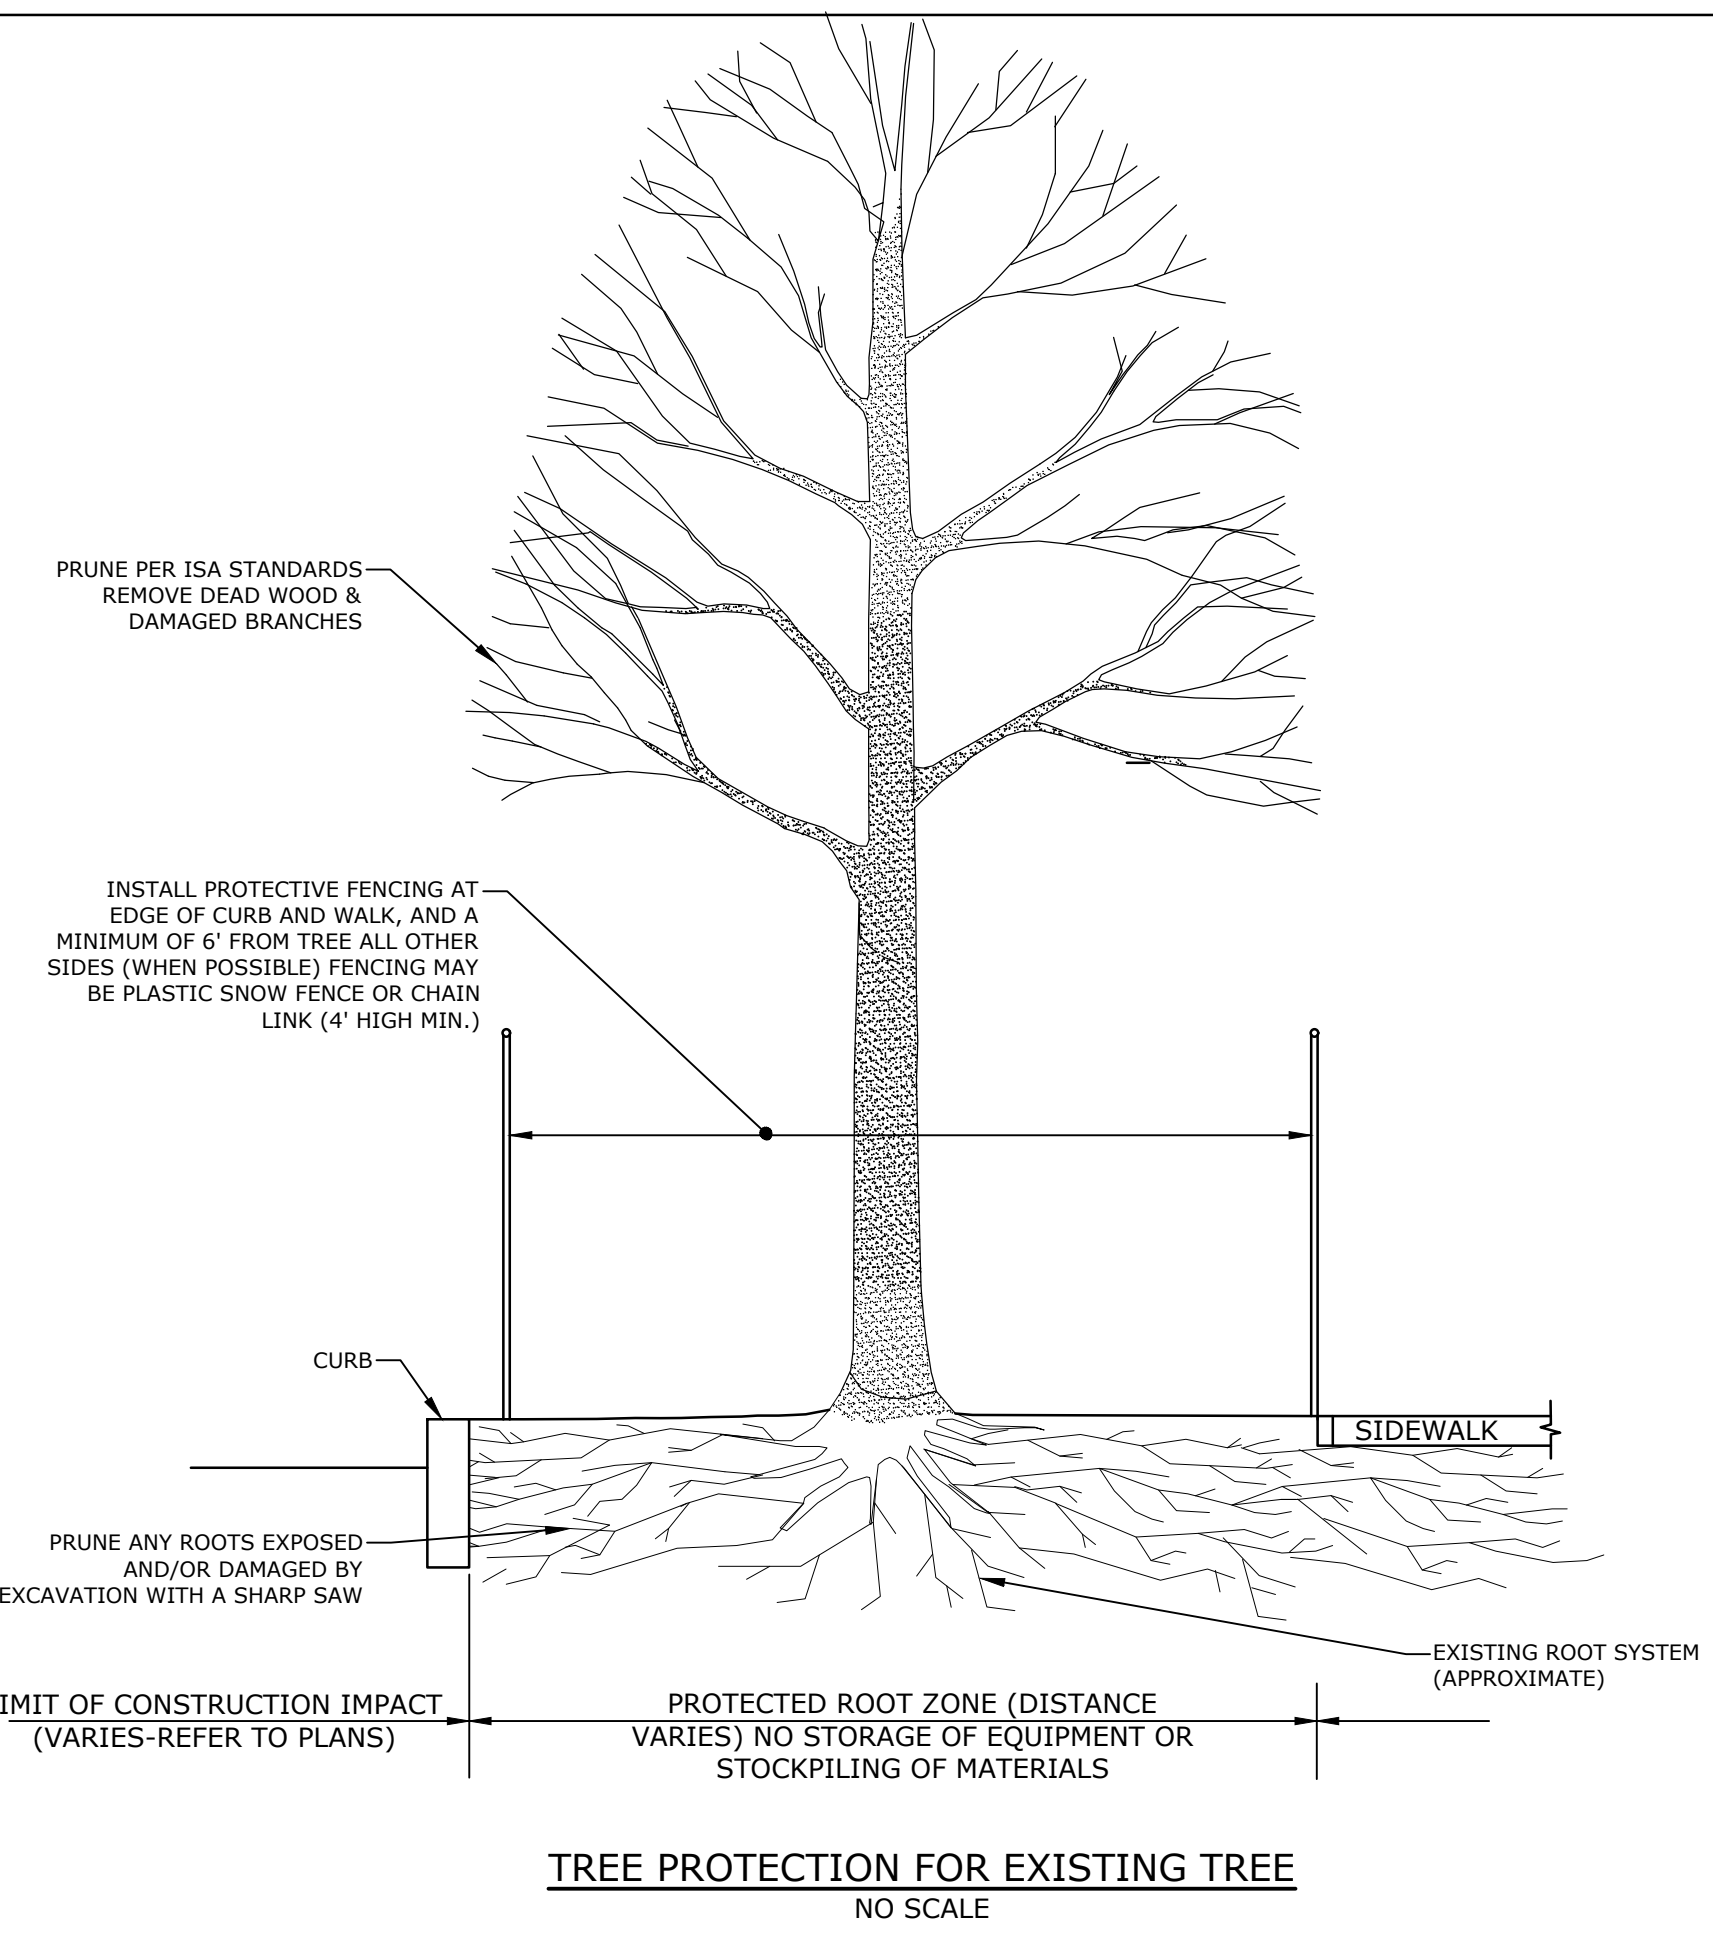


TREE PROTECTION FOR EXISTING TREE NO SCALE

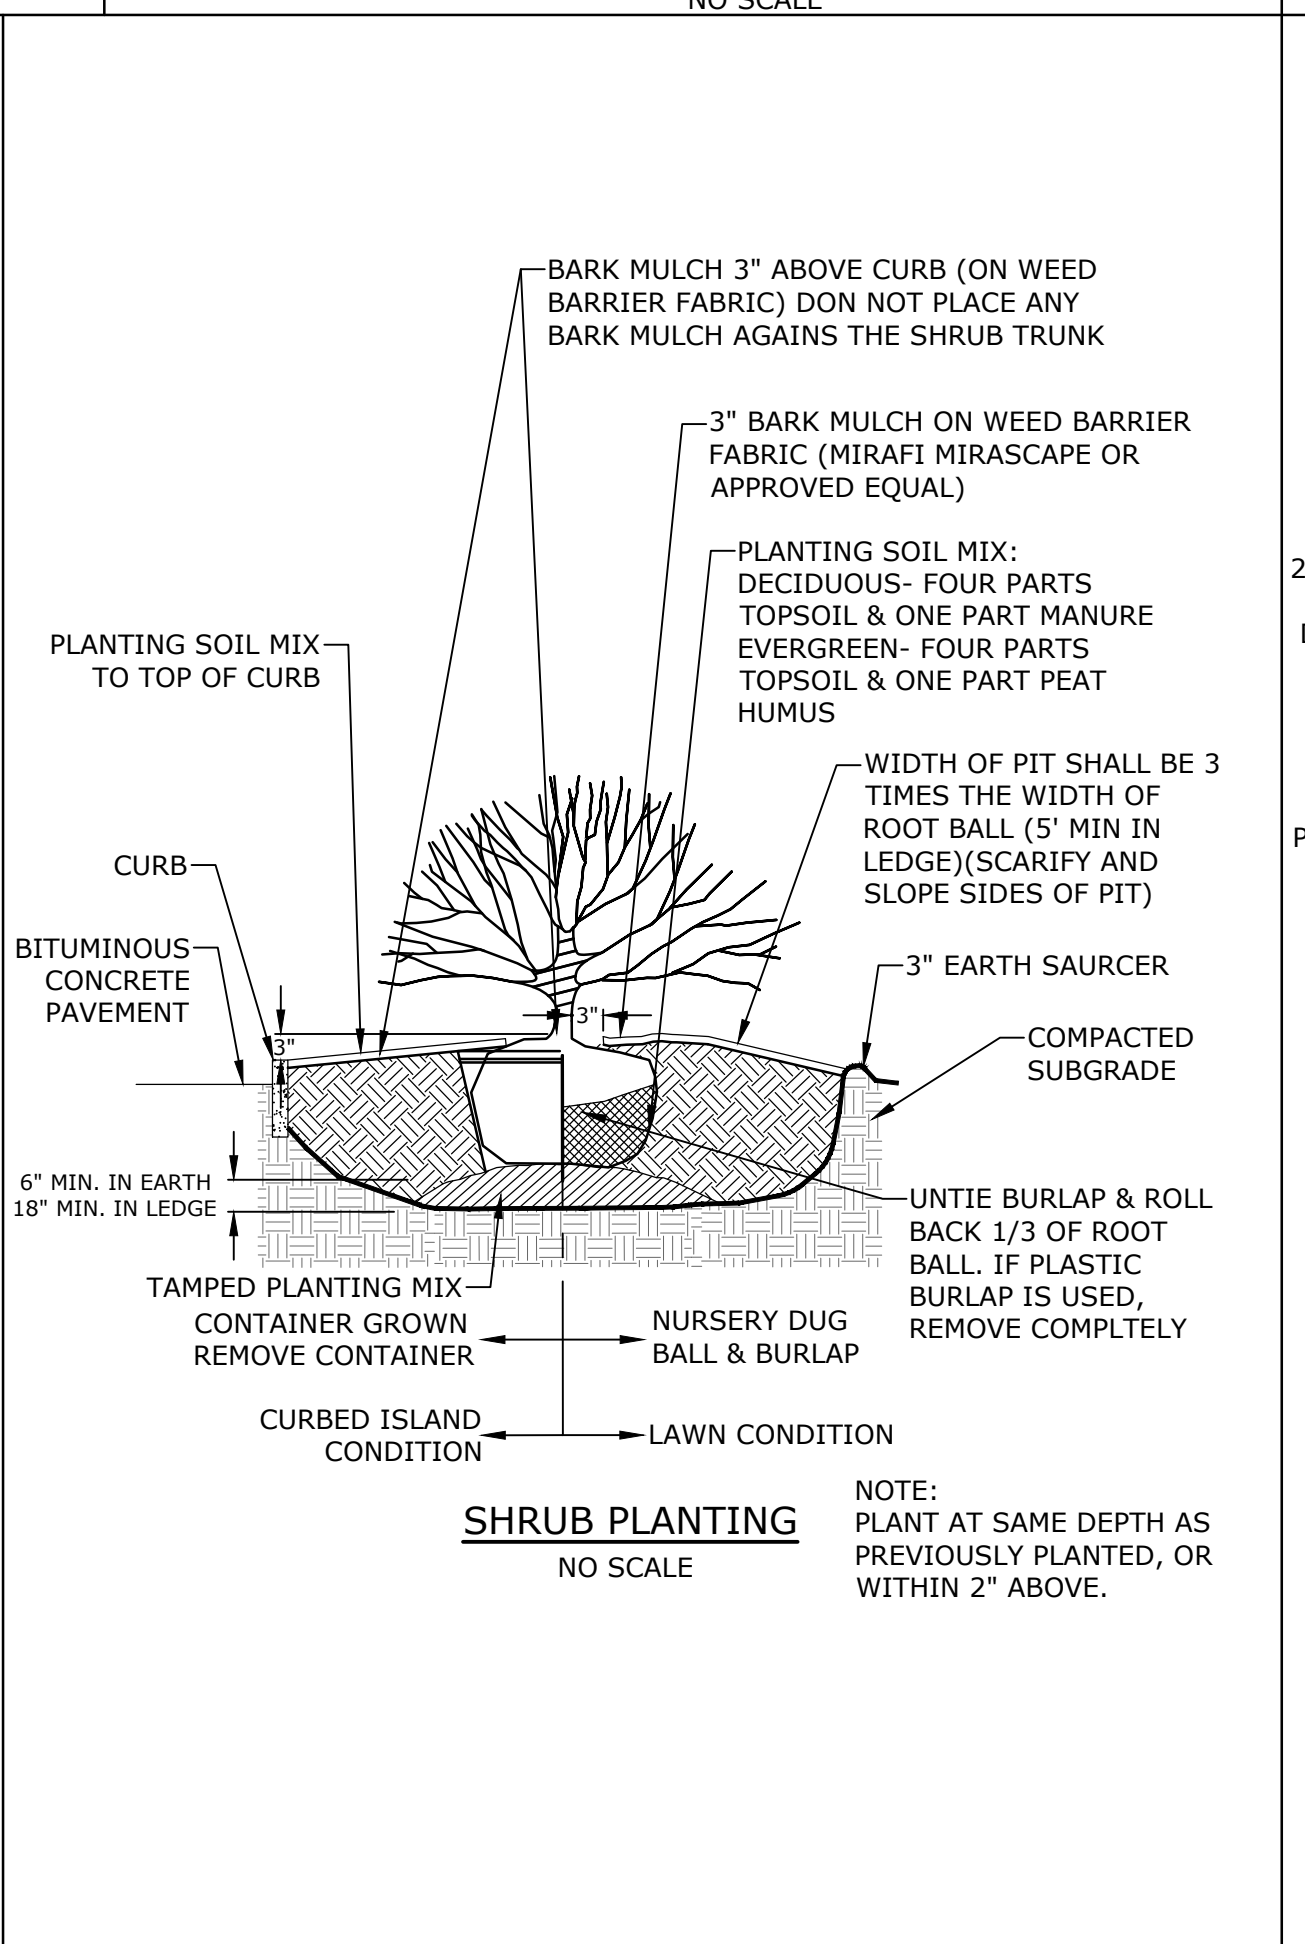


SHRUB PLANTING NO SCALE

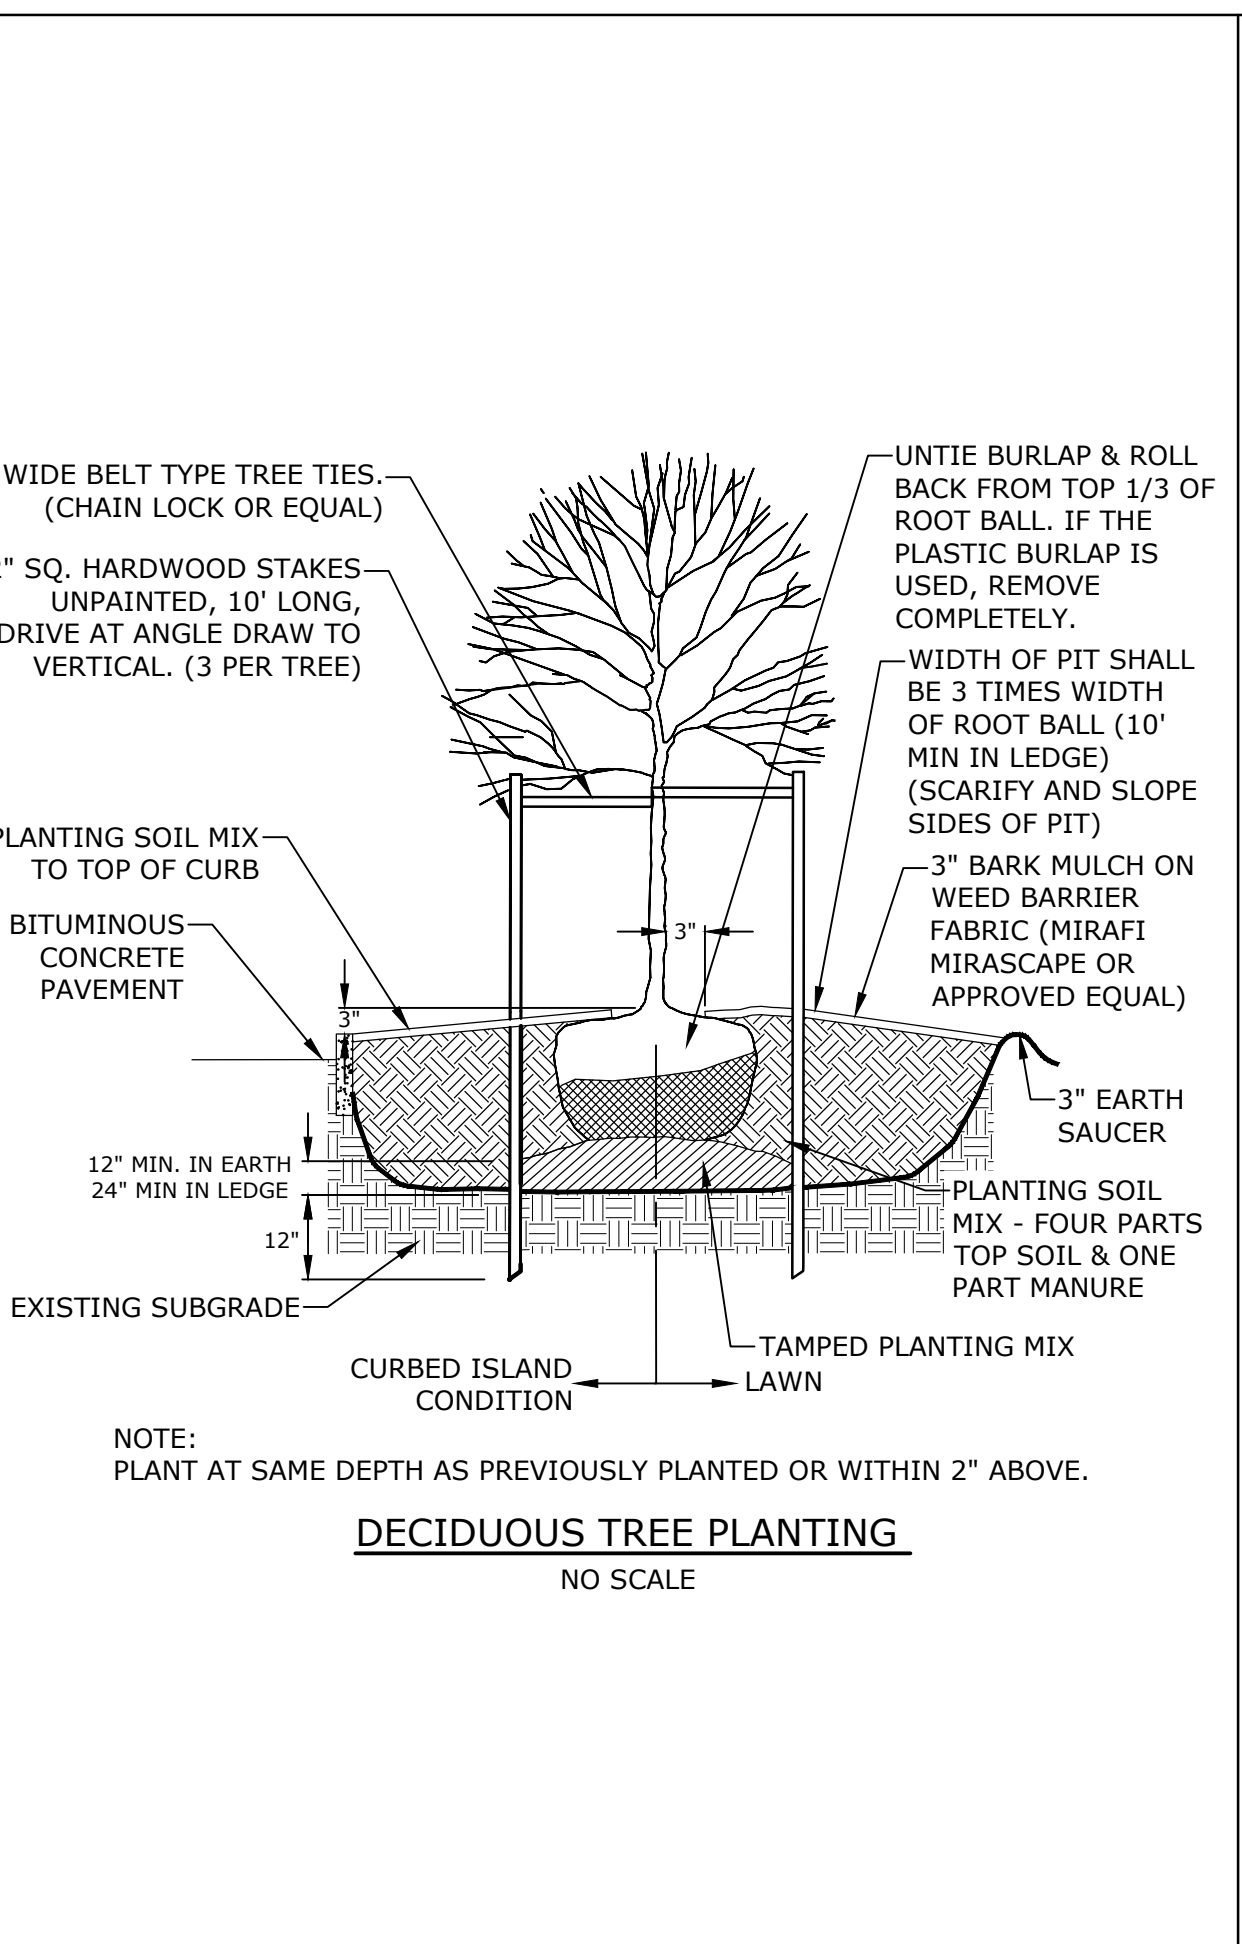

DECIDUOUS TREE PLANTING NO SCALE

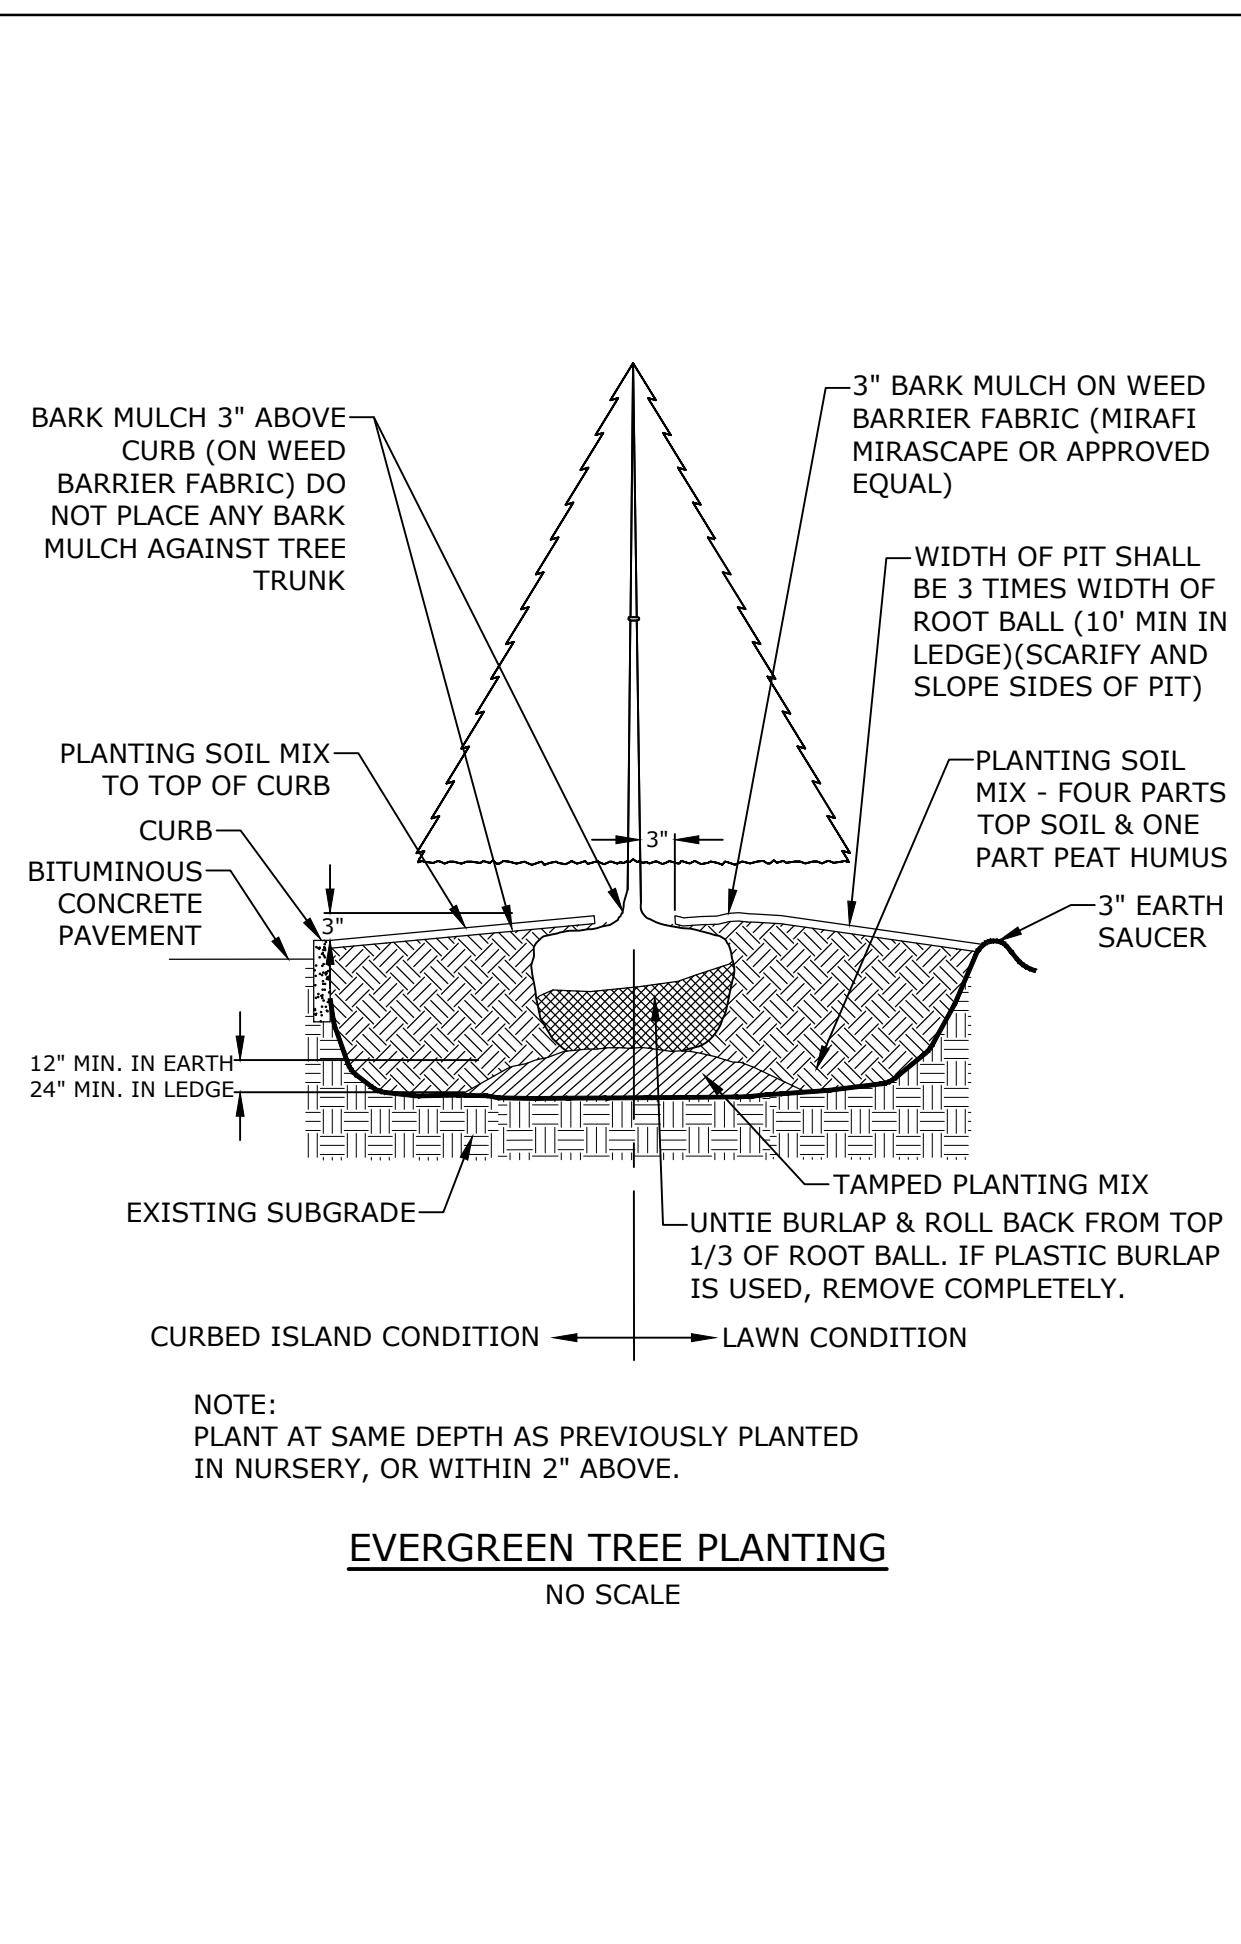

EVERGREEN TREE PLANTING NO SCALE

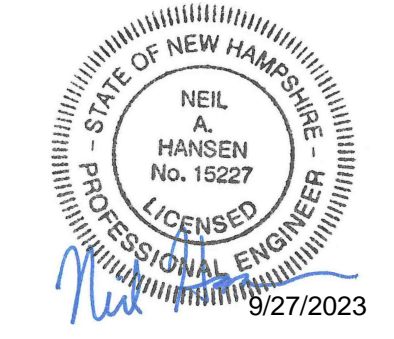

Proposed Industrial Development

Lonza Biologics

Portsmouth, New Hampshire





MARK	DATE	DESCRIPTION
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M		

PROJECT NO:	L-0700-013
DATE:	04/03/2018
FILE:	L-0700-026-C-DTLS.dwg
DRAWN BY:	CHK
CHECKED:	NAH
APPROVED:	PMC

DETAILS SHEET

SCALE: AS SHOWN


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 P&E File Location: Z:\L-0700 Lonza Biologics Expansion.was 12/26/2026 Project Alternate Drawings\AutoCAD\1-0700-026-C-DTLS.dwg Layout: Tab: C-504

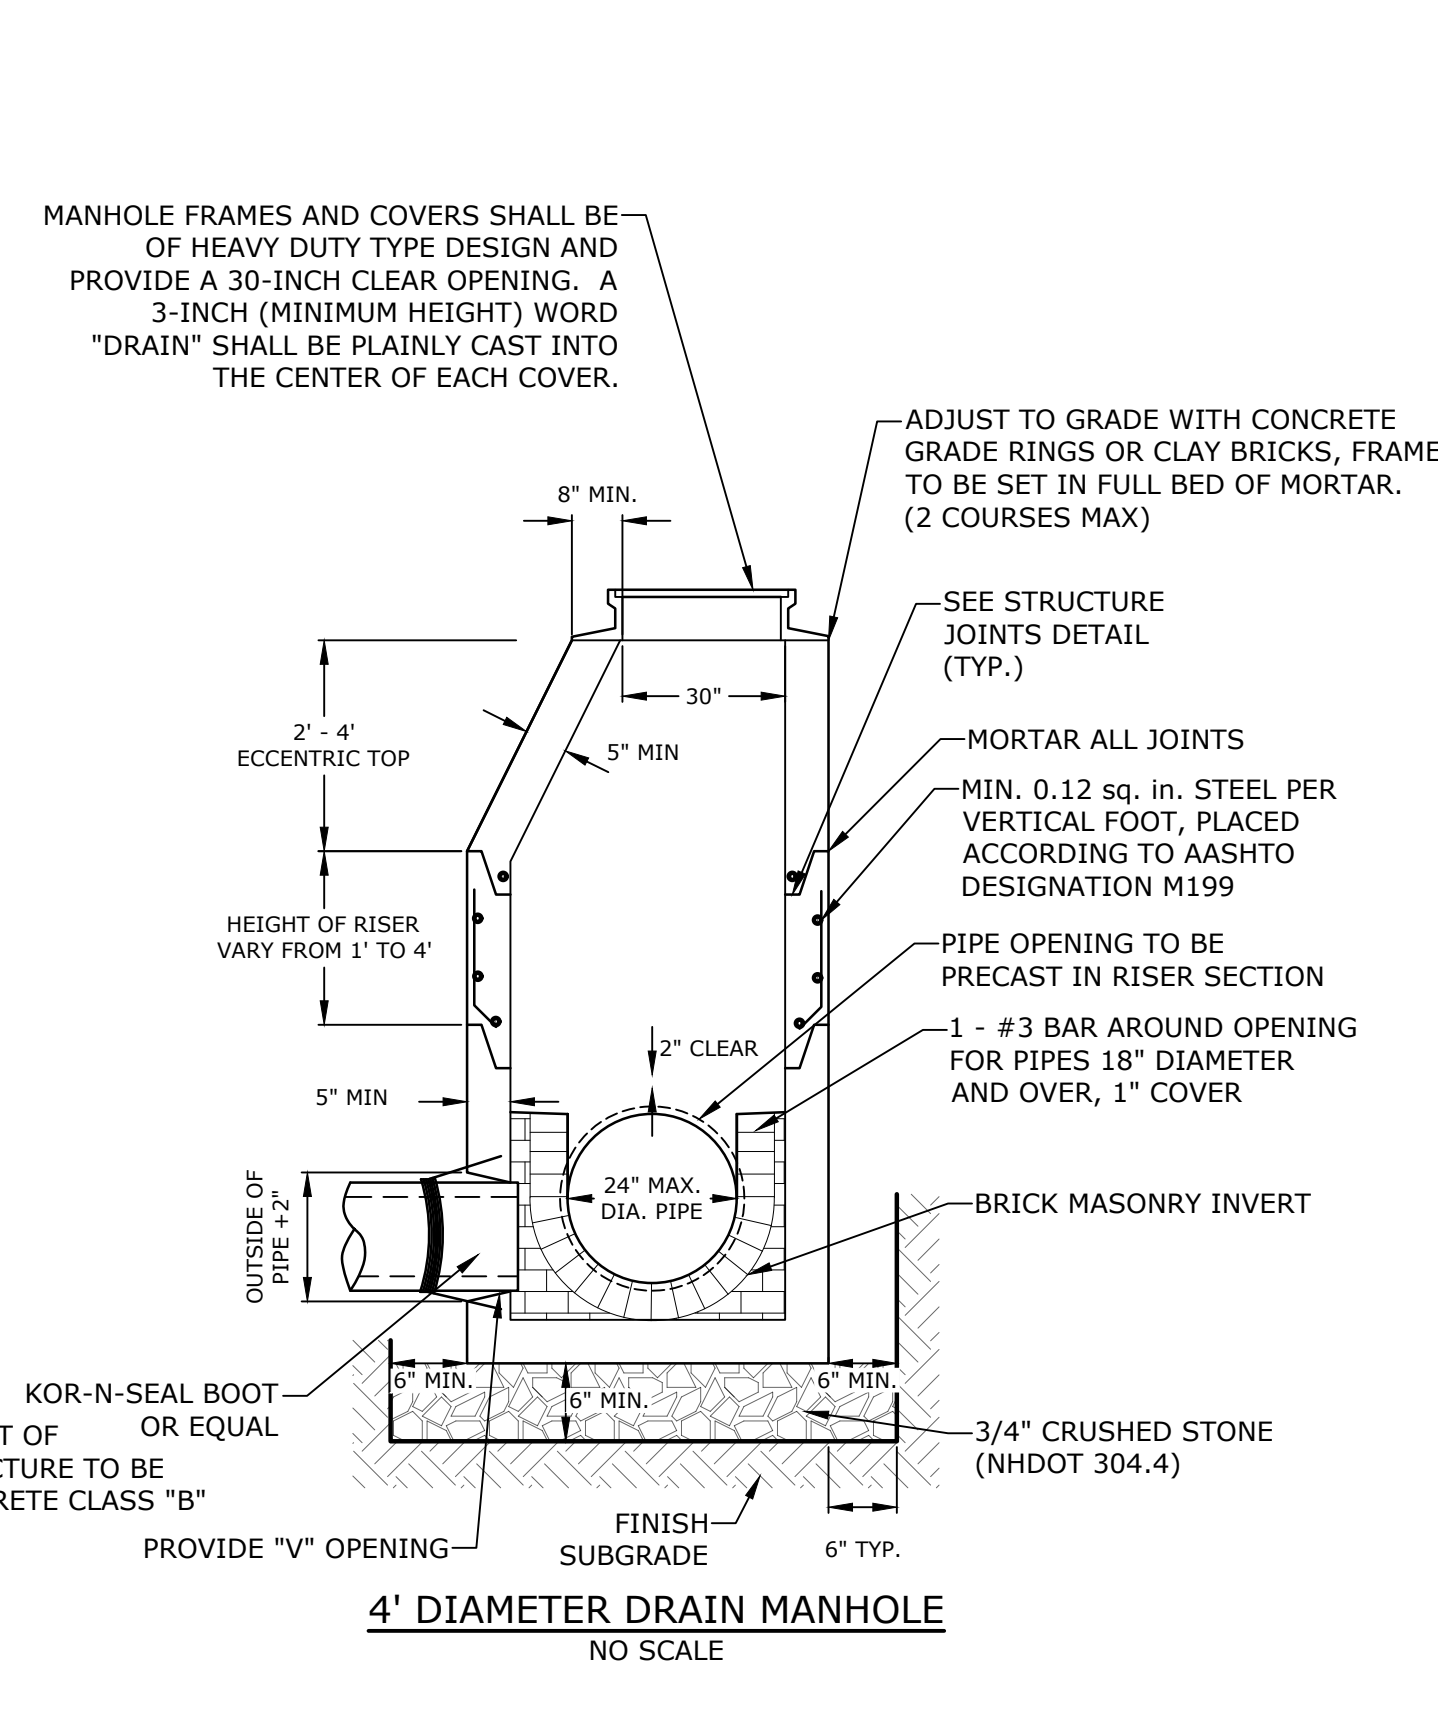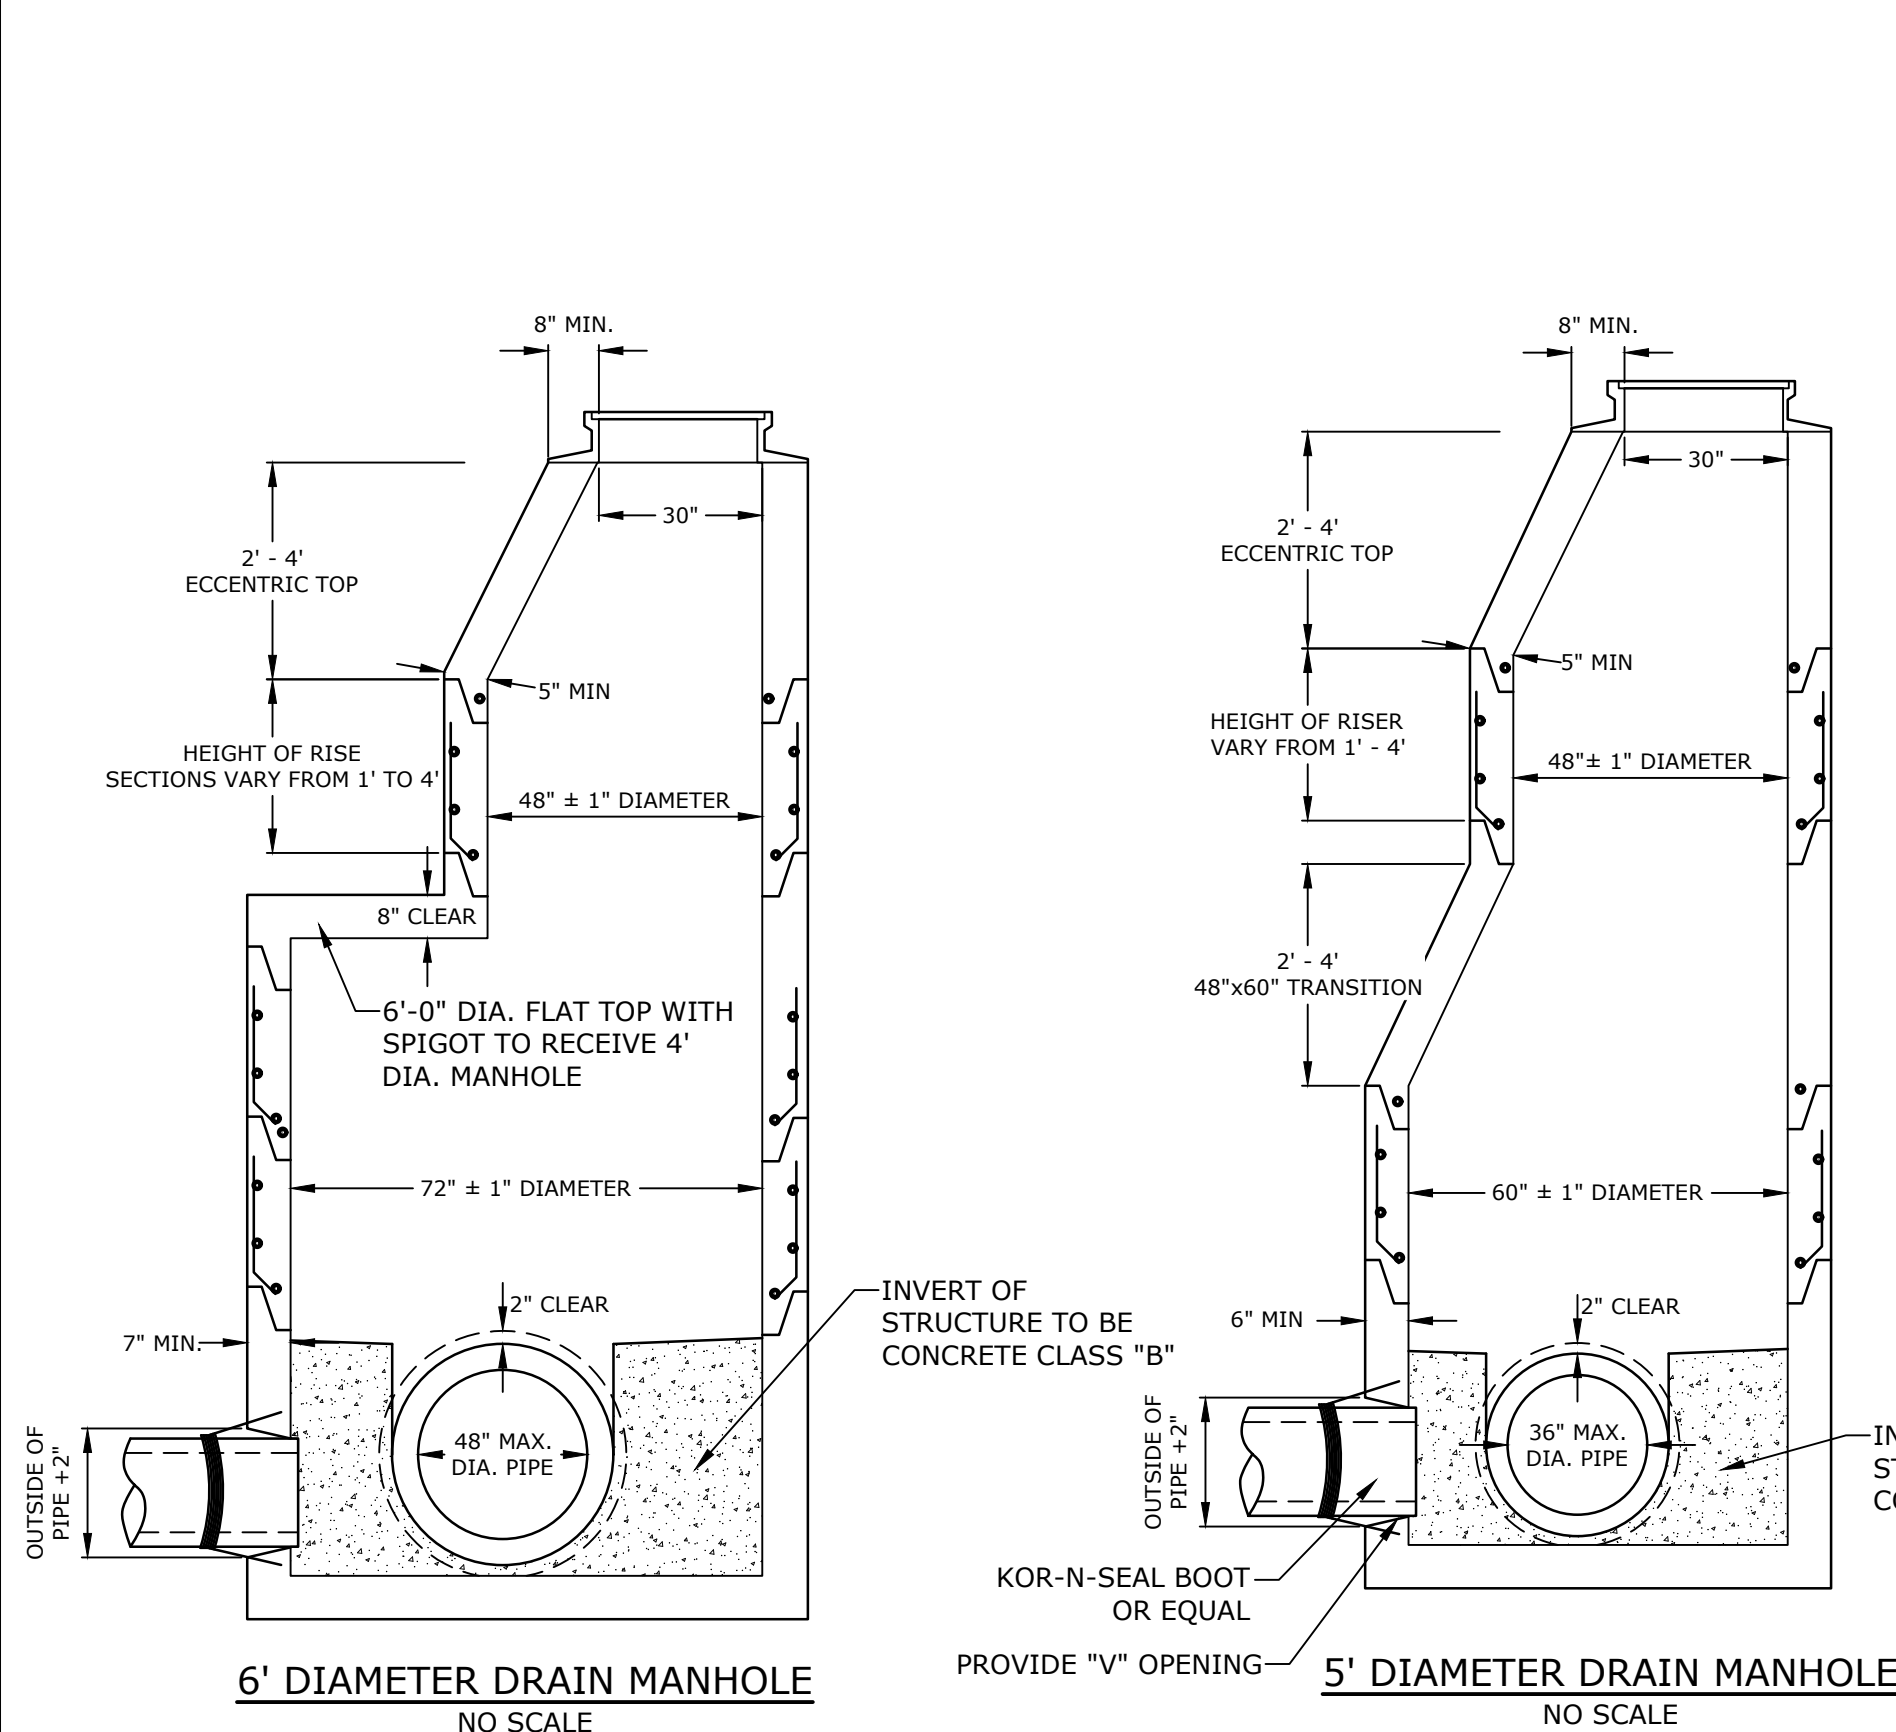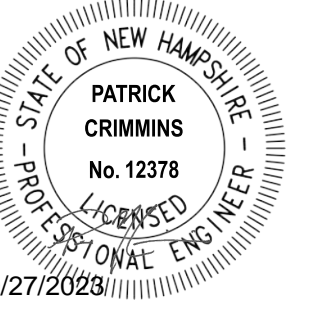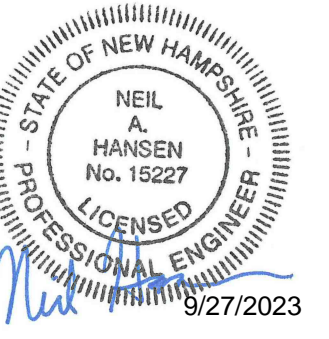

- NOTES:**
- ALL SECTIONS SHALL BE 4,000 PSI CONCRETE.
 - CIRCUMFERENTIAL REINFORCEMENT SHALL BE 0.12 SQUARE INCHES PER LINEAR FOOT IN ALL SECTIONS AND SHALL BE PLACED IN THE CENTER THIRD OF THE WALL.
 - THE TONGUE AND THE GROOVE OF THE JOINT SHALL CONTAIN ONE LINE OF CIRCUMFERENTIAL REINFORCEMENT EQUAL TO 0.12 SQUARE INCHES PER LINEAR FOOT.
 - THE STRUCTURES SHALL BE DESIGNED FOR H20 LOADING.
 - CONSTRUCT CRUSHED STONE BEDDING AND BACKFILL UNDER (6" MINIMUM THICKNESS)
 - THE TONGUE AND GROOVE JOINT SHALL BE SEALED WITH ONE STRIP OF BUTYL RUBBER SEALANT.
 - PIPE ELEVATIONS SHOWN ON PLANS SHALL BE FIELD VERIFIED PRIOR TO PRECASTING.
 - OUTSIDE EDGES OF PIPES SHALL PROJECT NO MORE THAN 3" BEYOND INSIDE WALL OF STRUCTURE.
 - PRECAST SECTIONS SHALL HAVE A TONGUE AND GROOVE JOINT 4" HIGH AT AN 11° ANGLE CENTERED IN THE WIDTH OF THE WALL AND SHALL BE ASSEMBLED USING AN APPROVED FLEXIBLE SEALANT IN JOINTS.
 - ALL STRUCTURES WITH MULTIPLE PIPES SHALL HAVE A MINIMUM OF 12" OF INSIDE SURFACE BETWEEN HOLES, NO MORE THAN 75% OF A HORIZONTAL CROSS SECTION SHALL BE HOLES, AND THERE SHALL BE NO HOLES CLOSER THAN 3" TO JOINTS.



CORE HOLE SIZE			
PIPE SIZE	RCP CORE HOLE DIA.	PLASTIC CORE HOLE DIA.	
INCHES	INCHES	FEET	INCHES
6	12	1.5	7
12	18	1.5	18
15	22	1.8	20
18	26	2.2	24
24	34	2.8	32
30	42	3.5	42
36	48	4.0	48

DIAMETER	WALL THICKNESS (MIN.)	FLOOR THICKNESS (MIN.)
4'	5"	6"
5'	6"	8"
6'	7"	8"

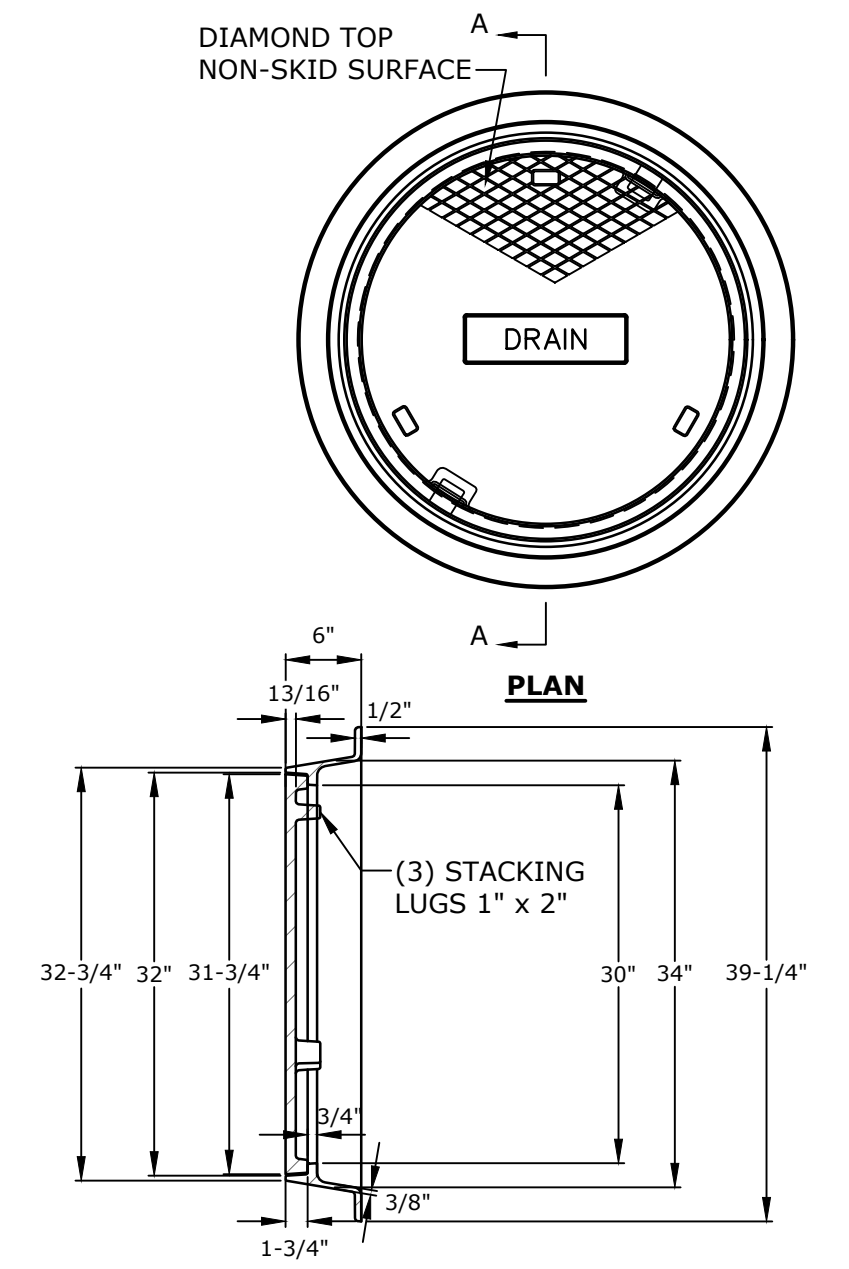

- NOTES:**
- ALL DIMENSIONS ARE NOMINAL.
 - FRAMES USING NARROWER DIMENSIONS FOR THICKNESS ARE ALLOWED PROVIDED:
 - A. THE FRAMES MEET OR EXCEED THE SPECIFIED LOAD RATING.
 - B. THE INTERIOR PERIMETER (SEAT AREA) DIMENSIONS OF THE FRAMES REMAIN THE SAME TO ALLOW CONTINUED USE OF EXISTING GRATES/COVERS AS THE EXISTING FRAMES ALLOW, WITHOUT SHIMS OR OTHER MODIFICATIONS OR ACCOMMODATIONS.
 - C. ALL OTHER PERTINENT REQUIREMENTS OF THE SPECIFICATIONS ARE MET.
 - LABEL TYPE OF MANHOLE WITH 3" HIGH LETTERS IN THE CENTER OF THE COVER.


DRAIN MANHOLE FRAME & COVER
NO SCALE

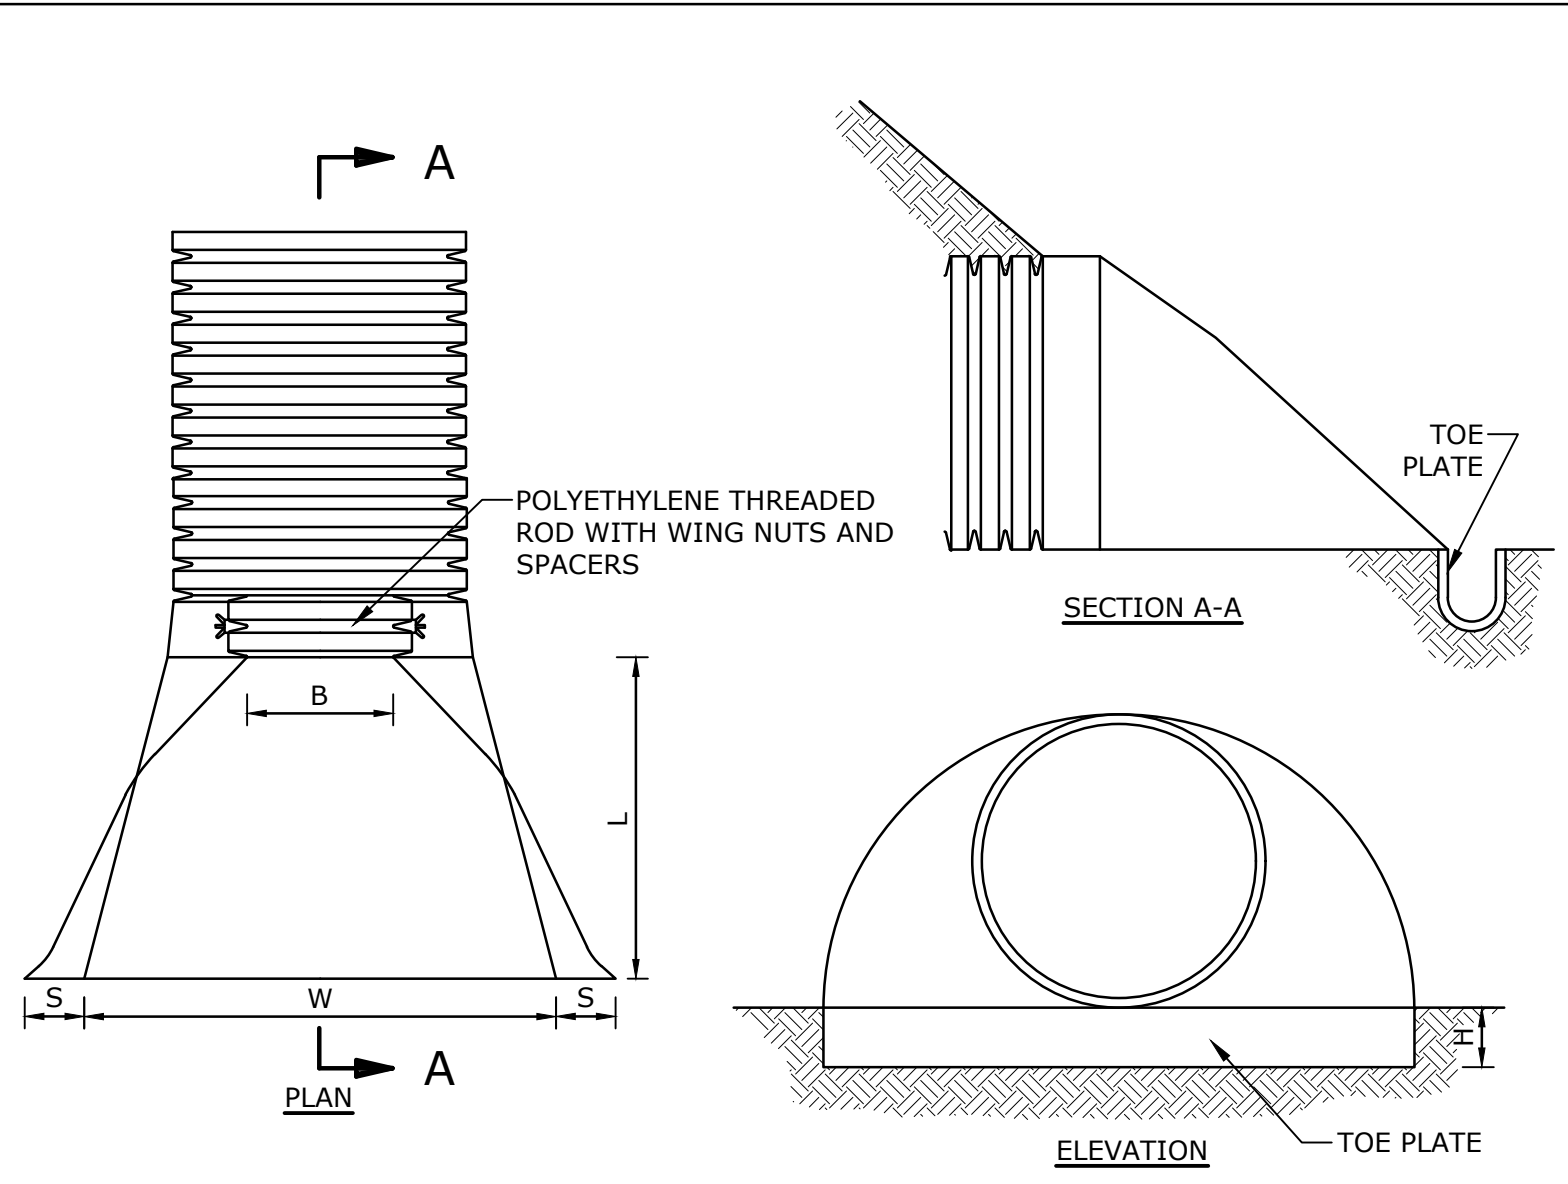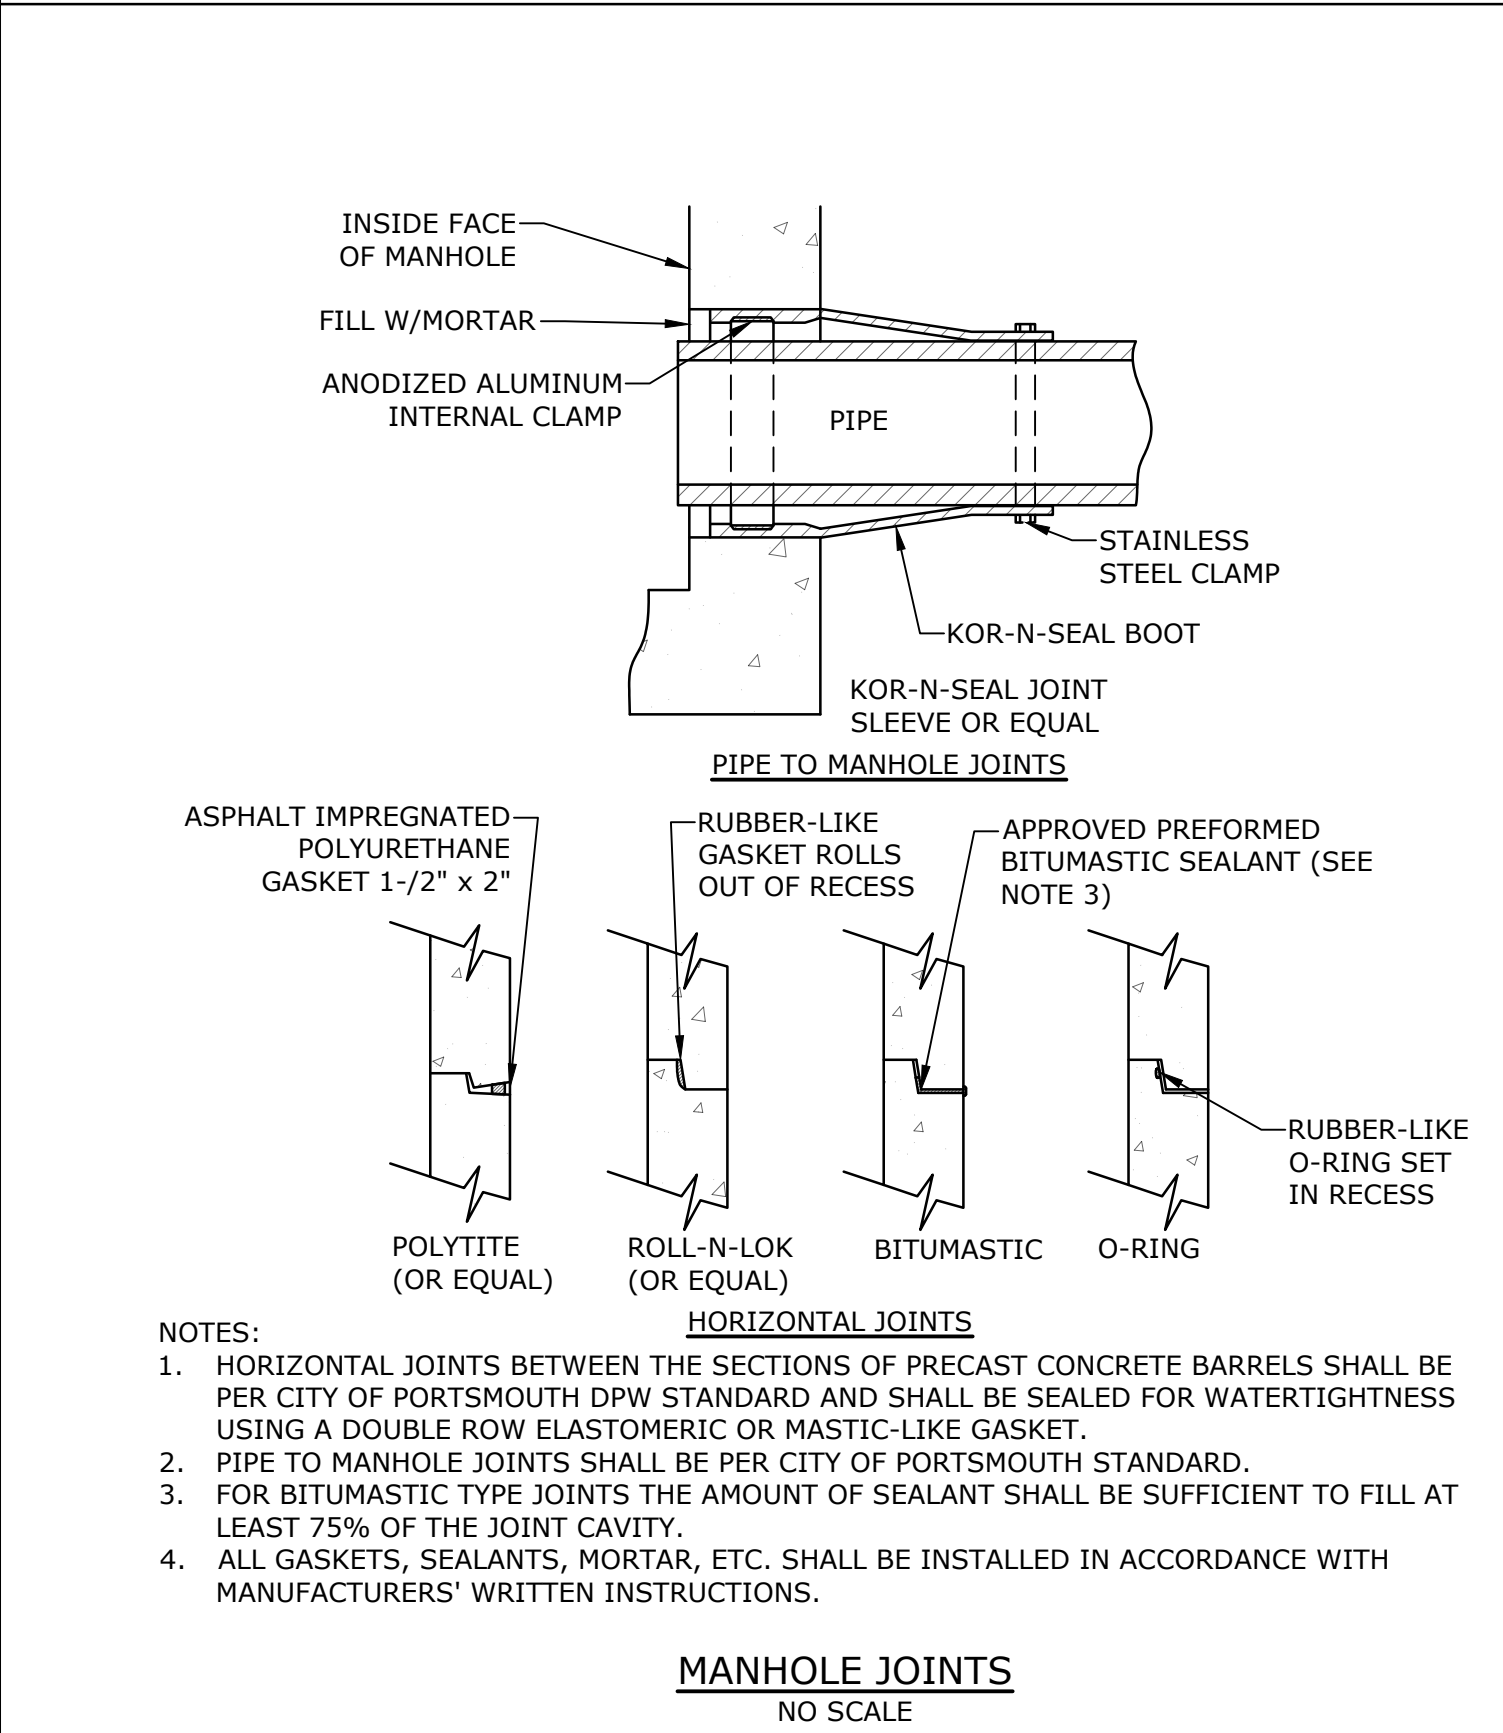

PIPE DIA.	S	B	H	L	W
12"	6.5"	10"	6.5"	25"	29"
15"	6.5"	10"	6.5"	25"	29"
18"	7.5"	15"	6.5"	32"	35"
24"	7.5"	18"	6.5"	36"	45"
30"	7.5"	12"	8.6"	58"	63"
36"	7.5"	25"	8.6"	58"	63"


- NOTE:**
- END SECTIONS MANUFACTURED BY ADVANCED DRAINAGE SYSTEMS, COLUMBUS, OHIO. END SECTIONS TO BE WELDED TO PIPE AS PER MANUFACTURER'S RECOMMENDATIONS.

HDPE END SECTION
NO SCALE

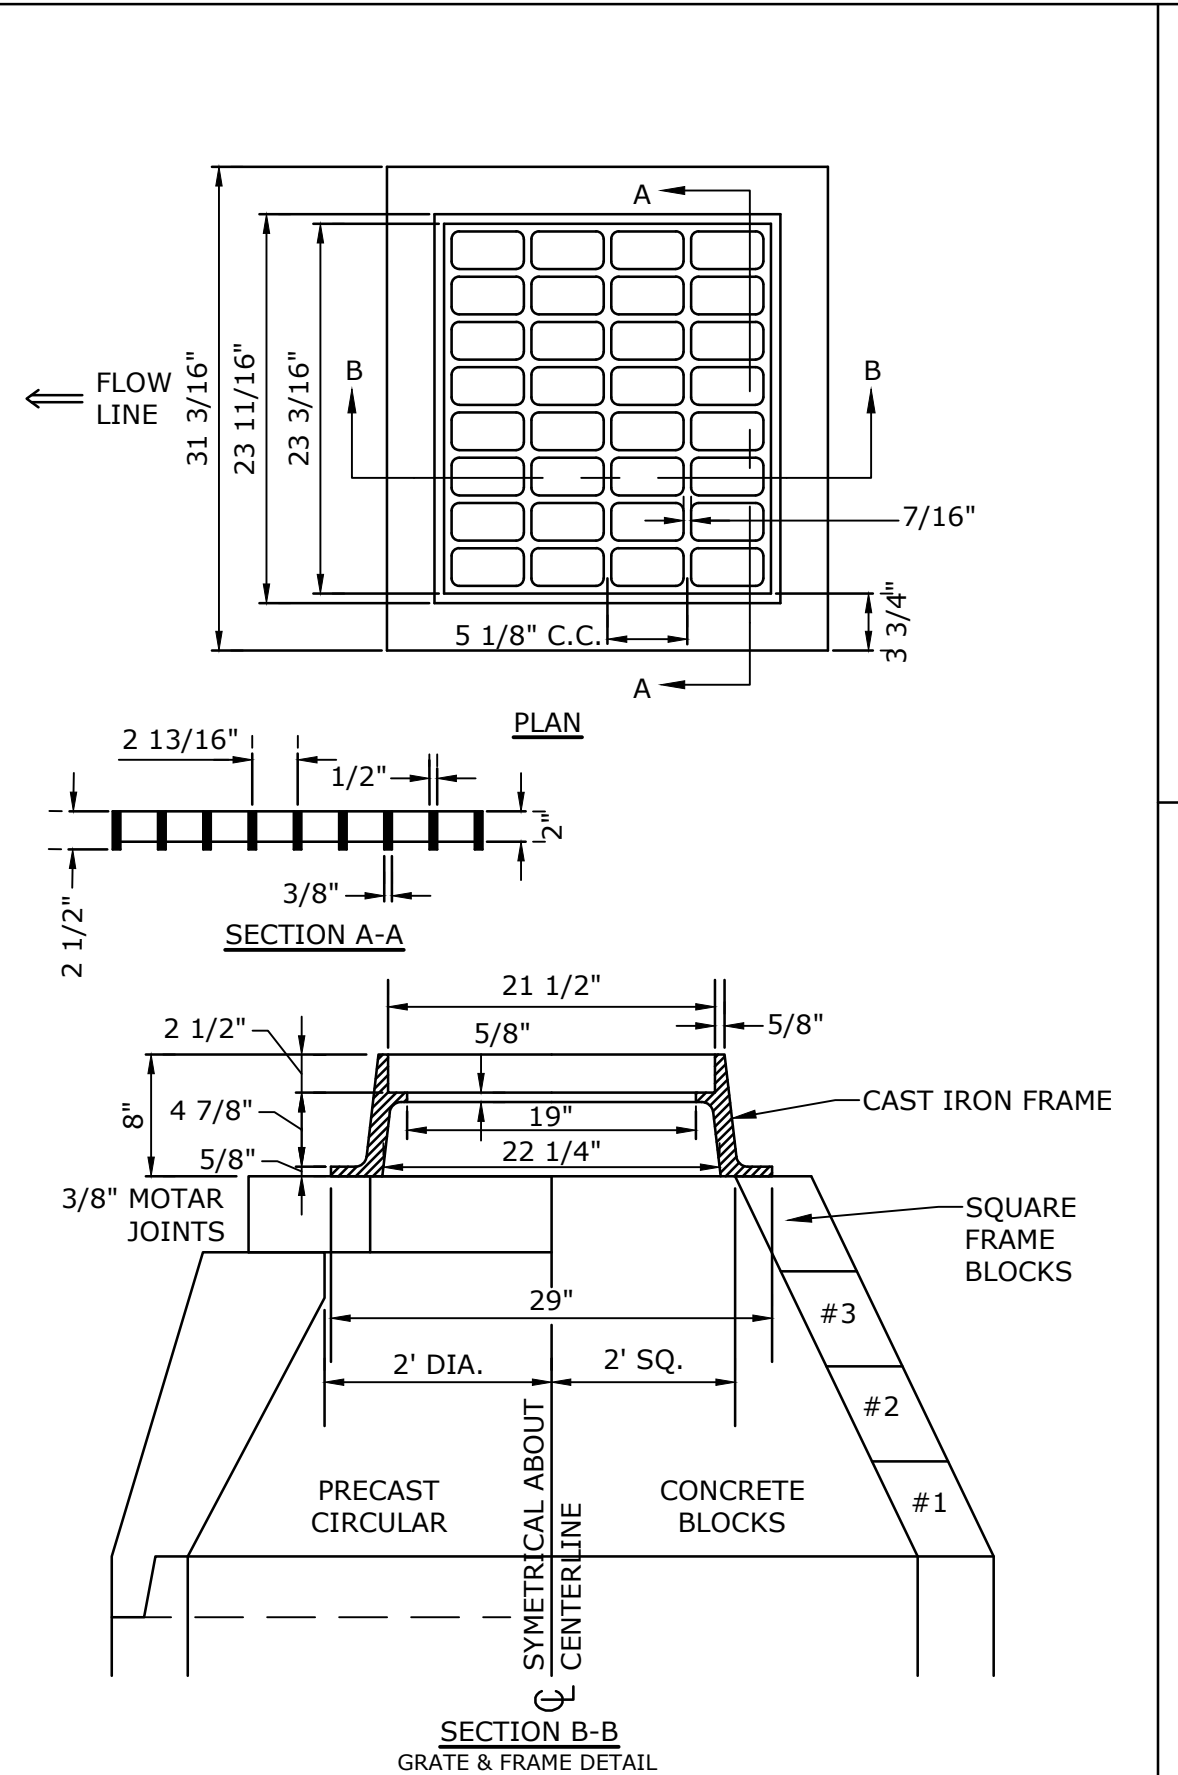


- NOTE:**
- GRATE TO BE CAST IRON (NHDOT TYPE B)
 - FRAME AND GRATE TO BE MANUFACTURED IN THE USA

CATCH BASIN FRAME & GRATE
NO SCALE

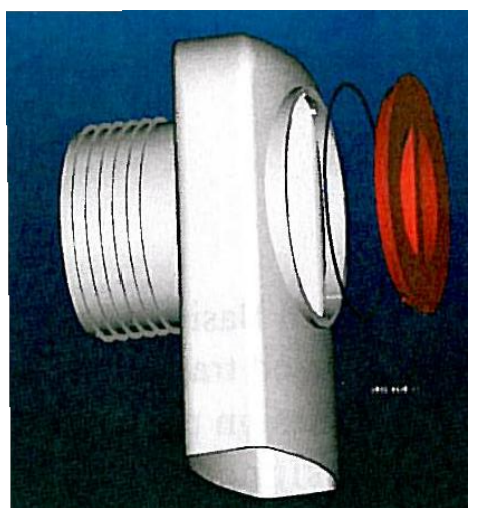

- NOTES:**
- ALL CATCH BASIN OUTLETS TO HAVE "ELIMINATOR" OIL AND FLOATING DEBRIS TRAP MANUFACTURED BY KLEANSTREAM (NO EIGHT).
 - INSTALL DEBRIS TRAP TIGHT TO INSIDE OF STRUCTURE.
 - 1/4" HOLE SHALL BE DRILLED IN TOP OF DEBRIS TRAP

"ELIMINATOR" OIL FLOATING DEBRIS TRAP
NO SCALE

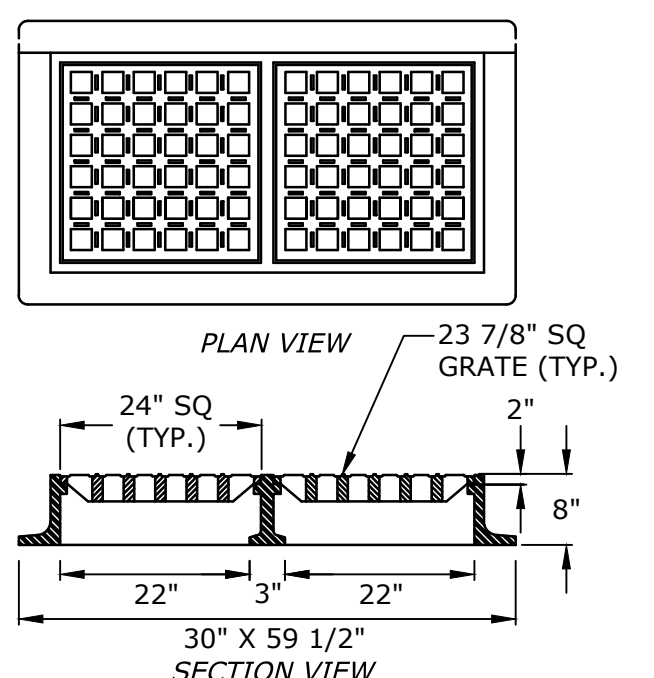

- NOTES:**
- FRAME AND GRATES SHALL BE EJ FOUNDRY OR APPROVED EQUAL.
 - MATERIAL SHALL BE CLASS 30B GRAY IRON AND SHALL COMPLY WITH ALTEST ASTM A48.
 - FRAME AND GRATES SHALL BE HEAVY DUTY AND RATED FOR H-20 LOADING.
 - 3 FLANGE FRAMES TO BE USED WITH CURB INLET.

DOUBLE CATCHBASIN FRAME & GRATE
NO SCALE

Proposed Industrial Development

Lonza Biologics

Portsmouth, New Hampshire


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APPROVED:	PMC


DETAILS SHEET

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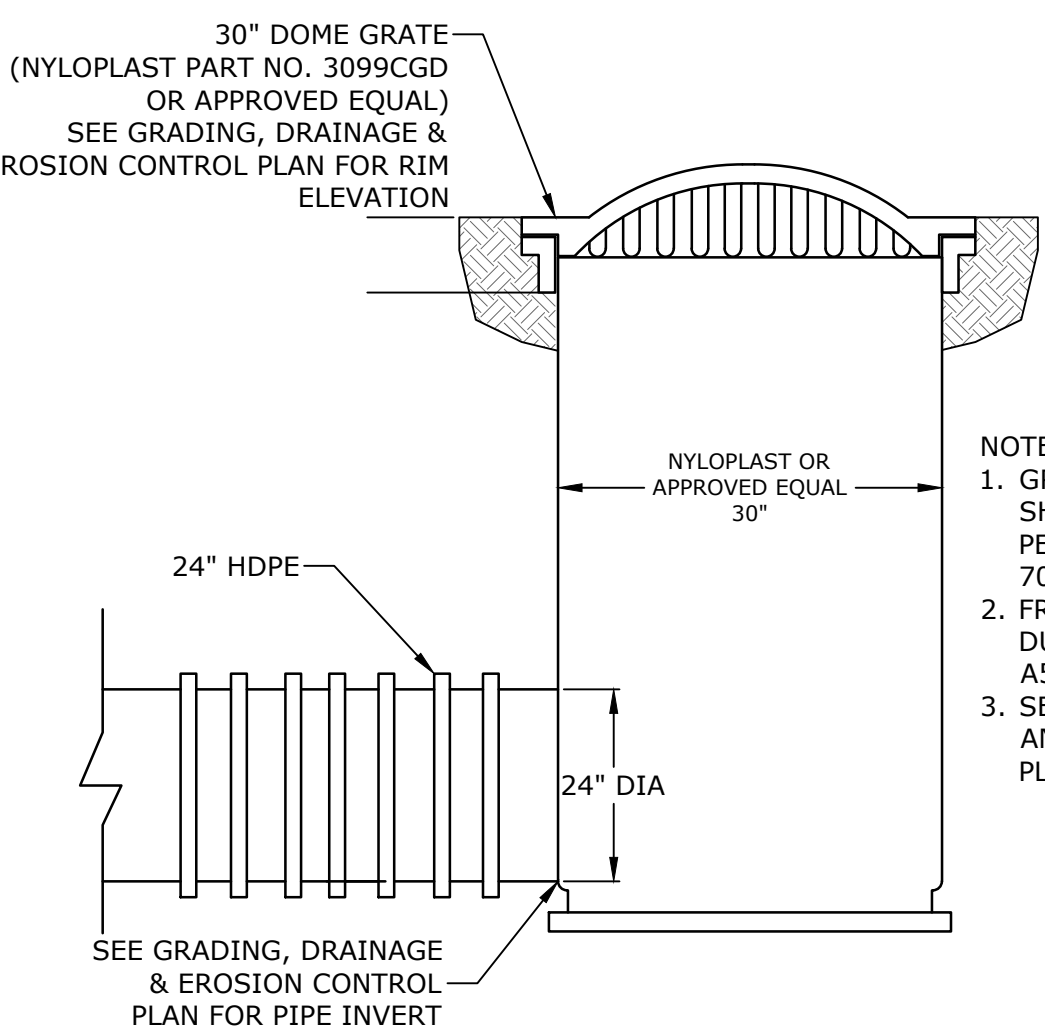
C-505



PYD100, PYD104, PYD104, PYD200, PYD201, PYD301, PYD302, PYD303, & PYD304
NO SCALE

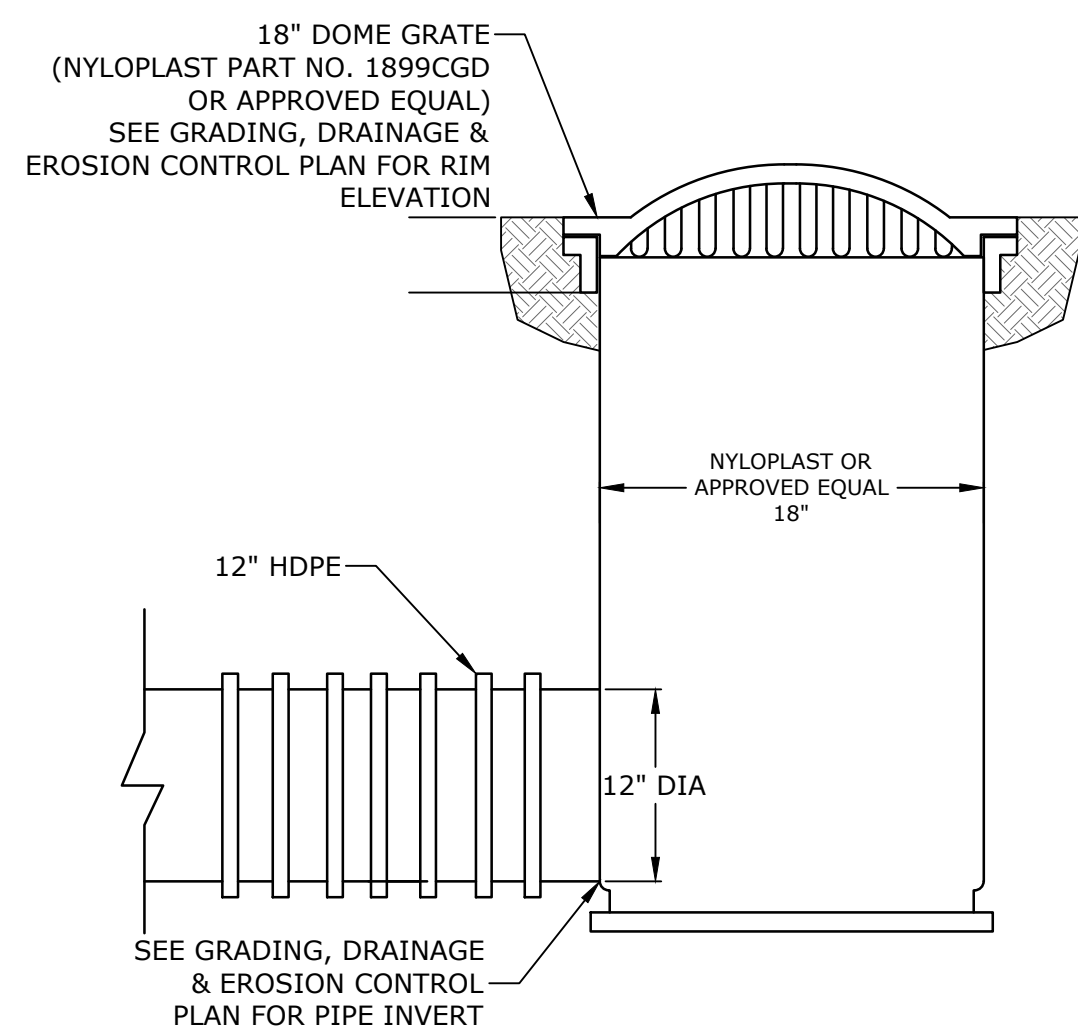


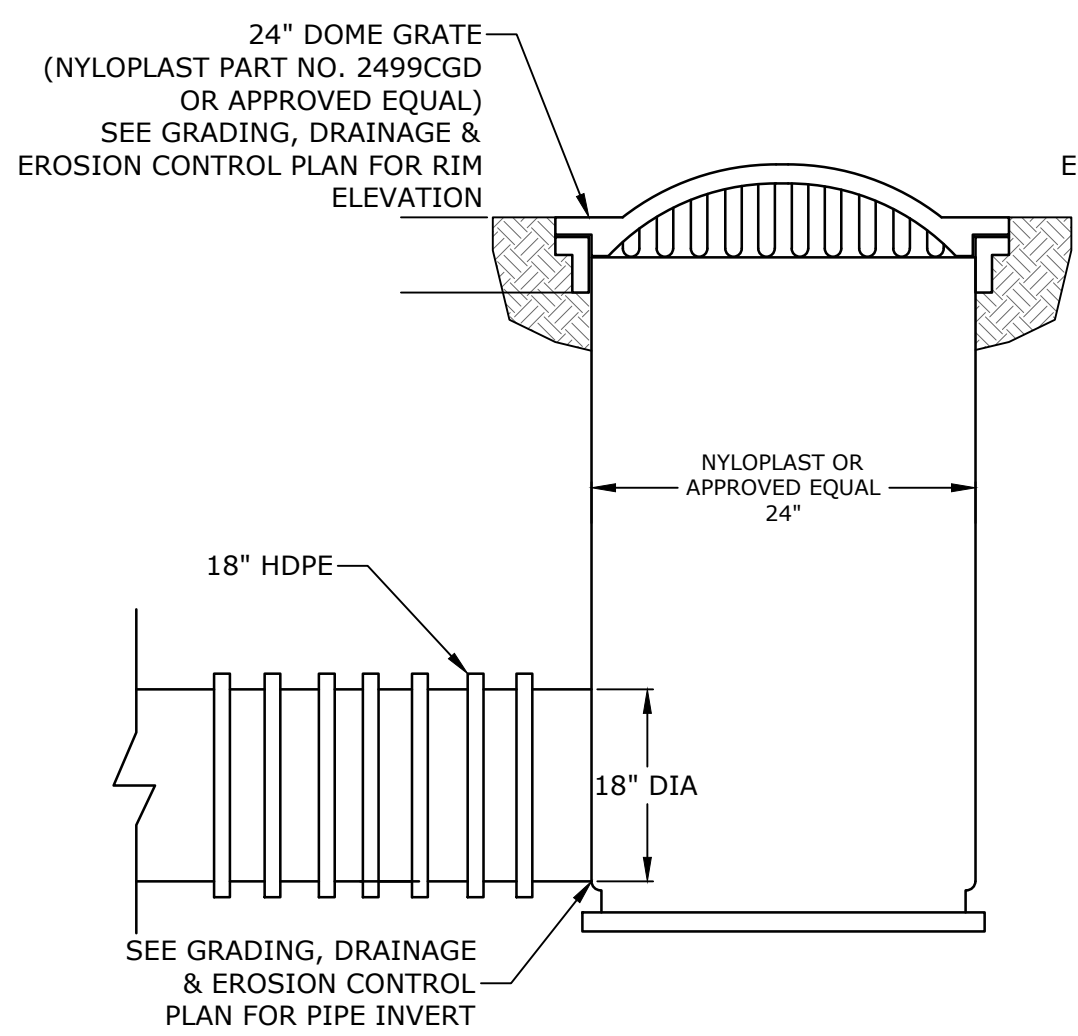PYD101
NO SCALE
PROPOSED YARD DRAINS
NO SCALE





PYD102 & PYD103
NO SCALE

- NOTES:**
1. GRATES/SOLID COVER SHALL BE DUCTILE IRON PER ASTM A536 GRADE 70-50-05.
 2. FRAMES SHALL BE DUCTILE IRON PER ASTM A536 GRADE 70-50-05
 3. SEE GRADING, DRAINAGE AND EROSION CONTROL PLAN FOR LOCATION.

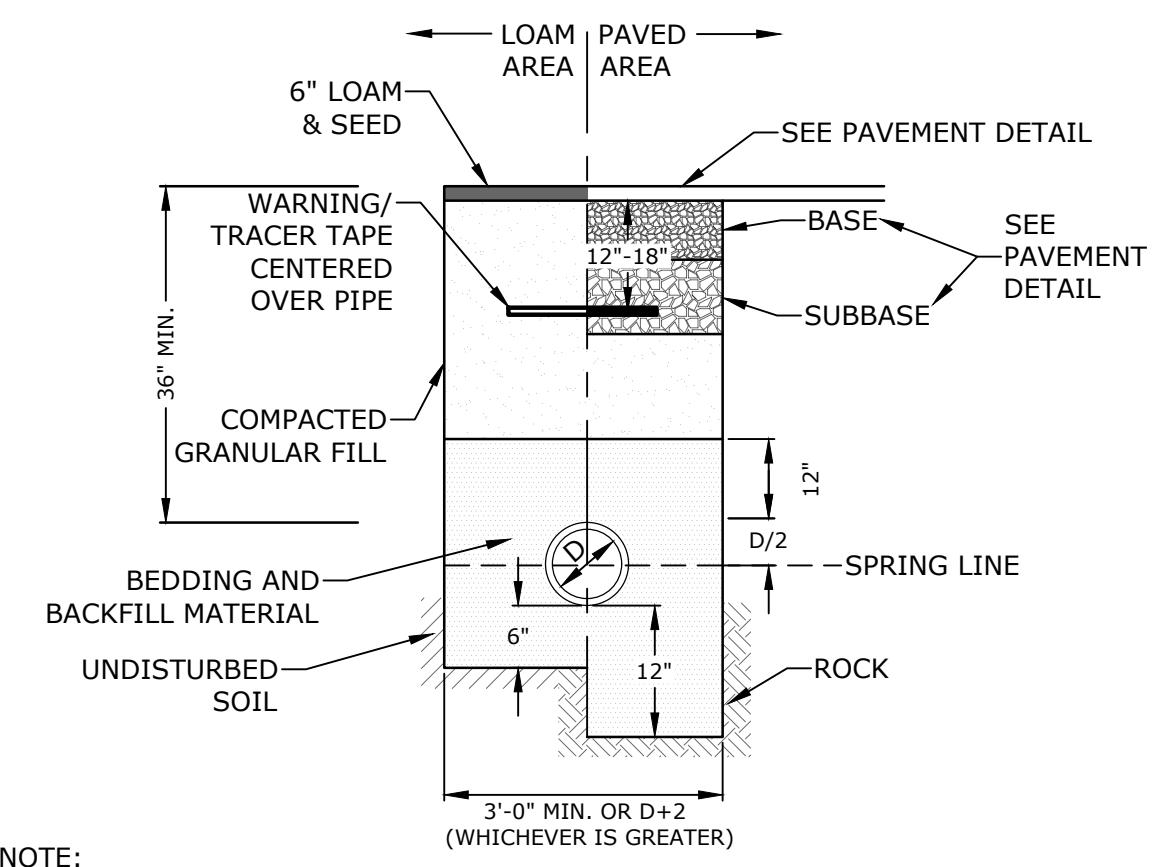


- NOTE:**
1. SAND BEDDING AND BACKFILL FOR FULL WIDTH OF THE TRENCH FROM 6" BELOW PIPE IN EARTH AND 12" BELOW PIPE IN ROCK UP TO 12" ABOVE TOP OF PIPE.
 2. GAS SHALL BE INSTALLED PER UNITIL STANDARDS. COORDINATE ALL INSTALLATIONS WITH UNITIL AND THE CITY OF PORTSMOUTH.

GAS TRENCH
NO SCALE

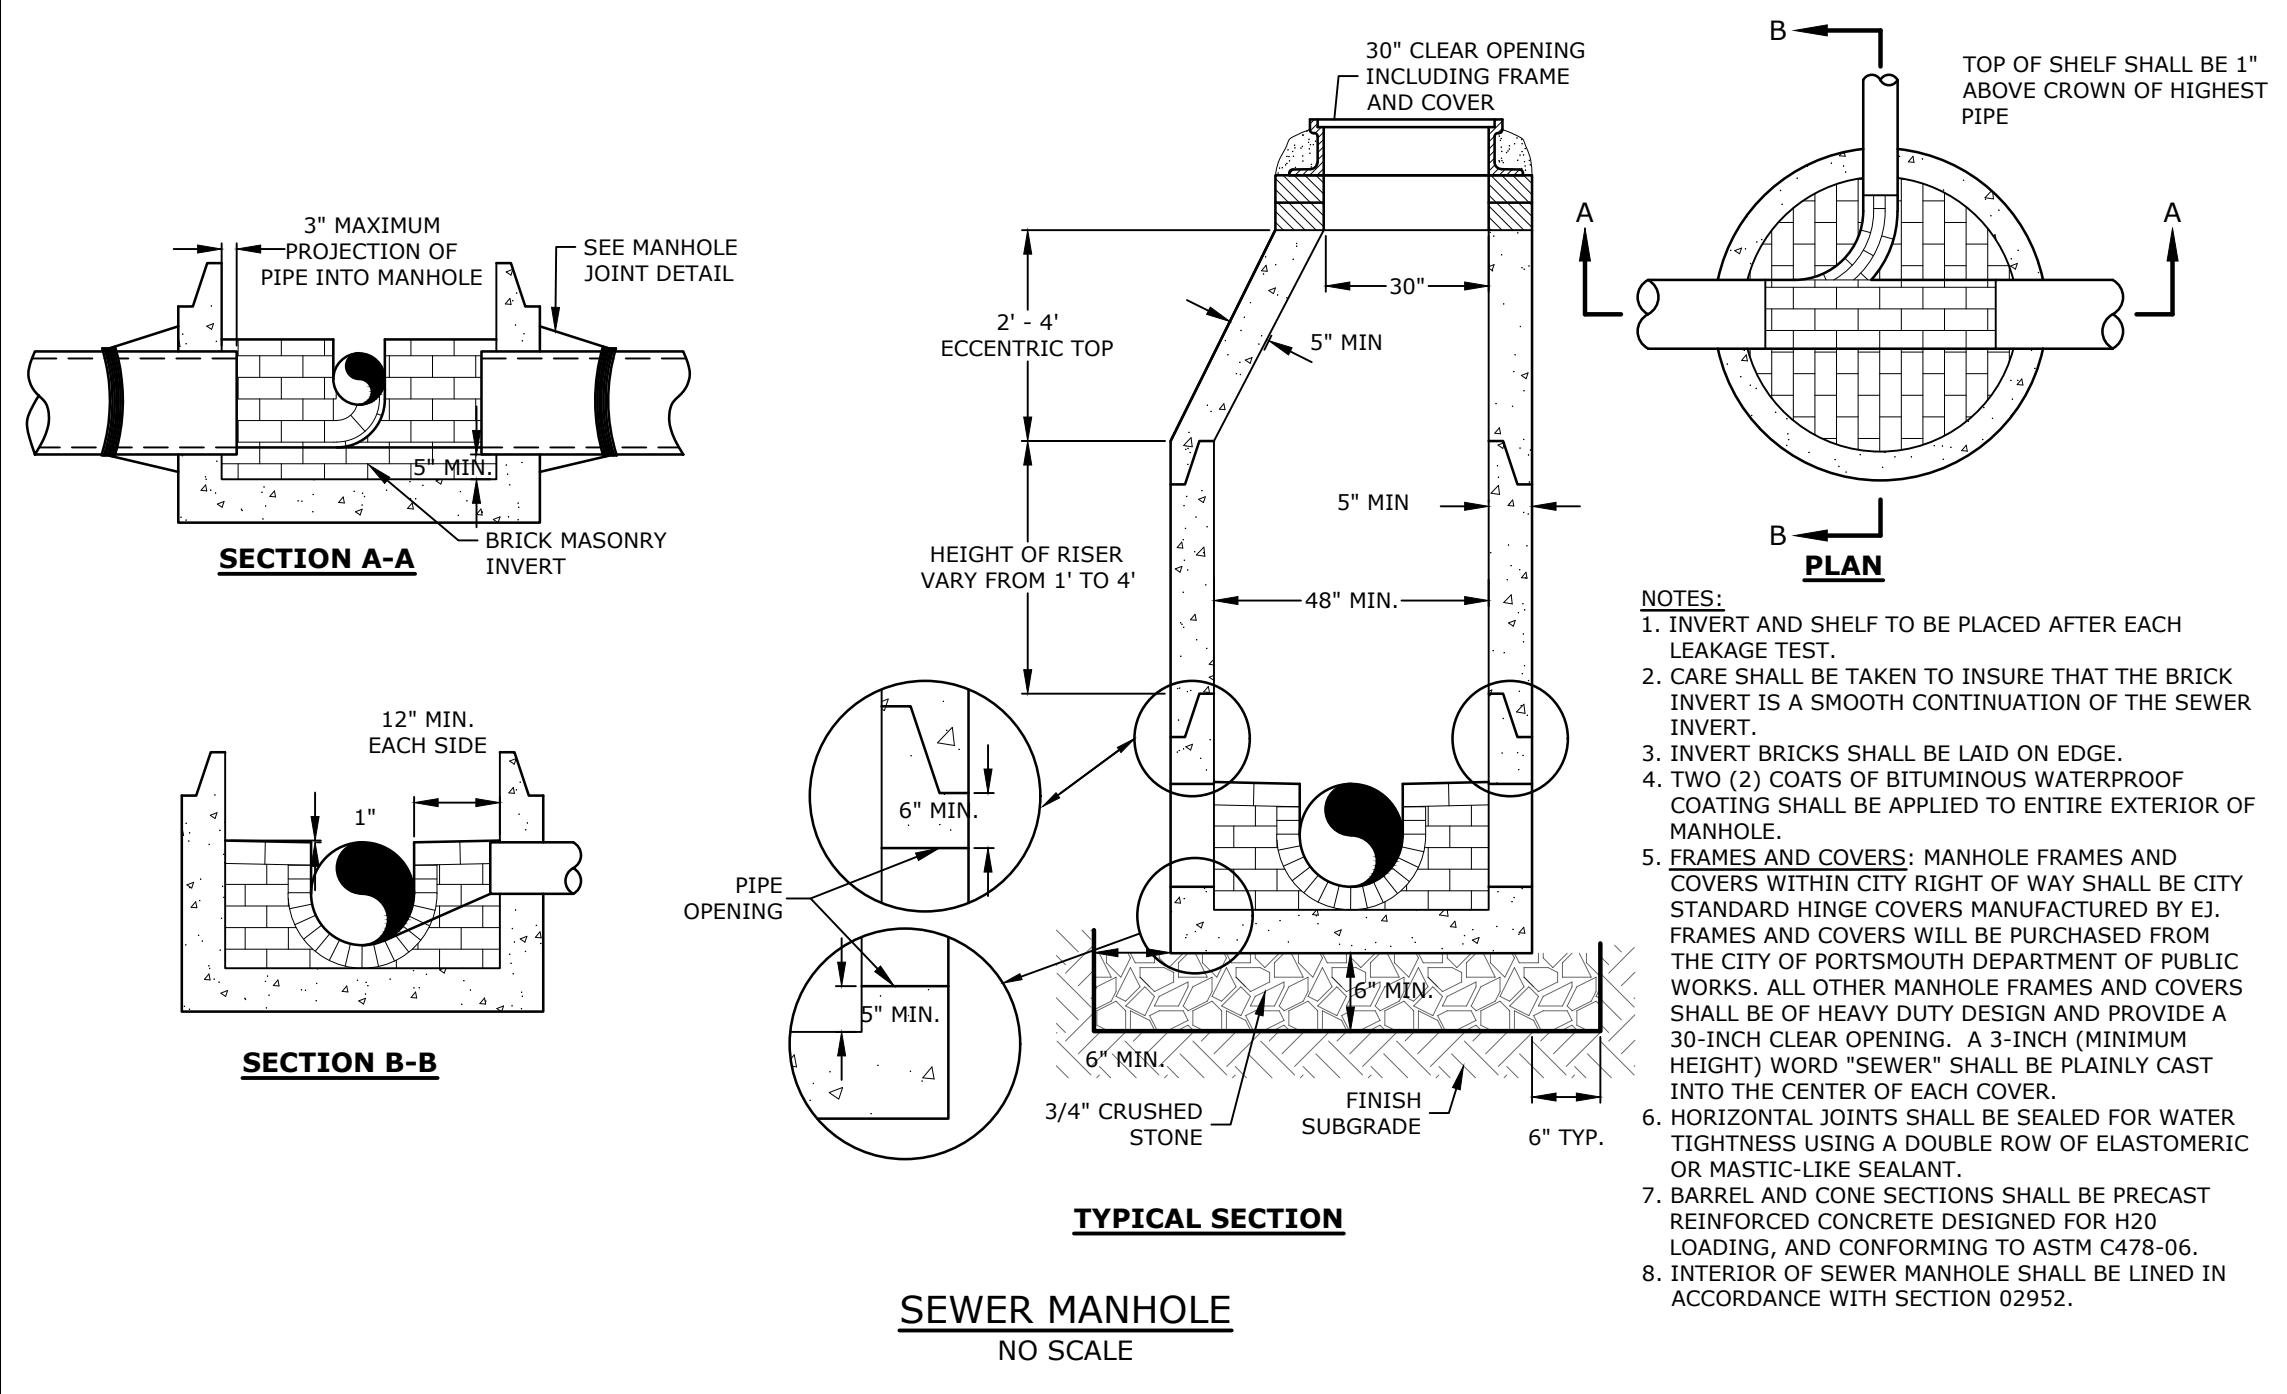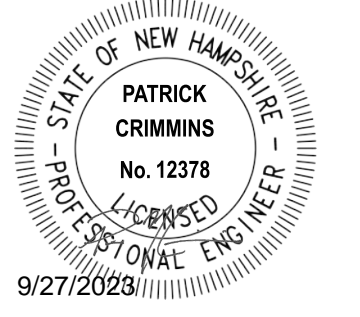

SEWER MANHOLE
NO SCALE

- NOTES:**
1. INVERT AND SHELF TO BE PLACED AFTER EACH LEAKAGE TEST.
 2. CARE SHALL BE TAKEN TO INSURE THAT THE BRICK INVERT IS A SMOOTH CONTINUATION OF THE SEWER INVERT.
 3. INVERT BRICKS SHALL BE LAID ON EDGE.
 4. TWO (2) COATS OF BITUMINOUS WATERPROOF COATING SHALL BE APPLIED TO ENTIRE EXTERIOR OF MANHOLE.
 5. FRAMES AND COVERS: MANHOLE FRAMES AND COVERS WITHIN CITY RIGHT OF WAY SHALL BE CITY STANDARD HINGE COVERS MANUFACTURED BY E.I. FRAMES AND COVERS WILL BE PURCHASED FROM THE CITY OF PORTSMOUTH DEPARTMENT OF PUBLIC WORKS. ALL OTHER MANHOLE FRAMES AND COVERS SHALL BE OF HEAVY DUTY DESIGN AND PROVIDE A 30-INCH CLEAR OPENING. A 3-INCH (MINIMUM HEIGHT) WORD "SEWER" SHALL BE PLAINLY CAST INTO THE CENTER OF EACH COVER.
 6. HORIZONTAL JOINTS SHALL BE SEALED FOR WATER TIGHTNESS USING A DOUBLE ROW OF ELASTOMERIC OR MASTIC-LIKE SEALANT.
 7. BARREL AND CONE SECTIONS SHALL BE PRECAST REINFORCED CONCRETE DESIGNED FOR H20 LOADING, AND CONFORMING TO ASTM C478-06.
 8. INTERIOR OF SEWER MANHOLE SHALL BE LINED IN ACCORDANCE WITH SECTION 02952.

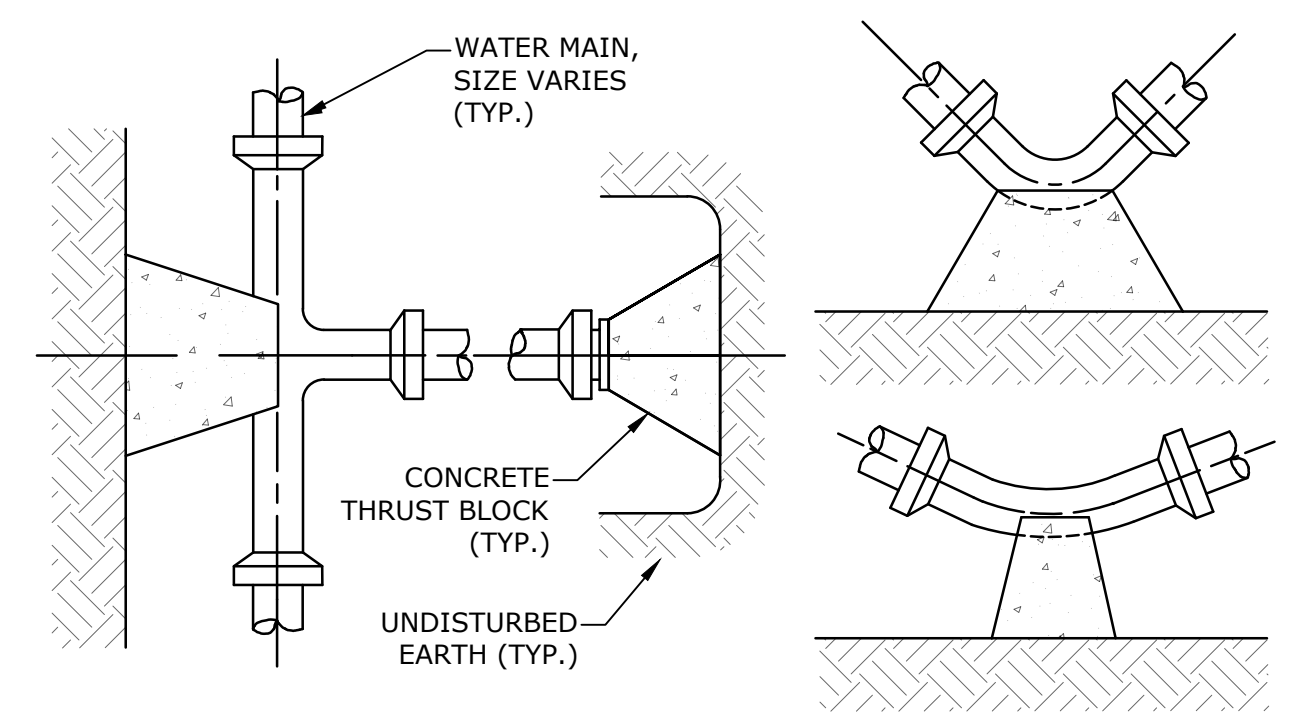


THRUST BLOCKING DETAIL
NO SCALE

REACTION TYPE	PIPE SIZE			
	4"	6"	8"	12"
A 90°	0.89	2.19	3.82	11.14
B 180°	0.65	1.55	2.78	8.38
C 45°	0.48	1.19	2.12	6.02
D 22-1/2°	0.25	0.60	1.06	3.08
E 11-1/4°	0.13	0.30	0.54	1.54


TEST PRESSURE = 200psi

- NOTES:**
1. POUR THRUST BLOCKS AGAINST UNDISTURBED MATERIAL, WHERE TRENCH WALL HAS BEEN DISTURBED, EXCAVATE LOOSE MATERIAL AND EXTEND THRUST BLOCK TO UNDISTURBED MATERIAL. NO JOINTS SHALL BE COVERED WITH CONCRETE.
 2. ON BENDS AND TEES, EXTEND THRUST BLOCKS FULL LENGTH OF FITTING.
 3. PLACE BOARD IN FRONT OF ALL PLUGS BEFORE POURING THRUST BLOCKS.
 4. WHERE M.J. PIPE IS USED, M.J. PLUG WITH RETAINER GLAND MAY BE SUBSTITUTED FOR END BLOCKINGS.
 5. INSTALLATION AND STANDARD DIMENSIONAL REQUIREMENTS SHALL BE WITH TOWN OF EXETER WATER DEPARTMENT STANDARDS.

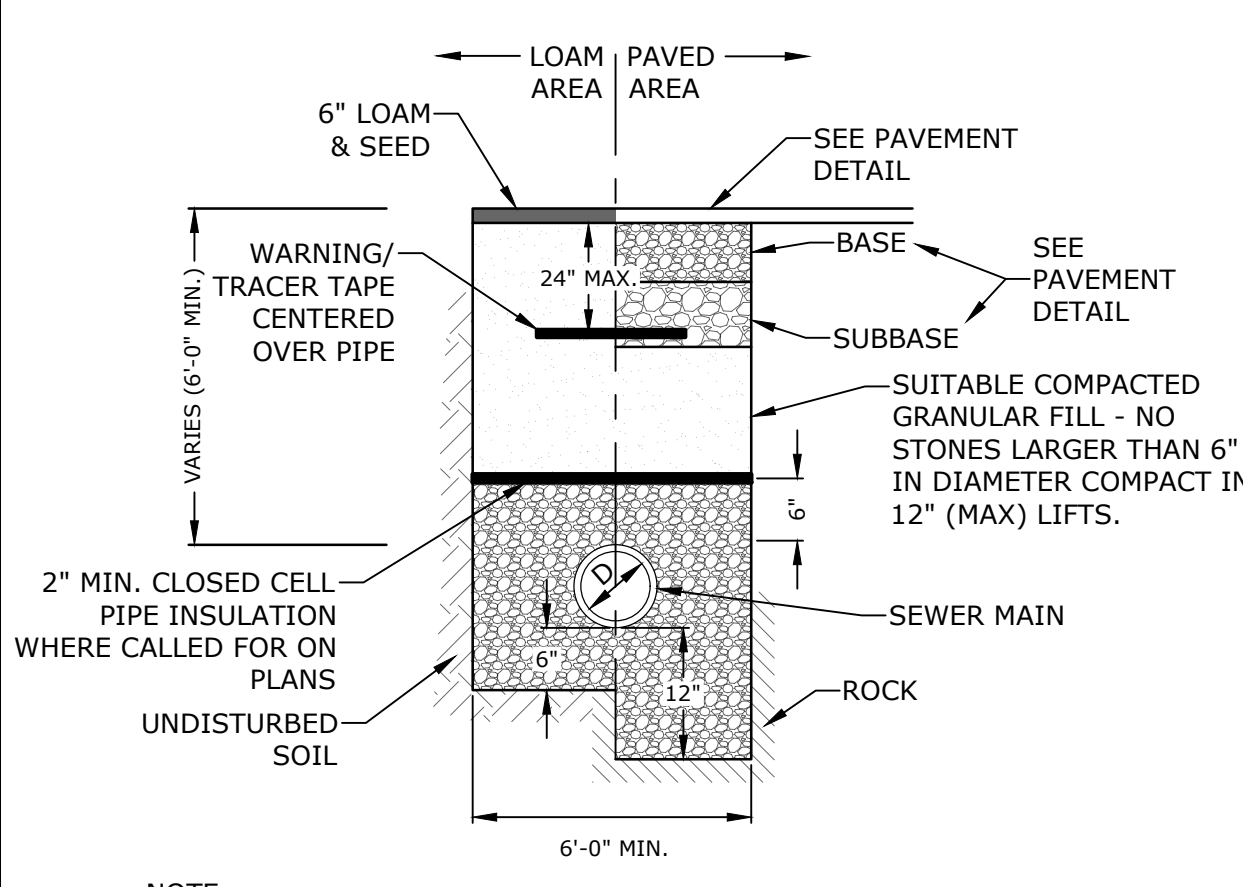


SEWER TRENCH
NO SCALE

- NOTE:**
1. COORDINATE ALL INSTALLATIONS WITH THE CITY OF PORTSMOUTH.

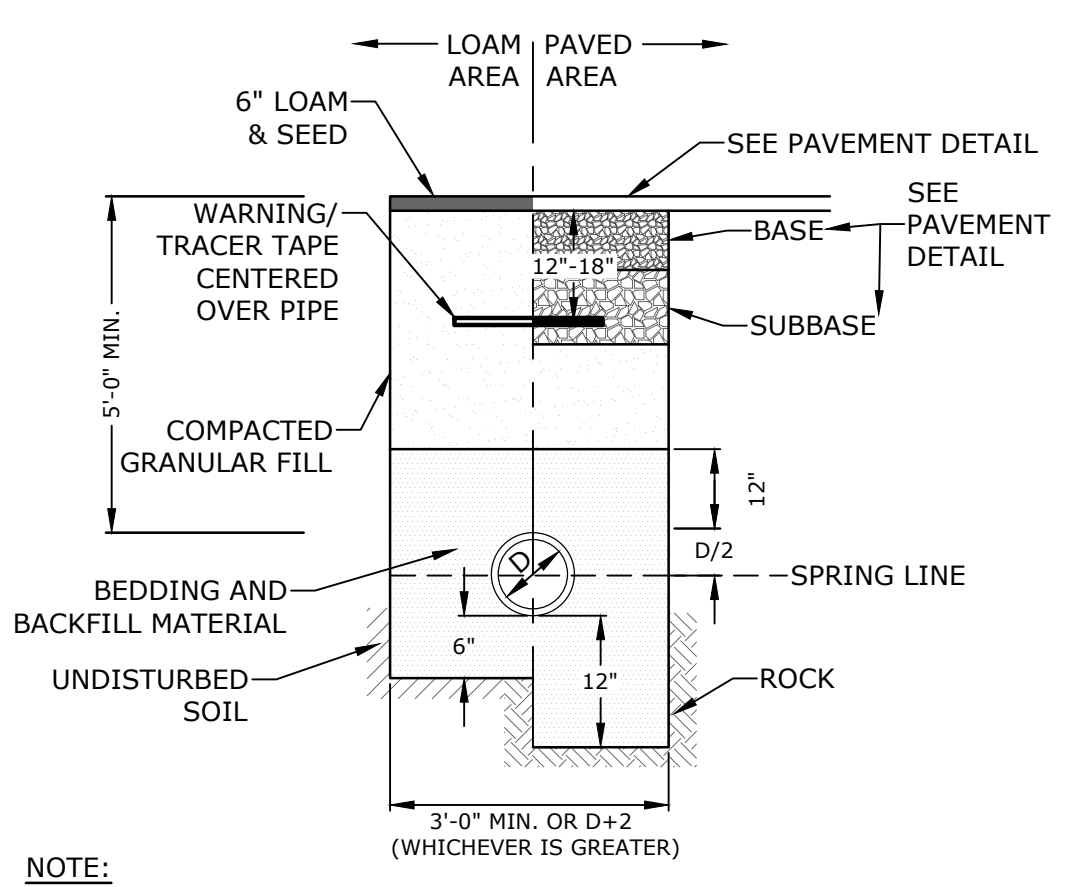


WATER TRENCH
NO SCALE

- NOTE:**
1. SAND BEDDING AND BACKFILL FOR FULL WIDTH OF THE TRENCH FROM 6" BELOW PIPE IN EARTH AND 12" BELOW PIPE IN ROCK UP TO 12" ABOVE TOP OF PIPE.
 2. WATER MAIN SHALL BE INSTALLED PER CITY OF PORTSMOUTH STANDARDS. COORDINATE ALL INSTALLATIONS WITH THE CITY OF PORTSMOUTH.

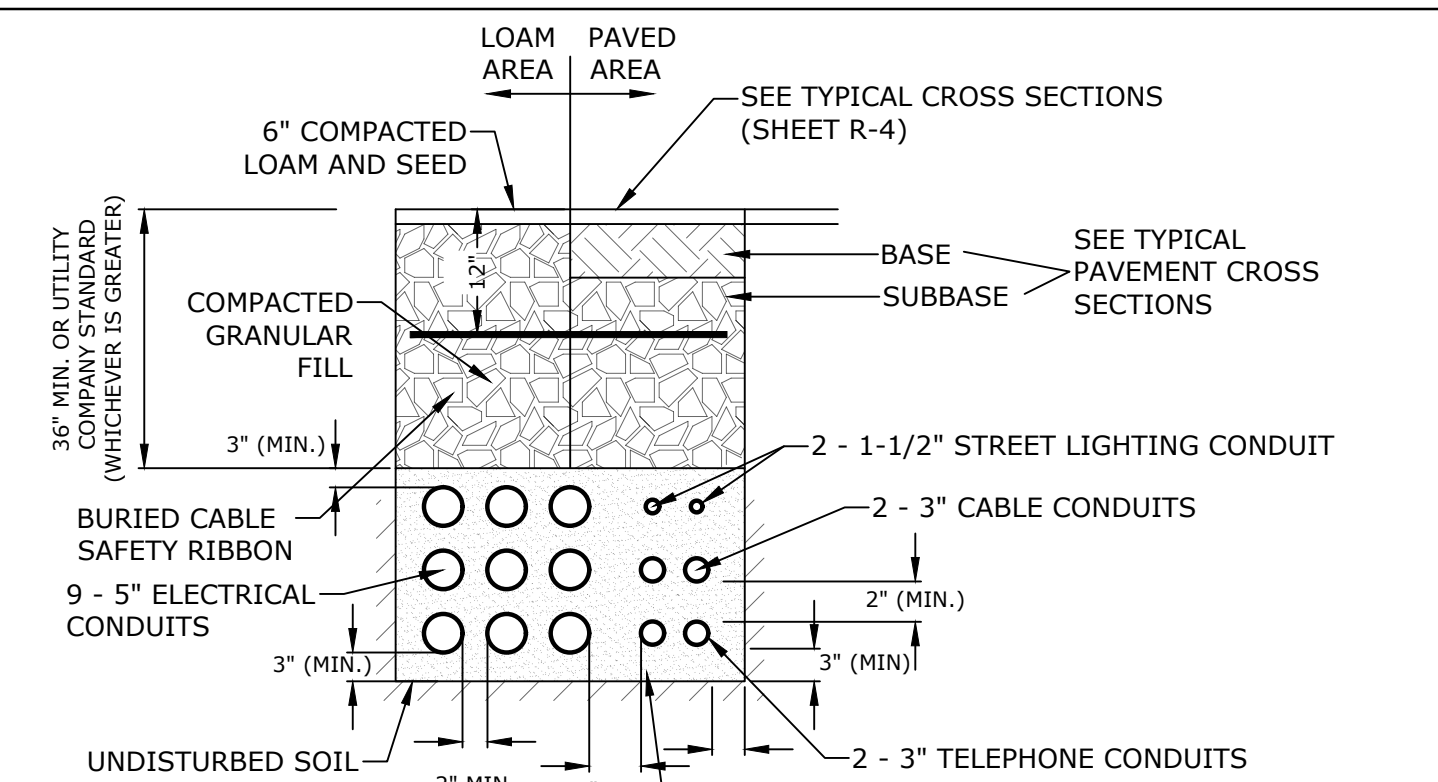

- NOTES:**
1. NUMBER, MATERIAL, AND SIZE OF UTILITY CONDUITS SHALL BE DETERMINED BY LOCAL UTILITY OR AS SHOWN ON ELECTRICAL DRAWINGS. CONTRACTOR TO PROVIDE ONE SPARE CONDUIT FOR EACH UTILITY TO BUILDING.
 2. DIMENSIONS SHOWN REPRESENT OWNERS MINIMUM REQUIREMENTS. ACTUAL DIMENSIONS MAY BE GREATER BASED ON UTILITY COMPANY STANDARDS, BUT SHALL NOT BE LESS THAN THOSE SHOWN. NO CONDUIT RUN SHALL EXCEED 360 DEGREES IN TOTAL BENDS.
 3. NO CONDUIT PULLING STRING, CAPABLE OF 200 POUNDS OF PULL, MUST BE INSTALLED IN THE CONDUIT BEFORE UTILITY COMPANY IS NOTIFIED TO INSTALL CABLE. THE STRING SHOULD BE BLOWN INTO THE CONDUIT AFTER THE RUN IS ASSEMBLED TO AVOID BONDING THE STRING TO THE CONDUIT.
 4. UTILITY COMPANY MUST BE GIVEN THE OPPORTUNITY TO INSPECT THE CONDUIT PRIOR TO BACKFILL. THE CONTRACTOR IS RESPONSIBLE FOR ALL REPAIRS SHOULD THE UTILITY COMPANY BE UNABLE TO INSTALL ITS CABLE IN A SUITABLE MANNER.
 5. ALL CONDUIT INSTALLATIONS MUST CONFORM TO THE CURRENT EDITION OF THE NATIONAL ELECTRIC SAFETY CODE, STATE AND LOCAL CODES AND ORDINANCES, AND, WHERE APPLICABLE, THE NATIONAL ELECTRIC CODE.
 6. ALL 90° SWEEPS WILL BE MADE USING RIGID GALVANIZED STEEL. SWEEPS WITH A 36 TO 48 INCH RADIUS.
 7. SAND BEDDING TO BE REPLACED WITH CONCRETE ENCASEMENT WHERE COVER IS LESS THAN 3 FEET, WHEN LOCATED BELOW PAVEMENT, OR WHERE SHOWN ON THE UTILITIES PLAN. COORDINATE LIMITS OF CONCRETE ENCASEMENT WITH EVERSOURCE.

ELECTRICAL AND COMMUNICATION CONDUIT
NO SCALE

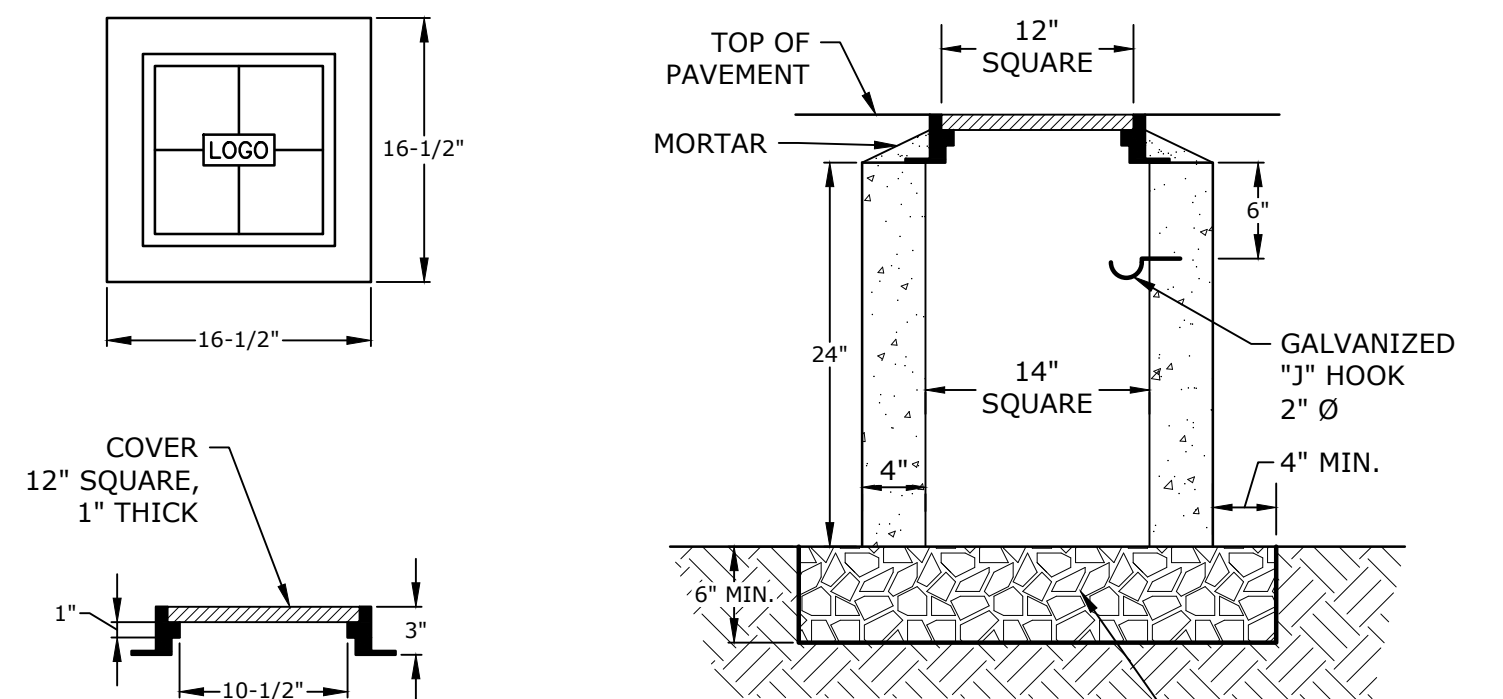

CONCRETE LIGHTING CONDUIT PULL BOX
NO SCALE

- NOTES:**
1. 14" X 14" CONCRETE PULL BOX, NHDOT ITEM 614.511

Proposed Industrial Development

Lonza Biologics

Portsmouth, New Hampshire

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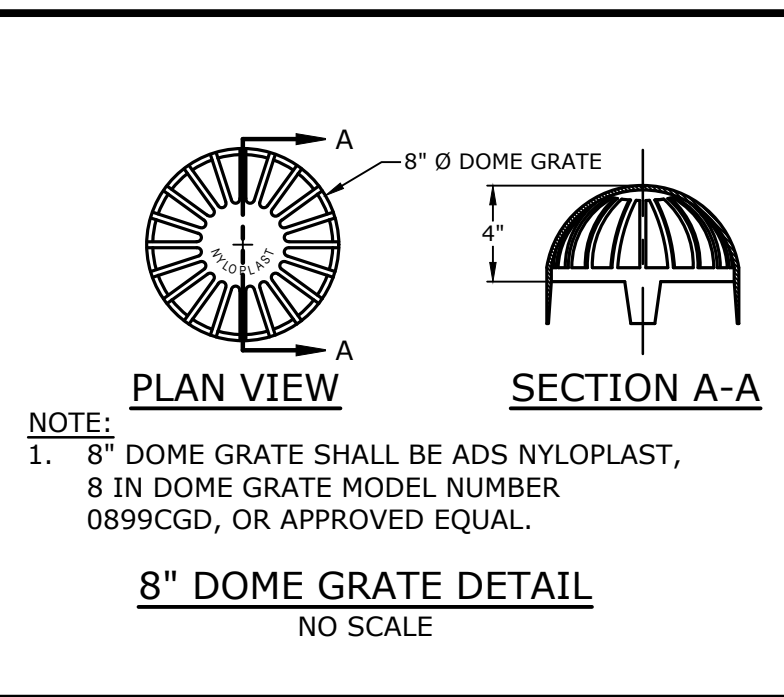
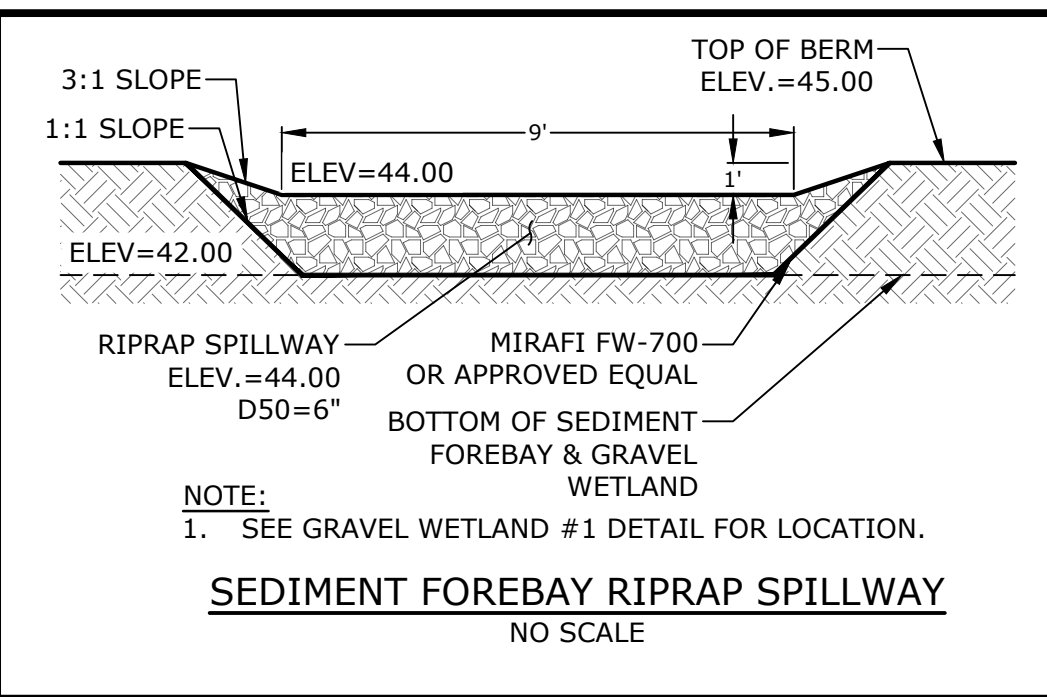
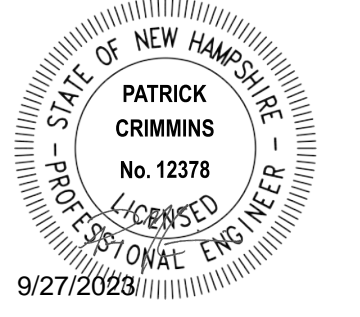
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APPROVED: PMC

DETAILS SHEET

SCALE: AS SHOWN



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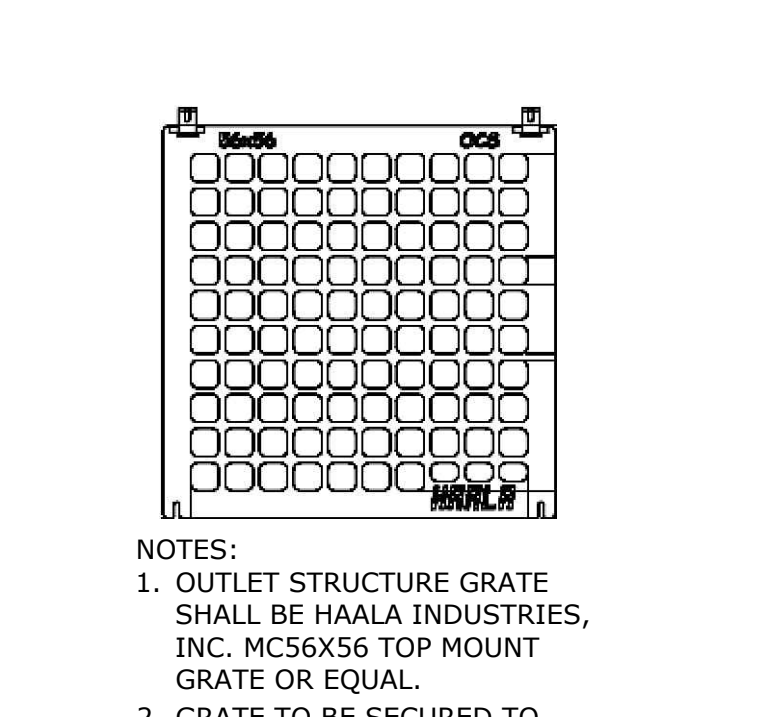
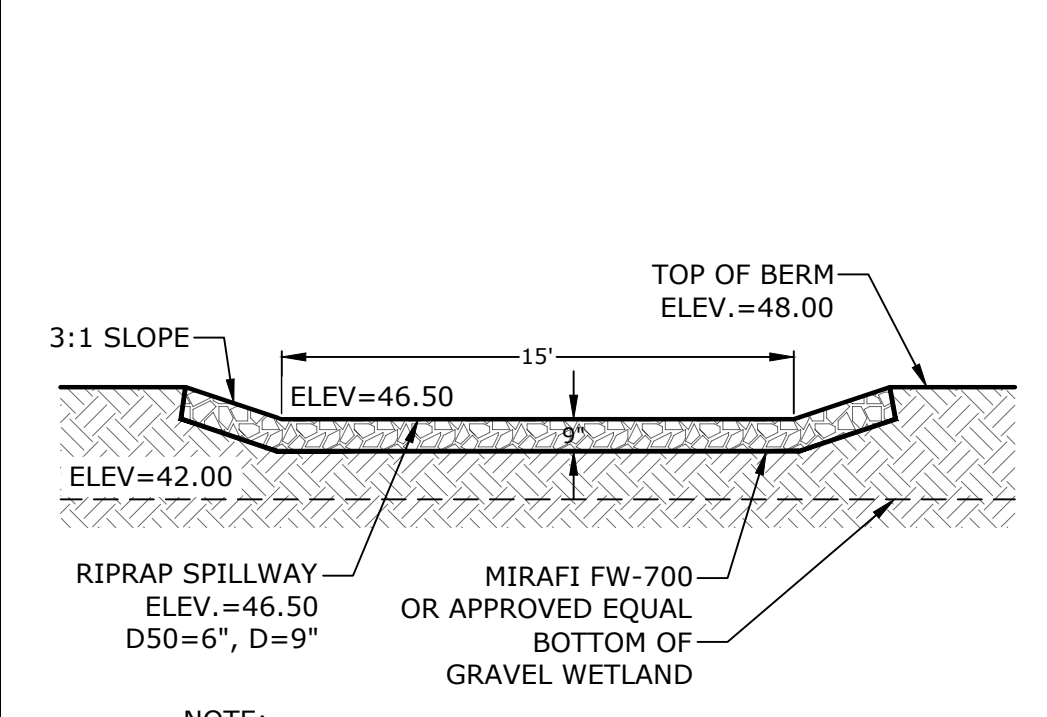
8" DOME GRATE DETAIL
NO SCALE

NOTE:
1. 8" DOME GRATE SHALL BE ADS NYLOPLAST, 8 IN DOME GRATE MODEL NUMBER 0899CGD, OR APPROVED EQUAL.





24" DOME GRATE DETAIL
NO SCALE

NOTE:
1. 24" DOME GRATE SHALL BE ADS NYLOPLAST, 24 IN DOME GRATE MODEL NUMBER 2499CGD, OR APPROVED EQUAL.

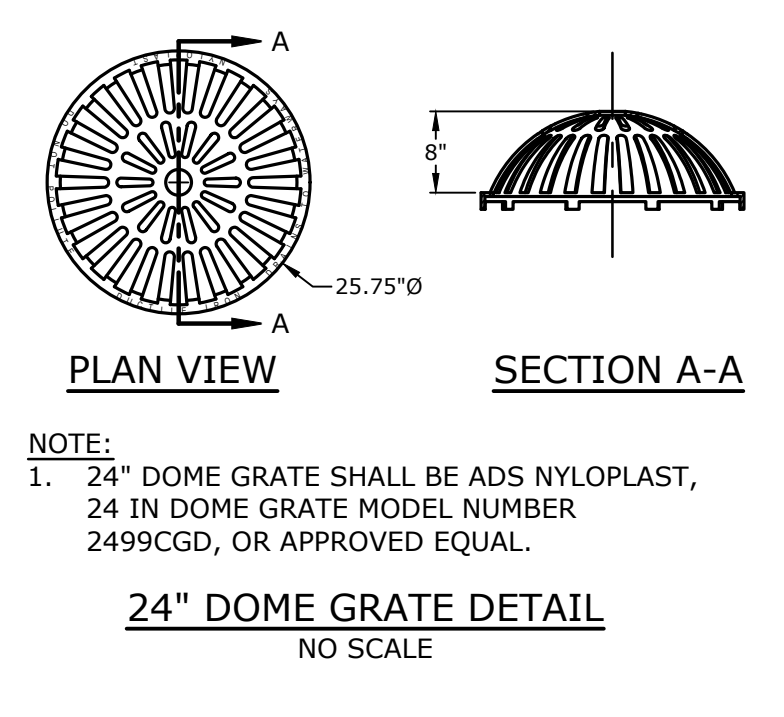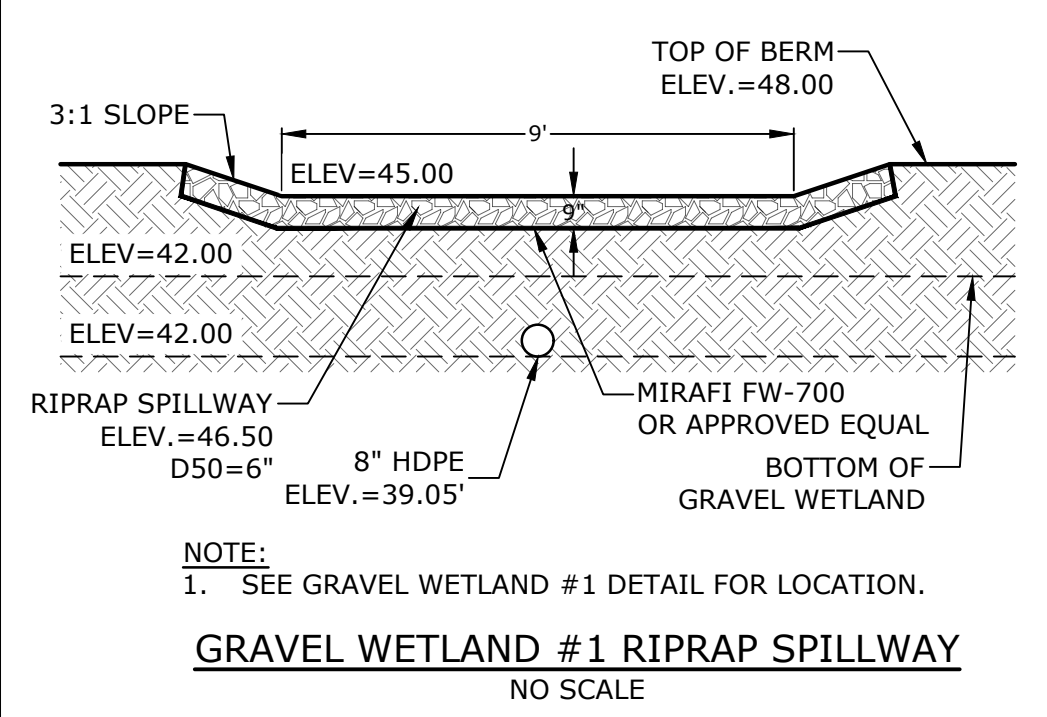



HAALA MC56X56 GRATE
NO SCALE

NOTES:
1. OUTLET STRUCTURE GRATE SHALL BE HAALA INDUSTRIES, INC. MC56X56 TOP MOUNT GRATE OR EQUAL.
2. GRATE TO BE SECURED TO CONCRETE STRUCTURE.

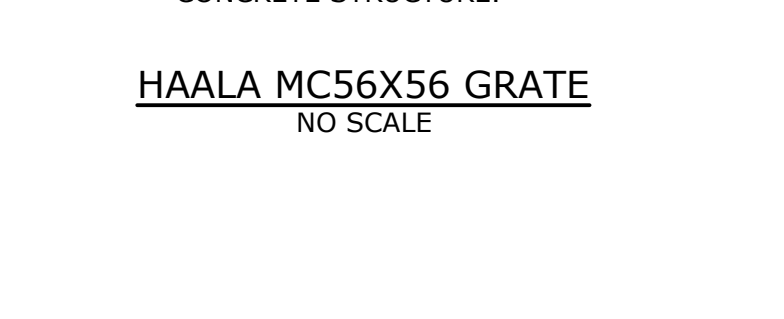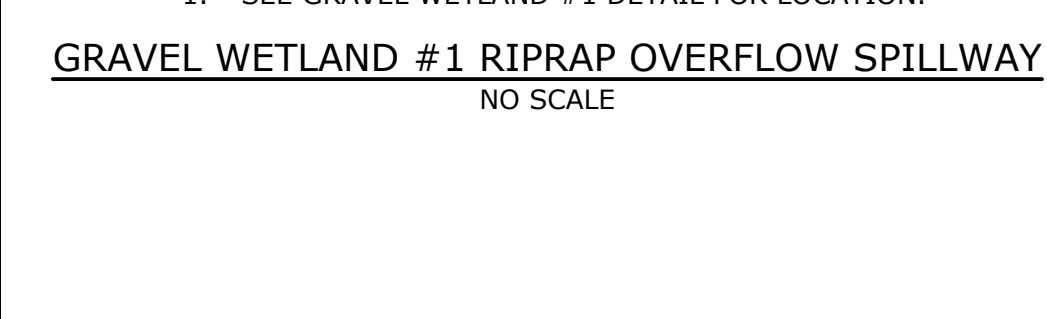

HAALA MC56X56 GRATE
NO SCALE

NOTES:
1. OUTLET STRUCTURE GRATE SHALL BE HAALA INDUSTRIES, INC. MC56X56 TOP MOUNT GRATE OR EQUAL.
2. GRATE TO BE SECURED TO CONCRETE STRUCTURE.

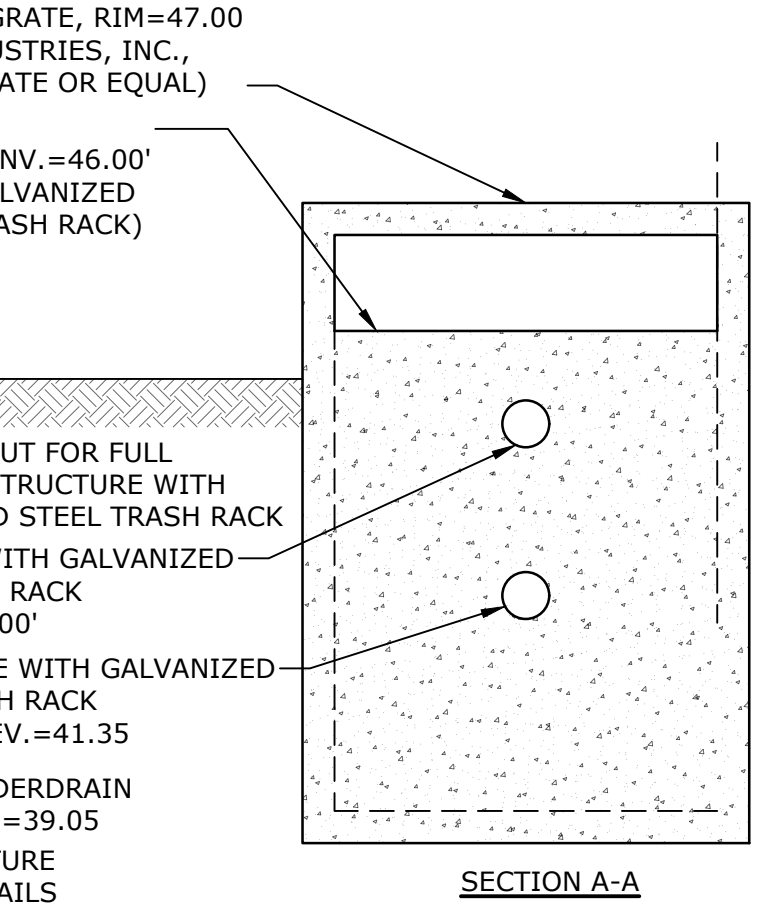
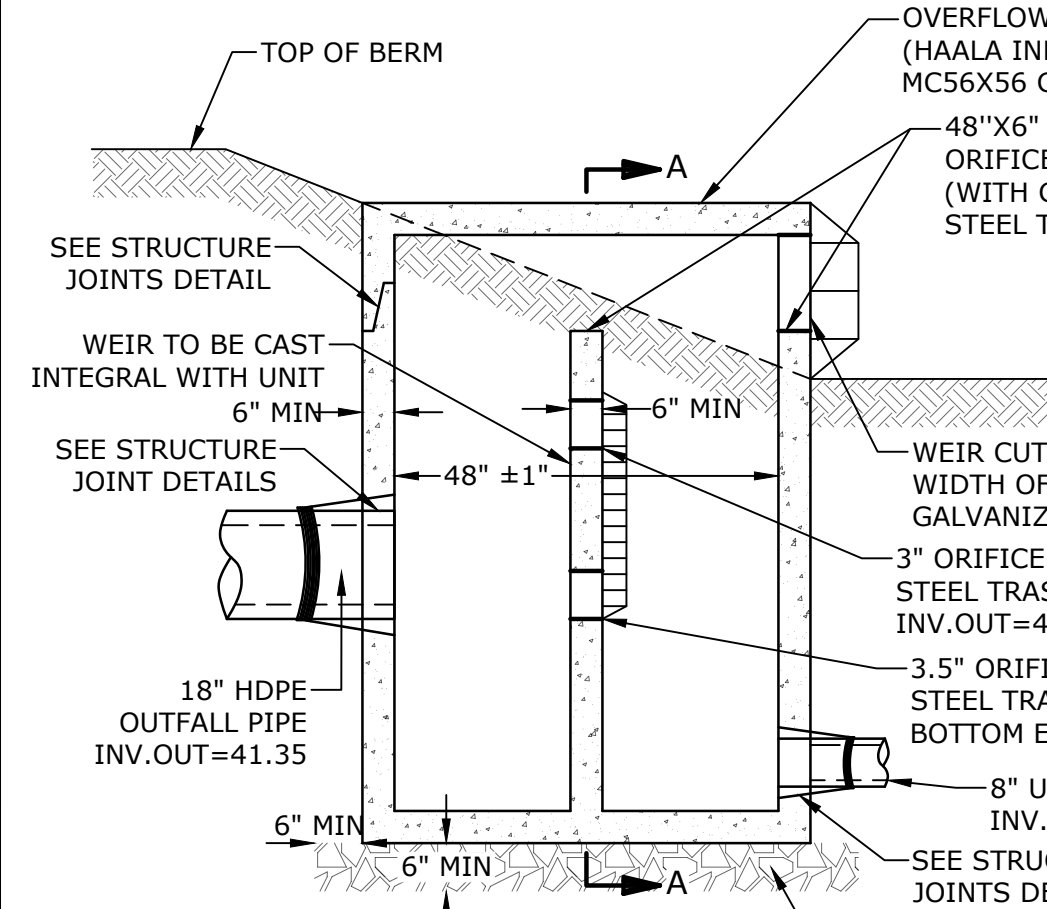


CRUSHED STONE (NHDOT ITEM No. 304.4)

SIEVE SIZE	% PASSING
2"	100
1-1/2"	85-100
3/4"	45-75
#4	10-45
#200	0-5

OUTLET STRUCTURE (POS101)
NO SCALE

NOTES:
1. ALL SECTIONS SHALL BE 4,000 PSI CONCRETE (TYPE II CEMENT).
2. CIRCUMFERENTIAL REINFORCEMENT SHALL BE 0.12 SQUARE INCHES PER LINEAR FOOT IN ALL SECTIONS AND SHALL BE PLACED IN THE CENTER OF THE THIRDE WALL.
3. THE TONGUE OR THE GROOVE OF THE JOINT SHALL CONTAIN ONE LINE OF CIRCUMFERENTIAL REINFORCEMENT EQUAL TO 0.12 SQUARE INCHES PER LINEAR FOOT.
4. THE STRUCTURES SHALL BE DESIGNED FOR H2O LOADING.
5. ALL JOINTS ON THE STRUCTURE AND PIPING SHALL BE WATERTIGHT.

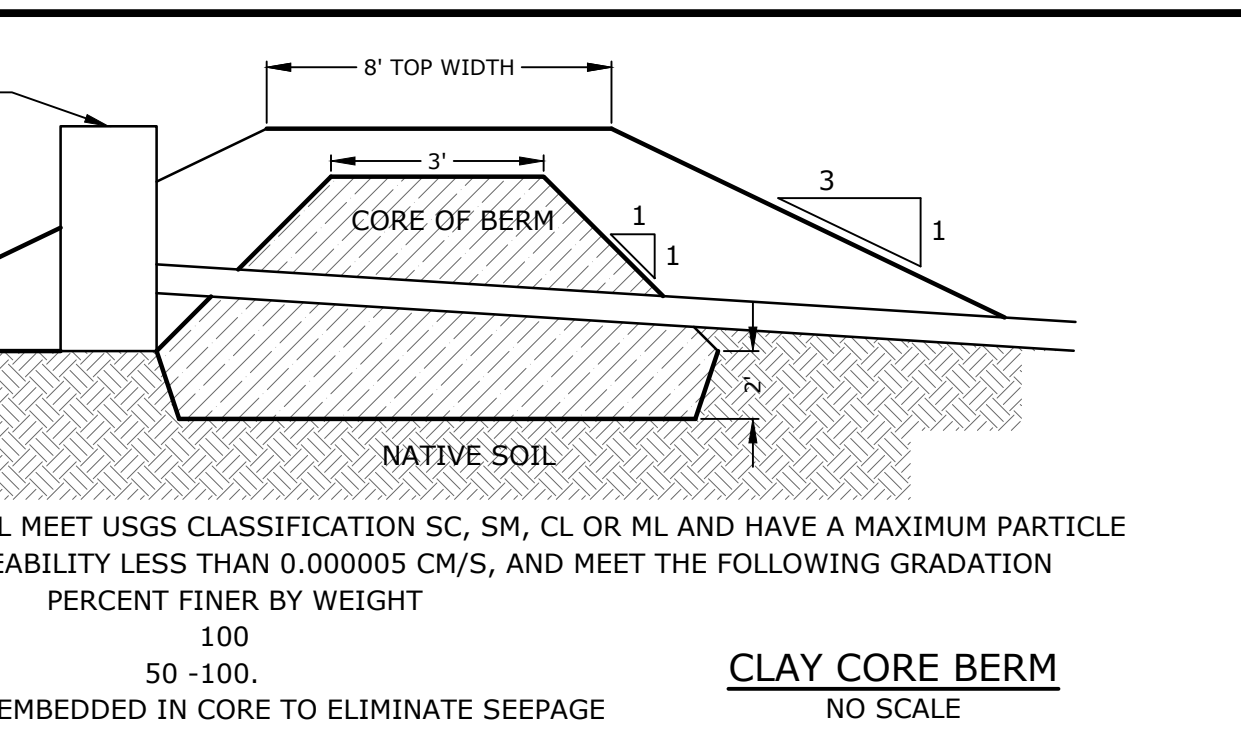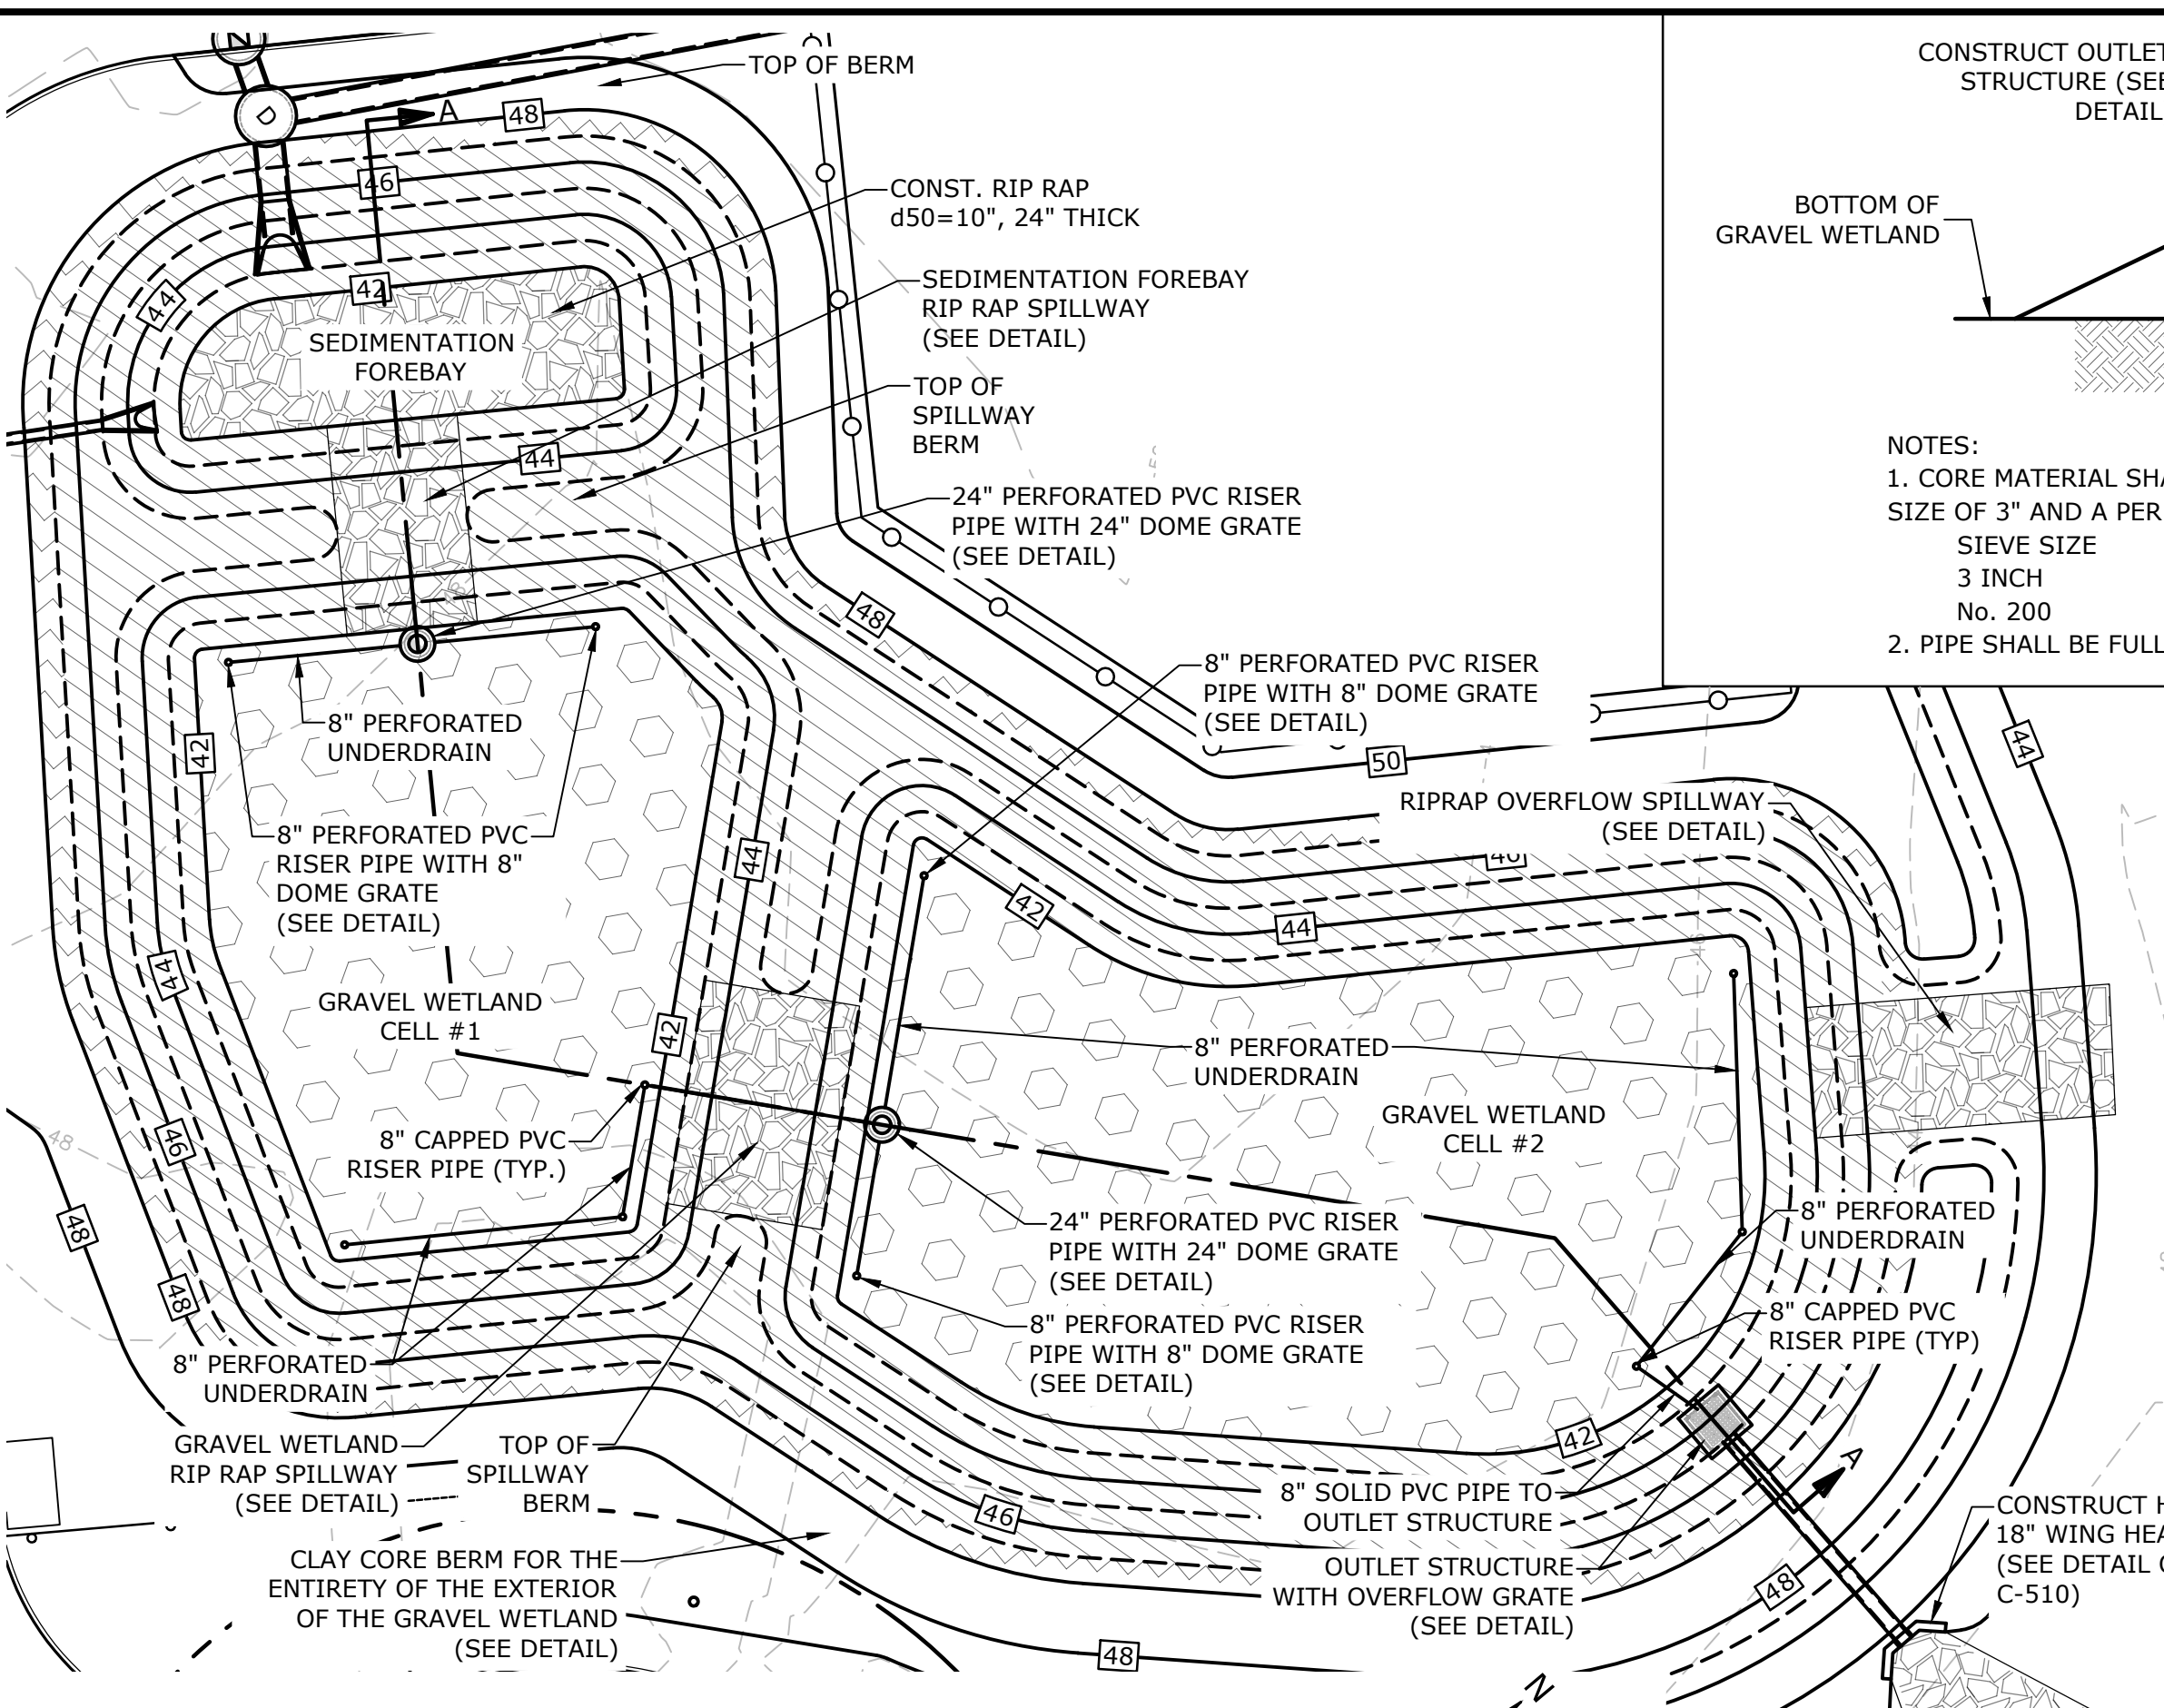


CLAY CORE BERM
NO SCALE

NOTES:
1. CORE MATERIAL SHALL MEET USGS CLASSIFICATION SC, SM, CL OR ML AND HAVE A MAXIMUM PARTICLE SIZE OF 3" AND A PERMEABILITY LESS THAN 0.000005 CM/S, AND MEET THE FOLLOWING GRADATION
SIEVE SIZE PERCENT FINER BY WEIGHT
3 INCH 100
3/8 INCH 50-100
2. PIPE SHALL BE FULLY EMBEDDED IN CORE TO ELIMINATE SEEPAGE

GRAVEL WETLAND PLANTING PLAN

SPECIES	PLANT SIZE	QUANTITY/ SPACING
NEW ENGLAND WETMIX, WETLAND SEED MIX OR EQUIVALENT		18 LB/ACRE
NEW ENGLAND EROSION CONTROL/RESTORATION MIX OR EQUIVALENT		35 LB/ACRE
"RED OSIER DOGWOOD" CORNUS SERICEA AND "SUMMERSWEET CLETHRA" CLETHRA ALNIFOLIA	2'-3'	8'-10' ON CENTER
NEW ENGLAND EROSION CONTROL/RESTORATION MIX OR EQUIVALENT		35 LB/ACRE
"SILKY DOGWOOD" CORNUS AMOMUM AND "HIGHBUSH BLUEBERRY" VACCINIUM CORYMBOSUM AND "WINTERBERRY" ILEX VERTICILLATA	2'-3'	8'-10' ON CENTER

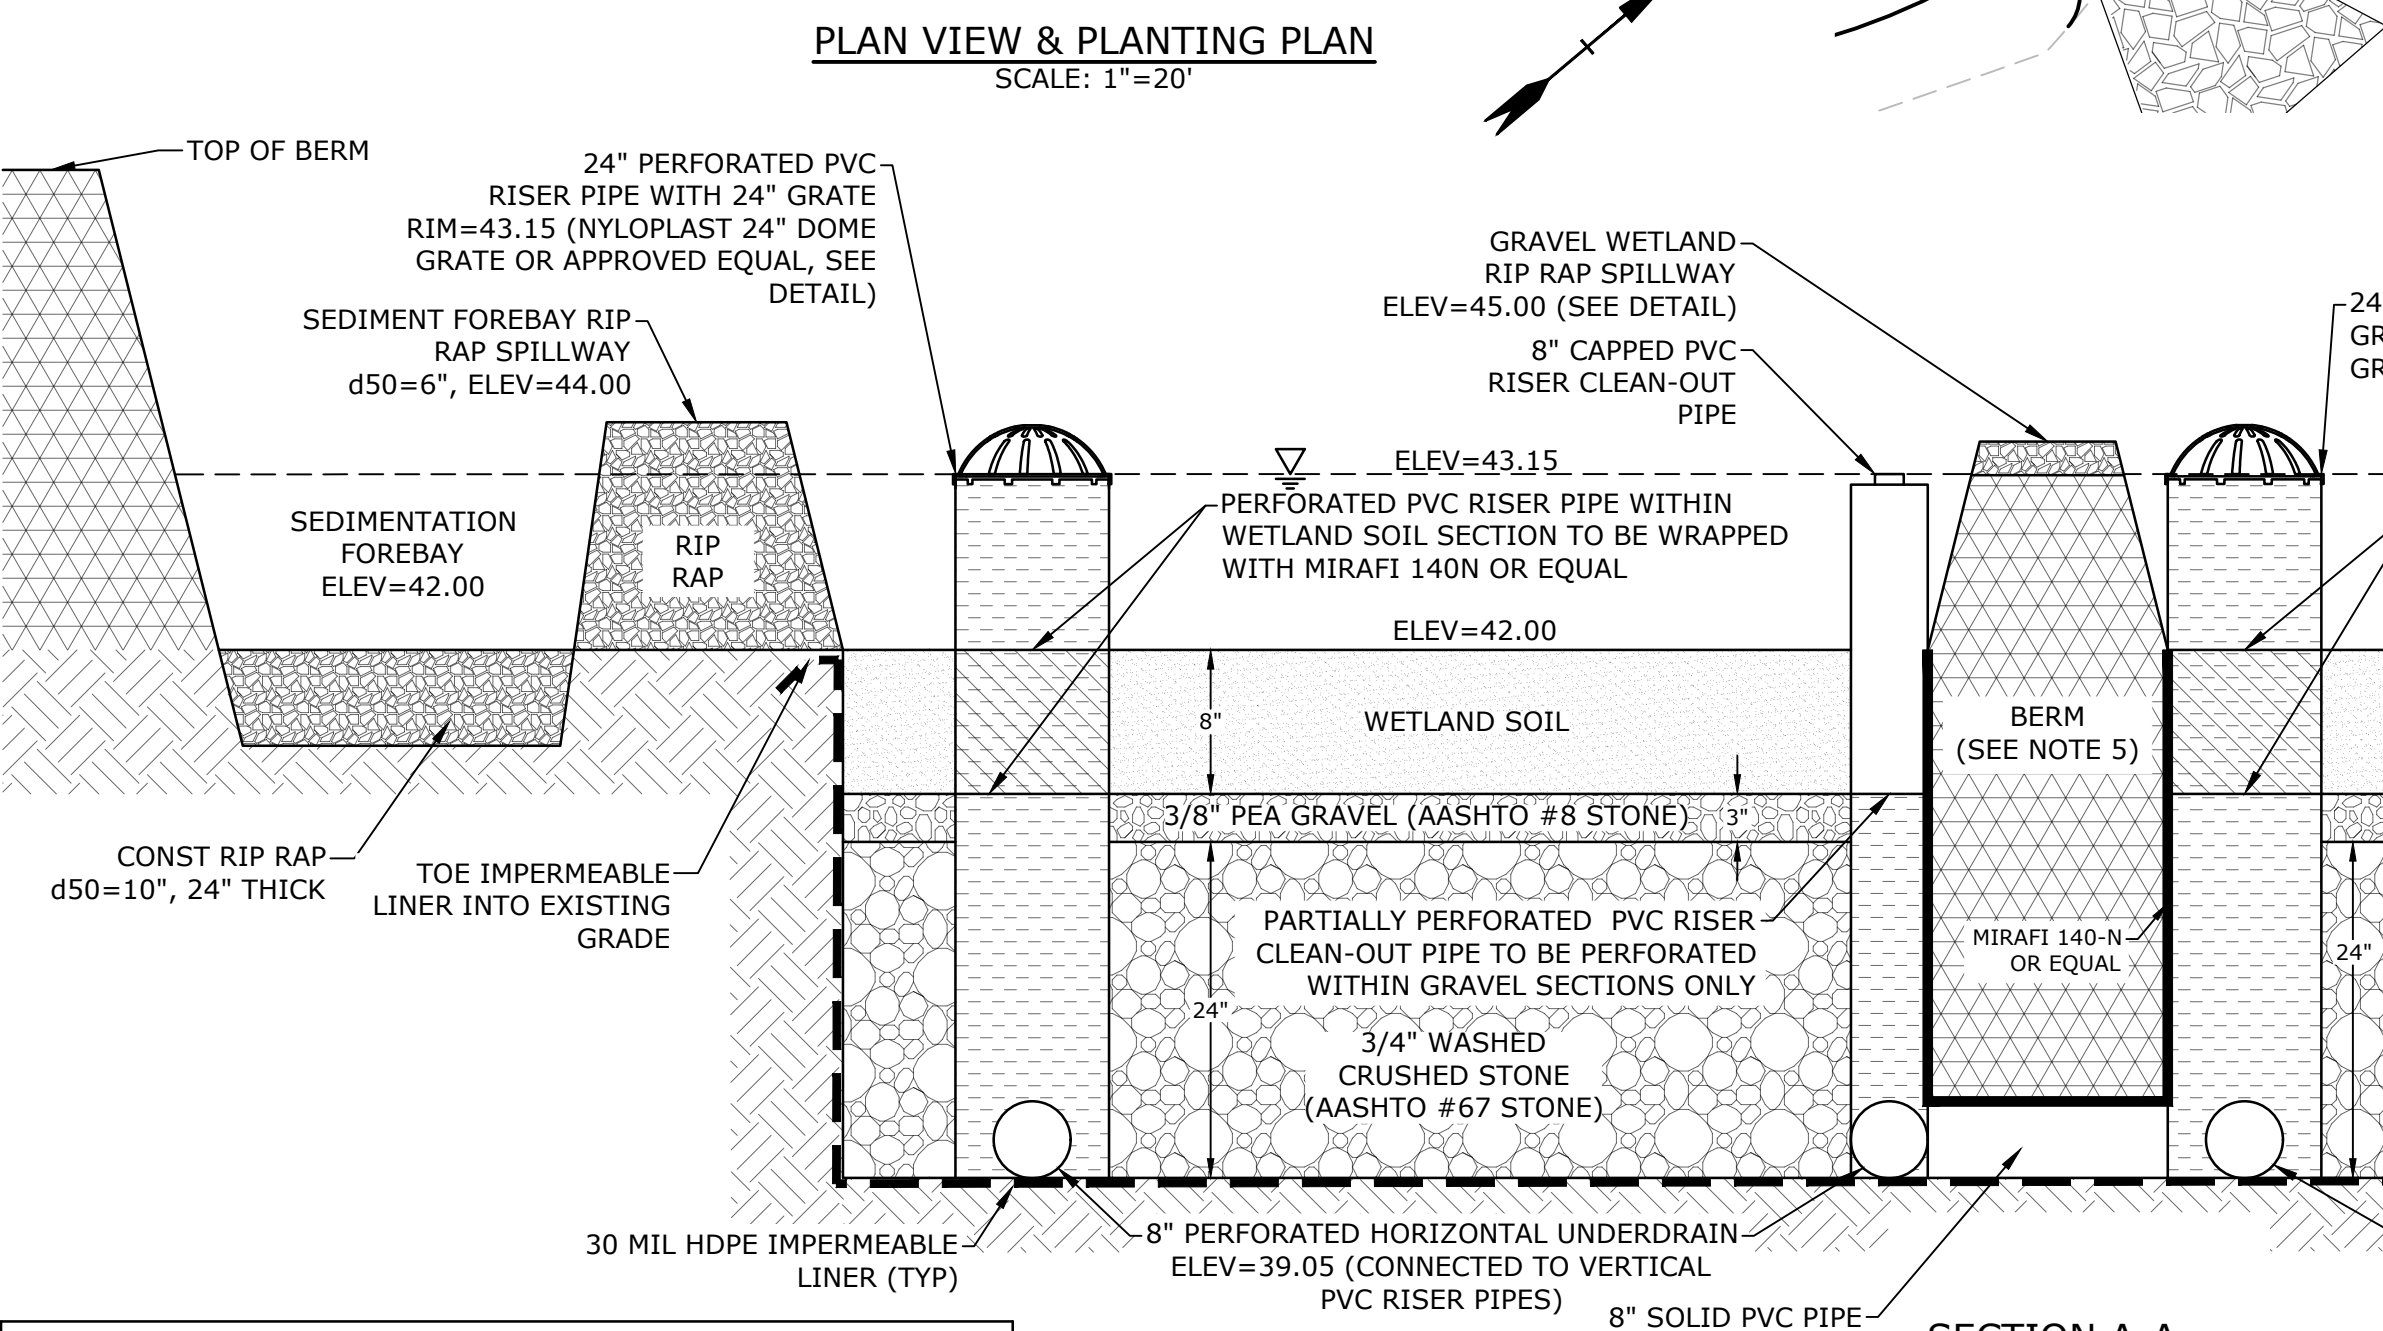

GRAVEL WETLAND INSPECTION / MAINTENANCE REQUIREMENTS

INSPECTION / MAINTENANCE	FREQUENCY	ACTION
MONITOR TO ENSURE THAT GRAVEL WETLAND FUNCTIONS EFFECTIVELY AFTER STORMS	FOUR (4) TIMES ANNUALLY (QUARTERLY) AND AFTER ANY RAINFALL EVENT EXCEEDING 2.5" IN A 24-HR PERIOD	- TRASH AND DEBRIS TO BE REMOVED - ANY REQUIRED MAINTENANCE SHALL BE ADDRESSED - INSPECT SOIL AND REPAIR ERODED AREAS, ESPECIALLY ON SLOPES. - CHECK INLETS, OUTLETS, AND OVERFLOW SPILLWAY FOR BLOCKAGE, STRUCTURAL INTEGRITY AND EVIDENCE OF EROSION.
INSPECT VEGETATION	ANNUALLY	- INSPECT THE CONDITION OF ALL GRAVEL WETLAND VEGETATION - PRUNE BACK OVERGROWTH - REPLACE DEAD VEGETATION - REMOVE ANY INVASIVE SPECIES - COORDINATE WITH UNH STORMWATER CENTER FOR FURTHER VEGETATION MANAGEMENT GUIDELINES
INSPECT DRAWDOWN TIME	ANNUALLY	- HIRE QUALIFIED PROFESSIONAL TO ASSESS THE CONDITION OF THE FACILITY TO DETERMINE MEASURES REQUIRED TO RESTORE THE FILTRATION FUNCTION, INCLUDING BUT NOT LIMITED TO REMOVAL OF ACCUMULATED SEDIMENTS OR RECONSTRUCTION OF THE FILTER.

SECTION A-A
NO SCALE

NOTES:
1. WETLAND SOIL SHALL BE A SANDY CLAY LOAM WITH A HYDRAULIC CONDUCTIVITY OF 0.1-0.01 FT/DAY. ORGANIC CONTENT SHALL BE GREATER THAN 15% BY VOLUME. CLAY CONTENT SHALL BE LESS THAN 15% BY VOLUME.
2. CONTRACTOR MAY REUSE EXISTING ON-SITE WETLAND SOILS. TESTING MUST BE PERFORMED BY THE CONTRACTOR PRIOR TO SOIL REUSE TO DETERMINE IF THE EXISTING WETLAND SOILS MEET THE CRITERIA LISTED IN NOTE 1. IF THE EXISTING SOILS DO NOT MEET THE CRITERIA OF WETLAND SOILS AS DEFINED IN NOTE 1 THEY MAY NOT BE REUSED.
3. PERFORATED PVC RISERS SHALL HAVE VERTICAL SLOTS CUT INTO PVC RISERS ABOVE GRADE MEASURING 3"x1/8".
4. GRAVEL WETLAND SOIL SHALL BE SEEDDED WITH NEW ENGLAND EROSION CONTROL/RESTORATION MIX OR EQUIVALENT AT A RATE OF 35 LB/ACRE.
5. BERM MATERIAL SHALL CONSIST OF NATIVE SOIL OR COMMON FILL.
6. A PRE-INSTALL MEETING SHALL BE HELD WITH THE CONTRACTOR RESPONSIBLE FOR GRAVEL WETLAND CONSTRUCTION AND THE DESIGN ENGINEER.
7. GRAVEL WETLAND TREATMENT CELLS SHALL BE LINED WITH AN IMPERMEABLE LINER.
8. IT IS THE DESIGN ENGINEERS RECOMMENDATION THAT THE GRAVEL WETLAND BE CONSTRUCTED IN THE DRY TO ACHIEVE THE ANTICIPATED TREATMENT QUALITY STANDARDS.
9. THE SLOPED SIDES OF THE GRAVEL WETLAND SHALL RECEIVE EROSION CONTROL MATTING. SEE DETAIL EROSION CONTROL BLANKET DETAIL.

AASHTO #8 STONE (#8 to 3/8")

SIEVE SIZE	% PASSING
1/2"	100
3/8"	85-100
#4	10-30
#8	0-10
#16	0-5

AASHTO #67 STONE (#4 to 3/4")

SIEVE SIZE	% PASSING
1"	100
3/4"	90-100
3/8"	20-55
#4	0-10
#8	0-5

Proposed Industrial Development

Lonza Biologics

Portsmouth, New Hampshire






MARK	DATE	DESCRIPTION
M	9/27/2023	P.B. Submission
L	7/17/2023	Amended Site Plan Review
K	5/5/2023	Phase 1B Issued for Bid
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DRAWN BY: CJK
CHECKED: NAH
APPROVED: PMC

DETAILS SHEETS


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C-507




NOTES:
1. OUTLET STRUCTURE GRATE SHALL BE HAALA INDUSTRIES, INC. MC56X56 TOP MOUNT GRATE OR EQUAL.
2. GRATE TO BE SECURED TO CONCRETE STRUCTURE.

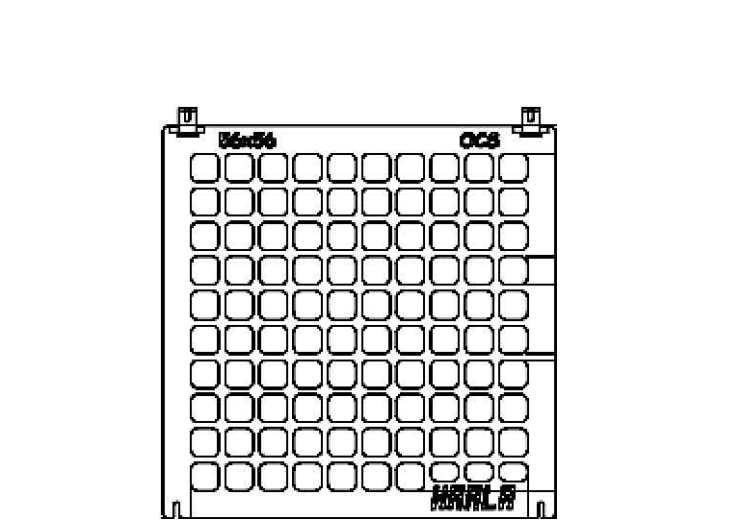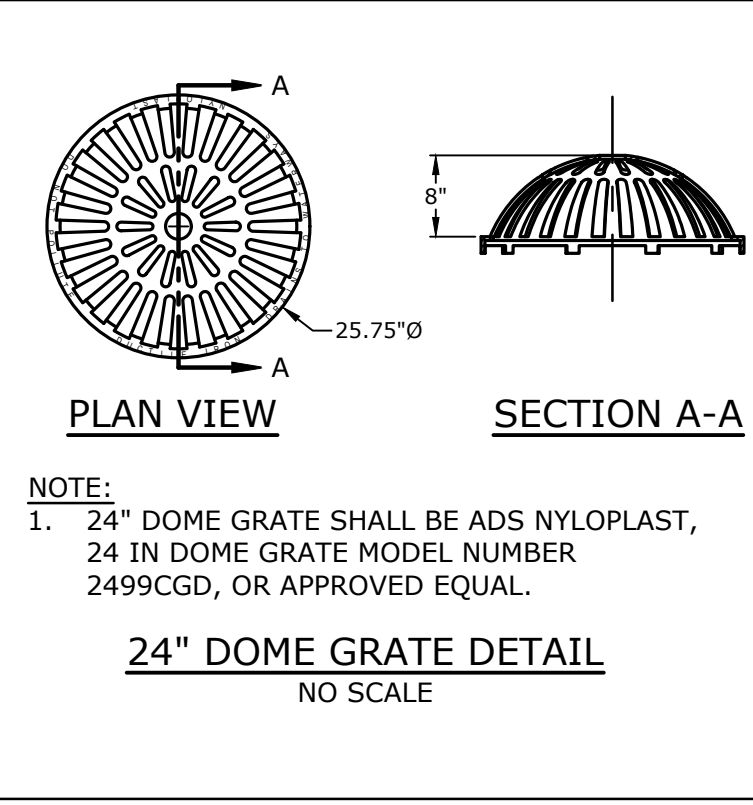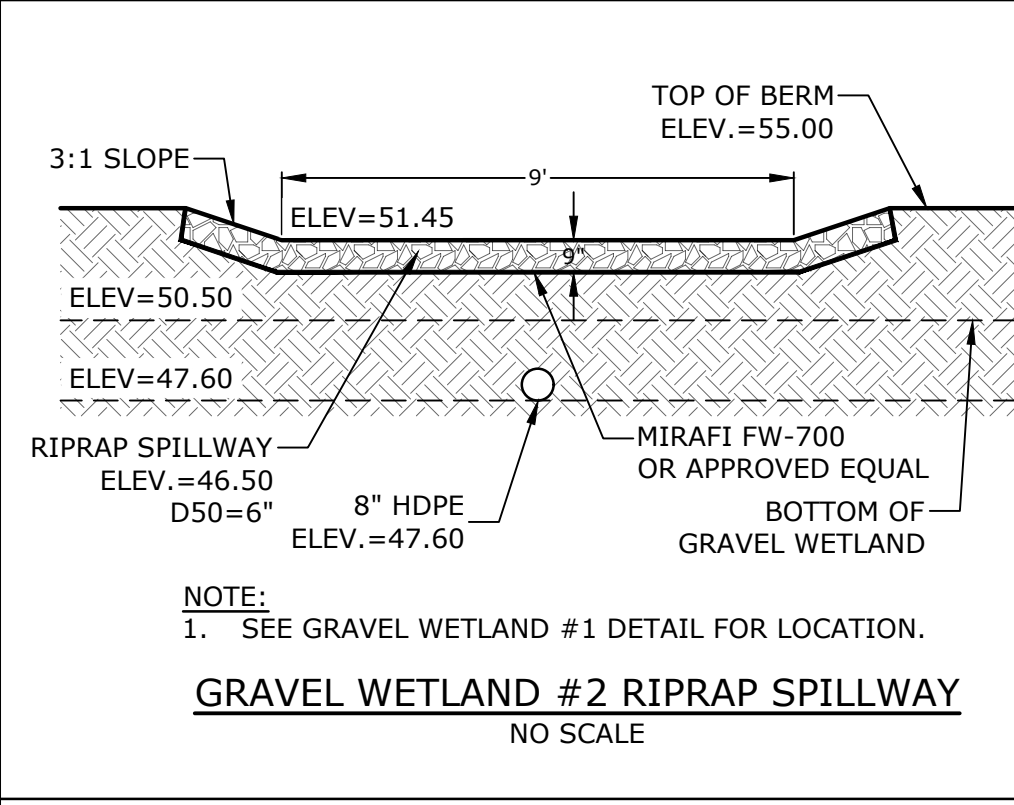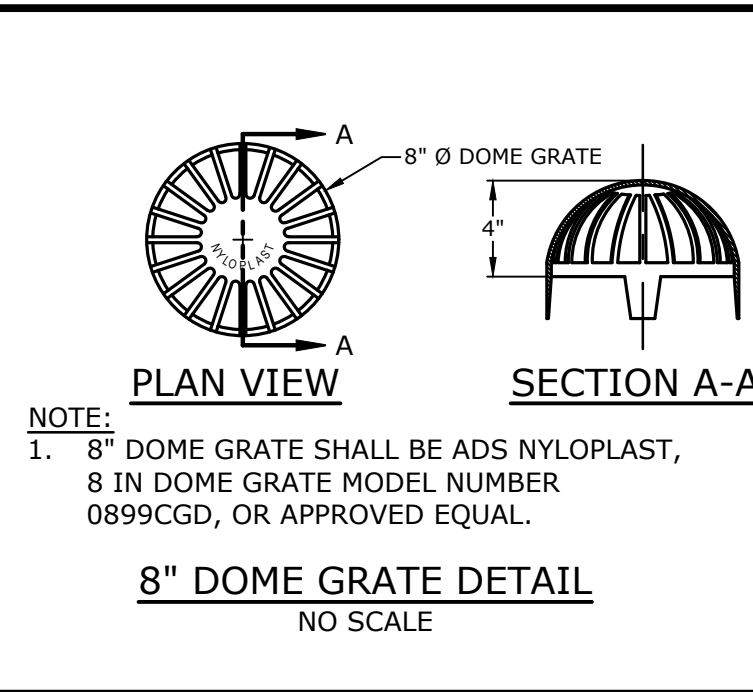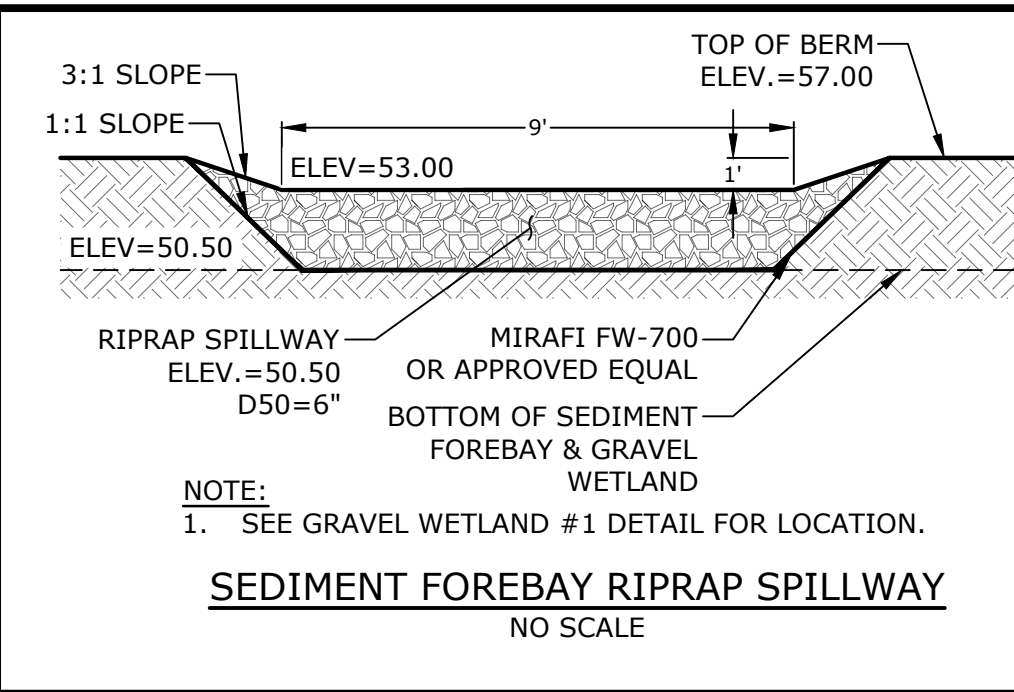HAALA MC56X56 GRATE
NO SCALE

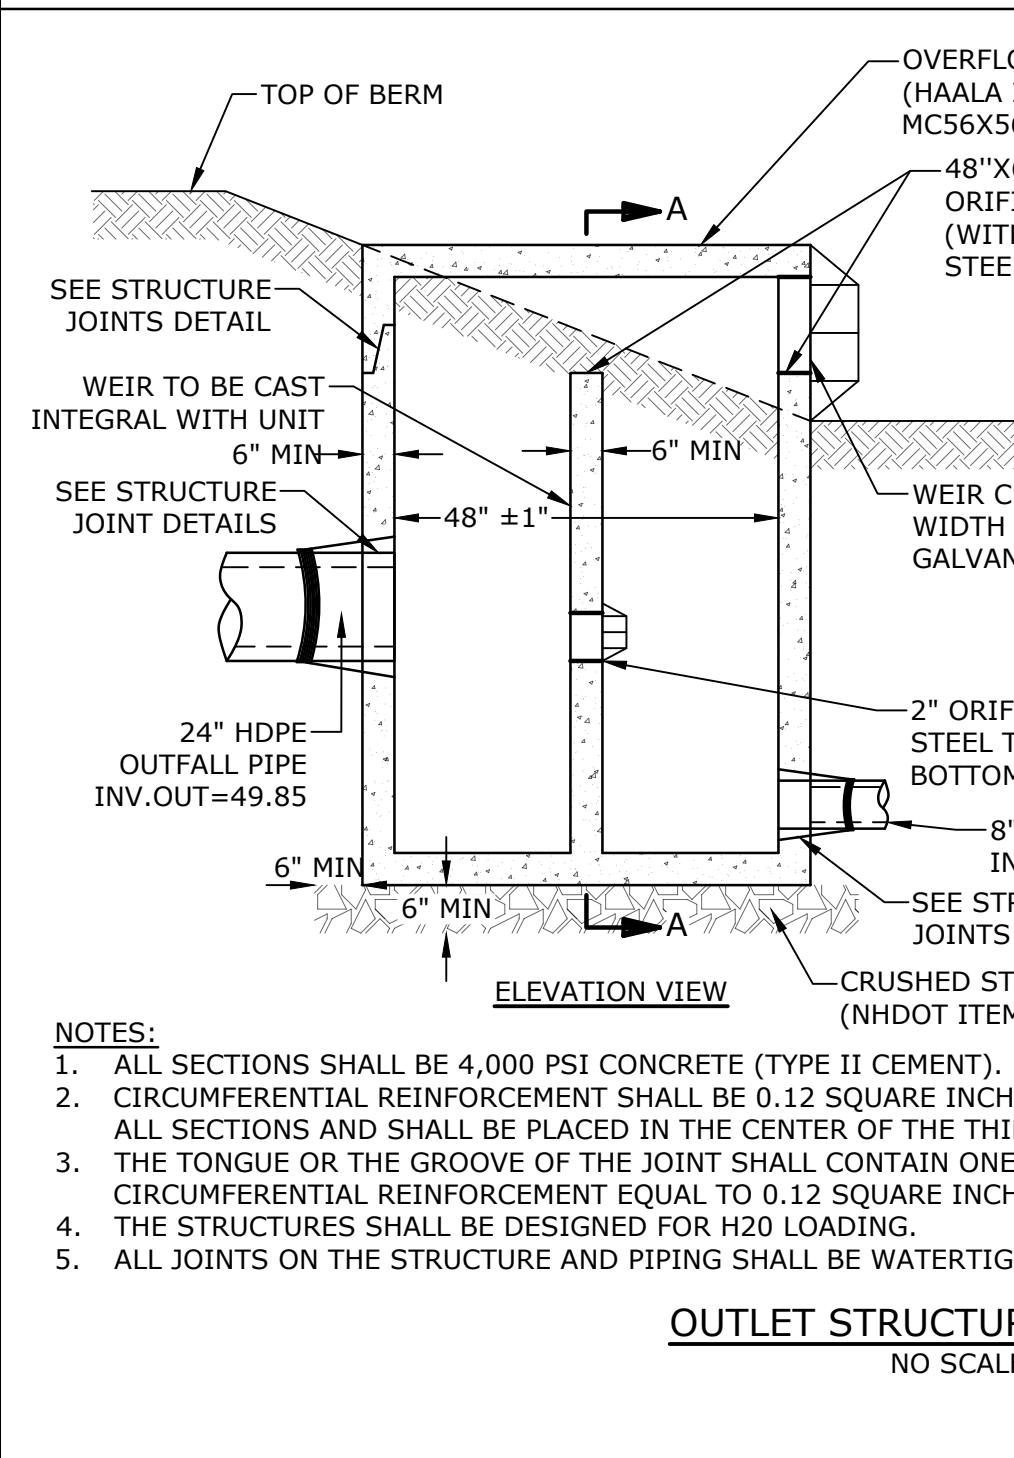



SECTION A-A

NHDOT ITEM No. 304.4 (CRUSHED STONE - FINE)	
SIEVE SIZE	% PASSING
2"	100
1-1/2"	85-100
3/4"	45-75
#4	10-45
#200	0-5

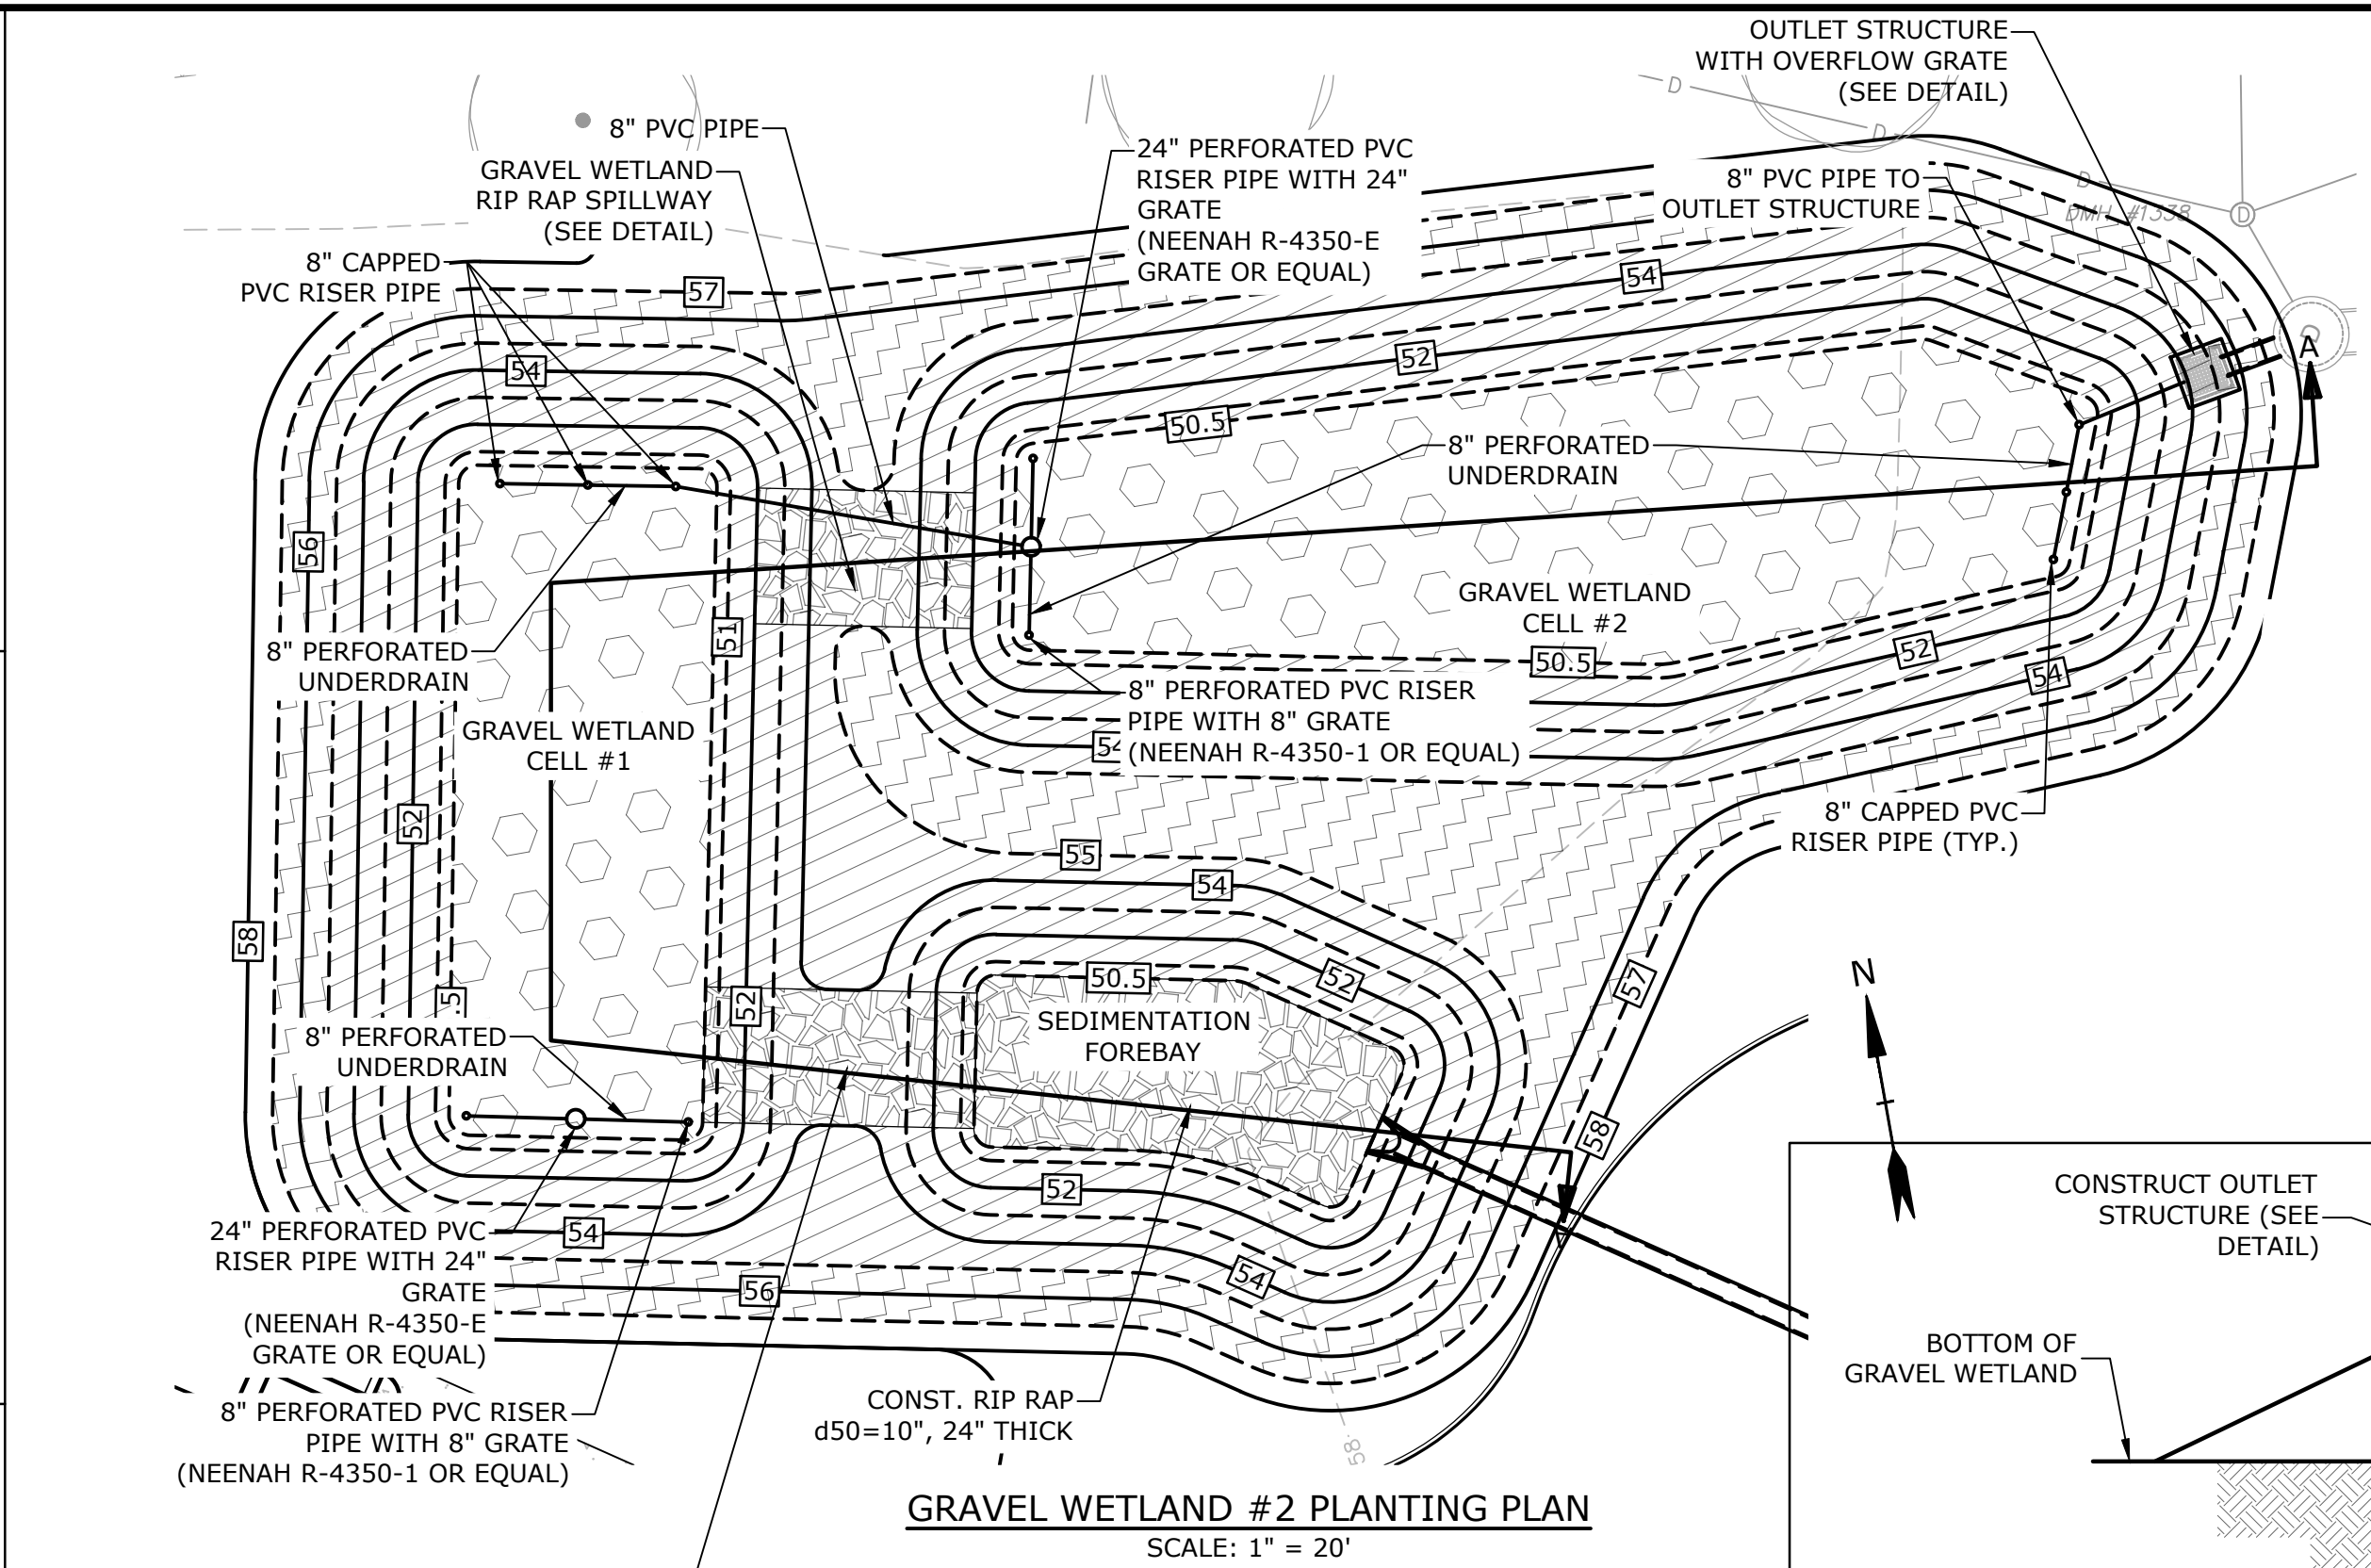

GRAVEL WETLAND PLANTING PLAN

SPECIES	PLANT SIZE	QUANTITY/SPACING
NEW ENGLAND WETMIX, WETLAND SEED MIX OR EQUIVALENT		18 LB/ACRE
NEW ENGLAND EROSION CONTROL/RESTORATION MIX OR EQUIVALENT		35 LB/ACRE
"RED OSIER DOGWOOD" CORNUS SERICEA AND "SUMMERSWEET CLETHRA" CLETHRA ALNIFOLIA	2'-3'	8'-10' ON CENTER
NEW ENGLAND EROSION CONTROL/RESTORATION MIX OR EQUIVALENT		35 LB/ACRE
"SILKY DOGWOOD" CORNUS AMOMUM AND "HIGHBUSH BLUEBERRY" VACCINIUM CORYMBOSUM AND "WINTERBERRY" ILEX VERTICILLATA	2'-3'	8'-10' ON CENTER

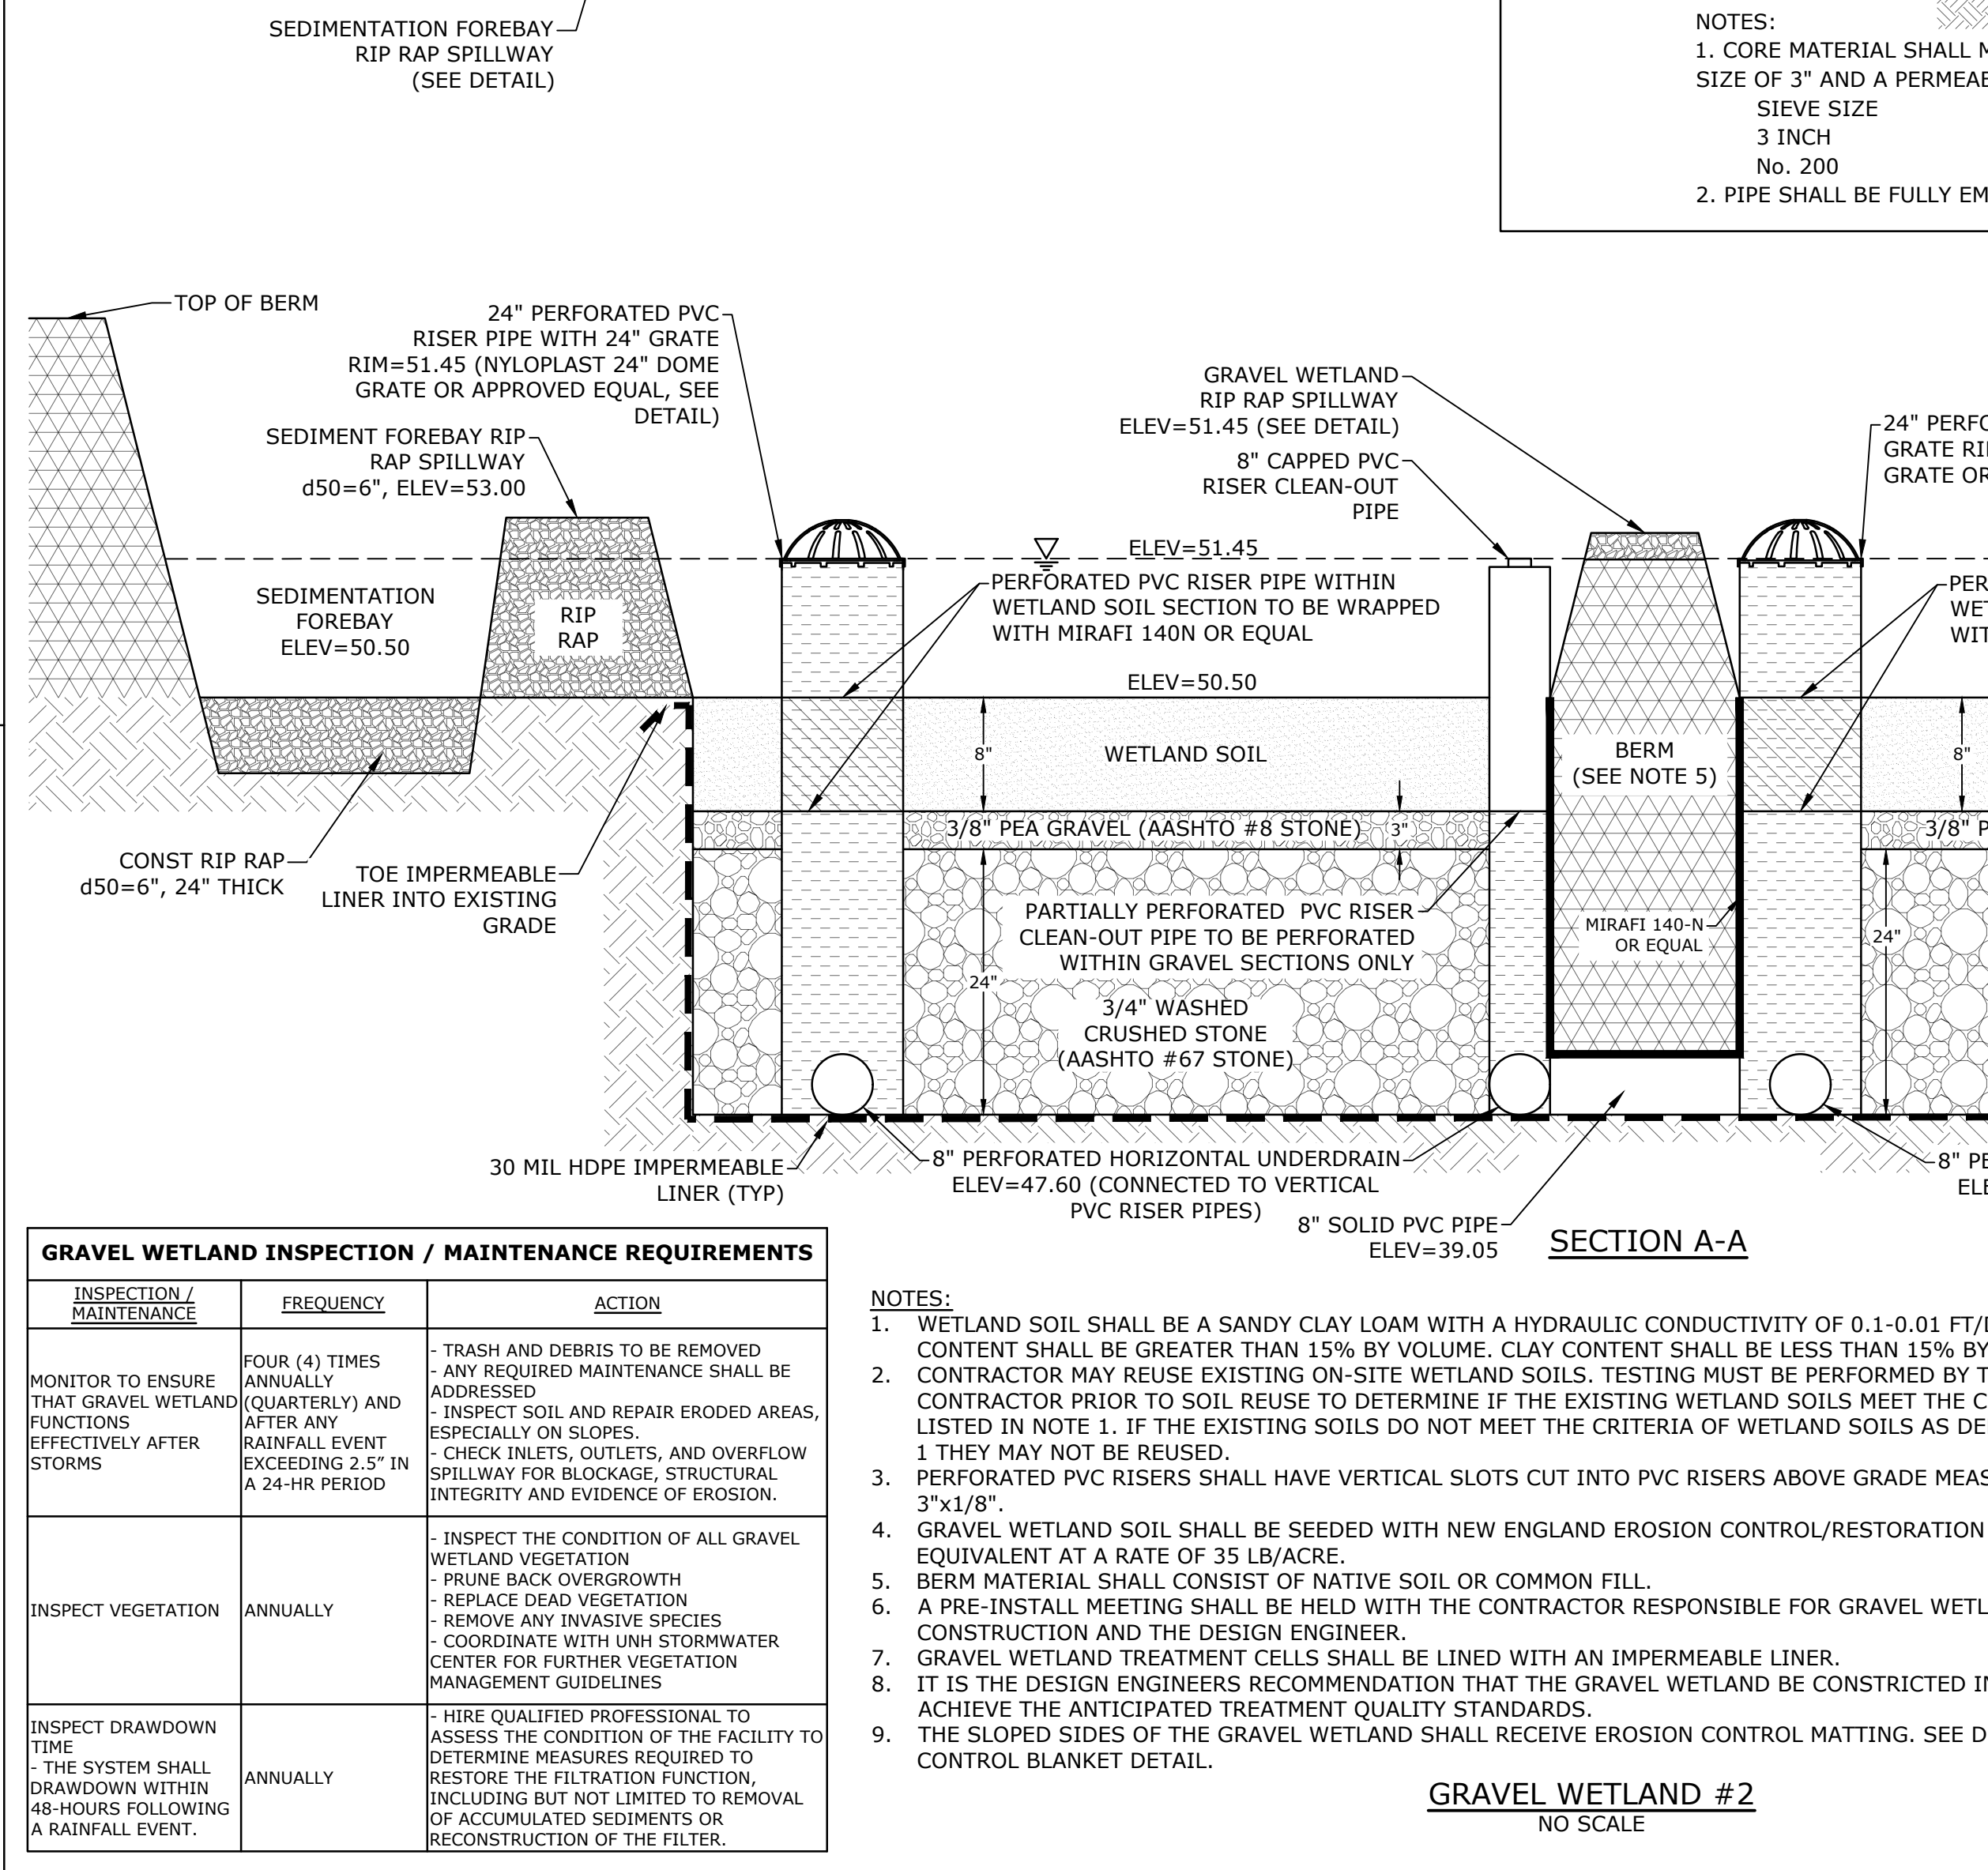
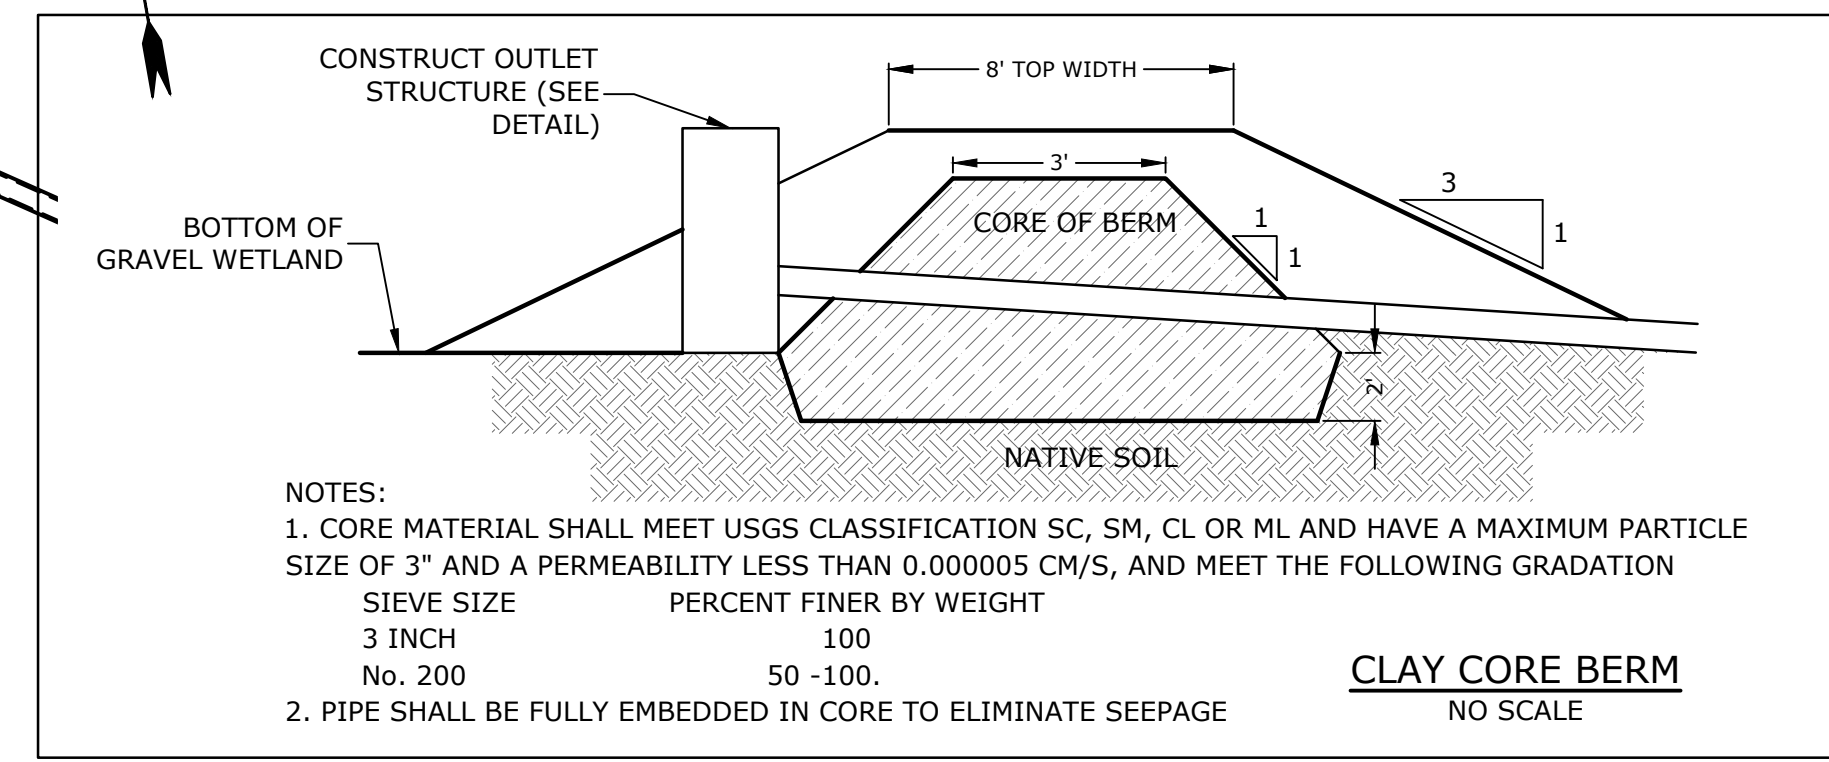


GRAVEL WETLAND INSPECTION / MAINTENANCE REQUIREMENTS

INSPECTION / MAINTENANCE	FREQUENCY	ACTION
MONITOR TO ENSURE THAT GRAVEL WETLAND FUNCTIONS EFFECTIVELY AFTER STORMS	FOUR (4) TIMES ANNUALLY (QUARTERLY) AND AFTER ANY RAINFALL EVENT EXCEEDING 2.5" IN A 24-HR PERIOD	- TRASH AND DEBRIS TO BE REMOVED - ANY REQUIRED MAINTENANCE SHALL BE ADDRESSED - INSPECT SOIL AND REPAIR ERODED AREAS, ESPECIALLY ON SLOPES. - CHECK INLETS, OUTLETS, AND OVERFLOW SPILLWAY FOR BLOCKAGE, STRUCTURAL INTEGRITY AND EVIDENCE OF EROSION.
INSPECT VEGETATION	ANNUALLY	- INSPECT THE CONDITION OF ALL GRAVEL WETLAND VEGETATION - PRUNE BACK OVERGROWTH - REPLACE DEAD VEGETATION - REMOVE ANY INVASIVE SPECIES - COORDINATE WITH UNH STORMWATER CENTER FOR FURTHER VEGETATION MANAGEMENT GUIDELINES
INSPECT DRAWDOWN TIME	ANNUALLY	- HIRE QUALIFIED PROFESSIONAL TO ASSESS THE CONDITION OF THE FACILITY TO DETERMINE MEASURES REQUIRED TO RESTORE THE FILTRATION FUNCTION, INCLUDING BUT NOT LIMITED TO REMOVAL OF ACCUMULATED SEDIMENTS OR RECONSTRUCTION OF THE FILTER.

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2. PERFORATED PVC RISERS SHALL HAVE VERTICAL SLOTS CUT INTO PVC RISERS ABOVE GRADE MEASURING 3"x1/8".
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8. THE SLOPED SIDES OF THE GRAVEL WETLAND SHALL RECEIVE EROSION CONTROL MATTING. SEE DETAIL EROSION CONTROL BLANKET DETAIL.

AASHTO #8 STONE (#8 to 3/8")		AASHTO #67 STONE (#4 to 3/4")	
SIEVE SIZE	% PASSING	SIEVE SIZE	% PASSING
1/2"	100	1"	100
3/8"	85-100	3/4"	90-100
#4	10-30	3/8"	20-55
#8	0-10	#4	0-10
#16	0-5	#8	0-5

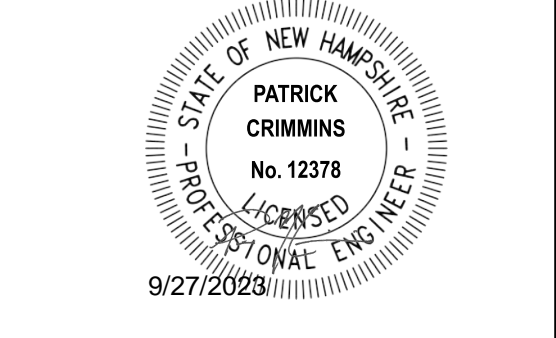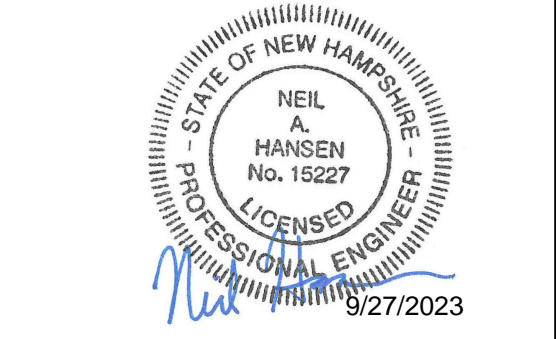

Proposed Industrial Development
Lonza Biologics


Portsmouth, New Hampshire

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APPROVED: PMC


DETAILS SHEETS
SCALE: AS SHOWN
C-508

Last Save Date: September 27, 2023 1:49 PM By: CKRZCUIK
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P&E File Location: X:\110720 Lonza Biologics Expansion.was 12/28/2026 Project Pathname Drawings\AutoCAD\0700-026-C-DTLS.dwg Layout: Tab: C-508

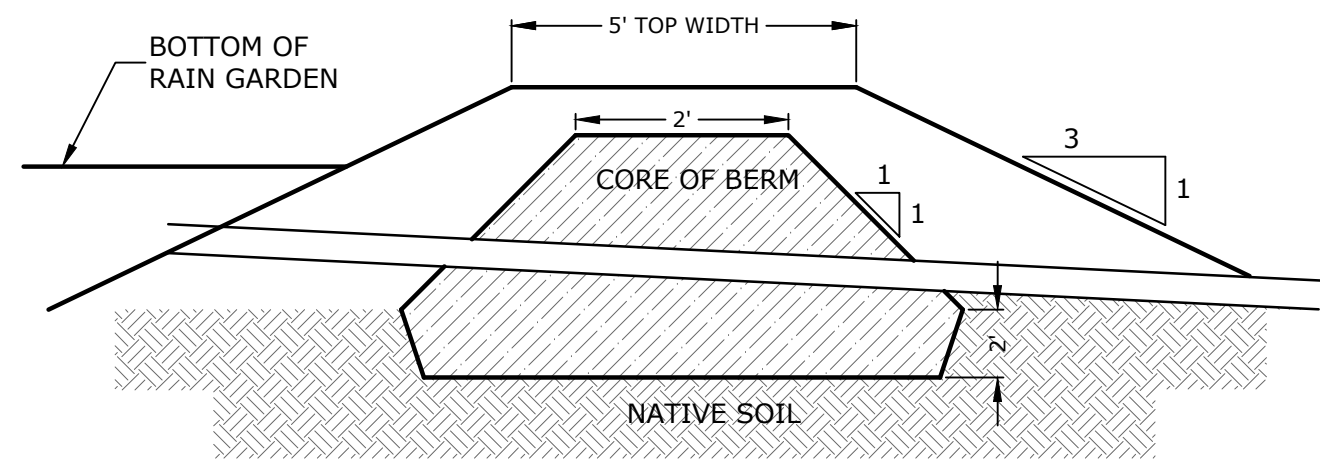

- NOTES:
- CORE MATERIAL SHALL MEET USGS CLASSIFICATION SC, SM, CL OR ML AND HAVE A MAXIMUM PARTICLE SIZE OF 3" AND A PERMEABILITY LESS THAN 0.000005 CM/S, AND MEET THE FOLLOWING GRADATION
 - PIPE SHALL BE FULLY EMBEDDED IN CORE TO ELIMINATE SEEPAGE
- | SIEVE SIZE | PERCENT FINER BY WEIGHT |
|------------|-------------------------|
| 3 INCH | 100 |
| No. 200 | 50 -100. |

CLAY CORE BERM
NO SCALE

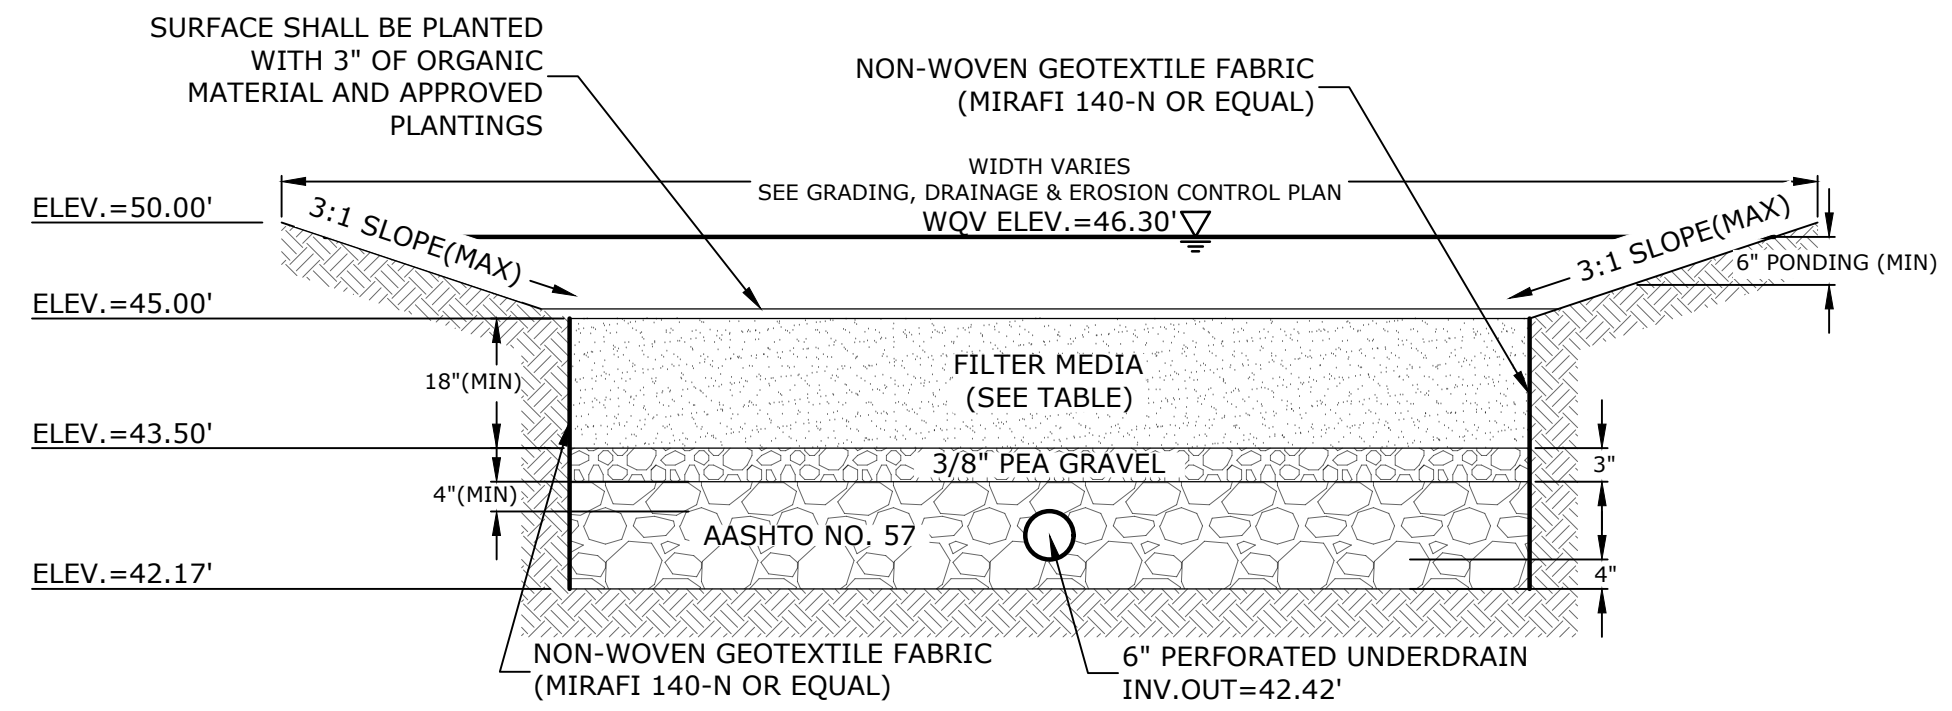


SECTION VIEW


FILTER MEDIA COMPOSITION:			
COMPONENT MATERIAL	PERCENT OF MIXTURE BY VOLUME	SIEVE NO.	GRADATION OF MATERIAL PERCENT PASSING
ASTM C-33 CONCRETE SAND	50-55	SEE NOTE #5	
LOAMY SAND TOPSOIL	20-30	200	15-25
MODERATELY FINE SHREDDED BARK OR WOOD FIBER MULCH	20-30	200	5 MAX.

- NOTES:
- RAIN GARDENS SHALL NOT BE PLACED INTO SERVICE UNTIL THE PRACTICE HAS BEEN PLANTED AND ITS CONTRIBUTING AREAS HAVE BEEN FULLY STABILIZED.
 - DO NOT TRAFFIC EXPOSED SOIL SURFACES WITH CONSTRUCTION EQUIPMENT. CONTRACTOR SHALL KEEP ALL EXCAVATION EQUIPMENT OUTSIDE OF THE LIMIT OF THE RAIN GARDEN.
 - SEE GRADING, DRAINAGE & EROSION CONTROL PLAN FOR LOCATIONS, LAYOUTS, AND ELEVATIONS.
 - THE SAND PORTION OF THE FILTER MEDIA SHALL MEET THE FOLLOWING GRADATION (ASTM C-33):
- | SIEVE SIZE | PERCENT PASSING |
|------------|-----------------|
| 3/8" | 100 |
| #4 | 95-100 |
| #8 | 80-100 |
| #16 | 50-85 |
| #30 | 25-60 |
| #50 | 5-30 |
| #100 | 0-10 |

RAIN GARDEN
NO SCALE

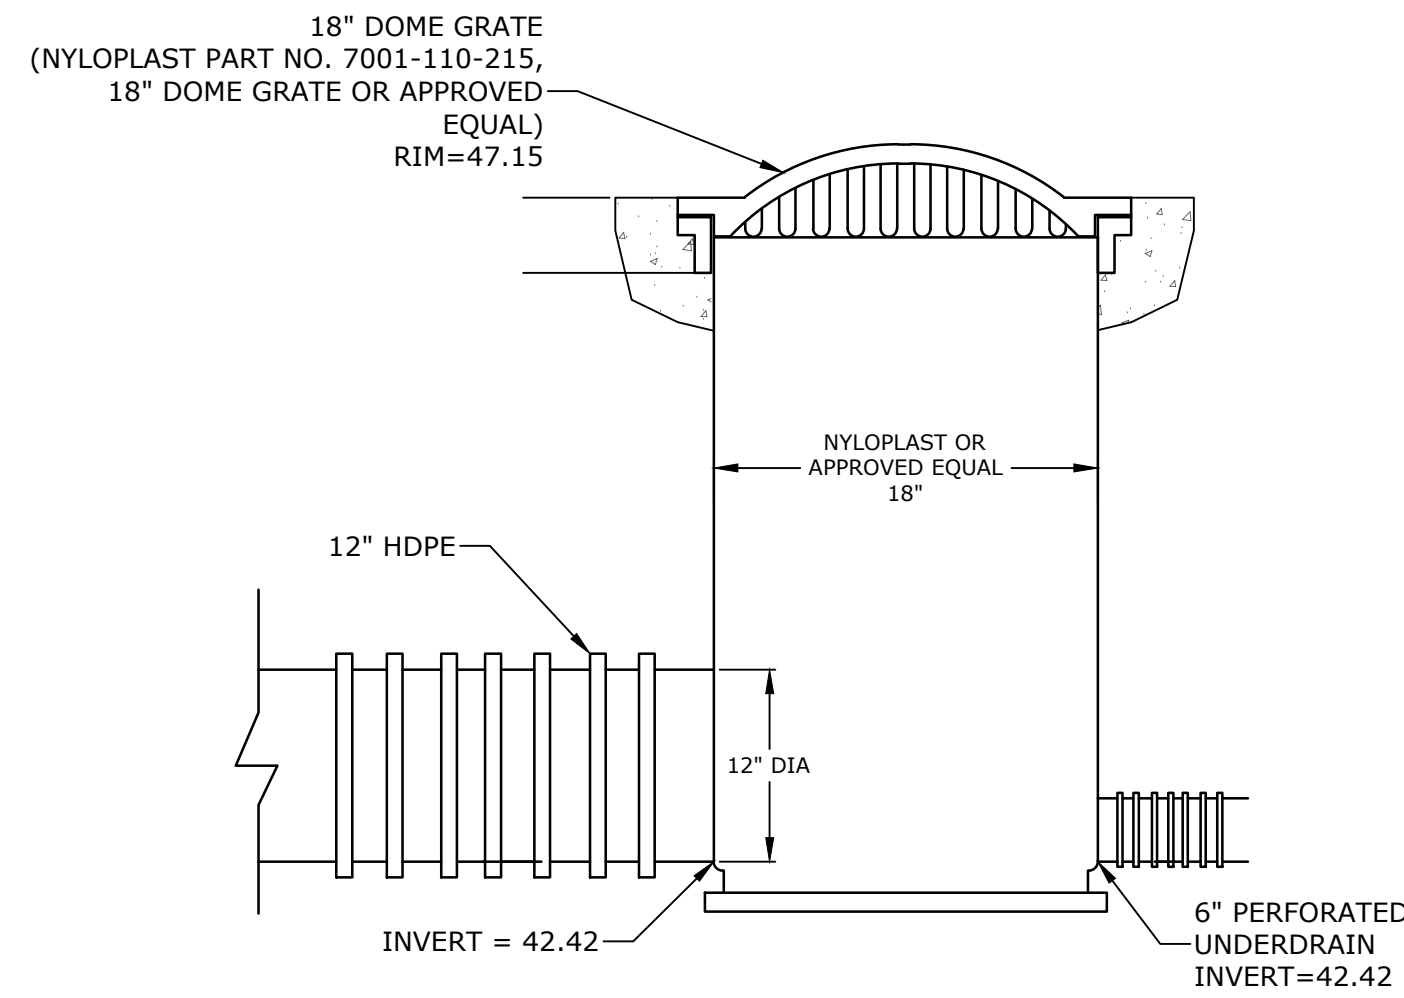


OUTLET STRUCTURE DETAIL (POS300)
NO SCALE

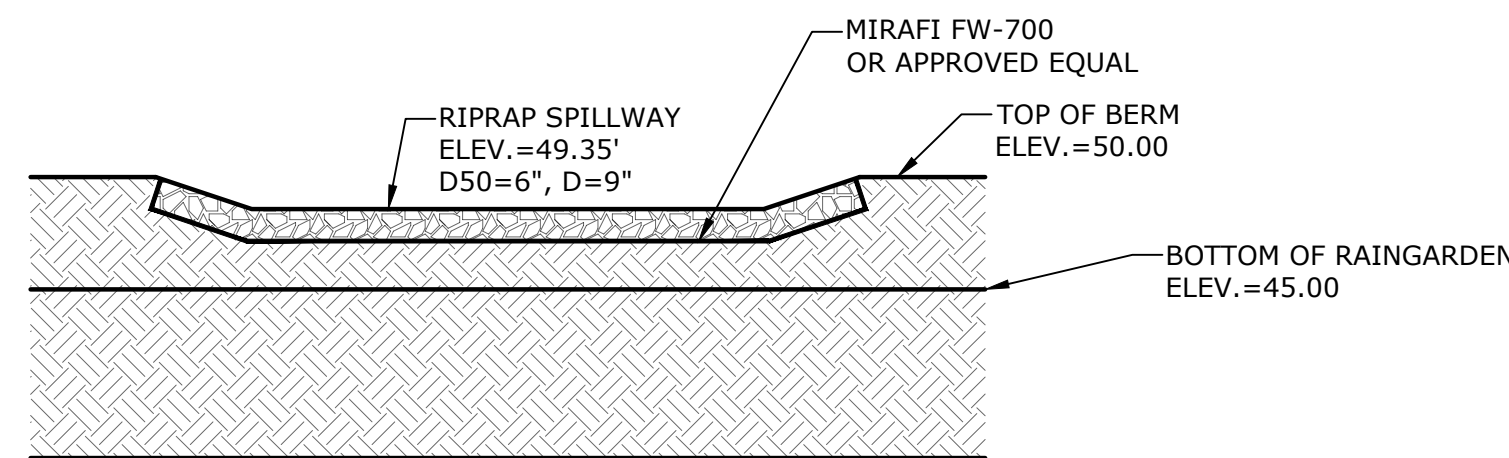



NOTE:
SEE GRADING, DRAINAGE & EROSION CONTROL PLANS, SHEET C-110, FOR LOCATIONS AND ELEVATIONS.

RIPRAP OVERFLOW SPILLWAY
NO SCALE

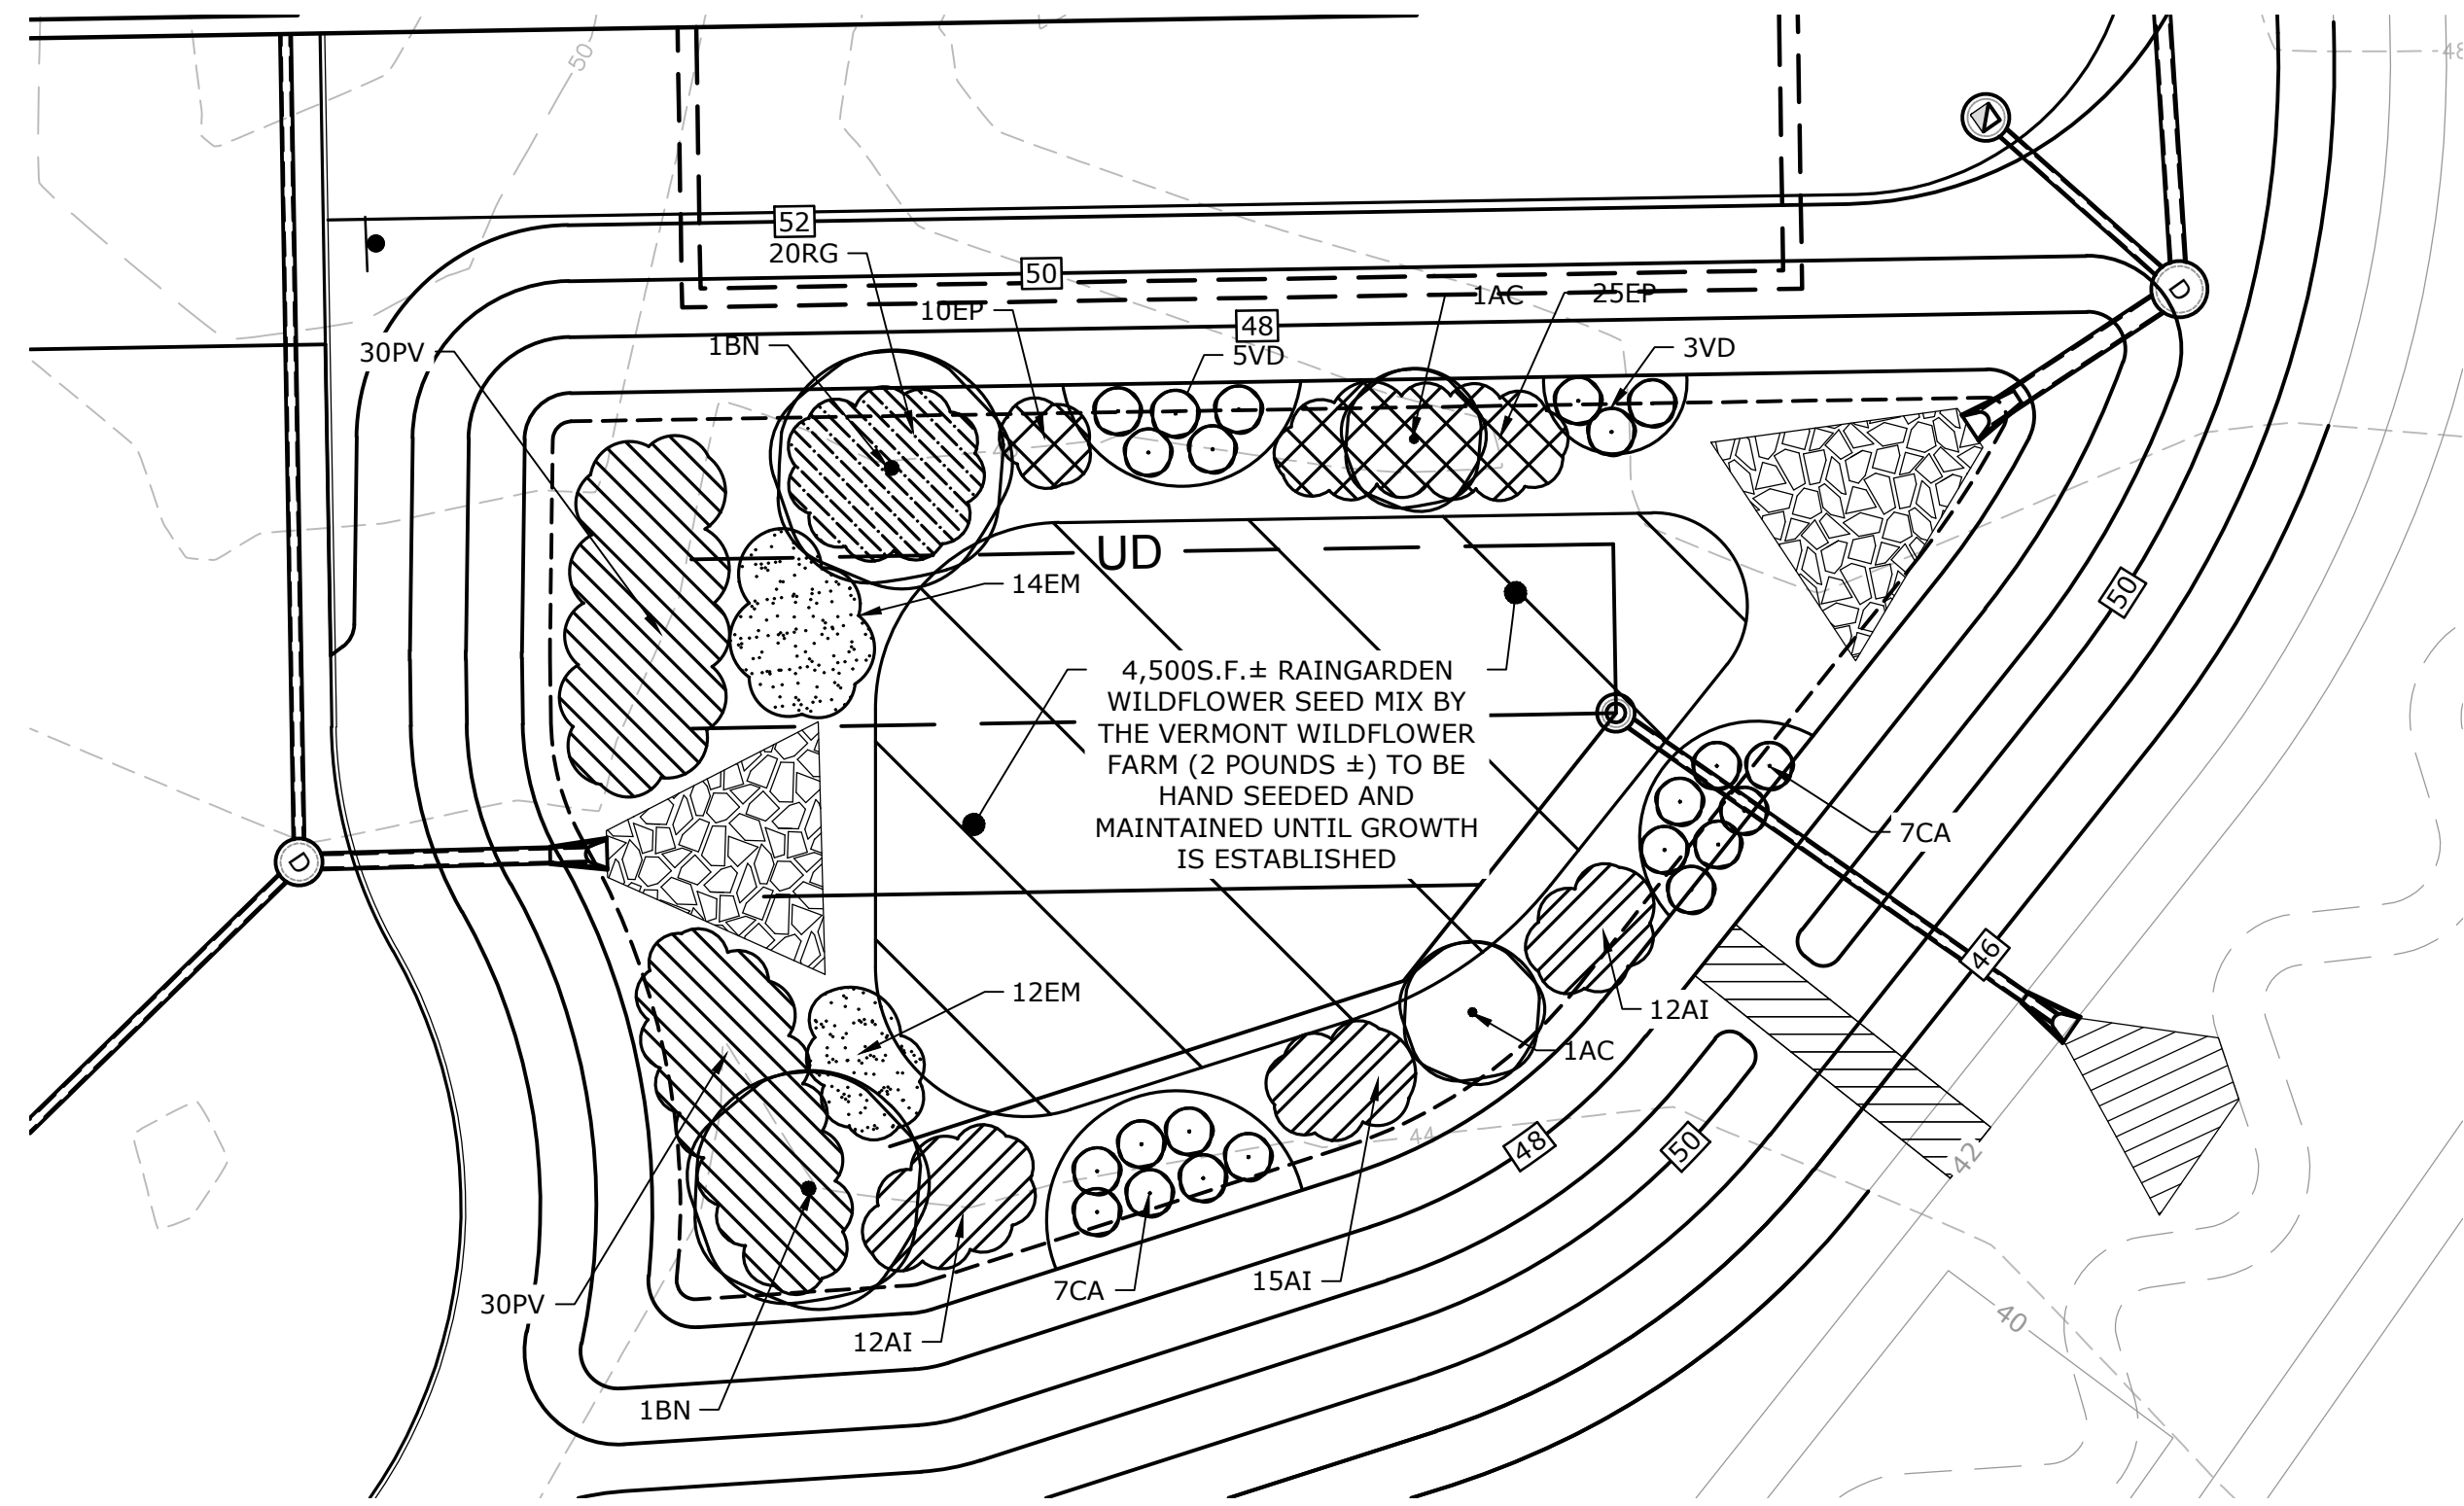

RAIN GARDEN PLANTING PLAN
SCALE: 1" = 20'

RAINGARDEN PLANT SCHEDULE				
CODE	BOTANICAL NAME	COMMON NAME	SIZE	REMARKS
TREES				
BN	BETULA NIGRA	RIVER BIRCH	12 - 14' HT	B & B (CLUMP)
AC	AMELANCHIER CANADENSIS	SHADBLOW SERVICEBERRY	6 - 7' HT	B & B (CLUMP)
SHRUBS				
VD	VIBURNUM DENTATUM	ARROWWOOD VIBURNUM	5 GALLON	CONTAINER
CA	CLETHRA ALNIFOLIA	SUMMERSWEET CLETHRA	5 GALLON	CONTAINER
PERENNIALS				
PV	PANICUM VIRGATUM 'SHENANDOAH'	SHENANDOAH SWITCH GRASS	3 GALLON	CONTAINER
EM	EUPATORIUM MACULATUM	JOE PYE WEED	2 GALLON	CONTAINER
AI	ASCLEPIAS INCARNATA	MARSH MILKWEED	2 GALLON	CONTAINER
RG	RUDBECKIA 'GOLDSTURM'	GOLDSTURM BLACKEYED SUSAN	1 GALLON	CONTAINER
EP	ECHINACEA 'PURPUREA'	PURPLE CONEFLOWER	1 GALLON	CONTAINER

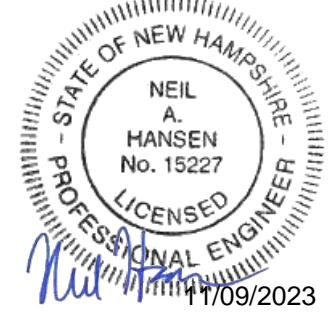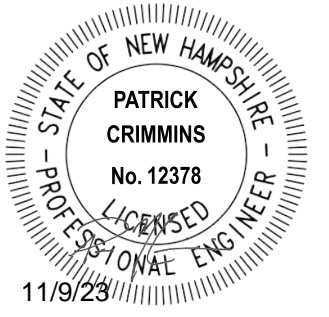

Proposed Industrial Development

Lonza Biologics

Portsmouth, New Hampshire




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M	9/27/2023	P.B. Submission
L	9/1/2022	Issued for Construction
K	5/27/2022	Issued for Bid
J	5/23/2022	Third Party Rev. Comments
I	4/26/2022	Revised PB Stipulations

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DRAWN BY:	CJK
CHECKED:	NAH
APPROVED:	PMC

DETAILS SHEETS


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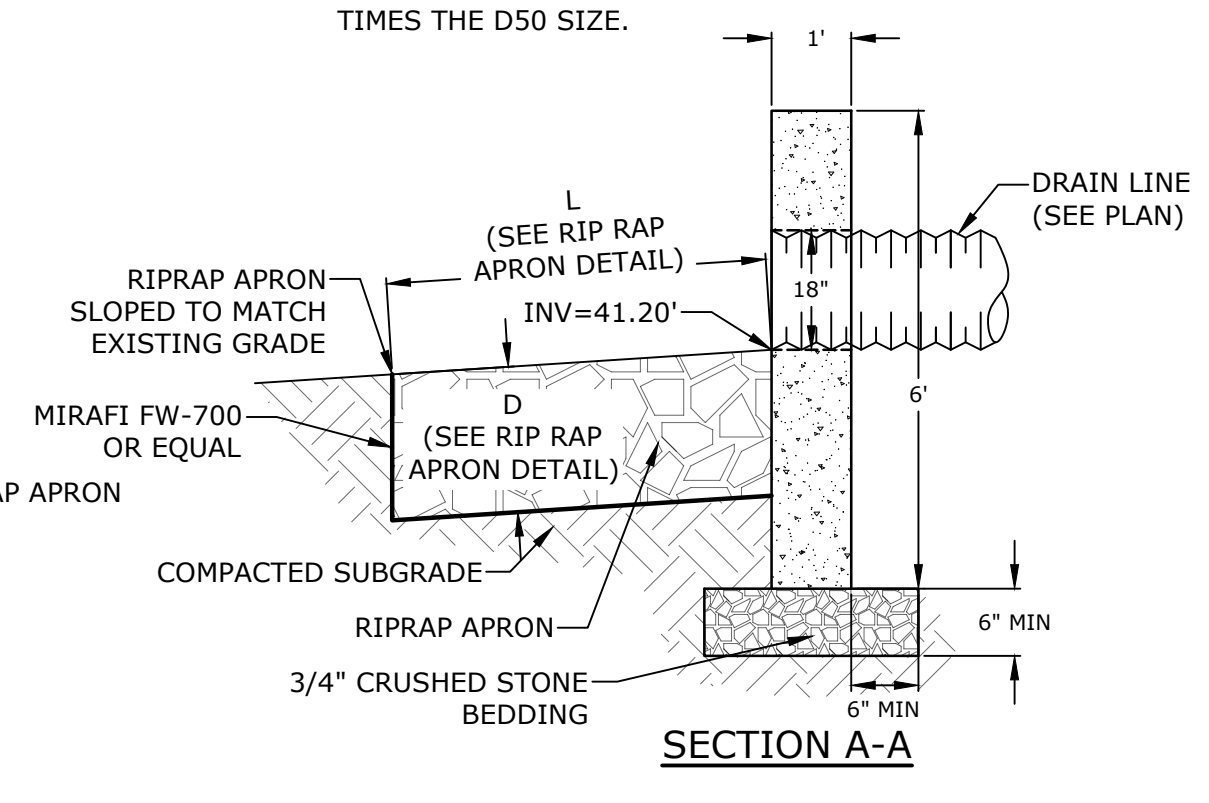
ELEVATION VIEW

- NOTES:**
1. HEADWALL SHALL BE 5,000 PSI CONCRETE.
 2. HEADWALL REINFORCEMENT SHALL BE 0.18 SQUARE INCHES PER LINEAR FOOT IN ALL SECTIONS AND SHALL BE PLACED IN THE CENTER THIRD OF THE WALL.
 3. SEE GRADING, DRAINAGE, & EROSION CONTROL PLAN FOR STONE SIZE AND APRON DIMENSIONS.
 4. STONE SHALL CONSIST OF SUB-ANGULAR FIELD STONE OR ROUGH UNHEWN QUARRY STONE OF APPROXIMATELY RECTANGULAR SHAPE. FLAT OR ROUND ROCKS ARE NOT ACCEPTABLE. THE STONE SHALL BE HARD AND OF SUCH QUALITY THAT IT WILL NOT DISINTEGRATE ON EXPOSURE TO WATER OR WEATHERING, BE CHEMICALLY STABLE AND IT SHALL BE SUITABLE IN ALL OTHER RESPECTS FOR THE PURPOSE INTENDED. THE BULK SPECIFIC GRAVITY (SATURATED SURFACE-DRY BASIS) OF THE INDIVIDUAL STONES SHALL BE AT LEAST 2.5.
 5. THE STONE SHALL BE COMPOSED OF A WELL-GRADED MIXTURE DOWN TO THE ONE-INCH SIZE PARTICLE SUCH THAT 50 PERCENT OF THE MIXTURE BY WEIGHT SHALL BE LARGER THAN THE D50 SIZE SPECIFIED. A WELL-GRADED MIXTURE IS DEFINED AS A MIXTURE COMPOSED PRIMARILY OF THE LARGER STONE SIZE BUT WITH A SUFFICIENT MIXTURE OF OTHER SIZES TO FILL THE PROGRESSIVELY SMALLER VOIDS BETWEEN THE STONES. THE DIAMETER OF THE LARGEST STONE SIZE IN SUCH A MIXTURE SHALL BE 1.5 TIMES THE D50 SIZE.

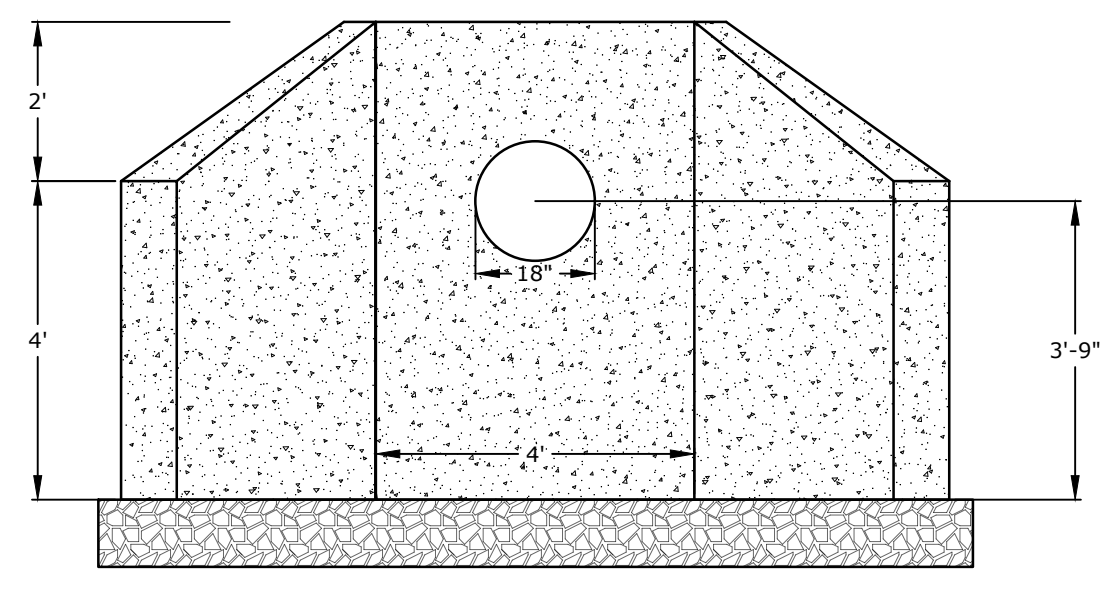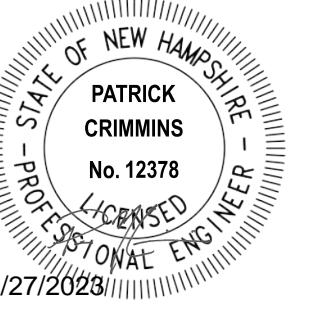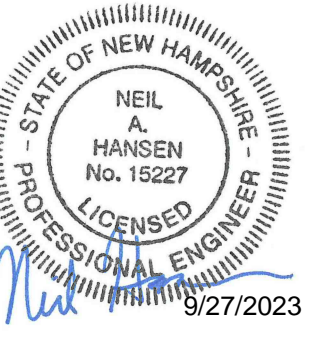


PLAN VIEW

PRECAST CONCRETE HEADWALL WITH WING WALLS (HW100)
NO SCALE

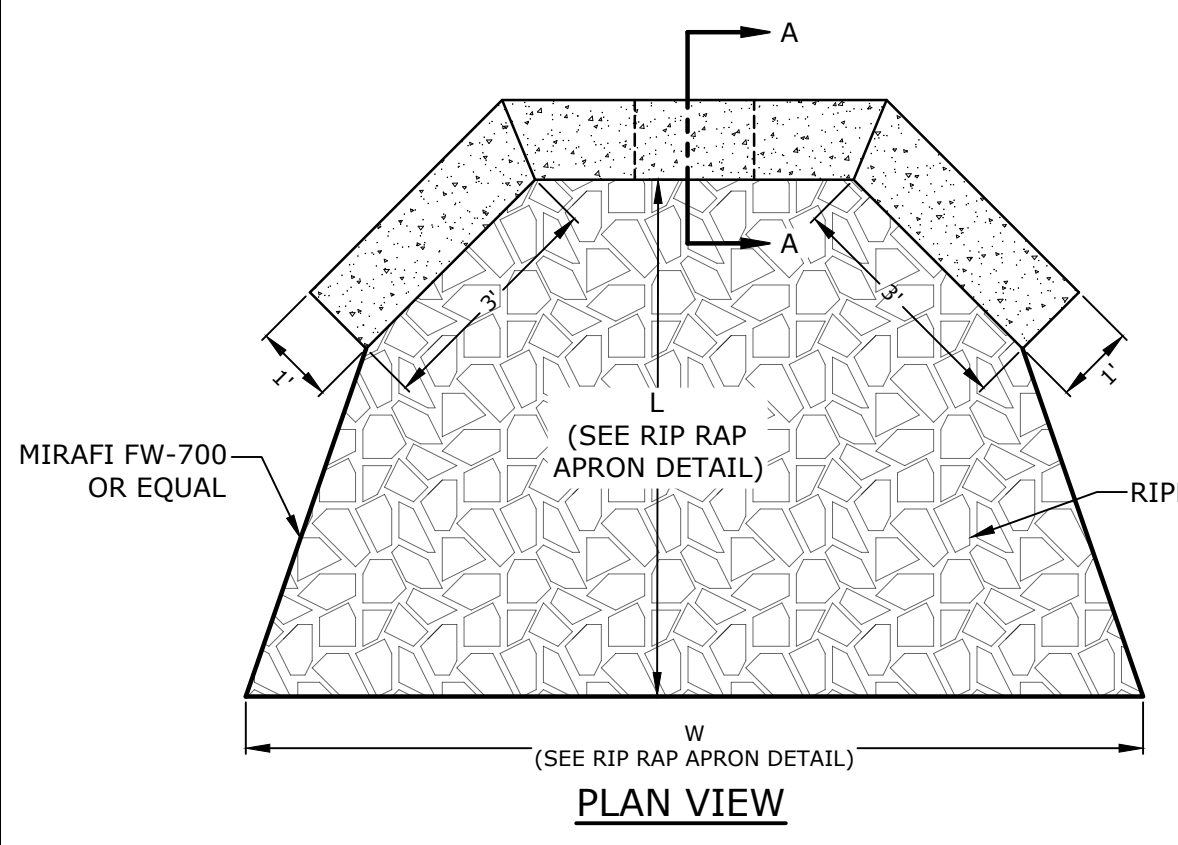


SECTION A-A

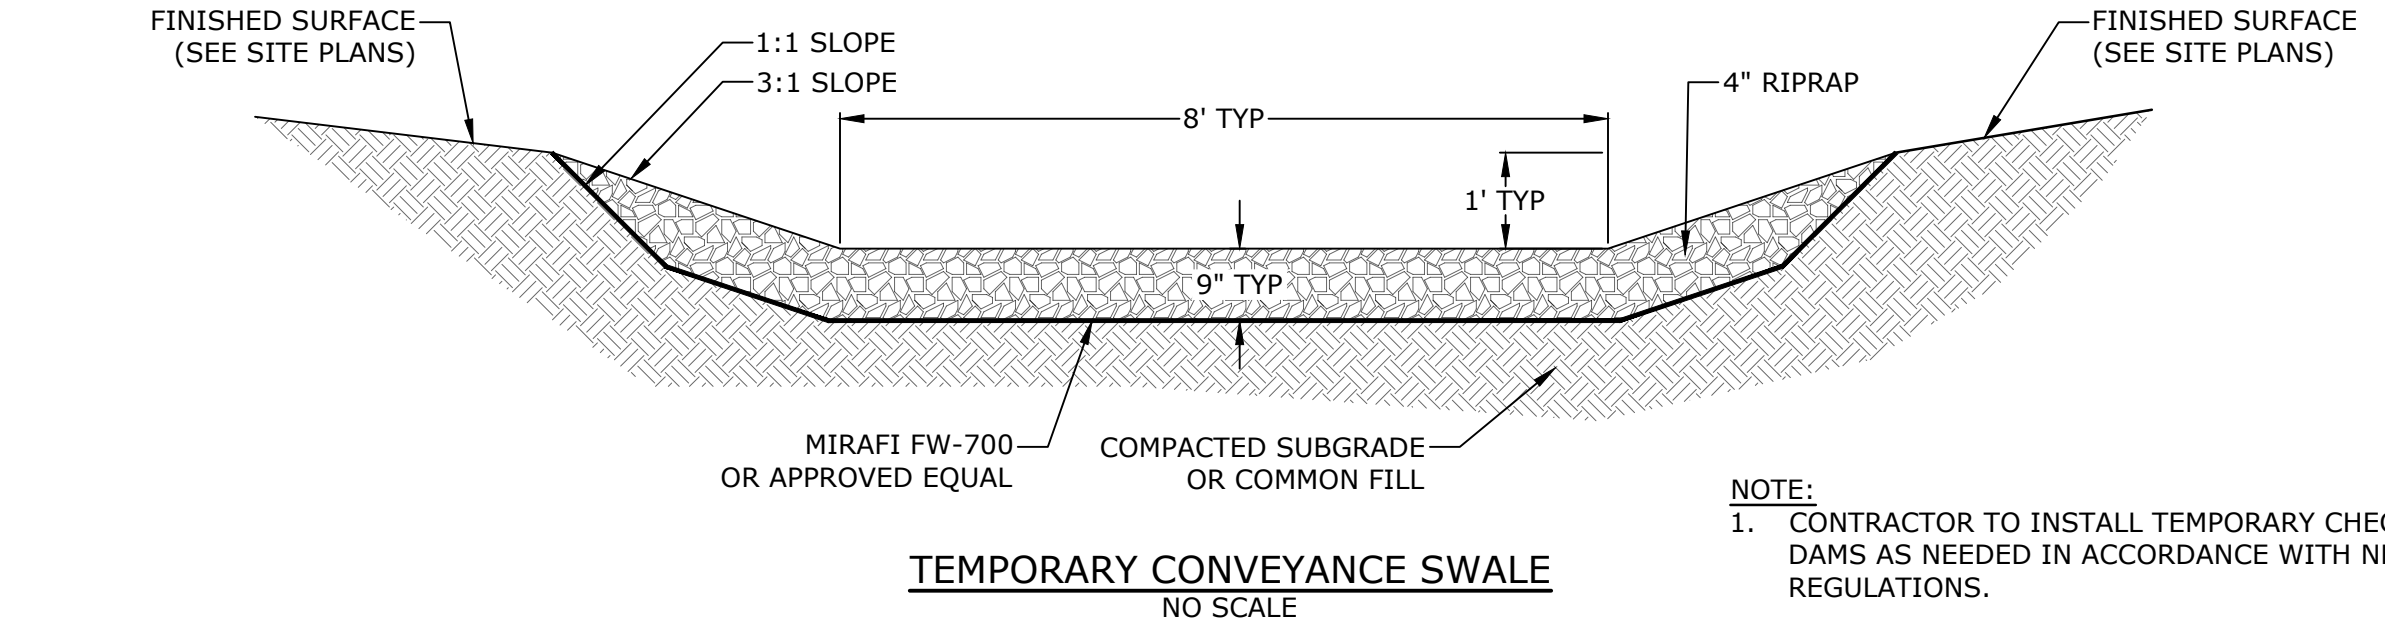


TEMPORARY CONVEYANCE SWALE
NO SCALE

- NOTE:**
1. CONTRACTOR TO INSTALL TEMPORARY CHECK DAMS AS NEEDED IN ACCORDANCE WITH NHDES REGULATIONS.

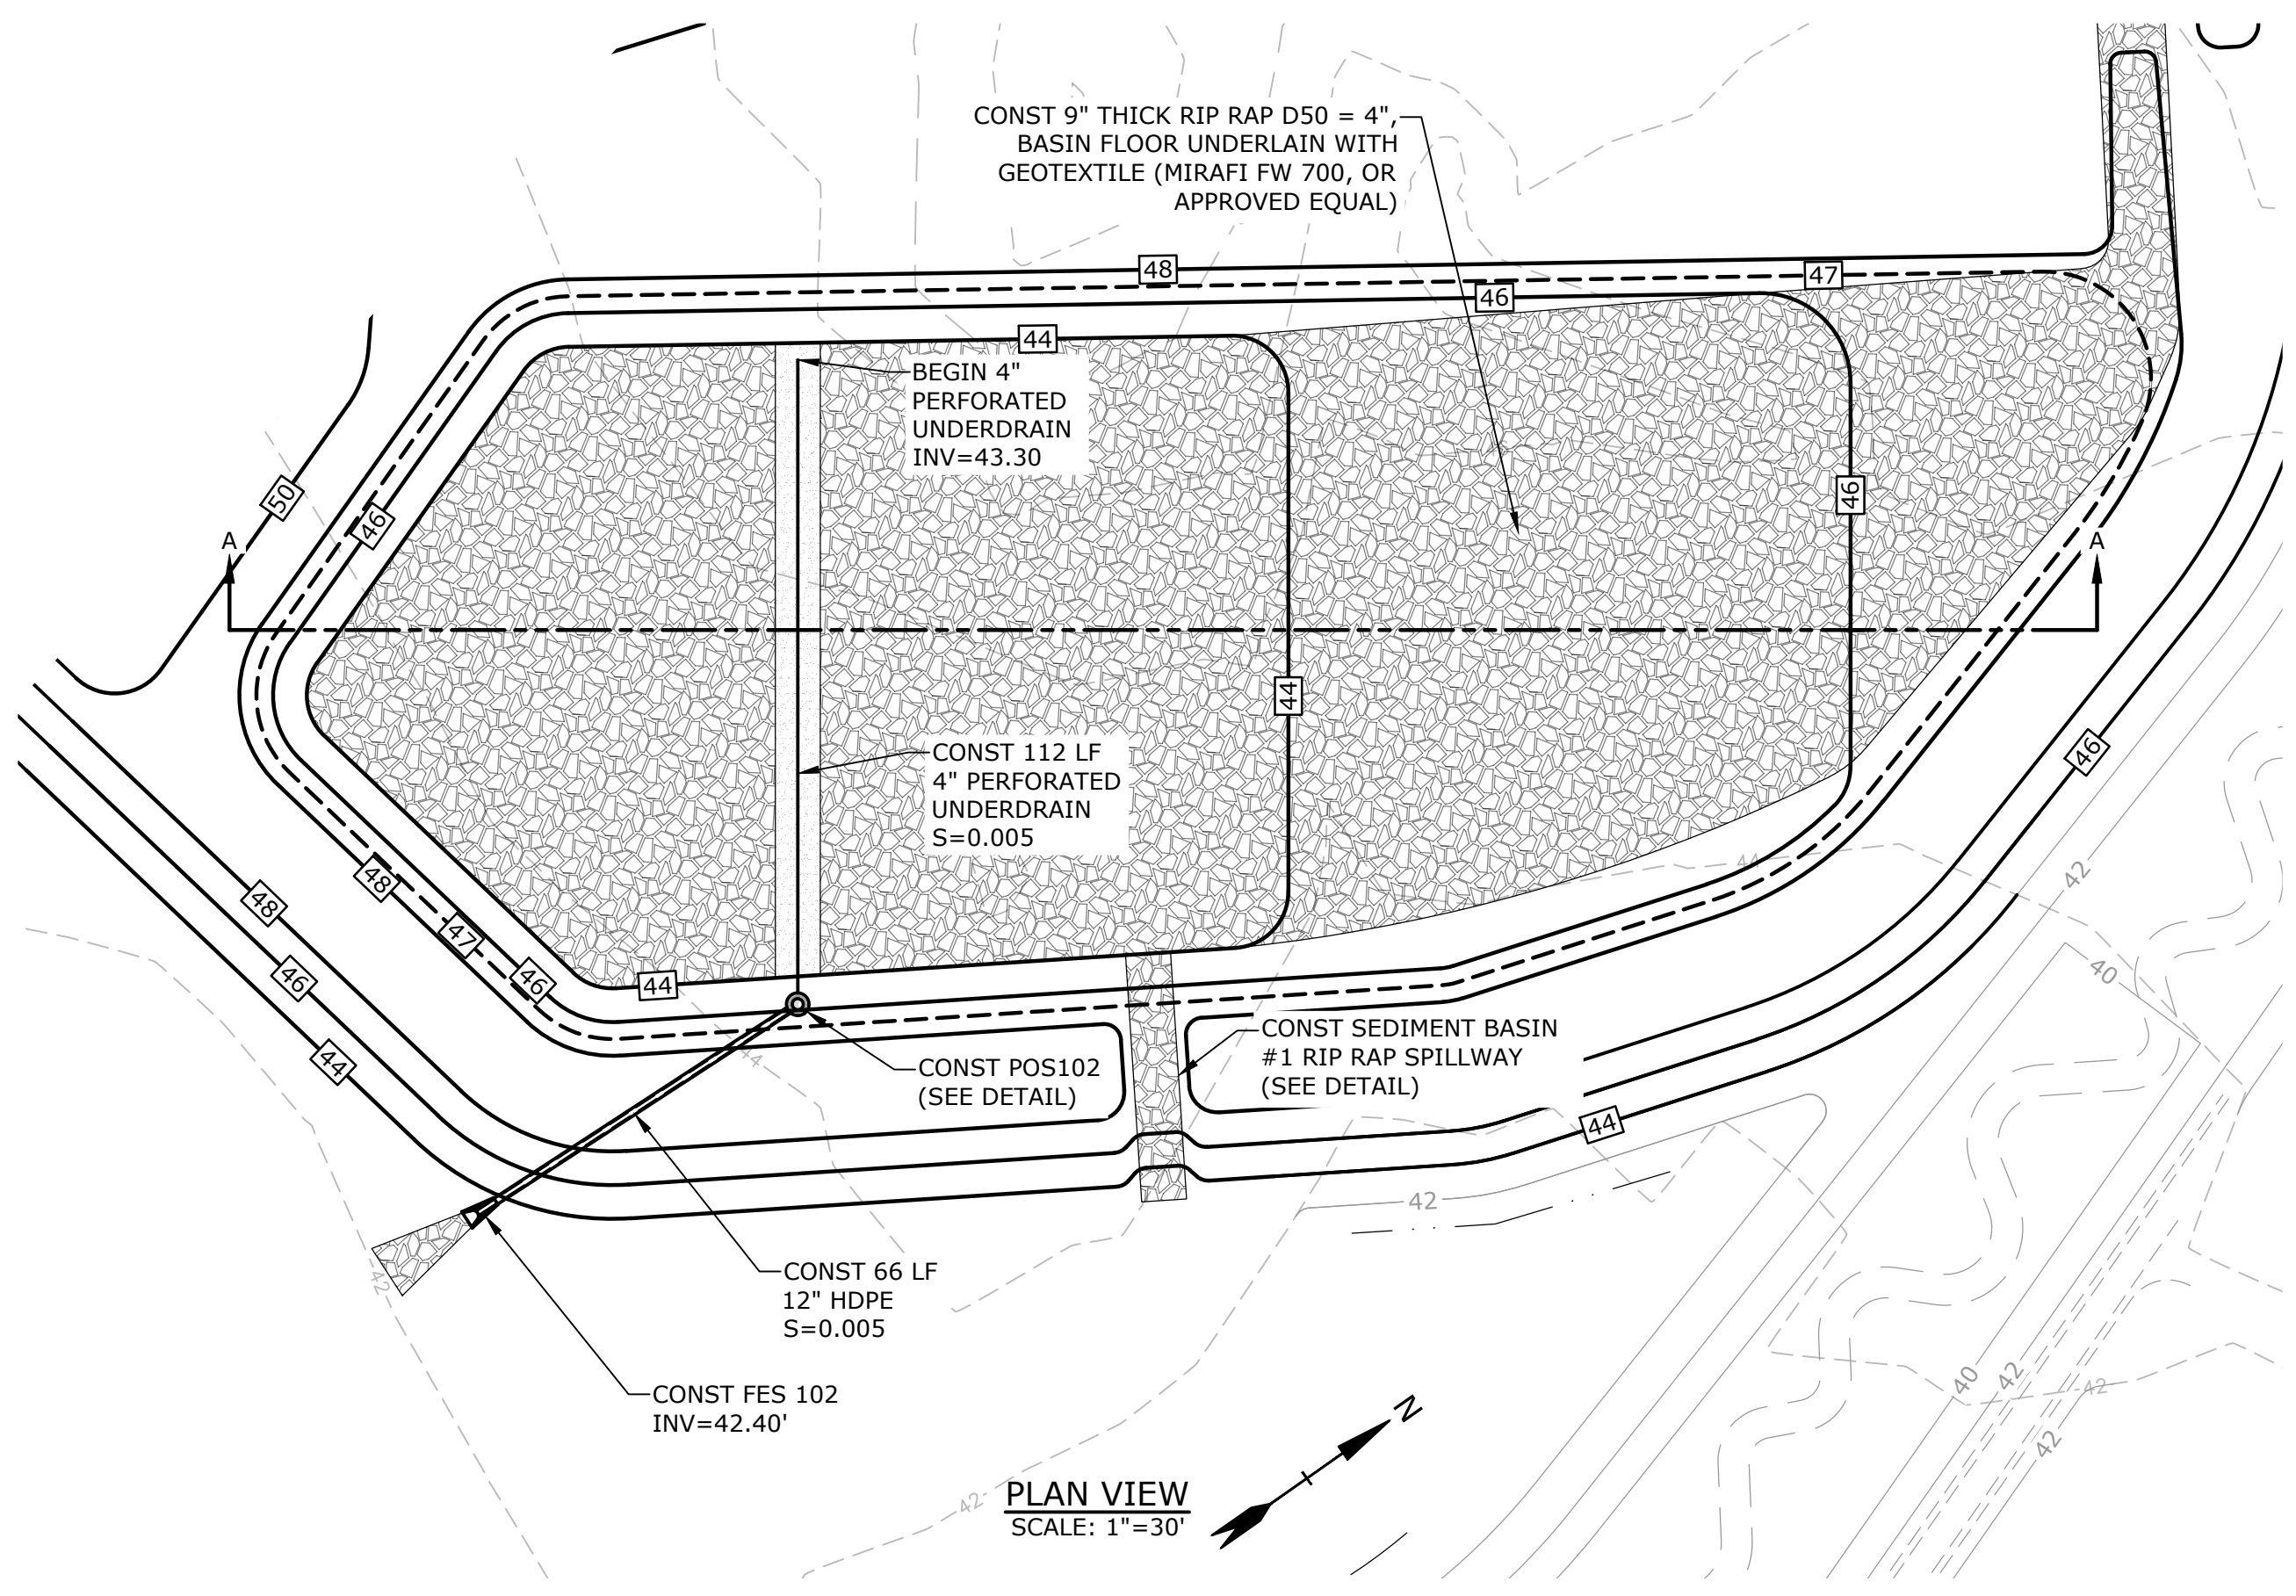


PLAN VIEW
SCALE: 1"=30'

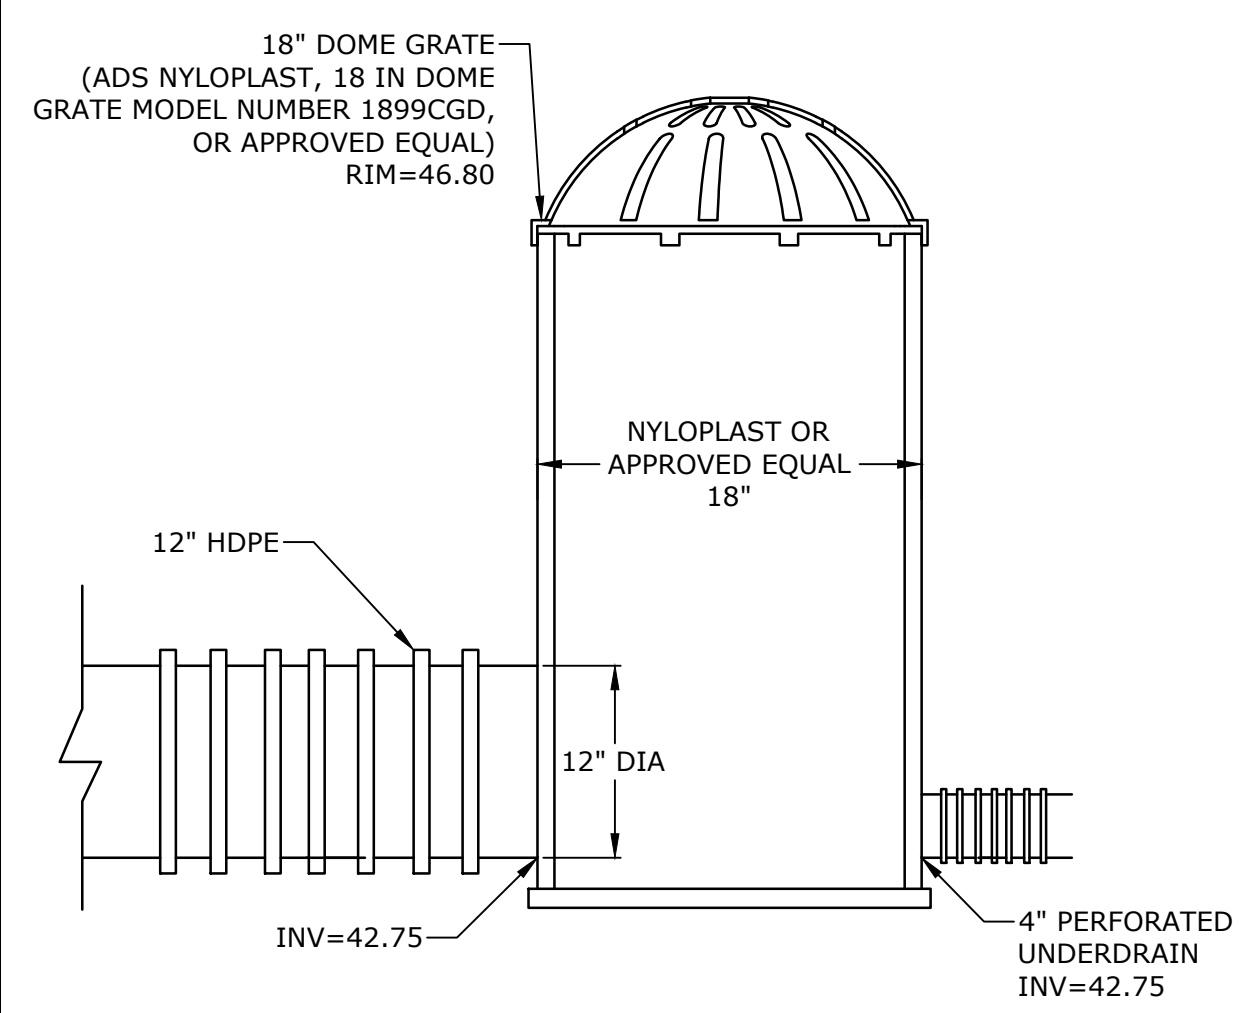


OUTLET STRUCTURE DETAIL (POS102)
NO SCALE

- NOTES:**
1. STONE SIZE AND MAT DIMENSIONS DETAILED ON PLANS.
 2. STONE SHALL CONSIST OF SUB-ANGULAR FIELD STONE OR ROUGH UNHEWN QUARRY STONE OF APPROXIMATELY RECTANGULAR SHAPE. FLAT OR ROUND ROCKS ARE NOT ACCEPTABLE. THE STONE SHALL BE HARD AND OF SUCH QUALITY THAT IT WILL NOT DISINTEGRATE ON EXPOSURE TO WATER OR WEATHERING, BE CHEMICALLY STABLE AND IT SHALL BE SUITABLE IN ALL OTHER RESPECTS FOR THE PURPOSE INTENDED. THE BULK SPECIFIC GRAVITY (SATURATED SURFACE-DRY BASIS) OF THE INDIVIDUAL STONES SHALL BE AT LEAST 2.5.
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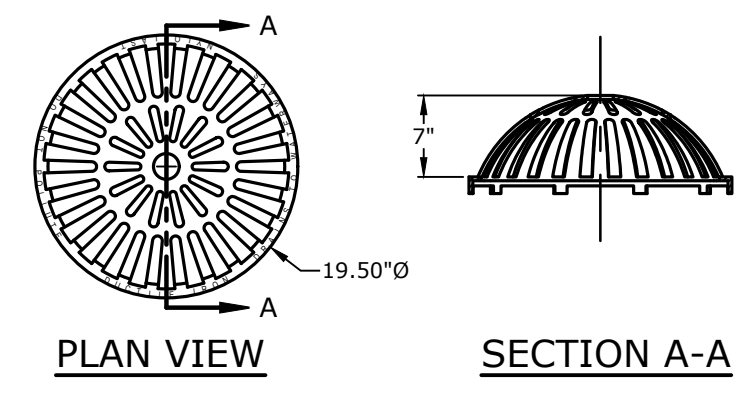
RIP-RAP APRON DETAIL
NO SCALE

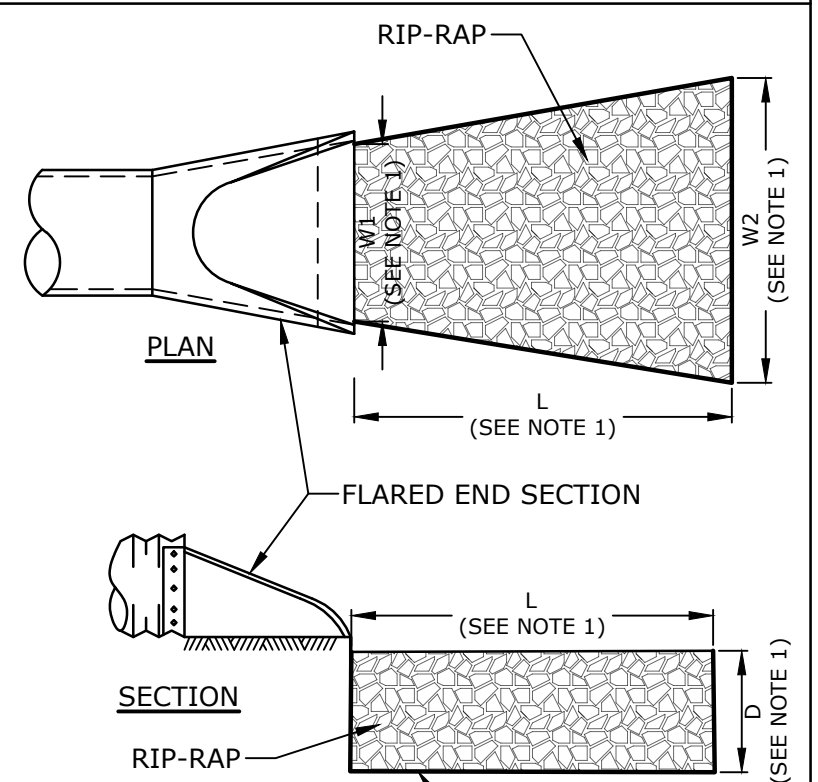

SECTION A-A

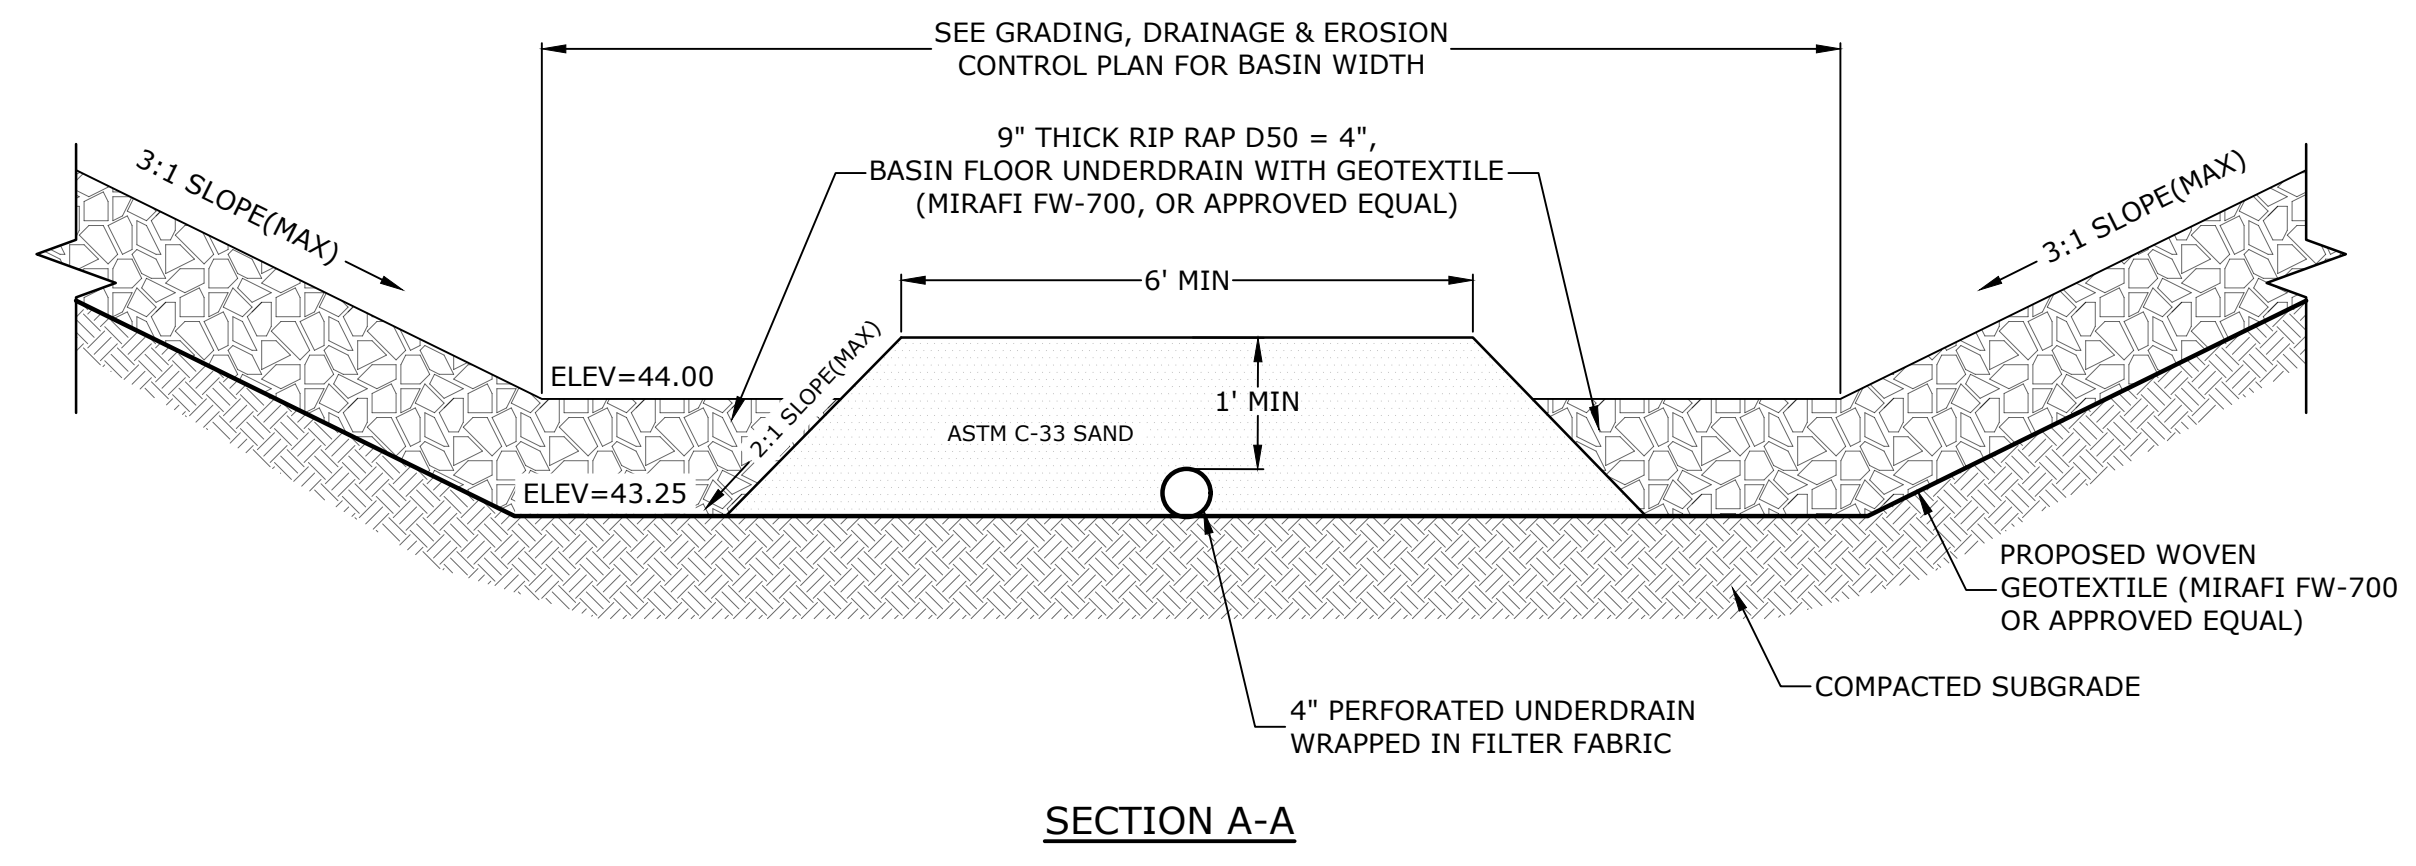
- NOTES:**
1. UNDERDRAIN SAND SHALL BE ASTM C-33 CONCRETE SAND.
 2. 4" PERFORATED UNDERDRAIN SHALL BE ADS SB2 LEACH BED PIPE OR APPROVED EQUAL.

TEMPORARY SEDIMENT BASIN 1
NO SCALE



- NOTE:**
1. 18" DOME GRATE SHALL BE ADS NYLOPLAST, 18 IN DOME GRATE MODEL NUMBER 1899CGD, OR APPROVED EQUAL.

18" DOME GRATE DETAIL
NO SCALE

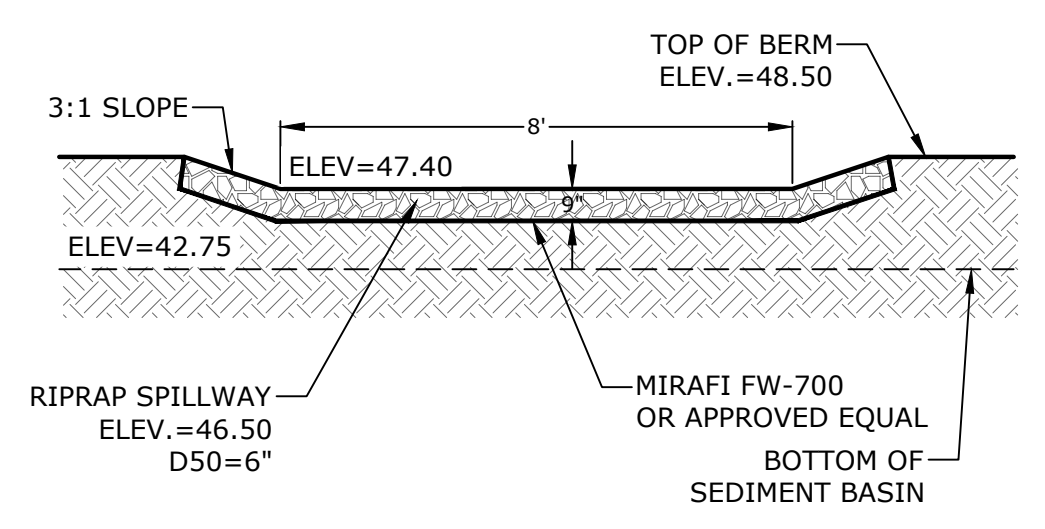

NOTE:

1. SEE SEDIMENT BASIN #1 DETAIL FOR LOCATION.

SEDIMENT BASIN #1 RIPRAP SPILLWAY
NO SCALE

Proposed Industrial Development

Lonza Biologics

Portsmouth, New Hampshire


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G	8/19/2019	Admin. Approval Submission
F	11/6/2018	P.B. Submission

PROJECT NO:	L-0700-013
DATE:	04/03/2018
FILE:	L-0700-026-C-DTLS.dwg
DRAWN BY:	CIK
CHECKED:	NAH
APPROVED:	PMC


DETAILS SHEETS

SCALE: AS SHOWN

C-510

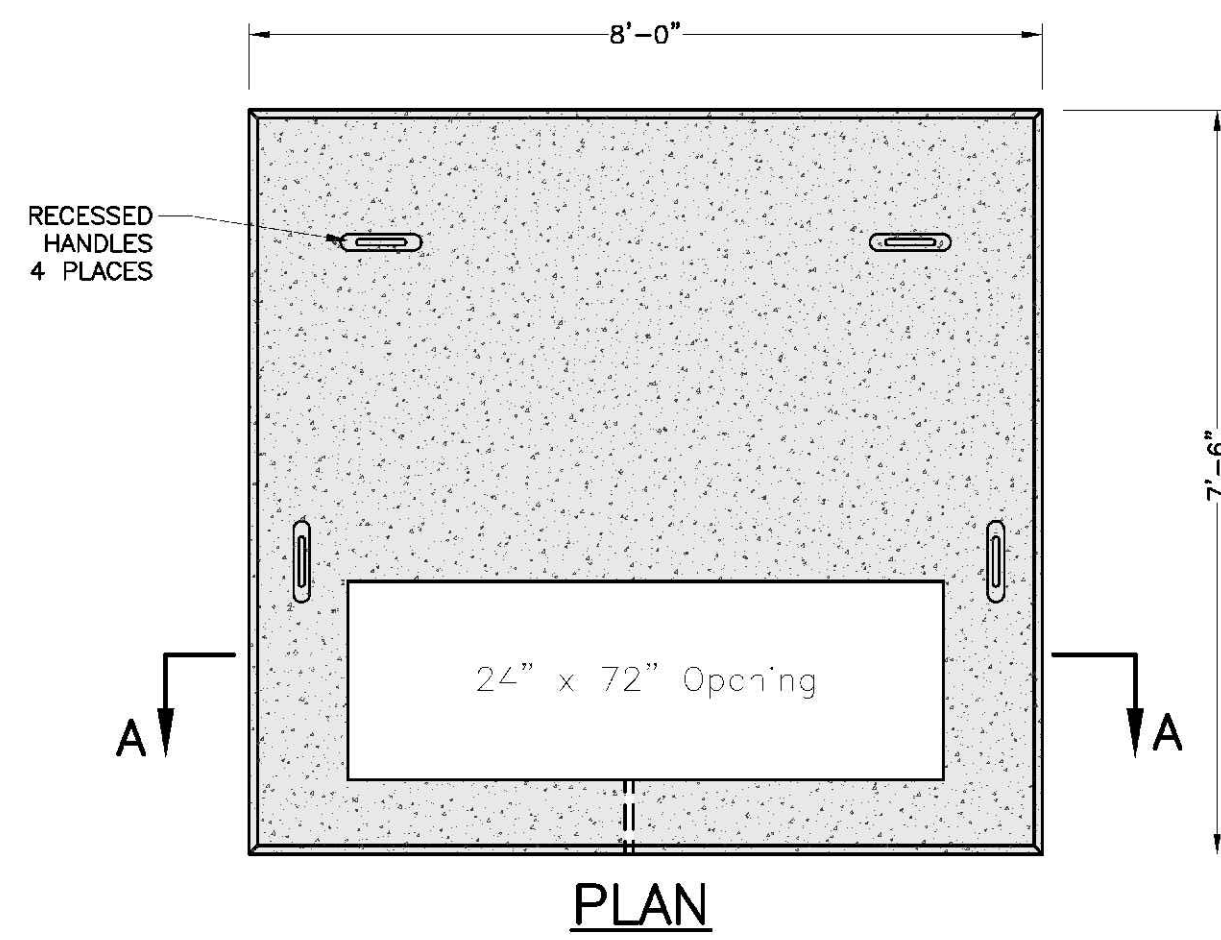


PLAN

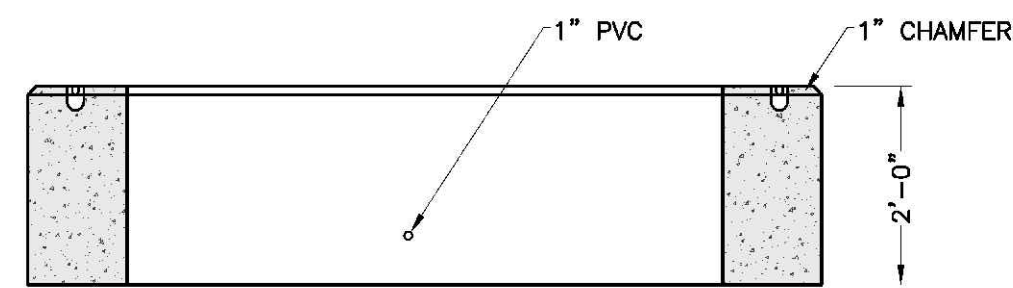


SECTION A-A

- NOTES:
1. DIMENSIONS SHOWN REPRESENT TYPICAL REQUIREMENTS. MANHOLE LOCATIONS AND REQUIREMENTS SHALL BE COORDINATED WITH EVERSOURCE PRIOR TO CONSTRUCTION.
 2. CONCRETE MINIMUM STRENGTH - 4,000 PSI @ 28 DAYS
 3. STEEL REINFORCEMENT - ASTM A615, GRADE 60
 4. PAD MEETS OR EXCEEDS EVERSOURCE SPECIFICATIONS
 5. TRANSFORMER PAD SHALL BE REVIEWED AND APPROVED BY EVERSOURCE PRIOR TO CONSTRUCTION.


TRANSFORMER PAD DETAIL
NO SCALE

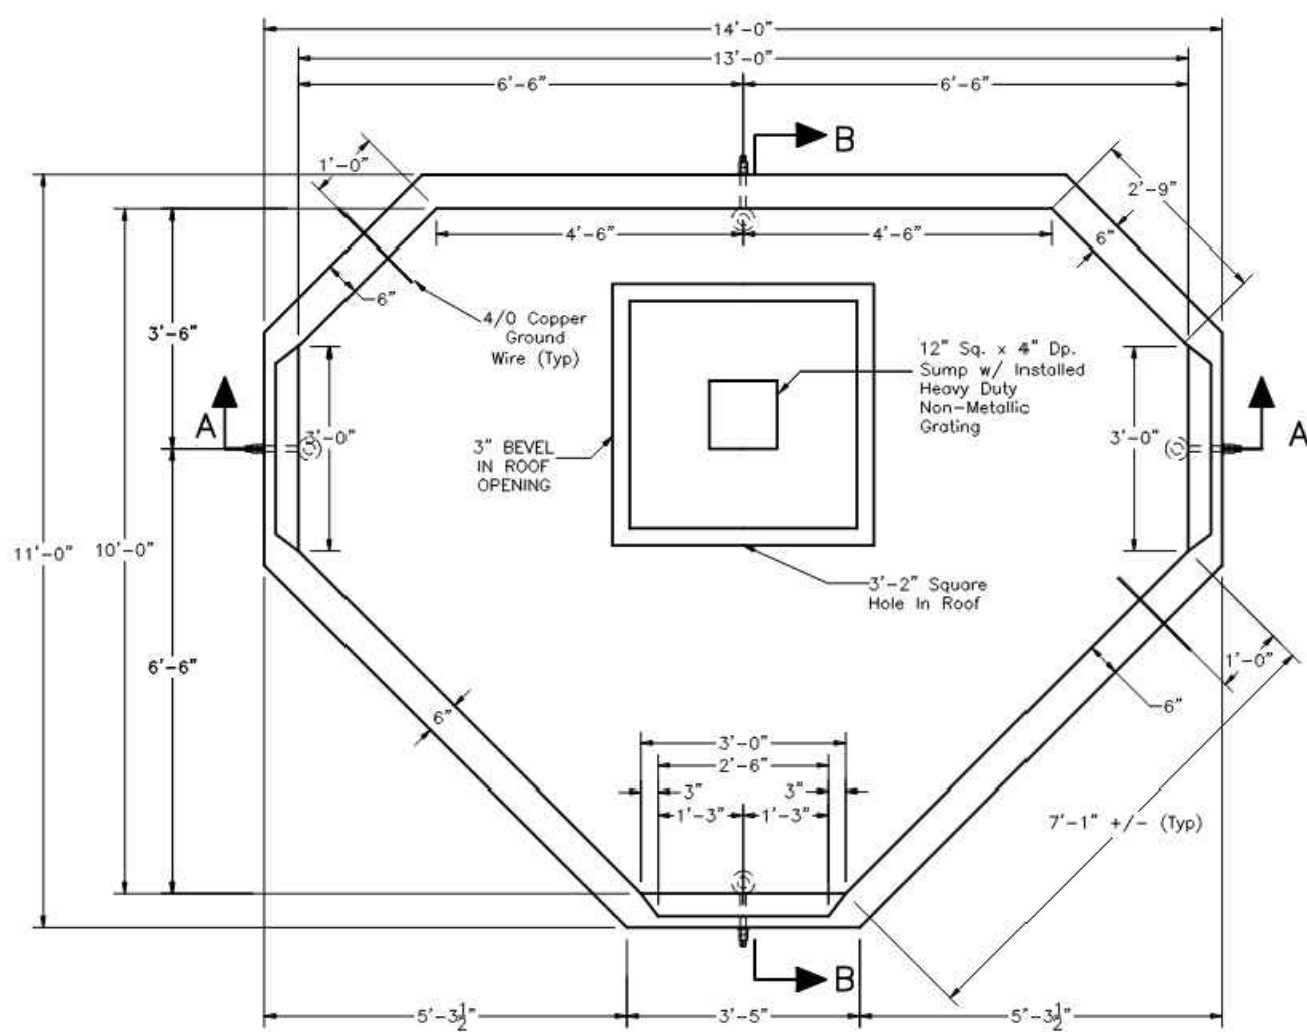

PLAN

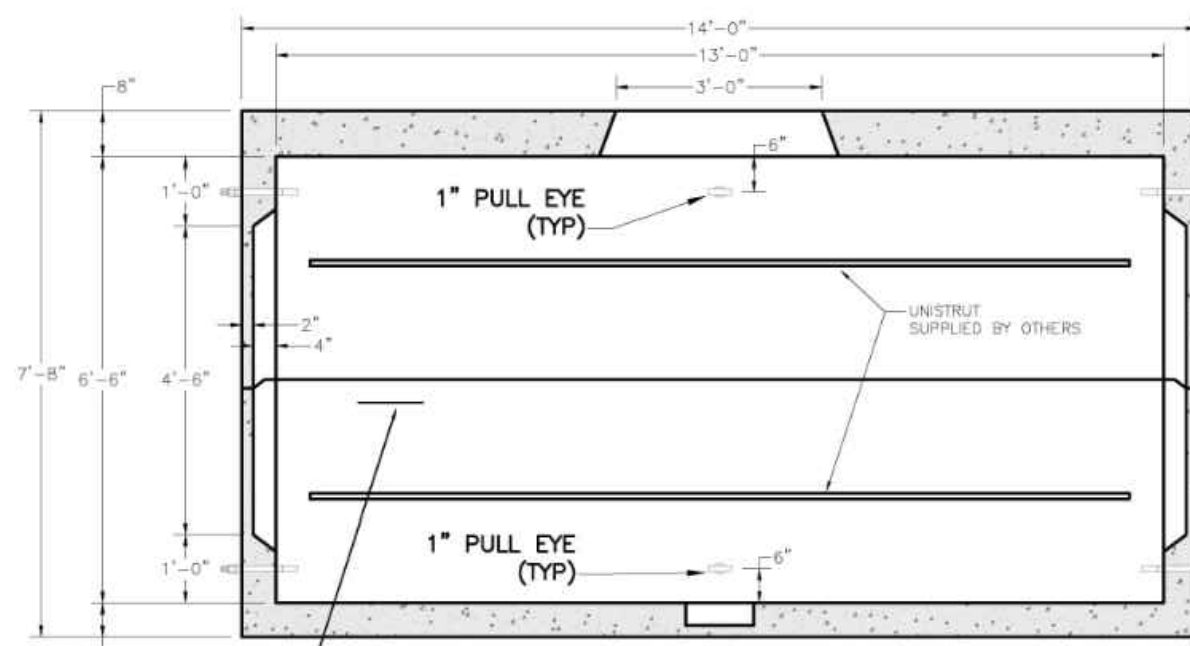


SECTION A-A

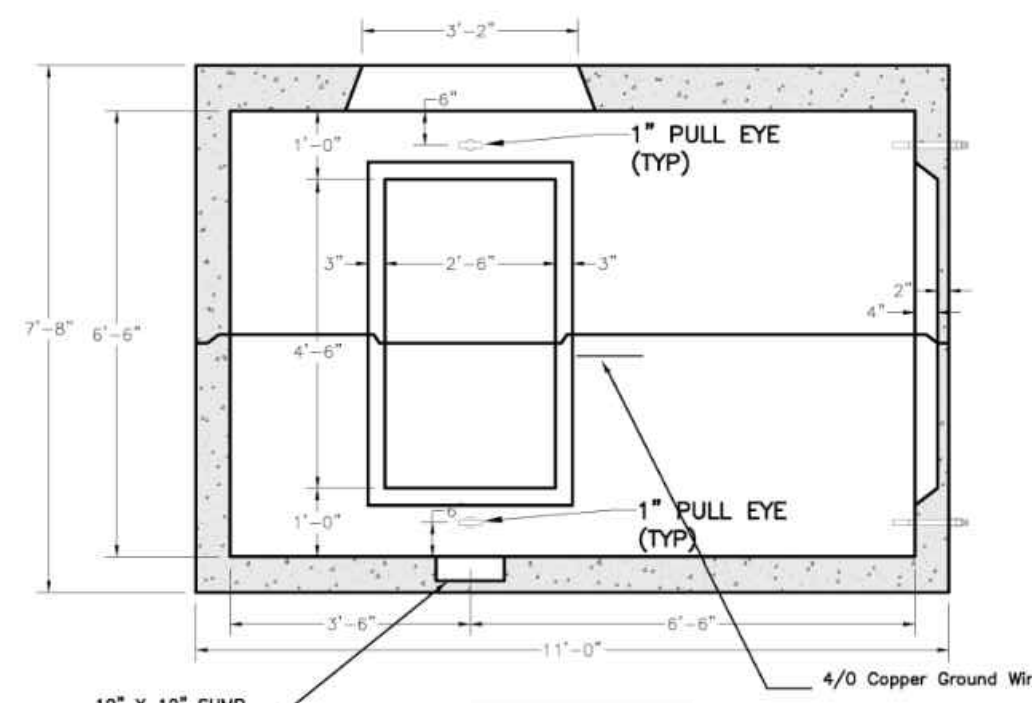

SECTION B-B


- NOTES:
1. DIMENSIONS SHOWN REPRESENT TYPICAL REQUIREMENTS. MANHOLE LOCATIONS AND REQUIREMENTS SHALL BE COORDINATED WITH EVERSOURCE PRIOR TO CONSTRUCTION.
 2. CONCRETE MINIMUM STRENGTH - 5,000 PSI @ 28 DAYS
 3. STEEL REINFORCEMENT - ASTM A615, GRADE 60
 4. DESIGN LOADING - AASHTO HS20-44
 5. EXTERIOR COATING PROVIDED
 6. EXTERIOR COATING PROVIDED
 7. ELECTRIC MANHOLE SHALL BE REVIEWED AND APPROVED BY EVERSOURCE PRIOR TO CONSTRUCTION.

3-WAY ELECTRIC MANHOLE
NO SCALE

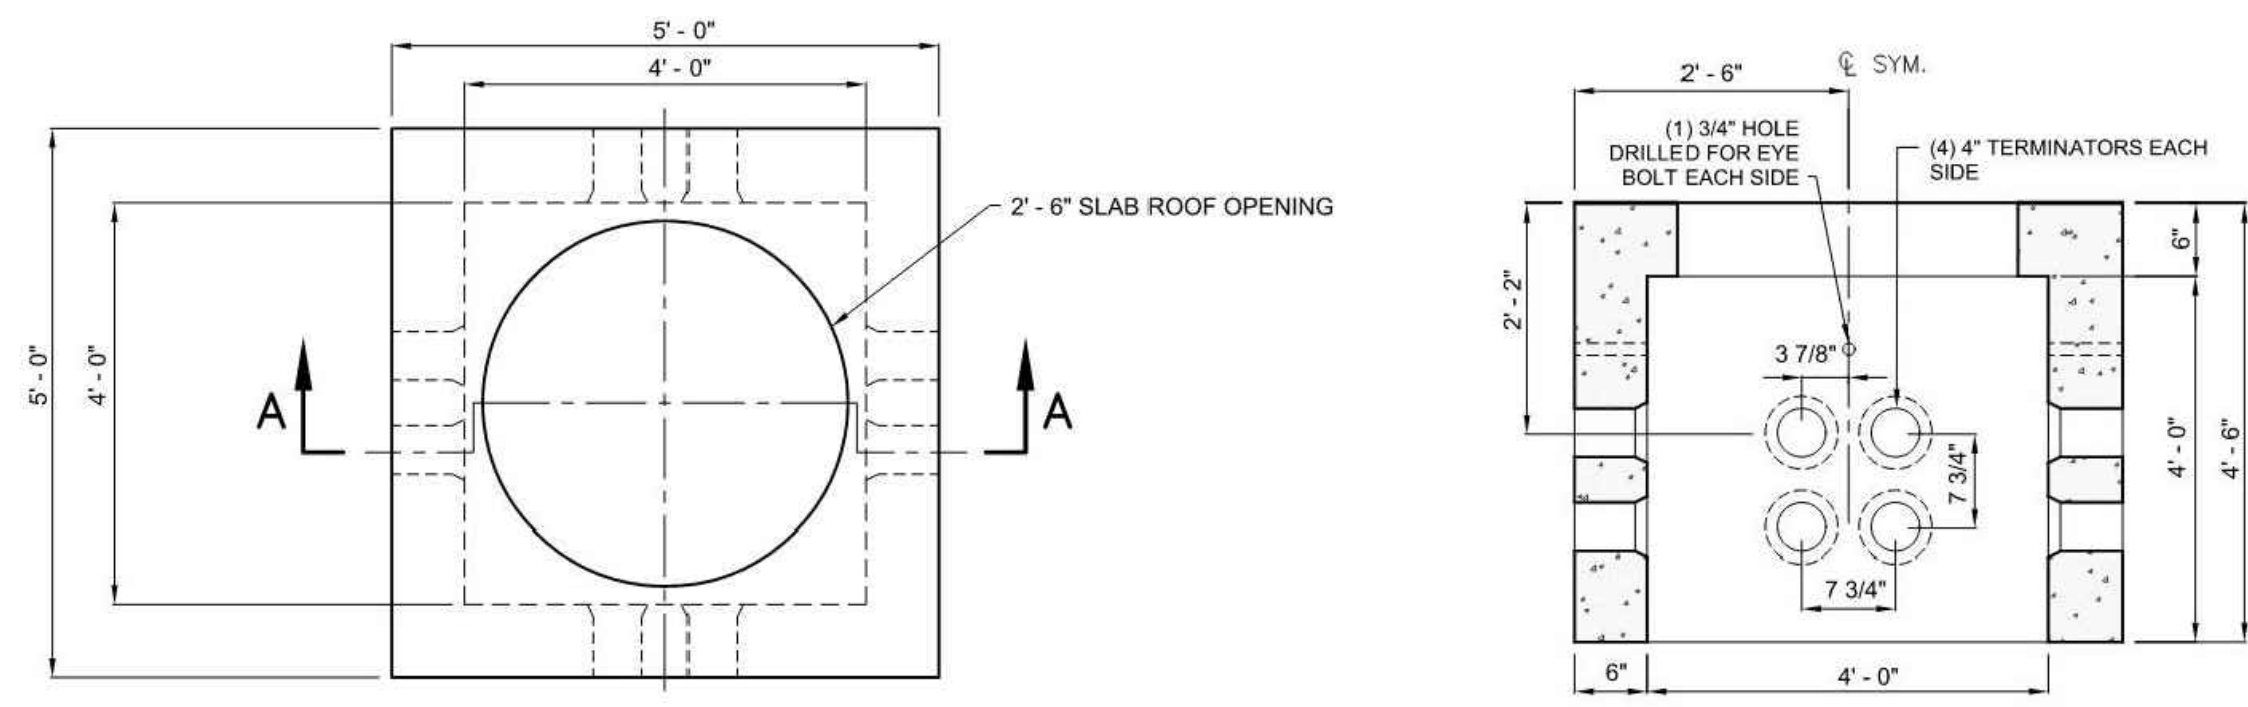


- NOTES:
1. DIMENSIONS SHOWN REPRESENT TYPICAL REQUIREMENTS. HAND HOLE LOCATIONS AND REQUIREMENTS SHALL BE COORDINATED WITH THE UTILITY COMPANY TO CONSTRUCTION.
 2. CONCRETE MINIMUM STRENGTH - 5,000 PSI @ 28 DAYS
 3. STEEL REINFORCEMENT - ASTM A615, GRADE 60
 4. HAND HOLE SHALL BE REVIEWED AND APPROVED BY THE UTILITY COMPANY PRIOR TO CONSTRUCTION.

COMMUNICATIONS HAND HOLE DETAIL
NO SCALE

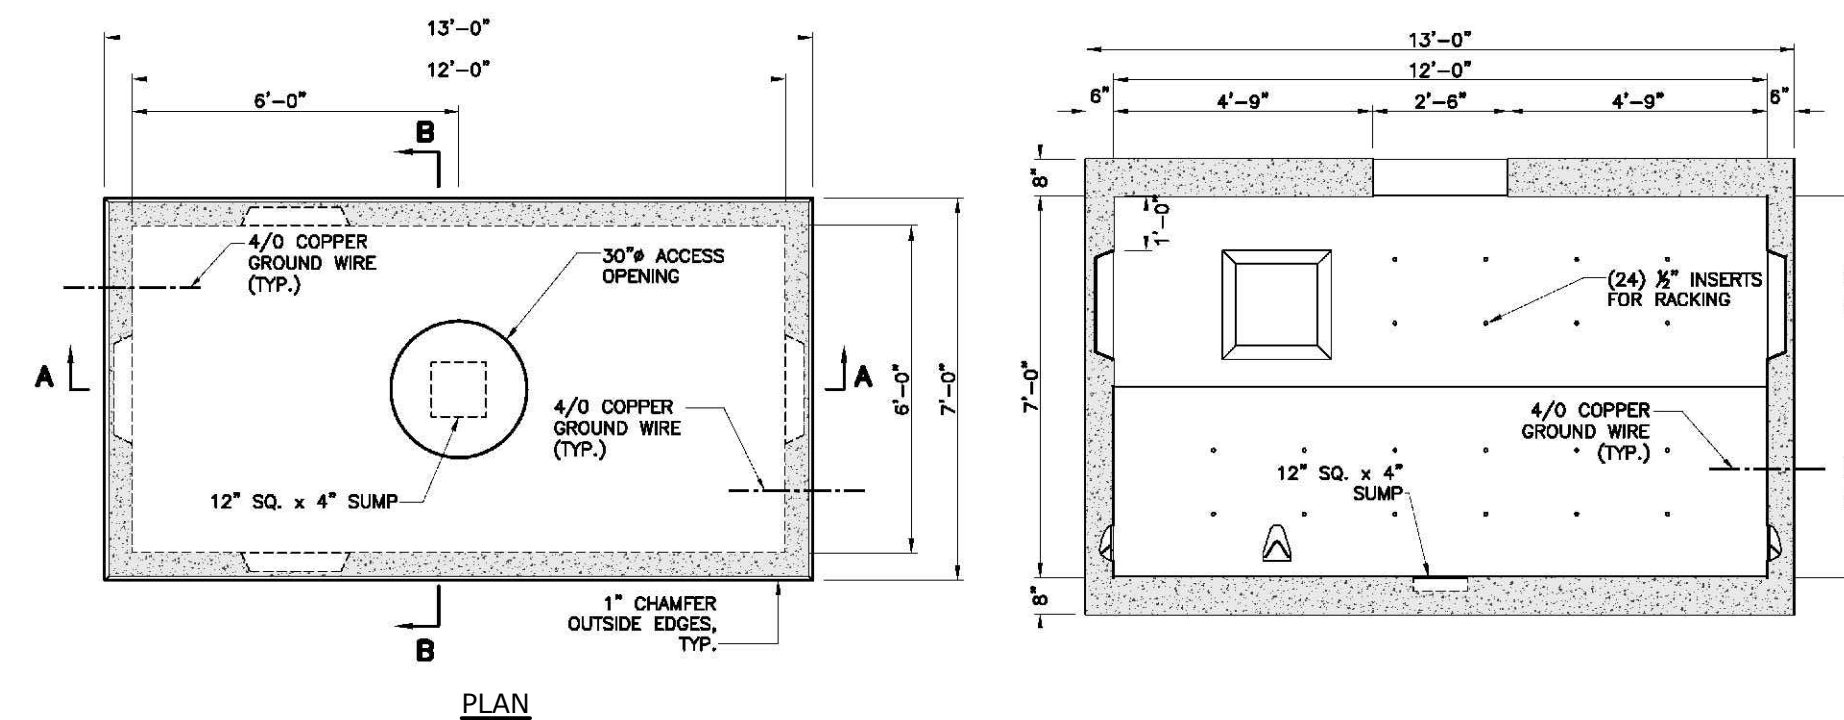


PLAN

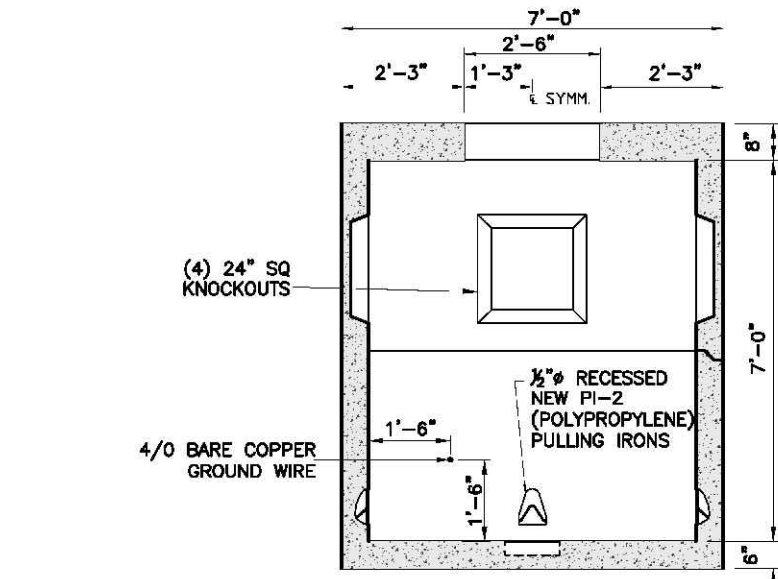

SECTION B-B


- NOTES:
1. DIMENSIONS SHOWN REPRESENT TYPICAL REQUIREMENTS. MANHOLE LOCATIONS AND REQUIREMENTS SHALL BE COORDINATED WITH EVERSOURCE PRIOR TO CONSTRUCTION.
 2. CONCRETE MINIMUM STRENGTH - 5,000 PSI @ 28 DAYS
 3. STEEL REINFORCEMENT - ASTM A615, GRADE 60
 4. MINIMUM STEEL COVER - 1 INCH
 5. DESIGN LOADING - AASHTO HS20-44
 6. EXTERIOR COATING PROVIDED
 7. ELECTRIC MANHOLE SHALL BE REVIEWED AND APPROVED BY EVERSOURCE PRIOR TO CONSTRUCTION.

TYPICAL ELECTRIC MANHOLE
NO SCALE

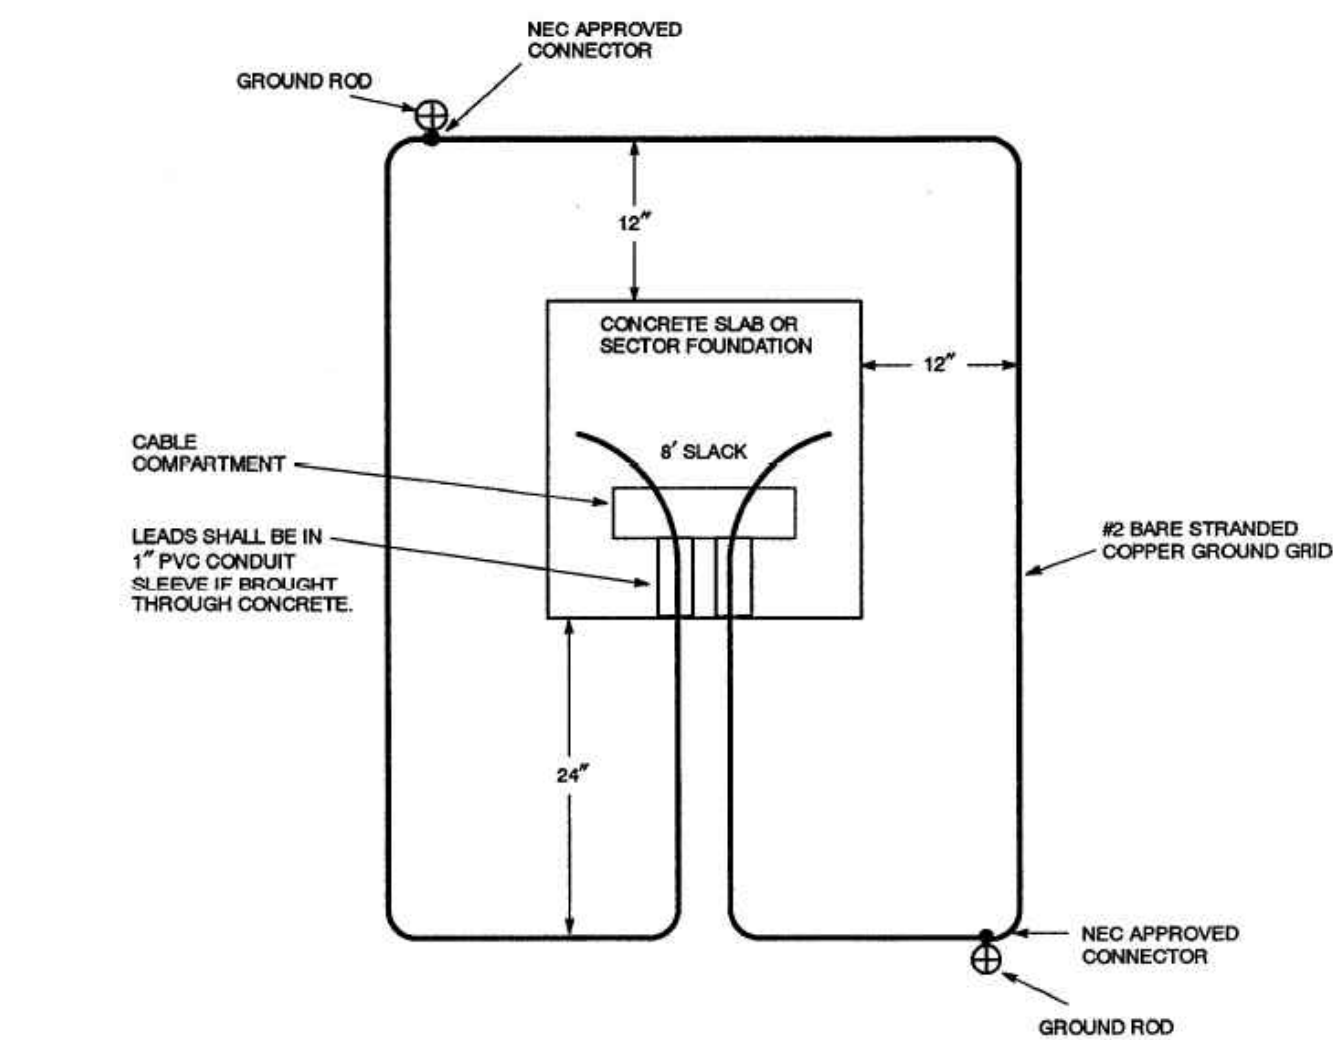

- NOTES:
1. THE GROUND GRID SHALL BE SUPPLIED AND INSTALLED BY THE CONTRACTOR AND IS TO BE BURIED AT LEAST 12 INCHES BELOW GRADE. EIGHT FEET OF EXTRA WIRE FOR EACH GROUND GRID LEG SHALL BE LEFT EXPOSED IN THE CABLE COMPARTMENT TO ALLOW FOR THE CONNECTION TO THE TRANSFORMER. THE TWO 8-FOOT GROUND RODS MAY BE EITHER GALVANIZED STEEL OR COPPERWELD AND THEY SHALL BE CONNECTED TO THE GRID WITH NEC APPROVED CONNECTORS.

TYPICAL PAD-MOUNTED EQUIPMENT GROUNDING GRID DETAIL
NO SCALE


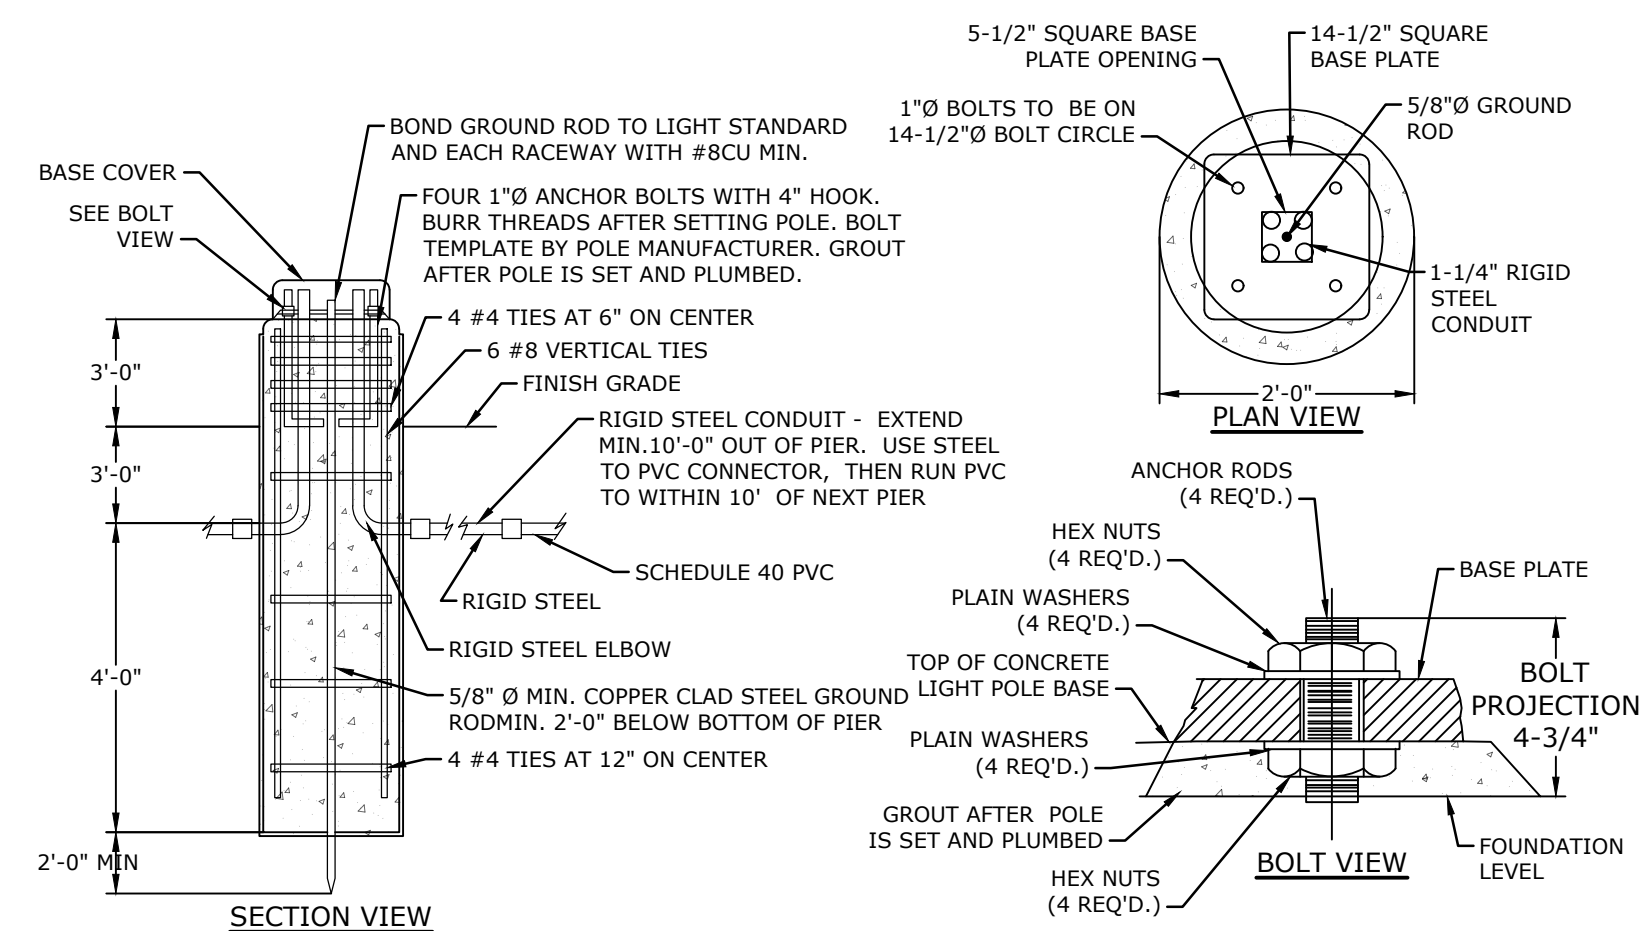


SECTION VIEW

PLAN VIEW

- NOTES:
1. PAINT BASE SAFETY YELLOW (UNLESS PROTECTED BY CURBED ISLAND).
 2. CONCRETE TO BE CLASS A, 4000 PSI, AIR ENTRAINED STEEL TO BE 60 KSI
 3. REFER TO ELECTRICAL PLANS FOR WIRING DETAILS.
 4. LIGHT POLE BASE DETAIL FOR BIDDING PURPOSES ONLY. CONTRACTOR SHALL SUBMIT SHOP DRAWINGS FOR APPROVAL, TO INCLUDE PERFORMANCE SPECIFICATIONS, CALCULATIONS AND NH LICENSED STRUCTURAL ENGINEER'S STAMP FOR LIGHT POLE FOUNDATION.

TYPICAL LIGHT POLE BASE
NO SCALE

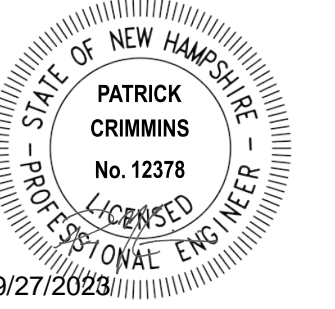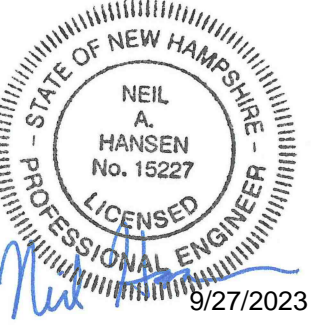

Proposed Industrial Development

Lonza Biologics




Portsmouth, New Hampshire

MARK	DATE	DESCRIPTION
M	9/27/2023	P.B. Submission
L	7/17/2023	Amended Site Plan Review
K	5/5/2023	Phase 1B Issued for Bid
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PROJECT NO:	L-0700-013
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APPROVED:	PMC





DETAILS SHEETS

SCALE: AS SHOWN

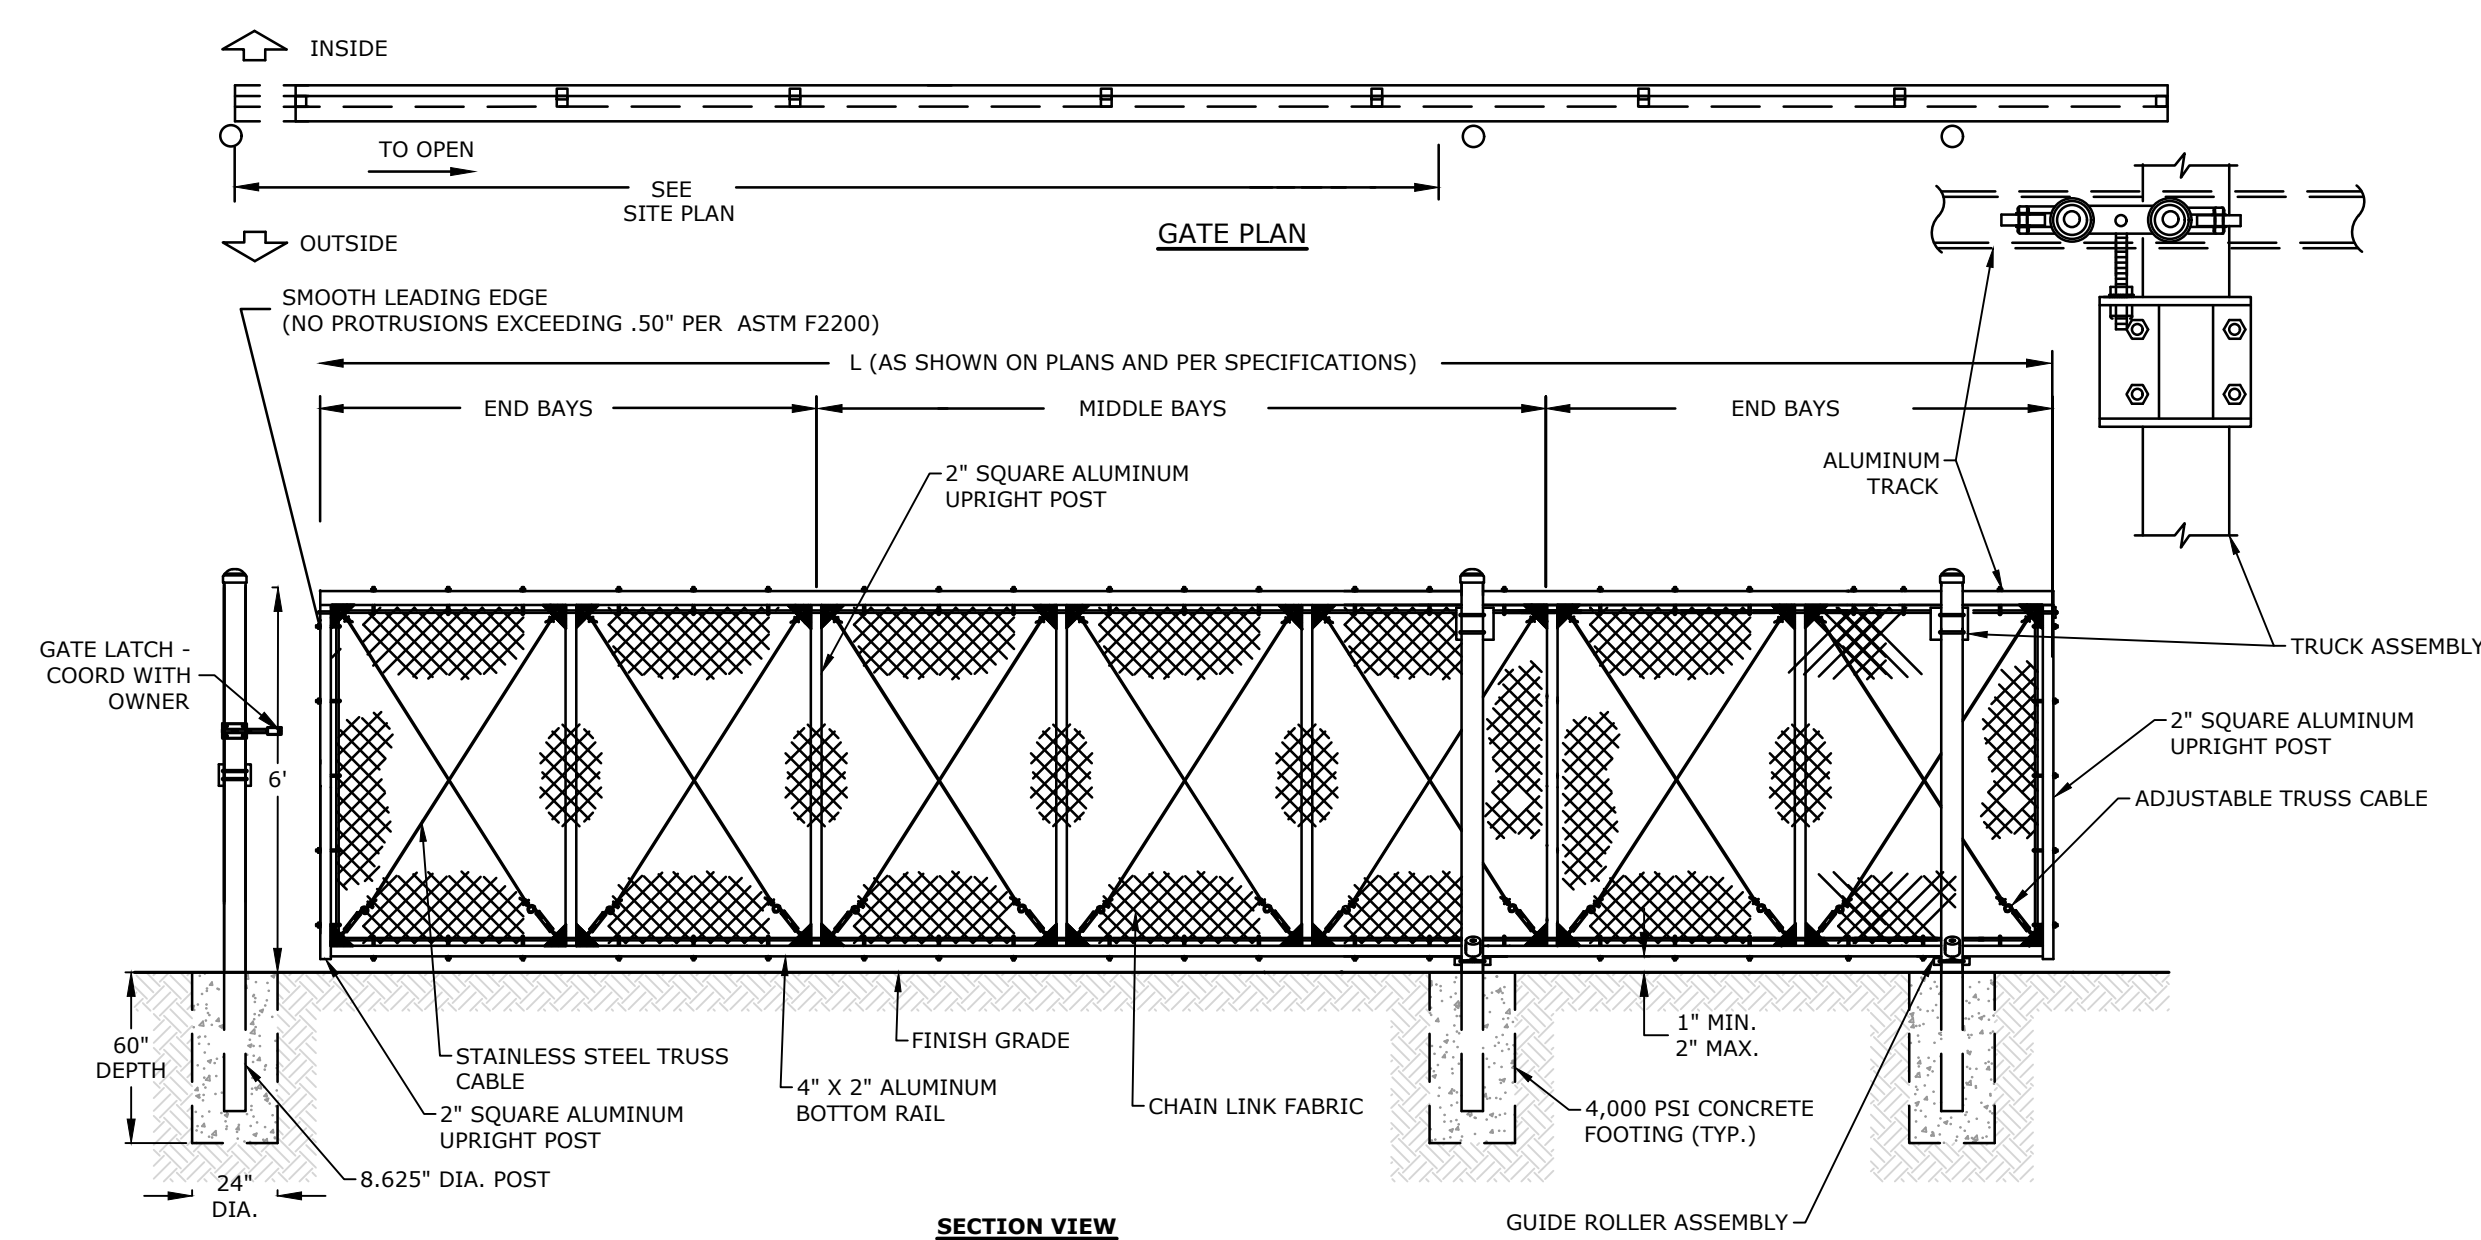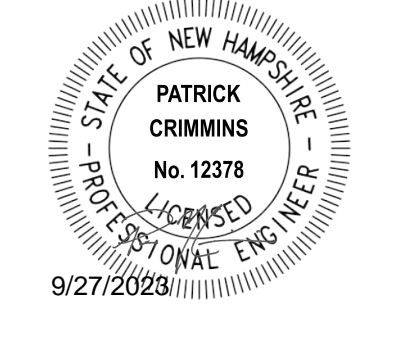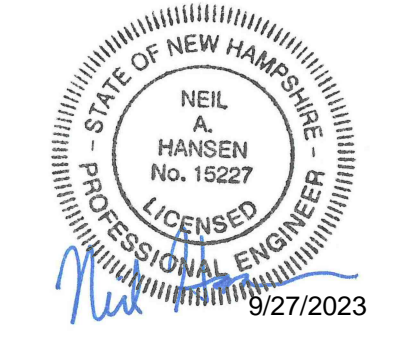


- NOTES:**
1. ALL GATE FRAMES SHALL BE A MINIMUM 1.90\"/>

CANTILEVERED SLIDING GATE
NO SCALE

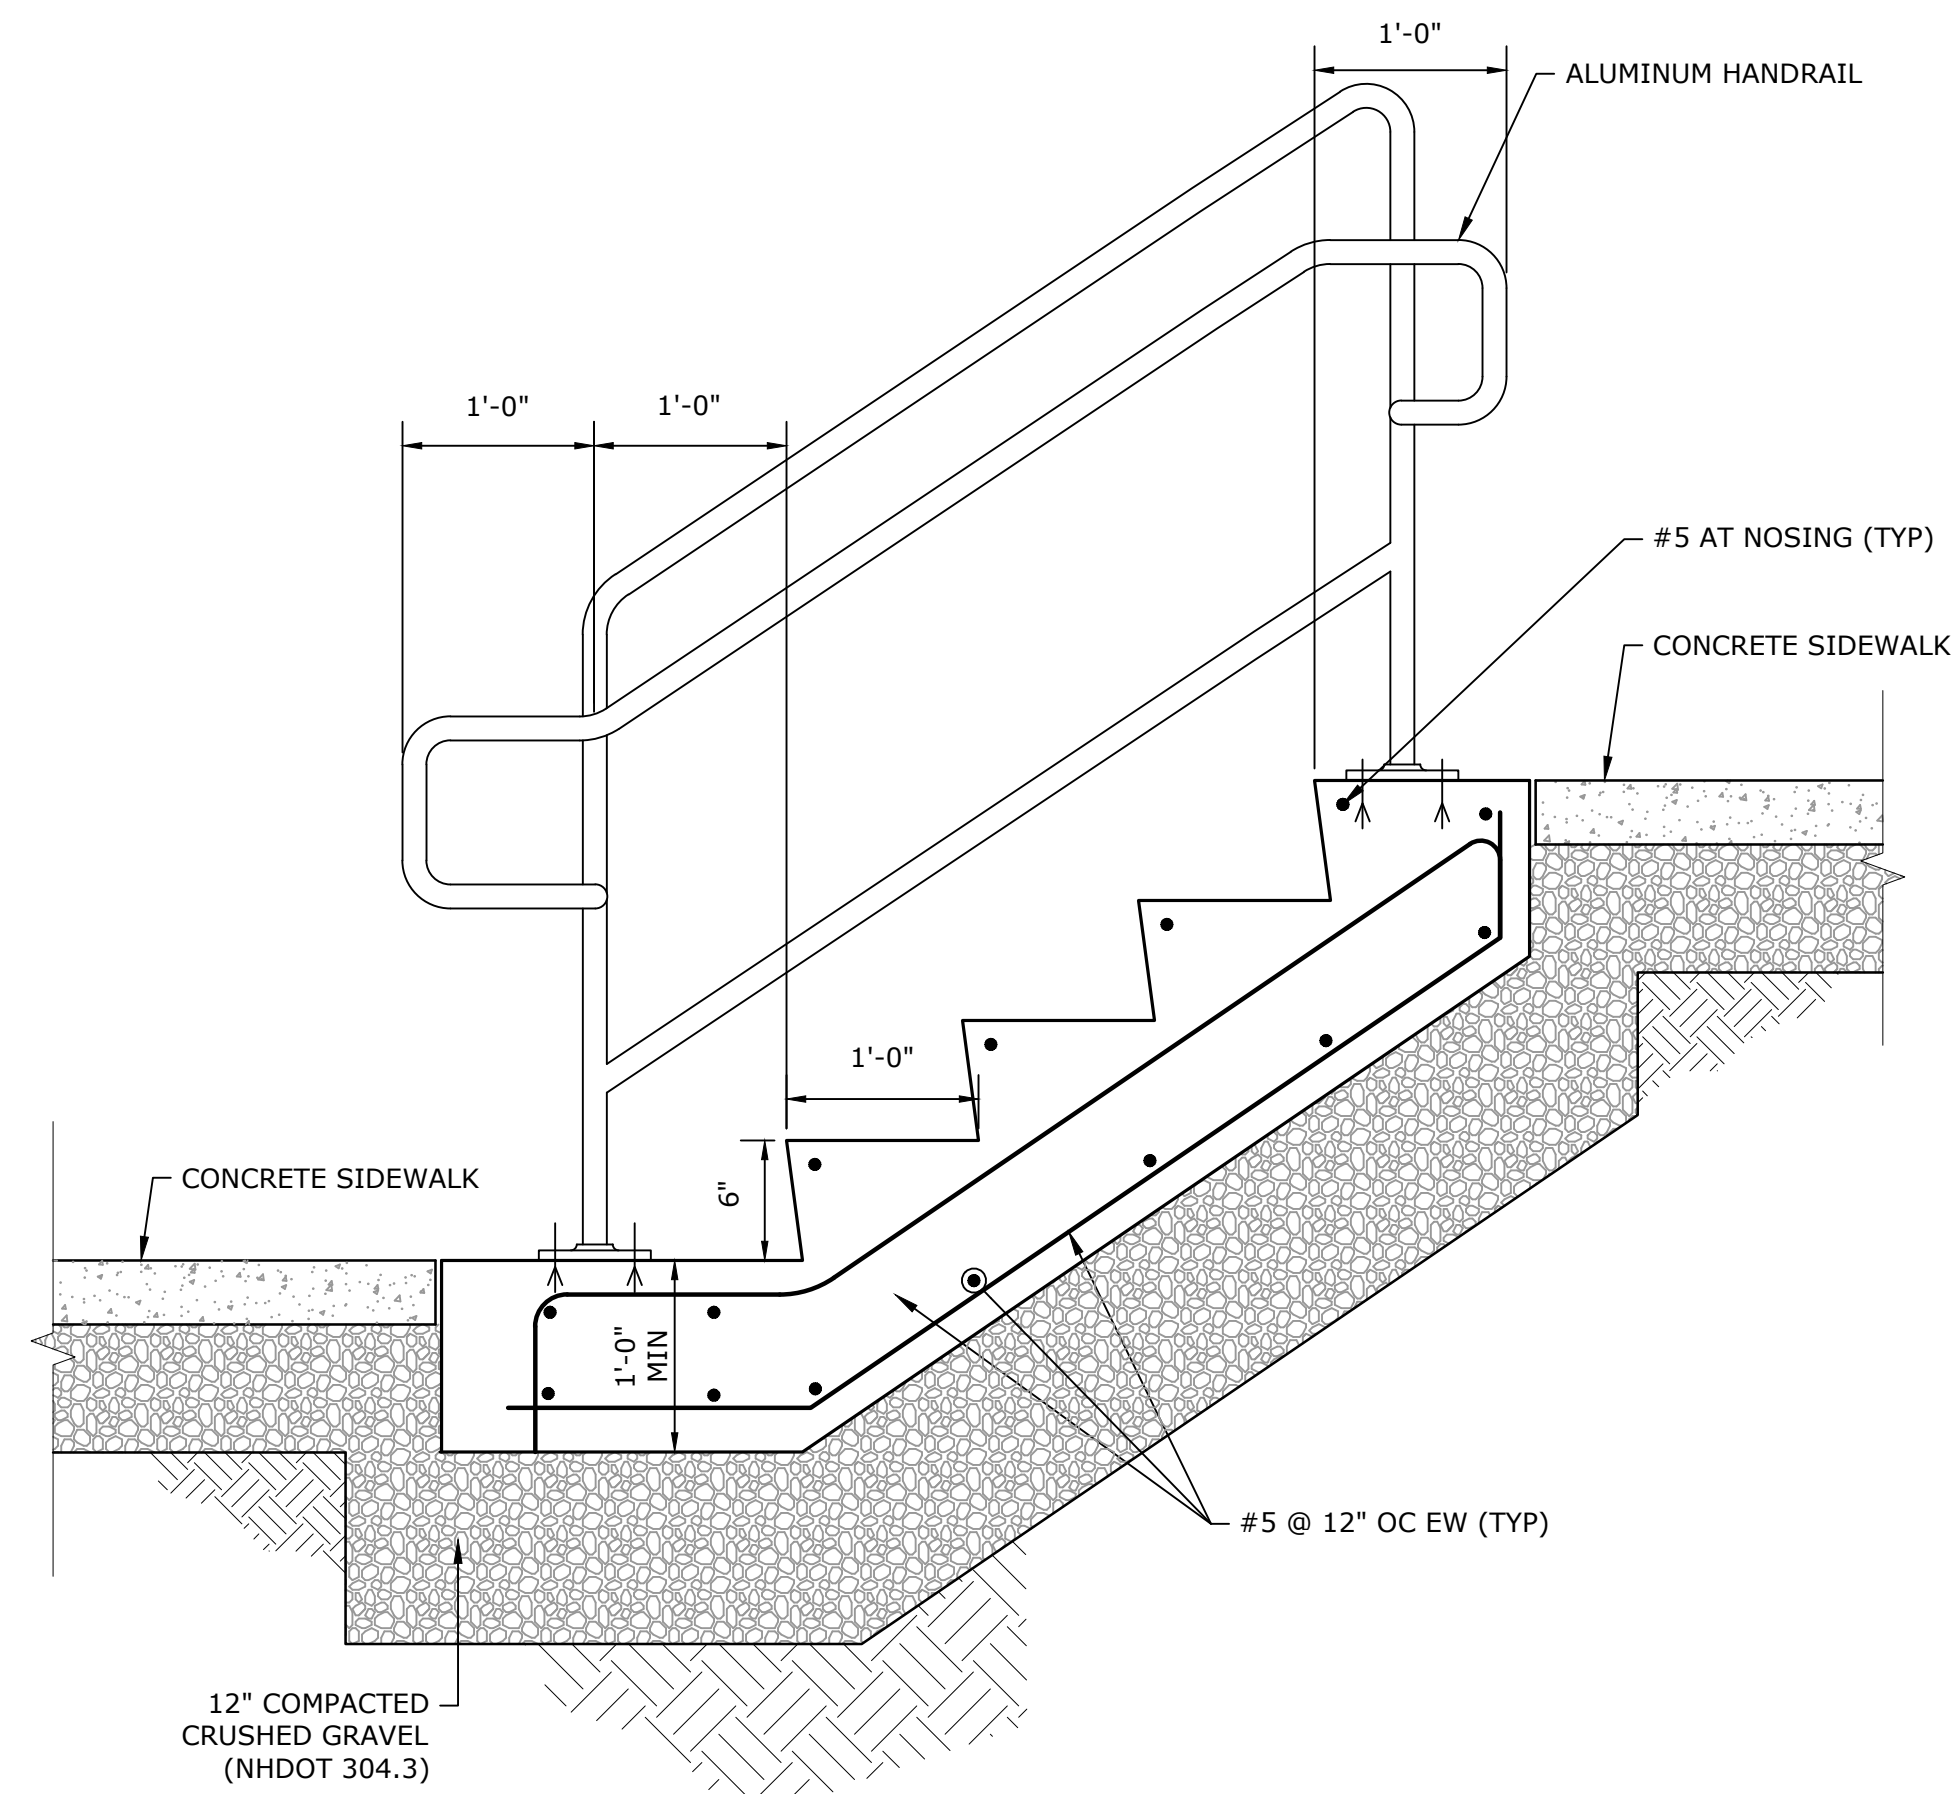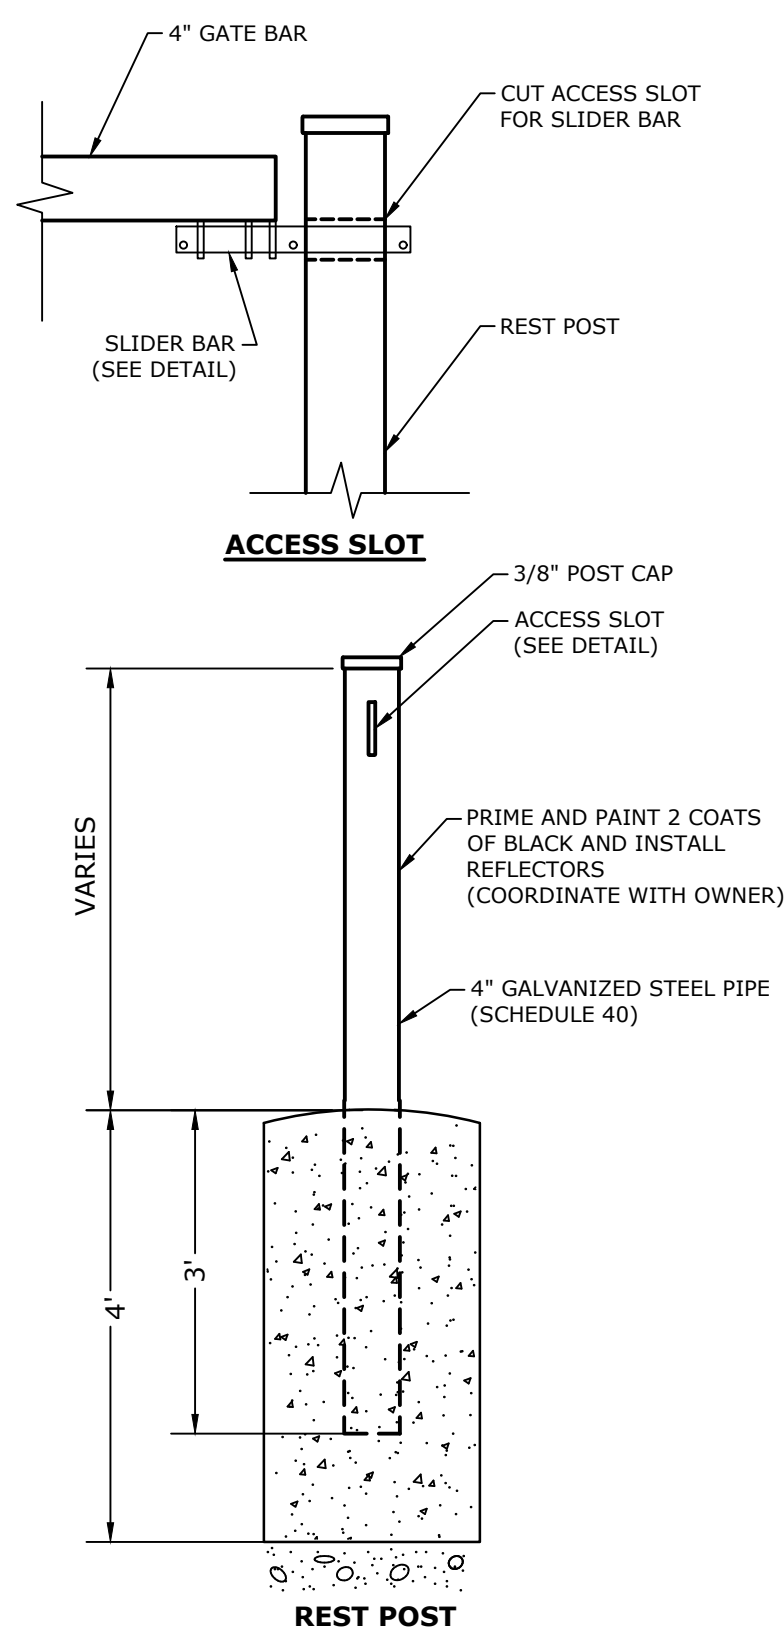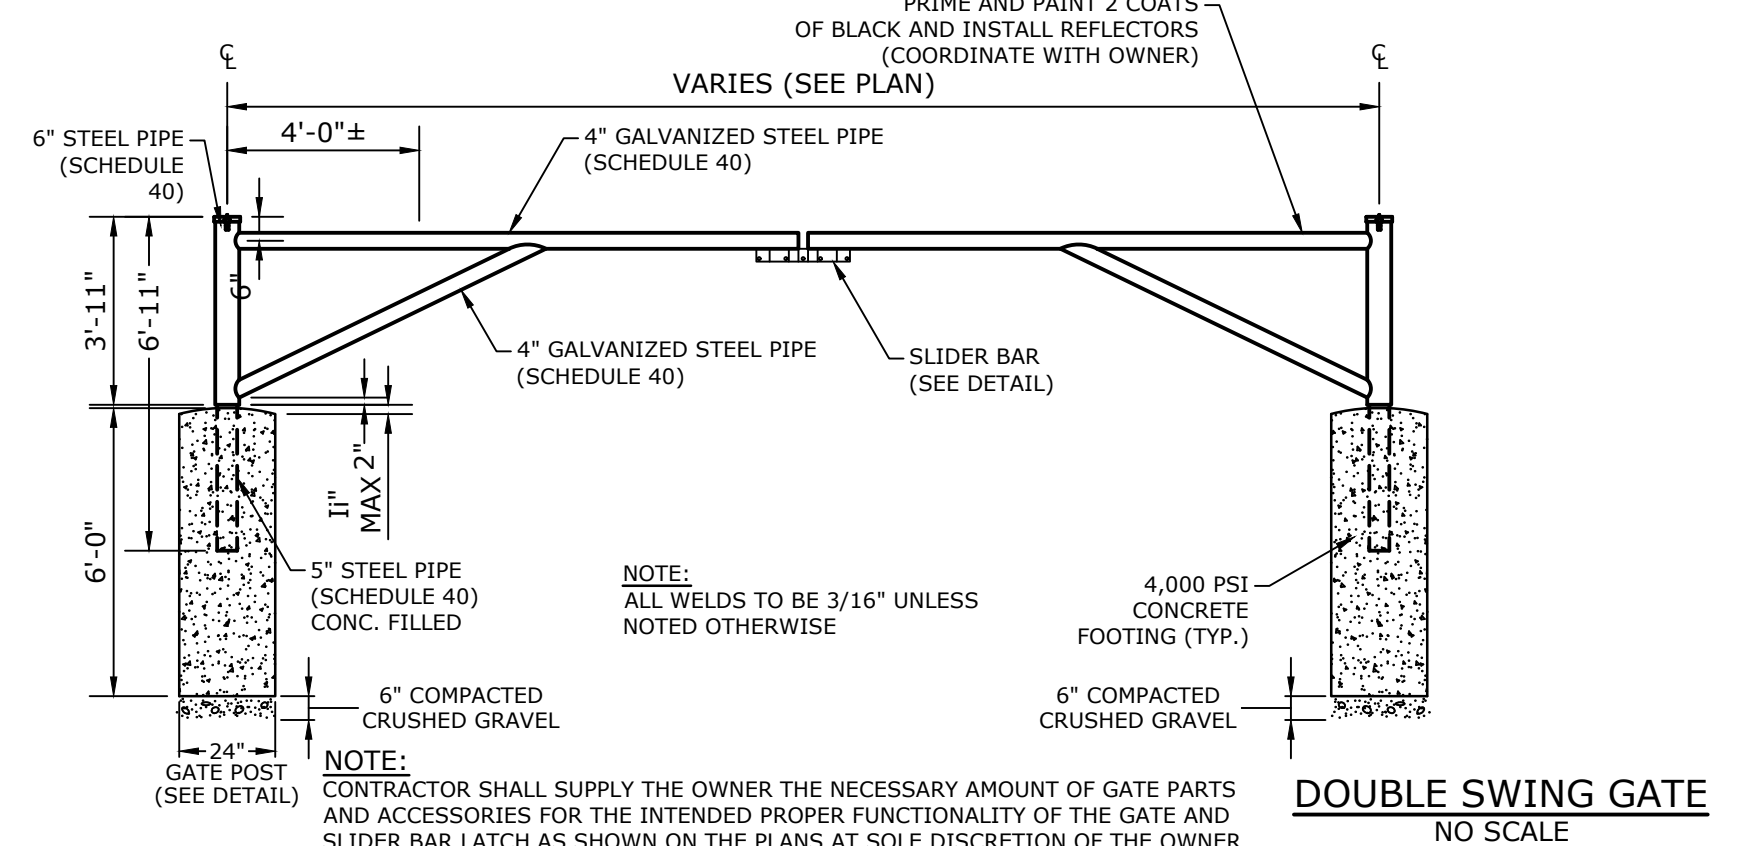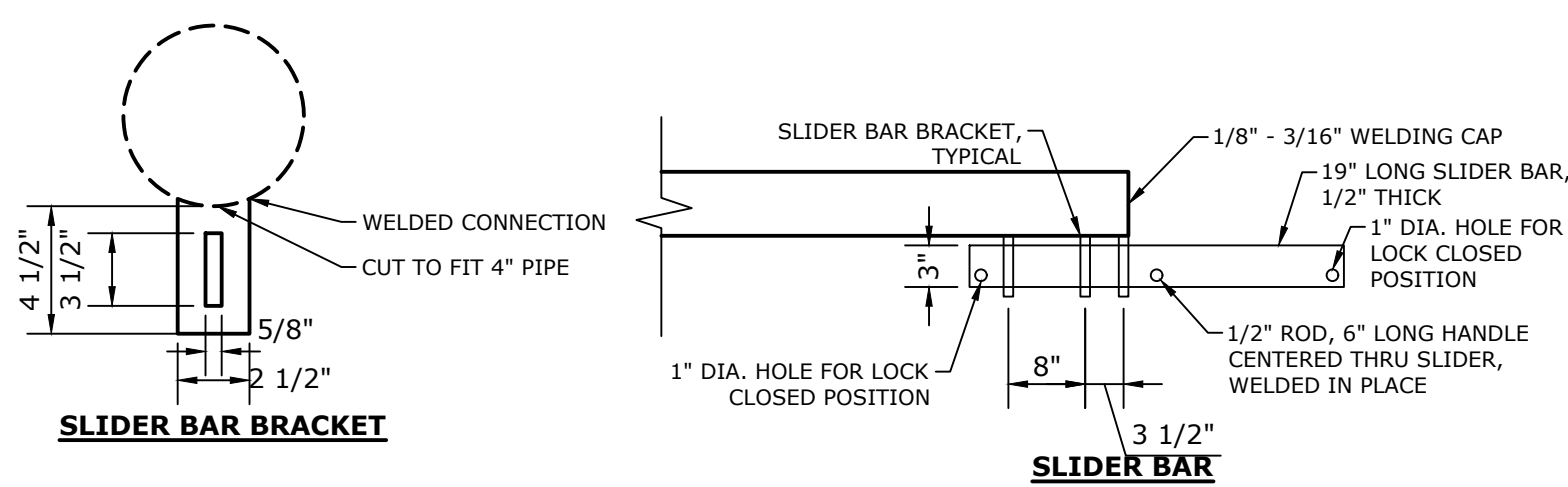

CONCRETE STAIRS AND HANDRAIL
NO SCALE

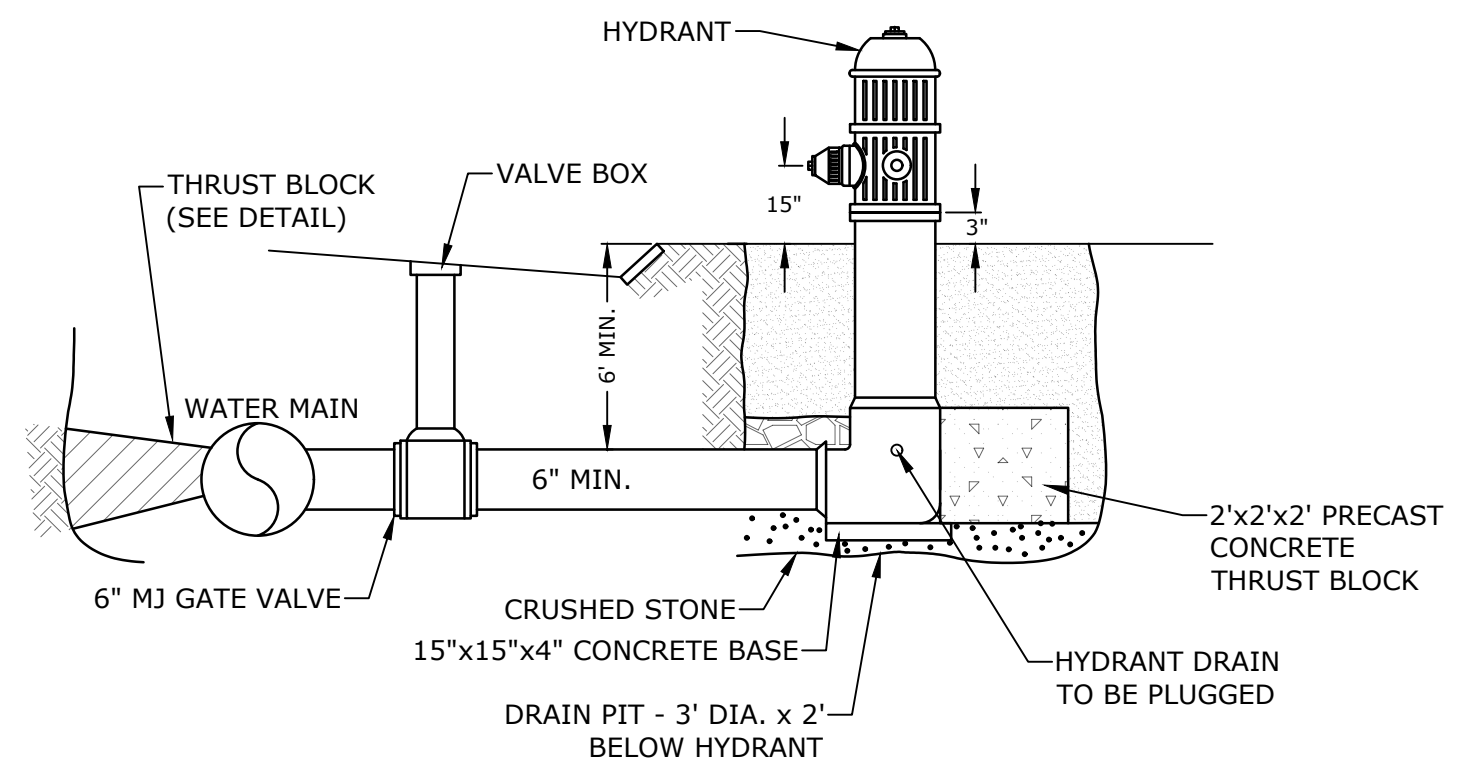

- NOTES:**
1. HYDRANT TO BE KENNEDY TYPE K-81, RIGHT OPEN (NO EQUAL). COORDINATE WITH CITY OF PORTSMOUTH WATER DEPARTMENT AND CITY OF PORTSMOUTH FIRE DEPARTMENT.
 2. PAINT HYDRANT IN ACCORDANCE WITH CITY STANDARD SPECIFICATIONS AFTER INSTALLATION AND TESTING.

FIRE HYDRANT
NO SCALE

Proposed Industrial Development

Lonza Biologics

Portsmouth, New Hampshire

MARK	DATE	DESCRIPTION
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PROJECT NO:	L-0700-013
DATE:	04/03/2018
FILE:	L-0700-026-C-DTLS.dwg
DRAWN BY:	CJK
CHECKED:	NAH
APPROVED:	PMC

DETAILS SHEETS

SCALE: AS SHOWN

C-512

Last Save Date: September 27, 2023 1:49 PM By: CKRZCUIK
 Plot Date: Wednesday, September 27, 2023 Plotted By: Colter Krzucik
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Peter M. Stith, AICP
Planning Manager
City of Portsmouth
Planning & Sustainability Department
1 Junkins Avenue
Portsmouth, NH 03801

October 3, 2023

Ref. T1399

Re: Proposed Lonza Biologics Expansion
Traffic Engineering Peer Review

Dear Mr. Stith:

On behalf of the City of Portsmouth, TEC, Inc. (TEC) has reviewed documents as part of the traffic engineering peer review for the proposed expansion of the Lonza Biologics, Inc. ("the Applicant") manufacturing campus along Corporate Drive in Portsmouth ("the Project"). The Project consists of constructing approximately 800,000 square feet of gross floor area supporting manufacturing, utility, and office space needs; and a new parking structure on a mainly undeveloped parcel as part of the Applicant's master plan. A portion of the Project was previously permitted and approved by the Planning Board in January 2019 with several conditions. The proposed expansion proposal includes one new full-access driveway that will utilize the former Goose Bay Drive right-of-way. The following documents were considered as part of our review:

- *Transportation Impact Assessment – Lonza Biologics*; prepared by Tighe & Bond, dated July 17, 2023;
- *Site Plans – Proposed Industrial Development – 70 & 80 Corporate Drive, Portsmouth, NH*; prepared by Tighe & Bond, dated July 17, 2023; and
- Other project related correspondence.

TEC completed a review of the Applicant's documents on behalf of the City of Portsmouth and provides the following transportation-related comments that we compiled during our review.

Traffic Impact Assessment

1. The Traffic Impact and Access Study (TIAS) prepared by Tighe & Bond (T&B) included the intersections that provide key access to the Project site and following supplemental intersections within the study area as requested by the Planning Board in Condition 2.11:
 - Gosling Road/ Spaulding Turnpike Intersection
 - International Drive/Corporate Drive/Manchester Square Intersection
 - International Drive/Pease Blvd Intersection
 - New Hampshire Ave/International Dr./Corporate Dr./Durham St. Intersection
 - Corporate Drive/Grafton Drive Intersection
 - NH 33/ Grafton Drive Intersection

TEC concurs with the Applicant's expanded study area. *No response required.*

2. Traffic volume counts, including Turning Movement Counts (TMCs) and Automatic Traffic Recorder (ATR) data, were conducted at the study area intersections in February 2022 and March 2023. The recorded volumes for both periods were found to be below the peak monthly conditions based on historical traffic-volume data obtained from NHDOT records, and therefore T&B applied an appropriate adjustment factor. The data was also further adjusted to reflect a COVID adjustment factor of 16% to 53% based on current NHDOT protocols. We believe these adjustments will result in a *highly conservative* assessment of the future No-Build scenario (without the influence of the trips associated with the Project). *No response required.*
3. The weekday morning and weekday evening peak “commuter” hours were studied to determine the project’s overall effect on the roadway. TEC concurs that these selected time periods are appropriate as the peak hours of the industrial development typically overlap with the peak hours of the adjacent street system. We understand that the Applicant currently manages their employee shift times to avoid the actual peak traffic hours. *No response required.*
4. The TIA presents motor vehicle crash data for each study area intersection. The crash data indicates the number, type, and severity of crashes at the study area intersections between 2019 and 2021 obtained from the City of Portsmouth Police Department. The TIA summarizes the general crash statistics. Given the influence of the pandemic, the data from 2020 and 2021 may not provide the most accurate data given the depressed traffic volumes during that time. However, given the data compiled for 2019, TEC concurs with the crash analysis methodology and findings based on the compiled data. *No response required.*
5. The background growth rate of 1.0 percent per year was applied to the 2022/2023 existing volumes to generate the 2025 and 2035 future year volumes per NHDOT guidelines. The traffic projections also included estimated trips associated with other remaining development parcels in the Pease Development Authority (PDA) master plan, including 100 New Hampshire Avenue. Given the COVID adjustments noted in Comment #2, the ambient traffic growth and other background trips, TEC believes the traffic projections are highly conservative. *No response required.*
6. The Project’s trip generation calculations for the proposed expansion of 800,000 square feet were based on the estimated 1,020 new employees and a prorated relationship to the traffic that was generated by the 1,139 existing employees as of 2018. This estimate of new trips may be based on the older data for the Lonza site during a time when they had a predominant in-person work environment. The T&B trip projections however fall well below the calculations based on the ITE *Trip Generation Manual, 11th Edition*, Land Use Codes (LUCs) 110 (General Light Industrial) and 140 (Manufacturing) when using floor area as the independent variable. This may be the result of the Applicant’s proactive management of the employee shift times. If the shift times overlap with the actual peak hours for the adjacent street system, the Applicant’s traffic impacts will be greater. The Planning Board should consider a condition of approval that mandates that the Applicant maintains shift times that do not overlap with the documented morning and evening peak hours for Corporate Drive and International Drive unless otherwise approved by the Board after considering updated traffic data and trip generation information. TEC further recommends that the Board request a daily traffic count for the proposed site access point to better understand the hourly distribution of traffic over the course of several weekdays.


7. The TIA included a distribution analysis for the new trips that was based on the zip code data for the current Lonza employees' place of residence. Given the significant number of new employees, TEC recommends that the Applicant perform a supplemental sensitivity analysis using U.S. Census data and limited travel time runs to confirm the percentage of traffic that is expected to use each gateway to the Pease Tradeport.
8. The Build traffic volumes were grown to 2025 and 2035 to cover an opening year and 10-year planning horizon from time of data collection (2022/2023). TEC concurs with this methodology as these scenarios align with NHDOT Transportation Impact Assessment (TIA) Guidelines. *No response required.*
9. Although the projections may be conservative, TEC generally concurs with the results of the capacity and queue analysis provided as part of the TIA utilizing Highway Capacity Manual (HCM) 6th Edition methodology for the study area intersections. The 2035 Build condition shows some concerning levels of service with high delays for certain traffic movements that are acutely related to the commuter traffic into Pease Tradeport in the morning and departing in the late afternoon and evening peak hours.
10. The Applicant should provide a queue analysis for the proposed driveway gate system to ensure that entering traffic will not queue onto Corporate Drive.
11. The TIA documents substantial delays for the exiting employee traffic during the evening peak hour within the single departure lane. The Applicant should consider separate left- and right-turn lanes at the driveway intersection with Corporate Drive.
12. TEC recommends that the Applicant coordinate with PDA to perform supplemental all-way stop control (AWSC) and traffic signal warrant analysis for the following intersections:
 - a. Corporate Drive at Grafton Road
 - b. International Drive at New Hampshire Avenue / Durham Street
 - c. International Drive / Corporate Drive (for the 2025 Opening Build condition)
13. The TIA states that the intersection of International Drive / Corporate Drive is programmed for NHDOT funding for intersection reconstruction and signalization within the State's 10-year plan. Depending on the actual timing of the project, the Applicant should coordinate with PDA and consider measures for the temporary signalization of this intersection. This should be closely coordinated with a potential condition of approval related to the Applicant's responsibility to provide updated traffic data following the occupancy of Building 1 (and other subsequent buildings) and assess the actual delays and queuing for this key gateway intersection.
14. The intersection of Greenland Road (Route 33) / Grafton Road, a State-controlled intersection, is currently overcapacity for different traffic movements during the peak hours. Although TEC does not believe that direct physical mitigation is warranted for the Applicant at this intersection, the City and PDA should work with NHDOT to identify long-range improvements to add capacity to this intersection.
15. Based on the results of the capacity and warrant analyses listed above, the Applicant should coordinate with PDA and other applicants within Pease Tradeport to develop a fair-share cost assessment for mitigation measures based on the number of new trips.
16. Corporate Drive currently accommodates an exclusive left-turn lane for the Residence Inn and Redhook Way that traverses the opening for Goose Bay Drive (site driveway). The

Applicant should review the potential for lane use changes within Corporate Drive that may consider an exclusive left-turn lane for Lonza's entering traffic. Any planned improvements should consider an enhanced pedestrian crossing between the Lonza site and the existing COAST bus stop on the opposite side of Corporate Drive in the vicinity of Redhook Way, including a new bus shelter to provide additional accommodations for existing and future transit riders.

17. The TIA does not include any parking occupancy data for the existing Lonza site and does not provide an analysis of the proposed parking supply in relation to the projected number of employees in Phase 2 and the Site Master Plan. The supply may indeed be appropriate based on the number of employees on each shift but should be confirmed with a reasonable level of parking analysis in relation to the zoning requirements.
18. The Applicant should coordinate with the City, PDA, and COAST to review the current ridership along Bus Route 42 related to the Lonza facility and identify opportunities for coordinated service schedules and potential bus route changes for Route 13 (Dover) and Route 14 (Rochester) to further reduce single-occupancy vehicle trips for several PDA employers.

Site Plans

19. The site plan currently depicts enclosed truck and trailer staging for deliveries. The Applicant should confirm that they do not require any exterior trailer parking as none is currently shown. TEC recommends that the Board considers a condition that prohibits exterior trailer storage in areas that are not specifically identified on the plan.
20. One trash compactor is located near the southerly corner of Building #1. The Applicant should confirm that they do not need additional exterior dumpsters for each building and confirm the truck circulation for any newly proposed locations.
21. The plans should include additional details for the signs and striping for the gated access points to the site. This may include additional roadway striping at the end of the Goose Bay Drive cul de sac to delineate the transition to the proposed private way.
22. TEC recommends the construction of additional sections of on-site sidewalks within the Phase 2 area to provide a sidewalk circuit for employees that desire to walk during breaks without unnecessarily traversing the busier on-site driveway aisles. This may include a new sidewalk along the northwesterly edge of Goose Bay Drive to connect to the recently constructed sidewalk along Corporate Drive and another segment south of the proposed 3-story utility building (shown in red below).

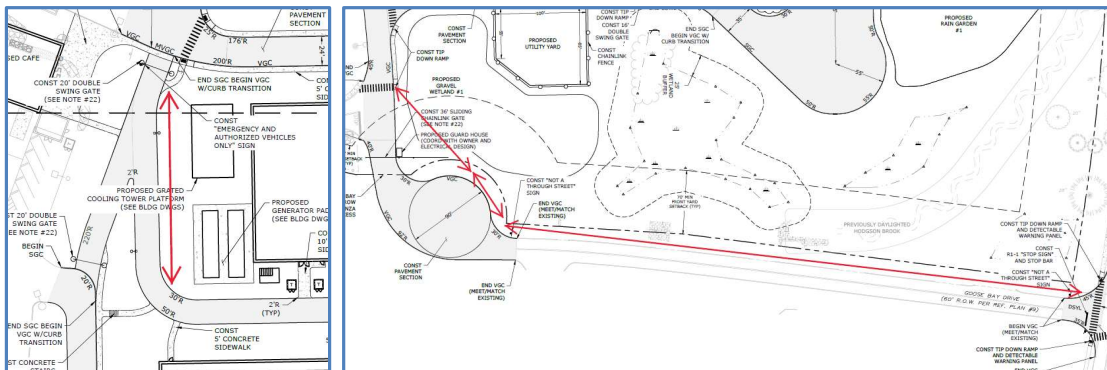

210700-026
October 24, 2023

Peter Stith, AICP
Planning Manager
Department of Planning & Sustainability
City Hall, 3rd Floor
1 Junkins Avenue
Portsmouth, NH 03801

Re: **Lonza Biologics Proposed Expansion
Traffic Peer Review Response 1**

Dear Mr. Stith:

Tighe & Bond has prepared this letter in response to peer review comments on the subject project received from The Engineering Corp (TEC) in a letter dated October 3, 2023. For ease of review, TEC comments are repeated herein in *italics*, followed by our response for each in **bold**. Comment responses are provided herein for comments on the Traffic Impact Study (TIS); responses to site plan comments will be provided under separate cover.

Traffic Impact Assessment Comments

Comments 1 through 5 were informational, and no response is required.

Comment 6: The Project's trip generation calculations for the proposed expansion of 800,000 square feet were based on the estimated 1,020 new employees and a prorated relationship to the traffic that was generated by the 1,139 existing employees as of 2018. This estimate of new trips may be based on the older data for the Lonza site during a time when they had a predominant in-person work environment. The T&B trip projections however fall well below the calculations based on the ITE Trip Generation Manual, 11th Edition, Land Use Codes (LUCs) 110 (General Light Industrial) and 140 (Manufacturing) when using floor area as the independent variable. This may be the result of the Applicant's proactive management of the employee shift times. If the shift times overlap with the actual peak hours for the adjacent street system, the Applicant's traffic impacts will be greater. The Planning Board should consider a condition of approval that mandates that the Applicant maintains shift times that do not overlap with the documented morning and evening peak hours for Corporate Drive and International Drive unless otherwise approved by the Board after considering updated traffic data and trip generation information. TEC further recommends that the Board request a daily traffic count for the proposed site access point to better understand the hourly distribution of traffic over the course of several weekdays.

Response: Site-specific data was utilized in the trip generation estimate in lieu of ITE data based on the specialized use of the proposed building. It is generally desirable to utilize site-specific data if available. It is important to note that Lonza continues to operate under a hybrid work policy, averaging over 60% employees working in the office on work days between June 2023 and October 2023. The trip generation estimate was based on existing employee data assuming



a fully occupied building and did not account for the current hybrid work policy. In addition, no trip reduction credit was taken for future employees working from home. As noted in the Traffic Study, “trip generation is based on the peak hour of the generator and applied to the peak hour of the study area network, which also results in a conservative approach”. Based on these assumptions, the proposed trip generation represents a conservative estimate of predicted site trips.

Employee parking garage badge swipes obtained from October 10 to 12, 2023, indicate approximately half of existing employees arrive prior to the current peak hour, which begins at 7:15 AM. Therefore, while there may be some amount of overlap between proposed arriving site trips and the network peak hour, much of the site traffic is estimated to arrive prior to the 7:00 to 9:00 AM period.

Comment 7: The TIA included a distribution analysis for the new trips that was based on the zip code data for the current Lonza employees’ place of residence. Given the significant number of new employees, TEC recommends that the Applicant perform a supplemental sensitivity analysis using U.S. Census data and limited travel time runs to confirm the percentage of traffic that is expected to use each gateway to the Pease Tradeport.

Response: Employee zip code data was used as a basis for the trip distribution following a request by the City of Portsmouth Technical Advisory Committee (TAC) during the previous Lonza Master Planning effort. While site-specific employee zip code data may provide a more realistic estimate of travel patterns, U.S. Census data was also reviewed as part of a sensitivity analysis. The comparison shows minor deviations in estimated travel patterns with a slightly higher proportion of traffic (80%) traveling toward Gosling Road and the Spaulding Turnpike interchange, amounting to an increase of 6 trips during the weekday morning peak hour and 14 trips during the weekday afternoon peak hour. The minor changes in traffic volumes are not expected to significantly impact traffic operations beyond what was presented in the TIS.

Travel times to/ from the major interchanges (I-95 and Spaulding Turnpike) were accounted for when developing the trip distribution. Based on existing travel patterns, it is anticipated that the majority of site traffic from the south will access the site via Spaulding Turnpike. However, the regional trip distribution does recognize 15% of traffic to/ from the south on I-95 will utilize Route 33, while 10% will utilize Spaulding Turnpike.

Comment 9: Although the projections may be conservative, TEC generally concurs with the results of the capacity and queue analysis provided as part of the TIA utilizing Highway Capacity Manual (HCM) 6th Edition methodology for the study area intersections. The 2035 Build condition shows some concerning levels of service with high delays for certain traffic movements that are acutely related to the commuter traffic into Pease Tradeport in the morning and departing in the late afternoon and evening peak hours.

Response: No response required.

Comment 10: The Applicant should provide a queue analysis for the proposed driveway gate system to ensure that entering traffic will not queue onto Corporate Drive.

Response: **The proposed gate system location was determined based on a queueing analysis at the proposed location that was previously conducted during the master planning effort. Based on the analysis, a third reversible lane was added to accommodate queues. It is important to note that this analysis was based on a higher number of proposed employees than what is currently proposed. Therefore, the available storage along Goose Bay Drive between Corporate Drive and the proposed gate system is in excess of what is required for the proposed future trips.**

Comment 11: The TIA documents substantial delays for the exiting employee traffic during the evening peak hour within the single departure lane. The Applicant should consider separate left- and right-turn lanes at the driveway intersection with Corporate Drive.

Response: **The vehicle delays estimated on Goose Bay Drive during the weekday afternoon peak hour are largely due to the high volume of left-turning vehicles onto Corporate Drive. A sensitivity analysis indicates long delays will continue even if dedicated left- and right-turn lanes are added. In addition, any widening of Goose Bay Drive is not possible due to the previously capped soils on the northeast side of the roadway as well as the proximity of the recently constructed parking lot adjacent to the existing parking garage.**

Comment 12: TEC recommends that the Applicant coordinate with PDA to perform supplemental all-way stop control (AWSC) and traffic signal warrant analysis for the following intersections:

- a. Corporate Drive at Grafton Road*
- b. International Drive at New Hampshire Avenue / Durham Street*
- c. International Drive / Corporate Drive (for the 2025 Opening Build condition)*

Response: **Please see enclosed PDA letter.**

Comment 13: The TIA states that the intersection of International Drive / Corporate Drive is programmed for NHDOT funding for intersection reconstruction and signalization within the State's 10-year plan. Depending on the actual timing of the project, the Applicant should coordinate with PDA and consider measures for the temporary signalization of this intersection. This should be closely coordinated with a potential condition of approval related to the Applicant's responsibility to provide updated traffic data following the occupancy of Building 1 (and other subsequent buildings) and assess the actual delays and queuing for this key gateway intersection.

Response: **Please see enclosed PDA letter.**

Comment 14: The intersection of Greenland Road (Route 33) / Grafton Road, a State-controlled intersection, is currently overcapacity for different traffic movements during the peak hours. Although TEC does not believe that direct physical mitigation is warranted for the Applicant at this intersection,

the City and PDA should work with NHDOT to identify long-range improvements to add capacity to this intersection.

Response: **No response required. Please see enclosed PDA letter.**

Comment 15: Based on the results of the capacity and warrant analyses listed above, the Applicant should coordinate with PDA and other applicants within Pease Tradeport to develop a fair-share cost assessment for mitigation measures based on the number of new trips.

Response: **Please see enclosed PDA letter.**

Comment 16: Corporate Drive currently accommodates an exclusive left-turn lane for the Residence Inn and Redhook Way that traverses the opening for Goose Bay Drive (site driveway). The Applicant should review the potential for lane use changes within Corporate Drive that may consider an exclusive left-turn lane for Lonza's entering traffic. Any planned improvements should consider an enhanced pedestrian crossing between the Lonza site and the existing COAST bus stop on the opposite side of Corporate Drive in the vicinity of Redhook Way, including a new bus shelter to provide additional accommodations for existing and future transit riders.

Response: **Based on the trip distribution, it is anticipated the majority of site generated traffic will enter Goose Bay Drive from the west, therefore a westbound exclusive left-turn lane would not be warranted. In addition, the exclusive eastbound left-turn lane is necessary to provide access to the Residence Inn and Red Hook Way. The Applicant will be adding a new sidewalk connection between the Lonza site and the existing bus stop location on Corporate Drive to improve access for transit users.**

Comment 17: The TIA does not include any parking occupancy data for the existing Lonza site and does not provide an analysis of the proposed parking supply in relation to the projected number of employees in Phase 2 and the Site Master Plan. The supply may indeed be appropriate based on the number of employees on each shift but should be confirmed with a reasonable level of parking analysis in relation to the zoning requirements.

Response: **The parking requirement for this site is 2 spaces per 3 employees during the largest shift based on the current PDA Land Use Controls. Based on this requirement and the existing and proposed employee counts, 1,326 spaces are required. 1,501 spaces will be provided as part of the project (801 existing parking spaces plus 700 proposed garage parking spaces) as indicated on Sheet C-104. The parking requirement for Phase 2 of the project is 880 spaces where 957 spaces will be provided (801 existing parking spaces plus 150 surface parking spaces) as indicated on Sheet C-164.**

Comment 18: The Applicant should coordinate with the City, PDA, and COAST to review the current ridership along Bus Route 42 related to the Lonza facility and identify opportunities for coordinated service schedules and potential bus route changes for Route 13 (Dover) and Route 14 (Rochester) to further reduce single-occupancy vehicle trips for several PDA employers.

Response: **The Applicant does not believe that the burden of coordinating with COAST to reconfigure their service routes or schedule should be placed on a single end user or tied to a specific planning approval.**

This would need to be a larger discussion involving the PDA and multiple other businesses at the Tradeport. However, the applicant is willing to be a participant in that discussion with COAST.

Site Plan Comments

Comment 19: The site plan currently depicts enclosed truck and trailer staging for deliveries. The Applicant should confirm that they do not require any exterior trailer parking as none is currently shown. TEC recommends that the Board considers a condition that prohibits exterior trailer storage in areas that are not specifically identified on the plan.

Response: The Applicant does not require any exterior trailer parking. The loading docks will be used for active loading and unloading.

Comment 20: One trash compactor is located near the southerly corner of Building #1. The Applicant should confirm that they do not need additional exterior dumpsters for each building and confirm the truck circulation for any newly proposed locations.

Response: A second trash compactor has been added to the site adjacent to the Utility Building. Truck turning was studied to confirm access.

Comment 21: The plans should include additional details for the signs and striping for the gated access points to the site. This may include additional roadway striping at the end of the Goose Bay Drive cul-de-sac to delineate the transition to the proposed private way.

Response: The site plans include proposed striping and signage for traffic circulation, including directional signage for truck traffic and not a through street signage prior to the gated/fenced entrances to the site. A turnaround area has been located prior to the gates on the northern entrance and the cul-de-sac will allow for vehicles to turn around prior to the security gate at the southern entrance. The applicant is open to reviewing and considering any other specific recommendations.

Comment 22: TEC recommends the construction of additional sections of on-site sidewalks within the Phase 2 area to provide a sidewalk circuit for employees that desire to walk during breaks without unnecessarily traversing the busier on-site driveway aisles. This may include a new sidewalk along the northwesterly edge of Goose Bay Drive to connect to the recently constructed sidewalk along Corporate Drive and another segment south of the proposed 3-story utility building (shown in red below).

Response: The area to the west of the utility building is designed to be a multipurpose area to allow for pedestrian circulation and emergency fire access between the two buildings. A sidewalk connection along Goose Bay Drive to Corporate Drive was not included in the design for a couple of reasons. As that is the main entrance for all truck traffic to the site the applicant does not want to encourage their employees to be walking around an active delivery area. Additionally, the gated access at the cul-de-sac is a sliding chain link gate that does not have pedestrian access. For the current phase of work there will be full pedestrian access on the northern half of the site, and future phases of work will provide

access to Corporate Drive away from the truck delivery access route.

Comment 23: Pedestrian warning signs should be provided at the major on-site crosswalks that would cross the major routes to and from the existing and proposed parking structures. The crosswalk widths should be noted on the plans and in the construction details.

Response: Pedestrian warning signs will be added to the plans as recommended. Crosswalk Striping detail will be revised to note an 8' width.

Comment 24: The 150-stall surface parking for Phase 2 should include a defined sidewalk connection from the outlying parking aisle to the currently proposed sidewalk. This could be considered within a wider landscape island in the middle of the parking lot as shown below.

Response: A central sidewalk will be added through the 150 space parking area connecting to the currently proposed sidewalk.

Comment 25: One proposed bike rack is depicted near the southerly corner of Building #2 in the Site Master Plan. The Applicant should consider additional bike racks at the major entrances to the proposed buildings, such as Building #1 in Phase 2, and covered bicycle parking on the ground floor of the proposed 700-stall parking structure in the site master plan.

Response: There is a proposed bike rack near the entrance of Building 1 and near the southern corner of building 2. Adding space for bike storage with the future proposed parking garage will be considered once the design of that structure begins.


Please contact us if you have any questions or comments on the responses above.

Sincerely,

TIGHE & BOND, INC.



Greg Lucas, PE (MA, NH), PTOE, RSP1
Senior Project Manager

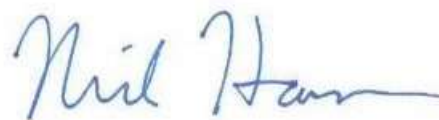

Neil A. Hansen, PE
Project Manager

Enclosures: PDA TEC Peer Review Response Letter, dated October 24, 2023

Copy: Lonza
Pease Development Authority

J:\L\L0700 Lonza Biologics Expansion was 1576F\026_Project Albacore\Report_Evaluations\Traffic Study\Peer Review 1 (October 2023)\2023-10-24 Traffic Peer Review Response Letter 1.docx



October 24, 2023

Peter Stith, AICP
Planning Manager
Department of Planning & Sustainability
City of Portsmouth, NH
1 Junkins Avenue
Portsmouth, NH 03801

Re: Lonza Phase 2 Planning Board Application
TEC Peer Review of Traffic Impact Assessment

Dear Mr. Stith:

The Engineering Corp (TEC) peer review of the proposed Lonza Biologics Phase 2 Expansion Traffic Impact Assessment (TIA) dated October 3, 2023 has recommended the applicant coordinate with Pease Development Authority (PDA) on a number of transportation related topics. I am writing to provide information that will hopefully provide some clarity to assist the Planning Board with making the most informed recommendation to the PDA Board regarding this application. The specific comments are addressed as follows:

TEC Comment # 12: TEC recommends that the applicant coordinate with PDA to perform supplemental all-way stop control (AWSC) and traffic signal warrant analysis for the following intersections:

- a. *Corporate Drive at Grafton Road*
- b. *International Drive at New Hampshire Avenue / Durham Street*
- c. *International Drive / Corporate Drive (for the 2025 Opening Build condition)*

PDA Response: Vanasse Hagen Brustlin, Inc. (VHB), PDA's on call transportation engineer, performed vehicle counts in 2016, as a supplement to the Pease Transportation Master Plan Update of 2010, when it was determined that the intersections of Corporate Dr/Grafton Rd and International Dr/New Hampshire Ave/Durham St met the warrants for a signal. The International Dr/Corporate Dr/Manchester Sq intersection did not meet the signal warrant at that time. Given traffic has yet to return to pre-pandemic levels, the PDA remains confident in that analysis, but notes that the intersection in question is currently under an AWSC.

TEC Comment # 13: The TIA states that the intersection of International Drive / Corporate Drive is programmed for NHDOT funding for intersection reconstruction and signalization within the State's 10-year plan. Depending on the actual timing of the project, the applicant should coordinate with PDA and consider measures for the temporary signalization of this intersection. This should be closely coordinated with a potential condition of approval related to the Applicants responsibility to provide updated traffic data following the occupancy of Building 1 (and other subsequent buildings) and assess the actual delays and queuing for this key gateway intersection.

PDA Response: As stated in the response to comment #12, the International Dr/Corporate Dr/Manchester Sq intersection did not meet the signal warrant in the analysis performed in 2016. Since that time, the pandemic has reduced traffic on the Tradeport due to remote work policies instituted by employers located on the Tradeport. In addition, the 2023 peak hour volumes at this intersection remain below the 2016 volumes. As such, a signal is unnecessary until it is warranted based on the data.

TEC comment # 14: The intersection of Greenland Road (Route 33) / Grafton Road, a State-controlled intersection, is currently overcapacity for different traffic movements during the peak hours. Although TEC does not believe that direct physical mitigation is warranted for the Applicant at this intersection, the City and PDA should work with NHDOT to identify long-range Improvements to add capacity to this intersection.

PDA response: As stated, this intersection is a state-controlled intersection under the sole jurisdiction of the NHDOT. As such, PDA has no jurisdiction with respect to improvements at this intersection. To the extent PDA is able share Tradeport data or information helpful to the City of Portsmouth or NHDOT regarding this intersection, it will do so. Furthermore, it is important to note that traffic on Route 33 is related to many factors. According to the TIA, of the 1439 vehicles that were counted passing through this intersection, heading north or east bound, during the weekday morning peak hour, only 337, or less than 25%, turned into Pease. 1,102 vehicles continued through the intersection towards I-95 North and the City of Portsmouth.

TEC Comment # 15: Based on the results of the capacity and warrant analyses listed above, the applicant should coordinate with PDA and other applicants within Pease Tradeport to develop a fair-share cost assessment for mitigation measures based on the number of new trips.

PDA response: The PDA Board of Directors, as the governing body of the PDA under state law, has considered this policy recommendation in the past, but has decided to fund intersection improvements on the Tradeport itself. Based on traffic studies it has undertaken, PDA has currently secured three grants though NHDOT for intersection improvements at New Hampshire Ave/Pease Blvd, Corporate Dr/International Dr/Manchester Sq, and Grafton Rd / Pease Golf Course. Furthermore, PDA continues to plan for improvements at four additional intersections VHB has identified as priorities in PDA's Capital Improvement Plan.

Sincerely,



Michael R. Mates, P.E.
Director of Engineering

cc: Peter Britz, City of Portsmouth (VIA Email)
Neil Hanson, Tighe & Bond, Inc. (VIA Email)
Luke St. Pierre, Lonza, (VIA Email)

Peter M. Stith, AICP
Planning Manager
City of Portsmouth
Planning & Sustainability Department
1 Junkins Avenue
Portsmouth, NH 03801

November 8, 2023

Ref. T1399

Re: Proposed Lonza Biologics Expansion
Traffic Engineering Peer Review #2

Dear Mr. Stith:

On behalf of the City of Portsmouth, TEC, Inc. (TEC) reviewed follow-up documentation as part of our firm's traffic engineering peer review for the proposed expansion of the Lonza Biologics, Inc. ("the Applicant") manufacturing campus along Corporate Drive in Portsmouth ("the Project"). TEC reviewed the following document as part of our follow-up review:

- *Lonza Biologics Proposed Expansion – Traffic Peer Review Response 1*; prepared by Tighe & Bond and dated October 24, 2023.

TEC completed a review of the Applicant's documents on behalf of the City of Portsmouth and provides the following transportation-related considerations as part of our review.

Traffic Impact Assessment

The Applicant's team provided helpful responses to our prior written comments related to the preparation of future traffic volumes in Pease Tradeport and its access points, both for background traffic volumes and the methodology for the estimate of new trips to be generated by the proposed expansion. They also provided a letter from the Pease International Development Authority (PDA) regarding their opinion of the current and future traffic operating conditions within their jurisdiction with references to their 2010 Master Plan Update.

TEC continues to encourage the Applicant and PDA, as the entity with jurisdiction over the roadway infrastructure, to assess the post-COVID and/or post-occupancy traffic data collection, traffic signal warrant analyses, and capacity analyses for the following intersections following substantial occupancy (>75%) of the Phase 2 building:

- International Drive / Corporate Drive / Manchester Square
- International Drive / New Hampshire Avenue / Durham Street
- Corporate Drive / Grafton Road

We believe this will provide more accurate information about the PDA's future transportation needs and the timing and phasing of their planned infrastructure improvements as part of any updated PDA Master Plan documents.

Site Plans

The Applicant and their team responded to TEC's comments to indicate their on-site operational needs and preferences related to traffic, pedestrian, loading, and parking accommodations. TEC recommends that the Planning Department staff review plan updates to ensure that TEC's comments 20 through 24 have been reasonably incorporated into the Applicant's next site plan revision. See Tighe & Bond's letter for the Applicant's detailed responses.

Please do not hesitate to contact me if you have any questions concerning our peer review at 603-601-8154. Thank you for your consideration.

Sincerely,
TEC, Inc.
"The **Engineering Corporation**"

A handwritten signature in blue ink, appearing to read "Kevin R. Dandrade".

Kevin R. Dandrade, P.E., PTOE
Principal