
GENERAL LEGEND BARBEST MIRE BARBEST MIRE FENCE STOCKAPE FENCE STOCKAPE FENCE SOL BOUNDARY AGUIFER PROTECTION LINE FLOOD PLAIN LINE ZONELINE EASEMENT MAURC CONTOUR MINOR CONTOUR EDGE OF PAVEMENT VERTICAL GRANITE CURB SLOPE GRANITE CURB EDGE FORCE SENCE FORCE MAN MATER LINE WATER LINE × 100.00 99.50 ¥ 100.00 CURB SPOT GRADE 4K SEPTIC AREA WETLAND IMPACT XXXXX VEGETATED FILTER STRIF 050505 OPEN WATER FRESHWATER WETLANDS TIDAL WETLANDS CONCRETE GRAVEL

SNOW STORAGE

DETARBLIC WALL

RESIDENTIAL CONDOMINIUMS TAX MAP 297, LOT 11 3400 LAFAYETTE ROAD, PORTSMOUTH, NH

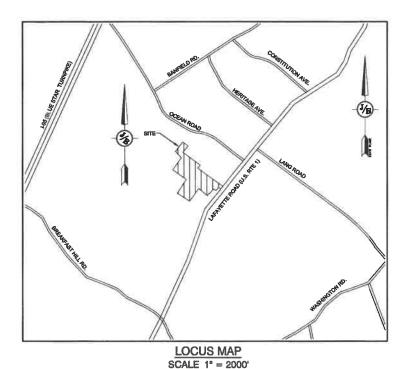



CIVIL ENGINEER / SURVEYOR JONES & BEACH ENGINEERS, INC.

PO BOX 219
STRATHAM, NH 03885
(603) 772-4746
CONTACT: JOSEPH CORONATI
EMAIL: JCORONATI@JONESANDBEACH.COM

WETLAND CONSULTANT
GZA ENVIRONMENTAL
5 COMMERCE PARK NORTH
SUITE 201
BEDFORD, NH 03110
603-623-3600
CONTACT: JAMES LONG

APPLICANT

GREEN & COMPANY
11 LAFAYETTE ROAD
PO BOX 1297
NORTH HAMPTON, NH 03862
603-964-7572
CONTACT: MICHAEL GREEN
MPG114@GMAIL.COM

LANDSCAPE ARCHITECT
TF MORAN, INC.
48 CONSTITUTION DRIVE
BEDFORD, NH 03110
603-472-4488
CONTACT: MIKE KRZEMINSKI
MKRZEMINSKI@TFMORAN.COM

ARCHITECT: STONEARCH DEVELOPMENT (603) 817-5758 CONTACT: MICHAEL MACNEIL

COVER SHEET BOUNDARY PLAN A1 **OVERVIEW EXISTING CONDITIONS PLAN EXOVR** C1 **EXISTING CONDTIONS PLAN OVERVIEW SITE PLAN** OVR SITE PLAN C2 **GRADING AND DRAINAGE PLAN** C3 C4-C5 UTILITY PLAN LIGHTING PLAN P1-P3 ROAD PLAN AND PROFILE P4-P6 SEWER PROFILES D1-D6 **DETAIL SHEETS EROSION AND SEDIMENT CONTROL DETAILS** E1 **T**1 TRUCK TURNING PLAN LANDSCAPE PLANS

SHEET INDEX

TELEPHONE

E-MAIL: JBE@JONESANDBEACH.COM

(603) 555-5334

ELECTRIC

EVERSOURCE ENERGY

ROCHESTER, NH 03867

74 OLD DOVER ROAD

FAIRPOINT COMMUNICATIONS 1575 GREENLAND ROAD GREENLAND, NH 03840 (603) 427-5525 CONTACT: JOE CONSIDINE

CONTACT: NICHOLAI KOSKO

CABLE TV
COMCAST COMMUNICATION CORPORATION
334-B CALEF HIGHWAY
EPPING, NH 03042-2325
(603) 679-5695

PROJECT PARCEL CITY OF PORTSMOUTH TAX MAP 297, LOT 11

1,931,721 SQ. FT. ±

APPROVED - PORTSMOUTH, NH PLANNING BOARD

DATE:

Design: JAC Draft: LAZ Date: 9/3/21
Checked: JAC Scale: AS NOTED Project No.: 20737
Drawing Name: 20737-PLAN,dwg
THIS PLAN SHALL NOT BE MODIFIED WITHOUT WRITTEN
PERMISSION FROM JONES & BEACH ENGINEERS, INC. (JBE),
ANY ALTERATIONS, AUTHORIZED OR OTHERWISE, SHALL BE

AT THE USER'S SOLE RISK AND WITHOUT LIABILITY TO JBE.



REV.	DATE	REVISION	BY
2	1/6/21	MINOR REVISIONS	DJM
3	3/3/21	ADDED SURVEY INFO	LAZ
4	3/18/21	ADDED DETAIL	LAZ
-5	5/5/21	REVISIONS	LAZ
6	6/22/21	REVISIONS PER TOWN REVIEW	LAZ




Plan Name:	COVER SHEET
Project:	3400 LAFAYETTE ROAD PORTSMOUTH, NH
Owner of Record: 225 B	RICCI CONSTRUCTION CO., INC. ANFIELD ROAD, PORTSMOUTH, NH 03801 BK 1930 PG 0229


DRAWING No.

CS
SHEET 1 OF 25
JBE PROJECT NO. 20737

PROJECT NAME AND LOCATION

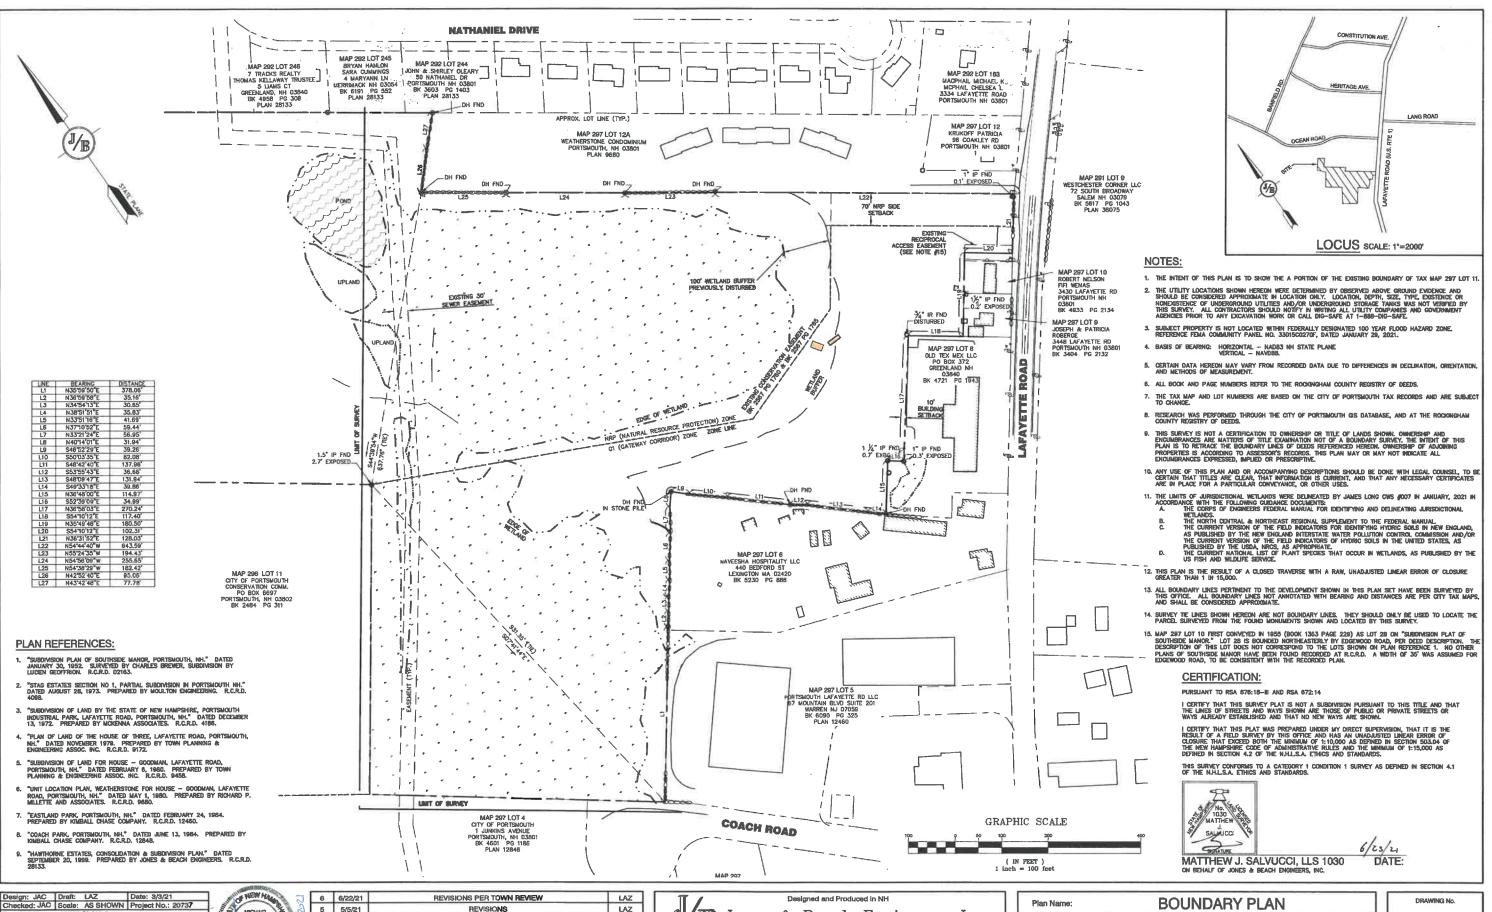

Drawing Name: 20737-PLAN.dwg HIS PLAN SHALL NOT BE MODIFIED WITHOUT WRITTEN PERMISSION FROM JONES & BEACH ENGINEERS, INC. (JBE). ANY ALTERATIONS, AUTHORIZED OR OTHERWISE, SHALL BE AT THE USER'S SOLE RISK AND WITHOUT LIABILITY TO JBE.

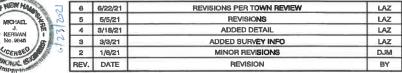


Jones & Beach Engineers, Inc.

603-772-4746

85 Portsmouth Ave. Civil Engineering Services
PO Box 219 E-MAIL: JBE@JONESANDBEACH.COM Stratham, NH 03885

Plan Name:	BOUNDARY PLAN	7 [
Project:	3400 LAFAYETTE ROAD PORTSMOUTH, NH	11
Owner of Record: 225 BANFIELD	RICCI CONSTRUCTION CO., INC. ROAD, PORTSMOUTH, NH 03801 BK 1930 PG 0229	11

SHEET 2 OF 2 JBE PROJECT NO. 20737

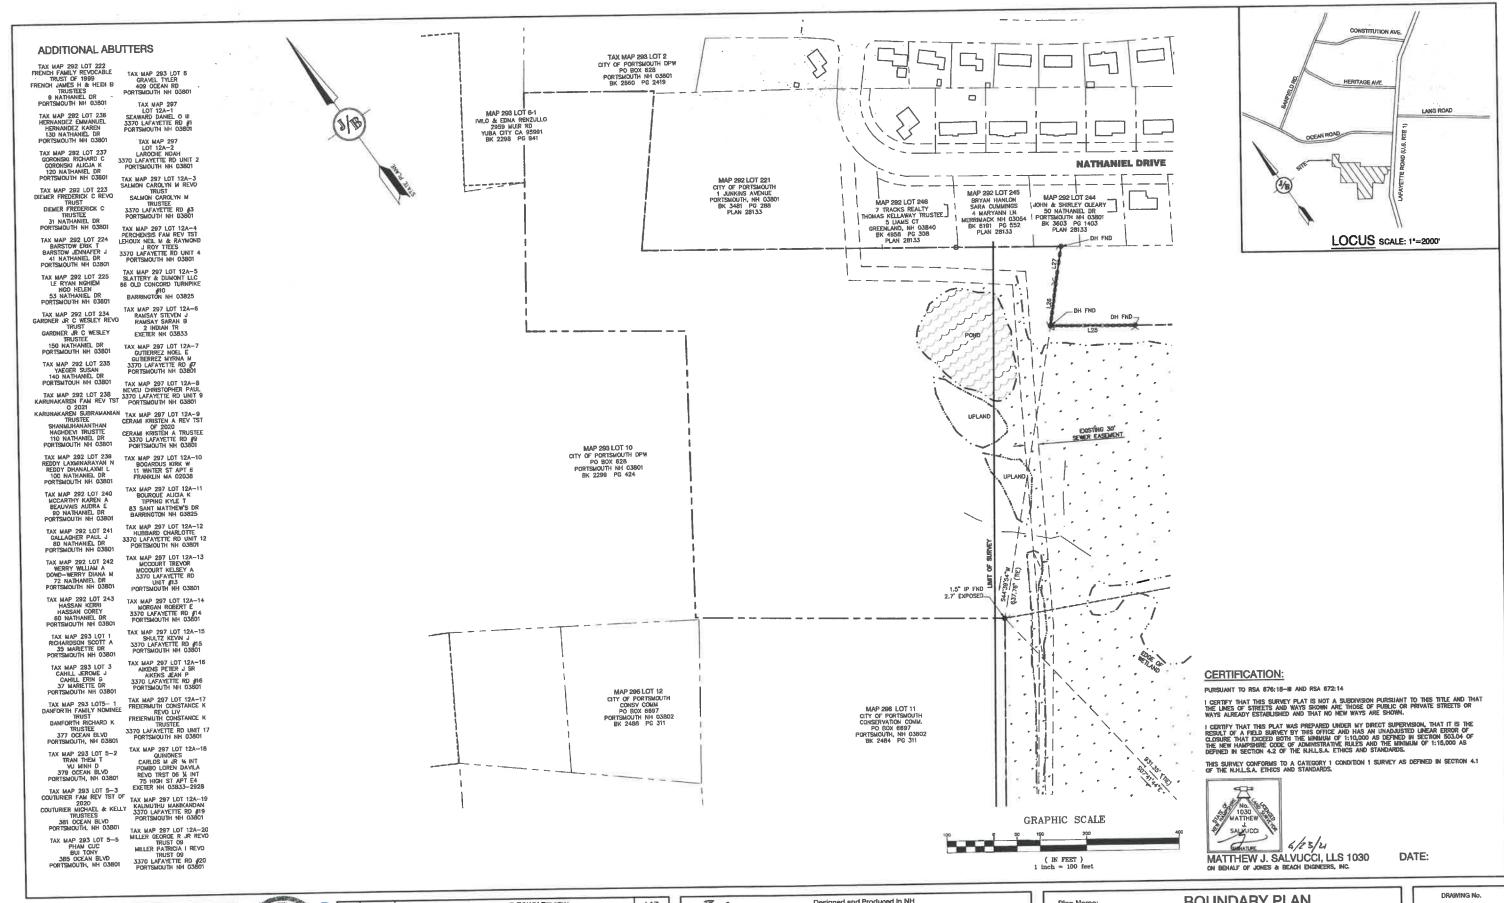

PO Box 219 Strethern, NH 03885

Design: JAC Draft: LAZ Date: 3/3/21
Checked: JAC Scale: AS SHOWN Project No.: 20737
Drawing Name: 20737-PLAN.dwg
THIS PLAN SHALL NOT BE MODIFIED WITHOUT WRITTEN
PERMISSION FROM JONES & BEACH ENGINEERS, INC. (JBE).
ANY ALTERATIONS, ALTHORIZED OR OTHERWASE, SHALL BE
AT THE USER'S SOLE RISK AND WITHOUT LIABILITY TO JBE.



в	6/22/21	REVISIONS PER TOWN REVIEW	LAZ
5	5/5/21	REVISIONS	LAZ
4	3/18/21	ADDED DETAIL	LAZ
3	3/3/21	ADDED SURVEY INFO	LAZ
2	1/6/21	MINOR REVISIONS	DJM
REV.	DATE	REVISION	BY

Designed and Produced In NH

Jones & Beach Engineers, Inc.


85 Portsmouth Ave. Civil Engineering Services


603-772-4746
FAX: 603-772-0227

E-MAIL: JBE@JONESANDBEACH.COM

Plan Name:	BOUNDARY PLAN	
Project:	3400 LAFAYETTE ROAD PORTSMOUTH, NH	
Owner of Record: 225 E	RICCI CONSTRUCTION CO., INC. BANFIELD ROAD, PORTSMOUTH, NH 03801 BK 1930 PG 0229	

A2
SHEET 3 OF 25
JBE PROJECT NO. 20737

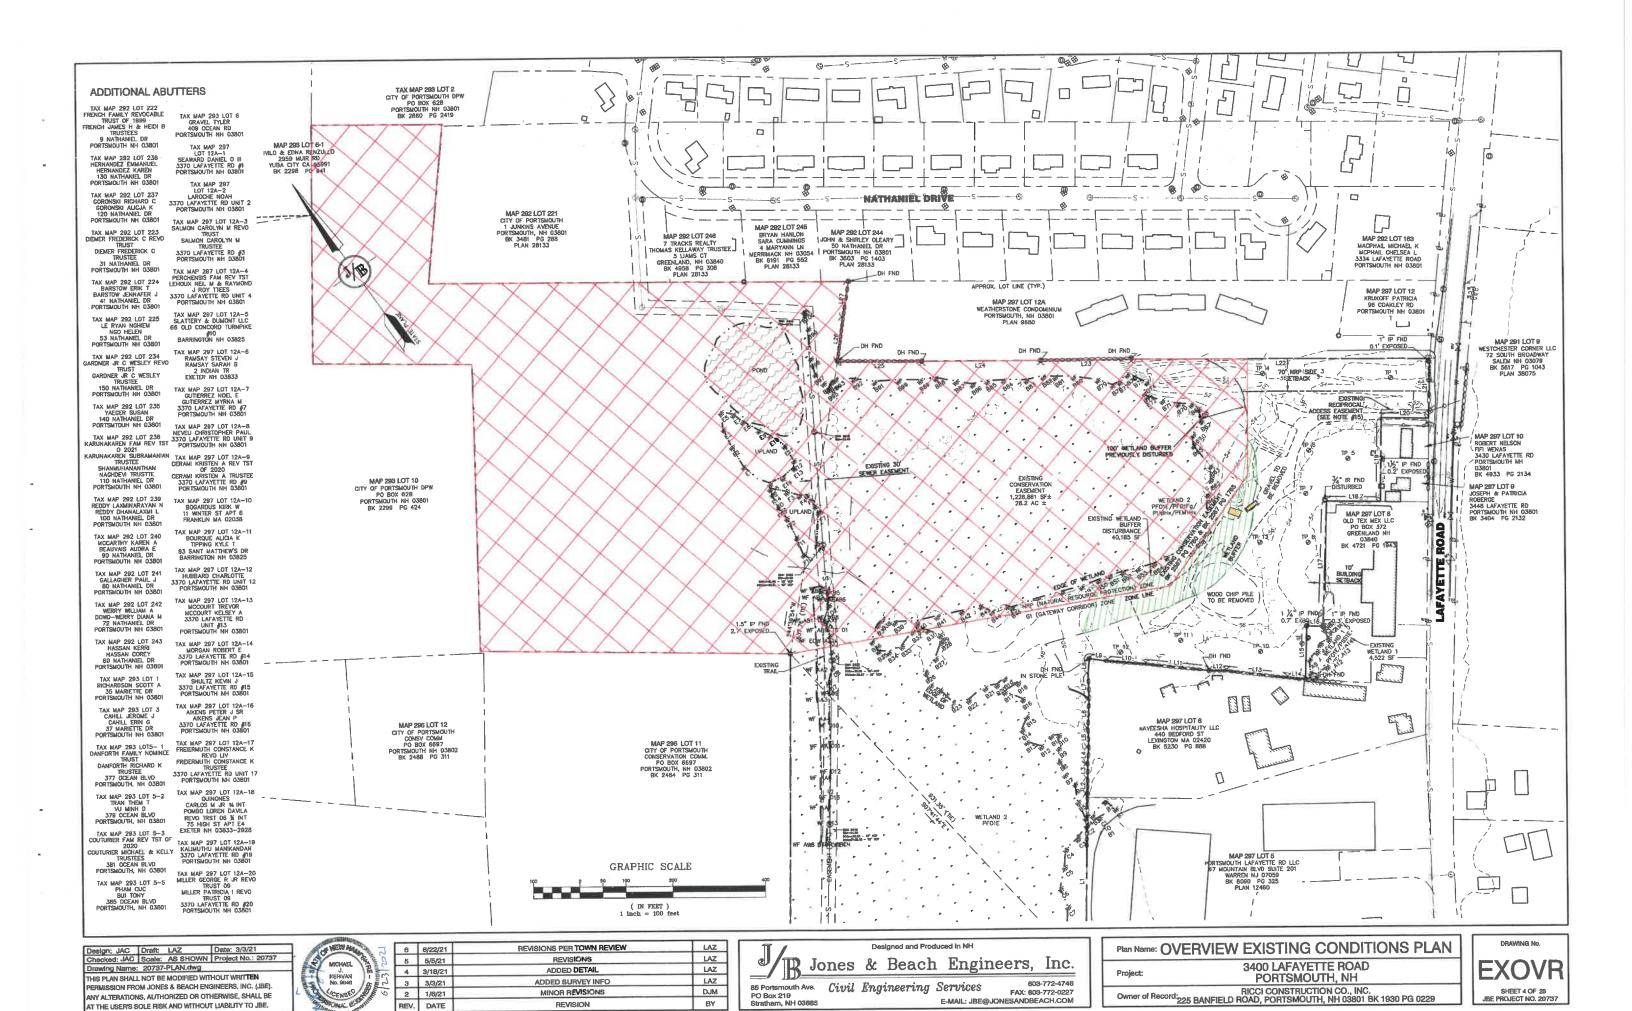

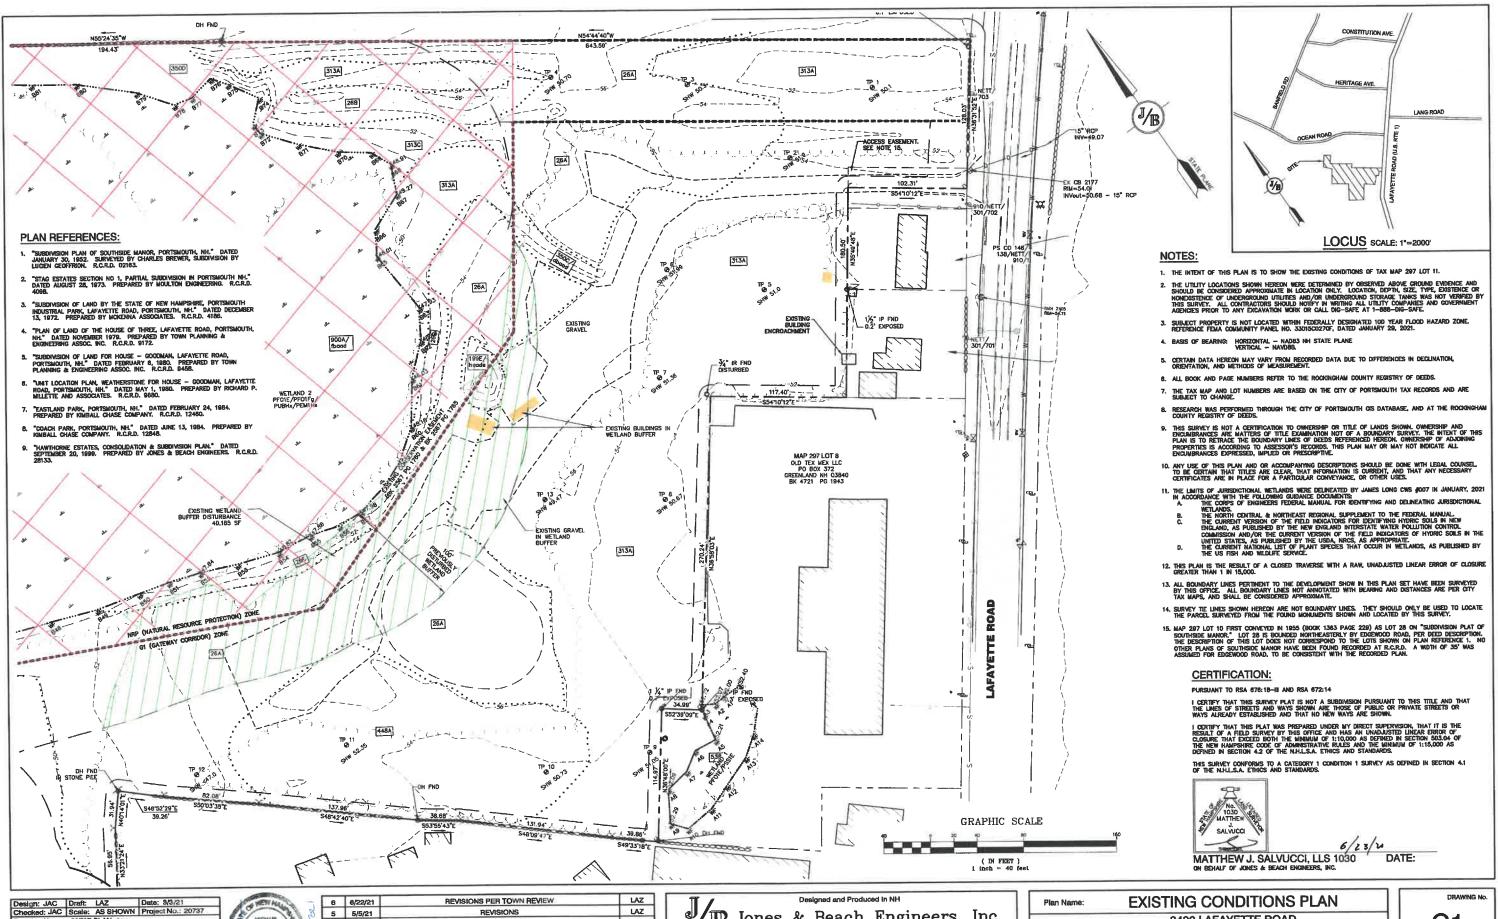

Drawing Name: 20737-PLAN.dwg THIS PLAN SHALL NOT BE MODIFIED WITHOUT WRITTEN RMISSION FROM JONES & BEACH ENGINEERS, INC. (JBE). ANY ALTERATIONS, AUTHORIZED OR OTHERWISE, SHALL BE AT THE USER'S SOLE RISK AND WITHOUT LIABILITY TO JBE.


5 5/5/21 REVISIONS ADDED DETAIL LAZ 4 3/18/21 LAZ 3 3/3/21 ADDED SURVEY INFO DJM 2 1/6/21 MINOR REVISIONS BY REVISION


Jones & Beach Engineers, Inc. 85 Portsmouth Ave. Civil Engineering Services
PO Box 219
Stratham, NH 03885
E-MAIL: JBE@ FAX: 603-772-0227


E-MAIL: JBE@JONESANDBEACH.COM

3400 LAFAYETTE ROAD Project: PORTSMOUTH, NH RICCI CONSTRUCTION CO., INC.
Owner of Record 225 BANFIELD ROAD, PORTSMOUTH, NH 03801 BK 1930 PG 0229

SHEET 5 OF 25 JBE PROJECT NO. 20737

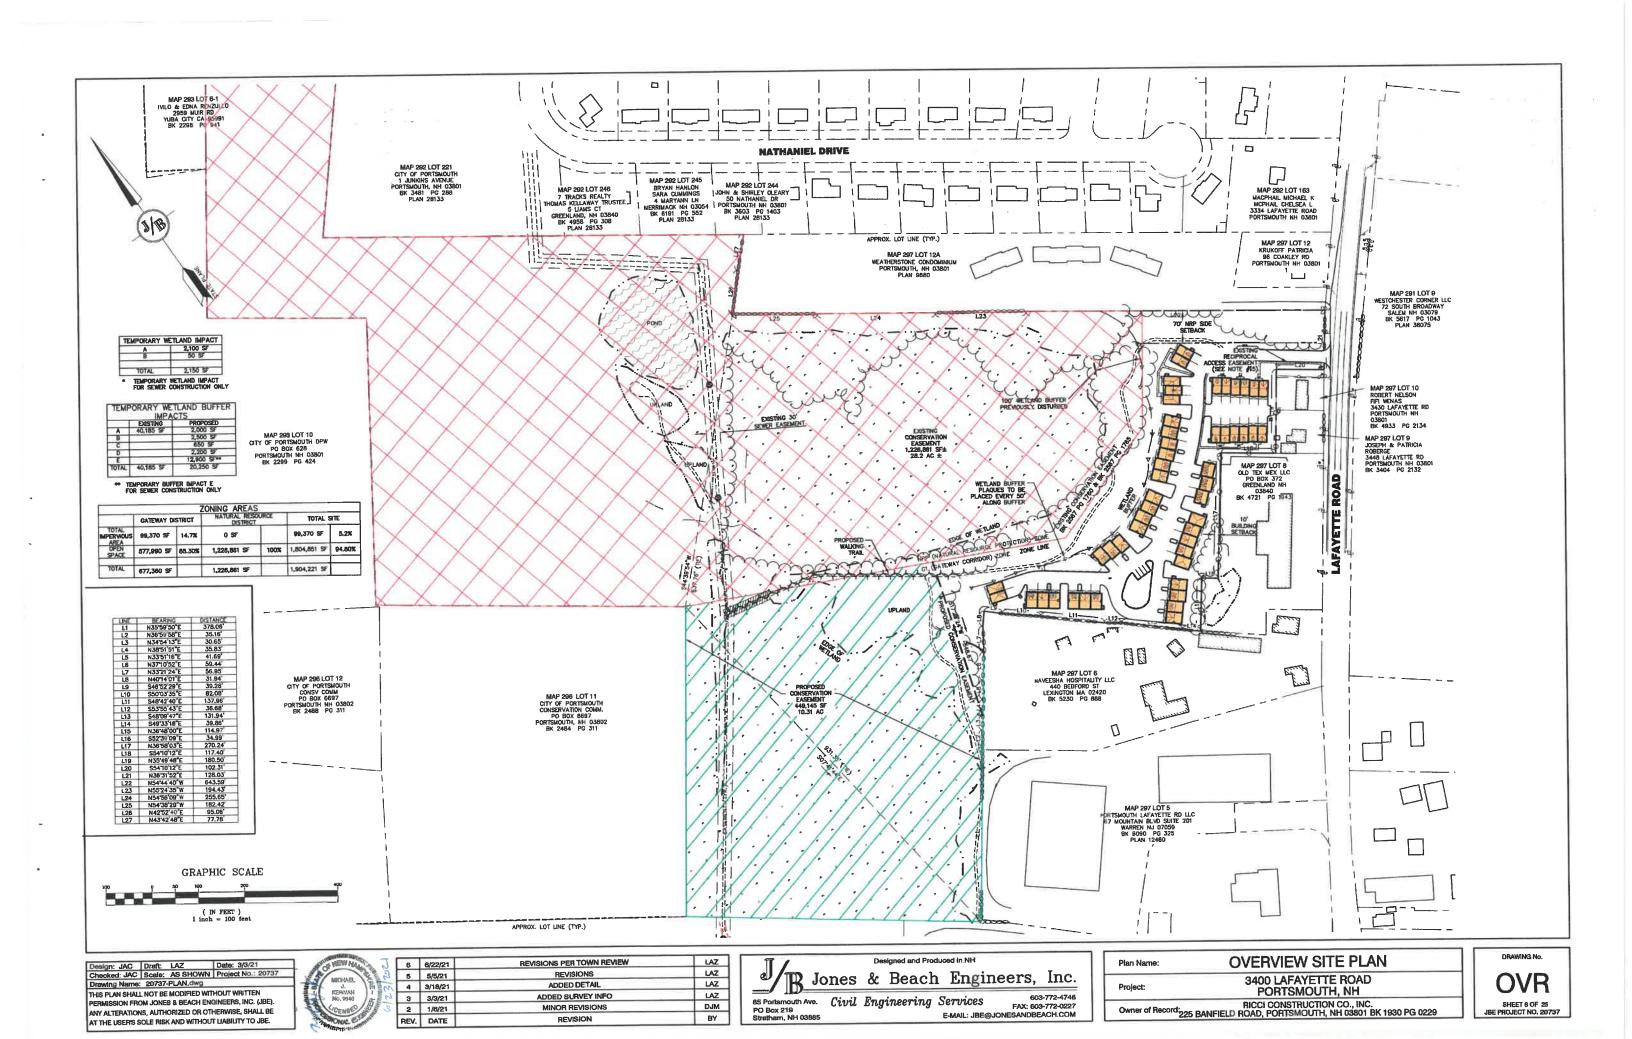

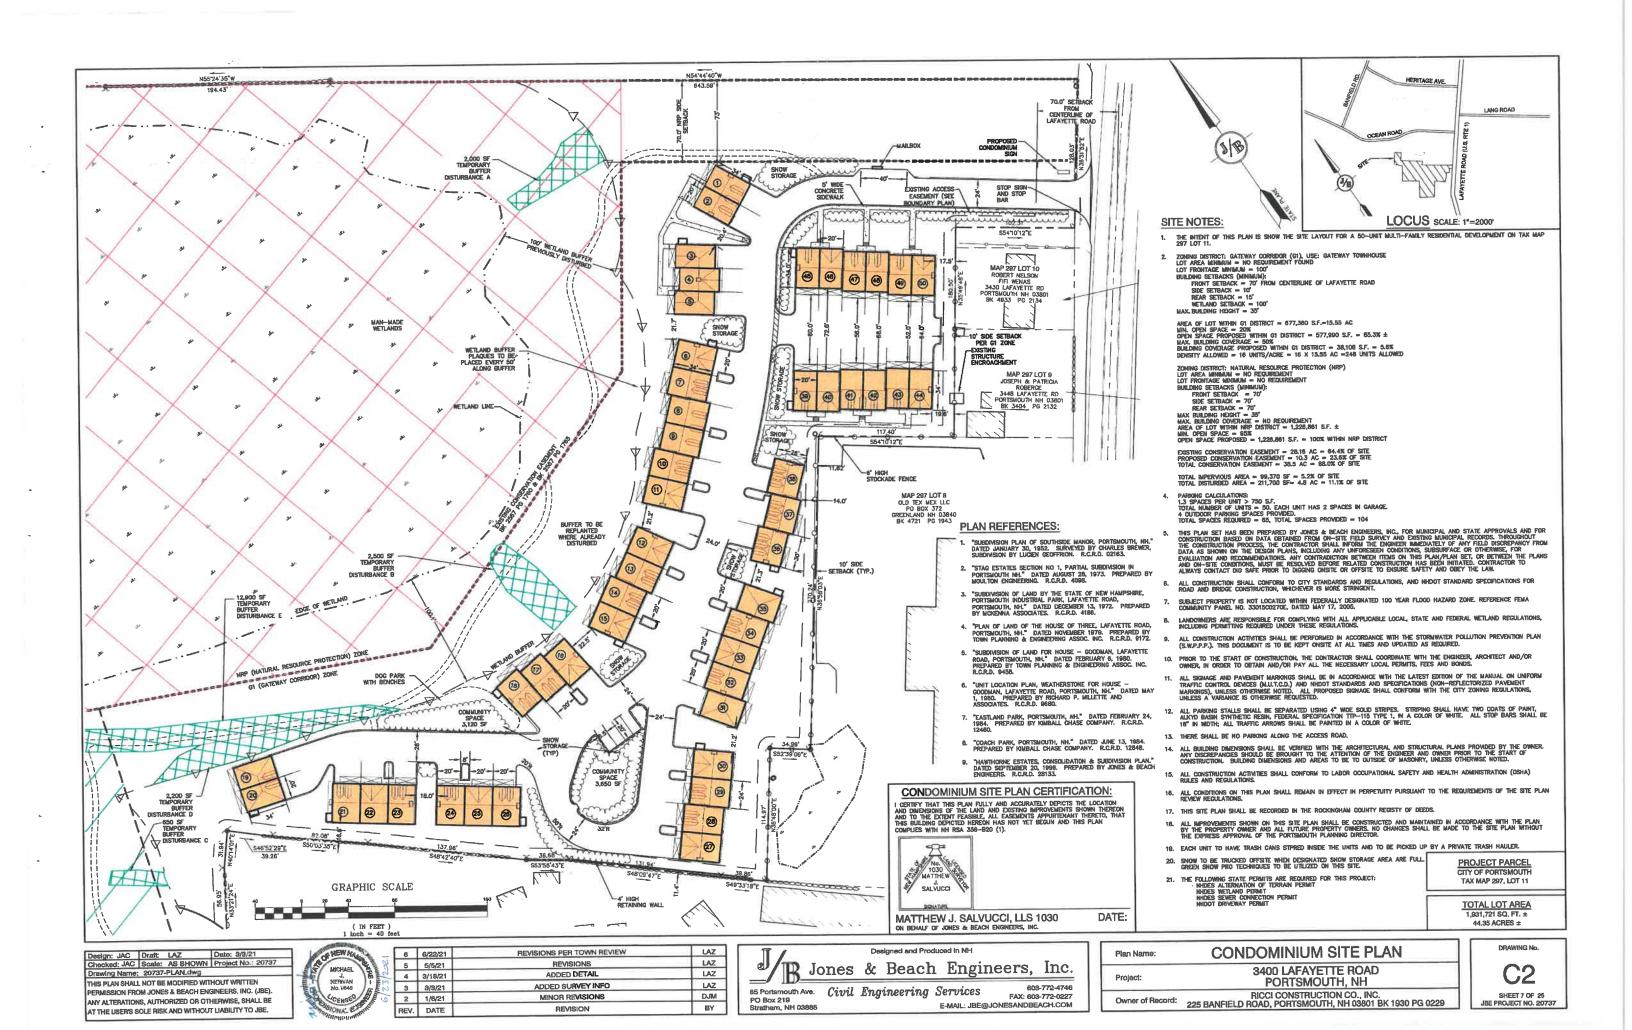

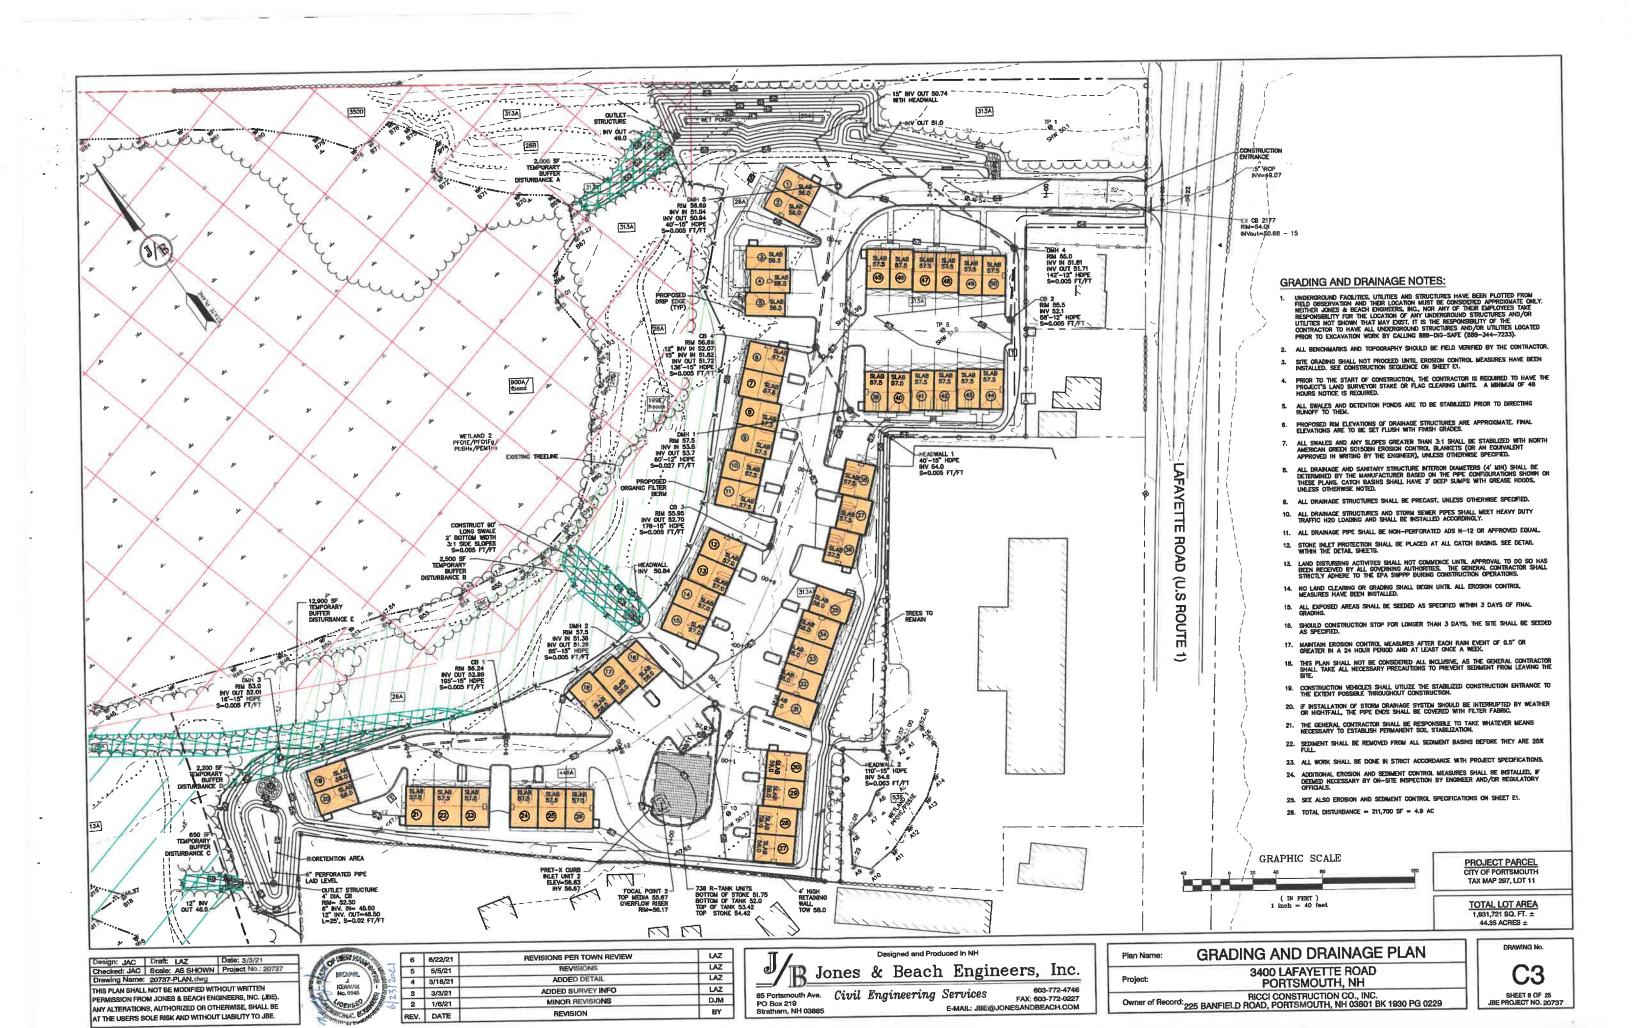



Design: JAC Draft: LAZ Date: 9/3/21
Checked: JAC Scale: AS SHOWN Project No.: 20737
Drawing Name: 20737-PLAN.dwg
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MECHAEL STATE OF STAT

REVISIONS PER TOWN REVIEW 6 6/22/21 REVISIONS LAZ 5 5/5/21 ADDED DETAIL LAZ 4 3/18/21 LAZ ADDED SURVEY INFO 3 3/3/21 DJM MINOR REVISIONS 2 1/6/21 BY REV. DATE

Jones & Beach Engineers, Inc.

85 Potsmouth Ave. Civil Engineering Services 603-772-4746
PO Box 219
Strethem, NH 03885
603-772-0227
E-MAIL: JBE@JONESANDBEACH.COM


Plan Name: UTILITY PLAN

Project: 3400 LAFAYETTE ROAD
PORTSMOUTH, NH


RICCI CONSTRUCTION CO., INC.
Owner of Record; 225 BANFIELD ROAD, PORTSMOUTH, NH 03801 BK 1930 PG 0229

C4

SHEET 8 OF 25 JBE PROJECT NO. 20737

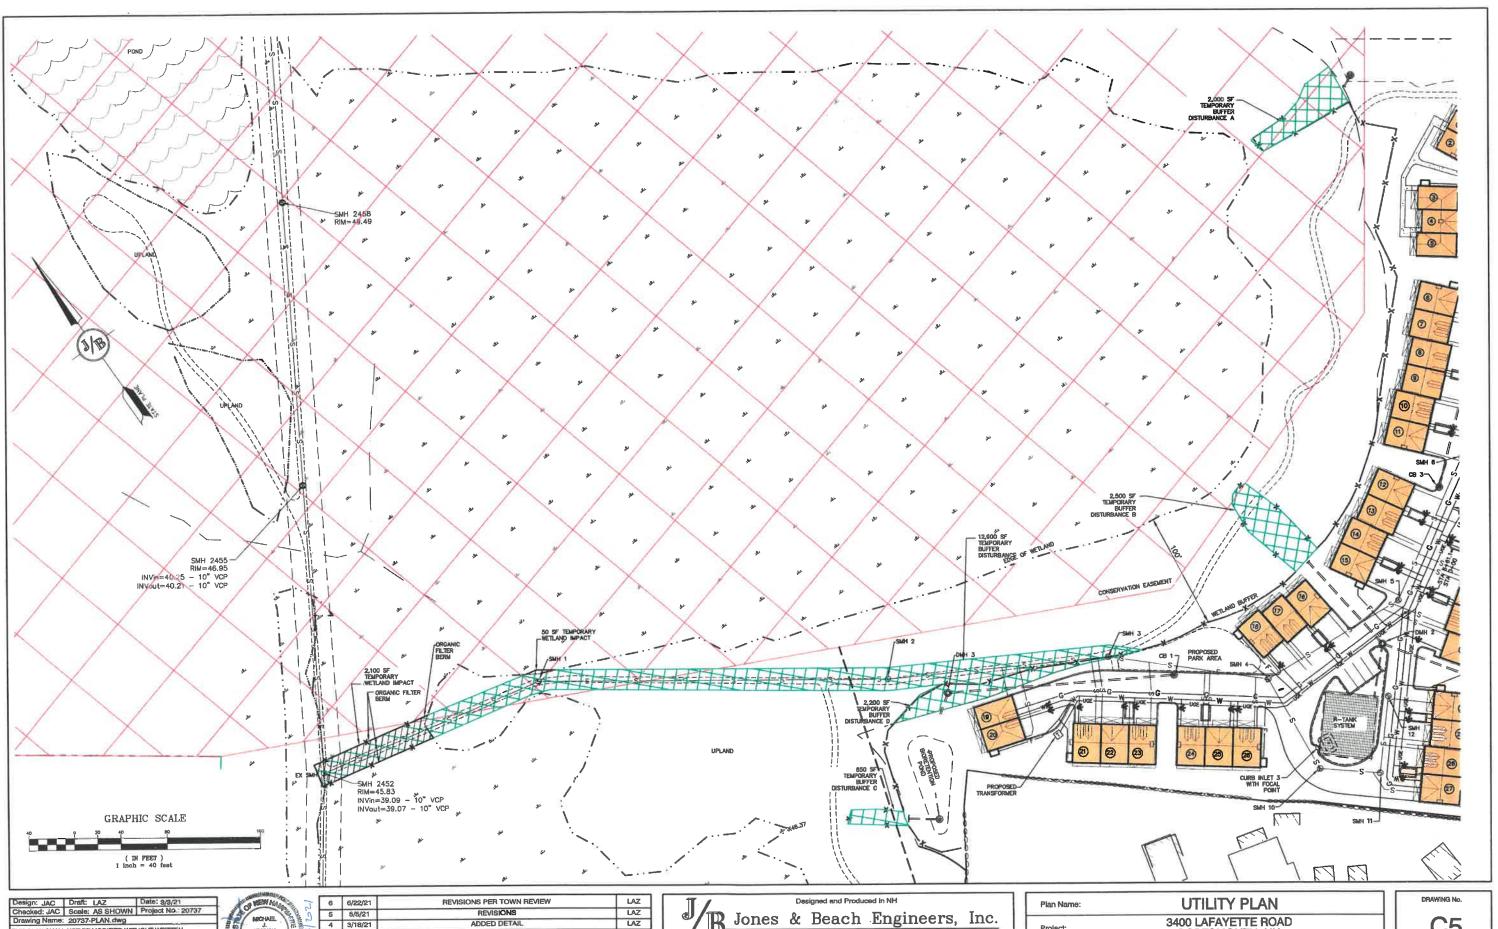

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Jones & Beach Engineers, Inc. 85 Portsmouth Ave. Civil Engineering Services
PO Box 219
Stretham, NH 03885 E-MAIL: JBE@ Services 603-772-4746 FAX: 603-772-0227 E-MAIL: JBE@JONESANDBEACH.COM

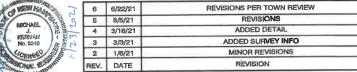
LAZ

MLG

BY

Plan Name:	UTILITY PLAN
Project:	3400 LAFAYETTE ROAD PORTSMOUTH, NH
Owner of Record: 225 B	RICCI CONSTRUCTION CO., INC. ANFIELD ROAD, PORTSMOUTH, NH 03801 BK 1930 PG 0229

C5 SHEET 10 OF 25 JBE PROJECT NO. 20737

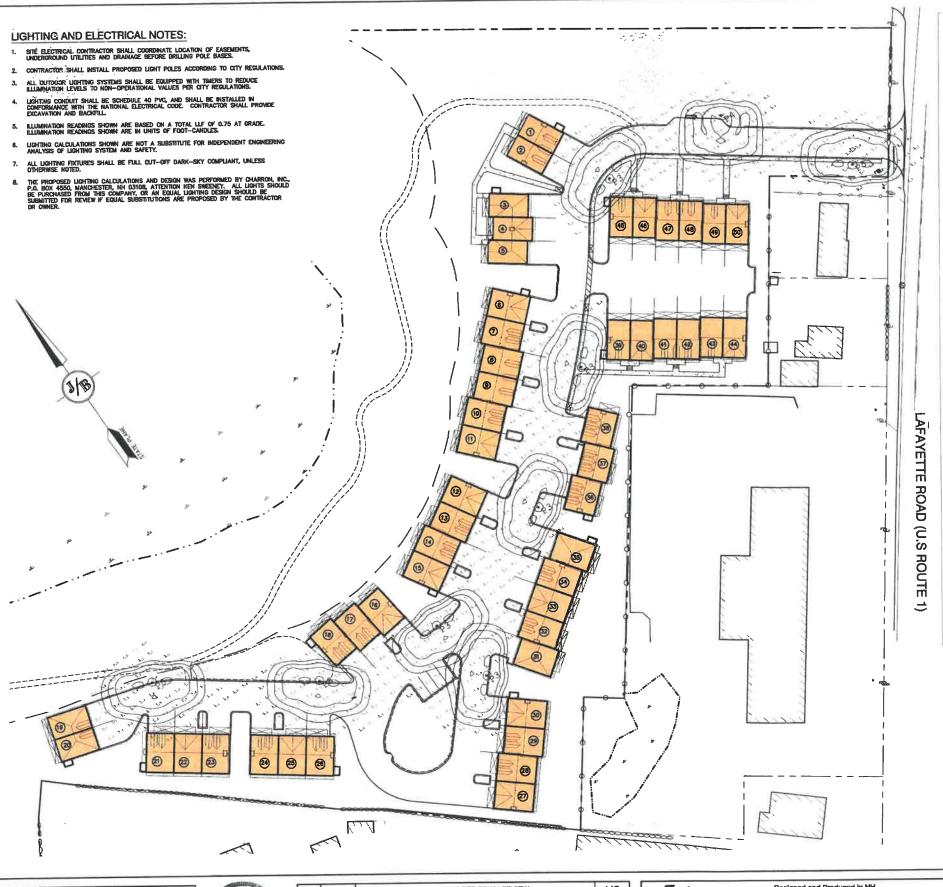

DESCRIPTION

The Traditionaire LED outdoor luminaire displays the old-fashion the Iraditional real lighting, enhancing any setting with distinctive styling. As a decorative luminaire, the Traditional real lighting. As a decorative luminaire, the Traditionaire LED tastefully complements the architectural and environmental design of parks and roadways. The high-lumen downlight configuration uses Cooper Lighting Solutions' patented LightBAR™ technology to deliver uniform and efficient illumination to pedestrian and roadway applications.

SPECIFICATION FEATURES

Hinged (stainless steel hinge pins) die-cast aluminum housing and cover with cupola. 3G vibration tested to ensure strength of construction and longevity in

Optics Choice of six patented, high-efficiency AccuLED Optic™ technology manufactured from injection-molded acrylic. Optics are precisely designed to shape efficiency and application spacing.
AccuLED Optic technology, creates
consistent distributions with the scalability to meet customized application requirements. Offered Standard in 4000K (+/- 275K) CCT and minimum 70 CRI. Optional 3000K CCT, 5000K CCT and 5700K CCT. For the ultimate level of spill

light control, an optional houseside shield accessory can be field or factory installed. The house-side shield is designed to seamlessly integrate with the SL2 or SL3

Electrical LED drivers mount to die-cast LEU drivers mount to die-cast aluminum back housing for optimal heat sinking, operation efficacy, and prolonged life. Standard drivers feature electronic universal voltage (120-277V 50/60Hz), 347V 60Hz or 480V 60Hz operation, greater than 0.9 power factor, less than 20% harmonic distortion, and is suitable for operation in -40°C to 40°C ambient environments.
All fixtures are shipped standard with 10kV/10kA common – and differential – mode surge protection. LightBARs feature an IP66 enclosure rating and

maintain greater than 95% lumen nce at 60,000 hours per

Self-aligning pole-top fitter for 3" O.D. pole tops or vertical tenons. Square headed 1-1/4" polymer costed mounting bolts with a lock

Cast components finished in a super durable black TGIC polyester powder coat paint, 2.5 mil nominal thickness for superior protection against fade and wear. Optional colors include: bronze, grey and white. RAL and custom color

Warranty

Streetworks

UTLD TRADITIONAIRE LED DOWNLIGHT

> 1 - 3 LightBARs Solid State LED

DECORATIVE POST TOP

OPTIONAL BIRD CONE DIMENSIONS TU 4-5/6" (119mm) 6-7/8° 1175mm 27-1/2" 3-3/4" (95mm - 17" [432mm]


CERTIFICATION DATA UL/CUL Listed LM79 / LM80 Compliant 3G Vibration Rated IP86 LightBARs ISC 9001

ENERGY DATA tronic LED Drive

>0.9 Power Factor <20% Total Harmonic Distortion 120-277V/50 & 60Hz, 347V/60Hz,

SHIPPING DATA Approximate Net Weight: 37 lbs. (17 kgs.)



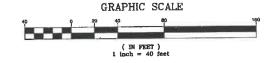

Design: JAC	Draft: LAZ	Date: 3/3/21
Checked: JAC	Scale: AS SHOWN	Project No.: 20737
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ANY ALTERATION	S, AUTHORIZED OR OTI	HERWISE, SHALL BE

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6	6/22/21	REVISIONS PER TOWN REVIEW	LAZ
5	5/5/21	REVISIONS	LAZ
4	3/18/21	ADDED DETAIL	LAZ
3	3/3/21	ADDED SURVEY INFO	LAZ
2	1/6/21	MINOR REVISIONS	DJM
REV.	DATE	REVISION	BY

Designed and Produced in NH Jones & Beach Engineers, Inc.

85 Portsmouth Ave. Civil Engineering Services PO Box 219 Strethern, NH 03885

Setvices Fax: 603-772-0227 E-MAIL: JBE@JONESANDBEACH.COM

LIGHTING PLAN Plan Name: 3400 LAFAYETTE ROAD Project: PORTSMOUTH, NH RICCI CONSTRUCTION CO., INC.
Owner of Record; 225 BANFIELD ROAD, PORTSMOUTH, NH 03801 BK 1830 PG 0229

SHEET 11 OF 25 JBE PROJECT NO. 20737

DRAWING No.



Design: JAC Draft: LAZ Date: 3/3/21
Checked: JAC Scale: AS SHOWN Project No.: 20737
Drawing Name: 20737-PLAN.dwg
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в	6/22/21	REVISIONS PER TOWN REVIEW	LAZ
_	5/5/21	REVISIONS	LAZ
5	3/18/21	ADDED DETAIL	LAZ
4		ADDED SURVEY INFO	LAZ
3	3/3/21	MINOR REVISIONS	DJM
2	1/6/21	REVISION	BY
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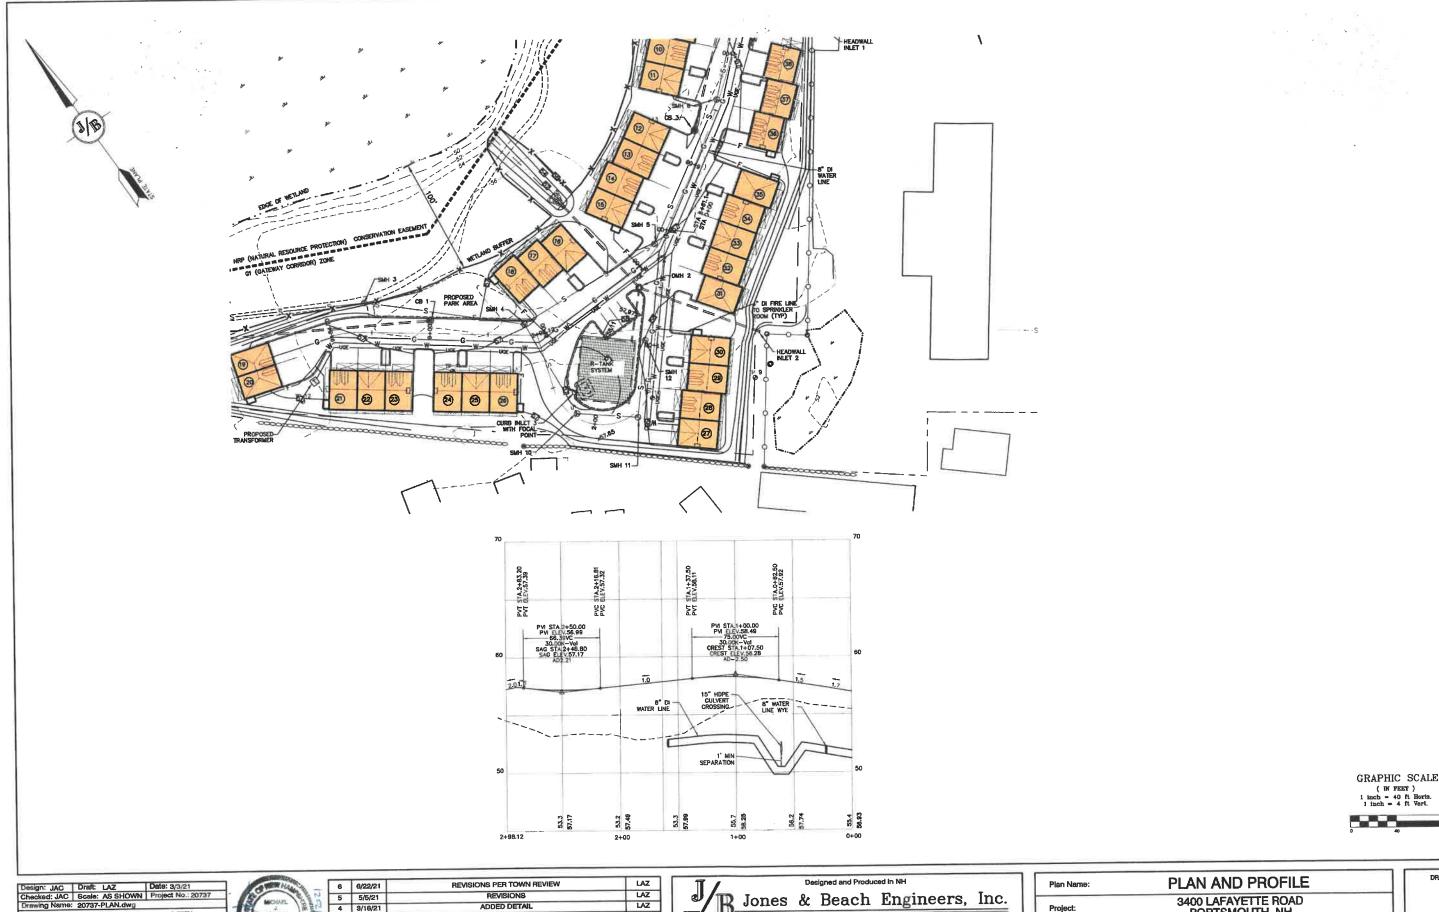
Jones & Beach Engineers, Inc.

BS Portsmouth Ave. Civil Engineering Services
PO Box 219
Stratham, NH 03885

E-MAIL: JBE@JONESANDBEACH.COM

Project:	3400 LAFAYETTE ROAD PORTSMOUTH, NH
Owner of Record: 225 BA	RICCI CONSTRUCTION CO., INC. NFIELD ROAD, PORTSMOUTH, NH 03801 BK 1930 PG 0229

DRAWING No.
P2
SHEET 13 OF 25
JBE PROJECT NO. 20737



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REV.	DATE	REVISION	BY
2	1/6/21	MINOR REVISIONS	DJM
3	3/3/21	ADDED SURVEY INFO	LAZ
4	3/18/21	ADDED DETAIL	LAZ
5	5/5/21	REVISIONS	LAZ
6	6/22/21	REVISIONS PER TOWN REVIEW	LAZ

B Jones & Beach Engineers, Inc. Services 603-772-4746
FAX: 603-772-0227
E-MAIL: JBE@JONESANDBEACH.COM 85 Portsmouth Ave. Civil Engineering Services
PO Box 219
Stretham, NH 03885 E-MAIL: JBE@

Plan Name:	PLAN AND PROFILE
Project:	3400 LAFAYETTE ROAD PORTSMOUTH, NH
Owner of Record: 225	RICCI CONSTRUCTION CO., INC. BANFIELD ROAD, PORTSMOUTH, NH 03801 BK 1930 PG 0229

P3 SHEET 14 OF 25 JBE PROJECT NO. 20737



Design: JAC Draft: LAZ Date: 9/3/21
Checked: JAC | Scale: AS SHOWN | Project No.: 20737
Drawing Name: 20737-PLAN.dwg
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6	6/22/21	REVISIONS PER TOWN REVIEW	LAZ
5	5/5/21	REVISIONS	LAZ
4	3/18/21	ADDED DETAIL	LAZ
3	3/3/21	ADDED SURVEY INFO	LAZ
2	1/8/21	MINOR REVISIONS	DJM
REV.	DATE	REVISION	BY

Designed and Produced in NH Designed and Produced in NH

Jones & Beach Engineers, Inc. Services 603-772-4748 FAX: 603-772-0227 E-MAIL: JBE@JONESANDBEACH.COM 85 Portsmouth Ave. PO Box 219
Stratham, NH 03885

Civil Engineering Services
E-MAIL: JBE@

Plan Name:	SEWER PROFILE
Project:	3400 LAFAYETTE ROAD PORTSMOUTH, NH
Owner of Record: 225 f	RICCI CONSTRUCTION CO., INC. BANFIELD ROAD, PORTSMOUTH, NH 03801 BK 1930 PG 0228

P4 SHEET 15 OF 25 JBE PROJECT NO. 20737



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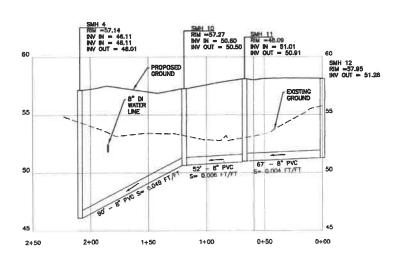
REVISIONS PER TOWN REVIEW LAZ LAZ LAZ 5 5/5/21 4 3/18/21 REVISIONS ADDED DETAIL LAZ DJM 3 3/3/21 2 1/6/21 ADDED SURVEY INFO MINOR REVISIONS BY REVISION

Designed and Produced in NH Jones & Beach Engineers, Inc. Services 603-772-4746 FAX: 603-772-0227 E-MAIL: JBE@JONESANDBEACH.COM B5 Portsmouth Ave. Civil Engineering Services
PO Box 219
Stretham, NH 03885
E-MAIL: JBE@


Plan Name:	SEWER PROFILE
Project:	3400 LAFAYETTE ROAD PORTSMOUTH, NH
Owner of Record: 225 E	RICCI CONSTRUCTION CO., INC. IANFIELD ROAD, PORTSMOUTH, NH 03801 BK 1930 PG 0229


P5 SHEET 16 OF 25 JBE PROJECT NO. 20737






LOOP ROAD

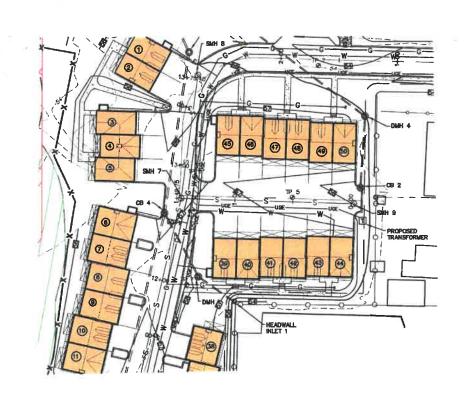

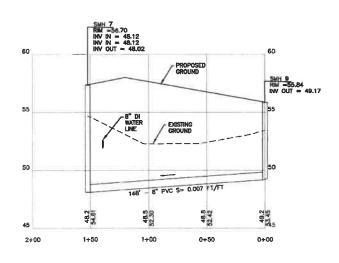

SHARED DRIVEWAY

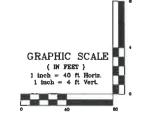

Draft: LAZ	Date: 3/3/21
Scale: AS SHOWN	Project No.: 20737
20737-PLAN.dwg	
	Draft: LAZ Scale: AS SHOWN : 20737-PLAN.dwg

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THEN HAVE	6	6/22/21	REVISIONS PER TOWN REVIEW
MICHAEL 1	5	5/5/21	REVISIONS
MERIUM I	4	3/18/21	ADDED DETAIL
No. 9848 DE	3	3/3/21	ADDED SURVEY INFO
(doesno	2	1/6/21	MINOR REVISIONS
OWT O	REV.	DATE	REVISION
-activities/fices.			


1		De	signed and Prod	duced in NH		
B	Jones	&	Beach	n Engi	neers,	Inc.
85 Portsmouth A PO Box 219	ve. Civil	Eng	ineering	Services		-772-4746 -772-0227

LAZ

LAZ DJM BY

Plan Name:	SEWER PROFILE	
Project:	3400 LAFAYETTE ROAD PORTSMOUTH, NH	
Owner of Record: 225	RICCI CONSTRUCTION CO., INC. BANFIELD ROAD, PORTSMOUTH, NH 03801 BK 1930 PG 0229	


P5
SHEET 17 OF 25
JBE PROJECT NO. 20737

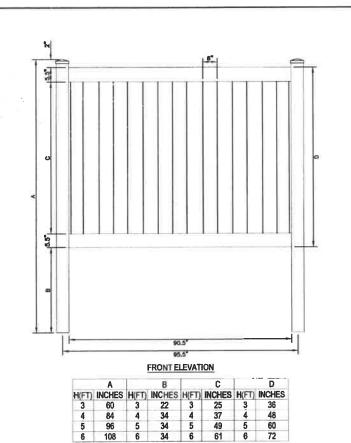

NOTES: 1. CONTRACTOR TO PROVIDE FENCE SPEC TO ENGINEER FOR REVIEW PRIOR TO INSTALLATION. 2. VIN'1. FENCE SHALL MEET ASTM F984-09 STANDARDS.

6' VINYL STOCKADE FENCE

NOT TO SCALE

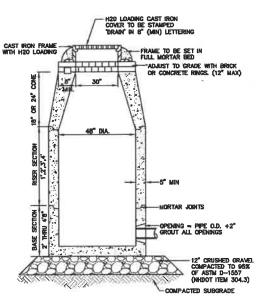



- 1. BASE SECTION SHALL BE MONOLITHIC WITH 48" INSIDE DIAMETER.
- 2. ALL SECTIONS SHALL BE DESIGNED FOR H20 LOADING.
- 3. CONCRETE SHALL BE COMPRESSIVE STRENGTH 4000 PSI, TYPE II CEMENT.
- 4. FRAMES AND GRATES SHALL BE HEAVY DUTY AND DESIGNED FOR H20 LOADING.
- 5. PROVIDE "V" KNOCKOUTS FOR PIPES WITH 2" MAX. CLEARANCE TO OUTSIDE OF PIPE. MORTAR ALL PIPE CONNECTIONS SO AS TO BE WATERTIGHT.
- 6. JOINT SEALANT BETWEEN PRECAST SECTIONS SHALL BE BUTYL RUBBER.
- ALL DRAIN MANHOLE FRAMES AND GRATES SHALL BE NHDOT TYPE MH-1, OR NEEMAH R-1798 OR APPROVED EQUAL (30" DIA. TYPICAL).
- B. STANDARD FRAME(S) AND GRATE(S) SHALL BE SET IN FULL MORTAR BED. ADJUST TO GRADE WITH CLAY BRICK AND MORTAR (2 BRICK COURSES TYPICALLY, 5 BRICK COURSES MAXIMUM, BUT NO MORE THAN 12"), OR PRECAST CONCRETE D'ONUTS'.

DRAIN MANHOLE


NOT TO SCALE

NOTES:

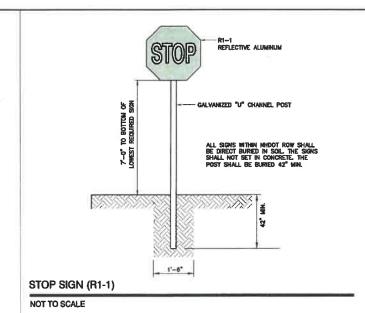

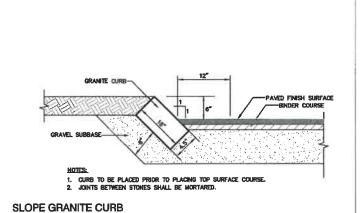

NOTES:

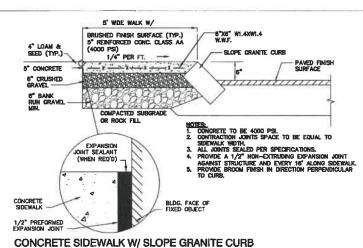

12" TO FACE OF CURE

COMPACTED SURGRADE

, SHOOFDEL

NOT TO SCALE

12' TO FACE OF CURE

-SLOPED GRANITE CURB

12" MIN, BANKRUN GRAVEL (NHDOT ITEM 304.2) -


TWO COURSES BITUMOUS CONCRETE 1.25" WEARING COURSE ROLLED (NHDOT TYPE E) 2" BINDER COURSE ROLLED (NHDOT TYPE B)

3, TOWN MAY REQUIRE UNDERDRAIN AND/OR ADDITIONAL DRAINAGE IF SOIL CONDITIONS WARRANT

4" CRUSHED GRAVEL (NHDOT ITEM 304.3)


REMOVE ALL ORGANICS, TOPSOIL AND MATERIAL YIELDING TO A 10 TON ROLLER, SUBBASE AREAS THAT CONTAIN UNSUITABLE
MATERIALS MUST BE EXCAVATED TO A DEPTH NO LESS THAN 36° BELOW FINISH GRADE AND BE REPLACED WITH GRAVEL
COMPACTED TO 95%

2. ALL MATERIALS TO BE AS SPECIFIED PER TOWN STANDARDS AND INDOT, WHICHEVER IS MOST STRINGENT. GRADATION AND
COMPACTION TEST RESULTS (95% MIN.) SHALL BE SUBMITTED FOR REVIEW AND APPROVAL.

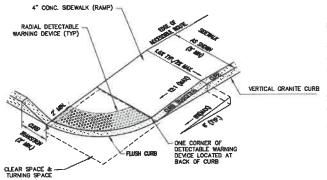


ACCESSIBLE CURB RAMP (NHDOT OPTION 3)

NOT TO SCAL

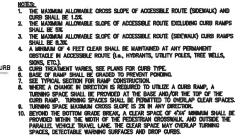

TYPICAL ROADWAY SECTION W/CURBING NOT TO SCALE

Design: JAC Draft: LAZ Date: 3/3/21
Checked: JAC Scale: AS NOTED Project No.: 20737
Drawing Name: 20737-PLAN, dwg
THIS PLAN SHALL NOT BE MODIFIED WITHOUT WRITTEN
PERMISSION FROM JONES & BEACH ENGINEERS, INC. (JBE).
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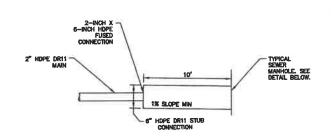
Plan Name:	DETAIL SHEET
Project:	3400 LAFAYETTE ROAD PORTSMOUTH, NH
Owner of Record: 225 B/	RICCI CONSTRUCTION CO., INC. ANFIELD ROAD, PORTSMOUTH, NH 03801 BK 1930 PG 0229

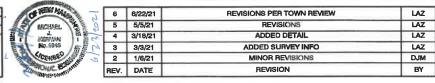
DRAWING No.

D1

SHEET 18 OF 25

JBE PROJECT NO. 20737



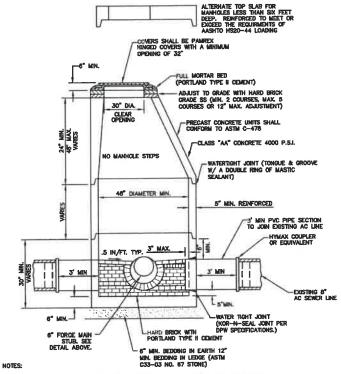


- 1. PER NHDES ENV-WO 704.13(C), THE MORTAR SPECIFICATION SHALL BE AS FOLLOWS:
 1. MORTAR SHALL BE COMPOSED OF PORTLAND COMENT AND SAND WITH OR WITHOUT HYDRATED LIME ADDITION;
 2. PROPORTIONS IN MORTAR OF PARTS BY VOLUMES SHALL BE:
 A 4.5 PARTS SAND AND 1-PARTS EXPENDED OR PART HYDRATED LIME;
 3. CALLED SHATTS BE TYPE PORTLAND COMENT CONFORMING TO ASTAL C150-05;
 4. HYDRATED LIME FOR MASONRY PURPOSES;
 4. HYDRATED LIME FOR MASONRY PURPOSES;
 5. SAND SHALL CONSIST OF NORTH TATURAL SAND CONFORMING TO THE ASTAL C33-03 STANDARD SPECIFICATIONS FOR CONCRETE, FINE AGGREGATES;
- SHELVES SHALL BE CONSTRUCTED TO THE ELEVATION OF THE HIGHEST PIPE CROWN AND SLOPED TO DRAIN TOWARD THE FLOWING THROUGH CHANNEL IN ACCORDANCE WITH ENV-WQ 704.12 (K).
- 3. ALL MANHOLES SHALL BE TESTED FOR LEAKAGE IN ACCORDANCE WITH ENV-WQ 704.17 (a) THROUGH (e).
- SEWER MANHOLE COVERS SHALL CONFORM TO ASTM A48 WITH A CASTING EQUAL TO CLASS 30 IN ACCORDANCE
- ALL ASBESTOS CONTAINING WASTE MATERIALS MUST BE PROPERLY IDENTIFIED, PACKAGED AND DELIVERED TO A LANDRIL LICENCED BY THE NHIDES SOLID WASTE MANAGEMENT PROGRAM FOR DISPOSAL CALL (603) 271—2925 FOR MODE MOFORMATION.
- 8. PORTSMOUTH STANDARD SEWER MANHOLE SHALL BE USED.
- 7. CONTRACTOR TO PURCHASE SEWER MANHOLE COVERS FROM THE CITY OF PORTSMOUTH DIRECTLY.
- MANHOLE BASE SECTIONS SHALL BE MONOLITHIC TO A POINT AT LEAST 6" ABOVE THE HIGHEST INCOMING SEWER PIPE PER ENV-WO 704.12 (e).
- 9. MANHOLE CASTINGS SHALL CONFORM TO ASTM A48 PER ENV-WQ 704.13 (a) (6).

PORTSMOUTH SEWER MANHOLE

NOT TO SCALE

REVISIONS PER TOWN REVIEW 6 6/22/21 5 5/5/21 REVISIONS ADDED DETAIL 4 3/18/21 3 3/3/21 ADDED SURVEY INFO 2 1/6/21 MINOR REVISIONS REV. DATE

NOTES:

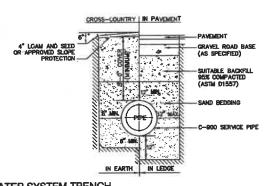

LOAM AREA | PAVED AREA

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LAZ

LAZ

LAZ


DJM

BY

3. ALL MATERIALS ARE TO BE COMPACTED TO 95% OF ASTM D-1567.


WATER SYSTEM TRENCH

NOT TO SCALE

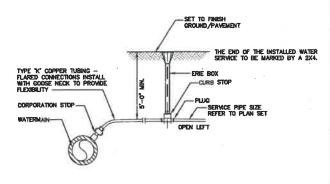

WATER SERVICE CONNECTION-COPPER PIPE

NOT TO SCALE

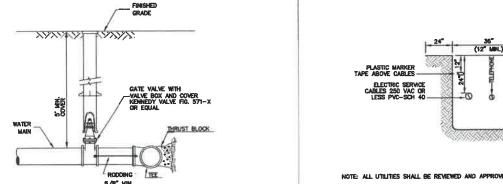


BURIED GATE VALVE DETAIL

4" COMPACTED LOAM -

SUITABLE BACKFILL MATERIAL

DRAINAGE TRENCH

NOT TO SCALE

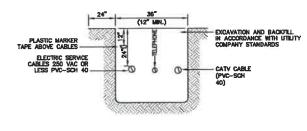

NOTE: ALL UTILITIES SHALL BE REVIEWED AND APPROVED BY APPROPRIATE UTILITY COMPANY.

UTILITY TRENCH

NOT TO SCALE

ALT, SLAB TOP REINFORCED TO MEET OR EXCEED REQUIREMENTS OF H20 LOADING

CATCH BASIN WITH GREASE HOOD

9. ALL CATCH BASINS ARE TO BE FITTED WITH GREASE HOODS

COMPACTED SUBGRADE.

3. CONCRETE SHALL BE COMPRESSIVE STRENGTH 4000 PSI, TYPE II CEMENT,

4. FRAMES AND GRATES SHALL BE HEAVY DUTY AND DESIGNED FOR H20 LOADIN


PROVIDE "V" KNOCKOUTS FOR PIPES WITH 2" MAX. CLEARANCE TO OUTSIDE OF PIPE. MORTAR ALL PIPE CONNECTIONS SO AS TO BE WATERTIGHT.

6. JOINT SEALANT BETWEEN PRECAST SECTIONS SHALL BE BUTYL RUBBER.

NOTES: 1. Base section shall be monolithic with 48" inside diameter.

2. ALL SECTIONS SHALL BE DESIGNED FOR H20 LOADING.

NOT TO SCALE

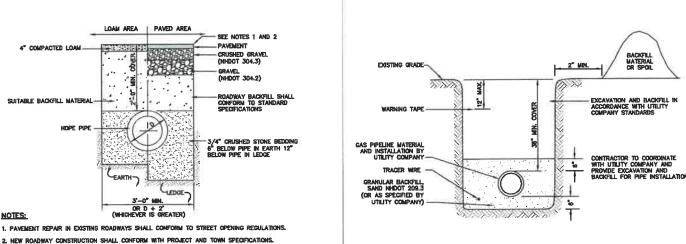

NOT TO SCALE

GAS TRENCH

LOAM AREA PAVED AREA SEE NOTES 1 AND 2 CRUSHED GRAVEL GRAVEL CRUSHED STONE (ASTM C33/c33M STONE SIZE NO. 67 IN ACCORDANCE WITH Env-Wq 704.11(q) BEDDING FOR FULL WIDTH OF THE PIPE 8° BELOW PIPE IN EARTH 12° BELOW PIPE IN EARTH 12°

ALL CATCH BASIN FRAMES AND GRATES SHALL BE NADOT CATCH BASIN TYPE ALTERNATE 1 OR NEENAH R-3570 OR APPROVED EQUAL (24"x24" TYPICAL).

STANDARD CATCH BASIN FRAME AND GRATE(S) SHALL BE SET IN FULL MORTAR BED. ADJUST TO GRADE WITH CLAY BRICK AND MORTAR (2 BRICK COURSES TYPICALLY, 5 BRICK COURSES MAXIMUM, BUT NO MORE THAN 12"). OR PRECAST CONCRETE CONUTS.

NOTES: 1. PAVEMENT REPAIR IN EXISTING ROADWAYS SHALL CONFORM TO PAVEMENT DETAILS.

- 2. NEW ROADWAY CONSTRUCTION SHALL CONFORM TO SUBDIVISION SPECIFICATIONS.
- TRENCH BACKFILL SHALL CONFORM WITH ENV. Wq 704.11(h) AND BE FREE OF DEBRIS, PAVEMENT, ORGANIC MATTER, TOP SOIL, WET OR SOFT MUCK, PEAT OR CLAY, EXCAVATED LEDGE OR ROCKS OVER SIX INCHES.
- 4. We MAXIMUM ALLOWASLE TRENCH WIDTH TO A PLANE 12" INCHES ABOVE THE PIPE. FOR PIPES 15 INCHES NOMINAL DIAMETER OR LESS, WIDTH SHALL BE NO MORE THAN 36"; FOR PIPES GREATER THAN 15 INCHES NOMINAL DIAMETER, WIDTH SHALL BE 24 INCHES TULLS PIPE OLD. WIDTH SHALL ALSO BE THE PAYMENT WIDTH FOR LEDGE EXCAVATION AND FOR ORDERED EXCAVATION BELOW GRADE.
- 5. RIGID FOAM INSULATION TO BE PROVIDED WHERE COVER IN THE ROADWAY IS LESS THAN 6' AND CROSS COUNTRY IS LESS THAN 4' WHERE INDICATED ON THE DES APPROVED PLANS.
- PIPE SAND BLANKET MATERIAL SHALL BE GRADED SAND, FREE FROM ORGANIC MATERIALS, GRADED SUCH THAT 100% PASSES A 1/2 " SIEVE AND A MAXIMUM OF 15% PASSES A #200 SIEVE IN ACCORDANCE WITH Env-Wq 704.11(b).

SEWER TRENCH

NOT TO SCALE

Designed and Produced in NH	Plan Name: DETAIL SHEET
Jones & Beach Engineers, Inc.	Project: 3400 LAFAYETTE ROAD PORTSMOUTH, NH
85 Portsmouth Ave. Civil Engineering Services 603-772-4748 PO Box 219 Stratham, NH 03885 E-MAIL: JBE@JONESANDBEACH.COM	RICCI CONSTRUCTION CO., INC. Owner of Record: 225 BANFIELD ROAD, PORTSMOUTH, NH 03801 BK 1930 PG 0229

DRAWING No. **D2** SHEET 19 OF 25 JBE PROJECT NO. 20737

FRAME TO BE SET IN FULL MORTAR BED ADJUST TO GRADE WITH BRICK OR PRE-CAST CONCRETE RINGS


"THE SNOUT, OIL
WATER-DEBRIS
SEPARATOR" OR
EQUAL


12° CRUSHED GRAVEL COMPACTED TO 95% OF ASTM -1557

(NHDOT ITEM 304.3)



AT THE USER'S SOLE RISK AND WITHOUT LIABILITY TO JBE.

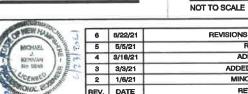

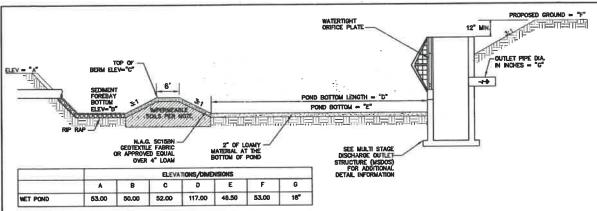

WET POND SECTION

NOT TO SCALE

PAINTED ANGLE IRON

#5 REBAR

CONCRETE SLAB

1/2" SLOT FOR 1/4" ORIFICE PLATE

NOT TO SCALE

WET POND CONSTRUCTION CRITERIA

- FOUNDATION PREPARATION THE FOUNDATION AREA SHALL BE CLEARED OF TREES LOGS, STUMPS, ROOTS, BRUSH, BOULDERS, SOD, AND RUBBISH, IF NEEDED TO ESTABLISH VEGETATION, THE TUPSOIL AND SOD SHALL BE STOCKPRED AND SPERAD ON THE COMPLETED DAM AND SPILLWAYS. FOUNDATION SURFACES SHALL BE SUPPED NO STEEPER THAN 1:1. THE FOUNDATION AREA SHALL HAVE MOSTURE ADDED OR IT SHALL BE COMPACTED, IF NECESSARY, SO THAT THE FRIST LAYER OF FILL MATERIAL CAN BE COMPACTED AND BONDED TO THE FUNDATIONATIONS. THE CUTTOFF TRENCH AND ANY OTHER REQUIRED EXCAVATION SHALL BE DUE TO THE UNITS AND GRADES SHOWN ON THE PERMANENT FILL. DISTING STREAM CHANNELS IN THE FOUNDATION AREA SHALL BE LUSTON THE PERMANENT FILL. DISTING STREAM CHANNELS IN THE FOUNDATION AREA SHALL BE LUSTON TO STREAM CHANNELS IN THE FOUNDATION AREA SHALL BE LUSTON TO STREAM CHANNELS IN THE FOUNDATION AREA COMMONANCE COMPACTION EXCORPTION THAN 1:1 AND DEEPEND AND WINDERDED AS NECESSARY TO REMOVE ALL STRONES, GRAVEL, SAND, STUMPS, ROOTS, AND OTHER OBJECTIONABLE MATERIAL PLACED IN THE FILL SHALL BE FREE OF DETRIMENTAL AMOUNTS OF SOO, ROOTS, FROZEN SOIL, STONES MORE THAN 6 INCHES IN DIAMETER (EXCEPT FOR ROCK FILLS), AND OTHER OBJECTIONABLE MATERIA.
- SELECTED BACK FILL MATERIAL SHALL BE PLACED AROUND STRUCTURES, PIPE CONDUITS AND ANTI SEEP COLLARS AT ABOUT THE SAME RATE ON ALL SIDES, TO PREVENT DAMAGE FROM UNIQUAL LOADING, THE PLACING AND SPREADING OF FILL MATERIAL SHALL BE STAFTED AT THE LOWEST POINT OF THE FOUNDATION AND THE FILL BROUGHT UP IN MORZONTAL LAYERS OF SUCH THICKNESS THAT THE REQUIRED COMPACTION CAN BE DETANDED. THE SHALL BE CONSTRUCTED IN CONTINUOUS HORZONTAL LAYERS EXCEPT WHERE OPENINGS OR SECTIONALIZED FIAR REGUIRED. IN THOSE CASES, THE SLOPE OF THE BOODING SURFACES BETWEEN THE EDBRANGHT IN PLACE AND THE EDBRANGHT TO BE PLACED SHALL NOT BE STEEPER THAN 3 HORZONTAL TO 1 VERTICAL THE BONDING SURFACE SHALL BE TREATED THE SAME AS THAT SPECIFIED FOR THE FOUNDATION SO AS TO INSURE A GOOD BOND WITH THE NEW FILL THE SURFOUNDING MATERIAL. IF IT IS NECESSARY TO USE MATERIALS OF VARYING TEXTURE AND GRADATION, THE MORE METERIAL SHALL BE PLACED ON THE SUBSTRIBUTION OF MATERIAL SHALL BE PLACED.

 PRATS OF THE FILL IF ZONDING FLILS OF SUBSTRIBUTION PORTERIAL SHALL BE PLACED ACCORDING TO THE LINES AND GRADES SHOWN ON THE DRAWING THE COMPLETE WORK SHALL CONFORM TO THE LINES, GRADES, AND ELEVATIONS SHOWN ON THE PRANISO OF AS STAKED IN THE FILL.
- COMPACTION CONSTRUCTION EQUIPMENT SHALL BE OPERATED OVER THE AREAS OR EACH LAYER OF FILL TO INSURE THAT THE REQUIRED COMPACTION IS OBTAINED, SPECIAL EQUIPMENT SHALL BE USED IF MEEDED TO DETAIN THE REQUIRED COMPACTED AS NECESSARY TO OBTAIN THAT SHALL BE USED IF MEEDED TO STRUCTURES, FIPE CONDUINED, NOT ANTI SEPF COLLARS SHALL BE COMPACTED TO STRUCTURES, FIPE CONDUINTS, AND ANTI SEPF COLLARS SHALL BE COMPACTED TO A DENSITY. FULL ADJACENT TO THAT OF THE SURROUNDING FILL BY MEANS OF HAND TAMPING OR MANAJALY DIRECTED POWER TAMPER OR PLATE VERYATERS. FILL ADJACENT TO CONCRETE STRUCTURES SHALL NOT BE COMPACTED UNTIL THE CONCRETE IS STRONG ENOUGH TO SUPPORT THE LOAD.
- PROTECTION --- A PROTECTIVE COVER OF VEGETATION SHALL BE ESTABLISHED ON ALL EXPOSED SURFACES OF THE EMBANKMENT, SPILLWAY, AND BORROW AREA IF SOIL AND CLIMATIC CONDITIONS PERMIT. IF SOIL OR CLIMATIC CONDITIONS PRECLIDE THE USE OF VEGETATION AND PROTECTION IS NEEDED, NON-VEGETATIVE MEANS SUCH AS MULCHES OR GRAVEL MAY BE USED. IN SOME PLACES, TEMPORARY VEGETATION MAY BE USED UNTIL CONDITIONS PERMIT ESTABLISHMENT OF PERMANENT VEGETATION. THE EMBANKMENT AND SPILLWAY SHALL BE FENCED IF NECESSARY TO PROTECT THE VEGETATION.
- SEFERS'D PREPARATION, SEEDING, FERTILIZING, AND MULCHING SHALL COMPLY WITH THE APPROPRIATE VEGETATIVE BMP'S.

1. REPROPERTY STATES.
2. COLORETE BOX TO BE CONSTRUCTED OR PRECAST OF EQUAL DIMENSIONS AND REINFORCING.
2. CONCRETE SLAB TO BE CONSTRUCTED ALONG WITH BASE, FOR PRECAST BOX, A SLOTTED CONCRETE SLAB TO BE LIST.
4. SECTION JOINTS AND PIPE OPENING SHALL BE SEALED WATERTIGHT WITH MORTAR BY CONTRACTOR.

MULTI-STAGE DISCHARGE OUTLET STRUCTURE (MSDOS)

- CONCRETE THE MIX DESIGN AND TESTING OF CONCRETE SHALL BE CONSISTENT WITH THE STRENGTH REQUIREMENTS OF THE JOB, MOX REQUIREMENTS OR NECESSARY STRENGTH SHALL BE SPECIFED. THE TYPE OF COMENT, ARE ENTRAPMENT, SLUMP, AGGREGATE, OR OTHER PROPERTIES SHALL BE SPECIFED IF NECESSARY, ALL CONCRETE IS TO CONSIST OF A WORKABLE MIX THAT CAN BE PLACED AND FRIGHED IN AN ACCEPTABLE MANNER. NECESSARY CURING SHALL BE SPECIFIED. REINFORCING STEEL SHALL BE PLACED AS INDICATED ON THE PLANS AND SHALL BE HELD SOURCHLY IN PLACE DURING CONCRETE PLACEMENT. SUB-GRADES AND FORMS SHALL BE INSTALLED TO LINE AND GRADE, AND THE FORMS SHALL BE MOTTAR TIGHT AND UNYIELDING AS THE CONCRETE IS PLACED.
- THE CONTRACTOR WILL NOTIFY JONES AND BEACH ENGINEERS AFTER EACH OF THE GRAVEL WETLAND PONDS HAVE BEEN EXCAVATED TO THE BOTTOM OF THE SYSTEM FOR A MANDATORY INSPECTION PRIOR TO BUILDING BERMS, PLACING STONE OR INSTALLING PIPE SYSTEM.


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©-

BERMS AND WEIRS SEPARATING THE FOREBAY AND TREATMENT CELLS SHOULD BE CONSTRUCTED WITH CLAY, OR NON-CONDUCTIVE SOILS, AND/OR A FINE GEOTEXTILE, OR SOME COMBINATION THEREOF, TO AVOID WATER SEEPAGE AND SOIL PIPING THROUGH THESE EARTHEN DIVIDERS.


FRONT VIEW

ANGLE IRON S.S. BOLTED

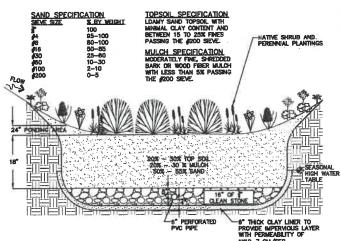

DESIGN CONSIDERATIONS

- DO NOT PLACE BIORETENTION SYSTEMS INTO SERVICE UNTIL THE SMP HAS BEEN PLANTED AND ITS CONTRIBUTING AREAS HAVE BEEN FULLY STABILIZED.
- DO NOT DISCHARGE SEDIMENT-LADEN WATERS FROM CONSTRUCTION ACTIVITIES (RUN-OFF, WATER FROM EXCAVATIONS) TO THE BIORETENTION AREA DURING ANY STAGE OF CONSTRUCTION.
- DO NOT TRAFFIC EXPOSED SOIL SUFFACE WITH CONSTRUCTION EQUIPMENT. IF FEASIBLE, PERFORM EXCAVATIONS WITH EQUIPMENT OUTSIDE THE LIMITS OF THE INFILTRATION COMPONENTS OF THE SYSTEM.
- CLAY LINER MATERIAL SHALL BE CLEAN SILTY-CLAY BORROW FREE OF ROOTS, ORGANIC MATTER, AND OTHER DELETERIOUS SUBSTANCES, AND SHALL CONTAIN NO ROCKS OR LUMPS OVER THREE INCHES (3*) IN DIAMETER. THIS MATERIAL SHALL BE INSTALLED IN 8* LIFTS COMPACTED TO 92% OF ASTM D-1557, AND SHALL MEET THE FOLLOWING SPECIFICATIONS: 8* PASSING 100%, \$40 SIEVE 95-100%, \$40 SIEVE 60-90%, \$100 SIEVE 40-80%, \$200 SIEVE 25-40% (07 THE FRACTION PASSING THE \$44 SIEVE). THE CLAY COMPONENT SHALL HAVE A PLASTICITY NIDEX OF AT LEAST 8 AND A HYDRAULIC CONDUCTIVITY OF 10 TO THE -6 CM/SEC.
- COMPACTION AND MATERIALS TESTING SERVICES SHALL BE PERFORMED BY AN INDEPENDENT GEOTECHNICAL ENGINEER RETAINED BY THE OWNER.

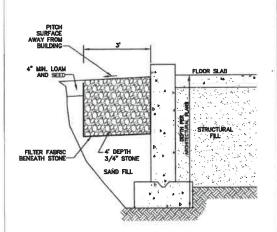

DRIP EDGE DETAIL

NOT TO SCALE


BIORETENTION SYSTEM (with clay bottom and pipe)

NOT TO SCALE

STAINLESS STEEL HINGE

PO Box 219 Stratham, NH 03885

POND STRUCTURE COVER

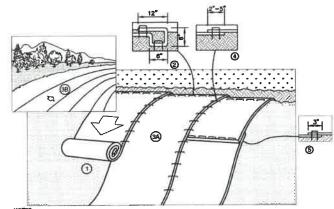

- 2. BEGIN AT THE TOP OF THE SLOPE BY ANCHORING THE BLANKET IN A 6" DEEP BY 6" WIDE TRENCH WITH APPROXIMATELY 12" OF BLANKET EXTENDED BEYOND THE UP-SLOPE PORTRON OF THE TRENCH. ANCHOR THE BLANKET WITH A ROW OF STAPLES/STAKES APPROXIMATELY 12" APART IN THE BOTTOM OF THE TRENCH. BACKFILL AND COMPACT THE TRENCH. BACKFILL AND FOLD REMAINING 12" PORTRON OF BLANKET BACK OVER SEED AND COMPACTED SOIL. SECURE BLANKET OVER COMPACTED SOIL WITH A ROW OF STAPLES/STAKES SPACED APPROXIMATELY 12" APART ACROSS THE WIDTH OF THE BLANKET.
- 3. ROLL THE BLANKETS (A) DOWN OR (B) HORIZONTALLY ACROSS THE SLOPE. BLANKETS WILL UNROLL WITH APPROPRIATE SIDE AGAINST THE SOIL SURFACE. ALL BLANKETS MUST BE SECURELY FASTENDE TO SOIL SURFACE BY PILATOR STAPLES/STAKES IN APPROPRIATE LOCATIONS AS SHOWN IN THE STAPLE PATTERN GUIDE. WHEN USING OPTIONAL DOT SYSTEM, STAPLES/STAKES SHOULD BE PLACED THROUGH EACH OF THE COLORDED DOTS CORRESPONDING TO THE APPROPRIATE STAPLE PATTERN.
- 4. THE EDGES OF PARALLEL BLANKETS MUST BE STAPLED WITH APPROXIMATELY 2"-5" OVERLAP DEPENDING ON BLANKET TYPE. TO ENSURE PROPER SEAM AUGINEATI, PLACE THE EDGE OF THE OVERLAPPING BLANKET BEING INSTALLED ON TOP) EVEN WITH THE COLORED SEAM STITIC THE PREVIOUSLY INSTALLED BLANKET.
- 5. CONSECUTIVE BLANKETS SPLICED DOWN THE SLOPE MUST BE PLACED END OVER END (SHINGLE STYLE) WITH AN APPROXIMATE 3" OVERLAP, STAPLE THROUGH OVERLAPPED AREA, APPROXIMATELY 12" APART ACROSS ENTIRE BLANKET WIDTH, MODEL IN LOOSE SOLL CONDITIONS. THE USE OF STAPLE OR STAKE LENGTHS GREATER THAN 6" MAY BE NEDESSARY TO PROPERLY SECURE THE BLANKETS.




NORTH AMERICAN GREEN 14649 HIGHWAY 41 NORTH EVANSVILLE, INDIANA 47725 1-800-772-2040

EROSION CONTROL BLANKET SLOPE INSTALLATION NORTH AMERICAN GREEN (800) 772-2040

E-MAIL: JBE@JONESANDBEACH.COM

NOT TO SCALE

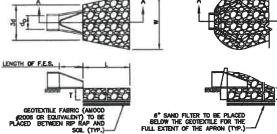

SECTION A-A PIPE OUTLET TO FLAT AREA WITH NO DEFINED CHANNEL

SECTION A-A PIPE OUTLET TO WELL-DEFINED

TABLE 7-24RECOMMENDED	RIP RAP GRADA	TION RANGES
THICKNESS OF RIP RAP = 1.5	5 FEET	
d50 SiZE= 0.50	FEET 6	INCHES
% OF WEIGHT SMALLER THAN THE GIVEN d50 SIZE	SIZE OF ST FROM	ONE (INCHES)
100%	9	12
85%	8	11
50%	6	9
15%	2	3

- 1. THE SUBGRADE FOR THE GEOTEXTILE FABRIC AND RIP RAP SHALL BE PREPARED TO THE LINES AND GRADES SHOWN ON THE PLANS.
- 2. THE RIP RAP SHALL CONFORM TO THE SPECIFIED GRADATION
- 3. GEOTEXTILE FABRICS SHALL BE PROTECTED FROM PUNCTURE OR TEARING DURING THE PLACEMENT OF THE ROCK RP. DAMAGED AREAS IN THE FABRIC SHALL BE REPAIRED BY PLACING A PECCE OF FABRIC OVER THE DAMAGED AREA OR BY COMPLETE REPLACEMENT OF THE FABRIC. ALL OVERLAPS REQUIRED FOR REPAIRS OR JOINING TWO PIECES OF FABRIC SHALL BE A MINIMUM OF 12 INCHES.
- 4. STONE FOR THE RIP RAP MAY BE PLACED BY EQUIPMENT AND SHALL BE CONSTRUCTED TO THE FULL LAYER THICKNESS IN ONE OPERATION AND IN SUCH A MANNER AS TO PREVENT SEGREGATION OF THE STONE SIZE.
- 5. OUTLETS TO A DEFINED CHANNEL SHALL HAVE 2:1 OR FLATTER SIDE SLOPES AND SHOULD BEGIN AT THE TOP OF THE CULVERT AND TAPER DOWN TO THE CHANNEL BOTTOM THROUGH THE LENGTH OF THE
- 6. MAINTENANCE: THE OUTLET PROTECTION SHOULD BE CHECKED AT LEAST ANNUALLY AND AFTER EVERY MAJOR STORM. IF THE RIP RAP HAS BEEN DISPLACED, UNDERSHED OF ANAMAGE, IT SHOULD BE REPAIRED BANEDIATELY. THE CHANNEL MANEDIATELY BELOW THE OUTLET SHOULD BE CHECKED TO SEE THAT EROSION IS NOT OCCURRING. THE DOWNSTREAM CHANNEL SHOULD BE KEPT CLEAR OF OBSTRUCTIONS SUCH AS FALLEN TREES, DEBRIS, AND SEDIMENT THAT COULD CHANGE FLOW PATTERNS AND/OR TAILWATER DEPTHS ON THE PIPES. REPAIRS MUST BE CARRIED OUT IMMEDIATELY TO AVOID ADDITIONAL DAMAGE TO CUTLET PROTECTION.

RIP RAP OUTLET PROTECTION APRON

NOT TO SCALE

Design: JAC Draft: LAZ Date: 3/3/21
Checked: JAC Scale: AS NOTED Project No.: 20737 Drawing Name: 20737-PLAN.dwg THIS PLAN SHALL NOT BE MODIFIED WITHOUT WRITTEN RMISSION FROM JONES & BEACH ENGINEERS, INC. (JBE). ANY ALTERATIONS, AUTHORIZED OR OTHERWISE, SHALL BE AT THE USER'S SOLE RISK AND WITHOUT LIABILITY TO JBE.

TOP VIEW



APPROXIMATE LIST OF MATERIALS

1. 3 C.Y. — 5000 PSI CONCRETE

2. 15 ANGLE RONS © 4' LENGTH

3. REQUIRED S.S. BOLTS AND FASTENERS

4. 1/4' STEEL PLATE WITH DIRLLED ONFICES

5. 1 C.Y. — GUSHED STONE FOR BASE

REV.	DATE	REVISION	BY
2	1/6/21	MINOR REVISIONS	DJM
3	3/3/21	ADDED SURVEY INFO	LA2
4	3/18/21	ADDED DETAIL	LAZ
5	5/5/21	REVISIONS	LAZ
6	6/22/21	REVISIONS PER TOWN REVIEW	LAZ

-1/2" SLOT FOR 1/4" ORIFICE BE

SIDE VIEW

WET POND 6" 51.00 52.25 52.75 36" 48.00 51.00 47.50 18"

5. ALL EXPOSED REBAR TO BE PAINTED WITH RUST-RESISTANT PAINT, COLOR AT CONTRACTOR'S DISCRETION.

8. TO BE SUPPLIED BY CAPITAL CONCRETE PRODUCTS OF HENRIKER, N.H., (1-803-428-3218) OR EQUAL.

7. STRUCTURE: TO HAVE TEMPORARY PLYMOOD INSTALLED IN THE ORIFICE PLATE SLOT UNTIL THE SITE IS STABLED.

8. STRUCTURE IS TO BE DESIGNED FOR H20 LOADING.
9. SOIL UNDERLYING THE STRUCTURE IS TO BE COMPACTED TO 95% MODIFIED PROCTOR


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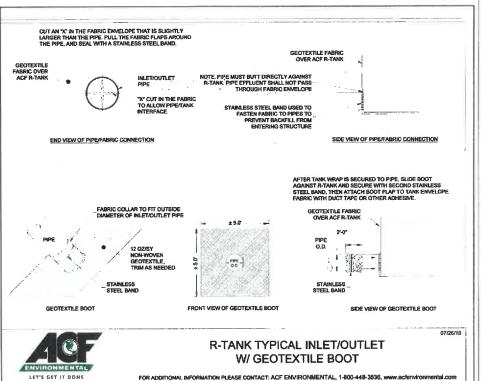
(A) (B) (C) (D) (C) (B) (O)


Designed and Produced in NH Jones & Beach Engineers, Inc. 85 Portsmouth Ave. Civil Engineering Services


Plan Name:	DETAIL SHEET
Project:	3400 LAFAYETTE ROAD PORTSMOUTH, NH
Owner of Record: 225 B	RICCI CONSTRUCTION CO., INC. ANFIELD ROAD, PORTSMOUTH, NH 03801 BK 1930 PG 0229

DRAWING No. SHEET 20 OF 25



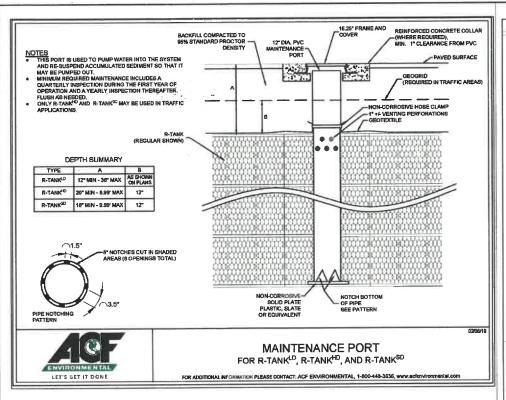

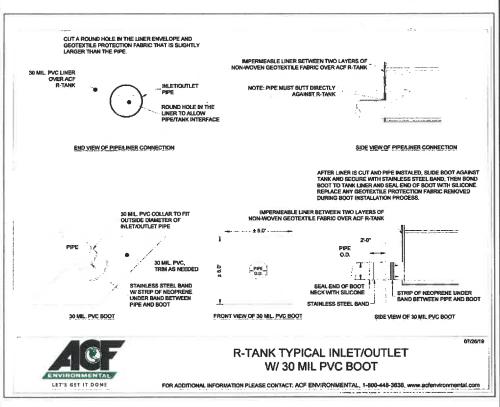

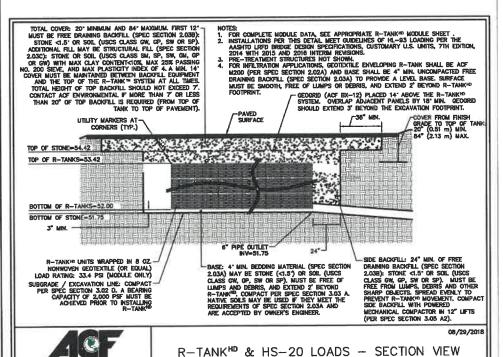

2.02 GEOSYNTHETICS

A. GEOTEXTILE. A GEOTEXTILE ENVELOPE IS REQUIRED TO PREVENT BACKFILL,

A GEOTEXTILE A GEOTEXTILE EVALUATE IS REQUIRED TO PREVENT BACKFLIC MATERIAL FROM ENTERING THE R-TANK MODULES.
STANDARD APPLICATION: THE STANDARD GEOTEXTILE SHALL BE AN 8.07.
PER SQUARE YARD NONNOVEN GEOTEXTILE (ACF NOBO OR EQUIVALENT).
NEI TRATION APPLICATIONS: WHEN WATER MIST INFILTRATIC FLOTILITATE HEROLD HER CEDITEXTILE AS A FUNCTION OF THE SYSTEM DESIGN, A WOVEN MONORFLAMENT (ACF M200 OR EQUIVALENT) SHALL BE USED.

B. GEOGRID. FOR INSTALLATIONS SUBJECT TO TRAFFIC LOADS AND/OR WHEN REQUIRED BY PROJECT PLANS, INSTALL GEOGRID (ACF BM12 OR EQUIVALENT) TO REINFORCE BACKFILL ABOVE THE R-TANK SYSTEM. GEOGRID IS NOT ALWAYS REQUIRED FOR R-TANKUD INSTALLATIONS, AND

2.03 BACKFILL & COVER MATERIALS

A BEDDING MATERIALS: STORE (ANGULAR AND SMALLER THAN 1.5' IN DIAMETER) OR SOIL (GW, GP, SW, OR SP AS CLASSIFIED BY THE UNIFIED SOIL CLASSIFICATION SYSTEM) SHALL BE USED BELOW THE R-TANK SYSTEM (3" MINIMUM). MATERIAL MUST BE FREE FROM LUMPS, DEBRIS, AND ANY SHARP OBJECTS THAT COULD GUT THE GEOTEXTILE, MATERIAL SHALL BE WITHIN 3 PERCENT OF THE OPTIMUM MOISTURE CONTENT AS DETERMINED BY ASTM D698 AT THE TIME OF INSTALLATION. FOR INFILTRATION APPLICATIONS BEDOING MATERIAL SHALL BE FREE DRAINING. A 1' TO 2' LAYER OF UNSUITABLE MATERIAL OCCURS 3' TO 8' BELOW EXISTING GRADE WITHIN THE R-TANK SYSTEM FOOTPRINT. THIS MATERIAL IS TO BE REMOVED AND REPLACED WITHIN THE R-TANK SYSTEM FOOTPRINT WITH STONE (ANGULAR AND SMALLER THAN 1.5" IN DIAMETER) OR SOIL (GW. GP. SW. OR SP AS CLASSIFIED BY THE UNIFIED SOIL CLASSIFICATION SYSTEM). A BED BOTTOM INSPECTION SHALL BE PERFORMED BY TRUSLOW RESOURCE CONSULTING PRIOR TO CONSTRUCTION OF THE R-TANK SYSTEM.

AND ANY SHARP OBJECTS THAT COULD CUT THE GEOTEXTILE MATERIAL 204 OTHER MATERIALS SHALL BE WITHIN 3 PERCENT OF THE CPTHAIM MOISTURE CONTENT AS A UTILITY MARKER: DETERMINED BY ASTM D698 AT THE TIME OF INSTALLATION.

SYSTEM TO MARK T

Stratham, NH 03885


IRAFFIC APPLICATIONS — FREE DRAWING MATERIAL SHALL BE USED ADJACENT TO (24" MINIBULM) AND ABOVE (FOR THE FIRST 12") THE DRAWING TO (25")

G. FOR HD, AND SD MODULES, BACKFILL MATERIALS SHALL BE FREE DRAINING STONE (ANGULAR AND SMALLER THAN 1.5' IN DIAMETER) OR SOIL (GW, GP, SW, OR SP AS CLASSIFIED BY THE UNIFIED SOIL CLASSIFICATION SYSTEM'L

b. FOR UD MODULES WITH LESS THAN 14' OF TOP COVER, BACKFILL MATERIALS SHALL BE FREE DRAINING STONE (ANGULAR AND SMALLER THAN 1.5" IN DIAMETER). THE USE OF SOIL BACKFILL ON THE SIDES AND TOP OF THE UD MODULE IS NOT PERMITTED UNLESS THE MODULES ARE INSTALLED OUTSIDE OF TRAFFIC AREAS OR WITH COVER DEPTHS OF 14° OR MORE, TOP BACKFILL MATERIAL (FROM TOP OF MODULE TO BOTTOM OF PAVEMENT BASE OR 12' MAXIMUM) MUST BE CONSISTENT WITH SIDE

NON-TRAFFIC / GREEN SPACE APPLICATIONS - FOR ALL R-TANK
MODULES INSTALLED IN GREEN SPACES AND NOT SUBJECTED TO
VEHICULAR LOADS, BACKFILL MATERIALS MAY ETHIER FOLLOW THE
GUIDELINES FOR TRAFFIC APPLICATIONS ABOVE, OR THE TOP BACKFILL
LAYER (12" MINIMUM) MAY CONSIST OF AASHTO #57 STONE BLENDED WITH
30-40X (8"Y VOLUME) TOPOSOL TO AND IN ESTABLISHING VECETATION
C. ADDITIONAL COVER MATERIALS: STRUCTURAL FILL SHALL CONSIST OF GRANULAR MATERIALS MEETING THE GRADATIONAL REQUIREMENTS OF SM. SP, SW, GM, GP OR GW AS CLASSIFIED BY THE UNIFIED SOIL CLASSIFICATION SYSTEM. STRUCTURAL FILL SHALL HAVE A MAXIMUM OF 25 PERCENT PASSING THE NO. 200 SIEVE, SHALL HAVE A MAXIMUM CLAY CONTENT OF 10 PERCENT AND A MAXIMUM PLASTICITY INDEX OF 4. MATERIAL SHALL BE WITHIN 3 PERCENT OF THE OPTIMUM MOISTURE CONTENT AS DETERMINED BY ASTM D698 AT THE TIME OF INSTALLATION.

A UTILITY MARGER: INSTALL METALLIC TAPE AT CORNERS OF R-TANK SYSTEM TO MARK THE AREA FOR FUTURE UTILITY DETECTION.

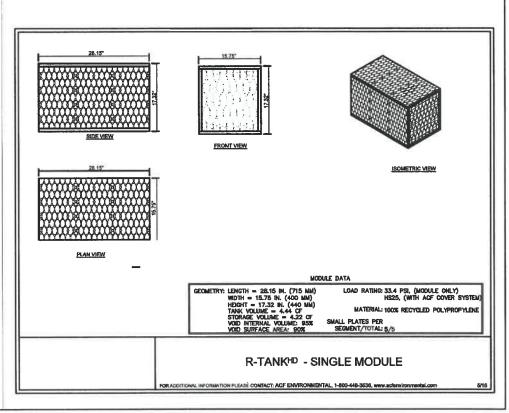

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Checked: JAC	Scale: AS NOTE	Project No.: 20737
Drawing Name:	20737-PLAN.dwg	
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LET'S GET IT DONI



FOR AUDITIONAL INFORMATION PLEASE CONTACT: ACF ENVIRONMENTAL, 1-800-448-3836, WWW.ACFERVERONMENTAL.COM


REV.	DATE	REVISION	BY
2	1/8/21	MINOR REVISIONS	DJW
3	3/3/21	ADDED SURVEY INFO	LAZ
4	3/18/21	ADDED DETAIL	LAZ
5	5/5/21	REVISIONS	LAZ
6	6/22/21	REVISIONS PER TOWN REVIEW	LAZ





E-MAIL: JBE@JONESANDBEACH.COM

Plan Name:	DETAIL SHEET
Project:	3400 LAFAYETTE ROAD PORTSMOUTH, NH
Owner of Record: 225 B	RICCI CONSTRUCTION CO., INC. ANFIELD ROAD, PORTSMOUTH, NH 03801 BK 1930 PG 0229

DRAWING No. **D4**

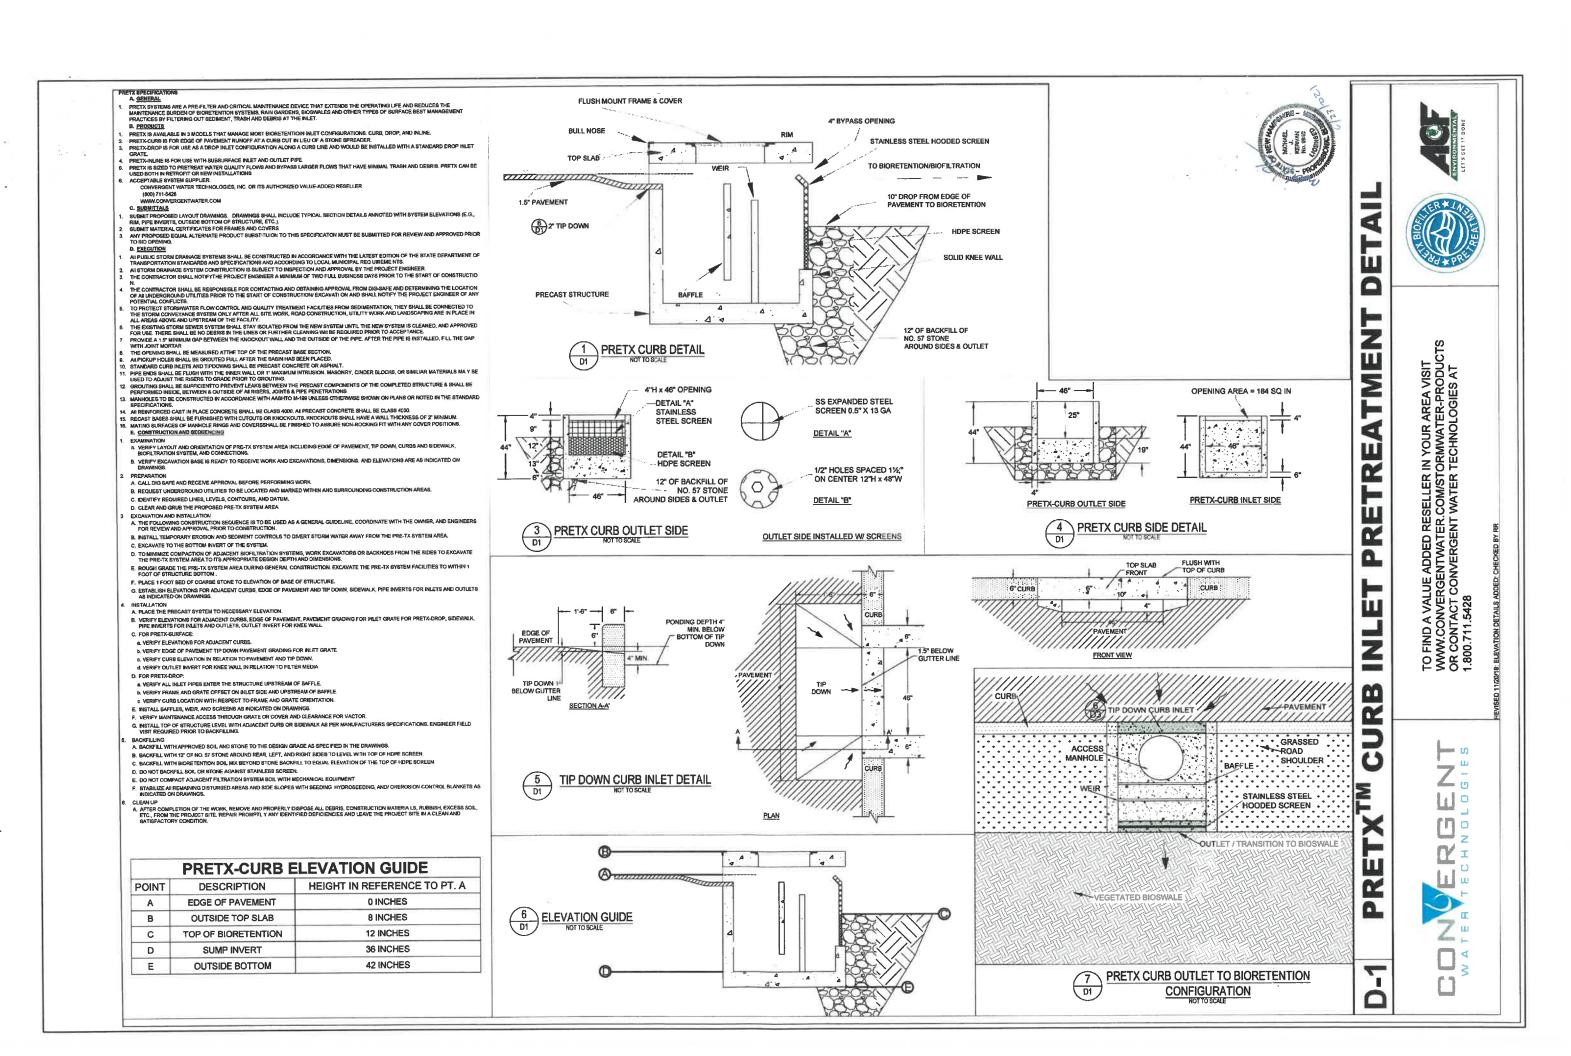

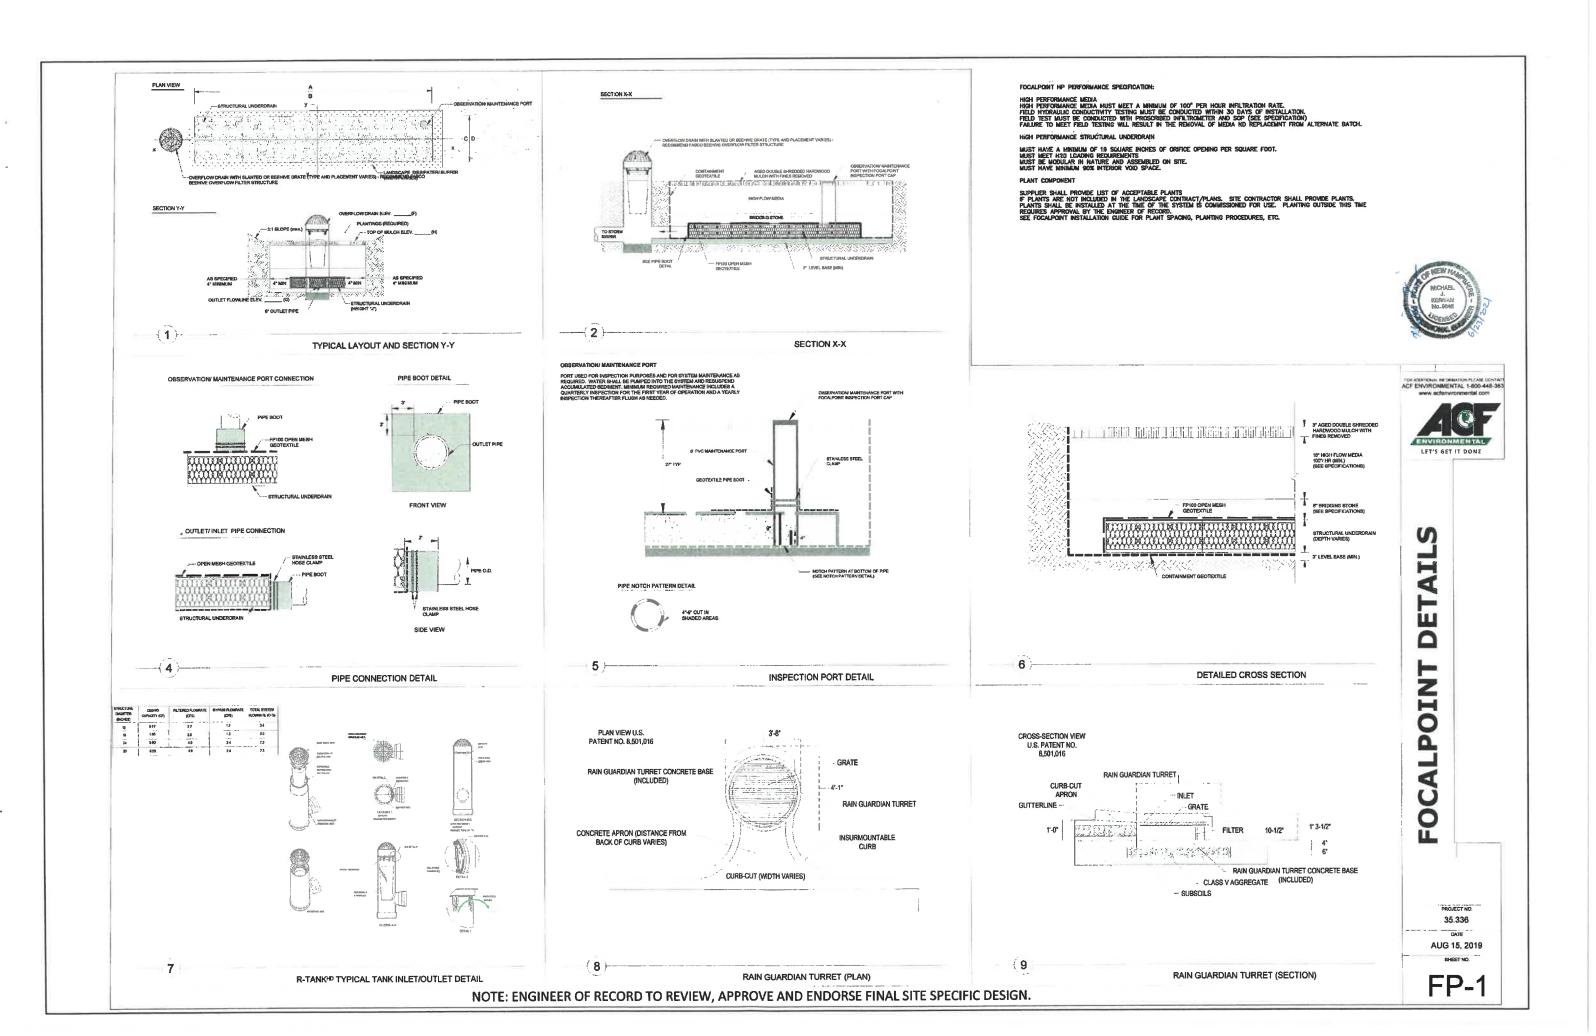

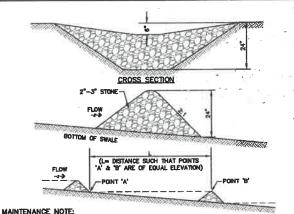


1. STONE CHECK DAMS SHOULD BE CHECKED AFTER EACH RAINFALL AND AT LEAST DAILY DURING PROLONGED RAINFALL. ANY INCRESSARY REPAIRS SHOULD BE MADE IMMEDIATELY. PARTICULAR ATTENTION SHOULD BE GIVEN TO END THE DRING HOUSE FOR CHECKEN HEN THE STRUCTURES ARE REMOVED, THE DISTURBED PORTION SHOULD BE BROUGHT TO THE ESTRING CHANNEL GRADE AND THE AREAS PREPARED, SEEDED AND MULCHED. WHILE THIS PRACTICE IS NOT INTERDED TO BE USED PRIMARLY FOR SEDIMENT TRAPPING, SOME SEDIMENT WILL ACCUMULATE BEHIND THE STRUCTURES. SEDIMENT SHALL BE REMOVED FROM BEHIND THE STRUCTURES WHEN IT HAS ACCUMULATED TO CHE HALF OF THE ORIGINAL HEIGHT OF THE STRUCTURE.

STONE CHECK DAM

NOT TO SCALE

NOT TO SCALE

SILT FENCE

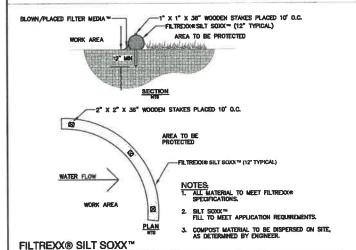

- TEMPORARY EROSION CONTROL NOTES

 1. THE SMALLEST PRACTICAL AREA OF LAND SHALL BE EXPOSED AT ANY ONE TIME. AT NO TIME SHALL AN AREA IN EXCESS OF 5 AGRES BE EXPOSED AT ANY ONE TIME BEFORE DISTURBED AREAS ARE STABILIZED.
- EROSION, SEDIMENT AND DETENTION MEASURES SHALL BE INSTALLED AS SHOWN ON THE PLANS AND AT LOCATIONS AS REQUIRED, DIRECTED BY THE ENGINEER.
- ALL DISTURBED AREAS (INCLUDING POND AREAS BELOW THE PROPOSED WATERLINE) SHALL BE RETURNED TO PROPOSED GRADES AND ELEVATIONS. DISTURBED AREAS SHALL BE LOAMED WITH A MINBIUM OF 6" OF SCREENED CREANIC LOAM AND SEEDED WITH SEED MIXTURE "C" AT A RATE NOT LESS THAN 1.10 POUNDS OF SEED PER 1000 SE OF ABEA (AM BIS / AUSP).
- SILT FENCES AND OTHER BARRIERS SHALL BE INSPECTED EVERY SEVEN CALENDAR DAYS AND WITHIN 24 HOURS OF A RANFALL OF 0.5° OR GREATER, ALL DAMAGED AREAS SHALL BE REPAIRED, AND SEDIMENT DEPOSITS SHALL PERIODICALLY BE REMOVED AND DISPOSED OF.
- AFTER ALL DISTURBED AREAS HAVE BEEN STABILIZED, THE TEMPORARY EROSION CONTROL MEASURES SHALL BE REMOVED AND THE AREA DISTURBED BY THE REMOVAL SMOOTHED AND RE-VEGETATED.
- AREAS MUST BE SEEDED AND MULCHED OR OTHERWISE PERMANENTLY STABILIZED WITHIN 3 DAYS OF FINAL GRADING, OR TEMPORARILY STABILIZED WITHIN 14 DAYS OF THE INITIAL DISTURBANCE OF SOIL, ALL AREAS SHALL BE STABILIZED WITHIN 14 DAYS OF WITHIN LOSTURBANCE.
- ALL PROPOSED VEGETATED AREAS THAT DO NOT EXHIBIT A MINIMUM OF 85 PERCENT VEGETATIVE GROWTH BY OCTOBER 15, OR WHICH ARE DISTURBED AFTER OCTOBER 15, SHALL BE STABILIZED BY SEEDING AND INSTALLING NORTH AMERICAN GREEN 575 EROSION CONTROL BLANGETS (OR AN EQUIVALENT APPROVED IN WRITING BY THE ENGINEER) ON SLOPES GREATER THAN 3-1, AND SEEDING AND PLACING 3 TO 4 TONS OF MILCH PER ACRE. SECURED WITH AMCHORED NETHING, ELSEWHERE. THE WISTALLATION OF EROSION CONTROL BLANGETS OR MULCH AND NETWING SHALL NOT OCCUR OVER ACCUMULATED SHOW OR ON PROZEN GROUND AND SHALL BE COMPLETED IN ADVANCE OF THAN OR SPRING MELT EVENTS.
- ALL DITCHES OR SWALES WHICH DO NOT EXHIBIT A MINIMUM OF 85 PERCENT VEGETATIVE GROWTH BY OCTOBER 15, OR WHICH ARE DISTURBED AFTER OCTOBER 15, SHALL BE STABILZED TEMPORABILY WITH STONE OR ERGISON CONTROL BLANKETS APPROPRIATE FOR THE DESIGN FLOW CONDITIONS.
- AFTER OCTOBER 15th, INCOMPLETE ROAD OR PARKING SURFACES, WHERE WORK HAS STOPPED FOR THE WINTER SEASON, SHALL BE PROTECTED WITH A MINIMUM OF 3" OF CRUSHED GRAVEL PER NIHDOT ITEM 304.3.
- - C. A MINIMUM OF 3" OF NON-EROSIVE MATERIAL SUCH STONE OR RIPRAP HAS BEEN INSTALLED; OR
 - d. EROSION CONTROL BLANKETS HAVE BEEN PROPERLY INSTALLED.
- FUGITIVE DUST CONTROL IS REQUIRED TO BE CONTROLLED IN ACCORDANCE WITH ENV-A 1000, AND THE PROJECT IS TO MEET THE REQUIREMENTS AND INTENT OF RSA 430:53 AND AGR 3800 RELATIVE TO INVASIVE SPECIES.

- 14. IN ORDER TO ENSURE THE STABILITY OF THE SITE AND EFFECTIVE IMPLEMENTATION OF THE SEDIMENT AN EROSION CONTROL MEASURES SPECIFIED IN THE PLANS FOR THE DURATION OF CONSTRUCTION, THE CONT SHALL BE IN STRICT COMPLIANCE WITH THE FOLLOWING INSPECTION AND MAINTENANCE REQUIREMENTS IN ADDITION TO THOSE CALLED FOR IN THE SWPPP:
 - a. A CERTIFIED PROFESSIONAL IN EROSION AND SEDIMENT CONTROL OR A PROFESSIONAL ENGINEER LICENSED IN THE STATE OF NEW HAMPSHIPE ("MONITOR") SHALL BE EMPLOYED TO INSPECT THE SITE FROM THE START OF ALTERATION OF TEBRAIN ACTIVITIES UNTIL THE SITE IS IN FULL COMPILANCE WITH THE SITE SPECIFIC PERMIT ("PERMIT").
 - b. DURING THIS PERIOD, THE MONITOR SHALL INSPECT THE SUBJECT SITE AT LEAST ONCE A WEEK, AND IF POSSIBLE, DURING ANY 1/2 INCH OR GREATER RAIN EVENT (I.E. 1/2 INCH OF PRECIPITATION OR MORE WITHIN A 24 HOUR PERIOD). IF UNABLE TO BE PRESENT DURING SUCH A STORM, THE MONITOR SHALL INSPECT THE SITE WITHIN 24 HOURS OF THIS EVENT.
 - c. THE MONTOR SHALL PROVIDE TECHNICAL ASSISTANCE AND RECOMMENDATIONS TO THE CONTRACTOR ON THE APPROPRIATE BEST MANAGEMENT PRACTICES FOR ENOSIGN AND SEDMENT CONTROLS REQUIRED TO MEET THE REQUIREMENTS OF RSA 488 A17 AND ALL APPLICABLE DES PERMIT CONTROLS.
 - d. WITHIN 24 HOURS OF EACH INSPECTION, THE MONITOR SHALL SUBMIT A REPORT TO DES VIA EMAIL. (RIDGELY MAUCK AT: RIDGELY.MAUCK@DES.NH.GOV).

CONTOUR LINES 600' RECOMMENDED MAXIMUM

THE MONITOR SHALL MEET WITH DES TO DECIDE UPON A REPORT FORMAT. THE REPORT FORMAT SHALL BE REVIEWED AND APPROVED BY DES PRIOR TO THE START OF CONSTRUCTION.

SEEDING SPECIFICATIONS

- GRADING AND SHAPING
 A. SLOPES SHALL NOT BE STEEPER THAN 2:1 WITHOUT APPROPRIATE EROSION CONTROL MEASURES AS SPECIFIED ON THE PLANS (3:1 SLOPES OR FLATTER ARE PREFERRED).

 8. WHERE MOMING WILL BE DONE, 3:1 SLOPES OR FLATTER ARE RECOMMENDED.

- 2. SECURED, PREPARATION.

 A. SURFACE AND SEEPAGE WATER SHOULD BE DRAINED OR DIVERTED FROM THE SITE TO PREVENT DROWNING OR WINTER KILLING OF THE PLANTS.

 B. STONES LARGER THAN 4 INCHES AND TRASH SHOULD BE REMOVED BECAUSE THEY INTERFERE WITH SEEDING AND FUTURE MAINTENANCE OF THE AREA. WHERE FEASIBLE, THE SOL SHOULD BE TILLED TO A DEPTH OF ABOUT 4 INCHES TO PREPARE A SEEDIED AND FERTILEER AND LINE MINED INTO THE SOIL THE SEEDIED SHOULD BE LIETT IN A REASONABLY FROM AND SHOULD BE PERFORMED ACROSS THE SLOPE WHEREVER PRACTICAL.

- 3. ESTABLISHING A STAND.

 A. LIME AND FERTILIZER SHOULD BE APPLIED PRIOR TO OR AT THE TIME OF SEEDING AND INCORPORATED INTO THE SOIL TYPES AND AMOUNTS OF LIME AND FERTILIZER SHOULD BE BASED ON AN EVALUATION OF SOIL TESTS. WHEN A SOIL TEST IS NOT AVAILABLE, THE FOLLOWING MINIMUM AMOUNTS SHOULD BE
 - APPLILIA AGRICULTURAL LIMESTONE, 2 TONS PER ACRE OR 100 LBS. PER 1,000 SQ.FT. NITROGEN(N), 50 LBS. PER ACRE OR 1.1 LBS. PER 1,000 SQ.FT. PHOSPHATE(P205), 100 LBS. PER ACRE OR 2.2 LBS. PER 1,000 SQ.FT. POTASH(K20), 100 LBS. PER ACRE OR 2.2 LBS. PER 1,000 SQ.FT.
 - (NOTE: THIS IS THE EQUIVALENT OF 500 LBS. PER ACRE OF 10-20-20 FERTILIZER OR 1,000 LBS. PER
 - SEED SHOULD BE SPREAD UNIFORMLY BY THE METHOD MOST APPROPRIATE FOR THE SITE. METHODS INCLUDE BROADCASTING, DRILLING AND HYDROSEEDING. WHERE BROADCASTING IS USED, COVER SEED WITH .25 INCH OF SOIL OR LESS, BY CULTIPACKING OR RAKING.

 - .25 INCH OF SOIL OR LESS, BY CULTIPACKING RAYERS.

 REFER TO THE "SEEDING GUIDE" AND "SEEDING RAYERS." TABLES ON THIS SHEET FOR APPROPRIATE SEED MIXTURES AND RATES OF SEEDING. ALL LEGUMES (CROMINISTOR), BIRDSFOOT, TREFOIL AND FLATPEA) MUST BE INCOLARATED WITH THEIR SPECIFIC INCOLLANT PROPR TO THEIR MITRODUCTION TO THE SITE.

 WHEN SEEDED AREAS ARE MILCHED, PLANTINGS MAY BE MADE FROM EARLY SPRING TO EARLY OCTOBER.
 WHEN SEEDED AREAS ARE NOT MILCHED, PLANTINGS SHOULD BE MADE FROM EARLY SPRING TO MAY 20th OR FROM AUGUST 10th TO SEPTEMBER 1st.

4. MULCH
A. HAY, STRAW, OR OTHER MULCH, WHEN NEEDED, SHOULD BE APPLIED IMMEDIATELY AFTER SEEDING.
B. MULCH WILL BE HELD IN PLACE USING APPROPRIATE TECHNIQUES FROM THE BEST MANAGEMENT PRACTICE
FOR MULCHING. HAY OR STRAW MULCH SHALL BE PLACED AT A RATE OF 90 LBS PER 1000 S.F.

- MAINTENANCE TO ESTABLISH A STAND
 A. PLANTED AREAS SHOULD BE PROTECTED FROM DAMAGE BY FIRE, GRAZING, TRAFFIC, AND DEINSE WEED
- GROWTH.

 B. FERTILIZATION NEEDS SHOULD BE DETERMINED BY ONSITE INSPECTIONS. SUPPLEMENTAL FERTILIZER IS USUALLY THE NEY TO FULLY COMPLETE THE ESTABLISHMENT OF THE STAND BECAUSE MOST PERENNALS TAKE 2 TO 3 YEARS TO BECOME FULLY ESTABLISHED.

 C. BI WATERWAYS, CHAMPALS, OR SHAMES WHERE UNFOOM FLOW CONDITIONS ARE ANTICIPATED, ANNUAL MOWING MAY BE NECESSARY TO CONTROL GROWTH OF WOODLY VEGETATION.

USE	SEEDING MIXTURE 1/	DROUGHTY	WELL DRAINED	MODERATELY WELL DRAINED	POORLY DRAINED
STEEP CUTS AND FILLS, BORROW AND DISPOSAL AREAS	A B C	FAIR POOR POOR	GOOD GOOD	GOOD FAIR EXCELLENT	FAIR FAIR GOOD
ALC-10	D	FAIR	EXCELLENT	EXCELLENT	POOR
WATERWAYS, EMERGENC SPILLWAYS, AND OTHER CHANNELS WITH FLOWING WATER	Y Å	G00D	GOOD EXCELLENT	EXCELLENT GOOD	FAIR FAIR
LIGHTLY USED PARKING LOTS, ODD AREAS, UNUSED LANDS, AND LOW INTENSITY USE RECREATION SITES.	A B C	G000 G000 G000	GOOD EXCELLENT	GOOD FAIR EXCELLENT	FAIR POOR FAIR
PLAY AREAS AND ATHLETIC FIELDS. (TOPSOIL IS ESSENTIAL FOR GOOD TURF.)	E F	FAIR FAIR	EXCELLENT	EXCELLENT	2/ 2/

GRAVEL PIT, SEE NH-PM-24 IN APPENDIX FOR RECOMMENDATION REGARDING RECLAMATION OF SAND AND GRAVEL PITS.


 $1/\!\!/$ refer to seeding mixtures and rates in table below. NOTE: TEMPORARY SEED MIX FOR STABILIZATION OF TURF SHALL BE WINTER RYE OR OATS AT A RATE OF 2.5 LBS, PER 100 S.F. AND SHALL BE PLACED PRIOR TO OCTOBER 15th, IF PERMANENT SEEDING NOT YET COMPLET.

SEEDING GUIDE

MIXTURE.	POUNDS PER ACRE	POUNDS 1.000 So
A. TALL FESCUE	20	0.45
CREEPING RED FESCUE	20	0.45
RED TOP TOTAL	42	0.05
		0.35
B. TALL FESCUE CREEPING RED FESCUE	15 10	0.35
CROWN VETCH	15	0.35
FLAT PEA	30	0.75
TOTAL	40 OR 55	0.95 OR 1.
C. TALL FESCUE	20	0.45
CREEPING RED FESCUE	20	0.45
BIRDS FOOT TREFOIL TOTAL	48	0.20 1.10
P. T 5704.5		0.45
D. TALL FESCUE FLAT PEA	20	0.45
TOTAL	20 30 50	1.20
E. CREEPING RED FESCUE 1/	50	1.15
KENTUCKY BLUEGRASS 17	50	1.15
TOTAL	100	2.30
F. TALL FESCUE 1	150	3.60
1/ FOR HEAVY USE ATHLETIC FIEL NEW HAMPSHIRE COOPERATIVE EX CURRENT VARIETIES AND SEEDING	TENSION TURF SPI	

SEEDING RATES

E-MAIL: JBE@JONESANDBEACH.COM

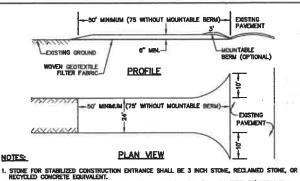

- WOULD APPLY.

 3. THICKNESS OF THE STORME FOR THE STABILIZED ENTRANCE SHALL NOT BE LESS THAN 8 MICHES.

 4. THE WOTH OF THE ENTRANCE SHALL NOT BE LESS THAN THE FULL WOTH OF THE ENTRANCE WHERE MORRESS OF ENTERS COCURS, OR 10 FEET, WHICHEVER IS GREATER.

 5. GEOTEXTILE FILTER FABRIC SHALL BE PLACED OVER THE ENTRE AREA PRIOR TO PLACING THE STONE. FILTER FARRE IS NOT REQUIRED FOR A SHIGLE FRANKLY RESIDENTIAL LOT.

 6. ALL SURFACE WATER THAT IS FLOWING TO OR DIVERTED TOWARD THE CONSTRUCTION ENTRANCE SHALL BE PIPED BEHATH THE ENTRANCE. IF FINING IS IMPRACTICAL, A STONE BERM WITH 5:1 SLOPES THAT CAN BE CROSSED BY VENCUES MAY BE SUBSTITUTED FOR THE PIPE.

 7. THE ENTRANCE SHALL BE MANTANDED IN A CONDITION THAT WILL PREVENT TRACKING OR FLOWING OF SEDMENT ONTO THE FURLIC ROTH—OF—MAY. THIS MAY REQUIRE PERIODIC TOP DRESSING WITH ADOITIONAL STONE AS CONDITIONS DEMAND AND REPARA AND/OR CLEAN GUT OF ANY MEASURES USED TO THAP SEDMENT, ALL SOMENTS DELLAGON, WASHED, OR TRACKED ONTO THE FUELIC RIGHT—OF—MAY MUST BE REMOVED PROMPTLY.

STABILIZED CONSTRUCTION ENTRANCE

- CONSTRUCTION SEQUENCE

 1. PRIOR TO THE START OF ANY ACTIVITY, IT IS THE RESPONSIBILITY OF THE SITE'S SITE DEVELOPER (OR OWNER) TO FILE A MOTICE OF INTENT (NOT) FORM WITH THE ENVIRONMENTAL PROTECTION AGENCY (EPOCKER TO GAIN COVERAGE UNDER THE IMPLES GENERAL PERMIT FOR STOOM WATER DISCOURCES FROM CONSTRUCTION ACTIVITIES. A PRIC CONSTRUCTION MEETING IS TO BE HELD WITH ALL DEPARTMENT HEAD PRIOR TO THE START OF CONSTRUCTION.
- 2. WETLAND BOUNDARIES ARE TO BE CLEARLY MARKED PRIOR TO THE START OF CONSTRUCTION
- 3. CUT AND REMOVE TREES IN CONSTRUCTION AREA AS REQUIRED OR DIRECTED
- INSTALL SILT FENCING, HAY BALES AND CONSTRUCTION ENTRANCES PRIOR TO THE START OF CONSTRUCTION. THESE ARE TO BE MAINTAINED UNTIL THE FINAL PAVEMENT SURFACING AND LANDSCAPING AREAS ARE ESTABLISHED.
- CLEAR, CUT, GRUB AND DISPOSE OF DEBRIS IN APPROVED FACILITIES. THIS INCLUDES ANY REQUIRED DEMOUTION OF EXISTING STRUCTURES, UTILITIES, ETC.
- CONSTRUCT AND/OR INSTALL TEMPORARY OR PERMANENT SEDIMENT AND/OR DETENTION BASIN(S) AS REQUIRED. THESE FACILITIES SHALL BE INSTALLED AND STABILIZED PRIOR TO DIRECTING RUM-OFF TO THEM.
- STRIP LOAM AND PAVEMENT, OR RECLAIM EQISTING PAVEMENT WITHIN LIMITS OF WORK PER THE RECOMMENDATIONS OF THE PROJECT ENGINEER AND STOCKPILE EXCESS MATERIAL STABILIZE STOCKPILE AS NECESSARY.
- 8. PERFORM PREJIMINARY STE GRADING IN ACCORDANCE WITH THE PLANS, INCLUDING THE CONSTRUCTION OF ANY RETAINING WALLS AND SOUND WALLS.
- INSTALL THE SEWER AND DRAINAGE SYSTEMS FIRST, THEN ANY OTHER UTILITIES IN ACCORDANCE WITH THE PLAN AND DETAILS. ANY CONFLICTS BETWEEN UTILITIES ARE TO BE RESOLVED WITH THE INVOLVEMENT AND
- 10. INSTALL INLET PROTECTION AT ALL CATCH BASINS AS THEY ARE CONSTRUCTED IN ACCORDANCE WITH DETAILS.
- ALL SWALES AND DRAMAGE STRUCTURES ARE TO BE CONSTRUCTED AND STABILIZED PRIOR TO HAVING RUN-OFF DIRECTED TO THEM.
- 12. DAILY, OR AS REQUIRED, CONSTRUCT TEMPORARY BERMS, DRAINAGE DITCHES, CHECK DAMS, SEDIMENT TRAPS, ETC., TO PREVENT EROSION ON THE SITE AND PREVENT ANY SILTATION OF ABUTTING WATERS AND/OR PROPERTY.
- 13. PERFORM FINAL FINE GRADING, INCLUDING PLACEMENT OF "SELECT" SUBGRADE MATERIALS.
- 14. PAVE ALL ROADWAYS WITH INITIAL BASE COURSE.
- 15. PERFORM ALL REMAINING SITE CONSTRUCTION (Le. BUILDING, CURBING, UTILITY CONNECTIONS, ETC.).
- LOAM AND SEED ALL DISTURBED AREAS AND INSTALL ANY REQUIRED SEDIMENT AND EROSION CONTROL FACILITIES (Lo. RIP RAP, EROSION CONTROL BLANKETS, ETC.).
- 17. FINISH PAVING ALL ROADWAYS AND PARKING AREAS WITH "FINISH" COURSE
- 18. ALL ROADWAYS AND PARKING LOTS SHALL BE STABILIZED WITHIN 72 HOURS OF ACHIEVING FINISHED GRADE.
- 19. ALL CUT AND FILL SLOPES SHALL BE SEEDED/LOAMED WITHIN 72 HOURS OF ACHIEVING FRISHED GRADE.
- REMOVE TEMPORARY EROSION CONTROL MEASURES AFTER SEEDING AREAS HAVE BEEN 75%-85%
 ESTABLISHED AND SITE IMPROVEMENTS ARE COMPLETE. SMOOTH AND RE-VEGETATE ALL DISTURBED AREAS.
- 22. CLEAN SITE AND ALL DRAINAGE STRUCTURES, PIPES AND SUMPS OF ALL SILT AND DEBRIS
- 23. INSTALL ALL PAINTED PAVEMENT MARKINGS AND SIGNAGE PER THE PLANS AND DETAILS
- ALL EROSION CONTROLS SHALL BE INSPECTED WEEKLY AND AFTER EVERY HALF-INCH OF RAINFALL
- 25. UPON COMPLETION OF CONSTRUCTION, IT IS THE RESPONSIBILITY OF THE CONTRACTOR TO NOTIFY ANY RELEVANT PERMITTING AGENCIES THAT THE CONSTRUCTION HAS BEEN FINISHED IN A SATISFACTORY MANNER.

MAINTENANCE:

SLT PENCES SHALL BE INSPECTED IMMEDIATELY AFTER EACH RAINFALL AND AT LEAST DAILY DURING PROLONGED RAINFALL. ANY REPAIRS THAT ARE REQUIRED SHALL BE DONE IMMEDIATELY.

FLARE ENDS UPHILL TO PROVIDE TRAPPING CAPABILITY AND SEDIMENT STORAGE AREA

7. SILT FENCES SHALL BE REMOVED WHEN NO LONGER NEEDED AND THE SEDIMENT COLLECTED SHALL BE DISPOSED AS DIRECTED BY THE ENGINEER. THE AREA DISTURBED BY THE REMOVAL SHALL BE SMOOTHED AND REVESTATED.

- IF THE FABRIC ON A SILT FENCE SHOULD DECOMPOSE OR BECOME INEFFECTIVE DURING THE EXPECTED LIFE OF THE FENCE, THE FABRIC SHALL BE REPLACED PROMPTLY.
- SEDIMENT DEPOSITS SHOULD BE INSPECTED AFTER EVERY STORM EVENT. THE DEPOSITS SHOULD BE REMOVED WHEN THEY REACH APPROXIMATELY ONE HALF THE HEIGHT OF THE BARRIER.
- SEDIMENT DEPOSITS THAT ARE REMOVED, OR LEFT IN PLACE AFTER THE FABRIC HAS BEEN REMOVED, SHALL BE GRADED TO CONFORM WITH THE EXISTING TOPOGRAPHY AND VEGETATED.

Design: JAC Draft: LAZ Date: 3/3/21 Checked: JAC Scale: AS NOTED Project No.: 20737 Drawing Name: 20737-PLAN.dwg PERMISSION FROM JONES & BEACH ENGINEERS, INC. (JBE).

8. SILT FENCE SHALL REMAIN IN PLACE FOR 24 MONTHS.

ANY ALTERATIONS, AUTHORIZED OR OTHERWISE, SHALL BE

AT THE USER'S SOLE RISK AND WITHOUT LIABILITY TO JBE.

WOVEN FABRIC FENCE TO BE FASTENED SECURELY TO FENCE POSTS WITH WIRE TES OR STAPLES. FILTER CLOTH SHALL BE FASTENED TO WOVEN WIRE EVERY 2^a AT TOP, AND AND SOTTOM AND EMBEDDED IN THE GROUND A MINIMAM OF a and their covered with soil.

THE FENCE POSTS SHALL BE A MINIMUM OF 48" LONG, SPACED A MAXIMUM 10" APART, AND DRIVEN A
MINIMUM OF 16" INTO THE GROUND.

. MAINTENANCE SHALL BE PERFORMED AS NEEDED AND SEDIMENT REMOVED AND PROPERLY CISPOSED OF WHEN IT IS 8" DEEP OR VISIBLE "BULGES" DEVELOP IN THE SILT FENCE.



REV. DATE		REVISION	BY
2	1/6/21	MINOR REVISIONS	DJM
3	3/3/21	ADDED SURVEY INFO	LAŻ
4	3/18/21	ADDED DETAIL	LAZ
5	5/5/21	REVISIONS	LAZ
6	6/22/21	REVISIONS PER TOWN REVIEW	LAZ

DISTURBED AREA


Designed and Produced in NH Jones & Beach Engineers, Inc. 85 Portsmouth Ave. Civil Engineering Services

Plan Name: EROSION AND SEDIMENT CONTROL DETAILS

Owner of Record. 225 BANFIELD ROAD, PORTSMOUTH, NH 03801 BK 1930 PG 0229

3400 LAFAYETTE ROAD PORTSMOUTH, NH RICCI CONSTRUCTION CO., INC. JBE PROJECT NO. 20737

DRAWING No.

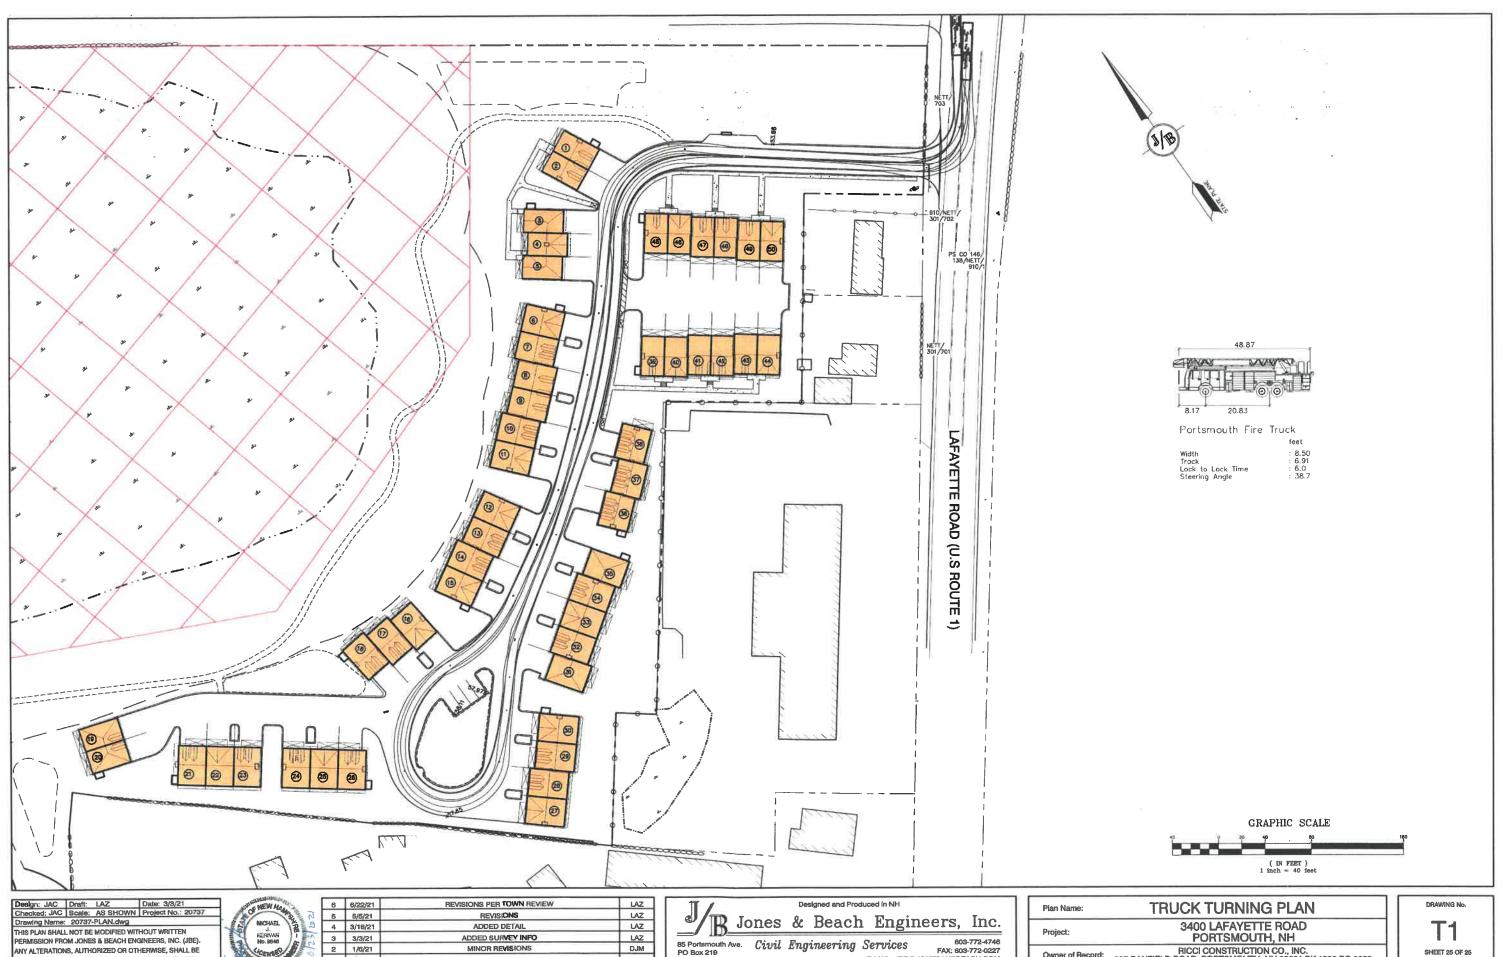

B5 Portsmouth Ave. Civil Engineering Services
PO Box 219
Stretham, NH 03865 E-MAIL: JBE@

Services 603-772-4746 FAX: 803-772-0227 E-MAIL: JBE@JONESANDBEACH.COM

ADDED DETAIL

ADDED SURVEY INFO

MINOR REVISIONS

LAZ


DJM


THIS PLAN SHALL NOT BE MODIFIED WITHOUT WRITTEN PERMISSION FROM JONES & BEACH ENGINEERS, INC. (JBE).

ANY ALTERATIONS, AUTHORIZED OR OTHERWISE, SHALL BE

AT THE USER'S SOLE RISK AND WITHOUT LIABILITY TO JBE.


Owner of Record: RICCI CONSTRUCTION CO., INC. 225 BANFIELD ROAD, PORTSMOUTH, NH 03801 BK 1930 PG 0229

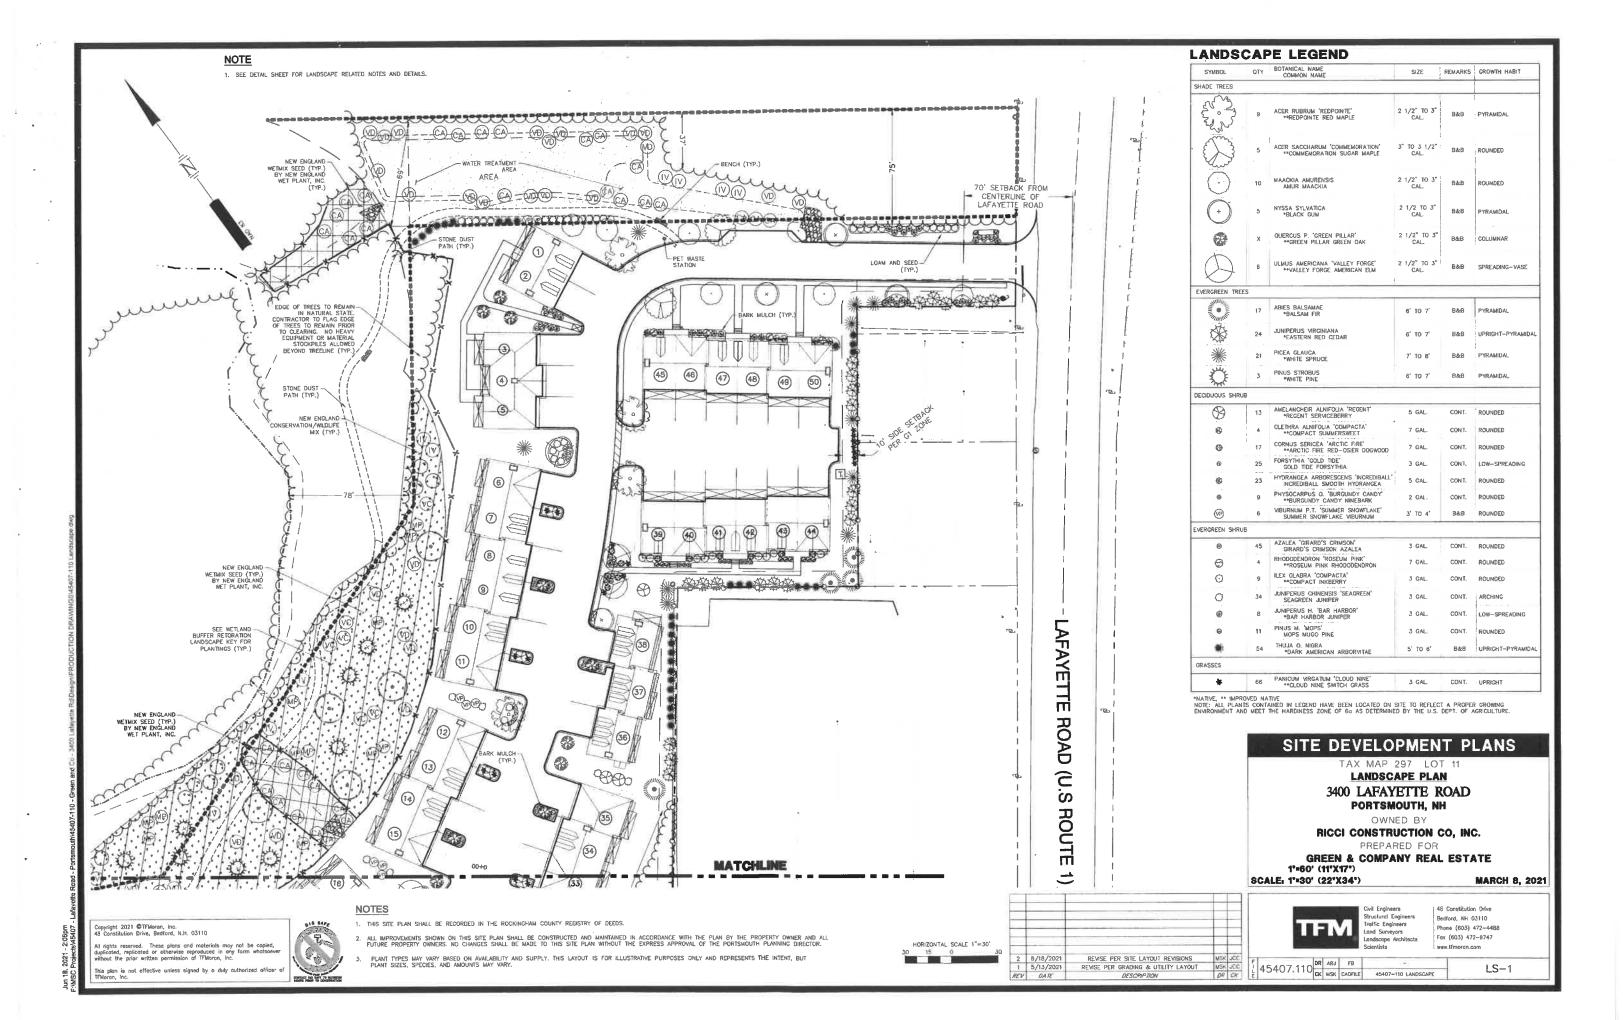

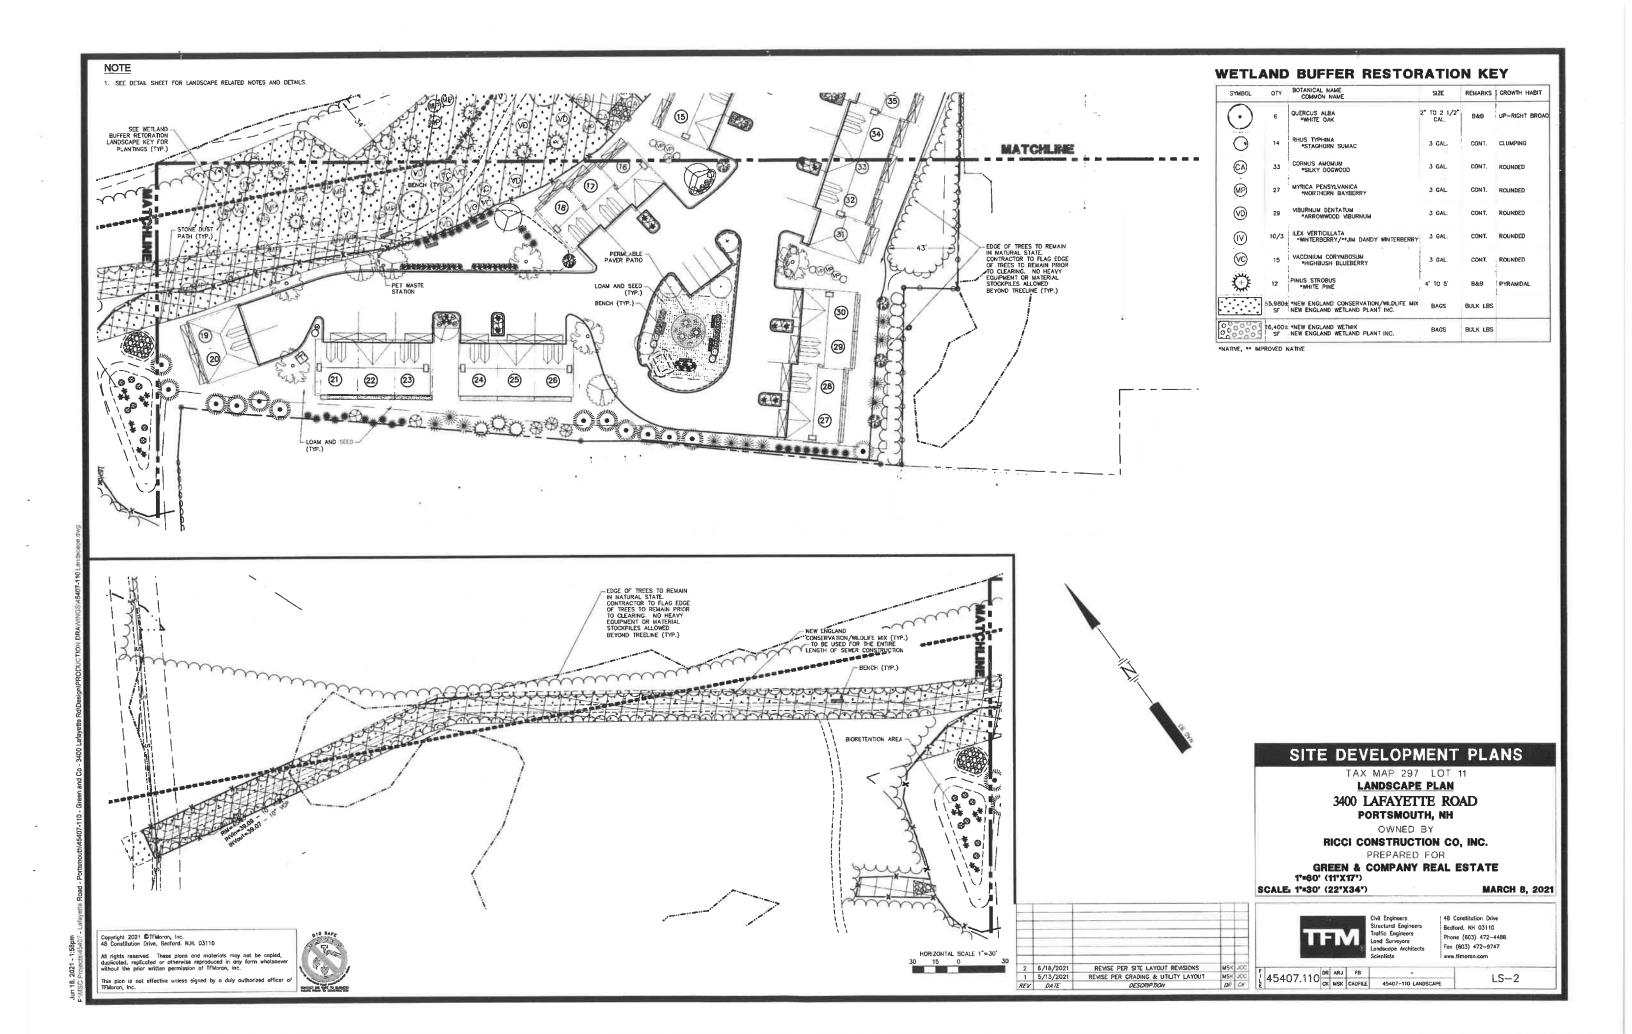

TREE WITH BERM

NOT TO SCALE

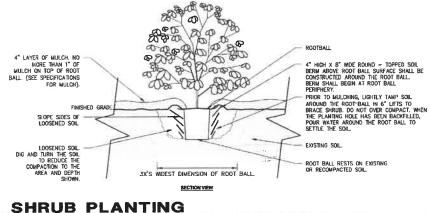

princes application of the street state of the street state of the sta 6" LOAM (ITEM 641) SEED (ITEM 644) — LIMESTONE (ITEM 642) FERTILIZER (ITEM 643.11) MULCH (ITEM 645.111) LOAM & SEED (WHERE SPECIFIED)

2" STONE DUST 5 OZ. WEED FABRIC

COMPACTED SUBGRADE~

STONE DUST PATH

LANDSCAPE NOTES

- CONTRACTOR WILL LOCATE, VERIFY AND MARK ALL EXISTING AND NEWLY INSTALLED UNDERGROUND UTILITIES PRIOR TO ANY LAWAWORK OR PLANTING. ANY CONFLICTS WHICH MIGHT OCCUR BETWEEN PLANTING AND UTILITIES WILL IMMEDIATELY BE REPORTED TO THE LANDSCAPE ARCHITECT OR OWNERS' REPRESENTATIVE, SO THAT ALTERNATE PLANTING LOCATIONS CAN BE DETERMINED.
- CONTRACTOR WILL FURNISH AND PLANT ALL PLANTS IN QUANTITIES AS SHOWN ON THIS PLAN. IN CASES OF DISCREPANCY BETWEEN PLAN AND LIST CLARIFY WITH LANDSCAPE ARCHITECT PRIOR TO PLACING PURCHASE ORDER AND AGAIN PRIOR TO PLANTING.
- 3. SEE PLANTING DETAILS AND IF INCLUDED, SPECIFICATIONS FOR ADDITIONAL INFORMATION.
- 4. NO SUBSTITUTION OF PLANT MATERIALS WILL BE ALLOWED WITHOUT PRIOR WRITTEN APPROVAL OF THE LANDSCAPE ARCHITECT OR OWNER'S REPRESENTATIVE.
- IT IS THE CONTRACTOR'S RESPONSIBILITY TO MAKE THE APPROPRIATE ARRANGEMENTS TO PROVIDE ALL PLANTS AND MATERIALS
 TO ACCOMMODATE PLANTING WITHIN THE TIME ALLOWED BY THE CONSTRUCTION SCHEDULE.
- 7. ALL PLANTS WILL BE NURSERY GROWN.
- PLANTS WILL BE IN ACCORDANCE, AT A MINIMUM, WITH CURRENT EDITION OF "AMERICAN STANDARDS FOR NURSERY STOCK" AS
 PUBLISHED BY THE AMERICAN HORTICULTURE INDUSTRY ASSOCIATION.
- TREES WILL BE PRUNED IN ACCORDANCE WITH THE LATEST EDITION OF ANSI A300 PART 1, "TREE, SHRUB AND OTHER WOODY PLANT MAINTENANCE STANDARD PRACTICES".
- 10. PLANTS MATERIAL IS SUBJECT TO APPROVAL / REJECTION BY THE LANDSCAPE ARCHITECT AT THE SITE AND AT THE NURSERY
- 11. ALL PLANTS WILL BE MOVED WITH ROOT SYSTEMS AS SOLID UNITS AND WITH BALLS OF EARTH FIRMLY WRAPPED WITH BURLAP. NO PLANT WILL BE ACCEPTED WHEN BALL OF EARTH SURROUNDING ITS ROOTS HAS BEEN BADLY CRACKED OR BROKEN BEFORE PLANTING. ALL PLANTS THAT CANNOT BE PLANTIED AT ONCE WILL BE HEELED-HID BY SETTING IN THE GROUND AND COVERING. THE BALLS WITH SOIL AND THEN WATERING. DURING TRANSPORT, ALL PLANT MATERIALS WILL BE WRAPPED WITH WIND PROOF COVERING.
- 12. NEWLY PLANTED MATERIAL WILL BEAR THE SAME RELATIONSHIP TO FINISHED GRADE AS TO THE ORIGINAL GRADE OF THE PLANT PRIOR TO DIGGING.
- 13. MULCH FOR PLANTED AREAS (NOT INCLUDING RAIN CARDENS) WILL BE AGED SHREDDED PINE BARK, PARTIALLY DECOMPOSED DARK BROWN IN COLOR AND FREE OF WOOD CHIPS UNLESS OTHERWISE SHOWN.
- 14. PLANT MATERIAL WILL BE LOCATED OUTSIDE BUILDING DRIPLINES AND ROOF VALLEY POINTS OF CONCENTRATION TO PREVENT DAMAGE TO PLANTS. CLARIFY DISCREPANCIES WITH LANDSCAPE ARCHITECT PRIOR TO INSTALLATION.
- 15. ALL DISTURBED AREAS NOT TO BE PAVED OR OTHERWISE TREATED, WILL RECEIVE SIX (6) INCH LOAM AND SEED AT THE DIRECTION OF THE LANDSCAPE ARCHITECT OR OWNER'S REPRESENTATIVE.
- 16. ALL PLANT GROUPINGS WILL BE IN MULCH BEDS UNLESS OTHERWISE SPECIFIED OR NOTED ON PLANS. WHERE MULCHED PLANT BED ABUTS LAWN, PROVIDE TURF CUT EDGE.
- 17. ALL PLANT BEDS WILL INTERSECT WITH PAVEMENT AT 90 DEGREES UNLESS OTHERWISE NOTED ON PLANS.
- 18. ALL PLANT BED EDGES WILL BE SMOOTH AND CONSISTENT IN LAYOUT OF RADII AND TANGENTS. IRREGULAR, WAVY EDGES WILL NOT BE ACCEPTED.

LANDSCAPE GUARANTEE AND MAINTENANCE NOTES

- 1. CONTRACTOR WILL BE RESPONSIBLE FOR ALL MEANS, METHODS AND TECHNIQUES OF WATERING
- CONTRACTOR WILL BEGIN WATERING IMMEDIATELY AFTER PLANTING, ALL PLANTS WILL BE THOROUGHLY WATERED TWICE DURING THE FIRST 24 HOUR PERIOD AFTER PLANTING, ALL PLANTS WILL BE WATERED WEEKLY, OR MORE OFTEN, IF NECESSARY DURING THE FIRST GROWING SEASON BUT NOT LESS THAN ONE YEAR FROM TIME OF INSTALLATION.
- 3. WATER ALL LAWNS AS REQUIRED. DO NOT LET NEWLY PLANTED LAWNS DRY OUT DURING THE FIRST FOUR WEEKS MINIMUM.
- . ALL NEW LAWNS WILL BE MAINTAINED AND MOWED A MINIMUM THREE (3) TIMES BEFORE REQUESTING REVIEW BY LANDSCAPE ARCHITECT OR OWNER'S REPRESENTATIVE FOR ACCEPTANCE. MAINTENANCE AND MOWING WILL CONTINUE UNTIL ACCEPTED BY LANDSCAPE ARCHITECT OR OWNERS' REPRESENTATIVE IS SSUED IN WRITING.
- 5. THE CONTRACTOR WILL MAINTAIN AND GUARANTEE ALL PLANTINGS TO BE IN GOOD HEALTHY, FLOURISHING AND ACCEPTABLE CONDITION FOR A PERIOD OF ONE (1) YEAR BEGINNING AT THE DATE OF ACCEPTANCE BY THE LANDSCAPE ARCHITECT OR OWNER'S REPRESENTATIVE. ALL GRASSES, TREES AND SHRUBS THAT, IN THE OPINION OF THE LANDSCAPE ARCHITECT OR OWNER'S REPRESENTATIVE SHOWING LESS THAN BOX HEALTHY GROWTH AT THE END OF ONE (1) YEAR PERIOD WILL BE IMMEDIATELY REPLACED BY THE CONTRACTOR.
- 6. DECIDIOUS PLANT MATERIAL INSTALLED AFTER SEPTEMBER 30 AND BEFORE APRIL 15 WILL NOT BE REVIEWED THAT SEASON FOR ACCEPTANCE DUE TO STAGE OF LEAF PHYSIOLOGY, THIS PLANT MARERIAL WILL NOT BE REVIEWED UNITL THE FOLLOWING GROWING SEASON, GUARANTEE PERIOD WILL BEGIN ONLY AFTER ACCEPTANCE BY LANDSCAPE ARCHITECT OR OWNERS' REPRESENTATIVE.
- 7. EVERGREEN PLANT MATERIAL INSTALLED AFTER OCTOBER 30 AND BEFORE APRIL 15 WILL NOT BE REVIEWED THAT SEASON FOR ACCEPTANCE DUE TO END OF GROWIN SEASON. THIS PLANT MATERIAL WILL NOT BE REVIEWED UNTIL THE FOLLOWING GROWING. SEASON. GUARANTEE PERIOD WILL BEGIN ONLY AFTER ACCEPTANCE BY LANDSCAPE ARCHITECT OR OWNERS' REPRESENTATIVE.

INVASIVE PLANT NOTES

EXISTING NON-MATIVE, INVASIVE PLANT SPECIES WILL BE IDENTIFIED, REMOVED, DESTROYED AND LEGALLY DISPOSED OF OFF-SITE
IN ACCORDANCE WITH THE LATEST UNIVERSITY OF NEW HAMPSHIRE COOPERATIVE EXTENSION METHODS OF DISPOSING
NON-MATINE INVASIVE PLANTS. SEE "MANAGE AND CONTROL INVASIVES" AND PROPERTY DISPOSE OF INVASIVE PLANTS.

PORTSMOUTH NOTES

- THE PROPERTY OWNER AND ALL FUTURE PROPERTY OWNER'S WILL BE RESPONSIBLE FOR THE MAINTENANCE OF ALL REQUIRED SCREENING AND LANDSCAPE MATERIALS INDICATED ON THESE PLAN(S).
- 2. ALL REQUIRED PLANT MATERIAL WILL BE TENDED TO AND KEPT FREE OF REFUSE AND DEBRIS.
- 3. ALL REQUIRED FENCES AND WALLS WILL BE MAINTAINED IN GOOD REPAIR.
- THE PROPERTY OWNER WILL BE RESPONSIBLE TO REMOVE AND REPLACE DEAD OR DISEASED PLANT MATERIALS IMMEDIATELY WITH THE SAME TYPE, SIZE AND QUANTITY OF PLANT MATERIALS AS ORIGINALLY INSTALLED, UNLESS ALTERNATIVE PLANTINGS ARE REQUESTED, JUSTIFIED AND APPROVED BY THE PLANNING BOARD OF PLANNING DIRECTOR:
- ALL IMPROVEMENTS SHOWN ON THIS PLAN WILL BE CONSTRUCTED AND MAINTAINED IN ACCORDANCE WITH THIS PLAN BY THE PROPERTY OWNER AND ALL FUTURE PROPERTY OWNERS. NO CHANGES WILL BE MADE TO THIS PLAN WITHOUT THE WRITTEN APPROVAL OF THE PORTISMOUTH PLANINING BOARD OR PLANINING DIRECTOR.
- 6. THE LANDSCAPE PLAN WILL BE RECORDED IN THE ROCKINGHAM COUNTY REGISTRY OF DEEDS

SEEDING NOTES

- SLOPES UP TO AND INCLUDING 3:1 GRADE, SEED WILL BE NEW ENGLAND EROSION CONTROL & RESTORATION MIX PER NEW ENGLAND WETLANDS PLANTS INC., AMHERST, MA.
- SLOPES STEEPER THAN 3:1 GRADE, SEED WILL BE NEW ENGLAND EROSION CONTROL & RESTORATION MIX PER NEW ENGLAND WETLANDS PLANTS INC., AMHERST, MA. SEE CIVIL FOR ADDITIONAL EROSION CONTROL MEASURES.
- 3. GENERAL SEED WILL BE NHDOT SPECIFICATION SECTION 644, TABLE 644-1-PARK SEED TYPE 15, INCLUDING NOTES TO TABLE 1.2 & 3.

SITE DEVELOPMENT PLANS

TAX MAP 297 LOT 11

LANDSCAPE DETAIL SHEET 3400 LAFAYETTE ROAD PORTSMOUTH, NH

OWNED BY

RICCI CONSTRUCTION CO, INC. PREPARED FOR GREEN & COMPANY REAL ESTATE

SCALE NOT TO SCALE

MARCH 8, 2021



NO REVISIONS THIS SHEET

Traffic Engineers
Land Surveyors

Bedford, NH 03110 Phone (603) 472-4488 ox (603) 472-9747

E 45407.110 DR ARJ FB - CK MSK CADFILE 45407-110 LANDSCAPE

LS-3

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NOT TO SCALE

5'-0" FINISHED GRADE

NOT TO SCALE

PERMEABLE PAVER DETAIL

NOT TO SCALE

ISOMETRIC VIEW

Sale of KIRBYBUILT of an 222 STATE ST. BATAVIA, IL 60510 TOLL FREE: 1-855-888-7461 PHONE: (855) 888-7461 FAX: (630) 979-8687 [] CEDAR [] BLACK ☐ GREEN ☐ BROWN ☐ DESERT TAN ☐ GRAY SELECY DESIRED MOUNT: SURFACE □ IN-GROUND

SIDE VIEW

FRONT VIEW

NOTES.

1 ALL MATERIAL RECYCLED HOPE
2 ALL HARDWARE STANKESS STEEL
3. SHPYED PARTIALLY ASSEMBLED
4 INSTALLATION TO BE COMPLETED IN ACCORDANCE WITH MANUSACTURER'S SPECIFICATIONS.
5 DO NOT SCALE DRAWING.
6 THIS DRAWING SI RITERIOED FOR USE BY ARCHITECTS, ENGINEERS, CONTRACTORS, CONSULTANTS AND DESIGN PROFESSIONALS FOR PLANKING PURPOSES ONLY THIS DRAWING MAY NOT BE USED FOR CONSTRUCTION.
7 ALL INFORMATION CONTAINED HEREIN WAS QUIPRENT AT THE TIME OF DEVELOPMENT BUT MUST BE REVIEWED AND APPROVED BY THE PROJUCT MANUSACTURER TO BE CONSIDERED ACCURATE.
5 CONTRACTOR'S MOTE FOR PRODUCT AND COMPANY INFORMATION VISIT WWW.CADDETAILS.COMMINGO AND ENTER REFERENCE NUMBER 1177-206.

STANDARD ROLL BAG PET WASTE STATIONS

APWIZZDAPW IZ215-STANDARD ROLL BAG PET WASTE STATION AND SIGN (BAG DISPENSER, 5 GALLON RECEPTACLE, POST, SIGN)—SURFACE MOUNT OR INFORMUND OR APPROVED EQUAL

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□ CEDAR □ BLACK TOP VIEW □ DESERT TAN □ GRAY 7188'-----LA SELECT DESIRED FRAME COLOR. ☐ CEDAR ☐ GLACK GREEN BROWN 8 DESERT TAN GRAY SELECT DESIRED MOUNT □ PORFABLE



NOTES

1. ALL NATERIAL RECYCLED HOPE.

2. ALL HARDWARE STANLESS STEEL.

3. SHIPPED PARTIALLY ASSEMBLED.

4. HISTALLATION TO BE COMPLETED IN ACCORDANCE WITH MANUFACTURERYS SPECIFICATIONS.

5. DO NOT SCALE DRAWNIS.

5. DO NOT SCALE DRAWNIS.

6. THIS DRAWNIS INTERIODE FOR USE BY ARCHITECTS, ENGINEERS, CONTRACTORS, COMSULTANTS AND DESIGN PROFESSIONALS FOR FUNNISHING UNIVERSELY THIS DRAWNING WITH AND THE USES FOR CONSTRUCTION.

7. ALL RECORDANIS CONTRINGED REPRENIANS CURRENT AT THE TILE OF DEVELOPMENT BUT MAST BE REVIEWED AND APPROVED BY THE PRODUCT MANUFACTURER TO BE CONSISCRED ACQUARTE.

8. CONTRACTORS NOTE: FOR PRODUCT AND COMPANY INFORMATION HIST WAW. CADDETALS COMBIFO AND ENTER REFERENCE NUMBER 1177.658

LEGEND A-FRAME BENCHES

ABC1020 - 6 LEGISHO A-FRAME BENCH OR APPROVED EQUAL

SITE DEVELOPMENT PLANS

TAX MAP 297 LOT 11 LANDSCAPE DETAIL SHEET

3400 LAFAYETTE ROAD PORTSMOUTH, NH

OWNED BY

RICCI CONSTRUCTION CO, INC.

PREPARED FOR GREEN & COMPANY REAL ESTATE

SCALE: NOT TO SCALE

MARCH 8, 2021







I 48 Constitution Drive Bedford, NH 03110 Phone (603) 472~4488 Fox (603) 472-9747 www.tfmoron.com

MSK JCC F 45407.110 DR ARJ FB CK MSK CADFILE 45407-110 LANDSCAPE

LS-4

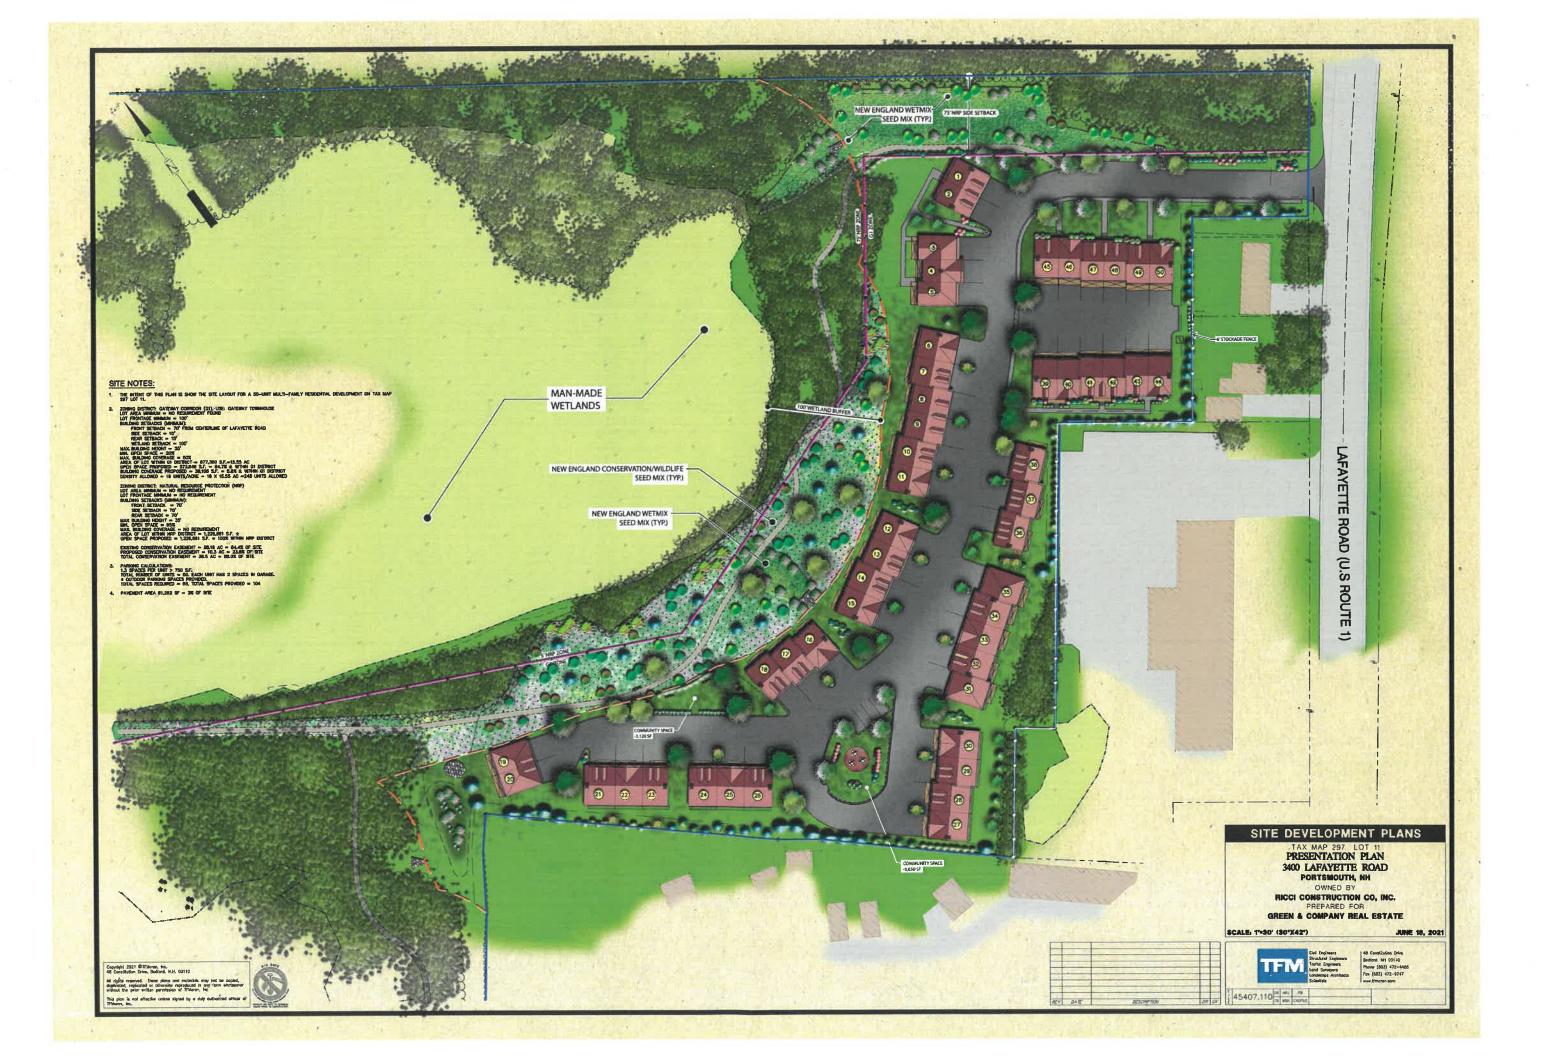


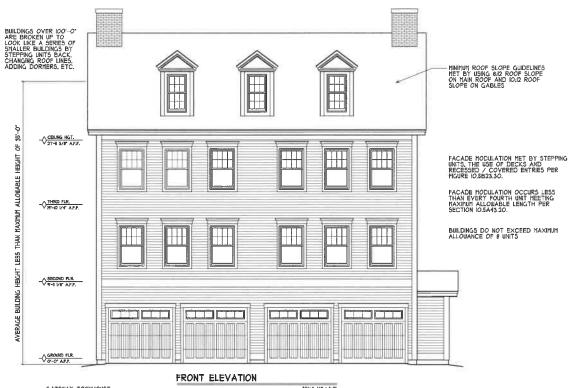

UNIT # 2 UNIT # 1


BUILDING # 1

GATEMAT TOWNHOUSE:
SMALL FOOTPRINT ATTACHED SING
FAMILY RESIDENTIAL BUILDINGS HAV
A NARROW MASSING AND MAY BE
LOCATED ON INDIVIDUAL OR COMMIL
LOTS, EACH UNIT IS SEPARATED
LORIZOLITALLY BY A COMMINICATION
OF THE PROPERTY OF

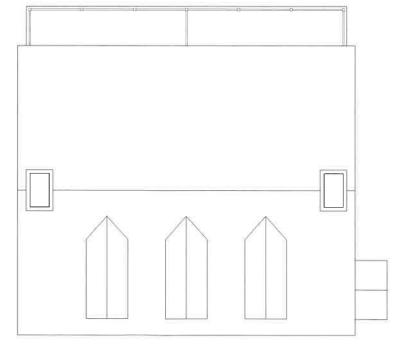

BUILDING # I




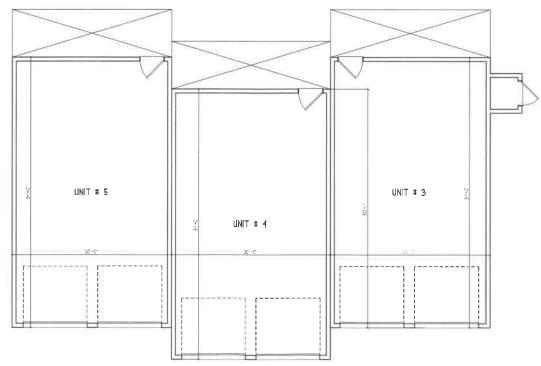

BUILDING # 2






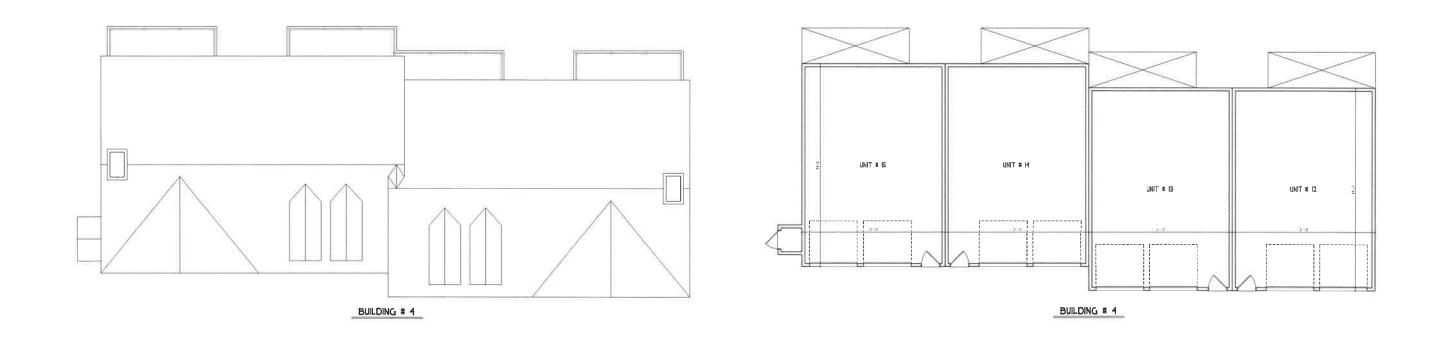





BUILDINGS DO NOT EXCEED MAXIMUM ALLOWANCE OF 8 UNITS

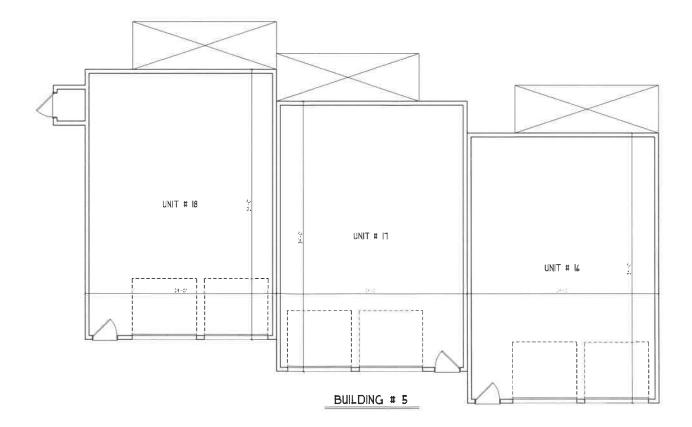



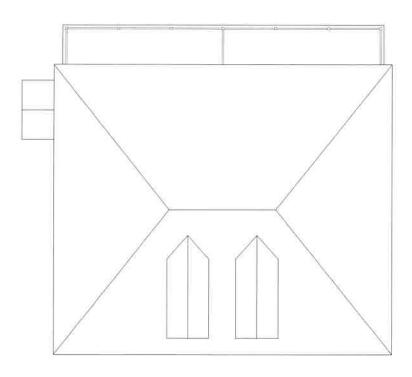


BUILDING # 6

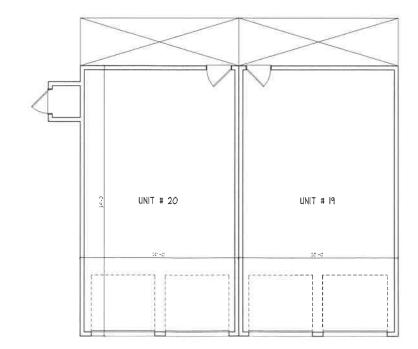


BUILDING # 6



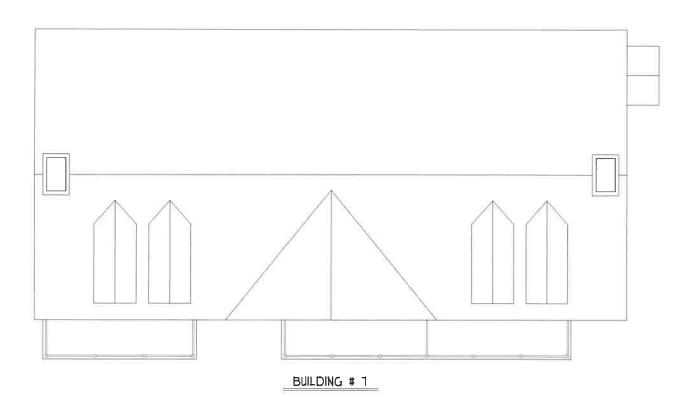


BUILDINGS DO NOT EXCEED MAXIMUM ALLOWANCE OF 8 UNITS

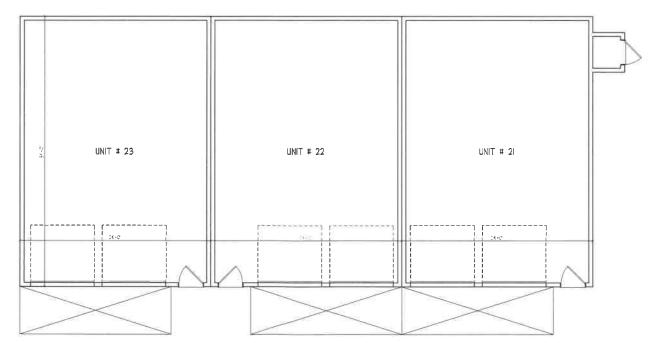


BUILDING # 7



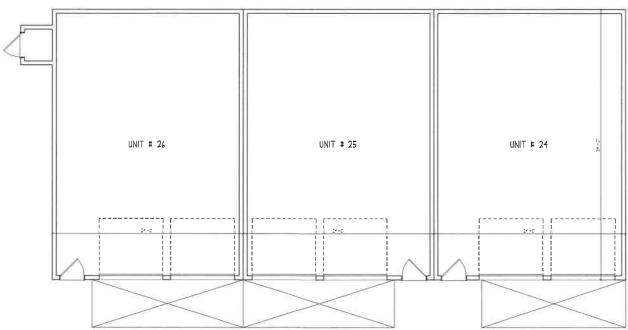


BUILDING # 8



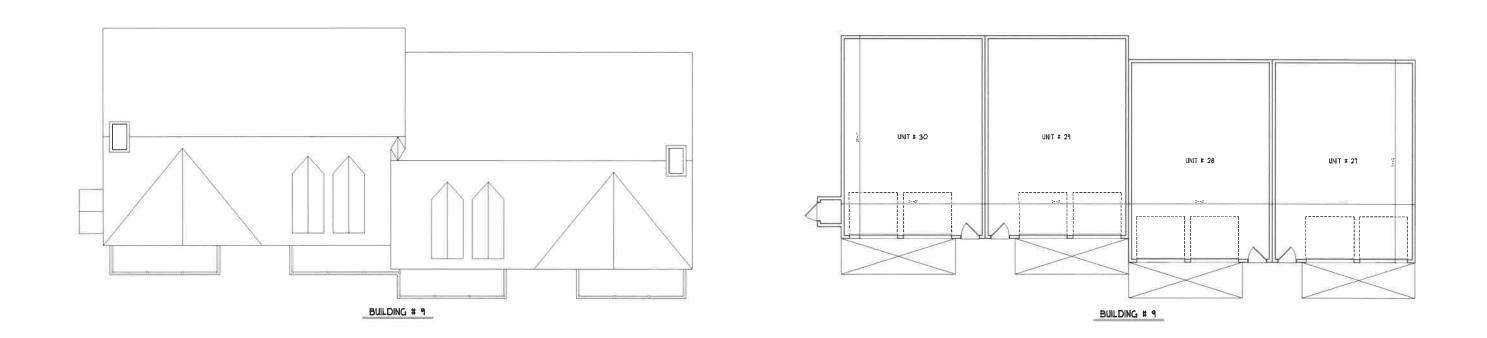



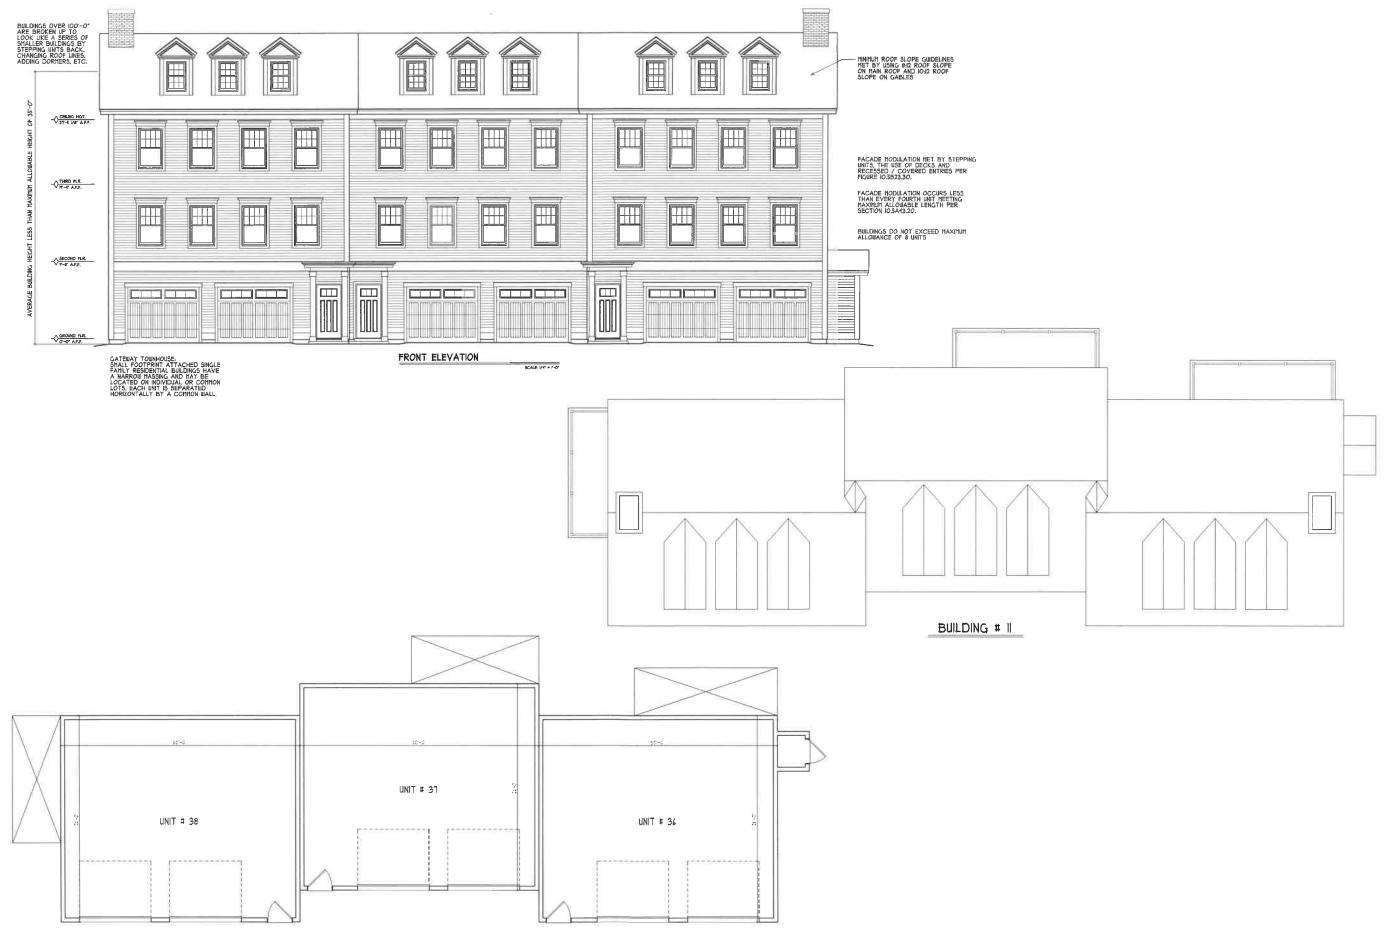

BUILDING # II



BUILDING # 12



\$ UNIT # 45 UNIT # 41 UNIT # 48 \$ UNIT # 49 UNIT # 50 \$

BUILDING # 13