

85 Portsmouth Avenue, PO Box 219, Stratham, NH 03885 603.772.4746 - JonesandBeach.com

June 23, 2021

Portsmouth Planning Board Attn: Dexter Legg 1 Junkins Avenue, Suite 3rd Floor Portsmouth, NH 03801

RE: Response Letter – TAC Comments 3400 Lafayette Road, Portsmouth, NH Tax Map 297, Lot 11 JBE Project No. 20737

Dear Mr. Legg,

Jones & Beach Engineers, Inc., is in receipt of comments from the TAC members dated June 1, 2021. Original review comments are italicized, and we offer the following responses below:

1. Please confirm compliance with the following Sections of the Zoning Ordinance – Section 10.5B22.40 Special Setback Requirements on Lafayette Road and Section 10.5B33.20 Front Lot Line Build Out.

RESPONSE: The Attorneys are currently reviewing the Zoning Ordinance to see if a varience is required.

- 2. The development appears to be very dense for this site. The community space does not appear to be functional for so many units on the site. Please consider revising the layout to allow for an arrangement that creates more meaningful community space.

 RESPONSE: We feel that the site is not dense and there is plenty of community space that is functional. The density using the G1 land is 240+ units and we based on documents from the City, we are allowed to use the NRP land for density as well that we haven't calculated as we are only proposing 50 units.
- 3. If the mailbox area is meant to be drive-up, the area should be larger to allow vehicles to pull in and out easier. if it is meant to be walk up, it should have a sidewalk and crosswalk leading to it.

RESPONSE: The mail box area has been widened for vehicles to drive up.

4. The driveway in front of unit 20 is very short due to the angle. It should be lengthened to allow for a vehicle to park in this space.

RESPONSE: The driveway has been modified to allow for a vehicle to park in the space.

5. The walkway between units 2 and 3 should have a tip down ramp at its terminus. RESPONSE: A tip down ramp has been added between units 2 and 3.

- 6. The project will require a driveway permit from the NHDOT. RESPONSE: NHDOT permit has been applied for in May.
- 7. Applicant's Engineer must work with City Engineer to determine if there is sufficient capacity in the City's sewer system for this development. Any approvals for this project are contingent on the approval of allowing the flow to be added to the City's system. RESPONSE: We are working with the City Engineers to determine if there is sufficient capacity in the City's sewer system for this development. We have already had a preliminary meeting with DPW to review the options and a solution should be coming together soon.
- 8. Third party engineer will be required to review on-site utilities and drainage during construction.

RESPONSE: This is up to the City and can be a condition of approval.

9. Third party engineer required to review drainage design.
RESPONSE: We don't feel that a third party review of the drainage design is needed since the drainage has to meet the Alteration of Terrain Permit standards, which is a more strict standard than the City. If this is still going to be required, than we would like to start the process as soon as possible.

10. Water main detail calls out C900 pipe.

RESPONSE: The water main detail is now a Ductile Iron pipe.

11. All water main parts to meet City standards.

RESPONSE: All water main parts meet the City standards.

12. All sewer pipe and manholes to meet City and State Standards.

RESPONSE: Sewer pipe and manholes meet City and State standards.

13. HDPE pipe must be surrounded by crushed stone.

RESPONSE: HDPE pipe is surrounded b crushed stone.

14. Hydrant locations to be approved by Portsmouth Fire.

RESPONSE: Hydrant locations will be approved by Portsmouth Fire.

15. Show water lines for fire service sprinklers.

RESPONSE: Water lines for fire service sprinklers are shown on the plans.

16. Will there be parking allowed on the internal driveways?

RESPONSE: No parking will be allowed on the internal driveways.

17. The width of the travel lane should not be less than 24' at any point.

RESPONSE: The travel lane width has been revised.

18. The dead end section of the travel lane should be a minimum of 26' wide. RESPONSE: The dead end section of the travel lane has been revised.



19. The driveway and parking areas for the 12 townhouse units located near Lafayette Road should have at least 60 feet of pavement between the buildings to allow for parking and turning movements.

RESPONSE: We already have over 60' of pavement from garage door to garage door from the closest units and more at the wider units. Dimension has been added to clarify.

- 20. All buildings should allow for front decks over the garages in order to soften the visual impact of the large garage doors at the ground level. Where no decks are proposed I would suggest double doors be considered (or a facsimile thereof) to add visual interest and break up the monotony and expansiveness of the ground-floor garages.

 RESPONSE: There are a number of different unit styles with varying roof lines to provide visual interest.
- 21. The neighborhood design would benefit from removal of units 19-23 and rotating the building containing units 24-26 along the cul-de-sac. At a minimum, due to the orientation and circulation constraints I would remove at least the last two units (19-20). This area could be used for active recreation (i.e. a playground, dog park, grilling area...) for the remaining units.
 RESPONSE: We have already removed 4 units from the design based on the previous feedback received. The site is more open between buildings, has additional buildings with less units per building, varying styles of buildings, sizes, deck locations and we do have more than required space for active and passive recreation and land conservation.
- 22. The dog park should be located outside the buffer zone.

 RESPONSE: The dog park has been moved out of the buffer zone.
- 23. 4 visitor spaces seems low given the proposed density and the fact that many residents will be parking in front or their units.
 RESPONSE: Each unit has a 2 car garage and 2 parking spaces in front of the unit. We feel the 4 visitor spaces is adequate since every unit can fit 4 cars.
- 24. The snow storage areas look inadequate for the proposed impervious surface. **RESPONSE:** The snow storage areas have been expanded.
- 25. The proposed sidewalk should be concrete and efforts should be made to connect a pedestrian walkway to all the proposed units.

 RESPONSE: The sidewalks have been modified to concrete.
- 26. The existing trail system around the wetland should be clearly identified and improved to be used as a passive recreational trail for the residents.
 RESPONSE: The existing trail system around the wetland has been clearly identified on the plans.
- 27. Please describe your plan for solid waste/trash storage and collection.

 RESPONSE: A note has been added to the plans for solid waste/trash storage and collection.



- 28. You will need to provide will-serve letters from relevant utilities. RESPONSE: We have requested the will-serve letter from relevant utilities.
- 29. Please provide an update on the status of any state permits.
 RESPONSE: Note #20 on the Sheet C2 provides a list of required State Permits.
 Dates and permit numbers will be added upon receipt.
- 30. Please provide a green building statement consistent with the requirements of Section 2.5.3.1A of the Site Review Regulations.

 RESPONSE: The architect will be providing the green building statement.

The following is provided in support of this letter:

- 1. One (1) Full Size Plan Set.
- 2. One (1) Half-Size Plan Set.
- 3. Color Rendering of Site Plan.
- 4. Mitigation Documents.

Thank you very much for your time. If you have any questions, or need further assistance, please contact our office.

Very truly yours,

JONES & BEACH ENGINEERS, INC.

Joseph Coronati
Vice President

cc: Michael Green, Green & Company (via email)

John Kuzinivich, Esq (via email)

John Bosen, Esq (via email)

Greg Mikolaities, consultant (via email)

Jamie Long, GZA (via email)

Lindsay White, GZA (via email)

Tom Severino (via email)





Portsmouth Water Works

City of Portsmouth

700 ISLINGTON STREET - - PORTSMOUTH, NEW HAMPSHIRE 03601

APRIL 17, 1985

MR. ROBERT RICCI % THE RICCI CONSTRUCTION CO. BANFIELD RD. PORTSMOUTH, N. H. 03801

DEAR MR. RICCI:

THIS IS TO INFORM YOU THAT YOU MAY CONNECT TO THE EXISTING EIGHT INCH WATER MAIN CROSSING LAFAYETTE ROAD TO PROVIDE SERVICE TO YOUR PROPERTY SHOWN AS LOT #11 OF THE CITY OF PORTSMOUTH TAX MAP #97.

YOU WILL, OF COURSE, BE REQUIRED TO HAVE PERMISSION FROM THE STATE HIGHWAY DEPARTMENT TO INSTALL THE SERVICE PIPE ON THEIR PROPERTY.

VERY TRULY YOURS,

RANCE G. COLLINS, SUPERINTENDENT

PORTSMOUTH WATER DEPARTMENT

RGC/DR



AGREEMENT made this IT day of April, 1985 by and between Hospital Corporation of America, of Nashville, Tennessee, hereinafter referred to as "Purchaser", and Ricci Corporation, having a principal place of business at Banfield Road, Portsmouth, County of Rockingham, State of New Hampshire, hereinafter referred to as "Seller", as follows:

- 1. SELLER agrees to convey to PURCHASER, or their successor in interest, an easement to enter onto and perform work upon a portion of a certain parcel of land, said parcel being located on the westerly side of Lafayette Road in said Portsmouth, containing forty-four (44.00) acres, more or less, more particularly bounded and described in attached Exhibit A.
- 2. SELLER further agrees to grant to the City of Portsmouth, concurrent with the easement referred to in the preceding paragraph, a perpetual conservation easement in a form acceptable to the City Attorney for the City of Portsmouth, said easement to cover the portion of the parcel of land more particularly described in Exhibit A.
- 3. It is agreed and understood by the parties that the purpose of the acquisition of the construction easement by Hospital Corporation of America or their successors in interest is to allow Hospital Corporation of America or their successors in interest to enter upon the property and to perform certain work pursuant to a "mitigation plan" approved by the Army Corps of Engineers, the Environmental Protection Agency, and U. S. Fish and Wildlife. Said mitigation plan will involve removal of construction debris and fill from a degraded wetland and upland

- area. The aforesaid mitigation plan will also involve the placement upon the subject property quantities of wetland fill to enable Hospital Corporation of America or its successors in interest to create upon the site additional wetland areas pursuant to the afore-mentioned approved mitigation plan.
- 4. That the within agreement is contingent upon approval being obtained from the Army Corps of Engineers, United States Fish and Wildlife, and the Environmental Protection Agency, as well as all State Wetlands Boards and local Boards and Commissions for the "mitigation plan" and implementation thereof.
- 5. It is further understood by the parties hereto that the SELLER shall retain fee simple title to the property described in Exhibit A, subject to the easements described herein.
- 6. That should the PURCHASER fail to receive the necessary approvals set forth herein, this Agreement shall be null and void and the PURCHASER'S deposit shall be refunded. PURCHASER agrees that any and all construction activity for which the easement is being acquired shall be completed on or before December 31, 1987. The parties agree that the PURCHASER shall have 180 days from the execution hereof to obtain all the necessary approvals set forth herein. The closing is to occur within 60 days of PURCHASER'S obtaining all necessary approvals of the "mitigation plan" set forth herein, as well as all necessary approvals for the implementation thereof.
- 7. SELLER further agrees to convey to PURCHASER and its successors in interest a non-exclusive easement twenty-five (25') feet in width to pass and re-pass from Lafayette Road to the easement area described in Exhibit A.

- 8. SELLER agrees that it will allow PURCHASER, its agents and representatives, as well as agents and representatives of the U.S. Fish and Wildlife Department, Army Corps of Engineers, and the Environmental Protection Agency to enter upon the property contained in the proposed easement area for purposes of conducting necessary observation and testing.
- 9. In consideration of the foregoing, PURCHASER agrees to pay to the SELLER the sum of Sixty Thousand (\$60,000.00) Dollars, as follows:

Deposit upon execution by the SELLER of the within Agreement \$ 1,000.00

At Closing 59,000.00

- 10. Purchaser agrees to survey at its expense the boundry of the proposed easement as shown on the attached Exhibit A, and to produce a recordable plan delineating said easement area.
- 11. With regard to said proposed easement area, Purchaser hereby agrees that the proposed easement will be no less than Four Hundred Ten (410') feet from the edge of the pavement of Lafayette Road, and Purchaser further covenants that the proposed easement area will be a minimum of One Hundred Twenty-five (125') feet from the northwesterly corner of land now or formerly of Louis Bowmar, Jr., said land being Lot #6 on Tax Map R-97 of the City of Portsmouth.


IN WITNESS WHEREOF, we have hereunto set our hand and seal this day of A, 1985.

HOSPITAL CORPORATION OF AMERICA

Ву

BURCHASER.

Pica Capenton Roberta. Pica S.

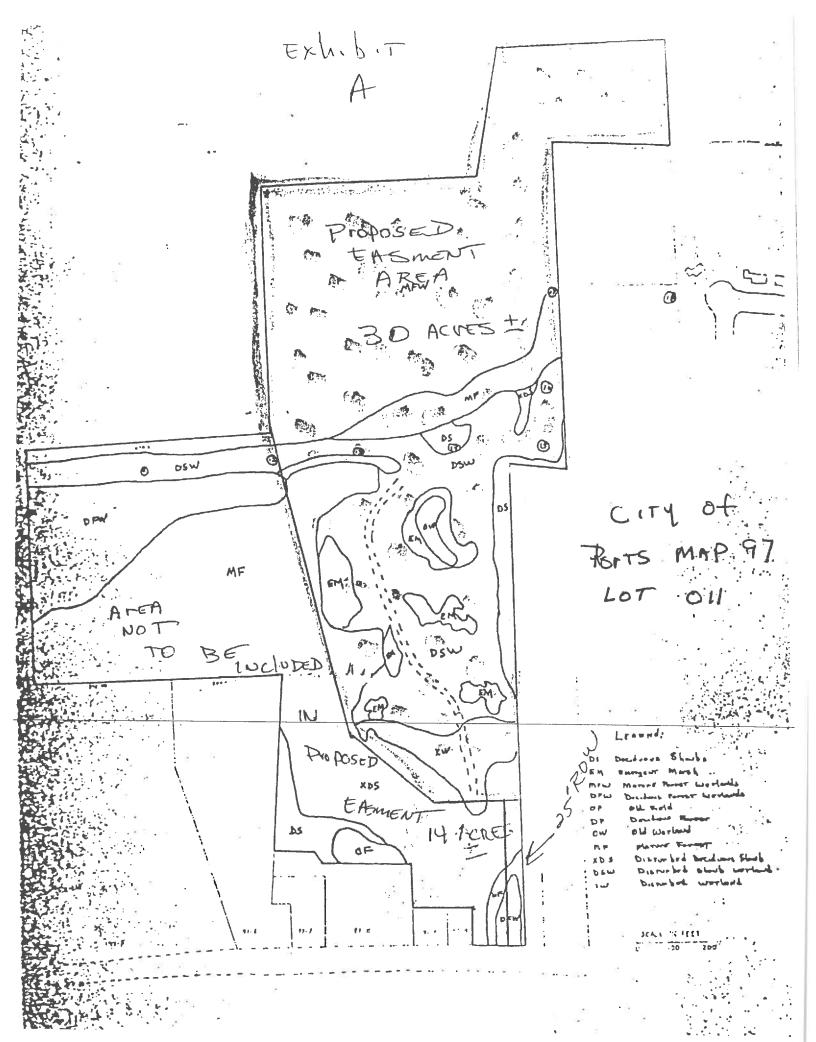

Weeks, Whalen & Gamester

REAL ESTATE BROKERS

April 19, 1985

Mr. Robert Ricci, Sr. Ricci Construction Co. Banfield Road Portsmouth, NH 03801

Dear Bud:

Enclosed is an executed copy between Hospital Corporation of America of Nashville, Tennessee, and Ricci Corporation of Portsmouth, New Hampshire for the easement for the 44 acres of land which is owned by the Ricci Corporation off of Lafayette Road.

This letter is also to confirm that at the time of the transfer of that easement by the Ricci Corporation to HCA, that the real estate firm of Weeks, Whalen and Gamester will be paid a \$6,000.00 commission by Ricci Corporation from the \$60,000.00 proceeds paid by Hospital Corporation of America.

I'm going to be on vacation next week but upon my return I will again get together with Mike Pagano now that the pressure is off on the inventory forms and he has a little more time to discuss the change in taxation on this land when the easement is taken by HCA.

Warm Personal Regards,

WEEKS WHALEN & GAMESTER

Peter G. Weeks

PGW:brg

Lafe J



Legal Department

CITY OF PORTSMOUTH

City Hall, 126 Daniel Street Portsmouth, New Hampshire 03801 (603) 431-2000, ext 200

Robert P. Sullivan. City Attorney

James J. Flynn, Assistant City Attorney

April 12, 1985

Robert Ricci, Sr. Ricci Construction Company Banfield Road Portsmouth, N.H. 03801

Re: Conservation Easements

Dear Mr. Ricci:

This is to advise that if the "proposed easement area" identified on the attached "Exhibit A" is conveyed to HCA for conservation purposes, it may still be considered in density calculation for planned unit development purposes on Lot 011, Map 97.

This, of course, does not imply or guarantee approval of any particular project, each of which must be reviewed on its own merits.

Very truly yours,

Robert P. Sullivan, City Attorney

RPS:bh

cc: Bernard Felech, Esquire Peter G. Weeks

EASEMENT

KNOW ALL MEN BY THESE PRESENTS That Ricci Corporation, a New Hampshire corporation having a principal place of business at 220 Banfield Road, Portsmouth, County of Rockingham, State of New Hampshire, in consideration of One Dollar and other valuable consideration, grants to the City of Portsmouth, a municipal corporation in the State of New Hampshire, an easement in perpetuity for conservation purposes, a certain parcel of land located off Lafayette Road in said Portsmouth, said parcel being more particularly bounded and described as follows:

Beginning at a point Three Hundred Ninety-three and thirtytwo hundredths (393.32) feet from the right-of-way limit of said Lafayette Road, said point being Four Hundred Ten (410) feet, more or less, from the edge of pavement of said Lafayette Road, at the eastern-most corner of the within described premises at Land now or formerly of House-Goodman Limited Partnership; thence running

NORTH 67° 12' 29" West by said land of House-Goodman Two Hundred Forty-nine and Ninety-five hundredths (249.95) feet to a drill hole in a stone wall; thence turning and running

NORTH 67' 52' 24" West by said stone wall at land of House-Goodman One Hundred Ninety-four and Forty-two hundredths (194.42) feet to a drill hole in said stone wall; thence turning and running

NORTH 67° 20' 57" West by land of said House-Goodman Two Hundred Fifty-five and Fifty-six hundredths (255.56) feet to a drill hole in a stone wall; thence turning and running

NORTH 67' 10' 33" West by said stone wall a distance of One Hundred Eighty-two and Fifty-one hundredths (182.51) feet to a drill hole at an intersecting stone wall; thence turning and running

NORTH 30' 47' 10" East along a stone wall One Hundred Seventy-two and Eighty-seven hundredths (172.87) feet by land of said House-Goodman to a drill hole in said stone wall; thence turning and running

NORTH 67° 16' 08" West by land now or formerly of Pres in and Shirley Garrett a distance of N_ne Hundred Three and Sixi six hundredths (903.66) feet to a point; thence turning and running

NORTY 27° 47' 17" East by land of said Garrett a distance of Two Hundred One and Sixty hundredths (201.60) feet to an iron rod at land of said Garrett and land of Karen and Elizabeth Kapelos; thence running

LAW OFFICES OF JOHN J. WHOLEY 224 STATE STREET PORTSMOUTH, N. H.

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NORTH 27° 47' 17" East by land of said Kapelos a distance of One Hundred Forty-one and Eighty-six hundredths (141.86) feet to an iron rod at land of Kapelos and land now or formerly of Lamothe Development Corporation; thence turning and running

NORTH 67° 16' 22" West by land of said Lamothe Development Corporation a distance of Two Hundred Eighty and Twenty-seven hundredths (280.27) feet to a point on a stone wall at land of said Lamothe Development Corporation at land now or formerly of the City of Portsmouth; thence turning and running

SOUTH 22° 49' 03° West by land of said Portsmouth a distance Seventy-five and Fifty-seven hundredths (75.57) feet to a tree with barbed wire; thence running

SOUTH 22° 49' 03" West along said stone wall by land of said Portsmouth One Hundred Forty-one and Fifty-two hundredths (141.52) feet to a blazed pine; thence running

SOUTH 22° 41' 08" West by land of said Portsmouth a distance of Two Hundred Ninety-six and Five Hundredths (296.05) feet to an iron pin; thence turning and running

SOUTH 66° 47' 15" East by land of said Portsmouth a distance of Three Hundred Forty-two and Fifty-one hundredths (342.51) feet to an iron pin; thence turning and running

SOUTH 21° 20' 53" West a distance of Six Hundred Seventeen and Sixty-two hundredths (617.62) feet to an iron pin at land of said Portsmouth and land now or formerly of the City of Portsmouth Conservation Commission; thence turning and running

SOUTH 66° 24' 52" East by land now or formerly of the City of Portsmouth Conservation Commission to a fencepost with barbed wire; thence turning and running

SOUTH 66° 37' 22" East by land of said Conservation Commission a distance of Three Hundred Ninety-five and Twentyeight Hundredths (395.28) feet to an iron pin at land of said Conservation Commission and land of the Grantor; thence turning and running

SOUTH 77° 10' 28" East a distance of Eight Hundred Thirtytwo and Sixty-nine hundredths (8:2.69) feet by land of the within Grantor to a point; thence turning and running

NORTH 57° 48' 48" East a distance of Two Lundred Eighty-nine and Ninety-nine hundredths (289.99) feet by land of the within Grantor to a point; thence turning and running

NORTH 22° 47' 31" East by land of the within Grantor a distance of Two Hundred Fifty and zero hundredths (250.00) feet to the point of beginning.

LAW OFFICES OF JOHN J. WHOLEY 224 STATE STREET PORTSMOUTH, N. H.

RK2567 P1762

Said easement is granted simultaneously with an easement granted to Hospital Corporation of America for the purposes of construction upon and maintenance of wetlands created on said premises. Said easement to Hospital Corporation of America will be recorded herewith.

For title reference, see decree of Rockingham County Superior Court dated September 13, 1968, recorded in the Rockingham County Registry of Deeds at Book 1930, Page 229. See also deed of Wayne Mullavey, Executor of the estate of Will am H. Sleeper, recorded in the Rockingham County Registry of Deeds in Book 1589, Page 442.

Signed this " day of Oc-

1985.

RICCI CORPORATION

By Pala a. Q. S.

STATE OF NEW HAMPSHIRE Rockingham, ss.

Personally appeared the above-named duly authorized, and acknowledged that he executed the foregoing instrument as his free act and deed and in his said capacity.

Justice of the Beate/Dates Dublic

LAW OFFICES OF JOHN J. WHOLEY 224 STATE STREET PORTSMOUTH, N. H.

CORPORATE VOTE OF RICCI CORPORATION

At a special meeting of the directors of Ricci Corporation held on October 8, 1985, it was duly voted that Robert A. Ricci, Sr. be authorized to sign any and all documents relative to the conveyance of easement to Hospital Corporation of America and the City of Portsmouth, New Hampshire.

ames E. Ritzo, Acting Secretary

A True Copy Attest

PRO	JECT CLASS FEE	FOR WETLANDS BOARD OFFICE USE ONLY
MIN MIN MAJ	,	FEE RECEIVED CHECK NO. AMOUNT INIT.
PAY/ TO /	ING FEE (CHECK OR MONEY ORDER MADE ABLE TO NH WETLANDS BOARD) IS REQUIRED ACCOMPANY THIS APPLICATION FORM TO THE LANDS BOARD OFFICE.	FILE NUMBER
and	ling, dredging, or construction of struc	to accomplish work described below relating to tures under the provisions of RSA Chapters 483-A will be acted upon by W.S.P.C.C. and such action
1.	NAME OF OWNER Hospital Corp. to America (Please Print Clearly	TELEPHONE NUMBER 1-800-251-2561
	MAILING ADDRESS 1 Park Plaza, Nashville	e. TN 37203
2.	LOCATION OF PROPUSED CONSTRUCTION Lafay	
3.	Complete the location map on reverse sid	le on all copies or attached a map to each copy.
4.	Adjacent to, or in (xxxx)(fresh) water_u	
		(name of water body)
5.	Type of project - (x)Fill (x)Dredge	()Pier ()Other (specify)
6.	Reason(s) for proposed construction See	0
	Normandeau Associates, Inc. Dated Se	ptember 4, 1985
7.	Proposed starting date October 15, 1985	Completion Date November 15, 1985
8.	Description of construction:	
	(a) Type of Material: Dredge Construct	de Wetland) Wetlands Soil from ion Debris & Fill Hospital Site
	G	ravel 6.63 AC - 288,750 SF Total Exc. e feet) 1.03 AC - 45,250 SF in man-made Wetland
	(c) Estimated area to be filled (square	feet) 6.63 AC - 288,750 SF Total

LAW OFFICES OF JOHN J. WHOLEY 224 STAYE STREET PORTSMOUTH N. H.

RASEMENT

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NORTH 67° 12' 29" West by said land of House-Goodman Two Hundred Forty-nine and Ninety-five hundredths (249.95) feet to a drill hole in a stone wall; thence turning and running

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SOUTH 77° 10' 28" East a distance of Eight Hundred Thirtytwo and Sixty-nine hundredths (832.69) feet by land of the within Grantor to a point; thence turning and running

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LAW OFFICES OF JOHN J WHOLEY 224 STATE STHEET PORTSMOHILL N H

Section 200

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Signed this " day of October

, 1985.

RICCI CORPORATION

By Robert a. Reis

STATE OF NEW HAMPSHIRE Rockingham, ss.

Personally appeared the above-named duly authorized, and acknowledged that he executed the foregoing instrument as his free act and deed and in his said capacity.

Justice of the Peace/Noticy Public

LAW OFFICES OF JOHN J WHOLEY STASIATE STREET

CORPORATE VOTE OF RICCI CORPORATION

At a special meeting of the directors of Ricci Corporation held on October 8, 1985, it was duly voted that Robert A. Ricci, Sr. be authorized to sign any and all documents relative to the conveyance of easement to Hospital Corporation of America and the City of Portsmouth, New Hampshire.

James E. Ritzo, Ming Secretary

A True Copy Attest

*



Legal Department

CITY OF FORTSMOUTH

City Hail, 126 Daniel Street Fortune-IIV. Non-Hampshire 2000 (503) 431-2000, ext. 200

Robert P. Sullivan Cdv Atlantey

James J. Flynn, Assistant City Allorney

April 12, 1985

Robert Ricci, Sr.. Ricci Construction Company Banfield Road Portsmouth, N.H. 03801

Re: Conservation Easements

Dear Mr. Ricci:

This is to advise that if the "proposed easement area" identified on the attached "Exhibit A" is conveyed to HCA for conservation purposes, it may still be considered in density calculation for planned unit development purposes on Lot Oll, Map 97.

This, of course, does not imply or guarantee approval of any particular project, each of which must be reviewed on its own merits.

Very truly yours,

Robert P. Sullivan, City Attorney

RPS:bh

cc: Bernard Pelech, Esquire Peter G. Weeks 23

LAW OFFICES OF JOHN J. WHOLEY 224 STATE STREET PORTSMOUTH, N. H.

EASEMENT

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Beginning at a point Three Hundred Ninety-three and thirty-two hundredths (393.32) feet from the right-of-way limit of said Lafayette Road, said point being Four Hundred Ten (410) feet, more or less, from the edge of pavement of said Lafayette Road, at the eastern-most corner of the within described premises at land now or formerly of House-Goodman Limited Partnership; thence running

NORTH 67° 12' 29" West by said land of House-Goodman Two Hundred Forty-nine and Ninety-five hundredths (249.95) feet to a drill hole in a stone wall; thence turning and running

NORTH 67° 52' 24" West by said stone wall at land of House-Goodman One Hundred Ninety-four and Forty-two hundredths (194.42) feet to a drill hole in said stone wall; thence turning and running

NORTH 67° 20' 57" West by land of said House-Goodman Two Hundred Fifty-five and Fifty-six hundredths (255.56) feet to a drill hole in a stone wall; thence turning and running

NORTH 67° 10' 33" West by said stone wall a distance of One Hundred Eighty-two and Fifty-one hundredths (182.51) feet to a drill hole at an intersecting stone wall; thence turning and running

NORTH 30' 47' 10" East along a stone wall One Hundred Seventy-two and Eighty-seven hundredths (172.87) feet by land of said House-Goodman to a drill hole in said stone wall; thence turning and running

NORTH 67° 16' 08" West by land now or formerly of Preston and Shirley Garrett a distance of Nine Hundred Three and Sixtysix hundredths (903.66) feet to a point; thence turning and running

NORTH 27° 47' 17" East by land of said Garrett a distance of Two Hundred One and Sixty hundredths (201.60) feet to an iron rod at land of said Garrett and land of Karen and Elizabeth Kapelos; thence running NORTH 27° 47' 17° East by land of said Kapelos a distance of One Hundred Forty-one and Eighty-six hundredths (141.86) feet to an iron rod at land of Kapelos and land now or formerly of Lamothe Development Corporation; thence turning and running

NORTH 67° 16' 22" West by land of said Lamothe Development Corporation a distance of Two Hundred Eighty and Twenty-seven hundredths (280.27) feet to a point on a stone wall at land of said Lamothe Development Corporation at land now or formerly of the City of Portsmouth; thence turning and running

SOUTH 22° 49' 03" West by land of said Portsmouth a distance of Seventy-five and Fifty-seven hundredths (75.57) feet to a tree with barbed wire; thence running

SOUTH 22° 49' 03" West along said stone wall by land of said Portsmouth One Hundred Forty-one and Fifty-two hundredths (141.52) feet to a blazed pine; thence running

SOUTH 22° 41' 08" West by land of said Portsmouth a distance of Two Hundred Ninety-six and Five Hundredths (296.05) feet to an iron pin; thence turning and running

SOUTH 66° 47' 15" East by land of said Portsmouth a distance of Three Hundred Forty-two and Fifty-one hundredths (342.51) feet to an iron pin; thence turning and running

SOUTH 21° 20' 53" West a distance of Six Hundred Seventeen and Sixty-two hundredths (617.62) feet to an iron pin at land of said Portsmouth and land now or formerly of the City of Portsmouth Conservation Commission; thence turning and running

SOUTH 66° 24' 52" East by land now or formerly of the City of Portsmouth Conservation Commission to a fencepost with barbed wire; thence turning and running

SOUTH 66° 37' 22" East by land of said Conservation Commission a distance of Three Hundred Ninety-five and Twenty-eight Hundredths (395.28) feet to an iron pin at land of said Conservation Commission and land of the Grantor; thence turning and running

SOUTH 77° 10' 28" East a distance of Eight Hundred Thirtytwo and Sixty-nine hundredths (832.69) feet by land of the within Grantor to a point; thence turning and running

NORTH 57° 48' 48" East a distance of Two Hundred Eighty-nine and Ninety-nine hundredths (289,99) feet by land of the within Grantor to a point; thence turning and running

NORTH 22° 47' 31" East by land of the within Grantor a distance of Two Hundred Fifty and zero hundredths (250.00) feet to the point of beginning.

LAW OFFICES OF JOHN J WHOLEY 224 STATE STREET PORTSMOUTH N H -

K2567 P1767

Said easement is granted simultaneously with a perpetual conservation easement to the City of Portsmouth of even date to be recorded herewith.

Said easement is granted for the purpose of allowing the within Grantee to enter onto said property to perform certain dredging and filling on the premises. The Grantee or its assigns shall have the right to enter onto said premises in perpetuity for the sole purpose of maintenance of wetlands to be created on the premises.

The Grantor herein does further convey to the Grantee a right to pass and repass over other land of the Grantor from Lafayette Road, so-called, to the within demised premises, upon a right-of-way twenty-five (25') feet in width running from Lafayette Road along the traveled way as it presently exists to the within demised premises.

For title reference, see decree of Rockingham County Superior Court dated September 13, 1968, recorded in the Rockingham County Registry of Deeds at Book 1930, Page 229. See also deed of Wayne Mullavey, Executor of the estate of William H. Sleeper, recorded in the Rockingham County Registry of Deeds in Book 1589, Page 412.

Signed this // day of Oction, 1985.

RICCI CORPORATION

By Plet a. Ris.

STATE OF NEW HAMPSHIRE Rockingham, ss.

Personally appeared the above-named duly authorized, and acknowledged that he executed the foregoing instrument as his free act and deed in his said capacity.

Justice of the Feage Notary Public

8X2567 P1768



Legal Dopariment

CITY OF FORTSMOUTH

City Hall, 126 Daniel Street Portsmouth, New Hampshire, 63801 (603) 431-2000, ext. 200

Robert P. Sullivan City Attorney

James J. Flyon, Assistant City Attorney

April 12, 1985

Robert Ricci, Sr. Ricci Construction Company Banfield Road Portsmouth, N.H. 03801

Re: Conservation Easements

Dear Mr. Ricci:

This is to advise that if the "proposed easement area" identified on the attached "Exhibit A" is conveyed to HCA for conservation purposes, it may still be considered in density calculation for planned unit development purposes on Lot Oll, Map 97.

This, of course, does not imply or guarantee approval of any particular project, each of which must be reviewed on its own merits.

Very truly yours,

RPS:bh

Robert P. Sullivan, City Attorney

cc: Bernard Pelech, Esquire Peter G. Weeks





Green & Co Attn: Michael Green 11 Lafayette Road, P.O. Box 1297 North Hampton, NH 03862

RE: 3400 Lafayette Road, Portsmouth, New Hampshire

Hello Michael:

Thank you for your continued commitment to ENERGY STAR Homes. We look forward to working with you on the certification of the units being constructed at 3400 Lafayette Road. Our team here at GDS is happy to be working with Green and Company on another ENERGY STAR Home project.

For the benefit of others not familiar with the ENERGY STAR label and what it means for homes receiving the label, ENERGY STAR is more than just energy efficient construction. It also includes an element of building durability and healthy building environments. The process includes energy modeling and performance-based testing as well as on-site inspections to confirm the modeling inputs, to identify opportunities to improve insulation and air-sealing prior to drywall, duct leakage testing, and blower door testing.

ENERGY STAR Home are by design at least 30% more efficient than code built home (IECC 2009) and include high efficient HVAC and water heating equipment, insulation installed to attain an installation grading of grade, excellent window efficiencies (u-value ≤ 0.30) and high efficacy lighting and ENERGY STAR appliances.

Because ENERGY STAR encourages tight, well insulated buildings, the program does not want to create any issues with indoor air quality. Therefore, the program requires some means of whole-house ventilation (compliant with ASHRAE Standard 62.2) and includes a moisture management checklist. All of this adds a non-energy benefit to constructing a home that is energy efficiency, healthy and durable.

Our plan is to utilize the NHSaves program (sponsored by Eversource, Unitil, Liberty and NHEC) to provide support for modeling and inspections.

Once we receive a set of plans we can begin the take-off and energy modeling. In the meantime, as always, please contact me with any questions or design changes that may impact the ENERGY STAR Home certification.

Bruce Bennett, Principal










FRESHWATER WETLANDS LINE TIDAL WETLANDS LINE BARBED WIRE STOCKADE FENCE CAPE COD BERM POURED CONCRETE CURB DRAINAGE LINE SEWER FORCE MAIN WATER SERVICE UNDERDRAIN FIRE PROTECTION LINE THRUST BLOCK IRON PIPE/IRON ROD IRON ROD/DRILL HOLE STONE/GRANITE BOUND SPOT GRADE × 100.00 x 100.00 PAVEMENT SPOT GRADE DOUBLE POST SIGN SINGLE POST SIGN FAILED TEST PIT MONITORING WELL PHOTO LOCATION TREES AND BUSHES UTILITY POLE LIGHT POLES SEWER MANHOLE WATER GATE WATER SHUT OFF REDUCER SINGLE GRATE CATCH BASIN DOUBLE GRATE CATCH BASIN CULVERT W/WINGWALLS CULVERT W/FLARED END SECTION CULVERT W/STRAIGHT HEADWALL STONE CHECK DAM DRAINAGE FLOW DIRECTION 4K SEPTIC AREA VEGETATED FILTER STRIP RIPRAP OPEN WATER अंकि अंकि अंकि FRESHWATER WETLANDS *** TIDAL WETLANDS STABILIZED CONSTRUCTION ENTRANCE CONCRETE 25000 **GRAVEL** SNOW STORAGE

RESIDENTIAL CONDOMINIUMS TAX MAP 297, LOT 11 3400 LAFAYETTE ROAD, PORTSMOUTH, NH

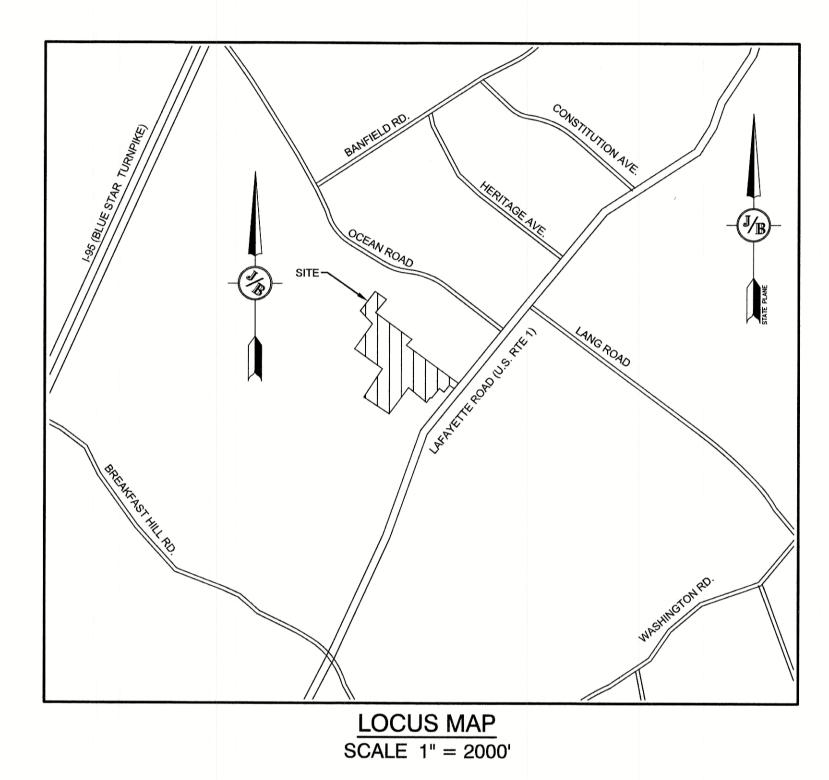

CIVIL ENGINEER / SURVEYOR JONES & BEACH ENGINEERS, INC. 85 PORTSMOUTH AVENUE PO BOX 219 STRATHAM, NH 03885 (603) 772-4746 CONTACT: JOSEPH CORONATI

EMAIL: JCORONATI@JONESANDBEACH.COM

WETLAND CONSULTANT **GZA ENVIRONMENTAL**

5 COMMERCE PARK NORTH SUITE 201 BEDFORD, NH 03110 603-623-3600 **CONTACT: JAMES LONG**

APPLICANT

GREEN & COMPANY 11 LAFAYETTE ROAD PO BOX 1297 NORTH HAMPTON, NH 03862 603-964-7572 CONTACT: MICHAEL GREEN MPG114@GMAIL.COM

LANDSCAPE ARCHITECT

TF MORAN, INC. 48 CONSTITUTION DRIVE BEDFORD, NH 03110 603-472-4488 CONTACT: MIKE KRZEMINSKI MKRZEMINSKI@TFMORAN.COM

ARCHITECT: STONEARCH DEVELOPMENT (603) 817-5758 CONTACT: MICHAEL MACNEIL

Stratham, NH 03885

ELECTRIC

EVERSOURCE ENERGY 74 OLD DOVER ROAD ROCHESTER, NH 03867 (603) 555-5334 CONTACT: NICHOLAI KOSKO

TELEPHONE

E-MAIL: JBE@JONESANDBEACH.COM

FAIRPOINT COMMUNICATIONS 1575 GREENLAND ROAD GREENLAND, NH 03840 (603) 427-5525 **CONTACT: JOE CONSIDINE**

CABLE TV COMCAST COMMUNICATION CORPORATION 334-B CALEF HIGHWAY EPPING, NH 03042-2325 (603) 679-5695

SHEET INDEX

LS-1-4

COVER SHEET BOUNDARY PLAN OVERVIEW EXISTING CONDITIONS PLAN EXISTING CONDTIONS PLAN OVR OVERVIEW SITE PLAN SITE PLAN C3 GRADING AND DRAINAGE PLAN UTILITY PLAN LIGHTING PLAN P1-P3 ROAD PLAN AND PROFILI P4-P6 SEWER PROFILES **DETAIL SHEETS** D1-D6 E1 **EROSION AND SEDIMENT CONTROL DETAILS** T1 TRUCK TURNING PLAN

LANDSCAPE PLANS

PROJECT PARCEL CITY OF PORTSMOUTH TAX MAP 297, LOT 11

TOTAL LOT AREA 1,931,721 SQ. FT. ± 44.35 ACRES ±

APPROVED - PORTSMOUTH, NH PLANNING BOARD

DATE:

Design: JAC Draft: LAZ Checked: JAC | Scale: AS NOTED | Project No.: 20737 Drawing Name: 20737-PLAN.dwg THIS PLAN SHALL NOT BE MODIFIED WITHOUT WRITTEN PERMISSION FROM JONES & BEACH ENGINEERS, INC. (JBE) ANY ALTERATIONS, AUTHORIZED OR OTHERWISE, SHALL BE

AT THE USER'S SOLE RISK AND WITHOUT LIABILITY TO JBE.

RETAINING WALL




-	6	6/22/21	REVISIONS PER TOWN REVIEW	LAZ
	5	5/5/21	REVISIONS	LAZ
1	4	3/18/21	ADDED DETAIL	LAZ
1	3	3/3/21	ADDED SURVEY INFO	LAZ
	2	1/6/21	MINOR REVISIONS	DJM
	REV.	DATE	REVISION	BY

Designed and Produced in NH Jones & Beach Engineers, Inc. Civil Engineering Services 603-772-4746 FAX: 603-772-0227 PO Box 219


Plan Name:	COVER SHEET
Project:	3400 LAFAYETTE ROAD PORTSMOUTH, NH
Owner of Record: 225 B	RICCI CONSTRUCTION CO., INC. ANFIELD ROAD, PORTSMOUTH, NH 03801 BK 1930 PG 0229

CS SHEET 1 OF 25 JBE PROJECT NO. 20737

DRAWING No.

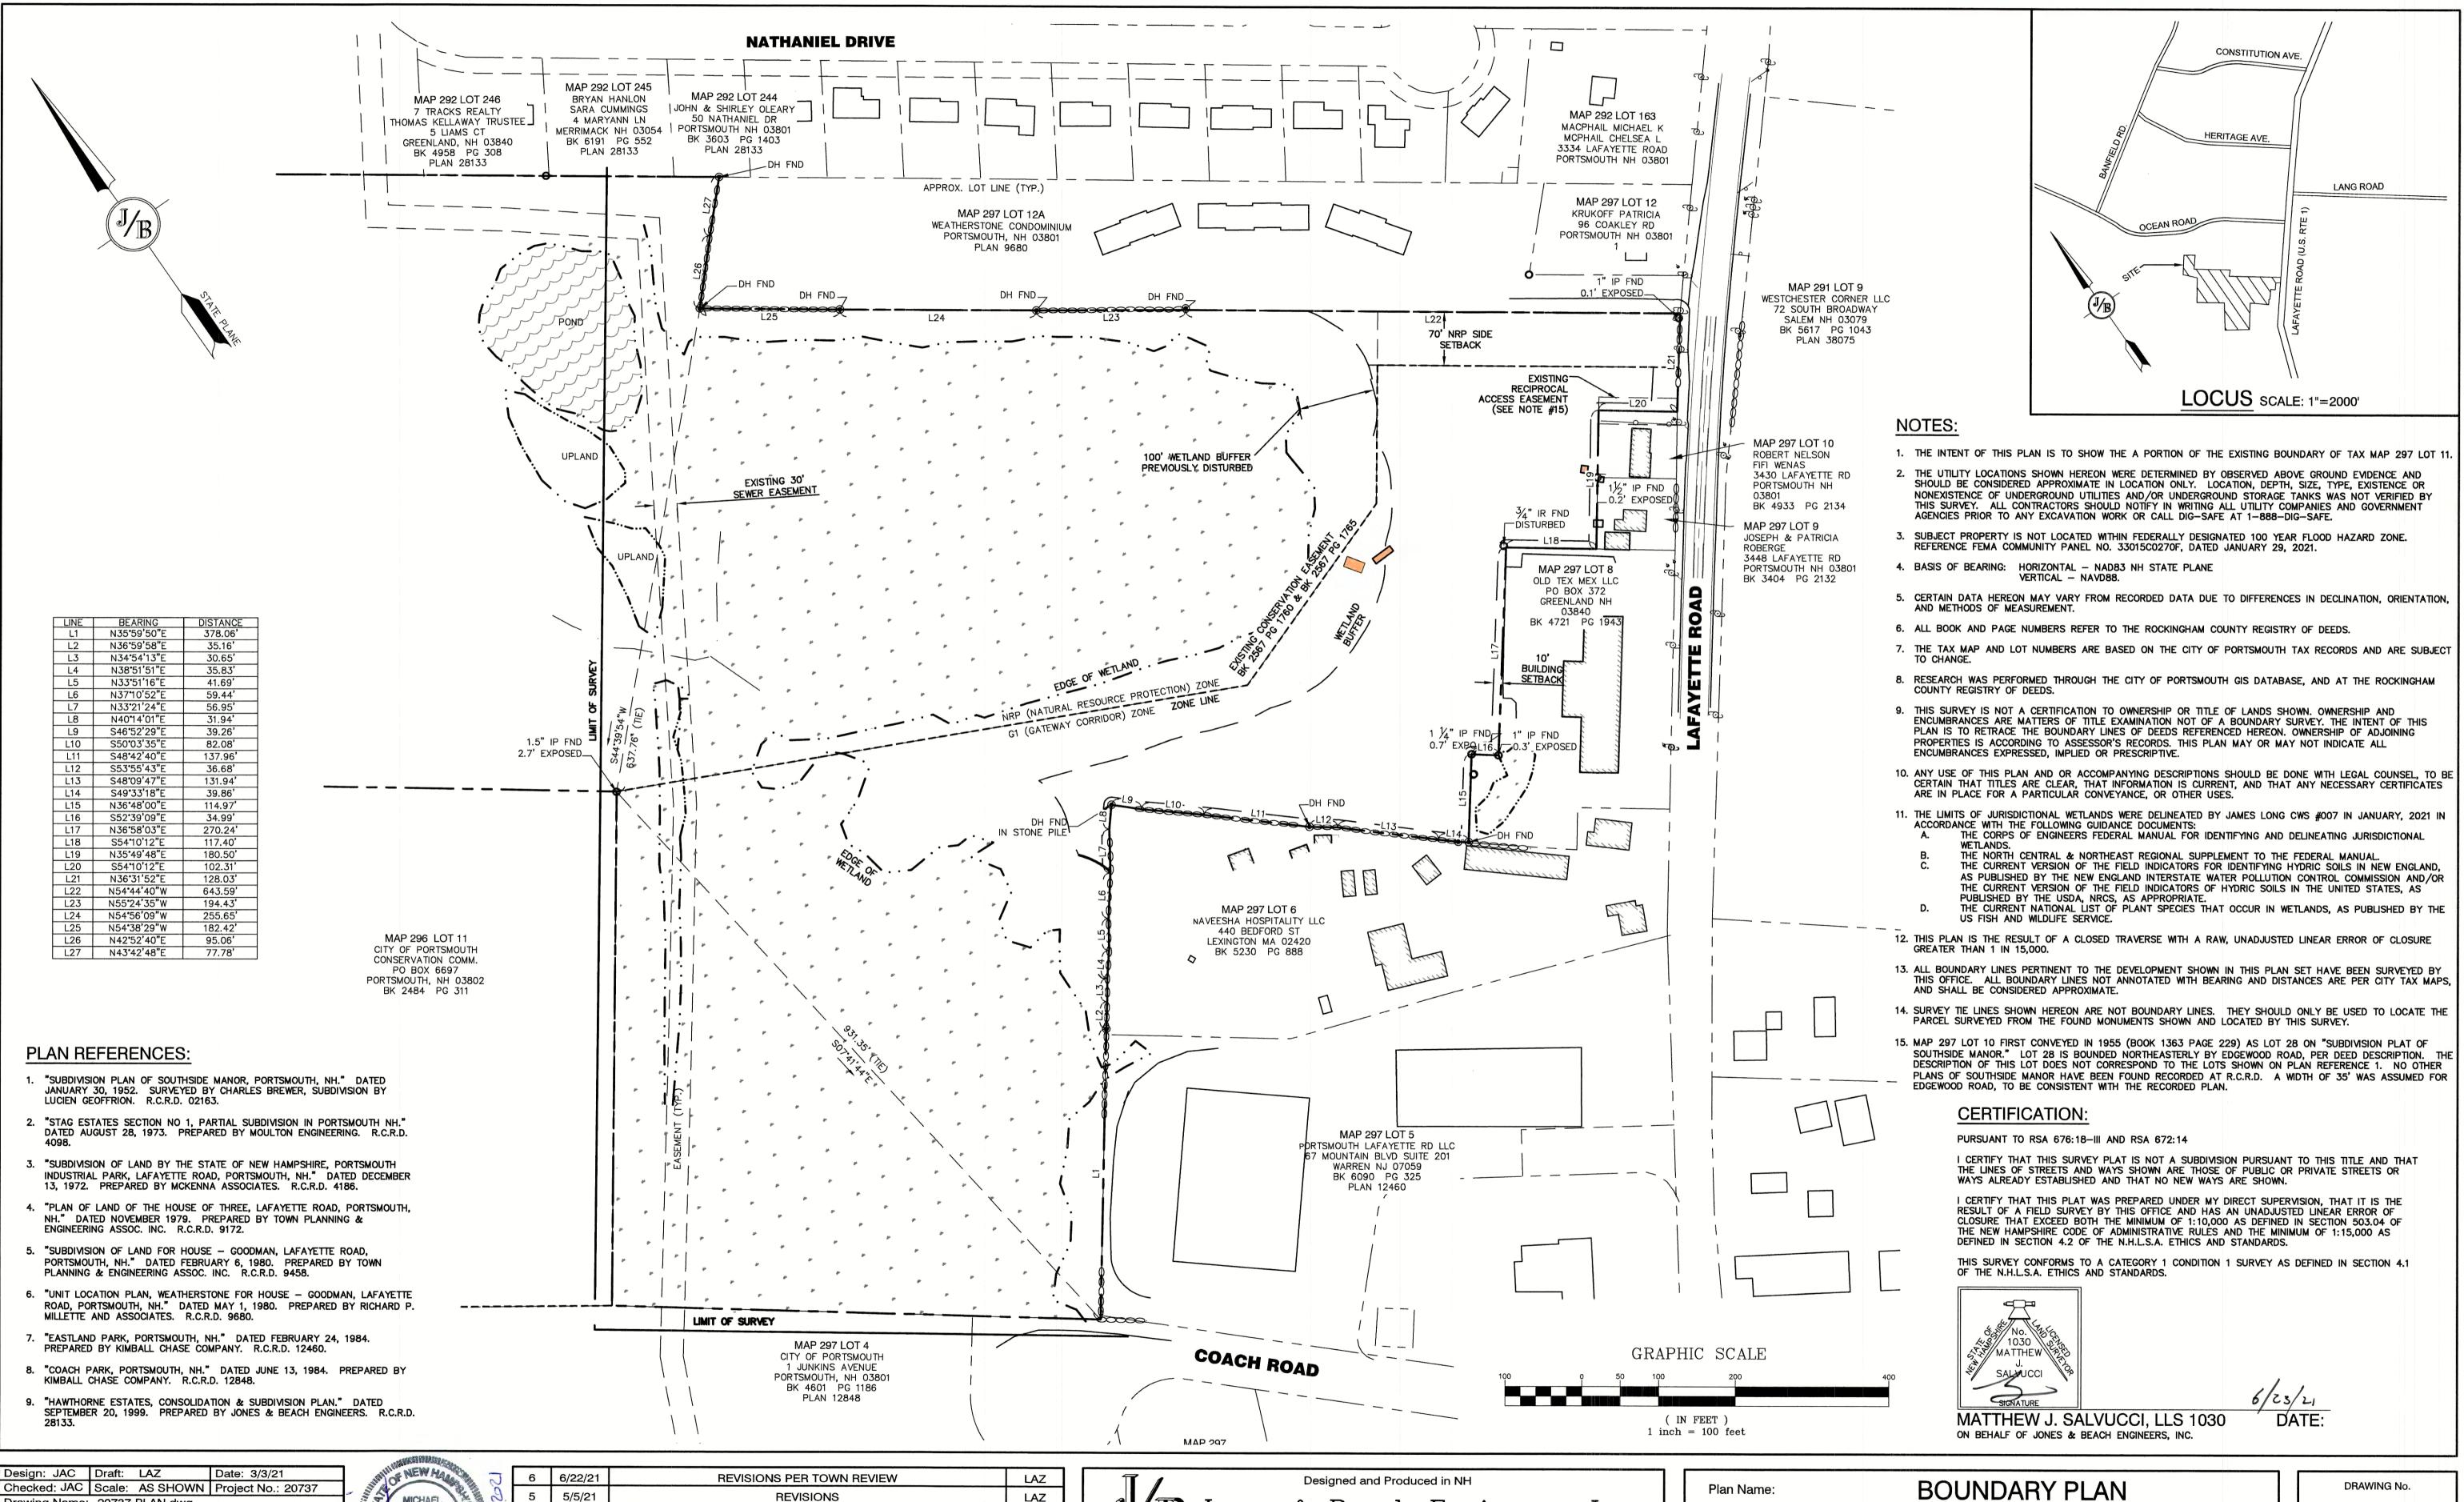

Checked: JAC | Scale: AS SHOWN | Project No.: 20737 rawing Name: 20737-PLAN.dwg HIS PLAN SHALL NOT BE MODIFIED WITHOUT WRITTEN PERMISSION FROM JONES & BEACH ENGINEERS, INC. (JBE). ANY ALTERATIONS, AUTHORIZED OR OTHERWISE, SHALL BE AT THE USER'S SOLE RISK AND WITHOUT LIABILITY TO JBE.

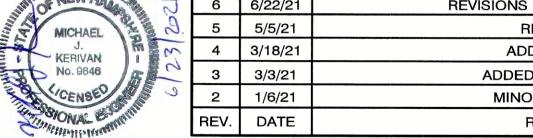

6/23/2021	6	6/22/21	REVISIONS PER TOWN REVIEW	LAZ
	5	5/5/21	REVISIONS	LAZ
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	3	3/3/21	ADDED SURVEY INFO	LAZ
	2	1/6/21	MINOR REVISIONS	DJM
	REV.	DATE	REVISION	BY

Jones & Beach Engineers, Inc. 85 Portsmouth Ave. Civil Engineering Services 603-772-4746 FAX: 603-772-0227


E-MAIL: JBE@JONESANDBEACH.COM

PO Box 219

Stratham, NH 03885

Project:	3400 LAFAYETTE ROAD	
	PORTSMOUTH, NH	
Owner of Record:	RICCI CONSTRUCTION CO., INC.	
225 BAN	FIELD ROAD, PORTSMOUTH, NH 03801 BK 1930 PG 0229	

SHEET 2 OF 25 JBE PROJECT NO. 20737

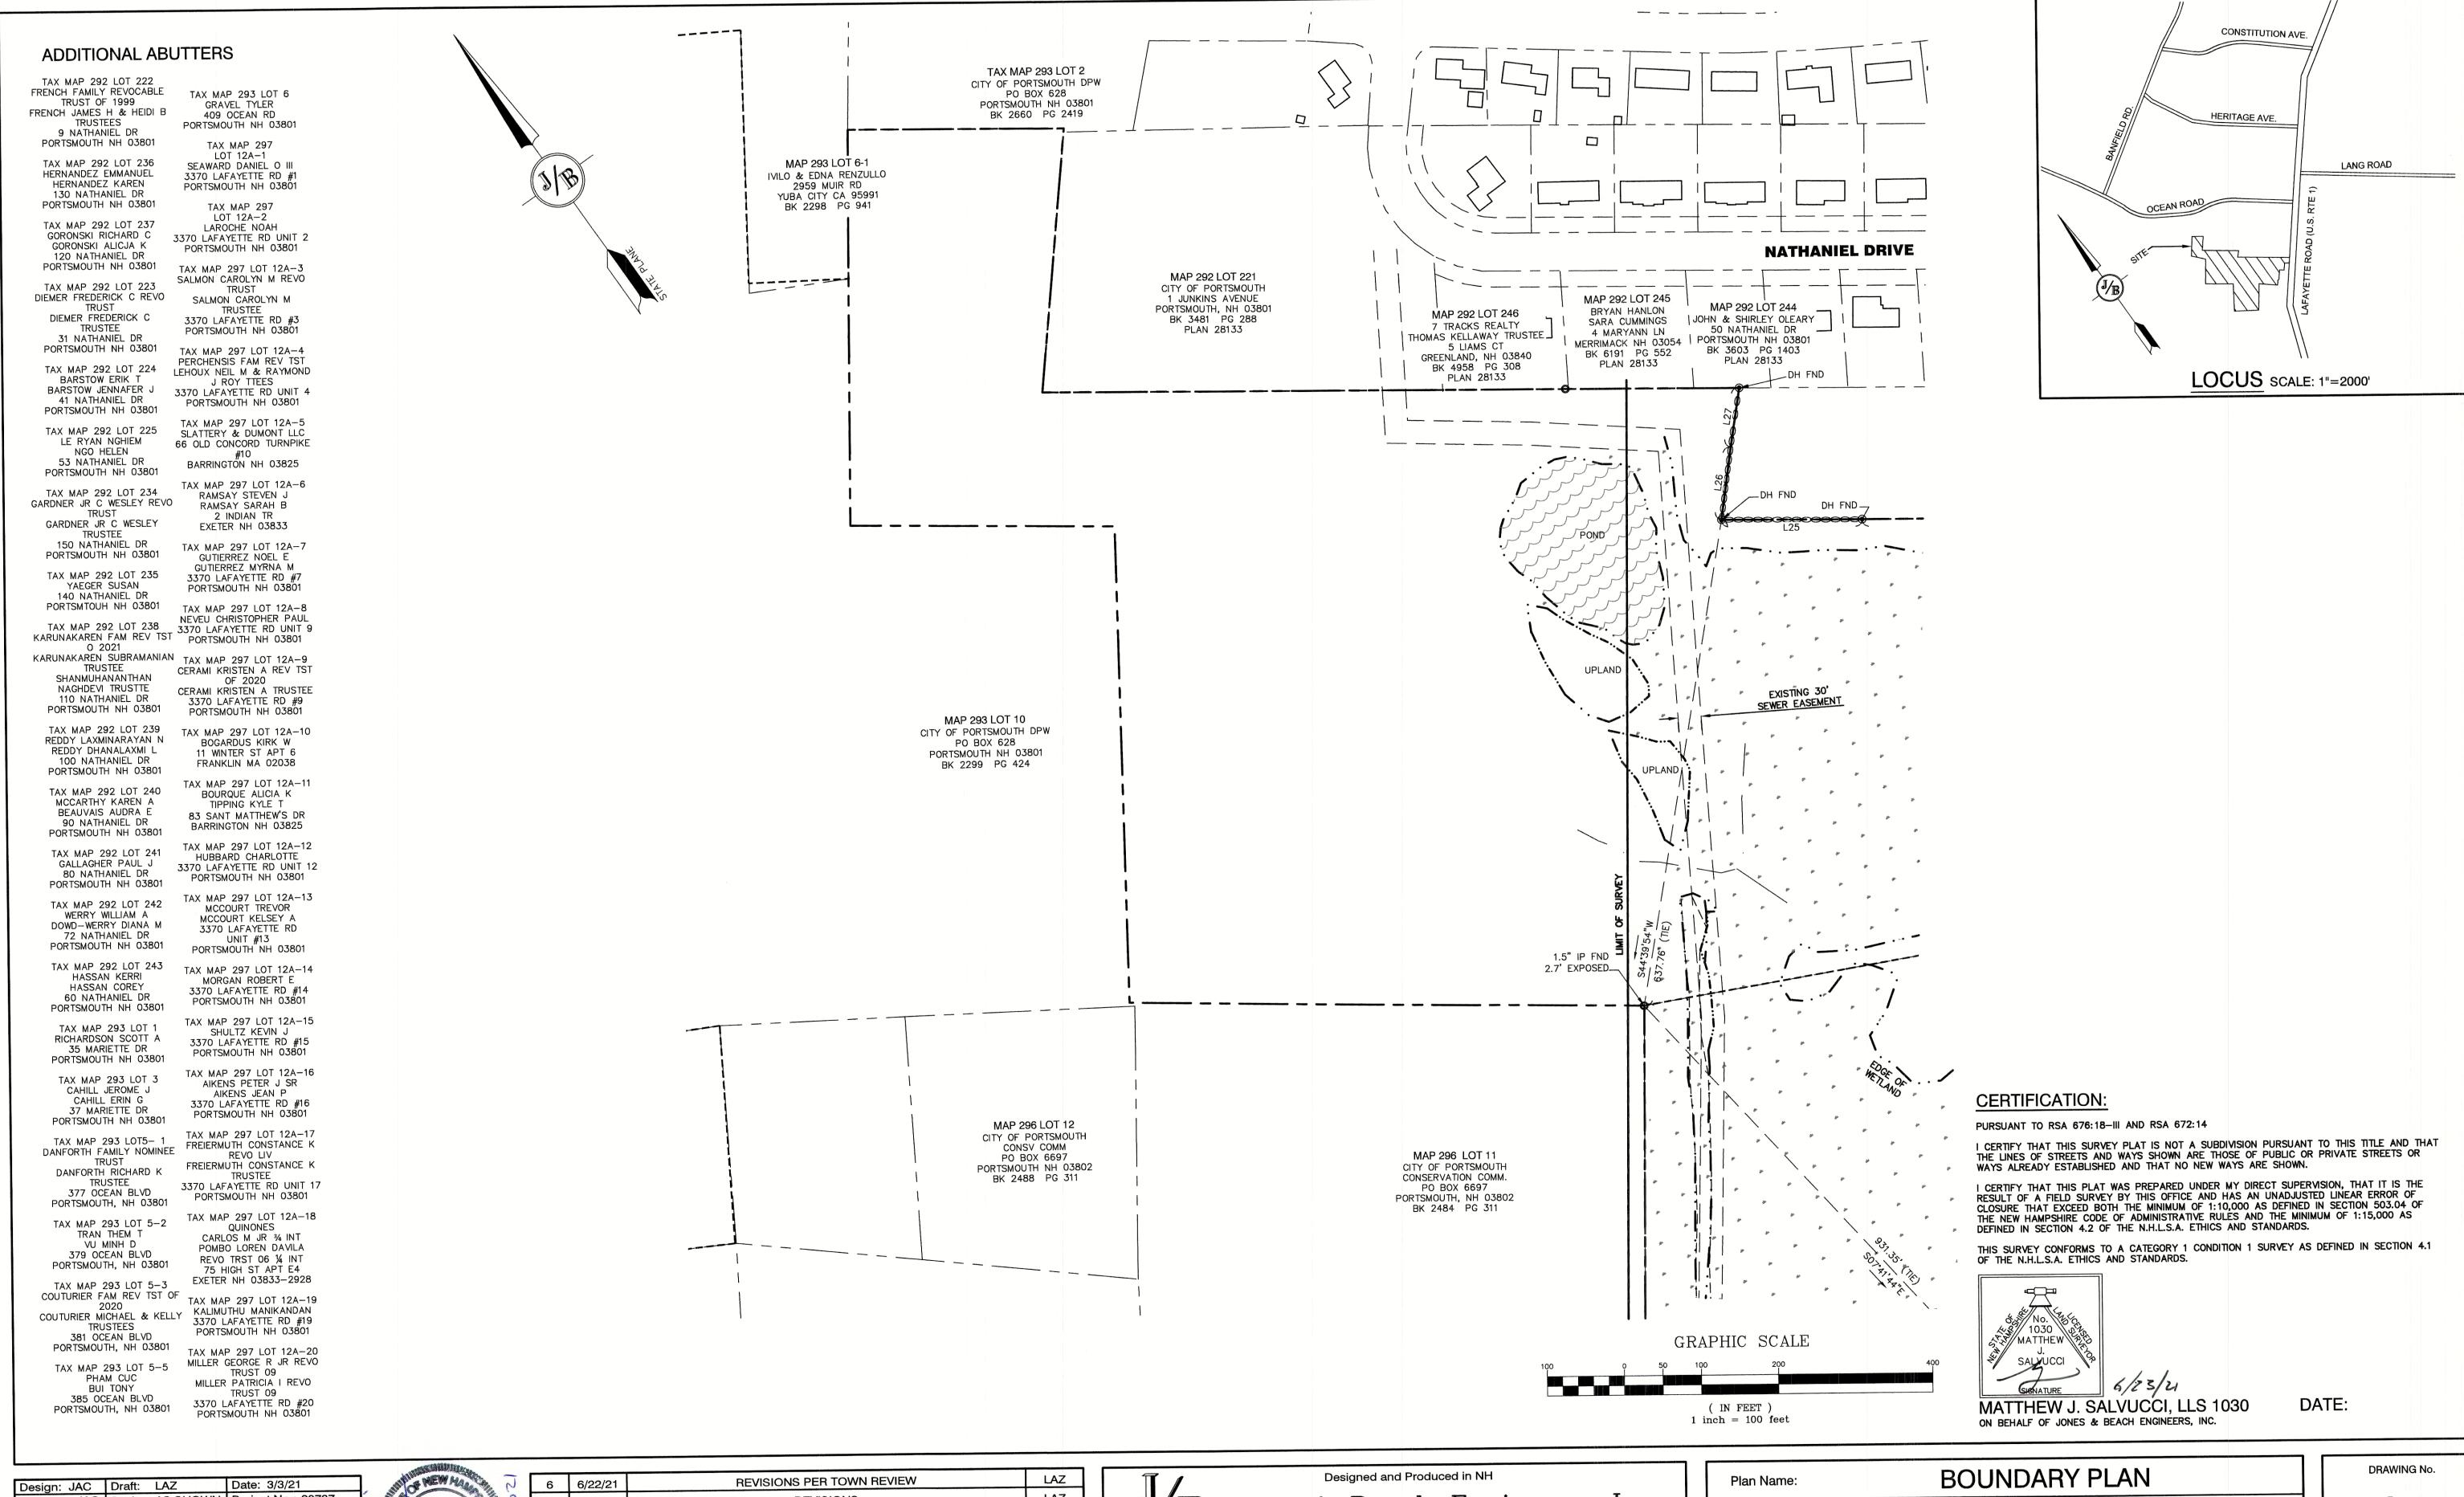

PO Box 219

Stratham, NH 03885

Checked: JAC Scale: AS SHOWN Project No.: 20737

Drawing Name: 20737-PLAN.dwg

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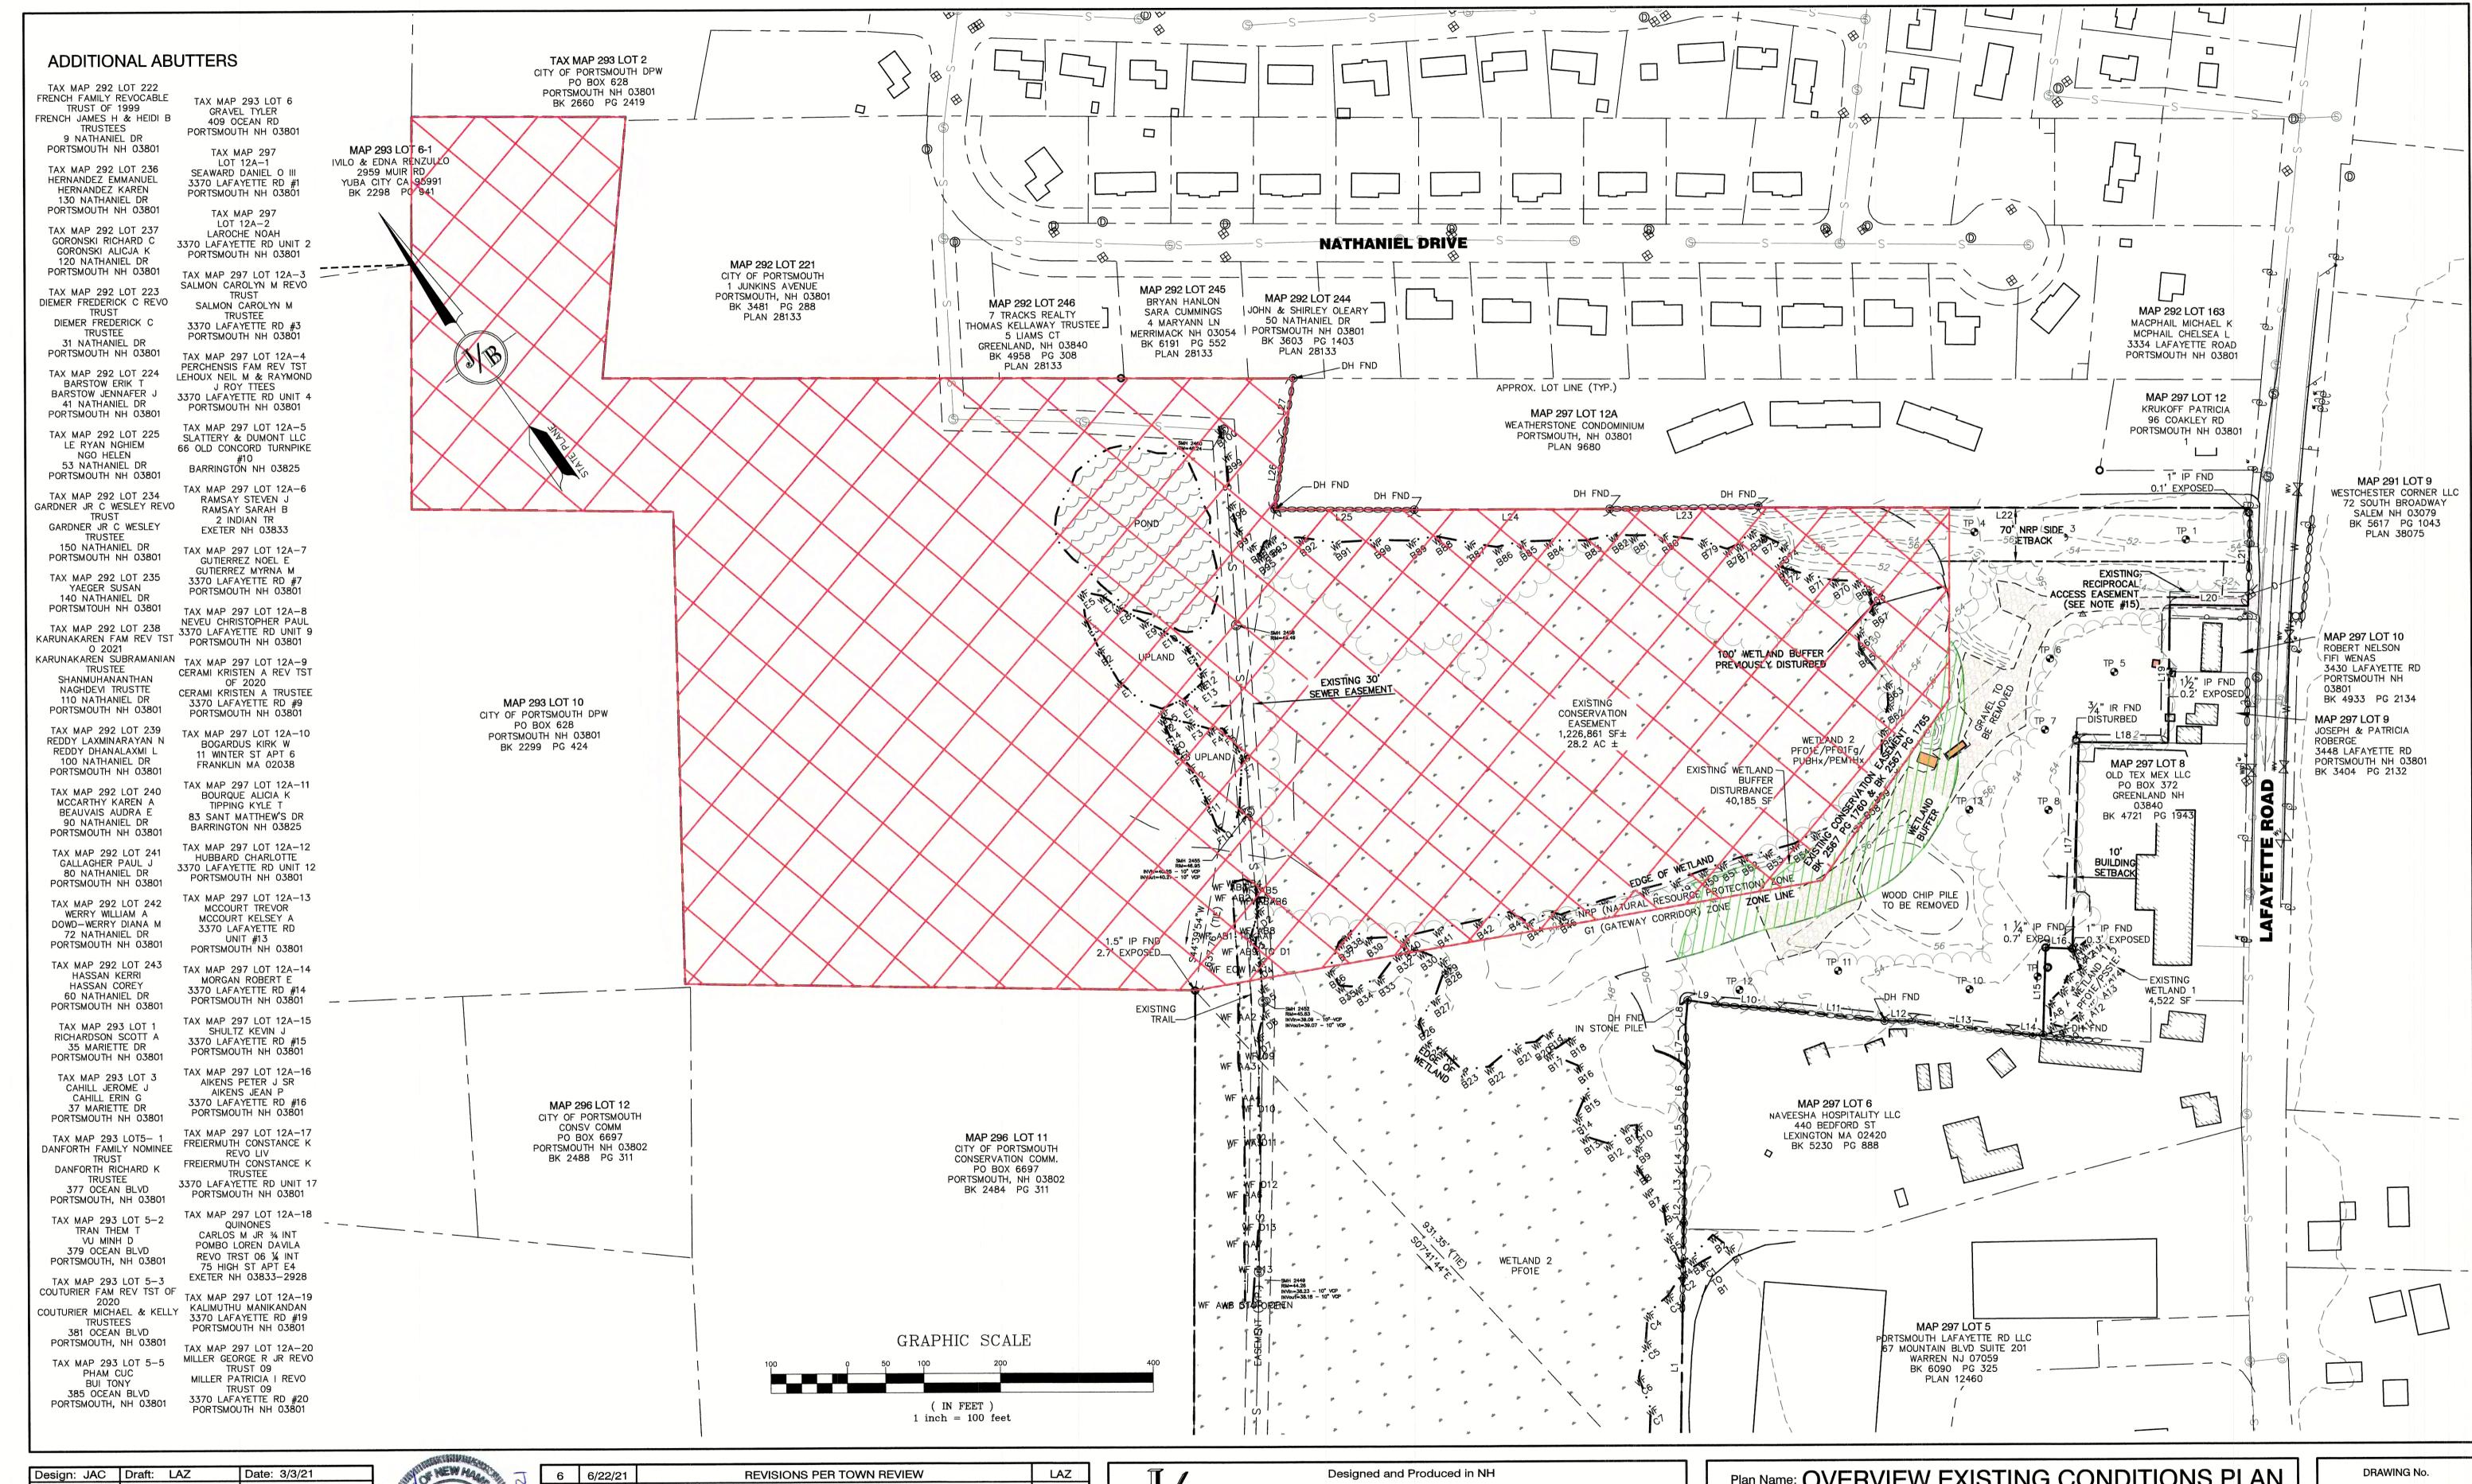
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	2	1/6/21	MINOR REVISIONS	DJM
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E-MAIL: JBE@JONESANDBEACH.COM

Plan Name:	BOUNDARY PLAN	
Project:	3400 LAFAYETTE ROAD PORTSMOUTH, NH	
Owner of Record: 225 B	RICCI CONSTRUCTION CO., INC. SANFIELD ROAD, PORTSMOUTH, NH 03801 BK 1930 PG 0229	

SHEET 3 OF 25
JBE PROJECT NO. 20737



PO Box 219

Stratham, NH 03885

Design: JAC	Draft:	LAZ	Date: 3/3/21
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			LIABILITY TO JBE.




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	3	3/3/21	ADDED SURVEY INFO	LAZ
	2	1/6/21	MINOR REVISIONS	DJM
	REV.	DATE	REVISION	BY

Jones & Beach Engineers, Inc. 603-772-4746 85 Portsmouth Ave. Civil Engineering Services FAX: 603-772-0227

E-MAIL: JBE@JONESANDBEACH.COM

Plan Name: OVER	VIEW EXISTING CONDITIONS PLAN
Project:	3400 LAFAYETTE ROAD PORTSMOUTH, NH
Owner of Record: 225 BA	RICCI CONSTRUCTION CO., INC. NFIELD ROAD, PORTSMOUTH, NH 03801 BK 1930 PG 0229



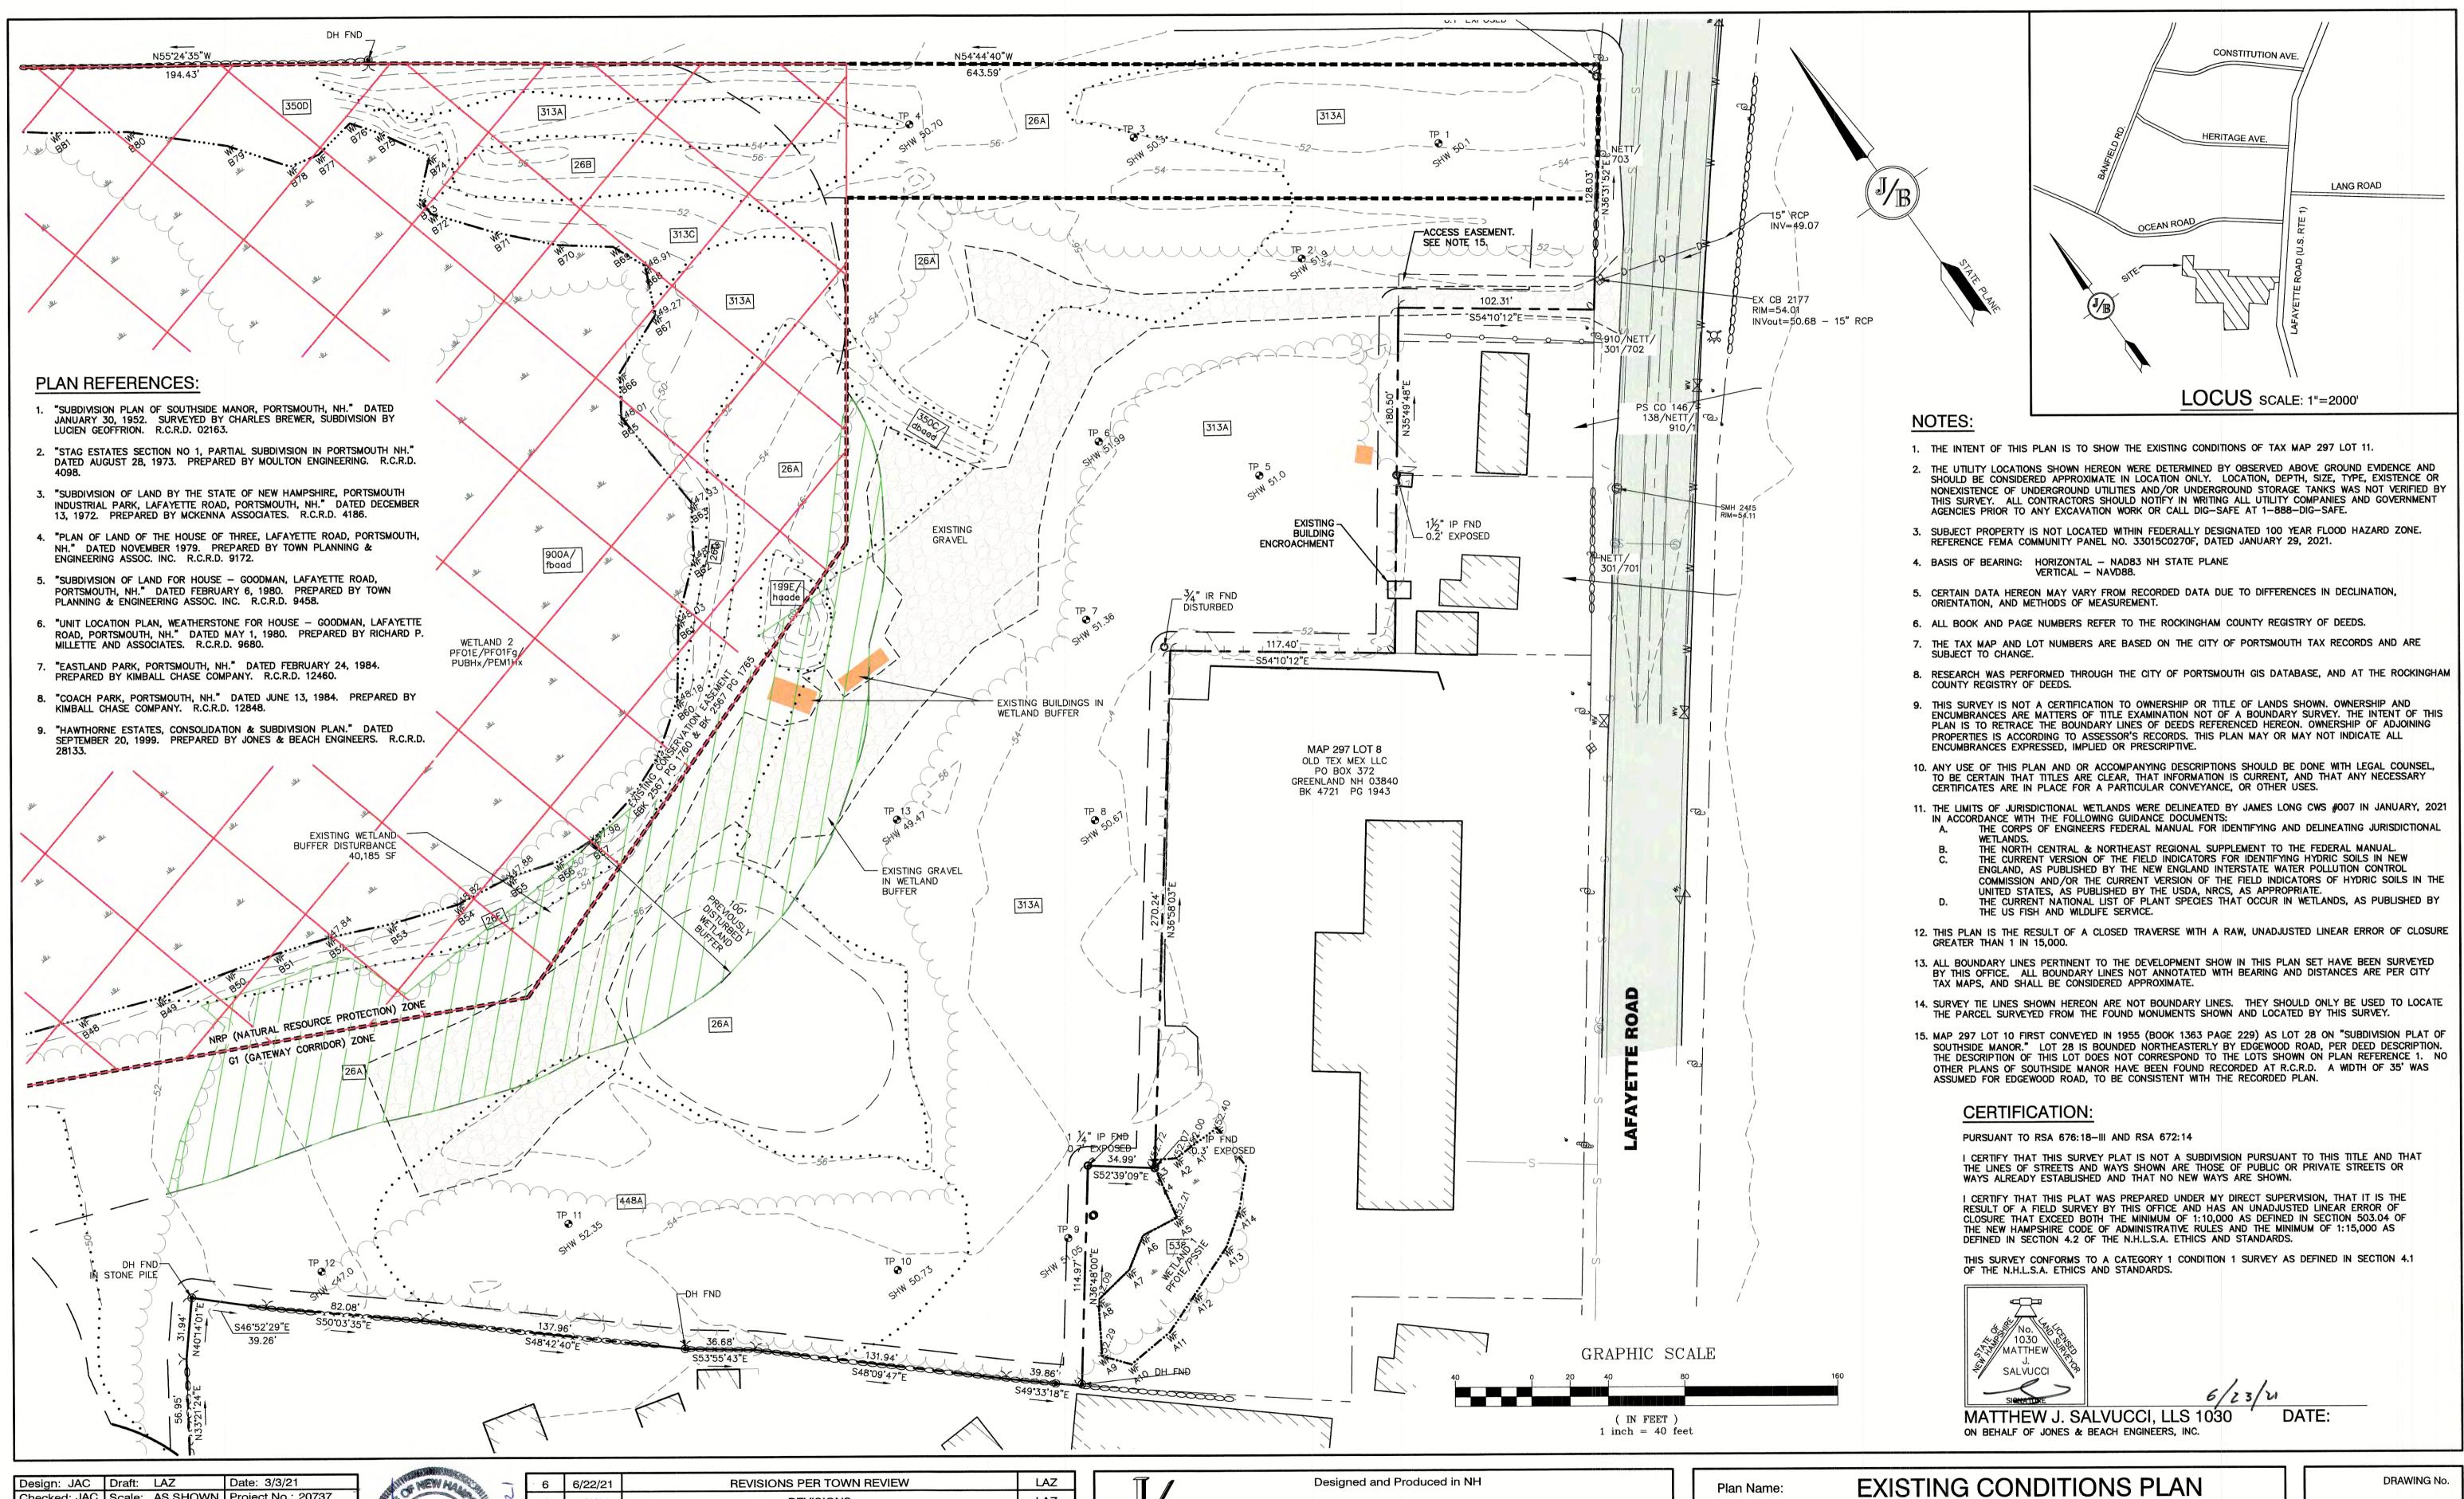

Checked: JAC | Scale: AS SHOWN | Project No.: 20737 Drawing Name: 20737-PLAN.dwg THIS PLAN SHALL NOT BE MODIFIED WITHOUT WRITTEN PERMISSION FROM JONES & BEACH ENGINEERS, INC. (JBE). ANY ALTERATIONS, AUTHORIZED OR OTHERWISE, SHALL BE AT THE USER'S SOLE RISK AND WITHOUT LIABILITY TO JBE.



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	3	3/3/21	ADDED SURVEY INFO	LAZ
	2	1/6/21	MINOR REVISIONS	DJM
	REV.	DATE	REVISION	BY

Jones & Beach Engineers, Inc. 603-772-4746

85 Portsmouth Ave. Civil Engineering Services PO Box 219 E-MAIL: JBE@JONESANDBEACH.COM Stratham, NH 03885

Project:

FAX: 603-772-0227


Owner of Record: 225 BANFIELD ROAD, PORTSMOUTH, NH 03801 BK 1930 PG 0229

3400 LAFAYETTE ROAD PORTSMOUTH, NH

RICCI CONSTRUCTION CO., INC.

SHEET 5 OF 25

JBE PROJECT NO. 20737

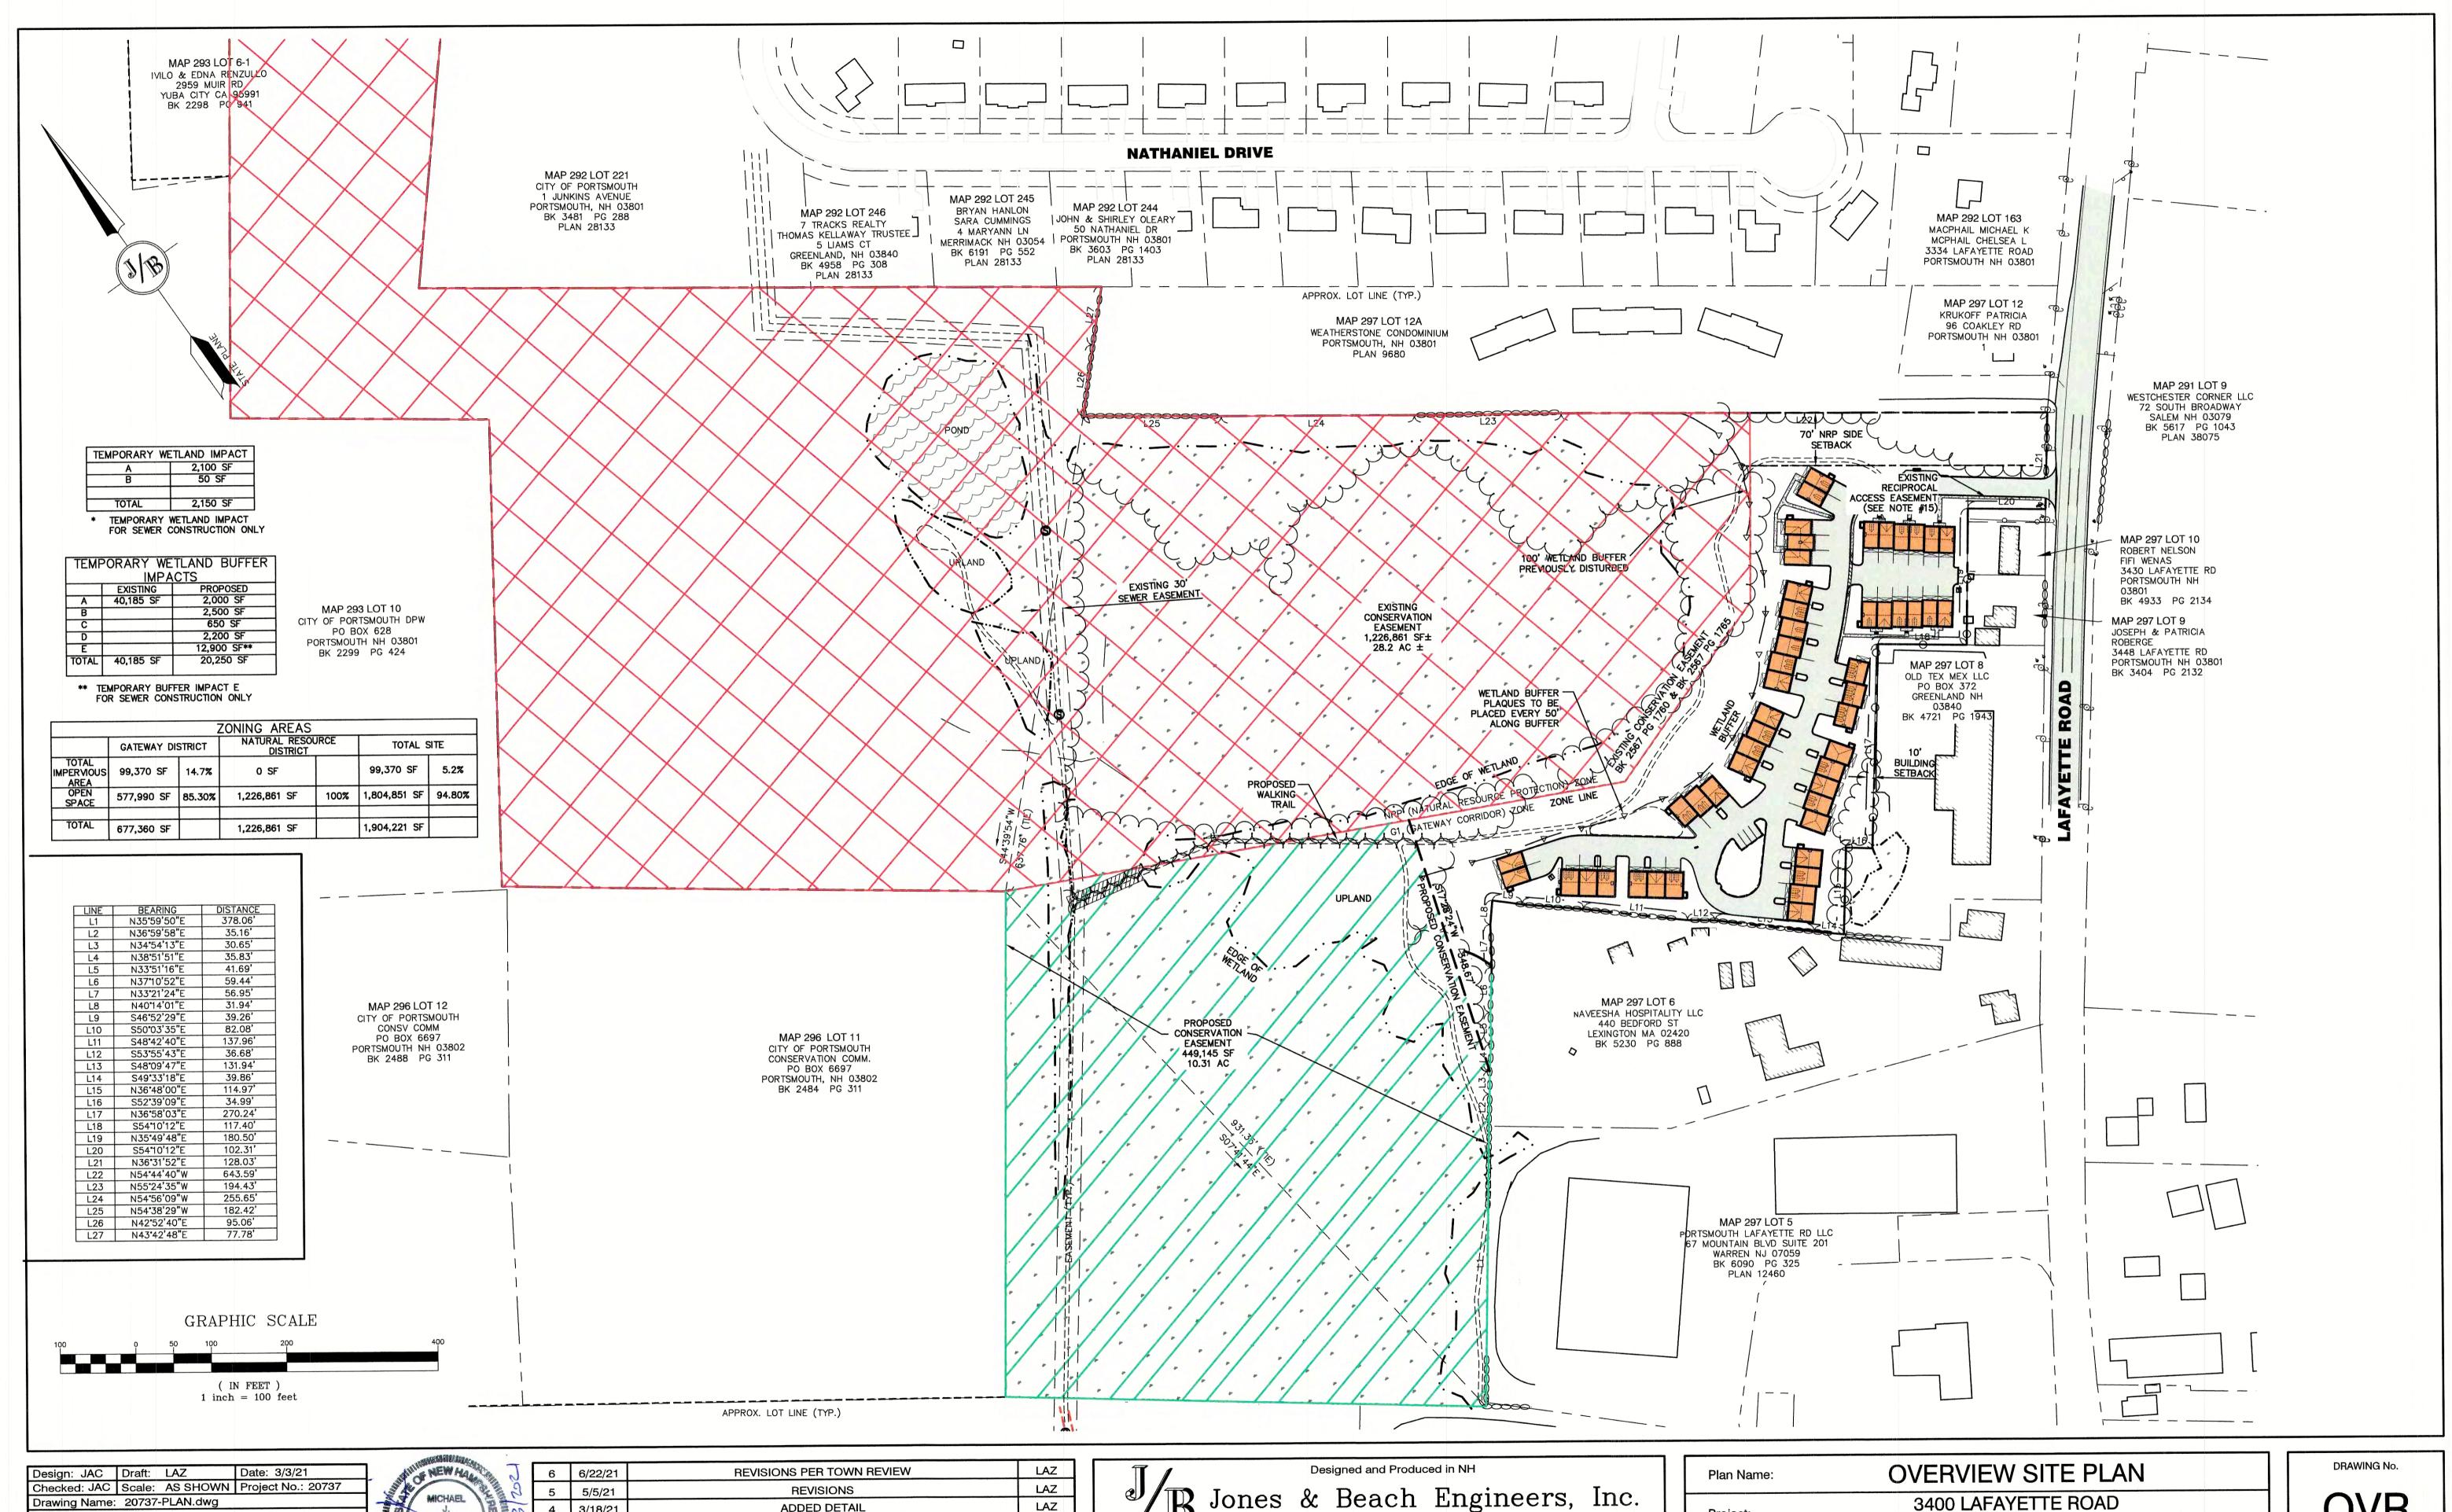

Stratham, NH 03885

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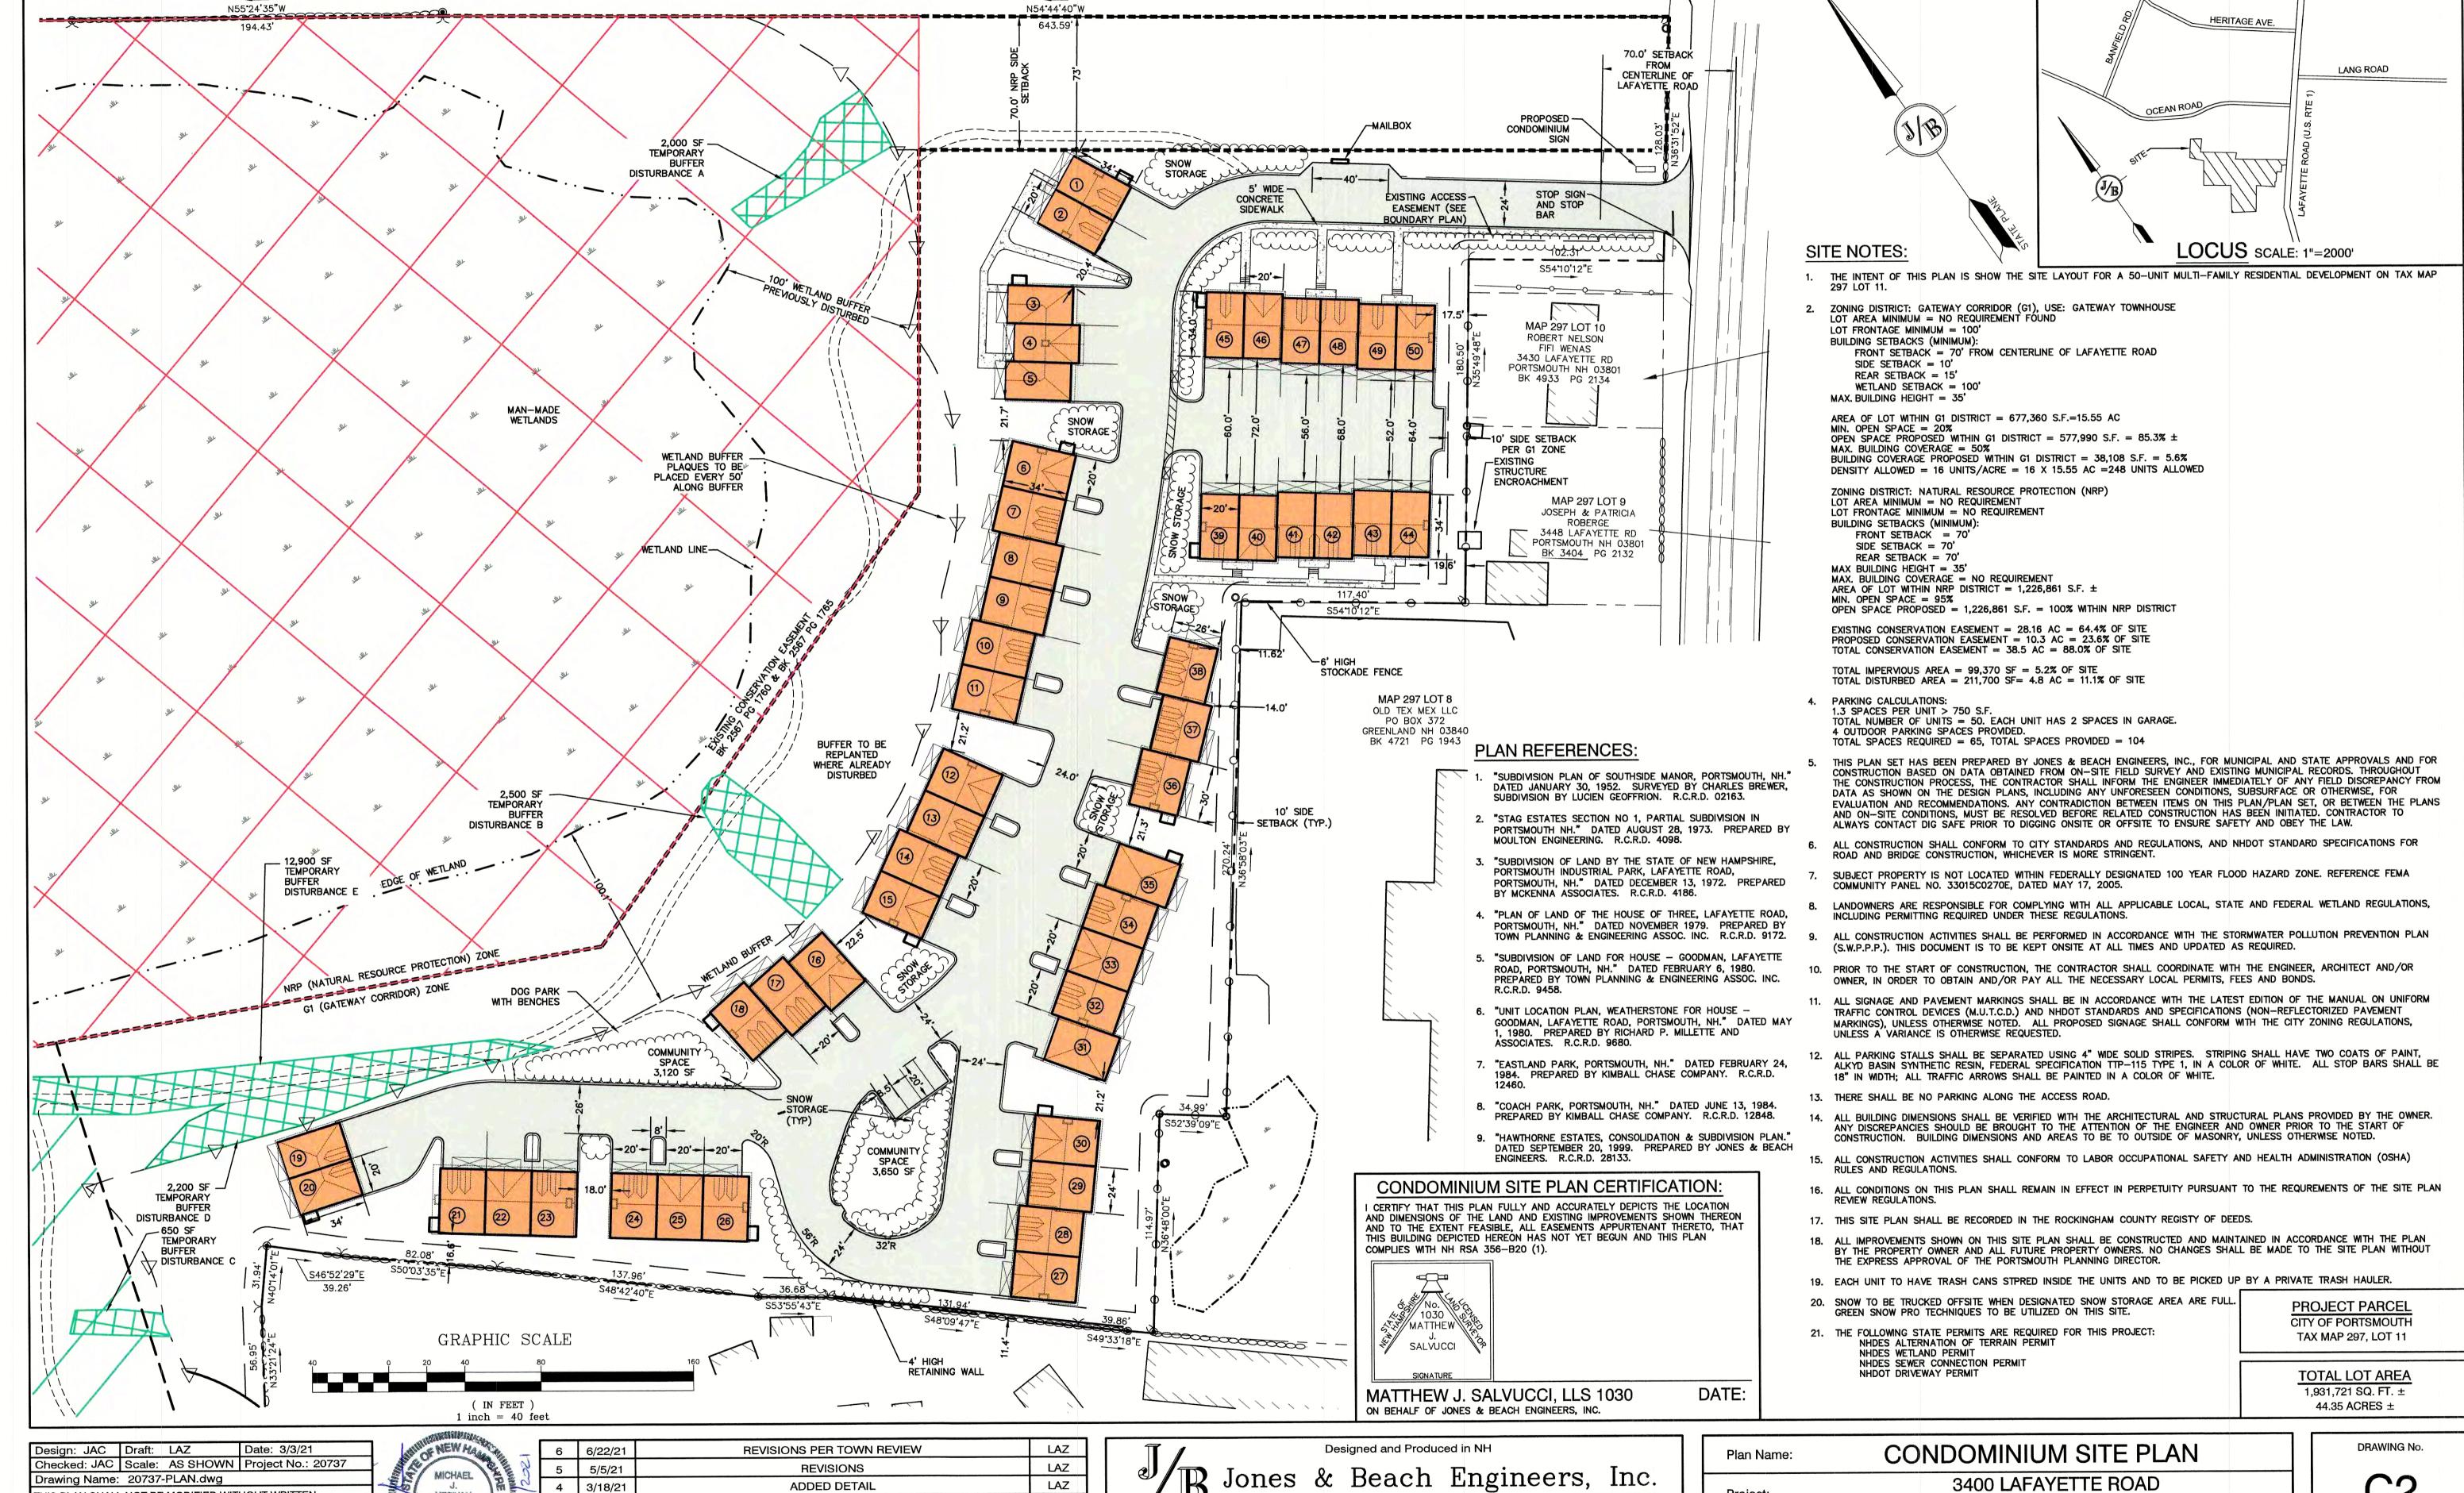
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Jones & Beach Engineers, Inc.

603-772-4746 85 Portsmouth Ave. Civil Engineering Services FAX: 603-772-0227 PO Box 219 E-MAIL: JBE@JONESANDBEACH.COM

Plan Name:	OVERVIEW SITE PLAN
Project:	3400 LAFAYETTE ROAD PORTSMOUTH, NH
Owner of Record: 225 BANFIELD	RICCI CONSTRUCTION CO., INC. ROAD, PORTSMOUTH, NH 03801 BK 1930 PG 0229

SHEET 6 OF 25 JBE PROJECT NO. 20737



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6/23/2021	6	6/22/21	REVISIONS PER TOWN REVIEW	LAZ
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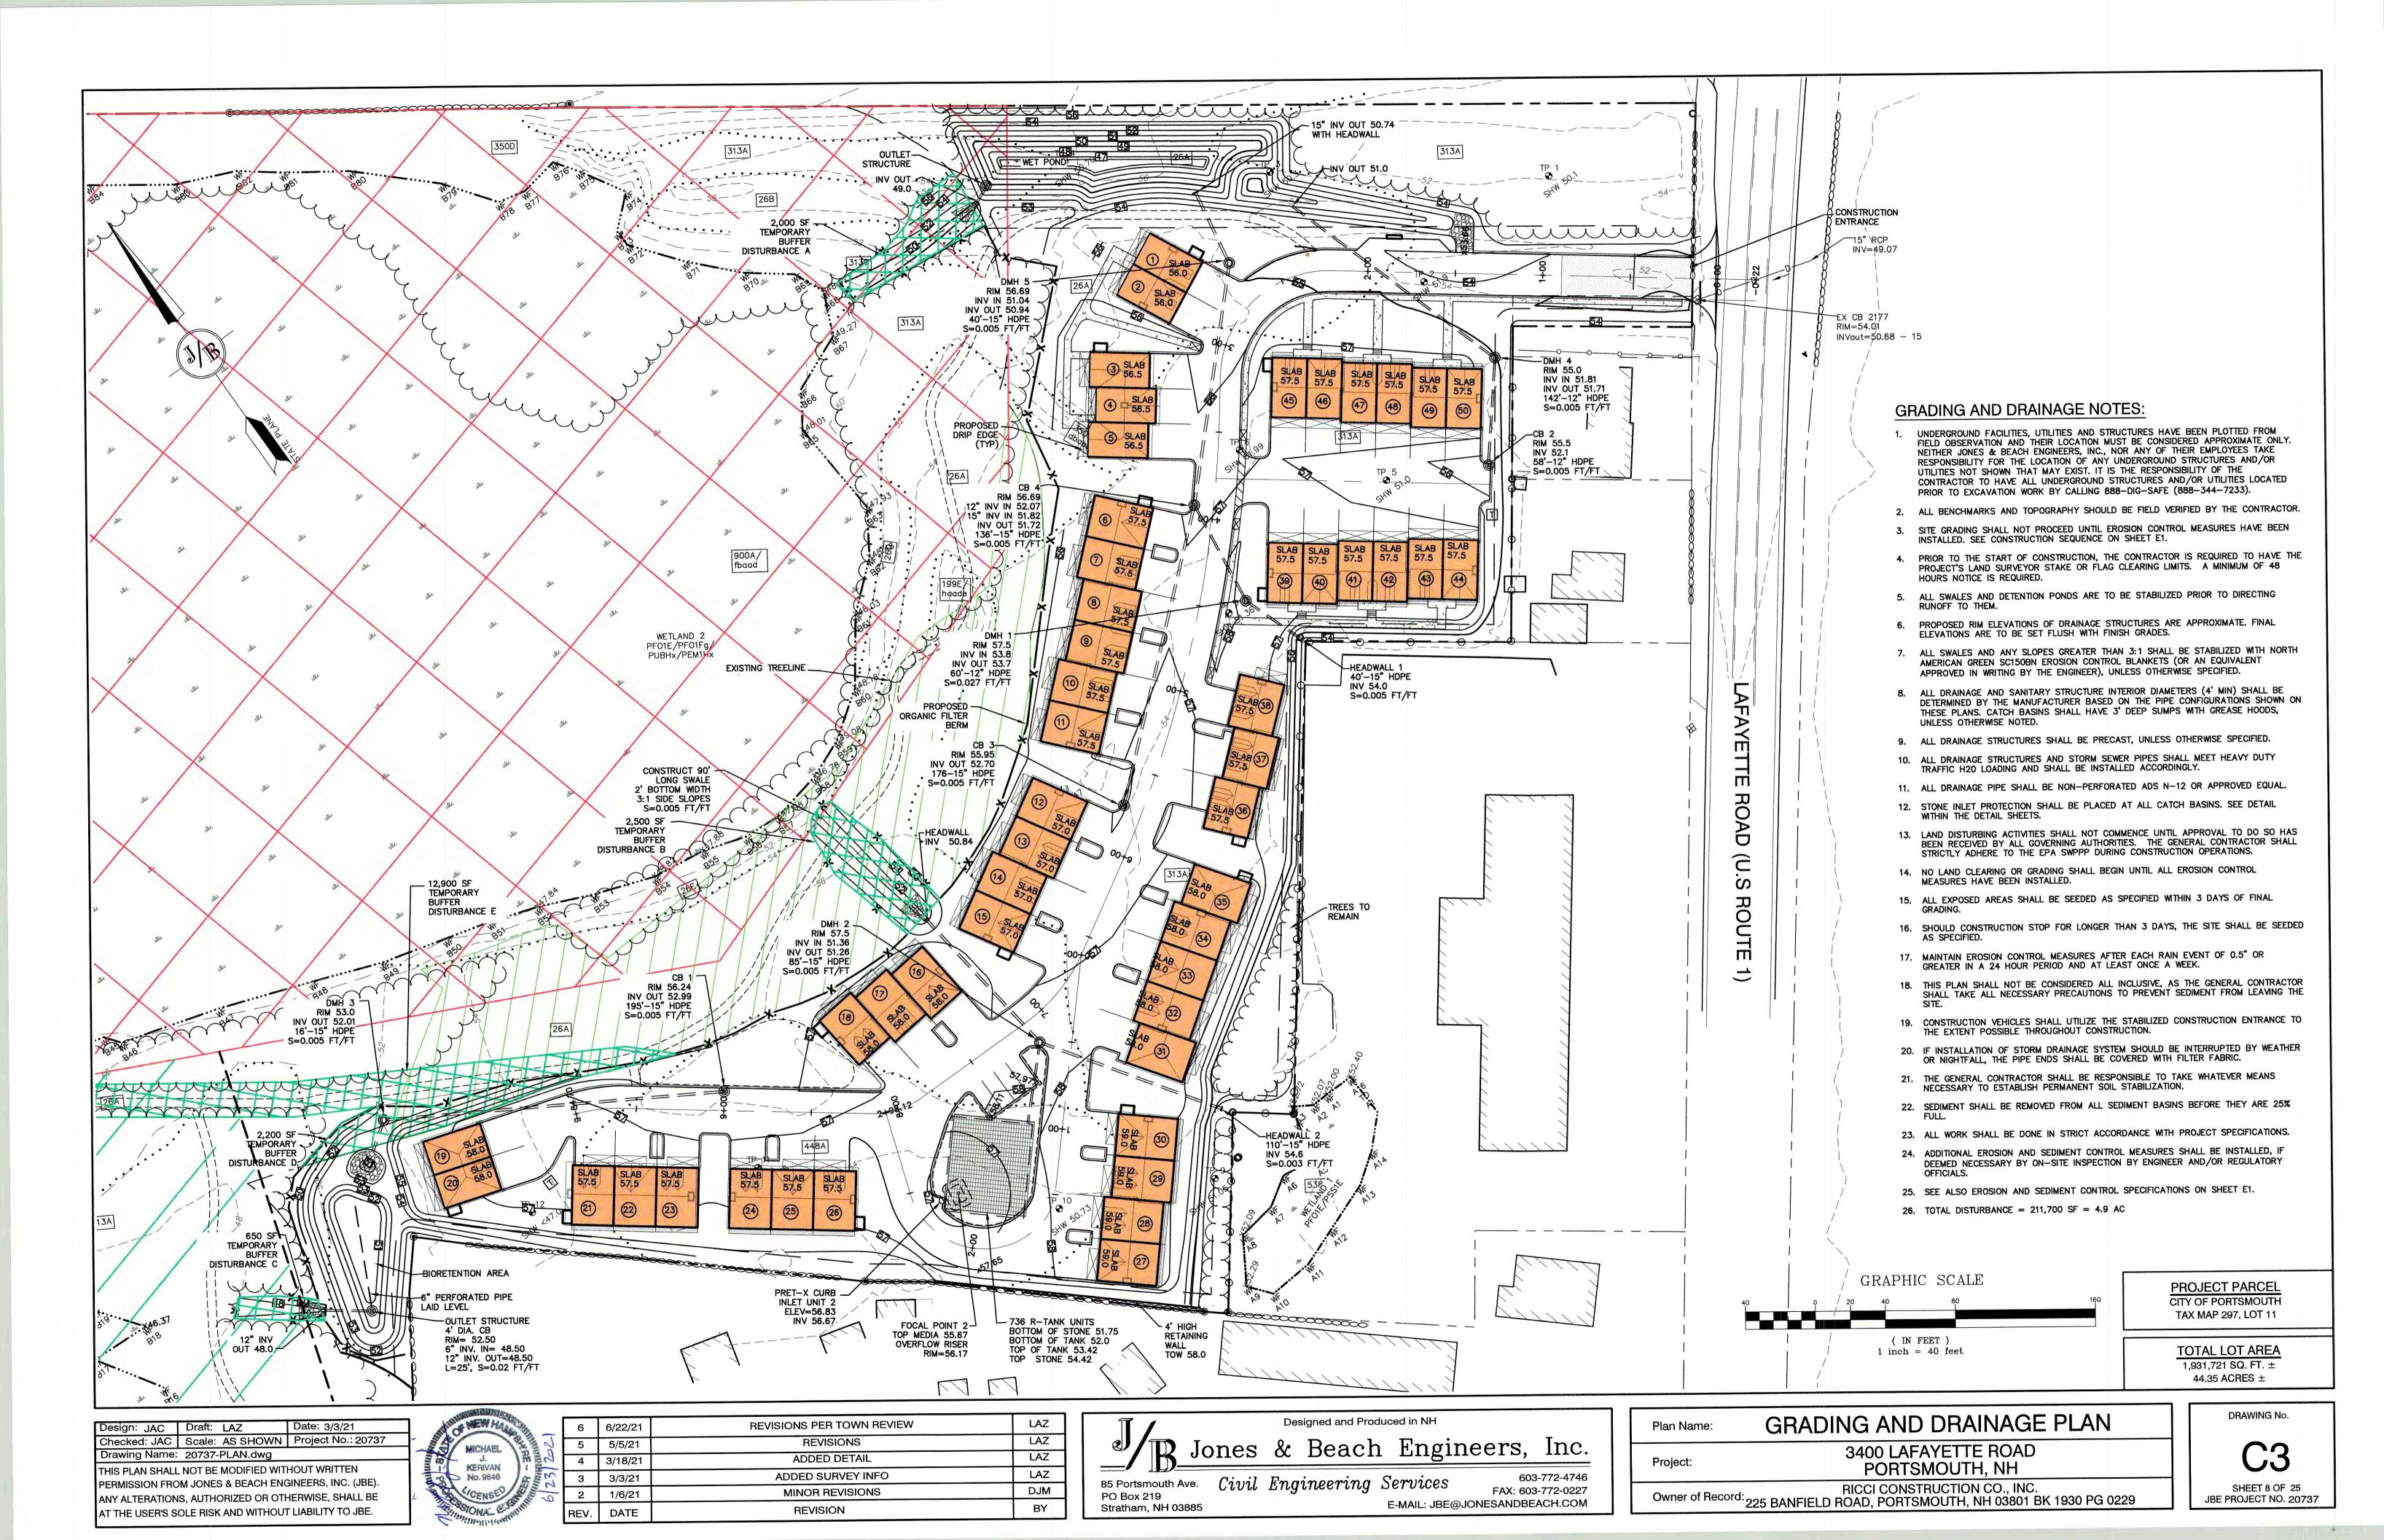
85 Portsmouth Ave. Civil Engineering Services PO Box 219 Stratham, NH 03885

603-772-4746 FAX: 603-772-0227 E-MAIL: JBE@JONESANDBEACH.COM Project:

PORTSMOUTH, NH

RICCI CONSTRUCTION CO., INC. 225 BANFIELD ROAD, PORTSMOUTH, NH 03801 BK 1930 PG 0229

SHEET 7 OF 25 JBE PROJECT NO. 20737





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3400 LAFAYETTE ROAD PORTSMOUTH, NH

Drawing Name: 20737-PLAN.dwg THIS PLAN SHALL NOT BE MODIFIED WITHOUT WRITTEN PERMISSION FROM JONES & BEACH ENGINEERS, INC. (JBE). ANY ALTERATIONS, AUTHORIZED OR OTHERWISE, SHALL BE AT THE USER'S SOLE RISK AND WITHOUT LIABILITY TO JBE.

REVISIONS 5/5/21 MICHAEL ADDED DETAIL 4 3/18/21 KERIVAN ADDED SURVEY INFO 3/3/21 No. 9846 MINOR REVISIONS 2 1/6/21 REVISION DATE REV.

Jones & Beach Engineers, Inc. 603-772-4746

85 Portsmouth Ave. Civil Engineering Services PO Box 219 Stratham, NH 03885


FAX: 603-772-0227 E-MAIL: JBE@JONESANDBEACH.COM

RICCI CONSTRUCTION CO., INC. Owner of Record. 225 BANFIELD ROAD, PORTSMOUTH, NH 03801 BK 1930 PG 0229

Project:

SHEET 9 OF 25 JBE PROJECT NO. 20737

DRAWING No.

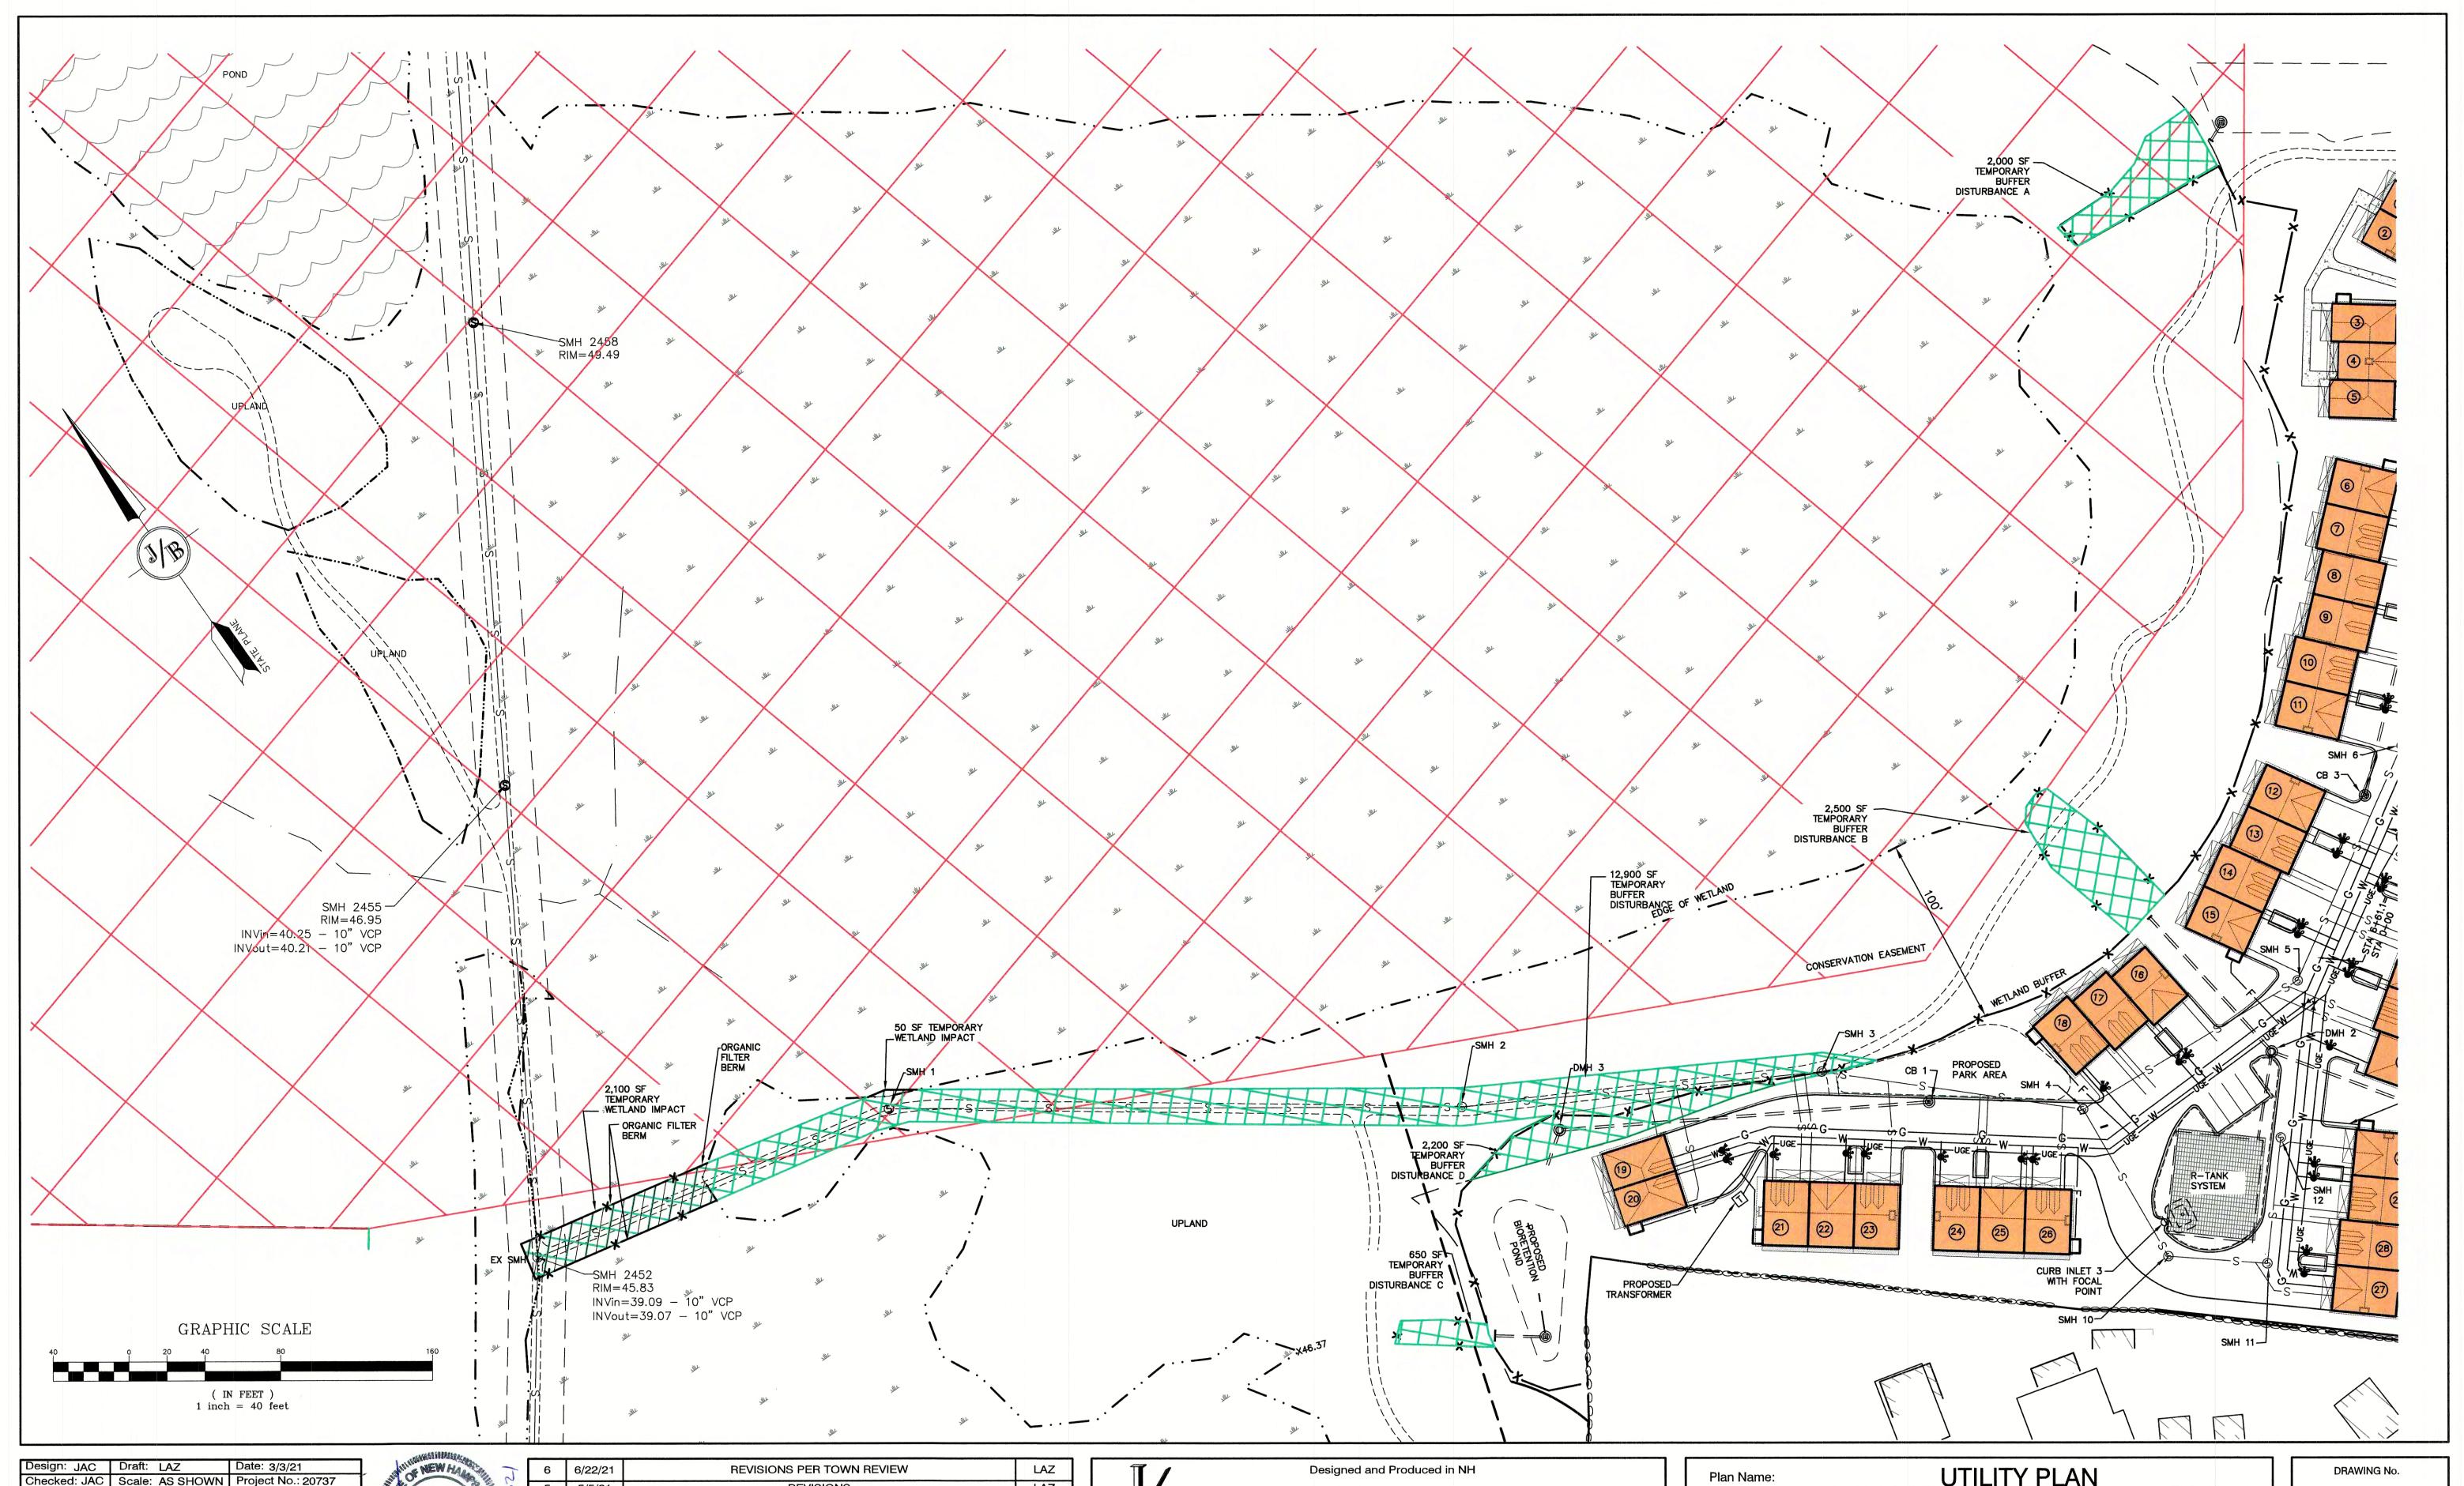

Checked: JAC | Scale: AS SHOWN | Project No.: 20737 Drawing Name: 20737-PLAN.dwg THIS PLAN SHALL NOT BE MODIFIED WITHOUT WRITTEN PERMISSION FROM JONES & BEACH ENGINEERS, INC. (JBE). ANY ALTERATIONS, AUTHORIZED OR OTHERWISE, SHALL BE AT THE USER'S SOLE RISK AND WITHOUT LIABILITY TO JBE.



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	REV.	DATE	REVISION	BY

Jones & Beach Engineers, Inc. 85 Portsmouth Ave. Civil Engineering Services

PO Box 219

Stratham, NH 03885

603-772-4746 FAX: 603-772-0227 E-MAIL: JBE@JONESANDBEACH.COM

UTILITY PLAN 3400 LAFAYETTE ROAD PORTSMOUTH, NH Project: Owner of Record: RICCI CONSTRUCTION CO., INC. 225 BANFIELD ROAD, PORTSMOUTH, NH 03801 BK 1930 PG 0229

SHEET 10 OF 25 JBE PROJECT NO. 20737



DESCRIPTION

The Traditionaire LED outdoor luminaire displays the old-fashioned charm of traditional area lighting, enhancing any setting with distinctive styling. As a decorative luminaire, the Traditionaire LED tastefully complements the architectural and environmental design of parks and roadways. The high-lumen downlight configuration uses Cooper Lighting Solutions' patented LightBAR™ technology to deliver uniform and efficient illumination to pedestrian and roadway applications.

Туре Date

Streetworks

SPECIFICATION FEATURES

Construction

Hinged (stainless steel hinge pins) die-cast aluminum housing and cover with cupola. 3G vibration tested to ensure strength of construction and longevity in application.

Optics

Choice of six patented, highefficiency AccuLED Optic™ technology manufactured from injection-molded acrylic. Optics are precisely designed to shape the light output, maximizing efficiency and application spacing. AccuLED Optic technology, creates consistent distributions with the scalability to meet customized application requirements. Offered Standard in 4000K (+/- 275K) CCT and minimum 70 CRI. Optional 3000K CCT, 5000K CCT and 5700K CCT. For the ultimate level of spill

light control, an optional houseside shield accessory can be field or factory installed. The house-side shield is designed to seamlessly integrate with the SL2 or SL3 optics.

Electrical

LED drivers mount to die-cast aluminum back housing for optimal heat sinking, operation efficacy, and prolonged life. Standard drivers feature electronic universal voltage (120-277V 50/60Hz), 347V 60Hz or 480V 60Hz operation, greater than 0.9 power factor, less than 20% harmonic distortion, and is suitable for operation in -40°C to 40°C ambient environments. All fixtures are shipped standard with 10kV/10kA common and differential - mode surge protection. LightBARs feature an IP66 enclosure rating and

maintain greater than 95% lumen maintenance at 60,000 hours per IESNA TM-21.

Mounting

Self-aligning pole-top fitter for 3" O.D. pole tops or vertical tenons. Square headed 1-1/4" polymer coated mounting bolts with a lock

Finish


Cast components finished in a super durable black TGIC polyester powder coat paint, 2.5 mil nominal thickness for superior protection against fade and wear. Optional colors include: bronze, grey and white. RAL and custom color matches available.

Warranty Five-year warranty.

TRADITIONAIRE LED DOWNLIGHT

1 - 3 LightBARs Solid State LED

> **DECORATIVE POST TOP** LUMINAIRE

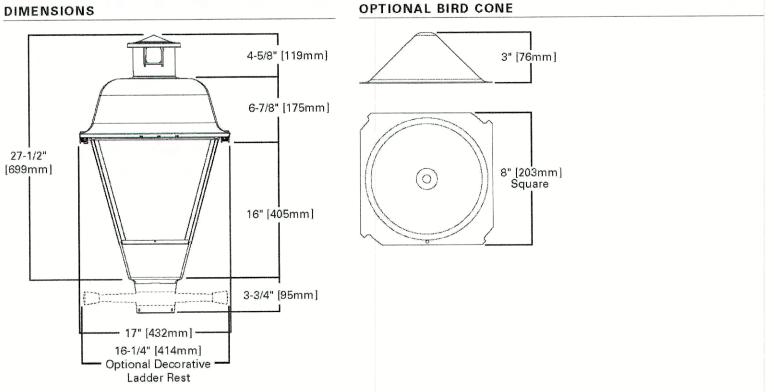

CERTIFICATION DATA UL/cUL Listed LM79 / LM80 Compliant 3G Vibration Rated IP66 LightBARs


ENERGY DATA Electronic LED Driver >0.9 Power Factor <20% Total Harmonic Distortion

ISO 9001

120-277V/50 & 60Hz, 347V/60Hz, 480V/60Hz -40°C Minimum Temperature 40°C Ambient Temperature Rating

Effective Projected Area: (Sq. Ft.)

SHIPPING DATA Approximate Net Weight: 37 lbs. (17 kgs.)

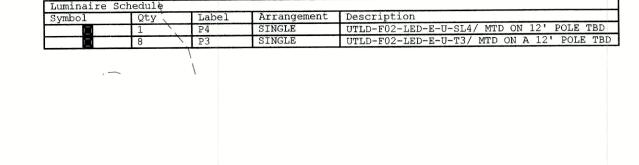

GRAPHIC SCALE (IN FEET) 1 inch = 40 feet

Owner of Record: RICCI CONSTRUCTION CO., INC. 225 BANFIELD ROAD, PORTSMOUTH, NH 03801 BK 1930 PG 0229

Design: JAC	Dran:	LAZ	Date: 3/3/21		
Checked: JAC	Scale:	AS SHOWN	Project No.: 20737		
Drawing Name: 20737-PLAN.dwg					
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ANY ALTERATIONS, AUTHORIZED OR OTHERWISE, SHALL BE					
AT THE USER'S S	OLE RISK	CAND WITHOUT	LIABILITY TO JBE.		



6	6/22/21	REVISIONS PER TOWN REVIEW	LAZ
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3	3/3/21	ADDED SURVEY INFO	LAZ
2	1/6/21	MINOR REVISIONS	DJM
REV.	DATE	REVISION	BY

Jones & Beach Engineers, Inc. 603-772-4746 85 Portsmouth Ave. Civil Engineering Services

PO Box 219

Stratham, NH 03885

Plan Name: Project:


FAX: 603-772-0227


E-MAIL: JBE@JONESANDBEACH.COM

LIGHTING PLAN 3400 LAFAYETTE ROAD PORTSMOUTH, NH

DRAWING No.

SHEET 11 OF 25 JBE PROJECT NO. 20737

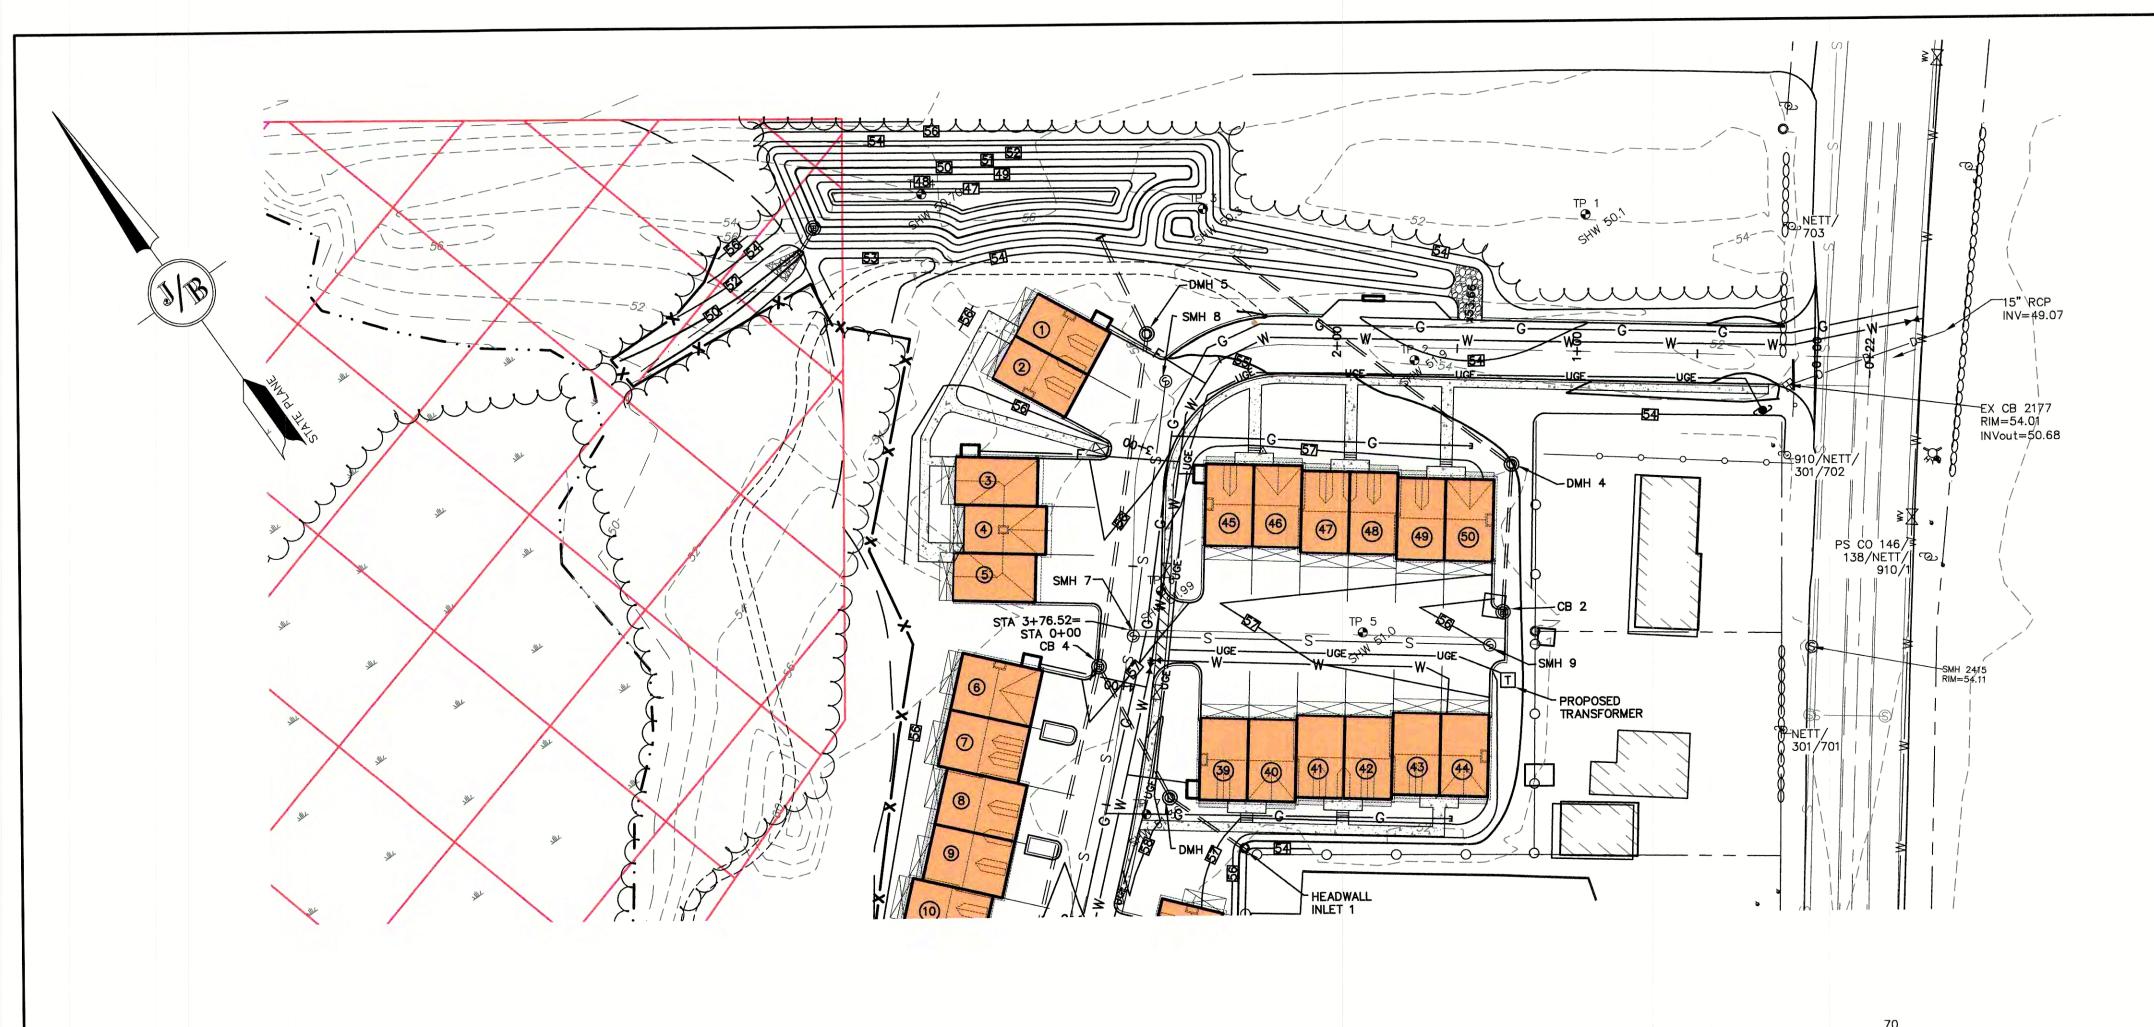

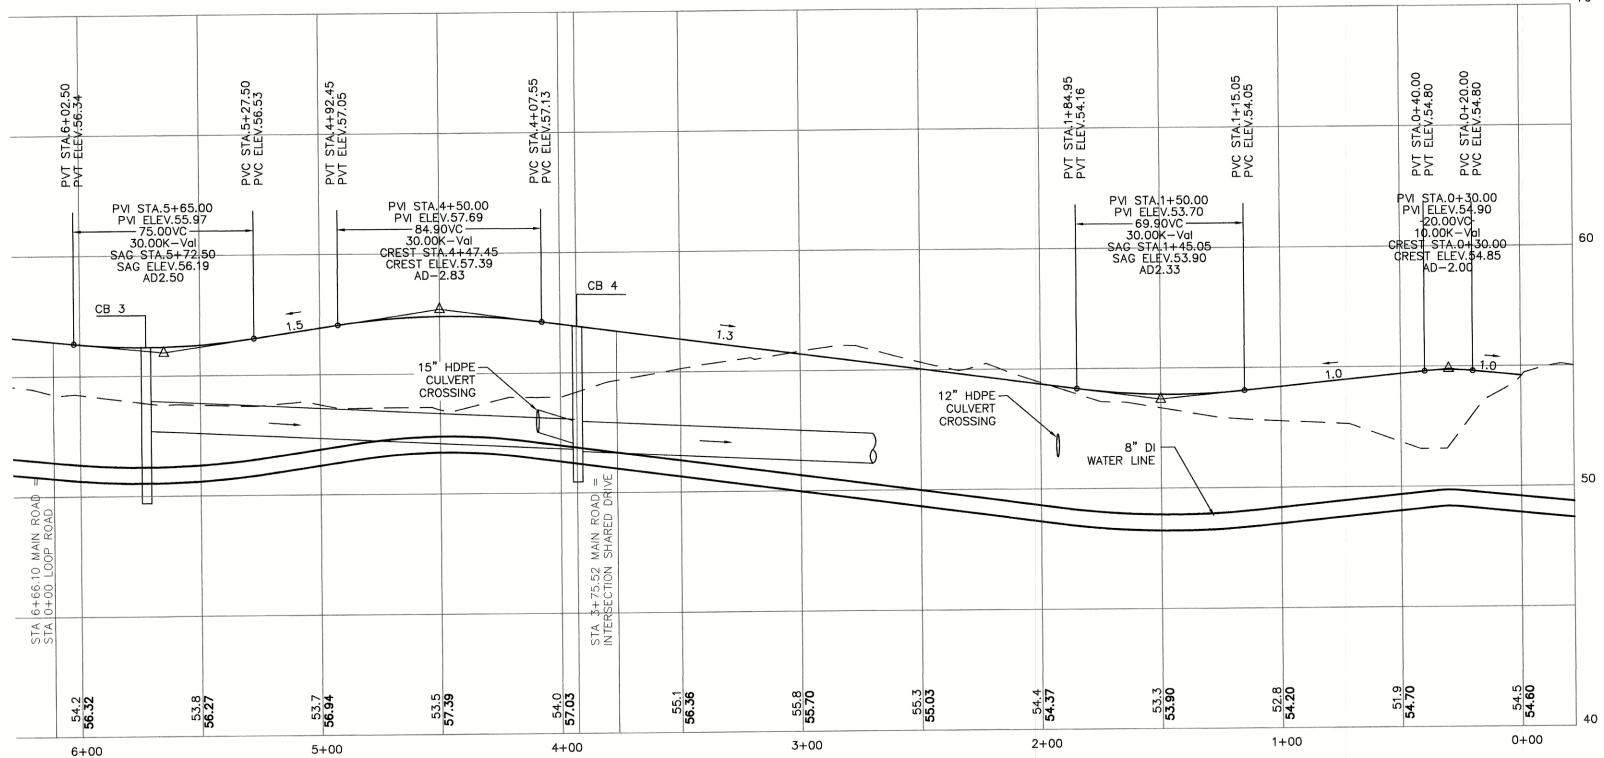

PO Box 219

Stratham, NH 03885

- 1. THIS SITE WILL REQUIRE A USEPA NPDES PERMIT FOR STORMWATER DISCHARGE FOR THE CONSTRUCTION SITE. THE CONSTRUCTION SITE OPERATOR SHALL DEVELOP AND IMPLEMENT A CONSTRUCTION STORM WATER POLLUTION PREVENTION PLAN (SWPPP), WHICH SHALL REMAIN ON SITE AND BE MADE ACCESSIBLE TO THE PUBLIC. THE CONSTRUCTION SITE OPERATOR SHALL SUBMIT A NOTICE OF INTENT (NOI) TO THE EPA REGIONAL OFFICE SEVEN DAYS PRIOR TO COMMENCEMENT OF ANY WORK ON SITE. EPA WILL POST THE NOI AT HTTP: //CFPUB1.EPA.GOV/NPDES/STORMWATER/NOI/NOISEARCH.CFM. AUTHORIZATION IS GRANTED UNDER THE PERMIT ONCE THE NOI IS SHOWN IN "ACTIVE" STATUS ON THIS WEBSITE. A COMPLETED NOTICE OF TERMINATION SHALL BE SUBMITTED TO THE NPDES PERMITTING AUTHORITY WITHIN 30 DAYS AFTER EITHER OF THE FOLLOWING CONDITIONS HAVE BEEN MET:

 A. FINAL STABILIZATION HAS BEEN ACHIEVED ON ALL PORTIONS OF THE SITE FOR WHICH THE PERMITTEE IS RESPONSIBLE;
 - A. ANOTHER OPERATOR/PERMITTEE HAS ASSUMED CONTROL OVER ALL AREAS OF THE SITE THAT HAVE NOT BEEN FINALLY
 - STABILIZED. PROVIDE DPW WITH A COPY OF THE NOTICE OF TERMINATION (NOT).
- ALL ROAD AND DRAINAGE WORK SHALL BE CONSTRUCTED IN ACCORDANCE WITH THE STANDARD SPECIFICATIONS FOR THE CITY, AND NHDOT SPECIFICATIONS FOR ROAD AND BRIDGE CONSTRUCTION, WHICHEVER IS MORE STRINGENT.
- 3. AS-BUILT PLANS TO BE SUBMITTED TO THE CITY PRIOR TO ACCEPTANCE OF THE ROADWAY.
- DEVELOPER IS RESPONSIBLE FOR COMPLYING WITH ALL APPLICABLE LOCAL, STATE AND FEDERAL WETLAND REGULATIONS, INCLUDING ANY PERMITTING AND SETBACK REQUIREMENTS REQUIRED UNDER THESE REGULATIONS.
- CONTRACTOR TO COORDINATE AND COMPLETE ALL WORK REQUIRED FOR THE RELOCATION AND/OR INSTALLATION OF ELECTRIC, CATV, TELEPHONE, AND FIRE ALARM PER UTILITY DESIGN AND STANDARDS. LOCATIONS SHOWN ARE APPROXIMATE. LOW PROFILE STRUCTURES SHALL BE USED TO THE GREATEST EXTENT POSSIBLE.
- THIS PLAN HAS BEEN PREPARED BY JONES & BEACH ENGINEERS, INC. FOR MUNICIPAL AND STATE APPROVALS AND FOR CONSTRUCTION BASED ON DATA OBTAINED FROM ON-SITE FIELD SURVEY AND EXISTING MUNICIPAL RECORDS. THROUGHOUT THE CONSTRUCTION PROCESS, THE CONTRACTOR SHALL INFORM THE ENGINEER IMMEDIATELY OF ANY FIELD DISCREPANCY FROM DATA SHOWN ON THE DESIGN PLANS. THIS INCLUDES ANY UNFORESEEN CONDITIONS, SUBSURFACE OR OTHERWISE, FOR EVALUATION AND RECOMMENDATIONS. ANY CONTRADICTION BETWEEN ITEMS OF THIS PLAN/PLAN SET, OR BETWEEN THE PLANS AND ON-SITE CONDITIONS MUST BE RESOLVED BEFORE RELATED CONSTRUCTION HAS BEEN INITIATED.
- 7. SILTATION AND EROSION CONTROLS SHALL BE INSTALLED PRIOR TO CONSTRUCTION, SHALL BE MAINTAINED DURING CONSTRUCTION, AND SHALL REMAIN UNTIL SITE HAS BEEN STABILIZED WITH PERMANENT VEGETATION. SEE DETAIL SHEET E1 FOR ADDITIONAL
- ALL DISTURBED AREAS NOT STABILIZED BY NOVEMBER 1st SHALL BE COVERED WITH AN EROSION CONTROL BLANKET. PRODUCT TO BE SPECIFIED BY THE ENGINEER.
- FINAL DRAINAGE, GRADING AND EROSION PROTECTION MEASURES SHALL CONFORM TO REGULATIONS OF THE PUBLIC WORKS
- 10. CONTRACTOR TO VERIFY EXISTING UTILITIES AND TO NOTIFY ENGINEER OF ANY DISCREPANCY IMMEDIATELY.
- 11. ROADWAY INTERSECTIONS WITH SLOPE GRANITE CURB SHALL EXTEND AROUND RADIUS WITH 6' STRAIGHT PIECE ALONG TANGENT.
- 12. 6" PERFORATED ADS UNDER DRAIN PLACEMENT TO BE DETERMINED BY THE ENGINEER DURING TIME OF SUBGRADE INSPECTION. CONTRACTOR TO ADJUST LOCATION IN THE FIELD ONLY WITH PRIOR APPROVAL OF PROJECT ENGINEER OR PUBLIC WORKS DEPARTMENT. CONTRACTOR TO INCLUDE 3000 LF IN BID PRICE.
- 13. ALL DRIVEWAYS TO BE CONSTRUCTED MAXIMUM 10% SLOPE. SEE DETAIL SHEET.
- 14. ENGINEER TO INSTALL PERMANENT BENCHMARK (REINFORCED GRANITE MARKER) AT LOCATIONS SHOWN ON PLANS. BENCH MARKS TO BE TIED TO STATE PLANE COORDINATE SYSTÈM.
- 15. DRAINAGE INSPECTION AND MAINTENANCE SCHEDULE: ORGANIC FILTER BERM WILL BE INSPECTED DURING AND AFTER STORM EVENTS TO ENSURE THAT THE BERM STILL HAS INTEGRITY AND IS NOT ALLOWING SEDIMENT TO PASS. SEDIMENT BUILD UP IN SWALES WILL BE REMOVED IF IT IS DEEPER THAN SIX INCHES, AND IS TO BE REMOVED FROM SUMPS BELOW THE INLET OF CULVERTS SEMIANNUALLY, AS WELL AS FROM CATCH BASINS. FOLLOWING MAJOR STORM EVENTS, THE STAGE DISCHARGE OUTLET STRUCTURES ARE TO BE INSPECTED AND ANY DEBRIS REMOVED FROM THE ORIFICE, TRASH TRACK AND EMERGENCY SPILL WAY. INFREQUENTLY, SEDIMENT MAY ALSO HAVE TO BE REMOVED FROM THE SUMP OF THE STRUCTURE.
- 16. ALL DRAINAGE INFRASTRUCTURE SHALL BE INSTALLED AND STABILIZED PRIOR TO DIRECTING ANY RUNOFF TO IT.
- 17. DETENTION PONDS REQUIRE TIMELY MAINTENANCE AND SHOULD BE INSPECTED AFTER EVERY MAJOR STORM EVENT, AS WELL AS FREQUENTLY DURING THE FIRST YEAR OF OPERATION, AND ANNUALLY THEREAFTER. EVERY FIVE YEARS, THE SERVICES OF A PROFESSIONAL ENGINEER SHOULD BE RETAINED TO PERFORM A THOROUGH INSPECTION OF THE DETENTION POND AND ITS INFRASTRUCTURE. ANY DEBRIS AND SEDIMENT ACCUMULATIONS SHOULD BE REMOVED FROM THE OUTLET STRUCTURE(S) AND EMERGENCY SPILLWAY(S) AND DISPOSED OF PROPERLY. DETENTION POND BERMS SHOULD BE MOWED AT LEAST ONCE ANNUALLY SO AS TO PREVENT THE ESTABLISHMENT OF WOODY VEGETATION. TREES SHOULD NEVER BE ALLOWED TO GROW ON A DETENTION POND BERM, AS THEY MAY DESTABILIZE THE STRUCTURE AND INCREASE THE POTENTIAL FOR FAILURE. AREAS SHOWING SIGNS OF EROSION OR THIN OR DYING VEGETATION SHOULD BE REPAIRED IMMEDIATELY BY WHATEVER MEANS NECESSARY, WITH THE EXCEPTION OF FERTILIZER. RODENT BORROWS SHOULD BE REPAIRED IMMEDIATELY AND THE ANIMALS SHOULD BE TRAPPED AND
- 18. THE DETENTION PONDS ARE TO BE CONSTRUCTED PRIMARILY THROUGH EXCAVATION. IN THOSE AREAS WHERE THE BERMS MUST BE CONSTRUCTED BY THE PLACEMENT OF FILL, THE ENTIRE EMBANKMENT AREA OF THE DETENTION PONDS SHALL BE EXCAVATED TO PROPOSED GRADE, STRIPPED OF ALL ORGANIC MATERIALS, COMPACTED TO AT LEAST 95% AND SCARIFIED PRIOR TO THE PLACEMENT OF THE EMBANKMENT MATERIAL. IN THE EVENT THE FOUNDATION MATERIAL EXPOSED DOES NOT ALLOW THE SPECIFIED COMPACTION, AN ADDITIONAL ONE FOOT (1') OF EXCAVATION AND THE PLACEMENT OF A ONE FOOT (1') THICK, TWELVE FOOT (12') WIDE PAD OF THE MATERIAL DESCRIBED IN THE NOTE BELOW, COMPACTED TO 95% OF ASTM D-1557 MAY BE NECESSARY. PLACEMENT AND COMPACTION SHOULD OCCUR AT A MOISTURE CONTENT OF OPTIMUM PLUS OR MINUS 3%, AND NO FROZEN OR ORGANIC MATERIAL SHOULD BE PLACED WITHIN FOR ANY REASON.
- 19. EMBANKMENT MATERIAL FOR THE BERMS SHALL BE CLEAN MINERAL SOIL WITH A CLAY COMPONENT FREE OF ROOTS, ORGANIC MATTER, AND OTHER DELETERIOUS SUBSTANCES, AND SHALL CONTAIN NO ROCKS OR LUMPS OVER FOUR INCHES (4") IN DIAMETER. THIS MATERIAL SHOULD BE INSTALLED IN 6" LIFTS AND COMPACTED TO 95% OS ASTM D-1557, AND SHOULD MEET THE FOLLOWING SPECIFICATIONS: 4" PASSING 100%, #4 SIEVE 25-70%, #200 SIEVE 10-29% (IN TOTAL SAMPLE).
- 20. EMBANKMENT IS TO HAVE 3:1 SIDE SLOPES (MAX.) AND IS TO BE BROUGHT TO SPECIFIED GRADES PRIOR TO THE ADDITION OF LOAM (4" MINIMUM) SO AS TO ALLOW FOR THE COMPACTION OF THE STRUCTURE OVER TIME WHILE MAINTAINING THE PROPER BERM
- 21. COMPACTION TESTING SERVICES (I.E. NUCLEAR DENSITY TESTS) ARE TO BE PERFORMED BY AN INDEPENDENT GEOTECHNICAL ENGINEER RETAINED BY THE CONTRACTOR FOR ROADWAY CONSTRUCTION, AND ON THE FOUNDATION OF THE BERM AND ON EVERY LIFT OF NEWLY PLACED MATERIAL.
- 22. ORNAMENTAL STREET LIGHTING SHALL BE PRIVATELY OWNED AND MAINTAINED BY THE HOME OWNER'S ASSOCIATION. LIGHTING SHALL NOT TO BE OWNED OR MAINTAINED BY THE CITY.
- 23. SLOPED GRANITE CURB TO BE TIPPED DOWN AT ALL DRIVEWAY ENTRANCES BY THE CONTRACTOR. ALL DRIVEWAY LOCATIONS SHALL BE REVIEWED AND APPROVED BY PUBLIC WORKS PRIOR TO ISSUANCE OF BUILDING PERMIT.

GRAPHIC SCAL (IN FEET) 1 inch = 40 ft Horiz.1 inch = 4 ft Vert.

E-MAIL: JBE@JONESANDBEACH.COM

Design: JAC | Draft: LAZ Date: 3/3/21 Checked: JAC | Scale: AS SHOWN | Project No.: 20737 Drawing Name: 20737-PLAN.dwg

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MICHAEL	5	5/5/21	REVISIONS	LAZ
J. 簡単10	4	3/18/21	ADDED DETAIL	LAZ
No. 9848	3	3/3/21	ADDED SURVEY INFO	LAZ
Cloence Land	2	1/6/21	MINOR REVISIONS	DJM
SONAL BURNING	REV.	DATE	REVISION	BY

Designed and Produced in NH Jones & Beach Engineers, Inc. 603-772-4746 85 Portsmouth Ave. Civil Engineering Services FAX: 603-772-0227

PLAN AND PROFILE Plan Name: 3400 LAFAYETTE ROAD Project: PORTSMOUTH, NH

RICCI CONSTRUCTION CO., INC.

Owner of Record: 225 BANFIELD ROAD, PORTSMOUTH, NH 03801 BK 1930 PG 0229

DRAWING No.

SHEET 12 OF 25 JBE PROJECT NO. 20737



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MICHAEL KERIVAN No. 9846

17	6	6/22/21	REVISIONS PER TOWN REVIEW	LAZ
	5	5/5/21	REVISIONS	LAZ
3	4	3/18/21	ADDED DETAIL	LAZ
623	3	3/3/21	ADDED SURVEY INFO	LAZ
	2	1/6/21	MINOR REVISIONS	DJM
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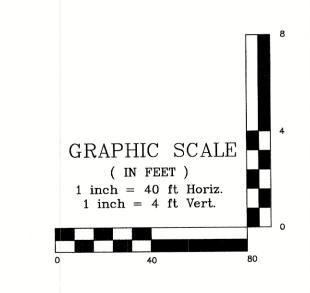
B Jones & Beach Engineers, Inc.

Services 603-772-4746
FAX: 603-772-0227
E-MAIL: JBE@JONESANDBEACH.COM 85 Portsmouth Ave. Civil Engineering Services
PO Box 219 Stratham, NH 03885

Plan Name:	PLAN AND PROFILE
Project:	3400 LAFAYETTE ROAD PORTSMOUTH, NH
Owner of Record: 225 BANFIEL	RICCI CONSTRUCTION CO., INC. D ROAD, PORTSMOUTH, NH 03801 BK 1930 PG 0229

SHEET 13 OF 25 JBE PROJECT NO. 20737





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3	3/3/21	ADDED SURVEY INFO	LAZ
2	1/6/21	MINOR REVISIONS	DJM
REV.	DATE	REVISION	BY

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Jones & Beach Engineers, Inc.

85 Portsmouth Ave. Civil Engineering Services
PO Box 219
Stratham, NH 03885

603-772-4746
FAX: 603-772-0227
E-MAIL: JBE@JONESANDBEACH.COM

Plan Name:	PLAN AND PROFILE
Project:	3400 LAFAYETTE ROAD PORTSMOUTH, NH
Owner of Record: 225 E	RICCI CONSTRUCTION CO., INC. BANFIELD ROAD, PORTSMOUTH, NH 03801 BK 1930 PG 0229

P3
SHEET 14 OF 25
JBE PROJECT NO. 20737



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4	3/18/21	ADDED DETAIL	LAZ
3	3/3/21	ADDED SURVEY INFO	LAZ
2	1/6/21	MINOR REVISIONS	DJM
REV.	DATE	REVISION	BY

B Jones & Beach Engineers, Inc.

85 Portsmouth Ave. PO Box 219
Stratham, NH 03885

Civil Engineering Services

FAX: 603-772-4746
FAX: 603-772-0227
FAX: 603-772-0227

Plan Name:	SEWER PROFILE
Project:	3400 LAFAYETTE ROAD PORTSMOUTH, NH
Owner of Record: 225 B	RICCI CONSTRUCTION CO., INC. ANFIELD ROAD, PORTSMOUTH, NH 03801 BK 1930 PG 0229

P4
SHEET 15 OF 25
JBE PROJECT NO. 20737



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3	3/3/21	ADDED SURVEY INFO	LAZ
2	1/6/21	MINOR REVISIONS	DJM
REV.	DATE	REVISION	BY


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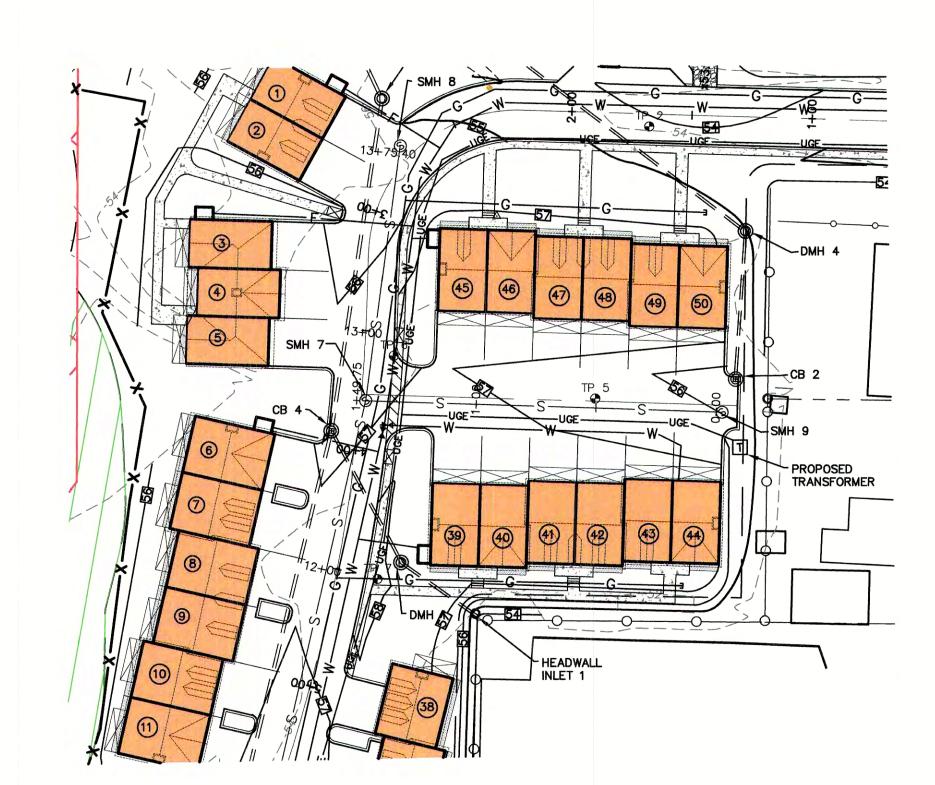
Plan Name:	SEWER PROFILE		
Project:	3400 LAFAYETTE ROAD PORTSMOUTH, NH		
Owner of Record: 225 BANFIELD ROAD, PORTSMOUTH, NH 03801 BK 1930 PG 0229			


DRAWING No. **P5** SHEET 16 OF 25 JBE PROJECT NO. 20737






LOOP ROAD

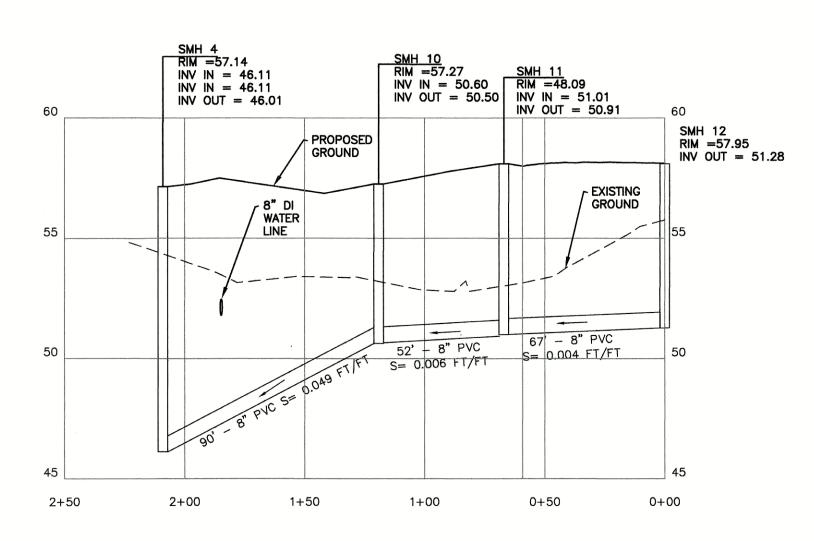

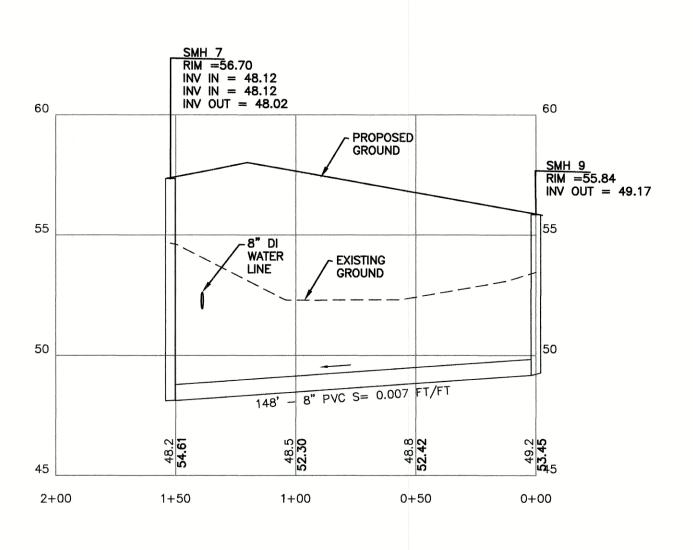

SHARED DRIVEWAY

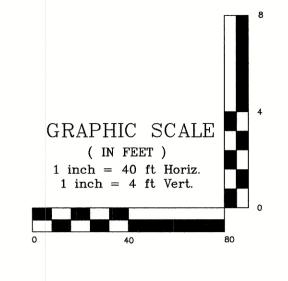

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	5	5/5/21	REVISIONS	LAZ
1	4	3/18/21	ADDED DETAIL	LAZ
23	3	3/3/21	ADDED SURVEY INFO	LAZ
0	2	1/6/21	MINOR REVISIONS	DJM
	REV.	DATE	REVISION	BY

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Jones & Beach Engineers, Inc.

85 Portsmouth Ave. Civil Engineering Services

603-772-4746


FAX: 603-772-0227

Stratham, NH 03885

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Plan Name:	SEWER PROFILE
Project:	3400 LAFAYETTE ROAD PORTSMOUTH, NH
Owner of Record: 225 BANFIELD	RICCI CONSTRUCTION CO., INC. ROAD, PORTSMOUTH, NH 03801 BK 1930 PG 0229

P5
SHEET 17 OF 25
JBE PROJECT NO. 20737

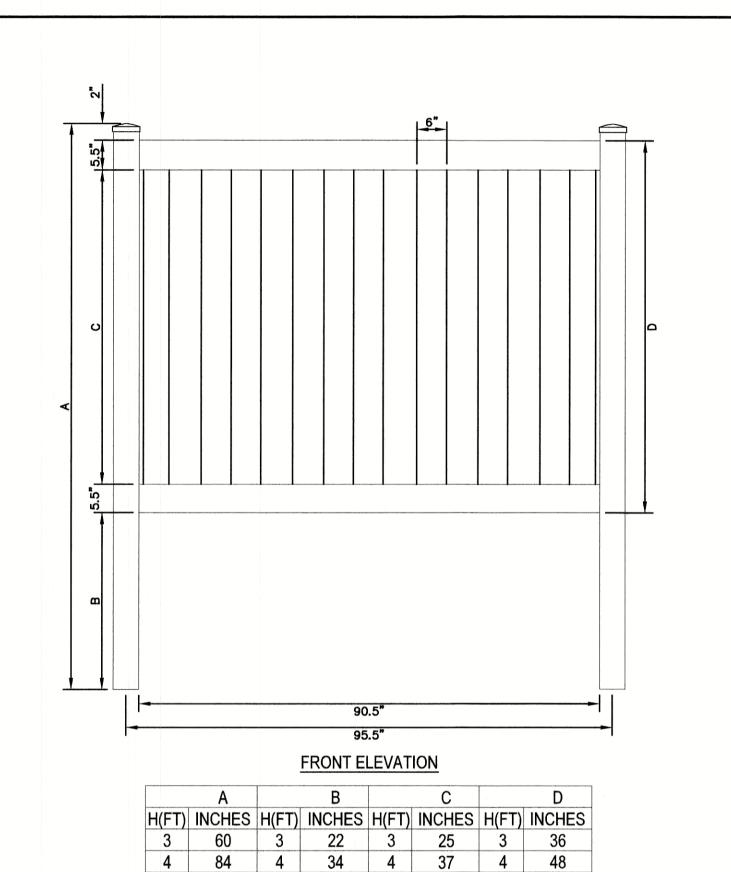

34

REVIEW PRIOR TO INSTALLATION.

6 | 108 | 6 | 34 | 6 | 61 | 6 | 72


1. CONTRACTOR TO PROVIDE FENCE SPEC TO ENGINEER FOR

49

2. VINYL FENCE SHALL MEET ASTM F964-09 STANDARDS.

6' VINYL STOCKADE FENCE

NOT TO SCALE

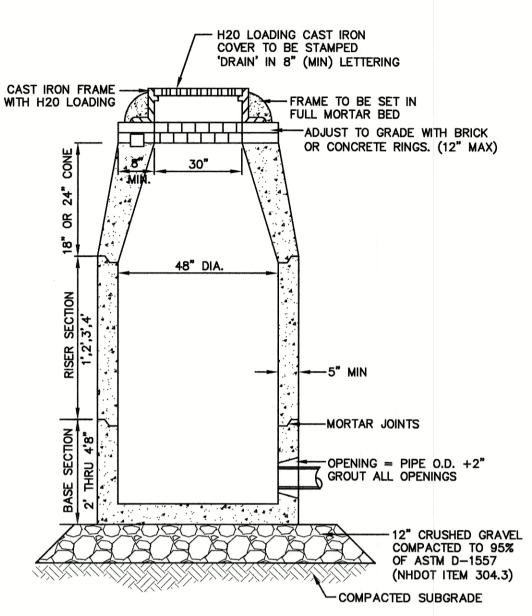


- 1. BASE SECTION SHALL BE MONOLITHIC WITH 48" INSIDE DIAMETER.
- 2. ALL SECTIONS SHALL BE DESIGNED FOR H20 LOADING.
- 3. CONCRETE SHALL BE COMPRESSIVE STRENGTH 4000 PSI, TYPE II CEMENT.
- 4. FRAMES AND GRATES SHALL BE HEAVY DUTY AND DESIGNED FOR H20 LOADING.
- 5. PROVIDE "V" KNOCKOUTS FOR PIPES WITH 2" MAX. CLEARANCE TO OUTSIDE OF PIPE. MORTAR ALL PIPE CONNECTIONS SO AS TO BE WATERTIGHT.
- 6. JOINT SEALANT BETWEEN PRECAST SECTIONS SHALL BE BUTYL RUBBER.
- 7. ALL DRAIN MANHOLE FRAMES AND GRATES SHALL BE NHDOT TYPE MH-1, OR NEENAH R-1798 OR APPROVED EQUAL (30" DIA. TYPICAL).
- 8. STANDARD FRAME(S) AND GRATE(S) SHALL BE SET IN FULL MORTAR BED. ADJUST TO GRADE WITH CLAY BRICK AND MORTAR (2 BRICK COURSES TYPICALLY, 5 BRICK COURSES MAXIMUM, BUT NO MORE THAN 12"), OR PRECAST CONCRETE 'DONUTS'.


DRAIN MANHOLE

NOT TO SCALE

NOTES:

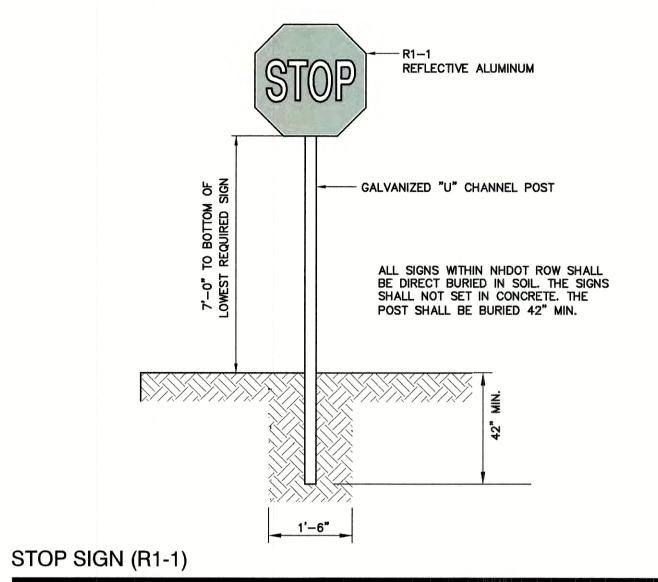

NOT TO SCALE

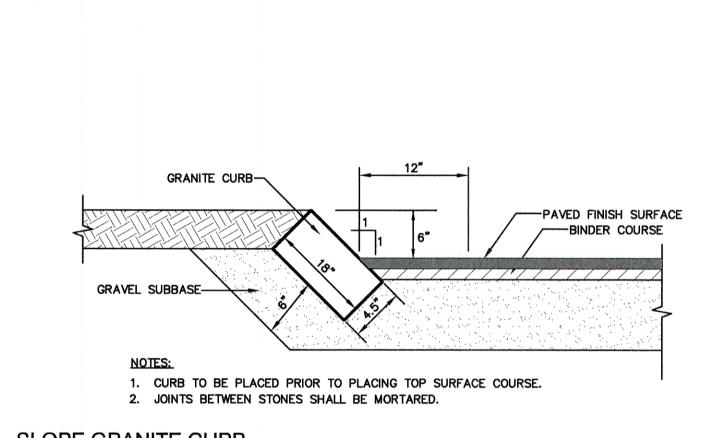

-6"X6" W1.4XW1.4 BRUSHED FINISH SURFACE (TYP.) W.W.F. 5" REINFORCED CONC. CLASS AA 4" LOAM & (4000 PSI) SEED (TYP.) ~ - SLOPE GRANITE CURB 1/4" PER FT. --- PAVED FINISH ____x ___x ___x ___x ___x ___x 5" CONCRETE SURFACE 6" CRUSHED GRAVEL ---8" BANK RUN GRAVEL -COMPACTED SUBGRADE OR ROCK FILL NOTES:
1. CONCRETE TO BE 4000 PSI. 2. CONTRACTION JOINTS SPACE TO BE EQUAL TO SIDEWALK WIDTH. **EXPANSION** 3. ALL JOINTS SEALED PER SPECIFICATIONS. JOINT SEALANT 4. PROVIDE A 1/2" NON-EXTRUDING EXPANSION JOINT (WHEN REQ'D) AGAINST STRUCTURE AND EVERY 16' ALONG SIDEWALK. 5. PROVIDE BROOM FINISH IN DIRECTION PERPENDICULAR TO CURB. CONCRETE SIDEWALK -FIXED OBJECT 1/2" PREFORMED EXPANSION JOINT CONCRETE SIDEWALK W/ SLOPE GRANITE CURB

4' SHOULDER

5' WIDE WALK W/

12' TO FACE OF CURB

COMPACTED SUBGRADE -

S=1/4" PER FT

NOT TO SCALE

12' TO FACE OF CURB

S=1/4" PER FT

-SLOPED GRANITE CURB

12" MIN. BANKRUN GRAVEL


(NHDOT ITEM 304.2) ---

SLOPE GRANITE CURB

4' MINIMUM

LOAM & SEED /

NOT TO SCALE

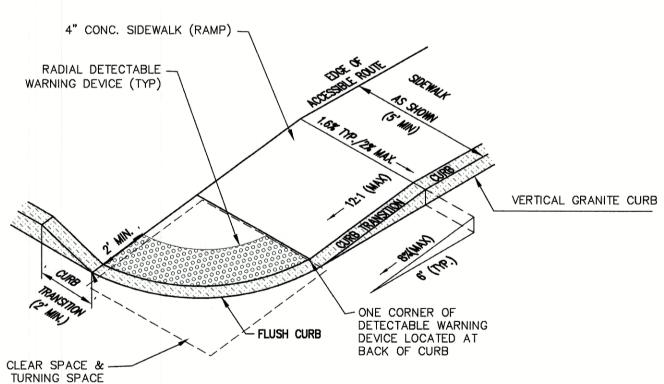

1. THE MAXIMUM ALLOWABLE CROSS SLOPE OF ACCESSIBLE ROUTE (SIDEWALK) AND

- CURB SHALL BE 1.5%.

 2. THE MAXIMUM ALLOWABLE SLOPE OF ACCESSIBLE ROUTE EXCLUDING CURB RAMPS
- 3. THE MAXIMUM ALLOWABLE SLOPE OF ACCESSIBLE ROUTE (SIDEWALK) CURB RAMPS
- 4. A MINIMUM OF 4 FEET CLEAR SHALL BE MAINTAINED AT ANY PERMANENT OBSTACLE IN ACCESSIBLE ROUTE (i.e., HYDRANTS, UTILITY POLES, TREE WELLS,
- . CURB TREATMENT VARIES, SEE PLANS FOR CURB TYPE.
 . BASE OF RAMP SHALL BE GRADED TO PREVENT PONDING.
- SEE TYPICAL SECTION FOR RAMP CONSTRUCTION.
- WHERE A CHANGE IN DIRECTION IS REQUIRED TO UTILIZE A CURB RAMP, A TURNING SPACE SHALL BE PROVIDED AT THE BASE AND/OR THE TOP OF THE CURB RAMP. TURNING SPACES SHALL BE PERMITTED TO OVERLAP CLEAR SPACES. . TURNING SPACE MAXIMUM CROSS SLOPE IS 2% IN ANY DIRECTION.
- 10. BEYOND THE BOTTOM GRADE BREAK, A CLEAR SPACE OF 4'X4' MINIMUM SHALL BE PROVIDED WITHIN THE WIDTH OF THE PEDESTRIAN CROSSWALK, AND OUTSIDE THE PARALLEL VEHICLE TRAVEL LANE. THE CLEAR SPACE MAY OVERLAP TURNING SPACES, DETECTABLE WARNING SURFACES AND DROP CURBS.

ACCESSIBLE CURB RAMP (NHDOT OPTION 3)

Date: 3/3/21

NOT TO SCALE

Design: JAC | Draft: LAZ

Drawing Name: 20737-PLAN.dwg


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6 6/22/21 5/5/21 MICHAEL 4 3/18/21 KERIVAN No. 9846 3 3/3/21 2 1/6/21

REVISIONS PER TOWN REVIEW LAZ **REVISIONS** LAZ ADDED DETAIL LAZ ADDED SURVEY INFO LAZ MINOR REVISIONS DJM REV. DATE REVISION BY

4" CRUSHED GRAVEL (NHDOT ITEM 304.3) -TWO COURSES BITUMOUS CONCRETE 1.25" WEARING COURSE ROLLED (NHDOT TYPE E) 2" BINDER COURSE ROLLED (NHDOT TYPE B) — 1. REMOVE ALL ORGANICS, TOPSOIL AND MATERIAL YIELDING TO A 10 TON ROLLER. SUBBASE AREAS THAT CONTAIN UNSUITABLE MATERIALS MUST BE EXCAVATED TO A DEPTH NO LESS THAN 36" BELOW FINISH GRADE AND BE REPLACED WITH GRAVEL 2. ALL MATERIALS TO BE AS SPECIFIED PER TOWN STANDARDS AND NHDOT, WHICHEVER IS MOST STRINGENT. GRADATION AND COMPACTION TEST RESULTS (95% MIN.) SHALL BE SUBMITTED FOR REVIEW AND APPROVAL. 3. TOWN MAY REQUIRE UNDERDRAIN AND/OR ADDITIONAL DRAINAGE IF SOIL CONDITIONS WARRANT. TYPICAL ROADWAY SECTION W/CURBING NOT TO SCALE

Designed and Produced in NH Language Page house Transported Trans	Plan Name: DETAIL SHEET
Jones & Beach Engineers, Inc. 85 Portsmouth Ave. Civil Engineering Services 603-772-4746 EAV. 603-772-4746	Project: 3400 LAFAYETTE ROAD PORTSMOUTH, NH
PO Box 219 FAX: 603-772-0227 Stratham, NH 03885 E-MAIL: JBE@JONESANDBEACH.COM	Owner of Record. RICCI CONSTRUCTION CO., INC. 225 BANFIELD ROAD, PORTSMOUTH, NH 03801 BK 1930 PG 0229


4' SHOULDER

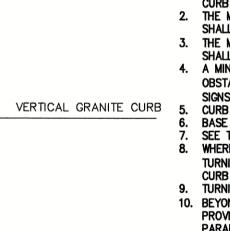
SHEET 18 OF 25 JBE PROJECT NO. 20737

DRAWING No.

APPROXIMATE

EXISTING GRADE

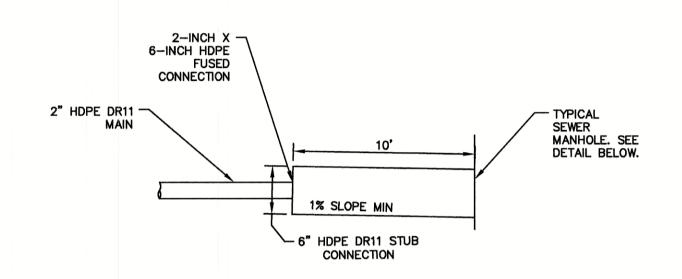


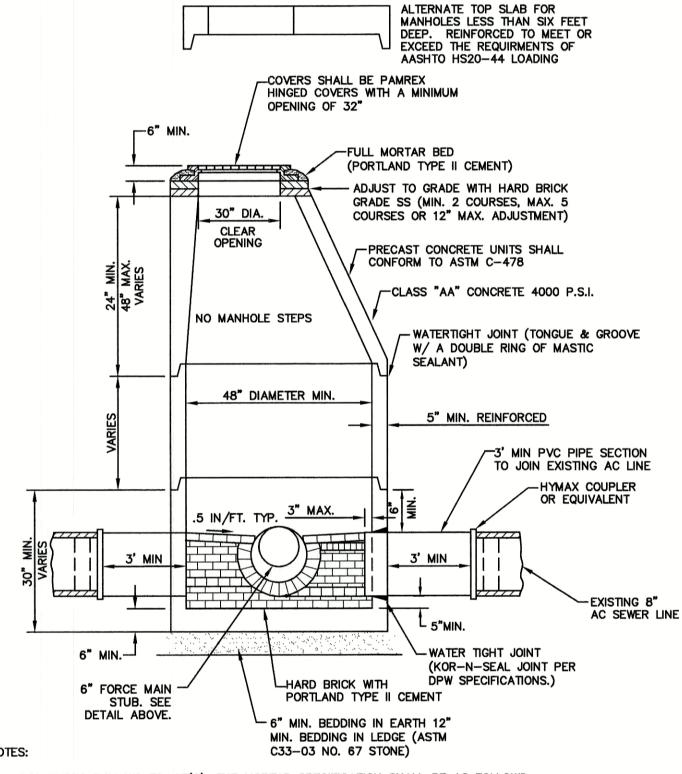

- PER NHDES ENV-WQ 704.13(C), THE MORTAR SPECIFICATION SHALL BE AS FOLLOWS: 1. MORTAR SHALL BE COMPÒSÉD OF PORTLAND CEMENT AND SAND WITH OR WITHOUT HYDRATED LIME ADDITION; 2. PROPORTIONS IN MORTAR OF PARTS BY VOLUMES SHALL BE:
- A. 4.5 PARTS SAND AND 1.5 PARTS CEMENT; OR B. 4.5 PARTS SAND, ONE PART CEMENT AND 0.5 PART HYDRATED LIME;
- 3. CEMENT SHALL BE TYPE II PORTLAND CEMENT CONFORMING TO ASTM C150-05; 4. HYDRATED LIME SHALL BE TYPE S CONFORMING TO THE ASTM C207-06 STANDARD SPECIFICATIONS FOR
- HYDRATED LIME FOR MASONRY PURPOSES"; 5. SAND SHALL CONSIST OF INERT NATURAL SAND CONFORMING TO THE ASTM C33-03 'STANDARD SPECIFICATIONS FOR CONCRETE, FINE AGGREGATES";
- 2. SHELVES SHALL BE CONSTRUCTED TO THE ELEVATION OF THE HIGHEST PIPE CROWN AND SLOPED TO DRAIN TOWARD THE FLOWING THROUGH CHANNEL IN ACCORDANCE WITH ENV-WQ 704.12 (K).
- 3. ALL MANHOLES SHALL BE TESTED FOR LEAKAGE IN ACCORDANCE WITH ENV-WQ 704.17 (a) THROUGH (e).
- 4. SEWER MANHOLE COVERS SHALL CONFORM TO ASTM A48 WITH A CASTING EQUAL TO CLASS 30 IN ACCORDANCE WITH ENV-WQ 704.13 (a).
- 5. ALL ASBESTOS CONTAINING WASTE MATERIALS MUST BE PROPERLY IDENTIFIED, PACKAGED AND DELIVERED TO A LANDFILL LICENCED BY THE NHDES SOLID WASTE MANAGEMENT PROGRAM FOR DISPOSAL. CALL (603) 271-2925 FOR MORE INFORMATION.
- 6. PORTSMOUTH STANDARD SEWER MANHOLE SHALL BE USED.
- 7. CONTRACTOR TO PURCHASE SEWER MANHOLE COVERS FROM THE CITY OF PORTSMOUTH DIRECTLY.
- 8. MANHOLE BASE SECTIONS SHALL BE MONOLITHIC TO A POINT AT LEAST 6" ABOVE THE HIGHEST INCOMING SEWER PIPE PER ENV-WQ 704.12 (e).
- 9. MANHOLE CASTINGS SHALL CONFORM TO ASTM A48 PER ENV-WQ 704.13 (a) (8).

PORTSMOUTH SEWER MANHOLE

NOT TO SCALE

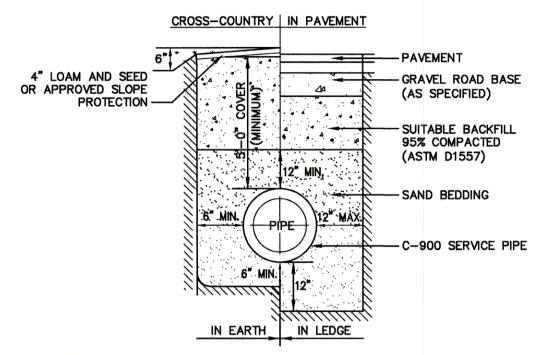

FINISHED GRADE

GATE VALVE WITH

OR EQUAL

RODDING

5/8" MIN.

-VALVE BOX AND COVER

KENNEDY VALVE FIG. 571-X

THRUST BLOCK


WATER SYSTEM TRENCH

BURIED GATE VALVE DETAIL

NOT TO SCALE


 λ

NOT TO SCALE

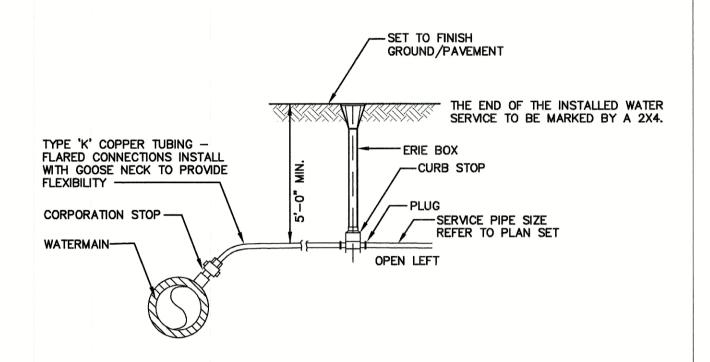

WATER SERVICE CONNECTION-COPPER PIPE

NOT TO SCALE

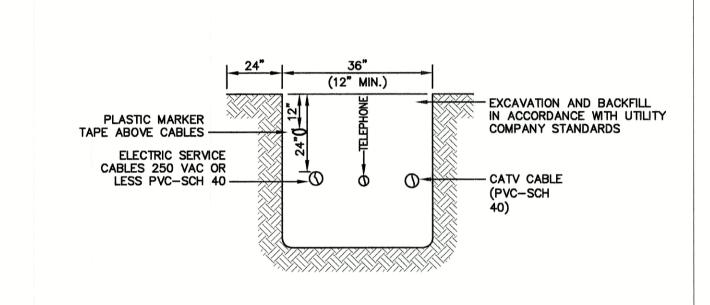

NOTE: ALL UTILITIES SHALL BE REVIEWED AND APPROVED BY APPROPRIATE UTILITY COMPANY.

UTILITY TRENCH

NOT TO SCALE

BACKFILL

MATERIAL

EXCAVATION AND BACKFILL IN

CONTRACTOR TO COORDINATE

BACKFILL FOR PIPE INSTALLATION

WITH UTILITY COMPANY AND

PROVIDE EXCAVATION AND


ACCORDANCE WITH UTILITY

COMPANY STANDARDS

ALT. SLAB TOP REINFORCED TO MEET OR

EXCEED REQUIREMENTS OF H20 LOADING

NOT TO SCALE

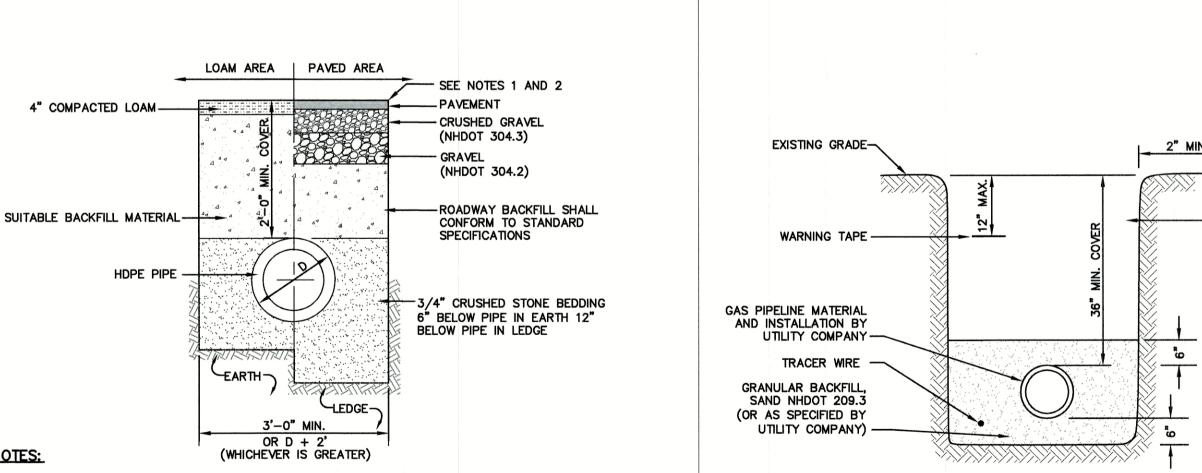


1. PAVEMENT REPAIR IN EXISTING ROADWAYS SHALL CONFORM TO STREET OPENING REGULATIONS.

2. NEW ROADWAY CONSTRUCTION SHALL CONFORM WITH PROJECT AND TOWN SPECIFICATIONS. 3. ALL MATERIALS ARE TO BE COMPACTED TO 95% OF ASTM D-1557.

DRAINAGE TRENCH

NOT TO SCALE

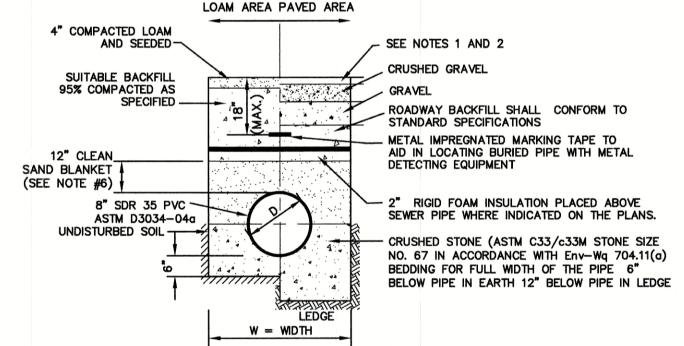

CAST IRON FRAME AND GRATE WITH H20 LOADING (NHDOT TYPE

-FRAME TO BE SET IN

CONCRETE RINGS

(12" MAX.)

ADJUST TO GRADE WITH

"THE SNOUT, OIL WATER-DEBRIS

SEPARATOR" OR

- OPENING = PIPE

O.D. +2" GROUT ALL OPENING

BRICK OR PRE-CAST

___ (EQUAL

12" CRUSHED GRAVEL COMPACTED
TO 95% OF ASTM -1557

(NHDOT ITEM 304.3)

FULL MORTAR BED

1. PAVEMENT REPAIR IN EXISTING ROADWAYS SHALL CONFORM TO PAVEMENT DETAILS.

COMPACTED SUBGRADE -

CONCRETE SHALL BE COMPRESSIVE STRENGTH 4000 PSI, TYPE II CEMENT.

4. FRAMES AND GRATES SHALL BE HEAVY DUTY AND DESIGNED FOR H20 LOADING

7. ALL CATCH BASIN FRAMES AND GRATES SHALL BE NHDOT CATCH BASIN TYPE ALTERNATE 1 OR NEENAH

8. STANDARD CATCH BASIN FRAME AND GRATE(S) SHALL BE SET IN FULL MORTAR BED. ADJUST TO GRADE

WITH CLAY BRICK AND MORTAR (2 BRICK COURSES TYPICALLY, 5 BRICK COURSES MAXIMUM, BUT NO

5. PROVIDE "V" KNOCKOUTS FOR PIPES WITH 2" MAX. CLEARANCE TO OUTSIDE

OF PIPE. MORTAR ALL PIPE CONNECTIONS SO AS TO BE WATERTIGHT.

6. JOINT SEALANT BETWEEN PRECAST SECTIONS SHALL BE BUTYL RUBBER.

1. BASE SECTION SHALL BE MONOLITHIC WITH 48" INSIDE DIAMETER.

2. ALL SECTIONS SHALL BE DESIGNED FOR H20 LOADING.

R-3570 OR APPROVED EQUAL (24"x24" TYPICAL).

MORE THAN 12"), OR PRECAST CONCRETE 'DONUTS'.

CATCH BASIN WITH GREASE HOOD

9. ALL CATCH BASINS ARE TO BE FITTED WITH GREASE HOODS.

- 2. NEW ROADWAY CONSTRUCTION SHALL CONFORM TO SUBDIVISION SPECIFICATIONS.
- 3. TRENCH BACKFILL SHALL CONFORM WITH ENV. Wq 704.11(h) AND BE FREE OF DEBRIS, PAVEMENT, ORGANIC MATTER, TOP SOIL, WET OR SOFT MUCK, PEAT OR CLAY, EXCAVATED LEDGE OR ROCKS OVER SIX INCHES.
- 4. W= MAXIMUM ALLOWABLE TRENCH WIDTH TO A PLANE 12" INCHES ABOVE THE PIPE. FOR PIPES 15 INCHES NOMINAL DIAMETER OR LESS, WIDTH SHALL BE NO MORE THAN 36"; FOR PIPES GREATER THAN 15 INCHES NOMINAL DIAMETER, WIDTH SHALL BE 24 INCHES PLUS PIPE O.D. WIDTH SHALL ALSO BE THE PAYMENT WIDTH FOR LEDGE EXCAVATION AND FOR ORDERED EXCAVATION BELOW GRADE.
- 5. RIGID FOAM INSULATION TO BE PROVIDED WHERE COVER IN THE ROADWAY IS LESS THAN 6' AND CROSS COUNTRY IS LESS THAN 4' WHERE INDICATED ON THE DES APPROVED PLANS.
- 6. PIPE SAND BLANKET MATERIAL SHALL BE GRADED SAND, FREE FROM ORGANIC MATERIALS, GRADED SUCH THAT 100% PASSES A 1/2 " SIEVE AND A MAXIMUM OF 15% PASSES A #200 SIEVE IN ACCORDANCE WITH Env-Wq 704.11(b).
- 7. JOINT SEALS FOR PVC PIPE SHALL BE OIL RESISTANT COMPRESSION RINGS OF ELASTOMERIC MATERIAL AND CERTIFIED BY THE MANUFACTURER AS CONFORMING TO THE ASTM D3212 STANDARD IN EFFECT WHEN THE JOINT SEALS WERE MANUFACTURED, AND SHALL BE PUSH-ON, BELL-AND-SPIGOT TYPE PER Env-Wq 704.05 (e).

SEWER TRENCH

NOT TO SCALE

DETAIL SHEET Plan Name: 3400 LAFAYETTE ROAD Project: PORTSMOUTH, NH RICCI CONSTRUCTION CO., INC. Owner of Record: 225 BANFIELD ROAD, PORTSMOUTH, NH 03801 BK 1930 PG 0229

JBE PROJECT NO. 20737

DRAWING No.

Date: 3/3/21 Design: JAC Draft: LAZ Checked: JAC | Scale: AS NOTED | Project No.: 20737 Drawing Name: 20737-PLAN.dwg THIS PLAN SHALL NOT BE MODIFIED WITHOUT WRITTEN PERMISSION FROM JONES & BEACH ENGINEERS, INC. (JBE). ANY ALTERATIONS, AUTHORIZED OR OTHERWISE, SHALL BE AT THE USER'S SOLE RISK AND WITHOUT LIABILITY TO JBE.



6 6/22/21 **REVISIONS PER TOWN REVIEW** 5 5/5/21 REVISIONS 4 3/18/21 ADDED DETAIL 3/3/21 ADDED SURVEY INFO LAZ 1/6/21 MINOR REVISIONS DJM REVISION BY DATE


Designed and Produced in NH 603-772-4746

85 Portsmouth Ave. Civil Engineering Services PO Box 219 Stratham, NH 03885

GAS TRENCH

NOT TO SCALE

FAX: 603-772-0227 E-MAIL: JBE@JONESANDBEACH.COM

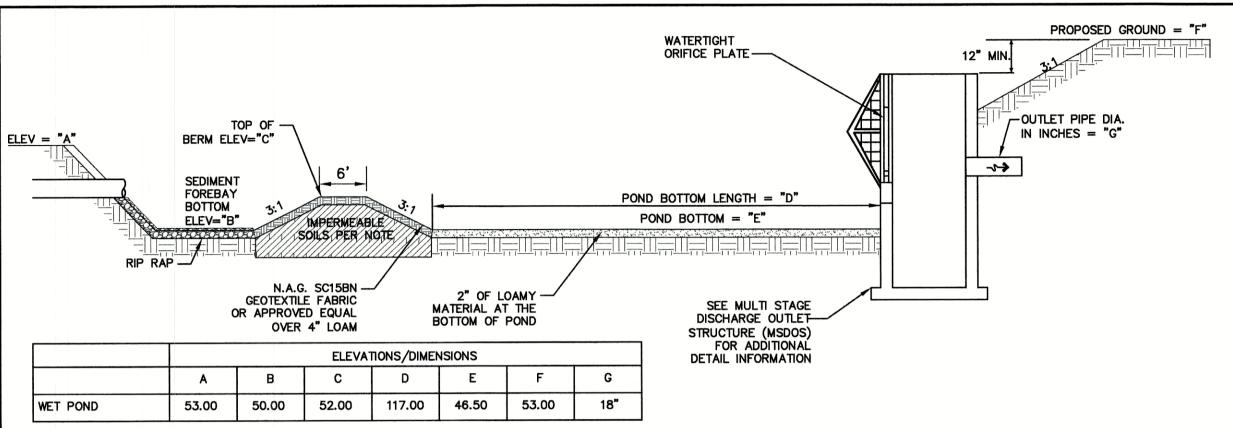

WET POND SECTION

NOT TO SCALE

PAINTED ANGLE IRON

#5 REBAR

4"o.c. –

CONCRETE SLAB

BE USED.

NOT TO SCALE

1/2" SLOT FOR

1/4" ORIFICE PLATE -

TRASHRACK FRAME

WET POND CONSTRUCTION CRITERIA

- FOUNDATION PREPARATION THE FOUNDATION AREA SHALL BE CLEARED OF TREES LOGS, STUMPS, ROOTS, BRUSH, BOULDERS, SOD, AND RUBBISH. IF NEEDED TO ESTABLISH VEGETATION, THE TOPSOIL AND SOD SHALL BE STOCKPILED AND SPREAD ON THE COMPLETED DAM AND SPILLWAYS. FOUNDATION SURFACES SHALL BE SLOPED NO STEEPER THAN 1:1. THE FOUNDATION AREA SHALL BE THOROUGHLY SCARIFIED BEFORE PLACEMENT OF THE MATERIAL. THE SURFACE SHALL HAVE MOISTURE ADDED OR IT SHALL BE COMPACTED, IF NECESSARY, SO THAT THE FIRST LAYER OF FILL MATERIAL CAN BE COMPACTED AND BONDED TO THE FOUNDATIONS. THE CUTOFF TRENCH AND ANY OTHER REQUIRED EXCAVATIONS SHALL BE DUG TO THE LINES AND GRADES SHOWN ON THE PLANS OR AS STAKED IN THE FIELD. IF THEY ARE SUITABLE, EXCAVATED MATERIALS SHALL BE USED IN THE PERMANENT FILL. EXISTING STREAM CHANNELS IN THE FOUNDATION AREA SHALL BE SLOPED NO STEEPER THAN 1:1 AND DEEPENED AND WIDENED AS NECESSARY TO REMOVE ALL STONES, GRAVEL, SAND, STUMPS, ROOTS, AND OTHER OBJECTIONABLE MATERIAL AND TO ACCOMMODATE COMPACTION EQUIPMENT. FILL PLACEMENT -- THE MATERIAL PLACED IN THE FILL SHALL BE FREE OF DETRIMENTAL AMOUNTS OF SOD, ROOTS, FROZEN SOIL, STONES MORE THAN 6 INCHES IN DIAMETER (EXCEPT FOR ROCK FILLS), AND OTHER OBJECTIONABLE MATTER.
- SELECTED BACK FILL MATERIAL SHALL BE PLACED AROUND STRUCTURES, PIPE CONDUITS AND ANTI SEEP COLLARS AT ABOUT THE SAME RATE ON ALL SIDES, TO PREVENT DAMAGE FROM UNEQUAL LOADING. THE PLACING AND SPREADING OF FILL MATERIAL SHALL BE STARTED AT THE LOWEST POINT OF THE FOUNDATION AND THE FILL BROUGHT UP IN HORIZONTAL LAYERS OF SUCH THICKNESS THAT THE REQUIRED COMPACTION CAN BE OBTAINED. THE FILL SHALL BE CONSTRUCTED IN CONTINUOUS HORIZONTAL LAYERS EXCEPT WHERE OPENINGS OR SECTIONALIZED FILLS ARE REQUIRED. IN THOSE CASES, THE SLOPE OF THE BONDING SURFACES BETWEEN THE EMBANKMENT IN PLACE AND THE EMBANKMENT TO BE PLACED SHALL NOT BE STEEPER THAN 3 HORIZONTAL TO 1 VERTICAL. THE BONDING SURFACE SHALL BE TREATED THE SAME AS THAT SPECIFIED FOR THE FOUNDATION SO AS TO INSURE A GOOD BOND WITH THE NEW FILL. THE DISTRIBUTION AND GRADATION OF MATERIALS SHALL BE SUCH THAT NO LENSES, POCKETS, STREAKS, OR LAYERS OF MATERIAL DIFFER SUBSTANTIALLY IN TEXTURE OF GRADATION FROM THE SURROUNDING MATERIAL. IF IT IS NECESSARY TO USE MATERIALS OF VARYING TEXTURE AND GRADATION, THE MORE IMPERVIOUS MATERIAL SHALL BE PLACED IN THE CENTER AND UPSTREAM PARTS OF THE FILL. IF ZONED FILLS OF SUBSTANTIALLY DIFFERING MATERIALS ARE SPECIFIED, THE ZONES SHALL BE PLACED ACCORDING TO THE LINES AND GRADES SHOWN ON THE DRAWINGS. THE COMPLETE WORK SHALL CONFORM TO THE LINES, GRADES, AND ELEVATIONS SHOWN ON THE DRAWINGS OR AS STAKED IN THE FIELD.
- MOISTURE CONTROL -- THE MOISTURE CONTENT OF THE FILL MATERIAL SHALL BE ADEQUATE FOR OBTAINING THE REQUIRED COMPACTION, MATERIAL THAT IS TOO WET SHALL BE DRIED TO MEET THIS REQUIREMENT, AND MATERIAL THAT IS TOO DRY SHALL HAVE WATER ADDED AND MIXED UNTIL THE REQUIREMENT IS MET.
- COMPACTION -- CONSTRUCTION EQUIPMENT SHALL BE OPERATED OVER THE AREAS OR EACH LAYER OF FILL TO INSURE THAT THE REQUIRED COMPACTION IS OBTAINED, SPECIAL EQUIPMENT SHALL BE USED IF NEEDED TO OBTAIN THE REQUIRED COMPACTION. IF A MINIMUM REQUIRED DENSITY IS SPECIFIED, EACH LAYER OF FILL SHALL BE COMPACTED AS NECESSARY TO OBTAIN THAT DENSITY. FILL ADJACENT TO STRUCTURES, PIPE CONDUITS, AND ANTI SEEP COLLARS SHALL BE COMPACTED TO A DENSITY EQUIVALENT TO THAT OF THE SURROUNDING FILL BY MEANS OF HAND TAMPING OR MANUALLY DIRECTED POWER TAMPER OR PLATE VIBRATORS. FILL ADJACENT TO CONCRETE STRUCTURES SHALL NOT BE COMPACTED UNTIL THE CONCRETE IS STRONG ENOUGH TO
- PROTECTION -- A PROTECTIVE COVER OF VEGETATION SHALL BE ESTABLISHED ON ALL EXPOSED SURFACES OF THE EMBANKMENT, SPILLWAY, AND BORROW AREA IF SOIL AND CLIMATIC CONDITIONS PERMIT. IF SOIL OR CLIMATIC CONDITIONS PRECLUDE THE USE OF VEGETATION AND PROTECTION IS NEEDED, NON-VEGETATIVE MEANS SUCH AS MULCHES OR GRAVEL MAY BE USED. IN SOME PLACES, TEMPORARY VEGETATION MAY BE USED UNTIL CONDITIONS PERMIT ESTABLISHMENT OF PERMANENT VEGETATION. THE EMBANKMENT AND SPILLWAY SHALL BE FENCED IF NECESSARY TO PROTECT THE VEGETATION.
- SEEDBED PREPARATION, SEEDING, FERTILIZING, AND MULCHING SHALL COMPLY WITH THE APPROPRIATE VEGETATIVE BMP'S.
- CONCRETE -- THE MIX DESIGN AND TESTING OF CONCRETE SHALL BE CONSISTENT WITH THE STRENGTH REQUIREMENTS OF THE JOB. MIX REQUIREMENTS OR NECESSARY STRENGTH SHALL BE SPECIFIED. THE TYPE OF CEMENT, AIR ENTRAPMENT, SLUMP, AGGREGATE, OR OTHER PROPERTIES SHALL BE SPECIFIED IF NECESSARY. ALL CONCRETE IS TO CONSIST OF A WORKABLE MIX THAT CAN BE PLACED AND FINISHED IN AN ACCEPTABLE MANNER. NECESSARY CURING SHALL BE SPECIFIED. REINFORCING STEEL SHALL BE PLACED AS INDICATED ON THE PLANS AND SHALL BE HELD SECURELY IN PLACE DURING CONCRETE PLACEMENT. SUB GRADES AND FORMS SHALL BE INSTALLED TO LINE AND GRADE, AND THE FORMS SHALL BE MORTAR TIGHT AND UNYIELDING AS THE
- 8. THE CONTRACTOR WILL NOTIFY JONES AND BEACH ENGINEERS AFTER EACH OF THE GRAVEL WETLAND PONDS HAVE BEEN EXCAVATED TO THE BOTTOM OF THE SYSTEM FOR A MANDATORY
- BERMS AND WEIRS SEPARATING THE FOREBAY AND TREATMENT CELLS SHOULD BE CONSTRUCTED WITH CLAY, OR NON-CONDUCTIVE SOILS, AND/OR A FINE GEOTEXTILE, OR SOME COMBINATION THEREOF, TO AVOID WATER SEEPAGE AND SOIL PIPING THROUGH THESE EARTHEN DIVIDERS.

FRONT VIEW

--|^{3"}|--|

APPROXIMATE LIST OF MATERIALS

3. REQUIRED S.S. BOLTS AND FASTENERS

4. 1/4" STEEL PLATE WITH DRILLED ORIFICES 5. 1 C.Y. - CRUSHED STONE FOR BASE

6. 48 #5 REBARS © 1', 2' AND 3' LENGTHS

1. 3 C.Y. - 5000 PSI CONCRETE

2. 15 ANGLE IRONS @ 4' LENGTH

7. 32 #4 REBARS @ 4.5' LENGTH


1. REINFORCING STEEL SHALL CONSIST OF A SINGLE LAYER OF HORIZONTAL AND VERTICAL PLACED #4 REBAR @

3. CONCRETE SLAB TO BE CONSTRUCTED ALONG WITH BASE. FOR PRECAST BOX, A SLOTTED CONCRETE SLAB TO

CONCRETE BOX TO BE CONSTRUCTED OR PRECAST OF EQUAL DIMENSIONS AND REINFORCING.

MULTI-STAGE DISCHARGE OUTLET STRUCTURE (MSDOS)

4. SECTION JOINTS AND PIPE OPENING SHALL BE SEALED WATERTIGHT WITH MORTAR BY CONTRACTOR.

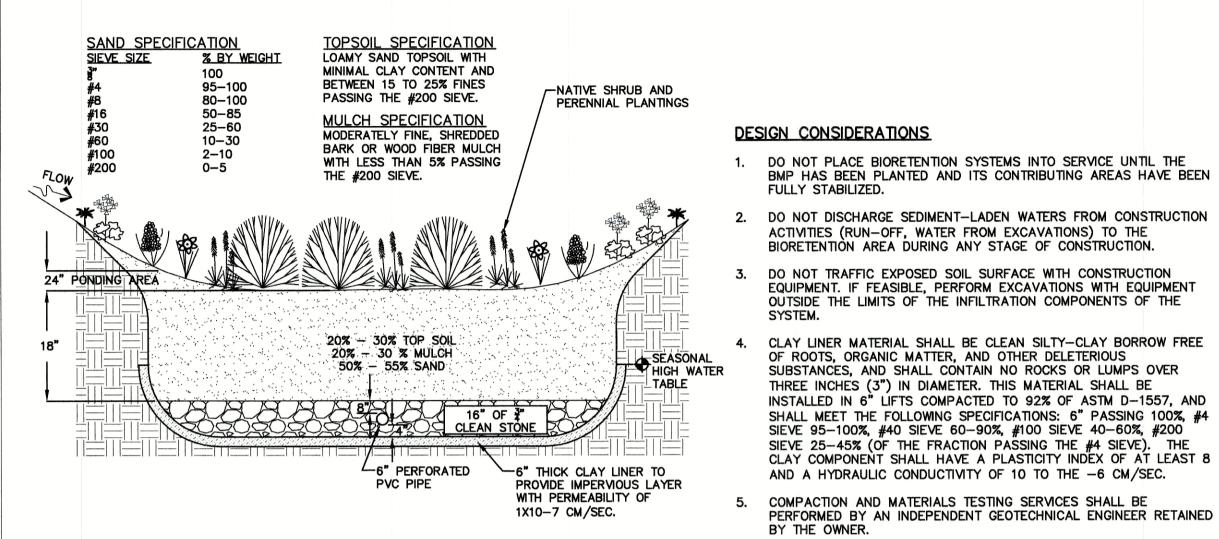

BIORETENTION SYSTEM (with clay bottom and pipe)

NOT TO SCALE


- STAINLESS STEEL HINGE

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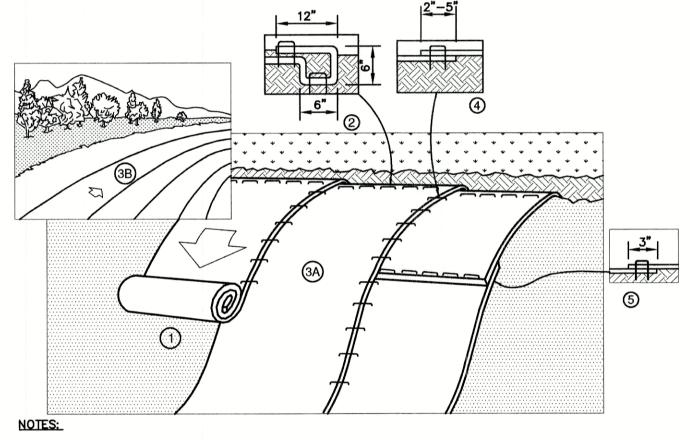
POND STRUCTURE COVER

- ANGLE IRON



DRIP EDGE DETAIL

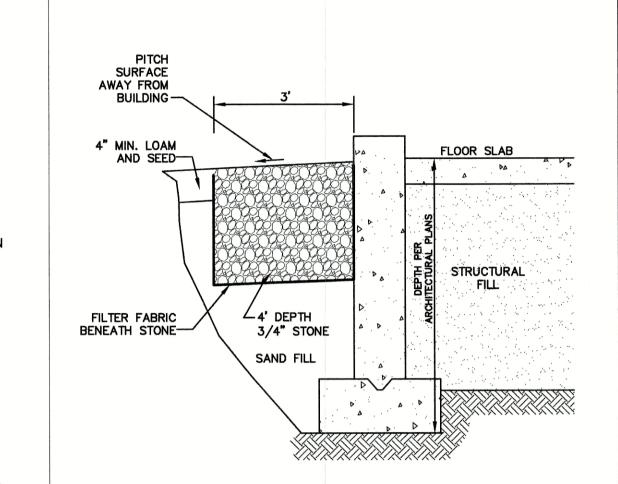NOT TO SCALE



- 1. PREPARE SOIL BEFORE INSTALLING BLANKETS, INCLUDING ANY NECESSARY APPLICATION OF LIME. FERTILIZER, AND SEED. NOTE: WHEN USING CELL-O-SEED DO NOT SEED PREPARED AREA. CELL-O-SEED MUST BE INSTALLED WITH PAPER SIDE DOWN.
- 2. BEGIN AT THE TOP OF THE SLOPE BY ANCHORING THE BLANKET IN A 6" DEEP BY 6" WIDE TRENCH WITH APPROXIMATELY 12" OF BLANKET EXTENDED BEYOND THE UP-SLOPE PORTION OF THE TRENCH. ANCHOR THE BLANKET WITH A ROW OF STAPLES/STAKES APPROXIMATELY 12" APART IN THE BOTTOM OF THE TRENCH, BACKFILL AND COMPACT THE TRENCH AFTER STAPLING. APPLY SEED TO COMPACTED SOIL AND FOLD REMAINING 12" PORTION OF BLANKET BACK OVER SEED AND COMPACTED SOIL. SECURE BLANKET OVER COMPACTED SOIL WITH A ROW OF STAPLES/STAKES SPACED APPROXIMATELY 12" APART ACROSS THE WIDTH OF THE BLANKET.
- 3. ROLL THE BLANKETS (A) DOWN OR (B) HORIZONTALLY ACROSS THE SLOPE. BLANKETS WILL UNROL WITH APPROPRIATE SIDE AGAINST THE SOIL SURFACE. ALL BLANKETS MUST BE SECURELY FASTENED TO SOIL SURFACE BY PLACING STAPLES/STAKES IN APPROPRIATE LOCATIONS AS SHOWN IN THE STAPLE PATTERN GUIDE. WHEN USING OPTIONAL DOT SYSTEMTM. STAPLES/STAKES SHOULD BE PLACED THROUGH EACH OF THE COLORED DOTS CORRESPONDING TO THE APPROPRIATE STAPLE PATTERN.
- 4. THE EDGES OF PARALLEL BLANKETS MUST BE STAPLED WITH APPROXIMATELY 2"-5" OVERLAP DEPENDING ON BLANKET TYPE. TO ENSURE PROPER SEAM ALIGNMENT, PLACE THE EDGE OF THE OVERLAPPING BLANKET (BLANKET BEING INSTALLED ON TOP) EVEN WITH THE COLORED SEAM STITCH ON THE PREVIOUSLY INSTALLED BLANKET.
- 5. CONSECUTIVE BLANKETS SPLICED DOWN THE SLOPE MUST BE PLACED END OVER END (SHINGLE STYLE) WITH AN APPROXIMATE 3" OVERLAP. STAPLE THROUGH OVERLAPPED AREA, APPROXIMATELY 12" APART ACROSS ENTIRE BLANKET WIDTH. NOTE: IN LOOSE SOIL CONDITIONS, THE USE OF STAPLE OR STAKE LENGTHS GREATER THAN 6" MAY BE NECESSARY TO PROPERLY SECURE THE BLANKETS.

FAX: 603-772-0227


E-MAIL: JBE@JONESANDBEACH.COM



NORTH AMERICAN GREEN 14649 HIGHWAY 41 NORTH EVANSVILLE, INDIANA 47725 1-800-772-2040

EROSION CONTROL BLANKET SLOPE INSTALLATION NORTH AMERICAN GREEN (800) 772-2040

NOT TO SCALE

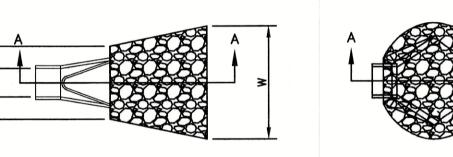

GEOTEXTILE FABRIC (AMOCO #2006 OR EQUIVALENT) TO BE PLACED BETWEEN RIP RAP AND

6" SAND FILTER TO BE PLACED BELOW THE GEOTEXTILE FOR THE FULL EXTENT OF THE APRON (TYP.)-

SECTION A-A PIPE OUTLET TO FLAT AREA

WITH NO DEFINED CHANNEL

SOIL (TYP.)-

SECTION A-A WELL-DEFINED CHANNEL

					CHANNEL
TABLE 7-24	RECOMMENDED	RIP RAP	GRADATI	ON	RANGES
THICKNESS OF	RIP RAP = 1.5	5 FEET			
d50 SIZE=	0.50	FEET	6	IN	CHES
% OF WEIGHT S THAN THE GIVE		SIZE FROM	OF STO	ΝE	(INCHES) TO
100%		9			12
85%		8			11
50%		6			9
15%		2			3

- 1. THE SUBGRADE FOR THE GEOTEXTILE FABRIC AND RIP RAP SHALL BE PREPARED TO THE LINES AND GRADES SHOWN ON THE PLANS.
- 2. THE RIP RAP SHALL CONFORM TO THE SPECIFIED GRADATION.
- 3. GEOTEXTILE FABRICS SHALL BE PROTECTED FROM PUNCTURE OR TEARING DURING THE PLACEMENT OF THE ROCK RIP. DAMAGED AREAS IN THE FABRIC SHALL BE REPAIRED BY PLACING A PIECE OF FABRIC OVER THE DAMAGED AREA OR BY COMPLETE REPLACEMENT OF THE FABRIC. ALL OVERLAPS REQUIRED FOR REPAIRS OR JOINING TWO PIECES OF FABRIC SHALL BE A MINIMUM OF 12 INCHES.
- 4. STONE FOR THE RIP RAP MAY BE PLACED BY EQUIPMENT AND SHALL BE CONSTRUCTED TO THE FULL LAYER THICKNESS IN ONE OPERATION AND IN SUCH A MANNER AS TO PREVENT SEGREGATION OF THE
- 5. OUTLETS TO A DEFINED CHANNEL SHALL HAVE 2:1 OR FLATTER SIDE SLOPES AND SHOULD BEGIN AT THE TOP OF THE CULVERT AND TAPER DOWN TO THE CHANNEL BOTTOM THROUGH THE LENGTH OF THE
- 6. MAINTENANCE: THE OUTLET PROTECTION SHOULD BE CHECKED AT LEAST ANNUALLY AND AFTER EVERY MAJOR STORM. IF THE RIP RAP HAS BEEN DISPLACED, UNDERMINED OR DAMAGED, IT SHOULD BE REPAIRED IMMEDIATELY. THE CHANNEL IMMEDIATELY BELOW THE OUTLET SHOULD BE CHECKED TO SEE THAT EROSION IS NOT OCCURRING. THE DOWNSTREAM CHANNEL SHOULD BE KEPT CLEAR OF OBSTRUCTIONS SUCH AS FALLEN TREES, DEBRIS, AND SEDIMENT THAT COULD CHANGE FLOW PATTERNS AND/OR TAILWATER DEPTHS ON THE PIPES. REPAIRS MUST BE CARRIED OUT IMMEDIATELY TO AVOID ADDITIONAL DAMAGE TO OUTLET PROTECTION.

RIP RAP OUTLET PROTECTION APRON

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TOP VIEW



2	6	6/22/21	REVISIONS PER TOWN REVIEW	LAZ
2	5	5/5/21	REVISIONS	LAZ
3	4	3/18/21	ADDED DETAIL	LAZ
12	3	3/3/21	ADDED SURVEY INFO	LAZ
0	2	1/6/21	MINOR REVISIONS	DJM
	REV.	DATE	REVISION	BY

PAINTED ANGLE IRON

-SLOT FOR 1/4" ORIFICE PLATE

-TRASH RACK OF ANGLE

ANGLE IRON S.S. BOLTED

ON CONCRETE FOR TRASH

IRON AND REBAR

RACK PLACEMENT

A ORIFICE SIZE

TRASHRACK FRAME __ -- 6" -

POND BOTTOM

51.00

6"

STRUCTURE IS TO BE DESIGNED FOR H20 LOADING.

1/2" SLOT FOR

ORIFICE/

SIDE VIEW

5. ALL EXPOSED REBAR TO BE PAINTED WITH RUST-RESISTANT PAINT, COLOR AT CONTRACTOR'S DISCRETION

TO BE SUPPLIED BY CAPITAL CONCRETE PRODUCTS OF HENNIKER, N.H., (1-603-428-3218) OR EQUAL.

STRUCTURE TO HAVE TEMPORARY PLYWOOD INSTALLED IN THE ORIFICE PLATE SLOT UNTIL THE SITE IS

(E)

52.25 52.75

(C)

9. SOIL UNDERLYING THE STRUCTURE IS TO BE COMPACTED TO 95% MODIFIED PROCTOR.

USIZE /

1/4" ORIFICE PAT

6" WALLS

(F)

(G)

48.00 51.00 47.50

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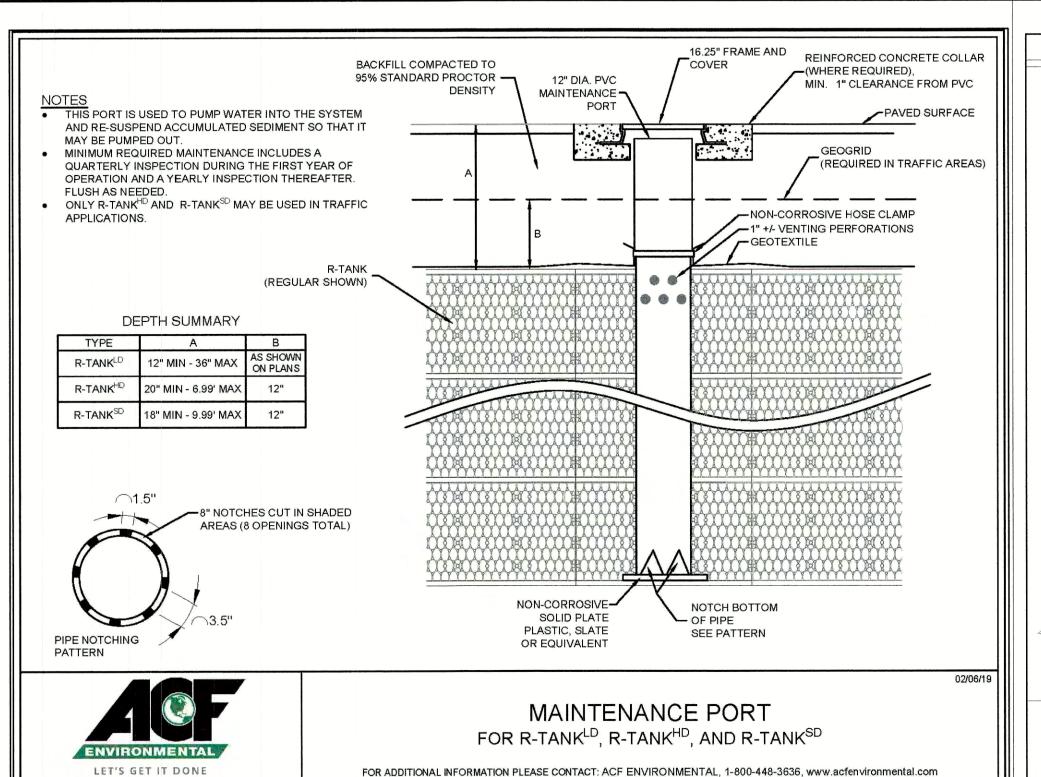
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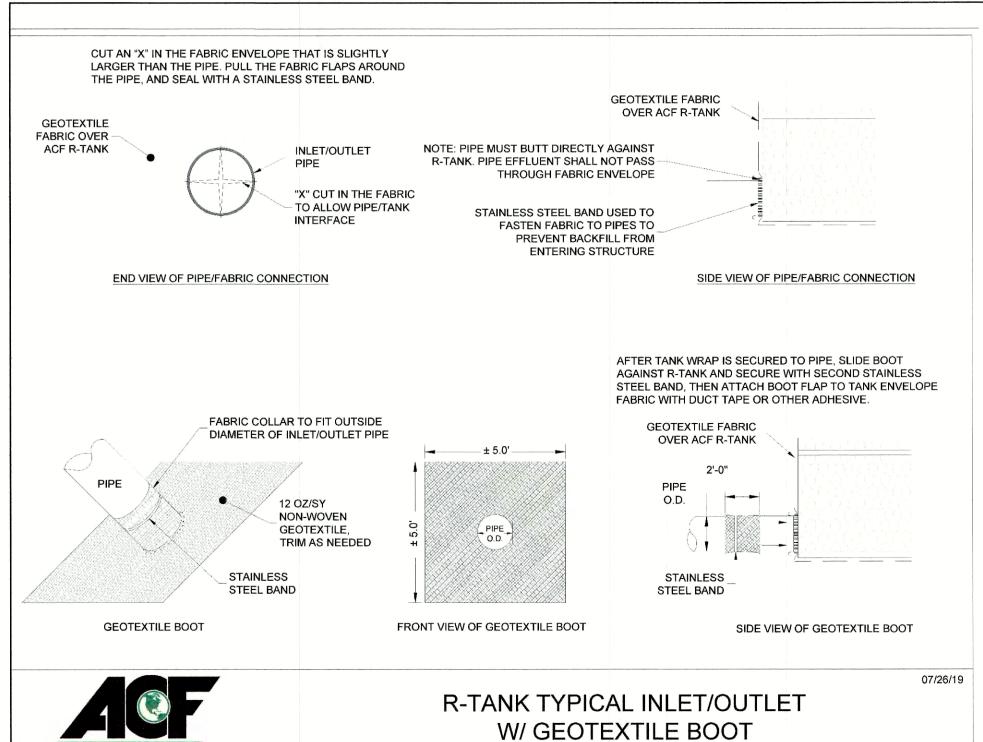
DETAIL SHEET Plan Name: 3400 LAFAYETTE ROAD Project: PORTSMOUTH, NH RICCI CONSTRUCTION CO., INC.


Owner of Record 225 BANFIELD ROAD, PORTSMOUTH, NH 03801 BK 1930 PG 0229


SHEET 20 OF 25 JBE PROJECT NO. 20737

DRAWING No.





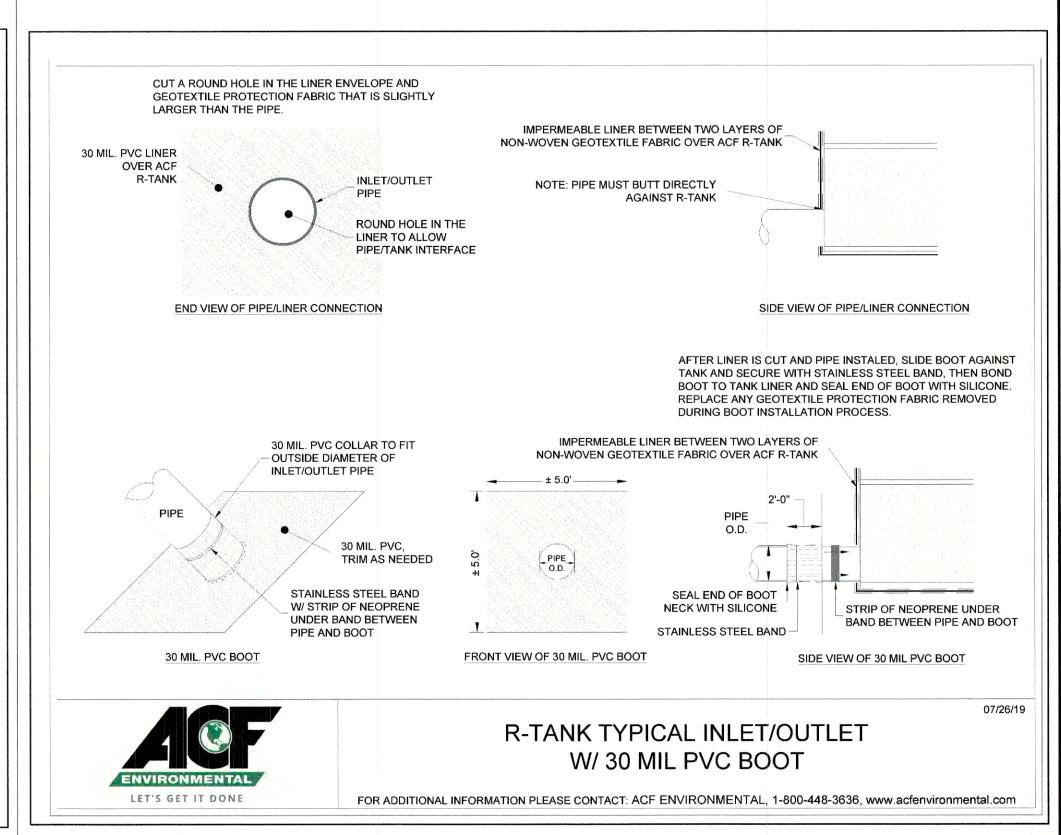

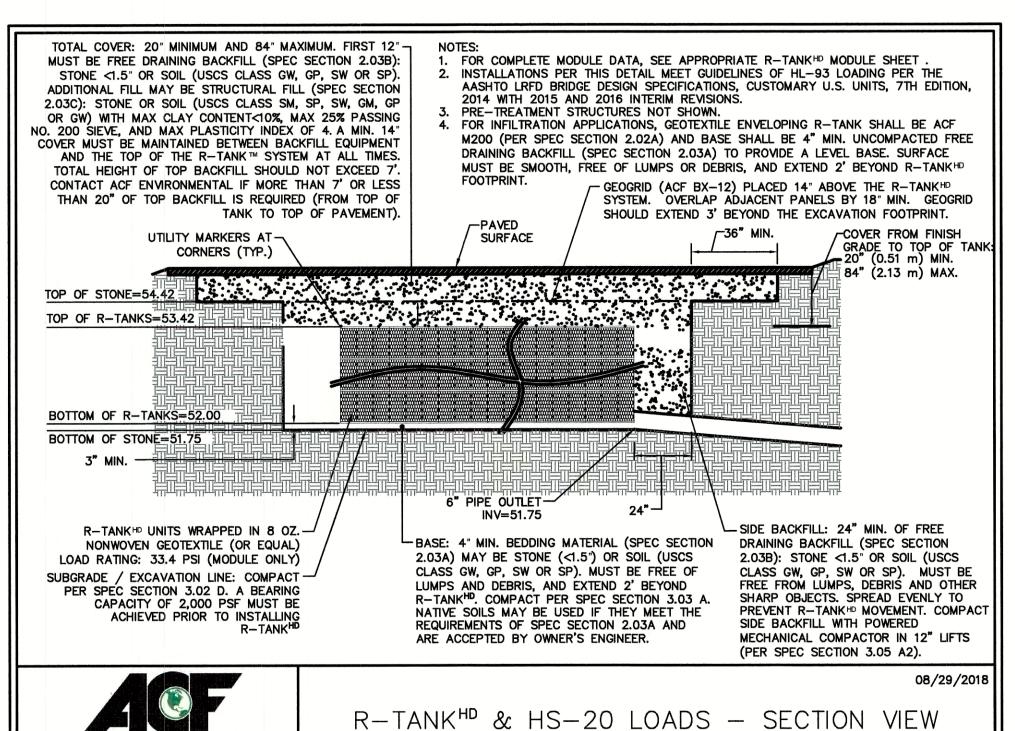

2.02 GEOSYNTHETICS

A. GEOTEXTILE. A GEOTEXTILE ENVELOPE IS REQUIRED TO PREVENT BACKFILL. TRAFFIC APPLICATIONS - FREE DRAINING MATERIAL SHALL BE USED MATERIAL FROM ENTERING THE R-TANK MODULES

STANDARD APPLICATION: THE STANDARD GEOTEXTILE SHALL BE AN 8 OZ PER SQUARE YARD NONWOVEN GEOTEXTILE (ACF NO80 OR EQUIVALENT). INFILTRATION APPLICATIONS: WHEN WATER MUST INFILTRATE /EXFILTRATE THROUGH THE GEOTEXTILE AS A FUNCTION OF THE SYSTEM DESIGN, A

WOVEN MONOFILAMENT (ACF M200 OR EQUIVALENT) SHALL BE USED. B. GEOGRID. FOR INSTALLATIONS SUBJECT TO TRAFFIC LOADS AND/OR WHEN REQUIRED BY PROJECT PLANS, INSTALL GEOGRID (ACF BX12 OR EQUIVALENT) TO REINFORCE BACKFILL ABOVE THE R-TANK SYSTEM. GEOGRID IS NOT ALWAYS REQUIRED FOR R-TANKUD INSTALLATIONS, AND IS OFTEN NOT REQUIRED FOR NON-TRAFFIC LOAD APPLICATIONS.

2.03 BACKFILL & COVER MATERIALS

A. BEDDING MATERIALS: STONE (ANGULAR AND SMALLER THAN 1.5" IN DIAMETER) OR SOIL (GW, GP, SW, OR SP AS CLASSIFIED BY THE UNIFIED SOIL CLASSIFICATION SYSTEM) SHALL BE USED BELOW THE R-TANK SYSTEM (3" MINIMUM). MATERIAL MUST BE FREE FROM LUMPS, DEBRIS, AND ANY SHARP OBJECTS THAT COULD CUT THE GEOTEXTILE. MATERIAL SHALL BE WITHIN 3 PERCENT OF THE OPTIMUM MOISTURE CONTENT AS DETERMINED BY ASTM D698 AT THE TIME OF INSTALLATION. FOR INFILTRATION APPLICATIONS BEDDING MATERIAL SHALL BE FREE DRAINING. A 1' TO 2' LAYER OF UNSUITABLE MATERIAL OCCURS 3' TO 6' BELOW EXISTING GRADE WITHIN THE R-TANK SYSTEM FOOTPRINT. THIS MATERIAL IS TO BE REMOVED AND REPLACED WITHIN THE R-TANK SYSTEM FOOTPRINT WITH STONE (ANGULAR AND SMALLER THAN 1.5" IN DIAMETER) OR SOIL (GW, GP, SW, OR SP AS CLASSIFIED BY THE UNIFIED SOIL CLASSIFICATION SYSTEM). A BED BOTTOM INSPECTION SHALL BE PERFORMED BY TRUSLOW RESOURCE CONSULTING PRIOR TO CONSTRUCTION OF THE R-TANK SYSTEM.

B. SIDE AND TOP BACKFILL: MATERIAL MUST BE FREE FROM LUMPS, DEBRIS AND ANY SHARP OBJECTS THAT COULD CUT THE GEOTEXTILE, MATERIAL2.04 SHALL BE WITHIN 3 PERCENT OF THE OPTIMUM MOISTURE CONTENT AS DETERMINED BY ASTM D698 AT THE TIME OF INSTALLATION.

ADJACENT TO (24" MINIMUM) AND ABOVE (FOR THE FIRST 12") THE R-TANK SYSTEM.


FOR ADDITIONAL INFORMATION PLEASE CONTACT: ACF ENVIRONMENTAL, 1-800-448-3636, www.acfenvironmental.com

a. FOR HD, AND SD MODULES, BACKFILL MATERIALS SHALL BE FREE DRAINING STONE (ANGULAR AND SMALLER THAN 1.5" IN DIAMETER) OR SOIL (GW, GP, SW, OR SP AS CLASSIFIED BY THE UNIFIED SOIL CLASSIFICATION SYSTEM).

b. FOR UD MODULES WITH LESS THAN 14" OF TOP COVER, BACKFILL MATERIALS SHALL BE FREE DRAINING STONE (ANGULAR AND SMALLER THAN 1.5" IN DIAMETER). THE USE OF SOIL BACKFILL ON THE SIDES AND TOP OF THE UD MODULE IS NOT PERMITTED UNLESS THE MODULES ARE INSTALLED OUTSIDE OF TRAFFIC AREAS OR WITH COVER DEPTHS OF 14" OR MORE. TOP BACKFILL MATERIAL (FROM TOP OF MODULE TO BOTTOM OF PAVEMENT BASE OR 12" MAXIMUM) MUST BE CONSISTENT WITH SIDE

NON-TRAFFIC / GREEN SPACE APPLICATIONS - FOR ALL R-TANK MODULES INSTALLED IN GREEN SPACES AND NOT SUBJECTED TO VEHICULAR LOADS, BACKFILL MATERIALS MAY EITHER FOLLOW THE GUIDELINES FOR TRAFFIC APPLICATIONS ABOVE, OR THE TOP BACKFILL LAYER (12" MINIMUM) MAY CONSIST OF AASHTO #57 STONE BLENDED WITH 30-40% (BY VOLUME) TOPSOIL TO AID IN ESTABLISHING VEGETATION. C. ADDITIONAL COVER MATERIALS: STRUCTURAL FILL SHALL CONSIST OF GRANULAR MATERIALS MEETING THE GRADATIONAL REQUIREMENTS OF SM, SP, SW, GM, GP OR GW AS CLASSIFIED BY THE UNIFIED SOIL CLASSIFICATION SYSTEM. STRUCTURAL FILL SHALL HAVE A MAXIMUM OF 25 PERCENT PASSING THE NO. 200 SIEVE, SHALL HAVE A MAXIMUM CLAY CONTENT OF 10 PERCENT AND A MAXIMUM PLASTICITY INDEX OF 4. MATERIAL SHALL BE WITHIN 3 PERCENT OF THE OPTIMUM MOISTURE CONTENT AS DETERMINED BY ASTM D698 AT THE TIME OF INSTALLATION.

A. UTILITY MARKER: INSTALL METALLIC TAPE AT CORNERS OF R-TANK SYSTEM TO MARK THE AREA FOR FUTURE UTILITY DETECTION.

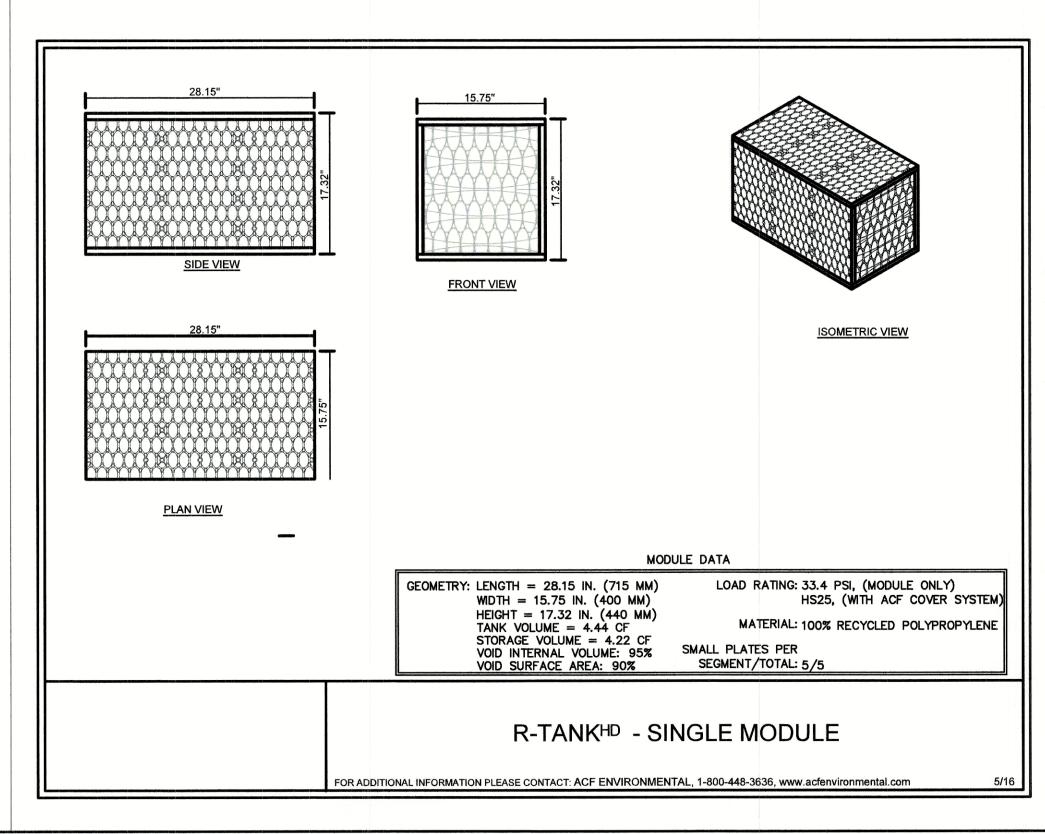

Design: JAC	Draft: LAZ	Date: 3/3/21
Checked: JAC	Scale: AS NOTED	Project No.: 20737
Drawing Name:	20737-PLAN.dwg	
THIS PLAN SHALL	NOT BE MODIFIED WIT	HOUT WRITTEN
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ANY ALTERATION	S, AUTHORIZED OR OT	HERWISE, SHALL BE
	OLE RISK AND WITHOU	

LET'S GET IT DONE



FOR ADDITIONAL INFORMATION PLEASE CONTACT: ACF ENVIRONMENTAL, 1-800-448-3636, WWW.ACFENVIRONMENTAL.COM

6	6/22/21	REVISIONS PER TOWN REVIEW	LAZ
5	5/5/21	REVISIONS	LAZ
4	3/18/21	ADDED DETAIL	LAZ
3	3/3/21	ADDED SURVEY INFO	LAZ
2	1/6/21	MINOR REVISIONS	DJM
REV.	DATE	REVISION	BY
	5 4 3 2	5 5/5/21 4 3/18/21 3 3/3/21 2 1/6/21	5 5/5/21 REVISIONS 4 3/18/21 ADDED DETAIL 3 3/3/21 ADDED SURVEY INFO 2 1/6/21 MINOR REVISIONS


Designed and Produced in NH Jones & Beach Engineers, Inc.


85 Portsmouth Ave. Civil Engineering Services 603-772-4746 FAX: 603-772-0227 PO Box 219 E-MAIL: JBE@JONESANDBEACH.COM Stratham, NH 03885

Plan Name:	DETAIL SHEET
Project:	3400 LAFAYETTE ROAD PORTSMOUTH, NH
Owner of Record: 225 BANFIELD	RICCI CONSTRUCTION CO., INC. ROAD, PORTSMOUTH, NH 03801 BK 1930 PG 0229

SHEET 21 OF 25 JBE PROJECT NO. 20737

DRAWING No.

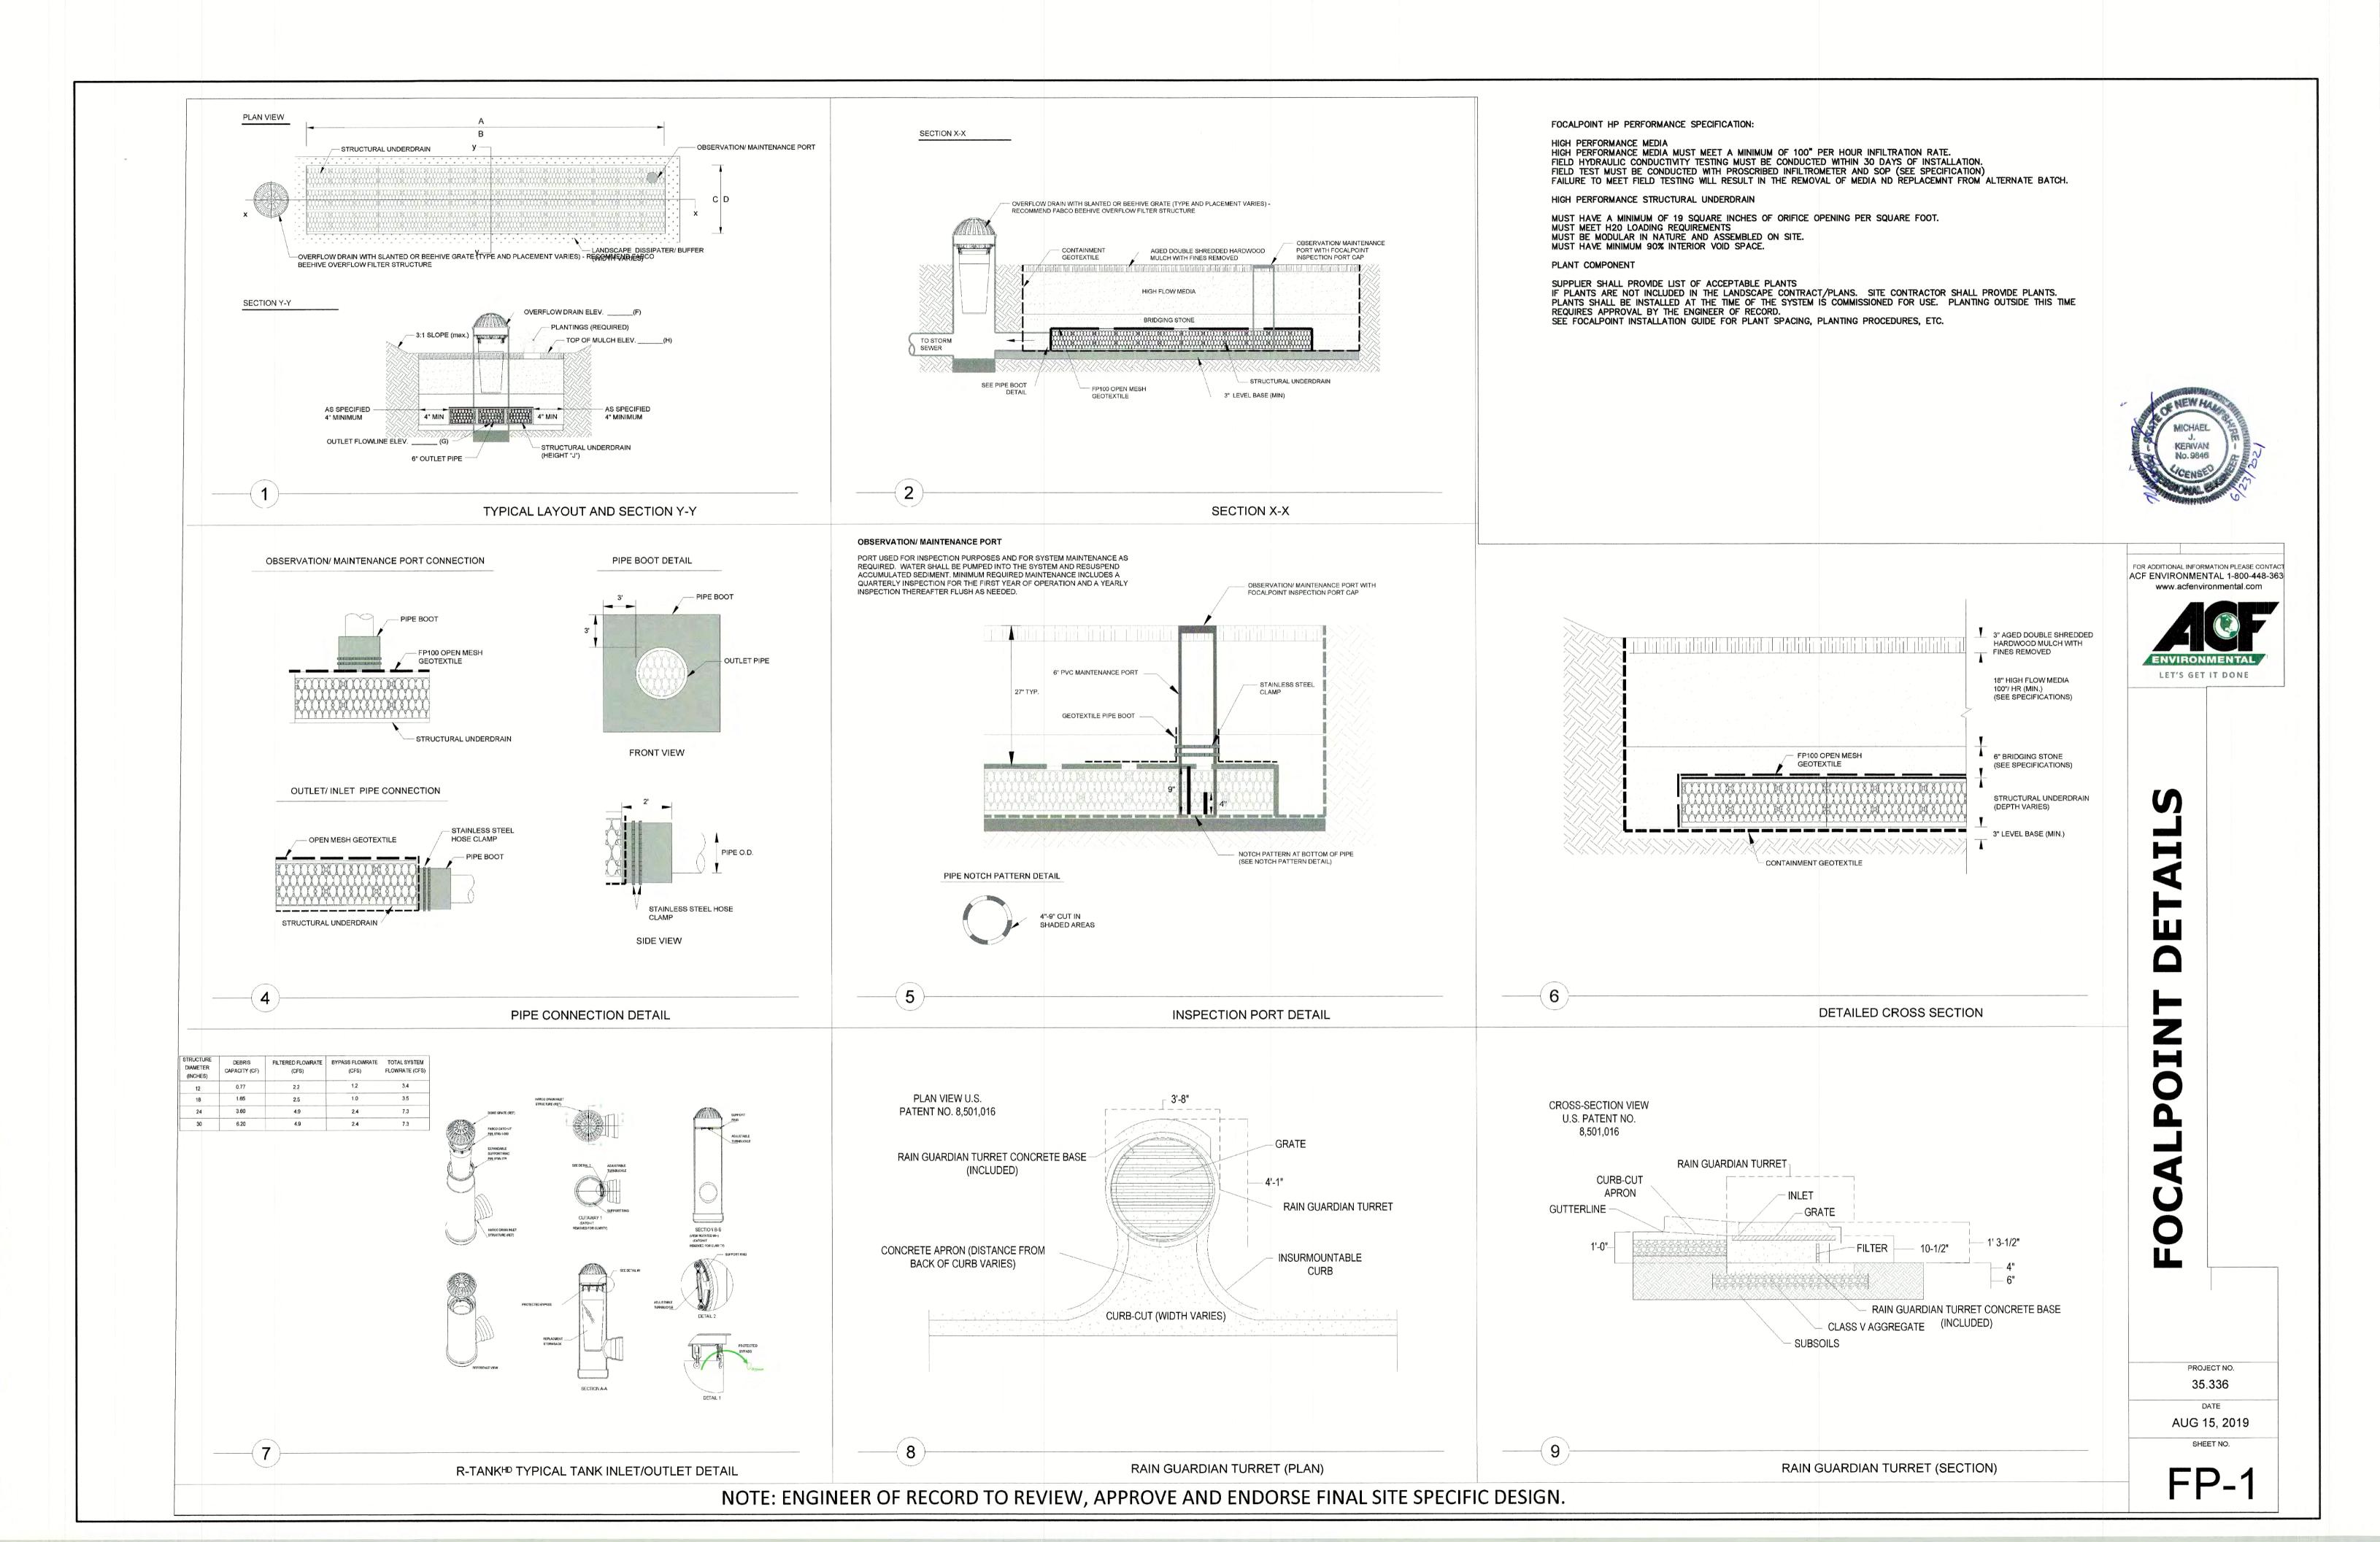

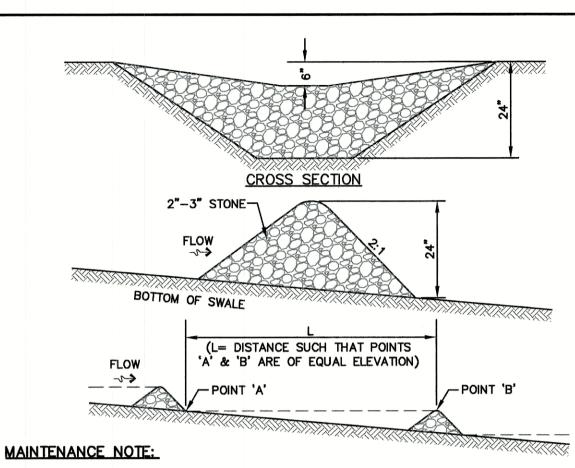


1. STONE CHECK DAMS SHOULD BE CHECKED AFTER EACH RAINFALL AND AT LEAST DAILY DURING PROLONGED RAINFALL. ANY NECESSARY REPAIRS SHOULD BE MADE IMMEDIATELY. PARTICULAR ATTENTION SHOULD BE GIVEN TO END RUN AND EROSION AT THE DOWNSTREAM TOE OF THE STRUCTURE. WHEN THE STRUCTURES ARE REMOVED, THE DISTURBED PORTION SHOULD BE BROUGHT TO THE EXISTING CHANNEL GRADE AND THE AREAS PREPARED, SEEDED AND MULCHED. WHILE THIS PRACTICE IS NOT INTENDED TO BE USED PRIMARILY FOR SEDIMENT TRAPPING, SOME SEDIMENT WILL ACCUMULATE BEHIND THE

STRUCTURES. SEDIMENT SHALL BE REMOVED FROM BEHIND THE STRUCTURES WHEN IT HAS ACCUMULATED

STONE CHECK DAM

TO ONE HALF OF THE ORIGINAL HEIGHT OF THE STRUCTURE.

NOT TO SCALE

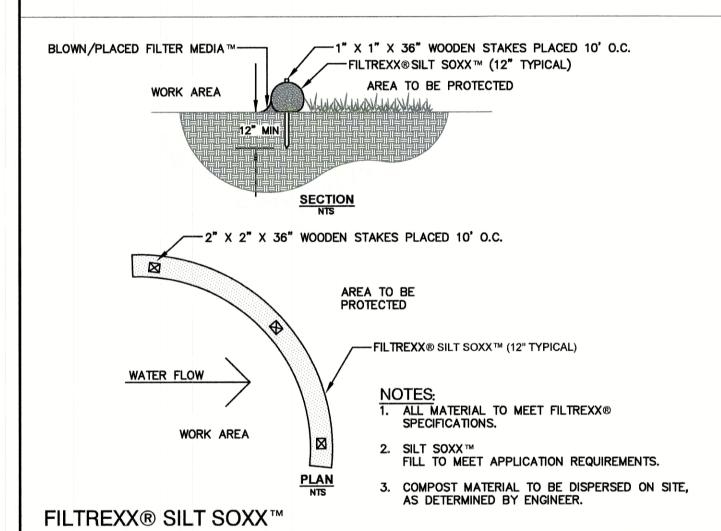

CONSTRUCTION OR ANY DISTURBED AREA TO BE STABILIZED (UPHILL)-GEOTEXTILE FENCE WITH PROPEX-SILT STOP SEDIMENT CONTROL FABRIC OR APPROVED EQUAL 48" HARDWOOD

— 16" POST DEPTH (MIN)


CONSTRUCTION SPECIFICATIONS:

NOT TO SCALE

- WOVEN FABRIC FENCE TO BE FASTENED SECURELY TO FENCE POSTS WITH WIRE TIES OR STAPLES. FILTER CLOTH SHALL BE FASTENED TO WOVEN WIRE EVERY 24" AT TOP, MID AND BOTTOM AND EMBEDDED IN THE GROUND A MINIMUM OF 8" AND THEN COVERED WITH SOIL.
- 2. THE FENCE POSTS SHALL BE A MINIMUM OF 48" LONG, SPACED A MAXIMUM 10' APART, AND DRIVEN A MINIMUM OF 16" INTO THE GROUND.
- 3. WHEN TWO SECTIONS OF FILTER CLOTH ADJOIN EACH OTHER, THE ENDS OF THE FABRIC SHALL BE OVERLAPPED 6", FOLDED AND STAPLED TO PREVENT SEDIMENT FROM BY-PASSING.
- 4. MAINTENANCE SHALL BE PERFORMED AS NEEDED AND SEDIMENT REMOVED AND PROPERLY DISPOSED OF WHEN IT IS 6" DEEP OR VISIBLE 'BULGES' DEVELOP IN THE SILT FENCE.
- 5. PLACE THE ENDS OF THE SILT FENCE UP CONTOUR TO PROVIDE FOR SEDIMENT STORAGE.
- SILT FENCE SHALL REMAIN IN PLACE FOR 24 MONTHS.

SILT FENCE

NOT TO SCALE

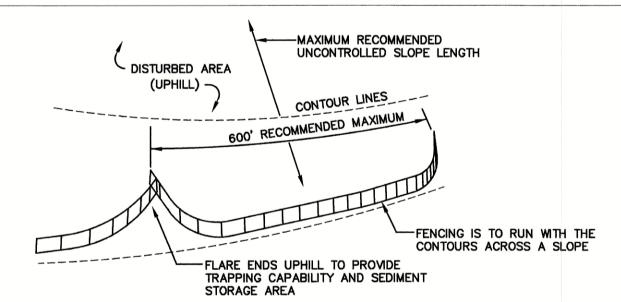

BE REVIEWED AND APPROVED BY DES PRIOR TO THE START OF CONSTRUCTION.

TEMPORARY EROSION CONTROL NOTES

LOCATIONS AS REQUIRED, DIRECTED BY THE ENGINEER.

BE STABILIZED WITHIN 45 DAYS OF INITIAL DISTURBANCE.

CONTROL BLANKETS APPROPRIATE FOR THE DESIGN FLOW CONDITIONS.

10. AN AREA SHALL BE CONSIDERED STABLE IF ONE OF THE FOLLOWING HAS OCCURRED:

b. A MINIMUM OF 85% VEGETATED GROWTH HAS BEEN ESTABLISHED;

d. EROSION CONTROL BLANKETS HAVE BEEN PROPERLY INSTALLED.

a. BASE COURSE GRAVELS HAVE BEEN INSTALLED IN AREAS TO BE PAVED;

1,000 S.F. OF AREA (48 LBS. / ACRE).

PERIODICALLY BE REMOVED AND DISPOSED OF.

IN ADVANCE OF THAW OR SPRING MELT EVENTS.

SUBMITTED TO DES VIA EMAIL (SEE BELOW).

LOCATED AND IDENTIFIED ON THIS PLAN.

ADDITION TO THOSE CALLED FOR IN THE SWPPP:

THE SITE WITHIN 24 HOURS OF THIS EVENT.

(RIDGELY MAUCK AT: RIDGELY.MAUCK ODES.NH.GOV).

SPECIFIC PERMIT ("PERMIT").

1. THE SMALLEST PRACTICAL AREA OF LAND SHALL BE EXPOSED AT ANY ONE TIME, AT NO TIME SHALL AN AREA IN

PROPOSED GRADES AND ELEVATIONS. DISTURBED AREAS SHALL BE LOAMED WITH A MINIMUM OF 6" OF SCREENED

OF A RAINFALL OF 0.5" OR GREATER. ALL DAMAGED AREAS SHALL BE REPAIRED, AND SEDIMENT DEPOSITS SHALL

AFTER ALL DISTURBED AREAS HAVE BEEN STABILIZED, THE TEMPORARY EROSION CONTROL MEASURES SHALL BE

GRADING, OR TEMPORARILY STABILIZED WITHIN 14 DAYS OF THE INITIAL DISTURBANCE OF SOIL. ALL AREAS SHALL

NORTH AMERICAN GREEN S75 EROSION CONTROL BLANKETS (OR AN EQUIVALENT APPROVED IN WRITING BY THE

SECURED WITH ANCHORED NETTING, ELSEWHERE. THE INSTALLATION OF EROSION CONTROL BLANKETS OR MULCH

AND NETTING SHALL NOT OCCUR OVER ACCUMULATED SNOW OR ON FROZEN GROUND AND SHALL BE COMPLETED

15, OR WHICH ARE DISTURBED AFTER OCTOBER 15, SHALL BE STABILIZED TEMPORARILY WITH STONE OR EROSION

ENGINEER) ON SLOPES GREATER THAN 3:1, AND SEEDING AND PLACING 3 TO 4 TONS OF MULCH PER ACRE,

8. ALL DITCHES OR SWALES WHICH DO NOT EXHIBIT A MINIMUM OF 85 PERCENT VEGETATIVE GROWTH BY OCTOBER

9. AFTER OCTOBER 15th, INCOMPLETE ROAD OR PARKING SURFACES, WHERE WORK HAS STOPPED FOR THE WINTER

c. A MINIMUM OF 3" OF NON-EROSIVE MATERIAL SUCH STONE OR RIPRAP HAS BEEN INSTALLED; OR

11. FUGITIVE DUST CONTROL IS REQUIRED TO BE CONTROLLED IN ACCORDANCE WITH ENV-A 1000, AND THE PROJECT

12. PRIOR TO BEGINNING CONSTRUCTION, THE CONTRACTOR'S NAME, ADDRESS, AND PHONE NUMBER SHALL BE

14. IN ORDER TO ENSURE THE STABILITY OF THE SITE AND EFFECTIVE IMPLEMENTATION OF THE SEDIMENT AND

SHALL BE IN STRICT COMPLIANCE WITH THE FOLLOWING INSPECTION AND MAINTENANCE REQUIREMENTS IN

13. PRIOR TO CONSTRUCTION, A PHASING PLAN THAT DELINEATES EACH PHASE OF THE PROJECT SHALL B

IS TO MEET THE REQUIREMENTS AND INTENT OF RSA 430:53 AND AGR 3800 RELATIVE TO INVASIVE SPECIES.

SUBMITTED. ALL TEMPORARY SEDIMENT BASINS THAT WILL BE NEEDED FOR DEWATERING WORK AREAS SHALL BE

EROSION CONTROL MEASURES SPECIFIED IN THE PLANS FOR THE DURATION OF CONSTRUCTION, THE CONTRACTOR

a. A CERTIFIED PROFESSIONAL IN EROSION AND SEDIMENT CONTROL OR A PROFESSIONAL ENGINEER LICENSED

IN THE STATE OF NEW HAMPSHIRE ("MONITOR") SHALL BE EMPLOYED TO INSPECT THE SITE FROM THE START OF ALTERATION OF TERRAIN ACTIVITIES UNTIL THE SITE IS IN FULL COMPLIANCE WITH THE SITE

b. DURING THIS PERIOD, THE MONITOR SHALL INSPECT THE SUBJECT SITE AT LEAST ONCE A WEEK, AND IF

POSSIBLE, DURING ANY 1/2 INCH OR GREATER RAIN EVENT (I.E. 1/2 INCH OF PRECIPITATION OR MORE WITHIN

A 24 HOUR PERIOD). IF UNABLE TO BE PRESENT DURING SUCH A STORM, THE MONITOR SHALL INSPECT

THE MONITOR SHALL PROVIDE TECHNICAL ASSISTANCE AND RECOMMENDATIONS TO THE CONTRACTOR ON THE APPROPRIATE BEST MANAGEMENT PRACTICES FOR EROSION AND SEDIMENT CONTROLS REQUIRED TO

MEET THE REQUIREMENTS OF RSA 485 A:17 AND ALL APPLICABLE DES PERMIT CONDITIONS.

d. WITHIN 24 HOURS OF EACH INSPECTION, THE MONITOR SHALL SUBMIT A REPORT TO DES VIA EMAIL

e. THE MONITOR SHALL MEET WITH DES TO DECIDE UPON A REPORT FORMAT. THE REPORT FORMAT SHALL

SEASON, SHALL BE PROTECTED WITH A MINIMUM OF 3" OF CRUSHED GRAVEL PER NHDOT ITEM 304.3.

ORGANIC LOAM AND SEEDED WITH SEED MIXTURE 'C' AT A RATE NOT LESS THAN 1.10 POUNDS OF SEED PER

4. SILT FENCES AND OTHER BARRIERS SHALL BE INSPECTED EVERY SEVEN CALENDAR DAYS AND WITHIN 24 HOURS

AREAS MUST BE SEEDED AND MULCHED OR OTHERWISE PERMANENTLY STABILIZED WITHIN 3 DAYS OF FINAL

7. ALL PROPOSED VEGETATED AREAS THAT DO NOT EXHIBIT A MINIMUM OF 85 PERCENT VEGETATIVE GROWTH BY OCTOBER 15, OR WHICH ARE DISTURBED AFTER OCTOBER 15, SHALL BE STABILIZED BY SEEDING AND INSTALLING

EXCESS OF 5 ACRES BE EXPOSED AT ANY ONE TIME BEFORE DISTURBED AREAS ARE STABILIZED.

REMOVED AND THE AREA DISTURBED BY THE REMOVAL SMOOTHED AND RE-VEGETATED.

2. EROSION, SEDIMENT AND DETENTION MEASURES SHALL BE INSTALLED AS SHOWN ON THE PLANS AND AT

3. ALL DISTURBED AREAS (INCLUDING POND AREAS BELOW THE PROPOSED WATERLINE) SHALL BE RETURNED TO

7. SILT FENCES SHALL BE REMOVED WHEN NO LONGER NEEDED AND THE SEDIMENT COLLECTED SHALL BE DISPOSED AS DIRECTED BY THE ENGINEER. THE AREA DISTURBED BY THE REMOVAL SHALL BE SMOOTHED AND REVEGETATED.

MAINTENANCE:

- 1. SILT FENCES SHALL BE INSPECTED IMMEDIATELY AFTER EACH RAINFALL AND AT LEAST DAILY DURING PROLONGED RAINFALL. ANY REPAIRS THAT ARE REQUIRED SHALL BE DONE IMMEDIATELY.
- 2. IF THE FABRIC ON A SILT FENCE SHOULD DECOMPOSE OR BECOME INEFFECTIVE DURING THE EXPECTED LIFE OF THE FENCE, THE FABRIC SHALL BE REPLACED PROMPTLY.
- 3. SEDIMENT DEPOSITS SHOULD BE INSPECTED AFTER EVERY STORM EVENT. THE DEPOSITS SHOULD BE
- REMOVED WHEN THEY REACH APPROXIMATELY ONE HALF THE HEIGHT OF THE BARRIER.
- 4. SEDIMENT DEPOSITS THAT ARE REMOVED, OR LEFT IN PLACE AFTER THE FABRIC HAS BEEN REMOVED, SHALL BE GRADED TO CONFORM WITH THE EXISTING TOPOGRAPHY AND VEGETATED.

SEEDING SPECIFICATIONS

- GRADING AND SHAPING
- A. SLOPES SHALL NOT BE STEEPER THAN 2:1 WITHOUT APPROPRIATE EROSION CONTROL MEASURES AS SPECIFIED ON THE PLANS (3:1 SLOPES OR FLATTER ARE PREFERRED)
- B. WHERE MOWING WILL BE DONE, 3:1 SLOPES OR FLATTER ARE RECOMMENDED.

2. SEEDBED PREPARATION

- A. SURFACE AND SEEPAGE WATER SHOULD BE DRAINED OR DIVERTED FROM THE SITE TO PREVENT DROWNING OR WINTER KILLING OF THE PLANTS.
- STONES LARGER THAN 4 INCHES AND TRASH SHOULD BE REMOVED BECAUSE THEY INTERFERE WITH SEEDING AND FUTURE MAINTENANCE OF THE AREA. WHERE FEASIBLE, THE SOIL SHOULD BE TILLED TO A DEPTH OF ABOUT 4 INCHES TO PREPARE A SEEDBED AND FERTILIZER AND LIME MIXED INTO THE SOIL. THE SEEDBED SHOULD BE LEFT IN A REASONABLY FIRM AND SMOOTH CONDITION. THE LAST TILLAGE OPERATION SHOULD BE PERFORMED ACROSS THE SLOPE WHEREVER PRACTICAL.

- A. LIME AND FERTILIZER SHOULD BE APPLIED PRIOR TO OR AT THE TIME OF SEEDING AND INCORPORATED INTO THE SOIL. TYPES AND AMOUNTS OF LIME AND FERTILIZER SHOULD BE BASED ON AN EVALUATION OF SOIL TESTS. WHEN A SOIL TEST IS NOT AVAILABLE, THE FOLLOWING MINIMUM AMOUNTS SHOULD BE
 - AGRICULTURAL LIMESTONE, 2 TONS PER ACRE OR 100 LBS. PER 1,000 SQ.FT. NITROGEN(N), 50 LBS. PER ACRE OR 1.1 LBS. PER 1,000 SQ.FT.
 - PHOSPHATE(P205), 100 LBS. PER ACRE OR 2.2 LBS. PER 1,000 SQ.FT.
 - POTASH(K2O), 100 LBS. PER ACRE OR 2.2 LBS. PER 1,000 SQ.FT. (NOTE: THIS IS THE EQUIVALENT OF 500 LBS. PER ACRE OF 10-20-20 FERTILIZER OR 1,000 LBS. PER
- ACRE OF 5-10-10.) SEED SHOULD BE SPREAD UNIFORMLY BY THE METHOD MOST APPROPRIATE FOR THE SITE. METHODS INCLUDE BROADCASTING, DRILLING AND HYDROSEEDING. WHERE BROADCASTING IS USED, COVER SEED WITH
- .25 INCH OF SOIL OR LESS, BY CULTIPACKING OR RAKING. C. REFER TO THE 'SEEDING GUIDE' AND 'SEEDING RATES' TABLES ON THIS SHEET FOR APPROPRIATE SEED MIXTURES AND RATES OF SEEDING. ALL LEGUMES (CROWNVETCH, BIRDSFOOT, TREFOIL AND FLATPEA)
- MUST BE INOCULATED WITH THEIR SPECIFIC INOCULANT PRIOR TO THEIR INTRODUCTION TO THE SITE. WHEN SEEDED AREAS ARE MULCHED, PLANTINGS MAY BE MADE FROM EARLY SPRING TO EARLY OCTOBER. WHEN SEEDED AREAS ARE NOT MULCHED, PLANTINGS SHOULD BE MADE FROM EARLY SPRING TO MAY 20th OR FROM AUGUST 10th TO SEPTEMBER 1st.

- A. HAY, STRAW, OR OTHER MULCH, WHEN NEEDED, SHOULD BE APPLIED IMMEDIATELY AFTER SEEDING. B. MULCH WILL BE HELD IN PLACE USING APPROPRIATE TECHNIQUES FROM THE BEST MANAGEMENT PRACTICE FOR MULCHING. HAY OR STRAW MULCH SHALL BE PLACED AT A RATE OF 90 LBS PER 1000 S.F.
- 5. MAINTENANCE TO ESTABLISH A STAND

A. PLANTED AREAS SHOULD BE PROTECTED FROM DAMAGE BY FIRE, GRAZING, TRAFFIC, AND DENSE WEED

- B. FERTILIZATION NEEDS SHOULD BE DETERMINED BY ONSITE INSPECTIONS. SUPPLEMENTAL FERTILIZER IS USUALLY THE KEY TO FULLY COMPLETE THE ESTABLISHMENT OF THE STAND BECAUSE MOST PERENNIALS TAKE 2 TO 3 YEARS TO BECOME FULLY ESTABLISHED.
- C. IN WATERWAYS, CHANNELS, OR SWALES WHERE UNIFORM FLOW CONDITIONS ARE ANTICIPATED, ANNUAL MOWING MAY BE NECESSARY TO CONTROL GROWTH OF WOODY VEGETATION.

USE	SEEDING MIXTURE 1/	DROUGHTY	WELL DRAINED	MODERATELY WELL DRAINED	POORLY DRAINED
STEEP CUTS AND FILLS, BORROW AND DISPOSAL AREAS	A B C	FAIR POOR POOR	GOOD GOOD GOOD	GOOD FAIR EXCELLENT	FAIR FAIR GOOD
ANLAS	D	FAIR	EXCELLENT	EXCELLENT	POOR
WATERWAYS, EMERGEN SPILLWAYS, AND OTHE CHANNELS WITH FLOWING WATER.		GOOD GOOD	GOOD EXCELLENT	GOOD EXCELLENT	FAIR FAIR
LIGHTLY USED PARKING LOTS, ODD AREAS, UNUSED LANDS, AND LOW INTENSITY USE RECREATION SITES.	G A B C	GOOD GOOD GOOD	GOOD GOOD EXCELLENT	GOOD FAIR EXCELLENT	FAIR POOR FAIR
PLAY AREAS AND ATHLETIC FIELDS. (TOPSOIL IS ESSENTIAL FOR GOOD TURF.)	E F -	FAIR FAIR	EXCELLENT EXCELLENT	EXCELLENT EXCELLENT	2/ 2/

GRAVEL PIT, SEE NH-PM-24 IN APPENDIX FOR RECOMMENDATION REGARDING RECLAMATION OF SAND AND GRAVEL PITS.


1/ REFER TO SEEDING MIXTURES AND RATES IN TABLE BELOW. 2/ Poorly drained soils are not desirable for use as playing area and athletic fields.

NOTE: TEMPORARY SEED MIX FOR STABILIZATION OF TURF SHALL BE WINTER RYE OR OATS AT A RATE OF 2.5 LBS. PER 1000 S.F. AND SHALL BE PLACED PRIOR TO OCTOBER 15th, IF PERMANENT SEEDING NOT YET COMPLETE.

SEEDING GUIDE

MIXTURE	POUNDS PER ACRE	POUNDS PER 1.000 Sq. Ft
A. TALL FESCUE CREEPING RED FESCUE RED TOP TOTAL	20 20 2 42	0.45 0.45 <u>0.05</u> 0.95
B. TALL FESCUE CREEPING RED FESCUE CROWN VETCH OR	15 10 15	0.35 0.25 0.35
FLAT PEA TOTAL	30 40 OR 55	0.75 0.95 OR 1.35
C. TALL FESCUE CREEPING RED FESCUE BIRDS FOOT TREFOIL TOTAL	20 20 <u>8</u> 48	0.45 0.45 <u>0.20</u> 1.10
D. TALL FESCUE FLAT PEA TOTAL	20 30 50	0.45 <u>0.75</u> 1.20
E. CREEPING RED FESCUE 1/ KENTUCKY BLUEGRASS 1/ TOTAL	50 50 100	1.15 1.15 2.30
F. TALL FESCUE 1	150	3.60
1/FOR HEAVY USE ATHLETIC FINEW HAMPSHIRE COOPERATIVE ECURRENT VARIETIES AND SEEDIN	XTENSION TURF SPE	

SEEDING RATES

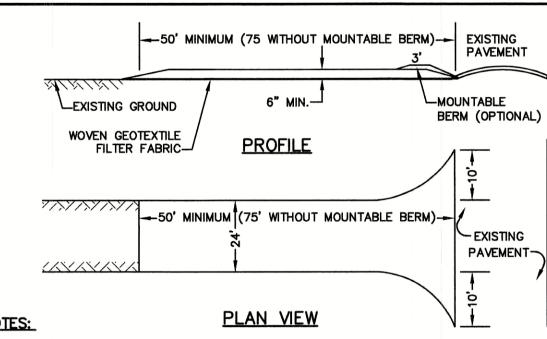

- 1. STONE FOR STABILIZED CONSTRUCTION ENTRANCE SHALL BE 3 INCH STONE, RECLAIMED STONE, OR
- RECYCLED CONCRETE EQUIVALENT. 2. THE LENGTH OF THE STABILIZED ENTRANCE SHALL NOT BE LESS THAN 50 FEET, 75' WITHOUT A MOUNTABLE BERM, AND EXCEPT FOR A SINGLE RESIDENTIAL LOT WHERE A 30 FOOT MINIMUM LENGTH
- 3. THICKNESS OF THE STONE FOR THE STABILIZED ENTRANCE SHALL NOT BE LESS THAN 6 INCHES.
 4. THE WIDTH OF THE ENTRANCE SHALL NOT BE LESS THAN THE FULL WIDTH OF THE ENTRANCE WHERE INGRESS OR EGRESS OCCURS, OR 10 FEET, WHICHEVER IS GREATER.
- GEOTEXTILE FILTER FABRIC SHALL BE PLACED OVER THE ENTIRE AREA PRIOR TO PLACING THE STONE.
- FILTER FABRIC IS NOT REQUIRED FOR A SINGLE FAMILY RESIDENTIAL LOT. 6. ALL SURFACE WATER THAT IS FLOWING TO OR DIVERTED TOWARD THE CONSTRUCTION ENTRANCE SHALL BE
- PIPED BENEATH THE ENTRANCE. IF PIPING IS IMPRACTICAL, A STONE BERM WITH 5:1 SLOPES THAT CAN BE CROSSED BY VEHICLES MAY BE SUBSTITUTED FOR THE PIPE 7. THE ENTRANCE SHALL BE MAINTAINED IN A CONDITION THAT WILL PREVENT TRACKING OR FLOWING OF
- SEDIMENT ONTO THE PUBLIC RIGHT-OF-WAY. THIS MAY REQUIRE PERIODIC TOP DRESSING WITH ADDITIONAL STONE AS CONDITIONS DEMAND AND REPAIR AND/OR CLEAN OUT OF ANY MEASURES USED TO TRAP SEDIMENT. ALL SEDIMENT SPILLED, WASHED, OR TRACKED ONTO THE PUBLIC RIGHT-OF-WAY MUST BE REMOVED PROMPTLY.

STABILIZED CONSTRUCTION ENTRANCE

NOT TO SCALE

CONSTRUCTION SEQUENCE

- PRIOR TO THE START OF ANY ACTIVITY, IT IS THE RESPONSIBILITY OF THE SITE'S SITE DEVELOPER (OR OWNER) TO FILE A NOTICE OF INTENT (NOI) FORM WITH THE ENVIRONMENTAL PROTECTION AGENCY (EPA) IN ORDER TO GAIN COVERAGE UNDER THE NPDES GENERAL PERMIT FOR STORM WATER DISCHARGES FROM CONSTRUCTION ACTIVITIES. A PRE CONSTRUCTION MEETING IS TO BE HELD WITH ALL DEPARTMENT HEADS PRIOR TO THE START OF CONSTRUCTION.
- 2. WETLAND BOUNDARIES ARE TO BE CLEARLY MARKED PRIOR TO THE START OF CONSTRUCTION.
- 3. CUT AND REMOVE TREES IN CONSTRUCTION AREA AS REQUIRED OR DIRECTED.
- INSTALL SILT FENCING, HAY BALES AND CONSTRUCTION ENTRANCES PRIOR TO THE START OF CONSTRUCTION. THESE ARE TO BE MAINTAINED UNTIL THE FINAL PAVEMENT SURFACING AND LANDSCAPING
- 5. CLEAR, CUT, GRUB AND DISPOSE OF DEBRIS IN APPROVED FACILITIES. THIS INCLUDES ANY REQUIRED DEMOLITION OF EXISTING STRUCTURES, UTILITIES, ETC.
- 6. CONSTRUCT AND/OR INSTALL TEMPORARY OR PERMANENT SEDIMENT AND/OR DETENTION BASIN(S) AS REQUIRED. THESE FACILITIES SHALL BE INSTALLED AND STABILIZED PRIOR TO DIRECTING RUN-OFF TO THEM.
- 7. STRIP LOAM AND PAVEMENT, OR RECLAIM EXISTING PAVEMENT WITHIN LIMITS OF WORK PER THE RECOMMENDATIONS OF THE PROJECT ENGINEER AND STOCKPILE EXCESS MATERIAL. STABILIZE STOCKPILE AS
- 8. PERFORM PRELIMINARY SITE GRADING IN ACCORDANCE WITH THE PLANS, INCLUDING THE CONSTRUCTION OF ANY RETAINING WALLS AND SOUND WALLS.
- INSTALL THE SEWER AND DRAINAGE SYSTEMS FIRST, THEN ANY OTHER UTILITIES IN ACCORDANCE WITH THE PLAN AND DETAILS. ANY CONFLICTS BETWEEN UTILITIES ARE TO BE RESOLVED WITH THE INVOLVEMENT AND
- 10. INSTALL INLET PROTECTION AT ALL CATCH BASINS AS THEY ARE CONSTRUCTED IN ACCORDANCE WITH
- ALL SWALES AND DRAINAGE STRUCTURES ARE TO BE CONSTRUCTED AND STABILIZED PRIOR TO HAVING
- 12. DAILY, OR AS REQUIRED, CONSTRUCT TEMPORARY BERMS, DRAINAGE DITCHES, CHECK DAMS, SEDIMENT TRAPS, ETC., TO PREVENT EROSION ON THE SITE AND PREVENT ANY SILTATION OF ABUTTING WATERS
- 13. PERFORM FINAL FINE GRADING, INCLUDING PLACEMENT OF 'SELECT' SUBGRADE MATERIALS.
- 14. PAVE ALL ROADWAYS WITH INITIAL 'BASE COURSE'.
- 15. PERFORM ALL REMAINING SITE CONSTRUCTION (i.e. BUILDING, CURBING, UTILITY CONNECTIONS, ETC.).
- 16. LOAM AND SEED ALL DISTURBED AREAS AND INSTALL ANY REQUIRED SEDIMENT AND EROSION CONTROL FACILITIES (i.e. RIP RAP, EROSION CONTROL BLANKETS, ETC.).
- 17. FINISH PAVING ALL ROADWAYS AND PARKING AREAS WITH 'FINISH' COURSE.
- 18. ALL ROADWAYS AND PARKING LOTS SHALL BE STABILIZED WITHIN 72 HOURS OF ACHIEVING FINISHED GRADE.
- 19. ALL CUT AND FILL SLOPES SHALL BE SEEDED/LOAMED WITHIN 72 HOURS OF ACHIEVING FINISHED GRADE.
- 20. COMPLETE PERMANENT SEEDING AND LANDSCAPING.
- REMOVE TEMPORARY EROSION CONTROL MEASURES AFTER SEEDING AREAS HAVE BEEN 75%-85% ESTABLISHED AND SITE IMPROVEMENTS ARE COMPLETE. SMOOTH AND RE-VEGETATE ALL DISTURBED AREAS.
- 22. CLEAN SITE AND ALL DRAINAGE STRUCTURES, PIPES AND SUMPS OF ALL SILT AND DEBRIS.
- 23. INSTALL ALL PAINTED PAVEMENT MARKINGS AND SIGNAGE PER THE PLANS AND DETAILS.
- 24. ALL EROSION CONTROLS SHALL BE INSPECTED WEEKLY AND AFTER EVERY HALF-INCH OF RAINFALL.
- 25. UPON COMPLETION OF CONSTRUCTION, IT IS THE RESPONSIBILITY OF THE CONTRACTOR TO NOTIFY ANY RELEVANT PERMITTING AGENCIES THAT THE CONSTRUCTION HAS BEEN FINISHED IN A SATISFACTORY MANNER.

Designed and Produced in NH

85 Portsmouth Ave. PO Box 219 Stratham, NH 03885

LAZ

LAZ

DJM

BY

Civil Engineering Services 603-772-4746 FAX: 603-772-0227 E-MAIL: JBE@JONESANDBEACH.COM

EROSION AND SEDIMENT CONTROL DETAILS

Project:


3400 LAFAYETTE ROAD PORTSMOUTH, NH


RICCI CONSTRUCTION CO., INC. Owner of Record 225 BANFIELD ROAD, PORTSMOUTH, NH 03801 BK 1930 PG 0229


SHEET 24 OF 25 JBE PROJECT NO. 20737

DRAWING No

Design: JAC Draft: LAZ Checked: JAC | Scale: AS NOTED | Project No.: 20737 Drawing Name: 20737-PLAN.dwg THIS PLAN SHALL NOT BE MODIFIED WITHOUT WRITTEN PERMISSION FROM JONES & BEACH ENGINEERS, INC. (JBE). ANY ALTERATIONS, AUTHORIZED OR OTHERWISE, SHALL BE AT THE USER'S SOLE RISK AND WITHOUT LIABILITY TO JBE.

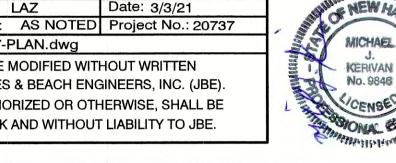

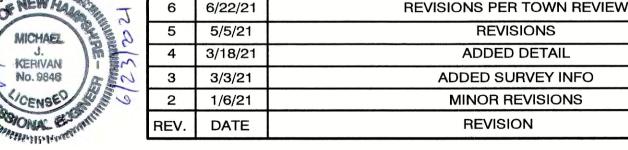

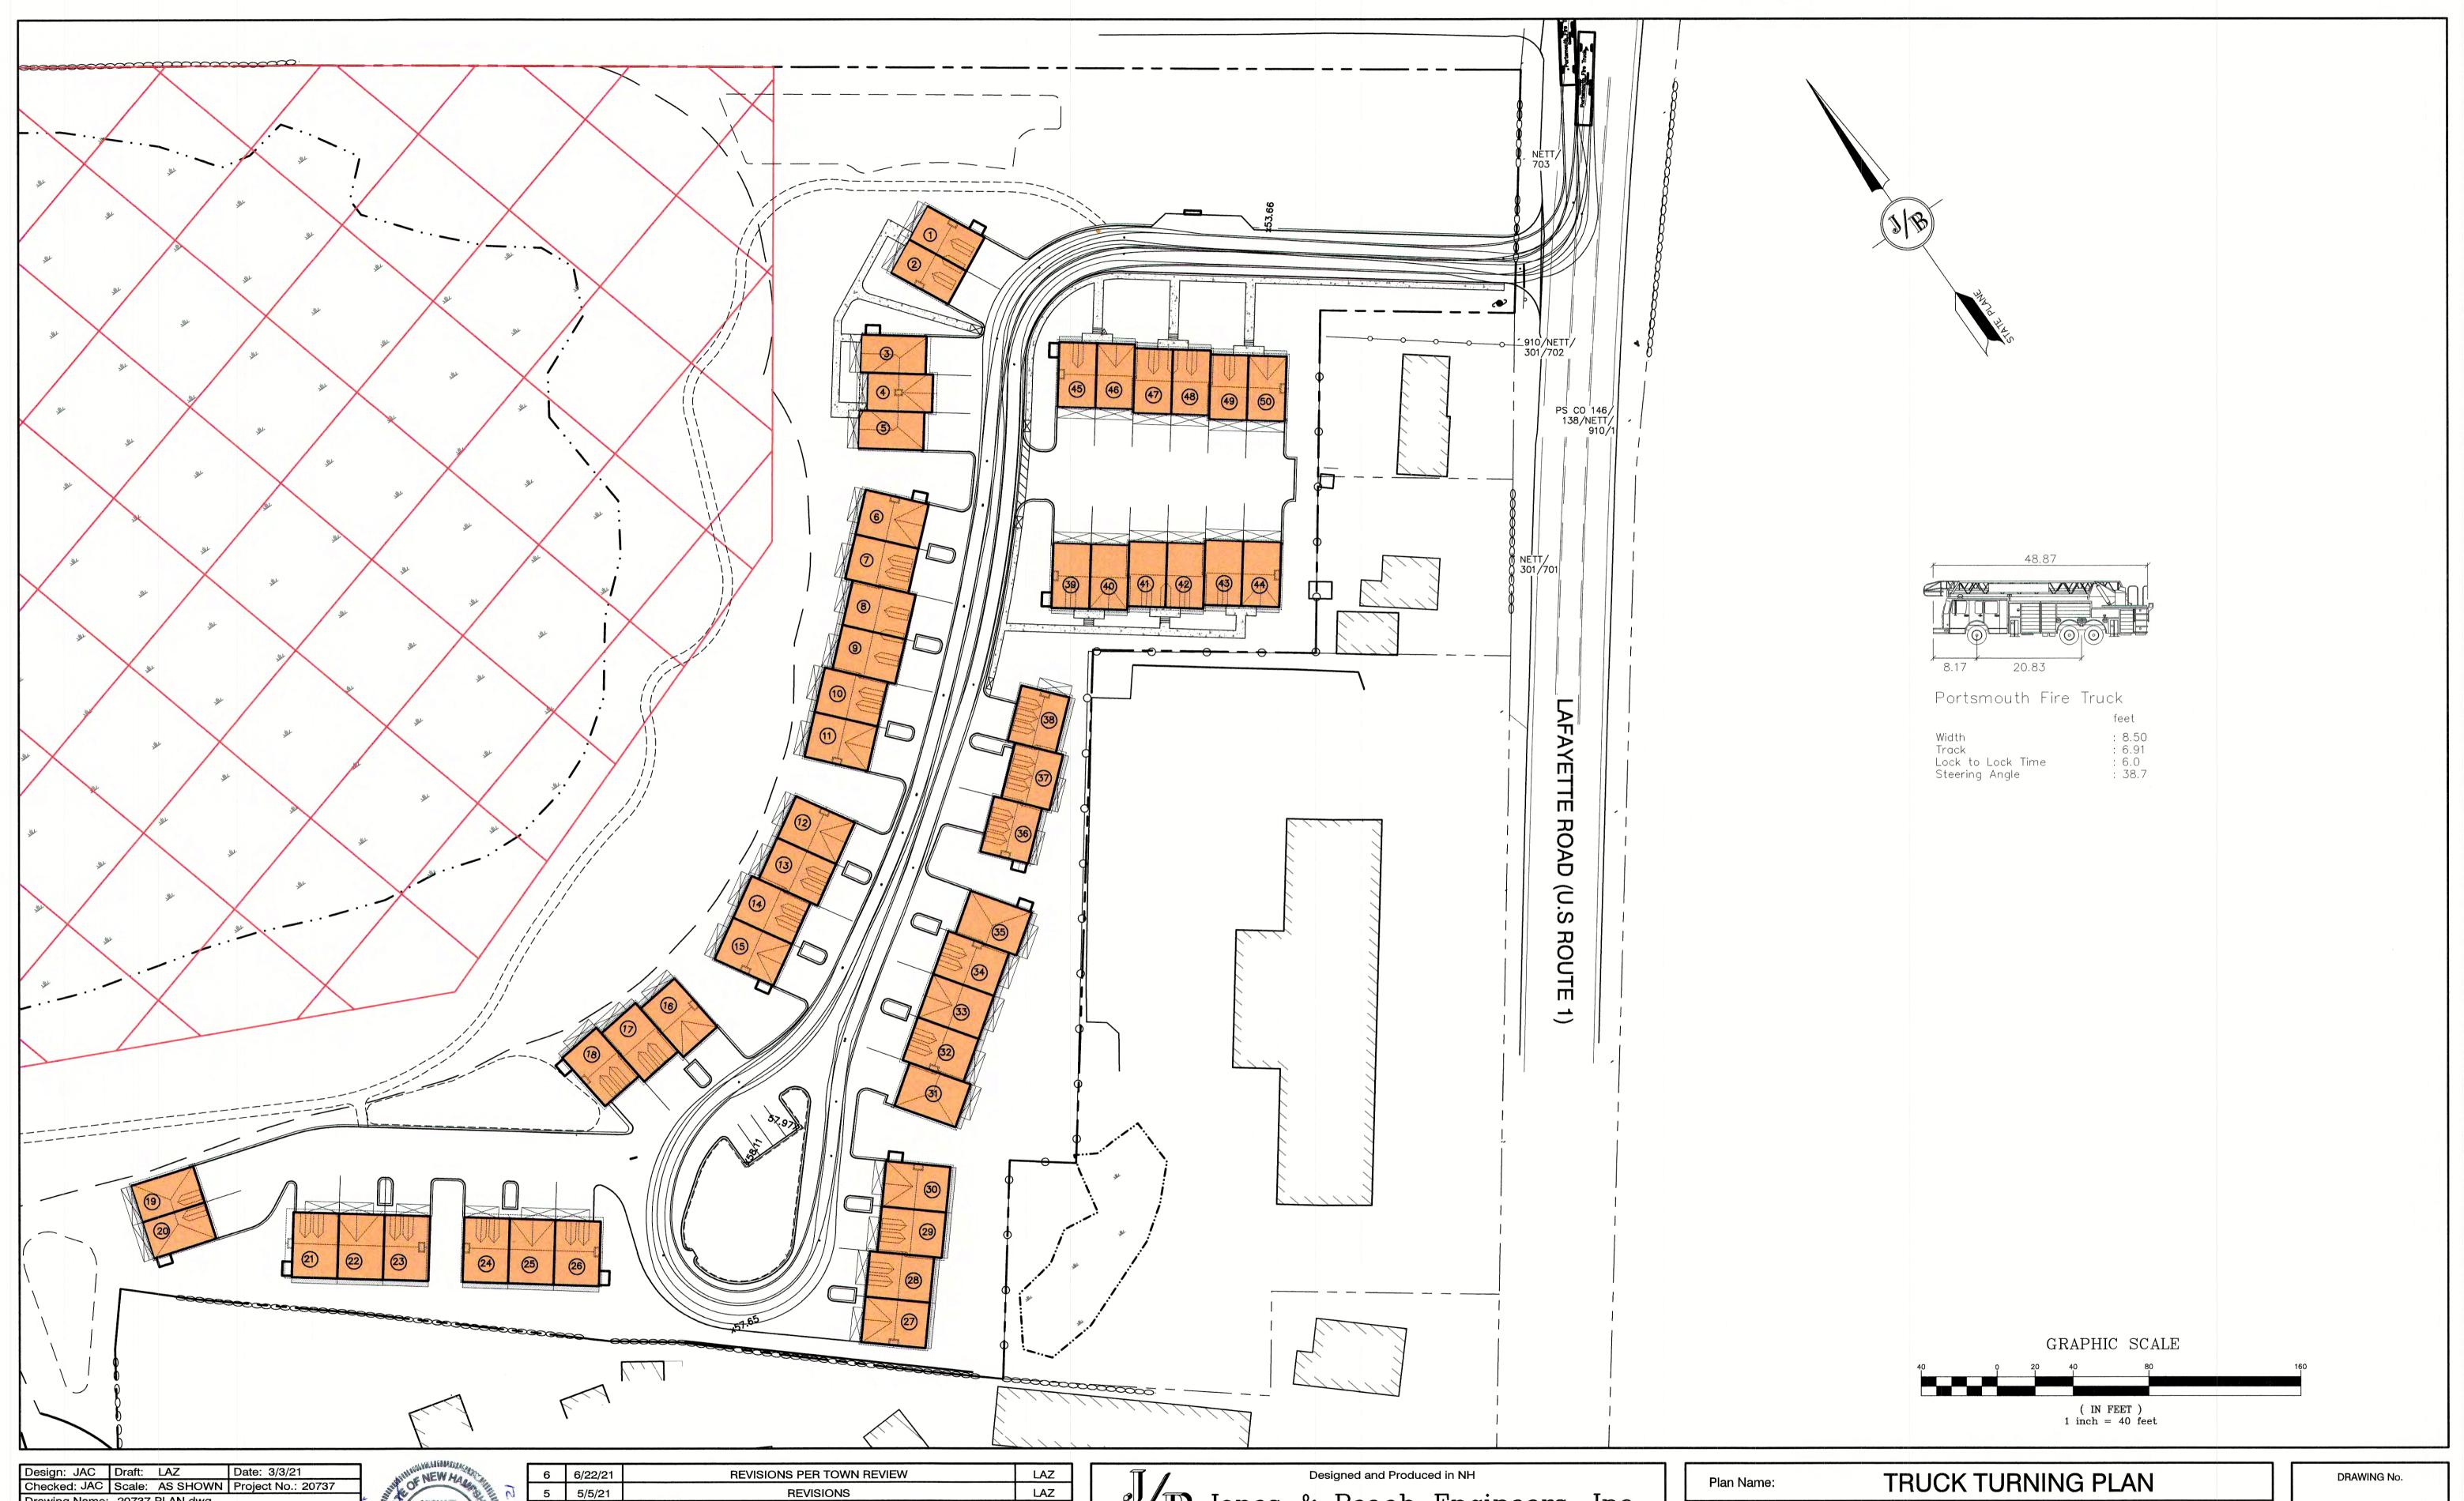

Drawing Name: 20737-PLAN.dwg

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6/23/2021	6	6/22/21	REVISIONS PER TOWN REVIEW	LAZ
	5	5/5/21	REVISIONS	LAZ
	4	3/18/21	ADDED DETAIL	LAZ
	3	3/3/21	ADDED SURVEY INFO	LAZ
	2	1/6/21	MINOR REVISIONS	DJM
	REV.	DATE	REVISION	BY

Designed and Produced in NH

Bords & Beach Engineers, Inc.

B5 Portsmouth Ave. Civil Engineering Services


PO Box 219
Stratham, NH 03885

Designed and Produced in NH

603-772-4746
FAX: 603-772-0227
E-MAIL: JBE@JONESANDBEACH.COM

Plan Name:	TRUCK TURNING PLAN
Project:	3400 LAFAYETTE ROAD PORTSMOUTH, NH
Owner of Record:	RICCI CONSTRUCTION CO., INC. 225 BANFIELD ROAD, PORTSMOUTH, NH 03801 BK 1930 PG 0229

SHEET 25 OF 25 JBE PROJECT NO. 20737

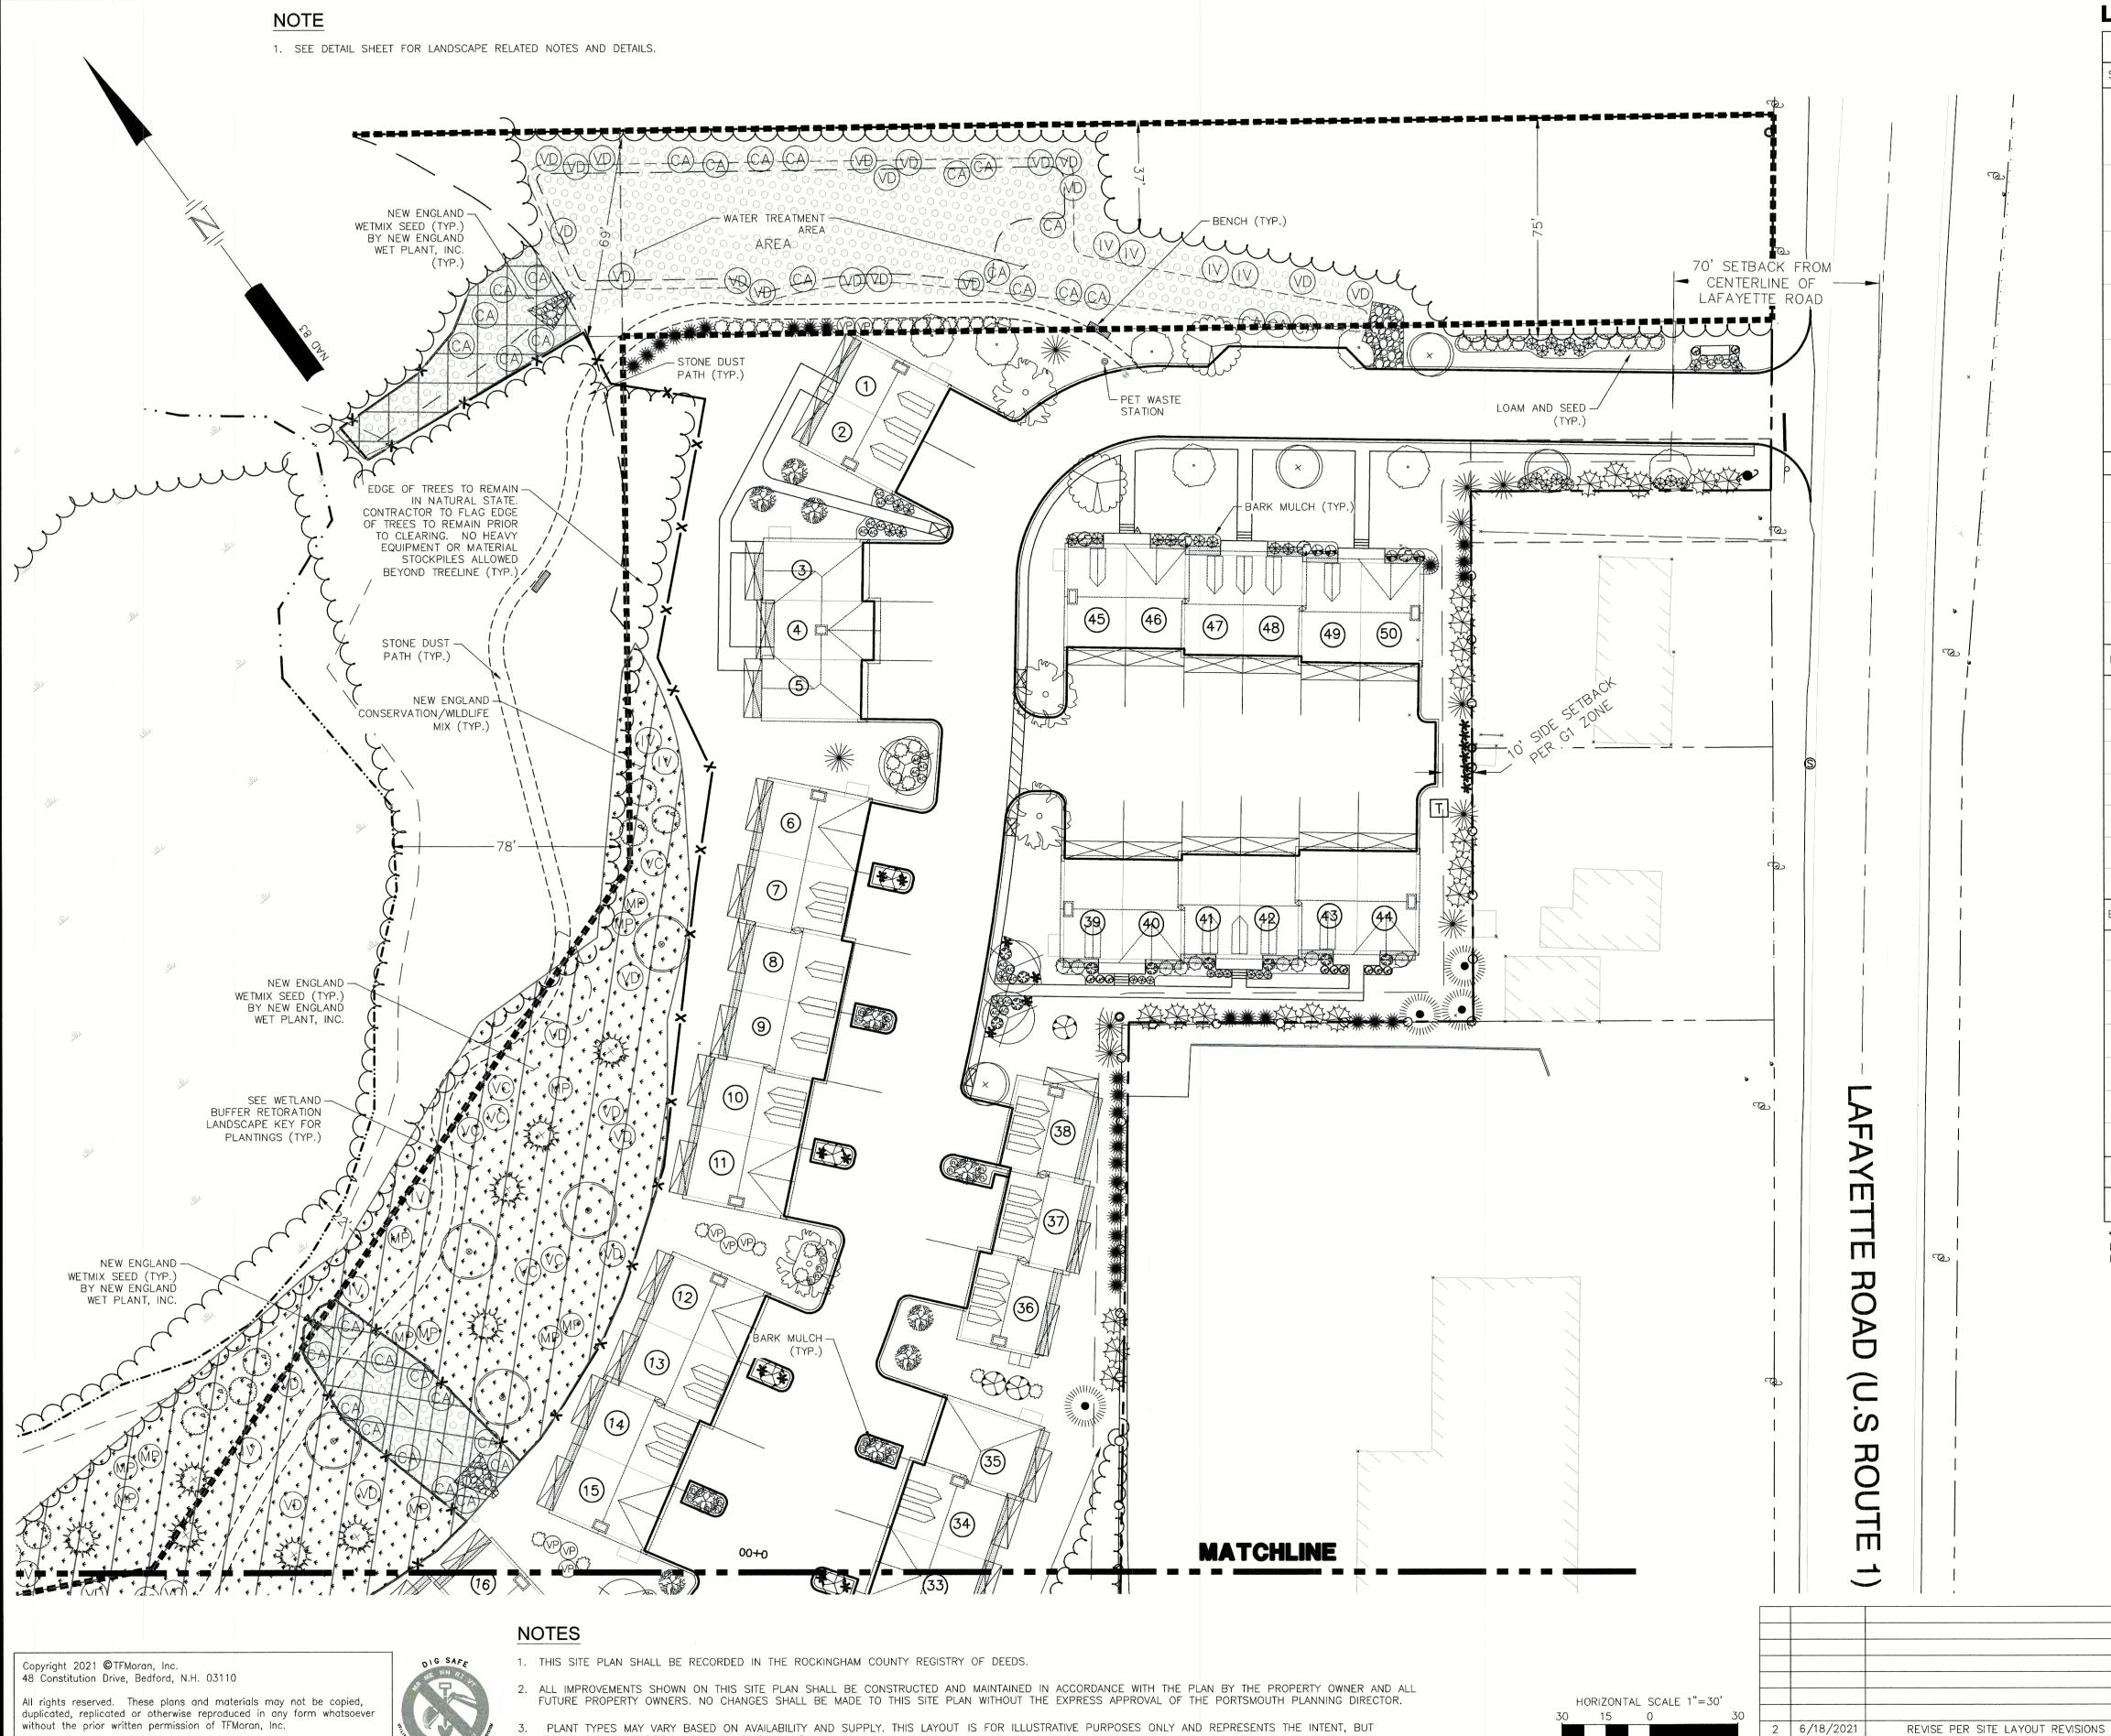

LANDSCAPE LEGEND

LANDS		ELEGEND					
SYMBOL	QTY	BOTANICAL NAME COMMON NAME	5	SIZE	REMARKS	GROWTH HABIT	
SHADE TREES		A service of the serv					
	9	ACER RUBRUM 'REDPOINTE' **REDPOINTE RED MAPLE	,	" TO 3" CAL.	B&B	PYRAMIDAL	
	5	ACER SACCHARUM 'COMMEMORATION' **COMMEMORATION SUGAR MAPLE		3 1/2" CAL.	В&В	ROUNDED	
	10	MAACKIA AMURENSIS AMUR MAACKIA	,	." TO 3" AL.	B&B	ROUNDED	
+	5	NYSSA SYLVATICA *BLACK GUM		2 TO 3" CAL.	B&B	PYRAMIDAL	
	X	QUERCUS P. 'GREEN PILLAR' **GREEN PILLAR GREEN OAK		2" TO 3" CAL.	В&В	COLUMNAR	
	6	ULMUS AMERICANA 'VALLEY FORGE' **VALLEY FORGE AMERICAN ELM		2" TO 3" CAL.	B&B	SPREADING-VASE	
EVERGREEN TRE	ES						
	17	ABIES BALSAMAE *BALSAM FIR	6'	TO 7'	B&B	PYRAMIDAL	
	24	JUNIPERUS VIRGINIANA *EASTERN RED CEDAR	6'	то 7'	B&B	UPRIGHT-PYRAMIC	
*	21	PICEA GLAUCA *WHITE SPRUCE	7'	то в'	В&В	PYRAMIDAL	
A Marie	3	PINUS STROBUS *WHITE PINE	6'	то 7'	В&В	PYRAMIDAL	
DECIDUOUS SHRU	JB						
\bigcirc	13	AMELANCHEIR ALNIFOLIA 'REGENT' *REGENT SERVICEBERRY	5	GAL.	CONT.	ROUNDED	
8	4	CLETHRA ALNIFOLIA 'COMPACTA' **COMPACT SUMMERSWEET	7	GAL.	CONT.	ROUNDED	
€3	17	CORNUS SERICEA 'ARCTIC FIRE' **ARCTIC FIRE RED-OSIER DOGWOOD	7	GAL.	CONT.	ROUNDED	
®	25	FORSYTHIA 'GOLD TIDE' GOLD TIDE FORSYTHIA	3	GAL.	CONT.	LOW-SPREADING	
₩	23	HYDRANGEA ARBORESCENS 'INCREDIBALL' INCREDIBALL SMOOTH HYDRANGEA	5	GAL.	CONT.	ROUNDED	
⊗	9	PHYSOCARPUS O. 'BURGUNDY CANDY' **BURGUNDY CANDY NINEBARK	2	GAL.	CONT.	ROUNDED	
(VP)	6	VIBURNUM P.T. 'SUMMER SNOWFLAKE' SUMMER SNOWFLAKE VIBURNUM	3'	TO 4'	В&В	ROUNDED	
EVERGREEN SHRU	JB						
89	45	AZALEA 'GIRARD'S CRIMSON' GIRARD'S CRIMSON AZALEA	3	GAL.	CONT.	ROUNDED	
9	4	RHODODENDRON 'ROSEUM PINK' **ROSEUM PINK RHODODENDRON	7	GAL.	CONT.	ROUNDED	
\otimes	9	ILEX GLABRA 'COMPACTA' **COMPACT INKBERRY	3	GAL.	CONT.	ROUNDED	
\bigcirc	34	JUNIPERUS CHINENSIS 'SEAGREEN' SEAGREEN JUNIPER	3	GAL.	CONT.	ARCHING	
*	8	JUNIPERUS H. 'BAR HARBOR' *BAR HARBOR JUNIPER	3	GAL.	CONT.	LOW-SPREADING	
Ө	11	PINUS M. 'MOPS' MOPS MUGO PINE	.3	GAL.	CONT.	ROUNDED	
**	54	THUJA O. NIGRA *DARK AMERICAN ARBORVITAE	5'	TO 6'	В&В	UPRIGHT-PYRAMIE	
GRASSES							
*	66	PANICUM VIRGATUM 'CLOUD NINE' **CLOUD NINE SWITCH GRASS	3	GAL.	CONT.	UPRIGHT	

*NATIVE, ** IMPROVED NATIVE

MSK JCC MSK JCC DR CK

REVISE PER GRADING & UTILITY LAYOUT

DESCRIPTION

1 5/13/2021

REV DATE

NOTE: ALL PLANTS CONTAINED IN LEGEND HAVE BEEN LOCATED ON SITE TO REFLECT A PROPER GROWING ENVIRONMENT AND MEET THE HARDINESS ZONE OF 6a AS DETERMINED BY THE U.S. DEPT. OF AGRICULTURE.

SITE DEVELOPMENT PLANS

TAX MAP 297 LOT 11

LANDSCAPE PLAN 3400 LAFAYETTE ROAD PORTSMOUTH, NH

OWNED BY

RICCI CONSTRUCTION CO, INC.

PREPARED FOR

GREEN & COMPANY REAL ESTATE

1"=60' (11"X17")

SCALE: 1"=30' (22"X34")

LS-1

MARCH 8, 2021

Structural Engineers Traffic Engineers Land Surveyors Landscape Architects

48 Constitution Drive Phone (603) 472-4488 Fax (603) 472-9747 www.tfmoran.com


45407.110 DR ARJ FB - CK MSK CADFILE 45407-110 LANDSCAPE

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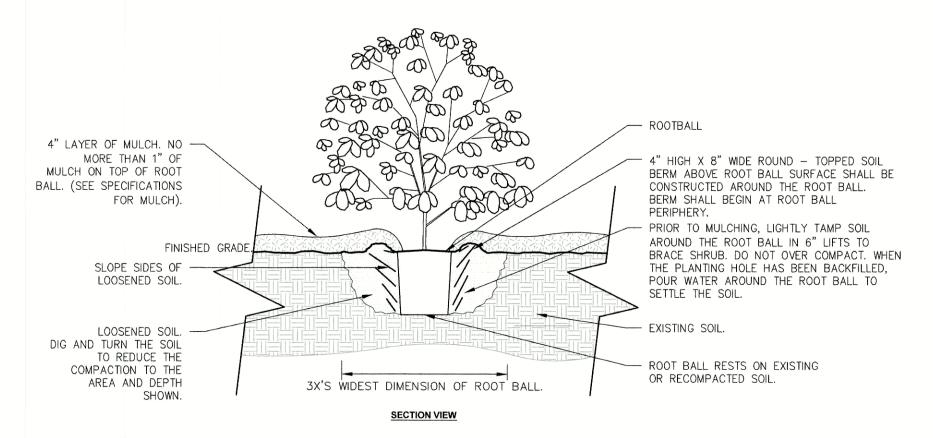


PLANT TYPES MAY VARY BASED ON AVAILABILITY AND SUPPLY. THIS LAYOUT IS FOR ILLUSTRATIVE PURPOSES ONLY AND REPRESENTS THE INTENT, BUT PLANT SIZES, SPECIES, AND AMOUNTS MAY VARY.




TREE WITH BERM

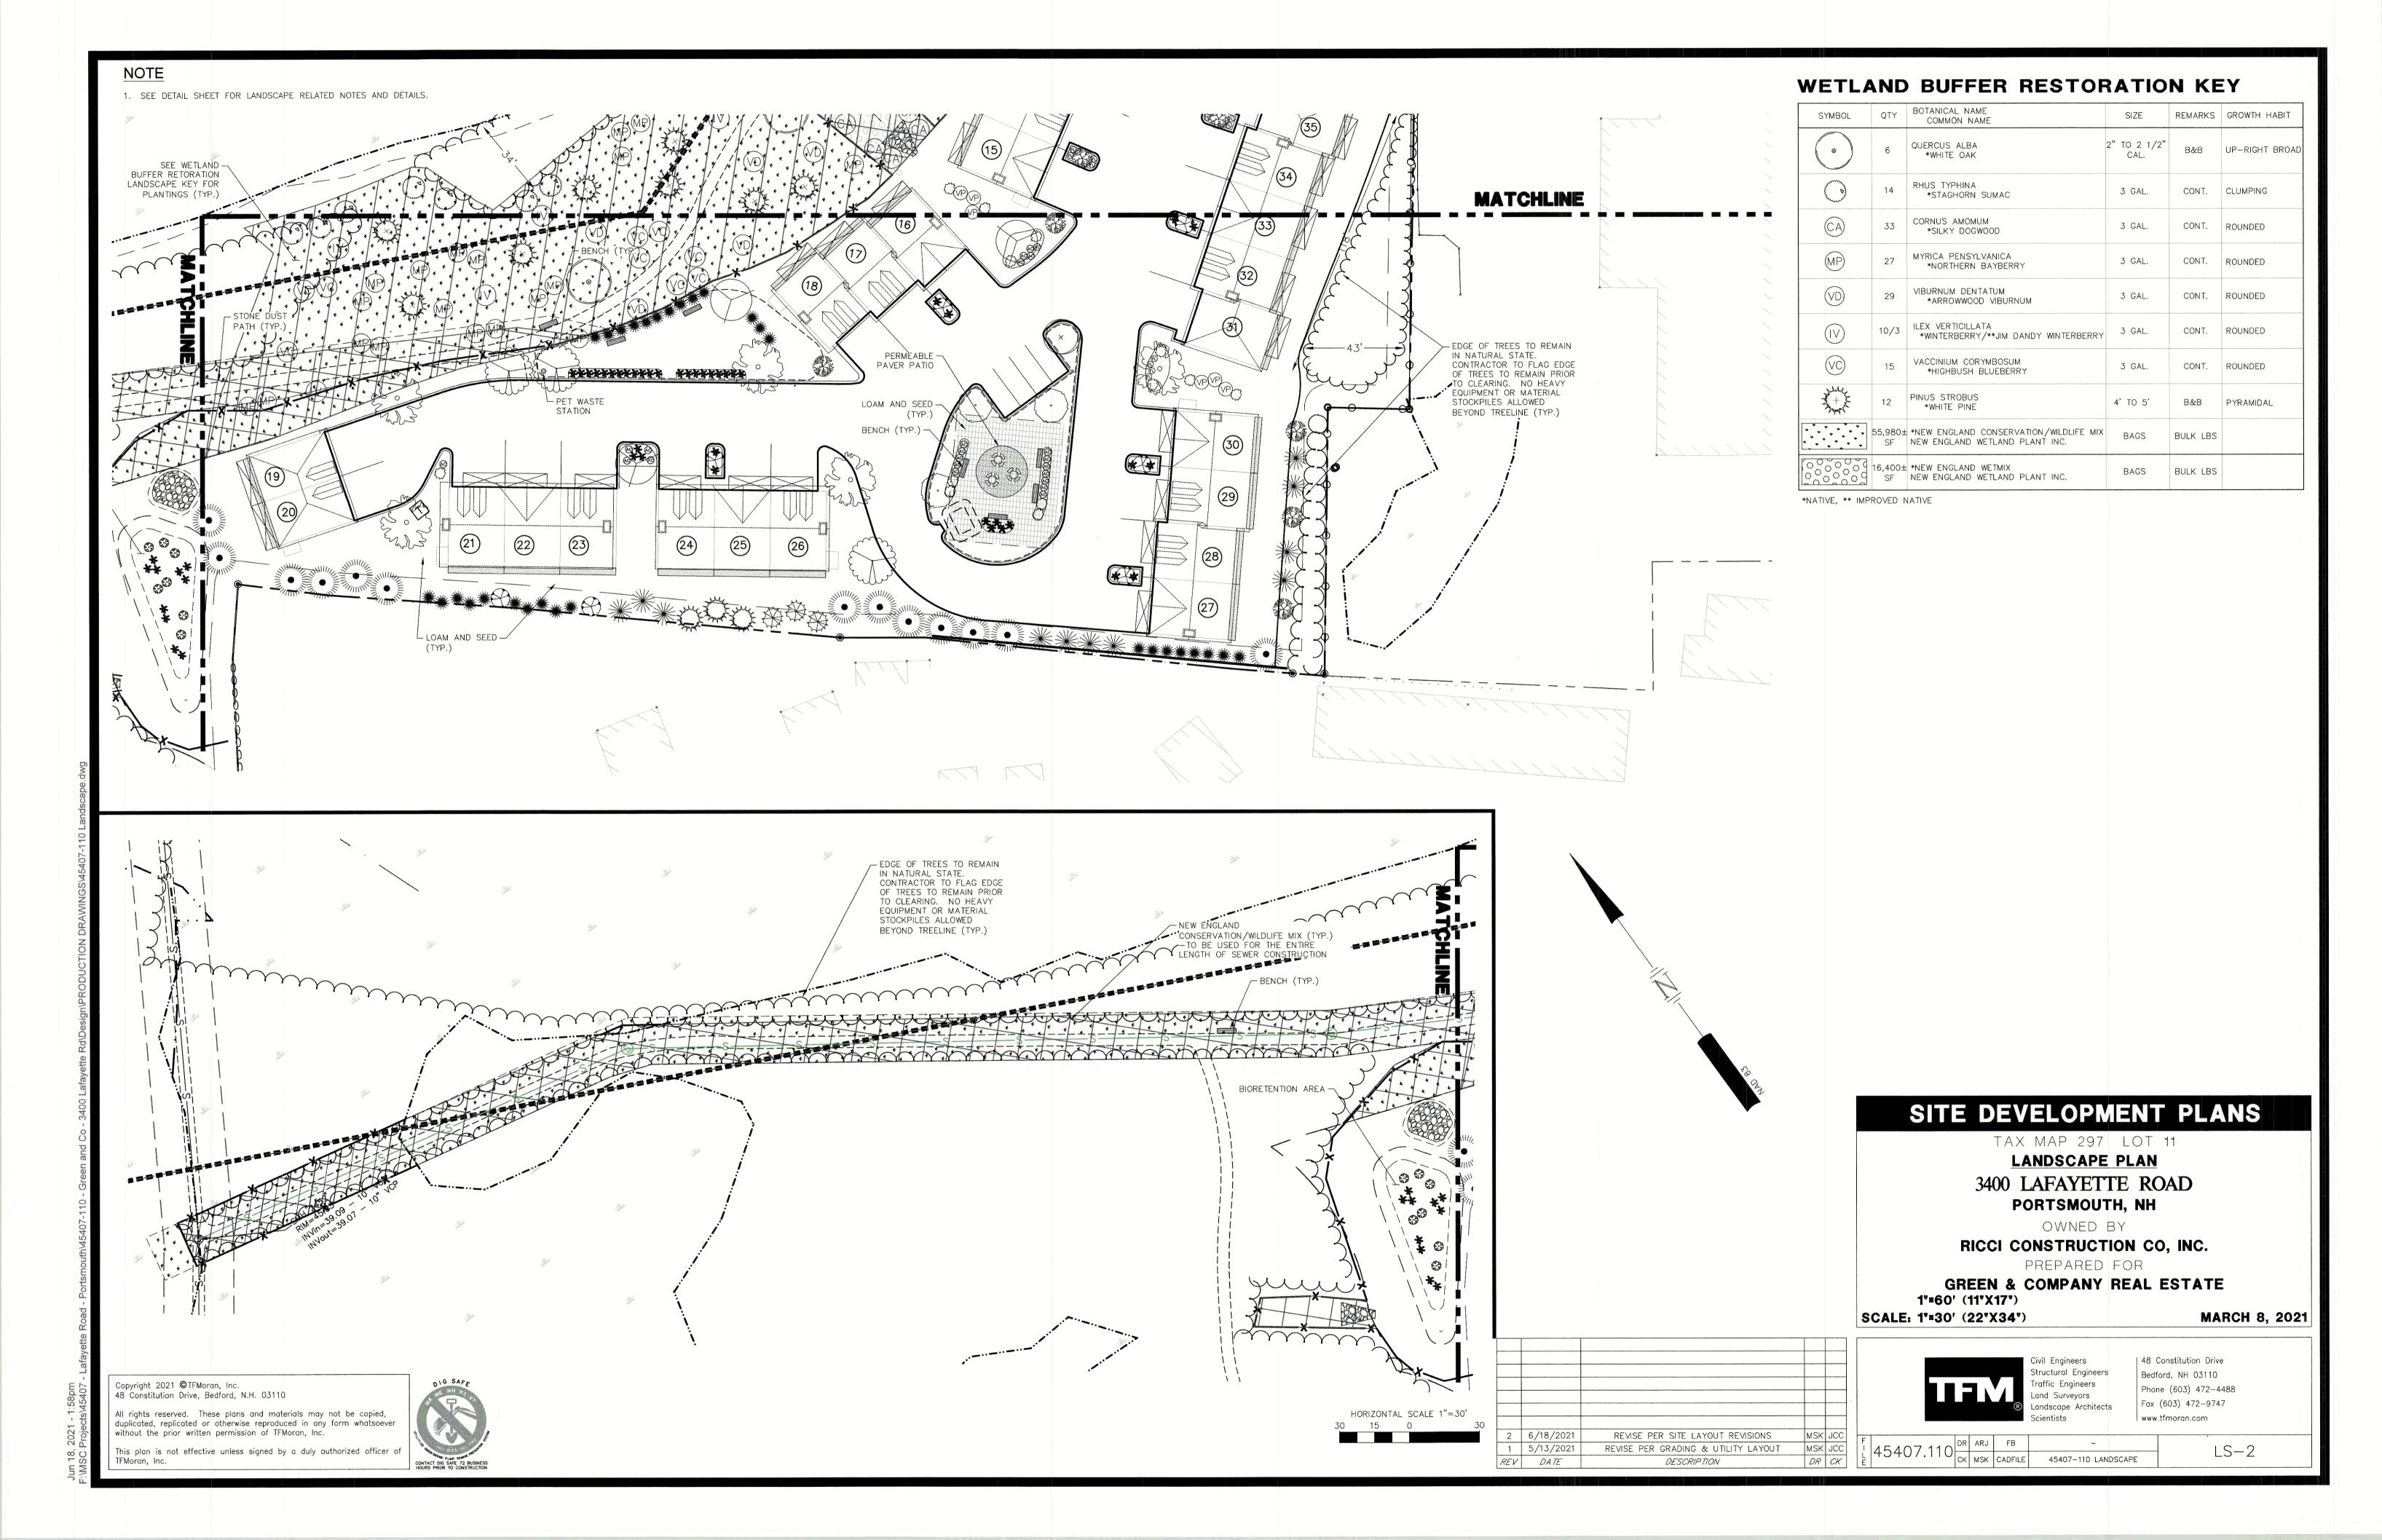NOT TO SCALE



SHRUB PLANTING

NOT TO SCALE

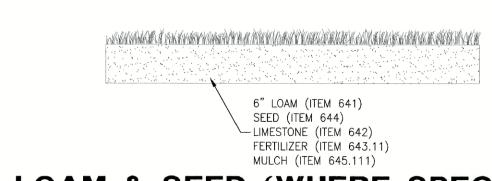

LOAM & SEED (WHERE SPECIFIED)

NOT TO SCALE

5'-0" 2" STONE DUST FINISHED GRADE 1% / 1% -5 OZ. WEED FABRIC

STONE DUST PATH

COMPACTED SUBGRADE-

NOT TO SCALE

PORTSMOUTH NOTES

- 1. THE PROPERTY OWNER AND ALL FUTURE PROPERTY OWNER'S WILL BE RESPONSIBLE FOR THE MAINTENANCE OF ALL REQUIRED SCREENING AND LANDSCAPE MATERIALS INDICATED ON THESE PLAN(S).
- 2. ALL REQUIRED PLANT MATERIAL WILL BE TENDED TO AND KEPT FREE OF REFUSE AND DEBRIS.
- 3. ALL REQUIRED FENCES AND WALLS WILL BE MAINTAINED IN GOOD REPAIR.
- 4. THE PROPERTY OWNER WILL BE RESPONSIBLE TO REMOVE AND REPLACE DEAD OR DISEASED PLANT MATERIALS IMMEDIATELY WITH THE SAME TYPE, SIZE AND QUANTITY OF PLANT MATERIALS AS ORIGINALLY INSTALLED. UNLESS ALTERNATIVE PLANTINGS ARE REQUESTED, JUSTIFIED AND APPROVED BY THE PLANNING BOARD OR PLANNING DIRECTOR.
- 5. ALL IMPROVEMENTS SHOWN ON THIS PLAN WILL BE CONSTRUCTED AND MAINTAINED IN ACCORDANCE WITH THIS PLAN BY THE PROPERTY OWNER AND ALL FUTURE PROPERTY OWNERS. NO CHANGES WILL BE MADE TO THIS PLAN WITHOUT THE WRITTEN APPROVAL OF THE PORTSMOUTH PLANNING BOARD OR PLANNING DIRECTOR.
- 6. THE LANDSCAPE PLAN WILL BE RECORDED IN THE ROCKINGHAM COUNTY REGISTRY OF DEEDS.

SEEDING NOTES

- 1. SLOPES UP TO AND INCLUDING 3:1 GRADE, SEED WILL BE NEW ENGLAND EROSION CONTROL & RESTORATION MIX PER NEW ENGLAND WETLANDS PLANTS INC., AMHERST, MA.
- 2. SLOPES STEEPER THAN 3:1 GRADE, SEED WILL BE NEW ENGLAND EROSION CONTROL & RESTORATION MIX PER NEW ENGLAND WETLANDS PLANTS INC., AMHERST, MA. SEE CIVIL FOR ADDITIONAL EROSION CONTROL MEASURES.
- 3. GENERAL SEED WILL BE NHDOT SPECIFICATION SECTION 644, TABLE 644-1-PARK SEED TYPE 15, INCLUDING NOTES TO TABLE

1 5/13/2021 NO REVISIONS THIS SHEET MSK JCC DR CK REV DATE **DESCRIPTION**

Structural Engineers Traffic Engineers Land Surveyors andscape Architects Scientists

| 48 Constitution Drive Bedford, NH 03110 Phone (603) 472-4488 Fax (603) 472-9747 www.tfmoran.com

45407.110 DR ARJ FB CK MSK CADFILE 45407-110 LANDSCAPE

LS-3

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LANDSCAPE NOTES

- CONTRACTOR WILL LOCATE, VERIFY AND MARK ALL EXISTING AND NEWLY INSTALLED UNDERGROUND UTILITIES PRIOR TO ANY LAWNWORK OR PLANTING. ANY CONFLICTS WHICH MIGHT OCCUR BETWEEN PLANTING AND UTILITIES WILL IMMEDIATELY BE REPORTED TO THE LANDSCAPE ARCHITECT OR OWNERS' REPRESENTATIVE, SO THAT ALTERNATE PLANTING LOCATIONS CAN BE
- 2. CONTRACTOR WILL FURNISH AND PLANT ALL PLANTS IN QUANTITIES AS SHOWN ON THIS PLAN. IN CASES OF DISCREPANCY BETWEEN PLAN AND LIST CLARIFY WITH LANDSCAPE ARCHITECT PRIOR TO PLACING PURCHASE ORDER AND AGAIN PRIOR TO
- 3. SEE PLANTING DETAILS AND IF INCLUDED, SPECIFICATIONS FOR ADDITIONAL INFORMATION.
- 4. NO SUBSTITUTION OF PLANT MATERIALS WILL BE ALLOWED WITHOUT PRIOR WRITTEN APPROVAL OF THE LANDSCAPE ARCHITECT OR OWNER'S REPRESENTATIVE.
- 5. IT IS THE CONTRACTOR'S RESPONSIBILITY TO MAKE THE APPROPRIATE ARRANGEMENTS TO PROVIDE ALL PLANTS AND MATERIALS TO ACCOMMODATE PLANTING WITHIN THE TIME ALLOWED BY THE CONSTRUCTION SCHEDULE.
- 6. PLANTING SHALL BE COMPLETED FROM APRIL 15TH THROUGH OCTOBER 15TH UNLESS OTHERWISE NOTED IN SPECIFICATIONS. THERE WILL BE NO PLANTING DURING JULY AND AUGUST UNLESS SPECIAL PROVISIONS ARE MADE FOR DROUGHT BY PROVIDING ADDITIONAL WATERING.
- 7. ALL PLANTS WILL BE NURSERY GROWN.
- 8. PLANTS WILL BE IN ACCORDANCE, AT A MINIMUM, WITH CURRENT EDITION OF "AMERICAN STANDARDS FOR NURSERY STOCK" AS PUBLISHED BY THE AMERICAN HORTICULTURE INDUSTRY ASSOCIATION.
- 9. TREES WILL BE PRUNED IN ACCORDANCE WITH THE LATEST EDITION OF ANSI A300 PART 1, "TREE, SHRUB AND OTHER WOODY PLANT MAINTENANCE STANDARD PRACTICES".
- 10. PLANTS MATERIAL IS SUBJECT TO APPROVAL / REJECTION BY THE LANDSCAPE ARCHITECT AT THE SITE AND AT THE NURSERY.
- 11. ALL PLANTS WILL BE MOVED WITH ROOT SYSTEMS AS SOLID UNITS AND WITH BALLS OF EARTH FIRMLY WRAPPED WITH BURLAP. NO PLANT WILL BE ACCEPTED WHEN BALL OF EARTH SURROUNDING ITS ROOTS HAS BEEN BADLY CRACKED OR BROKEN BEFORE PLANTING. ALL PLANTS THAT CANNOT BE PLANTED AT ONCE WILL BE HEELED-IN BY SETTING IN THE GROUND AND COVERING THE BALLS WITH SOIL AND THEN WATERING. DURING TRANSPORT, ALL PLANT MATERIALS WILL BE WRAPPED WITH WIND PROOF
- 12. NEWLY PLANTED MATERIAL WILL BEAR THE SAME RELATIONSHIP TO FINISHED GRADE AS TO THE ORIGINAL GRADE OF THE PLANT PRIOR TO DIGGING.
- 13. MULCH FOR PLANTED AREAS (NOT INCLUDING RAIN GARDENS) WILL BE AGED SHREDDED PINE BARK, PARTIALLY DECOMPOSED, DARK BROWN IN COLOR AND FREE OF WOOD CHIPS UNLESS OTHERWISE SHOWN.
- 14. PLANT MATERIAL WILL BE LOCATED OUTSIDE BUILDING DRIPLINES AND ROOF VALLEY POINTS OF CONCENTRATION TO PREVENT DAMAGE TO PLANTS. CLARIFY DISCREPANCIES WITH LANDSCAPE ARCHITECT PRIOR TO INSTALLATION.
- 15. ALL DISTURBED AREAS NOT TO BE PAVED OR OTHERWISE TREATED, WILL RECEIVE SIX (6) INCH LOAM AND SEED AT THE DIRECTION OF THE LANDSCAPE ARCHITECT OR OWNER'S REPRESENTATIVE.
- 16. ALL PLANT GROUPINGS WILL BE IN MULCH BEDS UNLESS OTHERWISE SPECIFIED OR NOTED ON PLANS. WHERE MULCHED PLANT BED ABUTS LAWN, PROVIDE TURF CUT EDGE.
- 17. ALL PLANT BEDS WILL INTERSECT WITH PAVEMENT AT 90 DEGREES UNLESS OTHERWISE NOTED ON PLANS.
- 18. ALL PLANT BED EDGES WILL BE SMOOTH AND CONSISTENT IN LAYOUT OF RADII AND TANGENTS. IRREGULAR, WAVY EDGES WILL

LANDSCAPE GUARANTEE AND MAINTENANCE NOTES

- 1. CONTRACTOR WILL BE RESPONSIBLE FOR ALL MEANS, METHODS AND TECHNIQUES OF WATERING.
- 2. CONTRACTOR WILL BEGIN WATERING IMMEDIATELY AFTER PLANTING. ALL PLANTS WILL BE THOROUGHLY WATERED TWICE DURING THE FIRST 24 HOUR PERIOD AFTER PLANTING. ALL PLANTS WILL BE WATERED WEEKLY, OR MORE OFTEN, IF NECESSARY DURING THE FIRST GROWING SEASON BUT NOT LESS THAN ONE YEAR FROM TIME OF INSTALLATION.
- 3. WATER ALL LAWNS AS REQUIRED. DO NOT LET NEWLY PLANTED LAWNS DRY OUT DURING THE FIRST FOUR WEEKS MINIMUM.
- 4. ALL NEW LAWNS WILL BE MAINTAINED AND MOWED A MINIMUM THREE (3) TIMES BEFORE REQUESTING REVIEW BY LANDSCAPE ARCHITECT OR OWNER'S REPRESENTATIVE FOR ACCEPTANCE. MAINTENANCE AND MOWING WILL CONTINUE UNTIL ACCEPTED BY LANDSCAPE ARCHITECT OR OWNERS' REPRESENTATIVE IS ISSUED IN WRITING.
- 5. THE CONTRACTOR WILL MAINTAIN AND GUARANTEE ALL PLANTINGS TO BE IN GOOD HEALTHY, FLOURISHING AND ACCEPTABLE CONDITION FOR A PERIOD OF ONE (1) YEAR BEGINNING AT THE DATE OF ACCEPTANCE BY THE LANDSCAPE ARCHITECT OR OWNER'S REPRESENTATIVE. ALL GRASSES, TREES AND SHRUBS THAT, IN THE OPINION OF THE LANDSCAPE ARCHITECT OR OWNER'S REPRESENTATIVE SHOWING LESS THAN 80% HEALTHY GROWTH AT THE END OF ONE (1) YEAR PERIOD WILL BE IMMEDIATELY REPLACED BY THE CONTRACTOR.
- 6. DECIDUOUS PLANT MATERIAL INSTALLED AFTER SEPTEMBER 30 AND BEFORE APRIL 15 WILL NOT BE REVIEWED THAT SEASON FOR ACCEPTANCE DUE TO STAGE OF LEAF PHYSIOLOGY. THIS PLANT MATERIAL WILL NOT BE REVIEWED UNTIL THE FOLLOWING GROWING SEASON. GUARANTEE PERIOD WILL BEGIN ONLY AFTER ACCEPTANCE BY LANDSCAPE ARCHITECT OR OWNERS'
- 7. EVERGREEN PLANT MATERIAL INSTALLED AFTER OCTOBER 30 AND BEFORE APRIL 15 WILL NOT BE REVIEWED THAT SEASON FOR ACCEPTANCE DUE TO END OF GROWTH SEASON. THIS PLANT MATERIAL WILL NOT BE REVIEWED UNTIL THE FOLLOWING GROWING SEASON. GUARANTEE PERIOD WILL BEGIN ONLY AFTER ACCEPTANCE BY LANDSCAPE ARCHITECT OR OWNERS' REPRESENTATIVE.

INVASIVE PLANT NOTES

1. EXISTING NON-NATIVE, INVASIVE PLANT SPECIES WILL BE IDENTIFIED. REMOVED, DESTROYED AND LEGALLY DISPOSED OF OFF-SITE IN ACCORDANCE WITH THE LATEST UNIVERSITY OF NEW HAMPSHIRE COOPERATIVE EXTENSION METHODS OF DISPOSING NON-NATIVE INVASIVE PLANTS. SEE "MANAGE AND CONTROL INVASIVES" AND PROPERLY DISPOSE OF INVASIVE PLANTS".

SITE DEVELOPMENT PLANS

TAX MAP 297 LOT 11

LANDSCAPE DETAIL SHEET 3400 LAFAYETTE ROAD PORTSMOUTH, NH

OWNED BY


RICCI CONSTRUCTION CO, INC. PREPARED FOR GREEN & COMPANY REAL ESTATE

SCALE: NOT TO SCALE

MARCH 8, 2021

PERMEABLE PAVER DETAIL

NOT TO SCALE

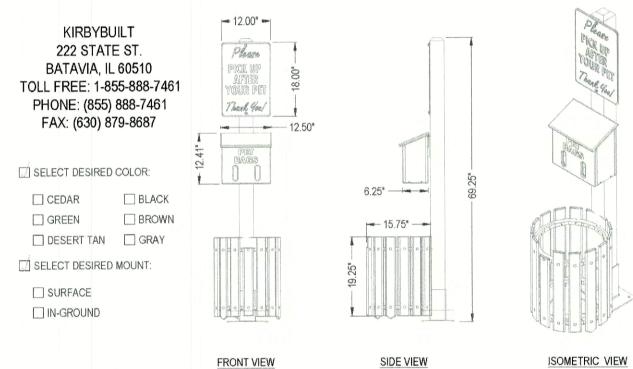

- 1. ALL MATERIAL RECYCLED HDPE. 2. ALL HARDWARE STAINLESS STEEL.
- SHIPPED PARTIALLY ASSEMBLED.
- 4. INSTALLATION TO BE COMPLETED IN ACCORDANCE WITH MANUFACTURER'S SPECIFICATIONS.
- DO NOT SCALE DRAWING.
- 7. ALL INFORMATION CONTAINED HEREIN WAS CURRENT AT THE TIME OF DEVELOPMENT BUT MUST BE REVIEWED AND APPROVED BY

REFERENCE NUMBER 1177-206.

STANDARD ROLL BAG PET WASTE STATIONS


APW1220/APW1215 - STANDARD ROLL BAG PET WASTE STATION AND SIGN (BAG DISPENSER, 5 GALLON RECEPTACLE, POST, SIGN) -SURFACE MOUNT OR IN-GROUND OR APPROVED EQUAL

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LEGEND A-FRAME BENCHES ABC1020 - 6' LEGEND A-FRAME BENCH OR APPROVED EQUAL

REFERENCE NUMBER 1177-059.

SITE DEVELOPMENT PLANS

LANDSCAPE DETAIL SHEET 3400 LAFAYETTE ROAD

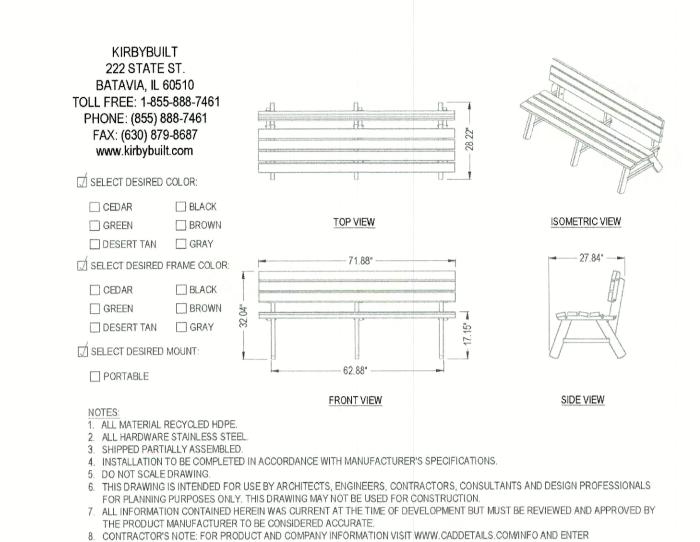OWNED BY

RICCI CONSTRUCTION CO, INC.

LS-4

					_		
						F	
2	6/18/2021	REVISE PER SITE LAYOUT REVISIONS	MSK	JCC		1	4
REV	DATE	DESCRIPTION	DR	CK		È	



| 48 Constitution Drive Civil Engineers Structural Engineers Bedford, NH 03110 Traffic Engineers Phone (603) 472-4488 Land Surveyors Fax (603) 472-9747 Landscape Architects www.tfmoran.com

15407.110 DR ARJ FB - CK MSK CADFILE 45407-110 LANDSCAPE

SIDE VIEW ISOMETRIC VIEW

6. THIS DRAWING IS INTENDED FOR USE BY ARCHITECTS, ENGINEERS, CONTRACTORS, CONSULTANTS AND DESIGN PROFESSIONALS FOR PLANNING PURPOSES ONLY. THIS DRAWING MAY NOT BE USED FOR CONSTRUCTION.

THE PRODUCT MANUFACTURER TO BE CONSIDERED ACCURATE. 8. CONTRACTOR'S NOTE: FOR PRODUCT AND COMPANY INFORMATION VISIT WWW.CADDETAILS.COM/INFO AND ENTER


TAX MAP 297 LOT 11

PORTSMOUTH, NH


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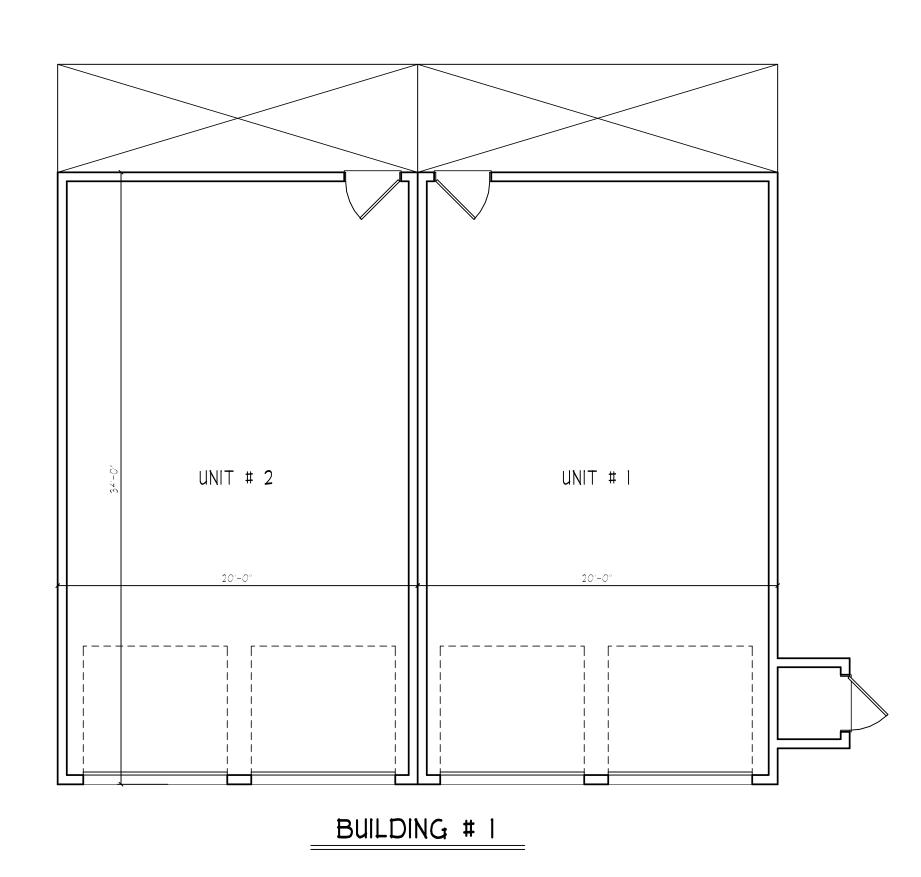
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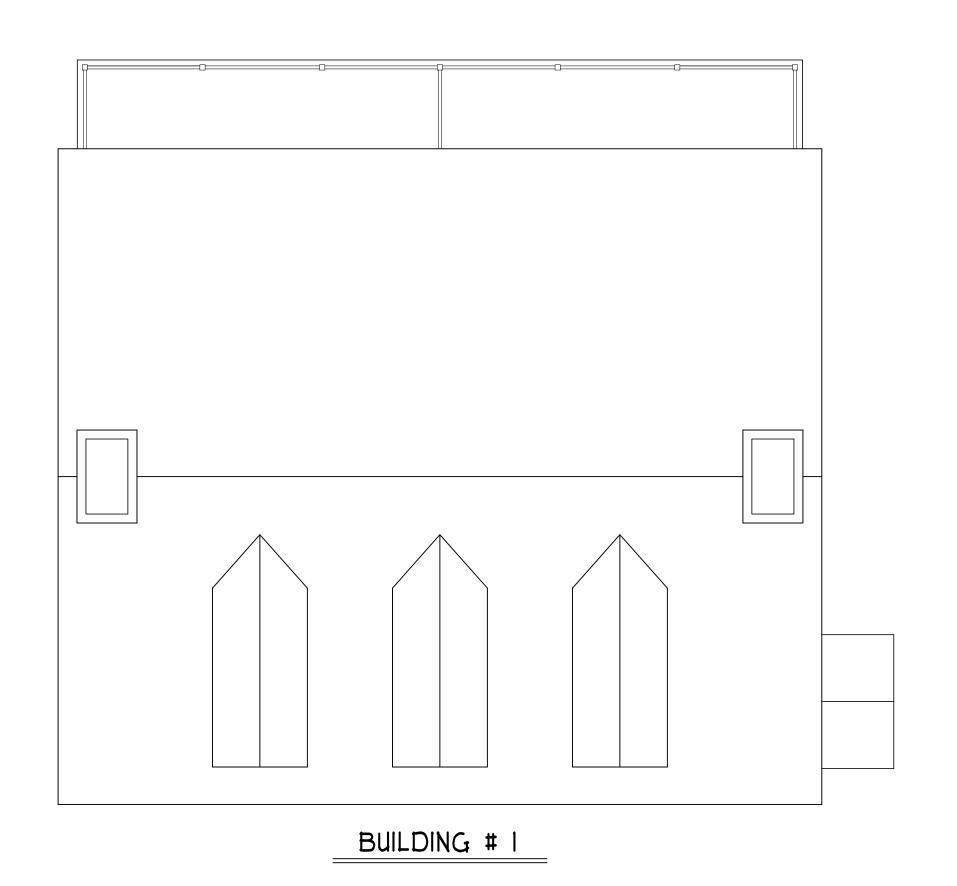
MARCH 8, 2021







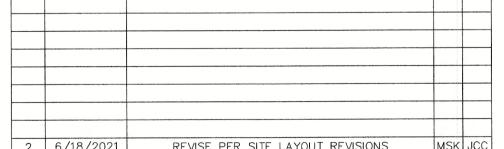



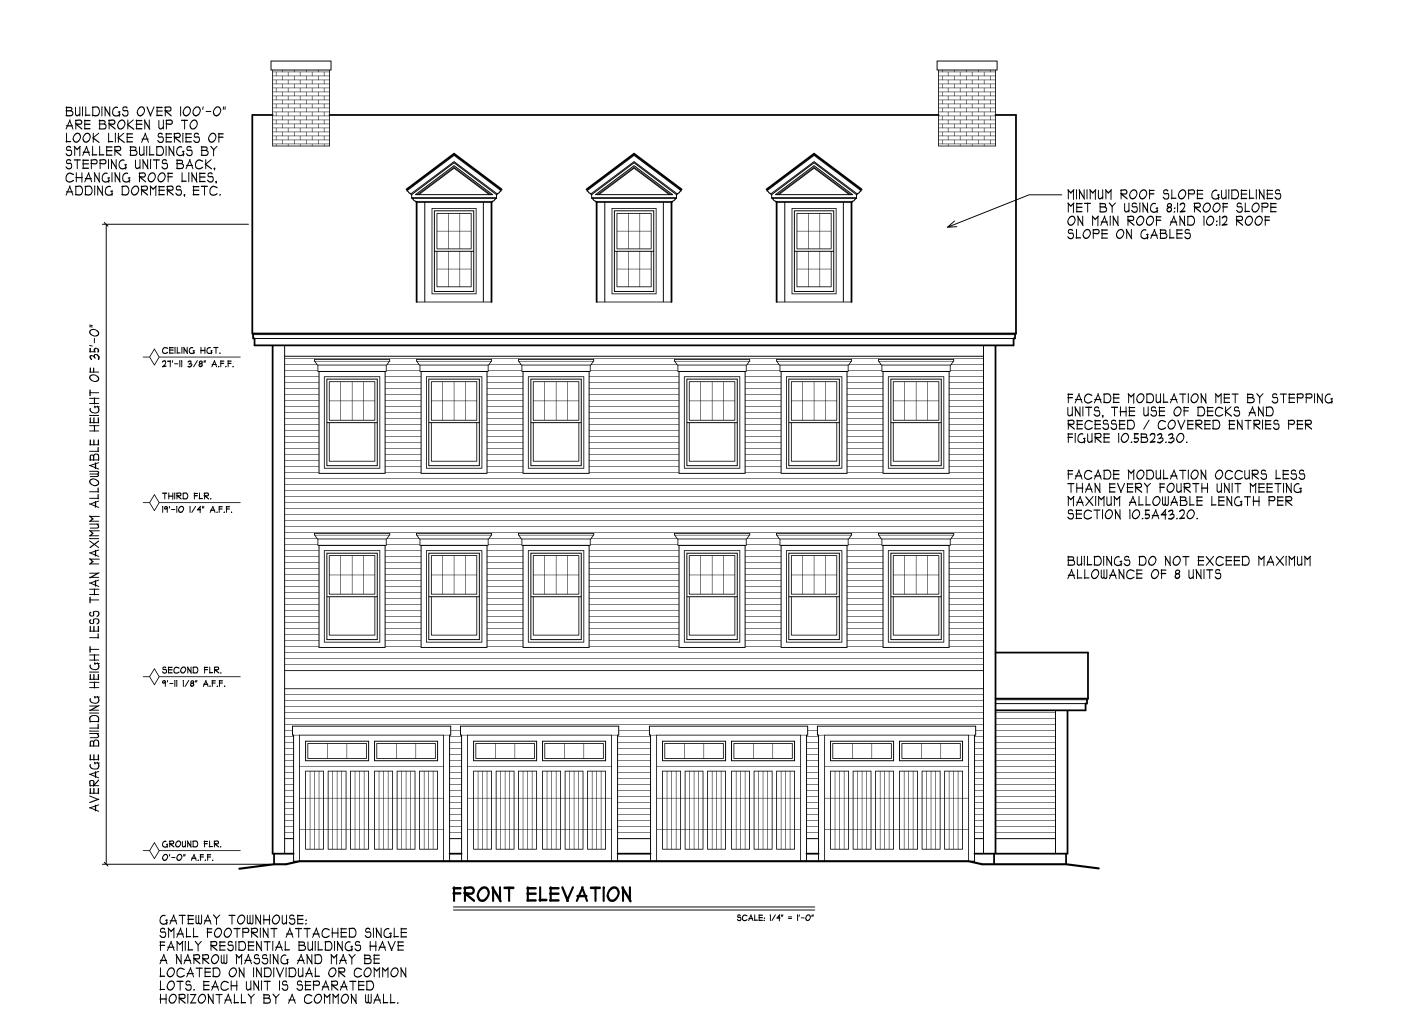

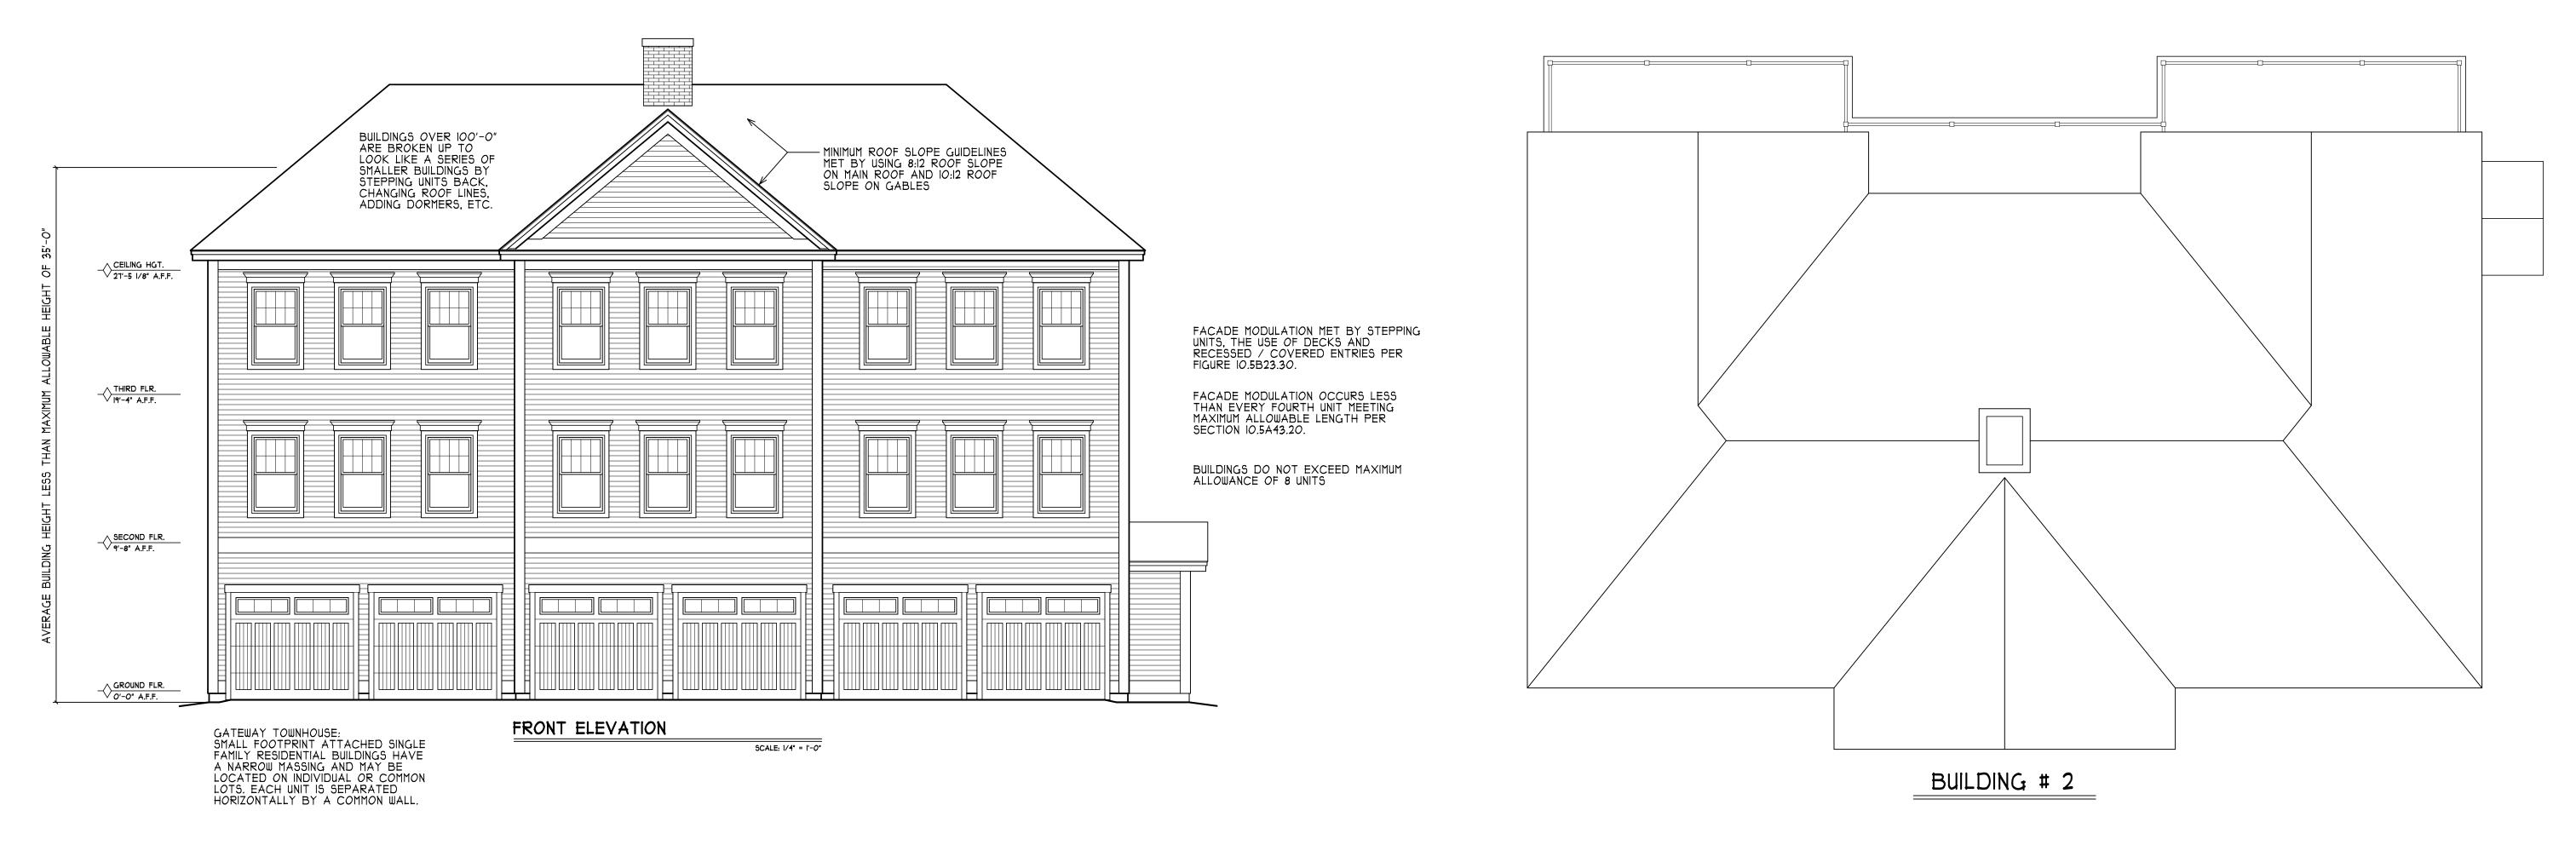


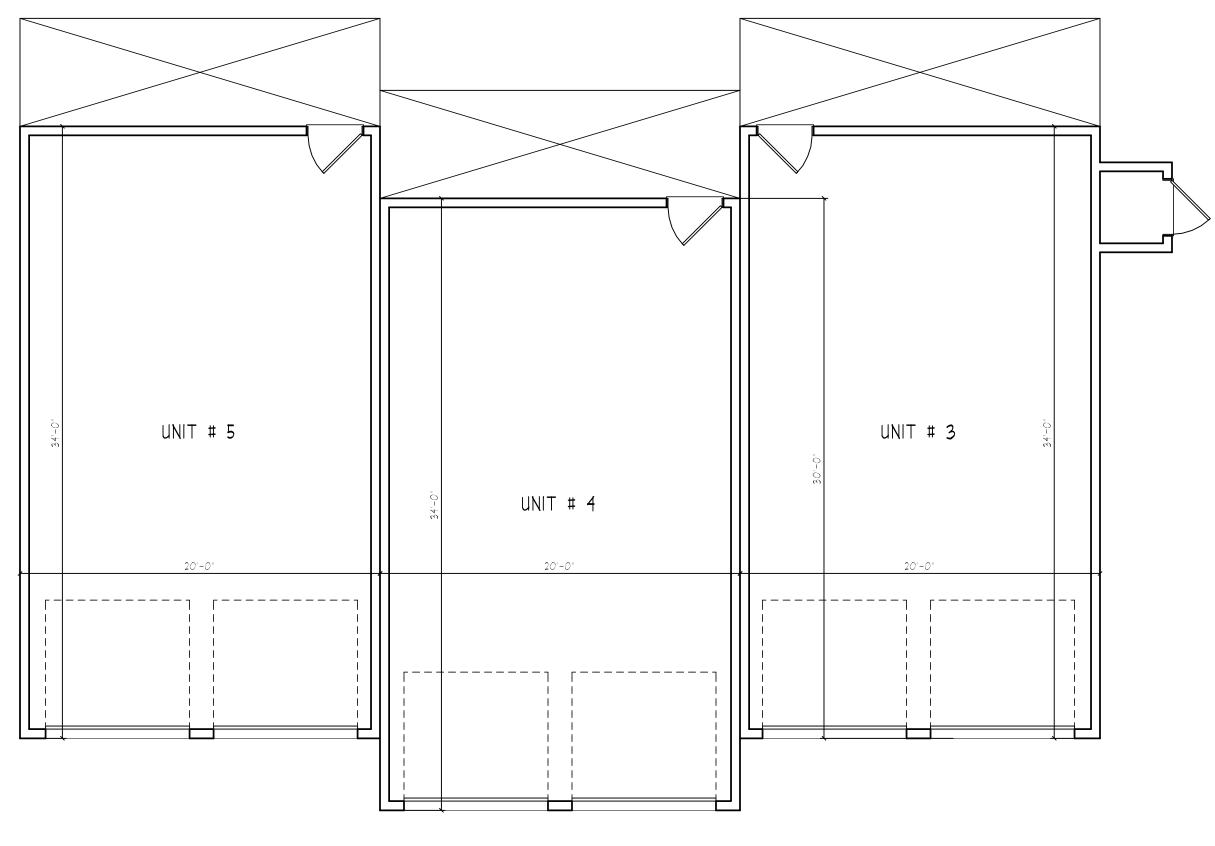

BUILDING # 2





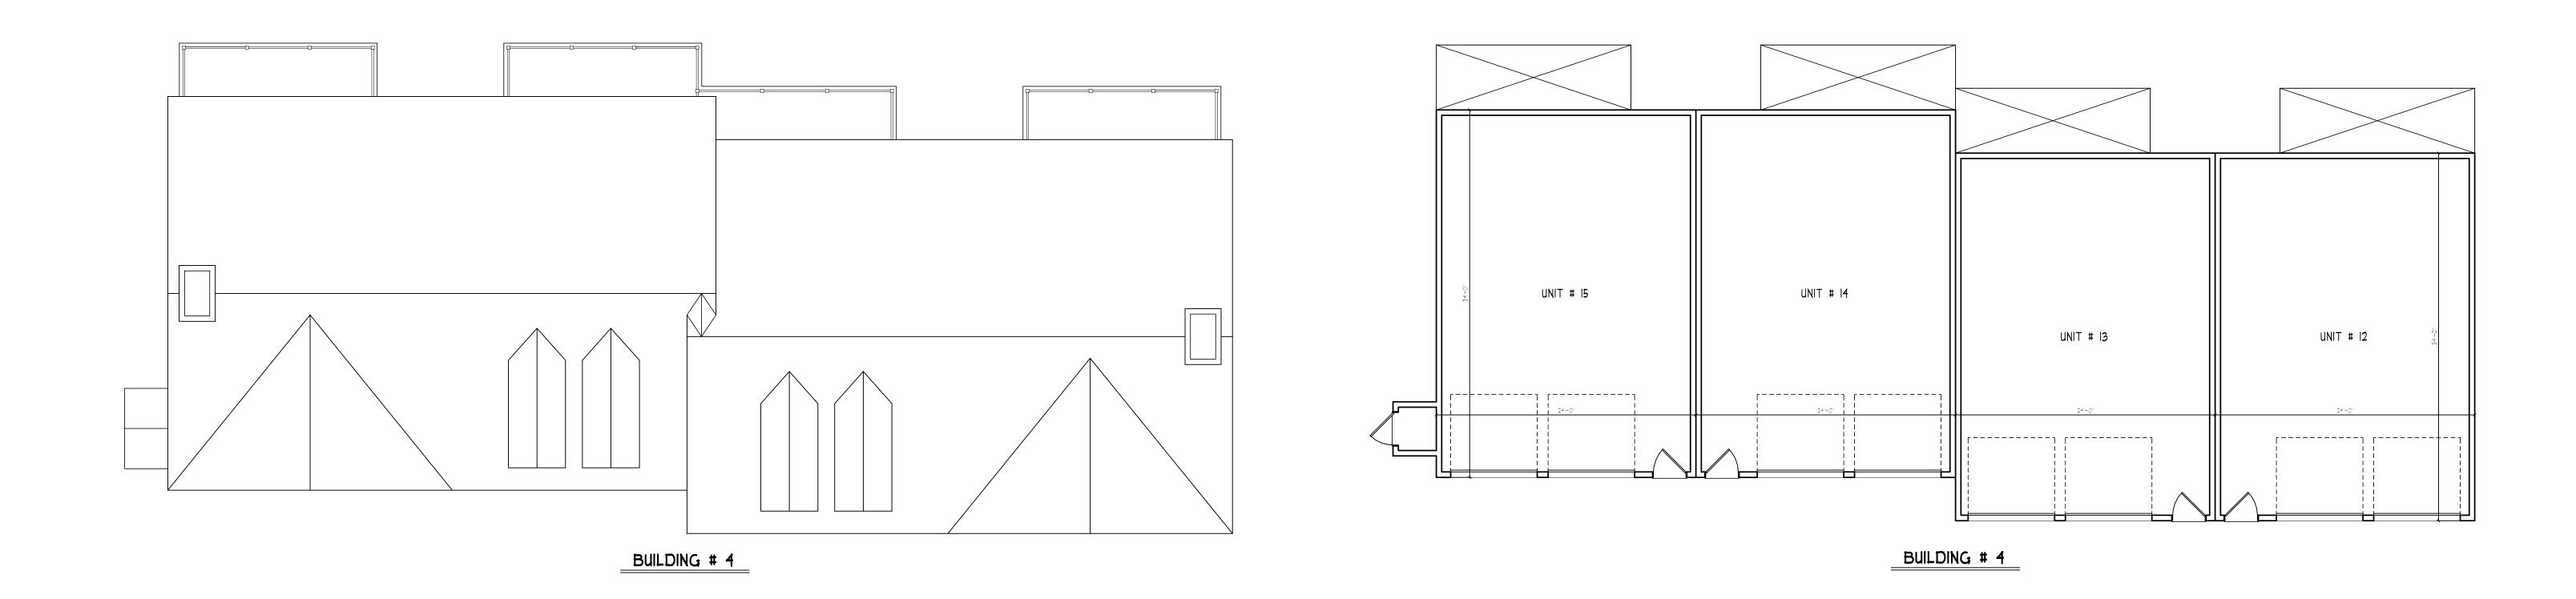



UNT # 18

UNT # 17


UNT # 18

BUILDING # 5


FACADE MODULATION OCCURS LESS THAN EVERY FOURTH UNIT MEETING MAXIMUM ALLOWABLE LENGTH PER SECTION 10.5A43.2O.


BUILDINGS DO NOT EXCEED MAXIMUM ALLOWANCE OF 8 UNITS



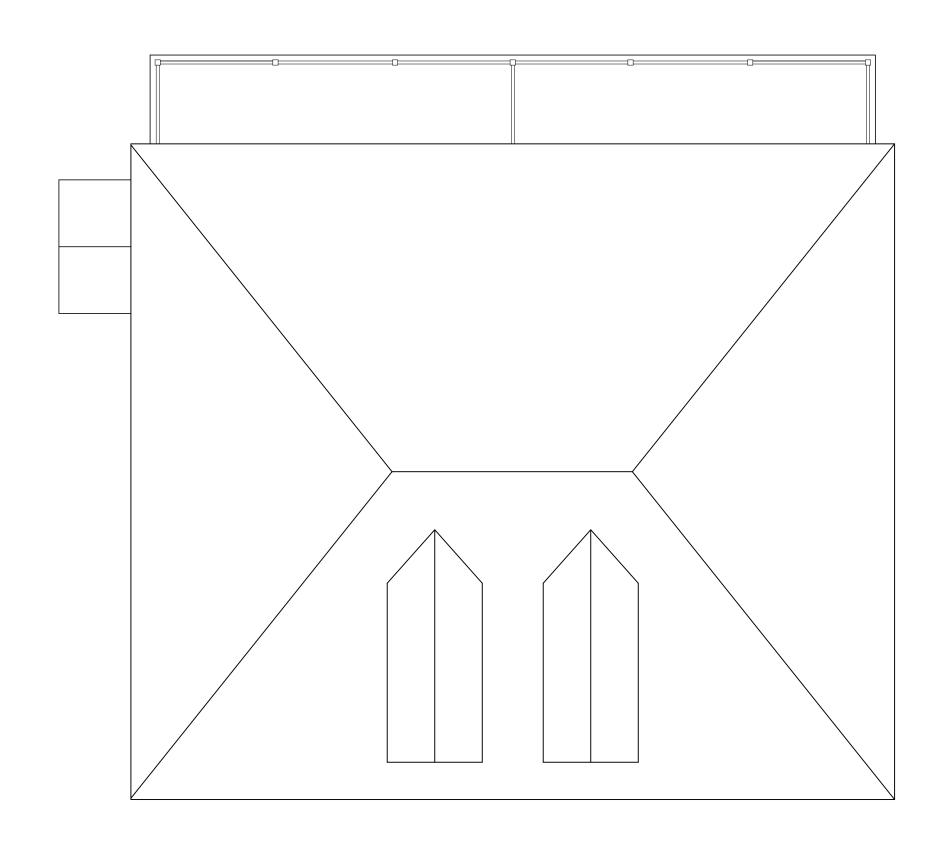


BUILDING # 6

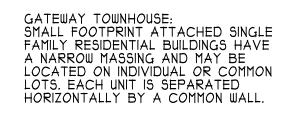


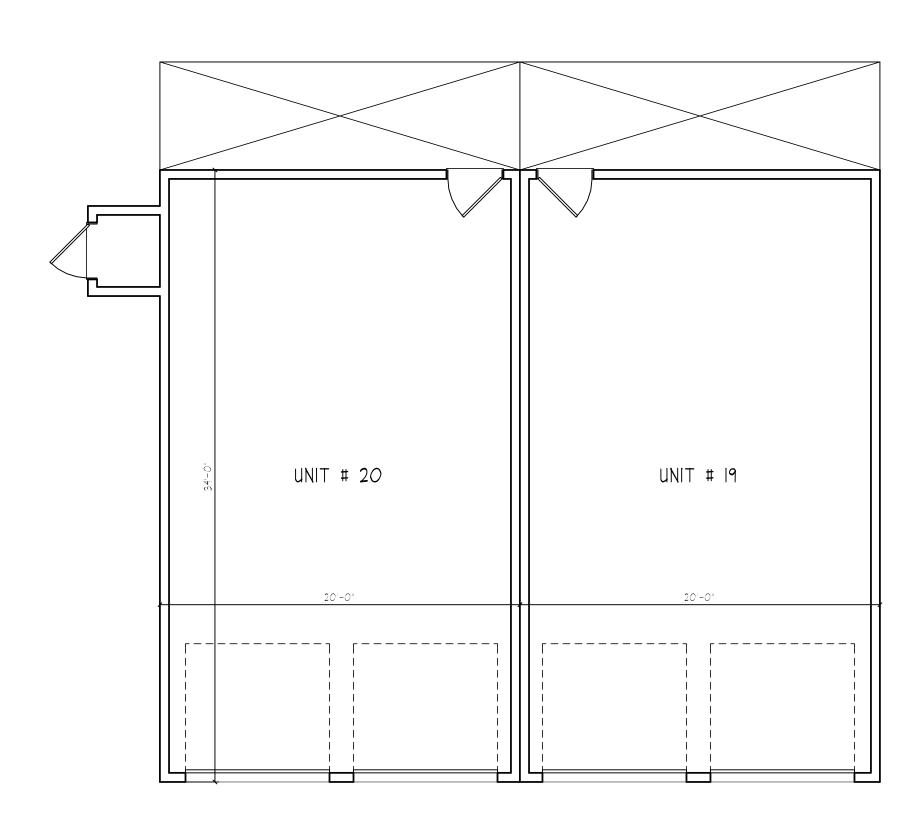


BUILDING # 6



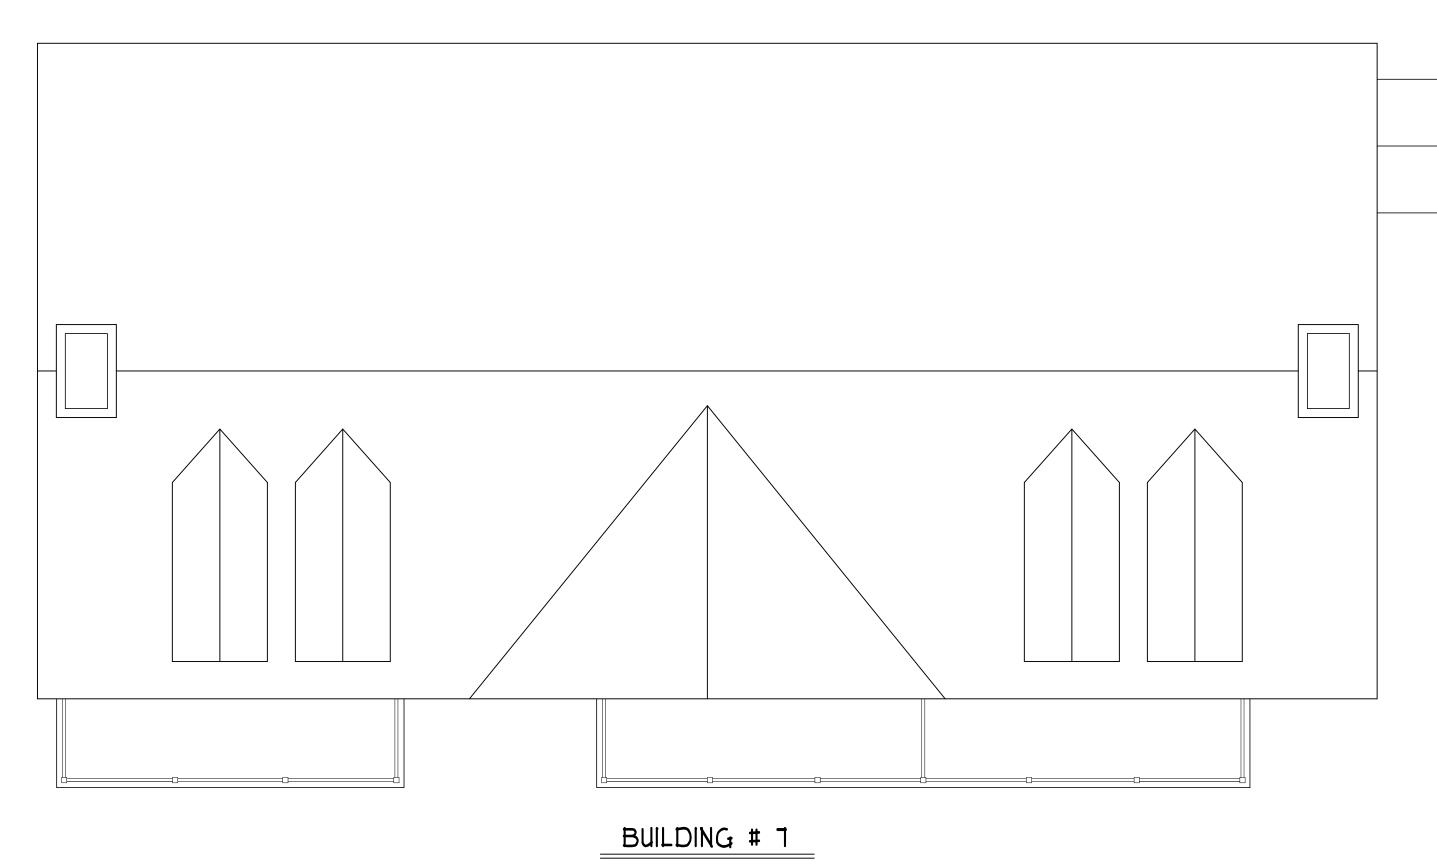

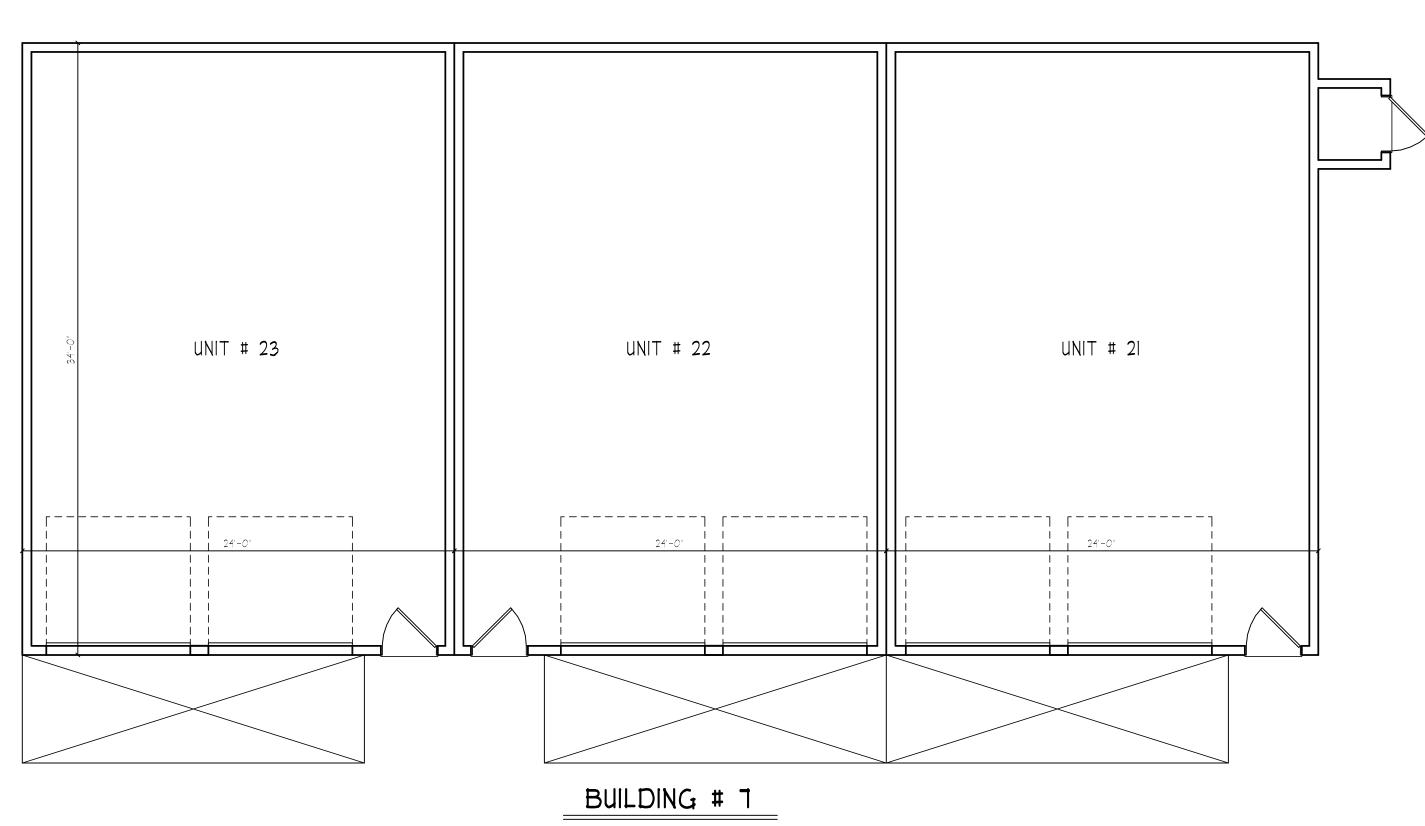


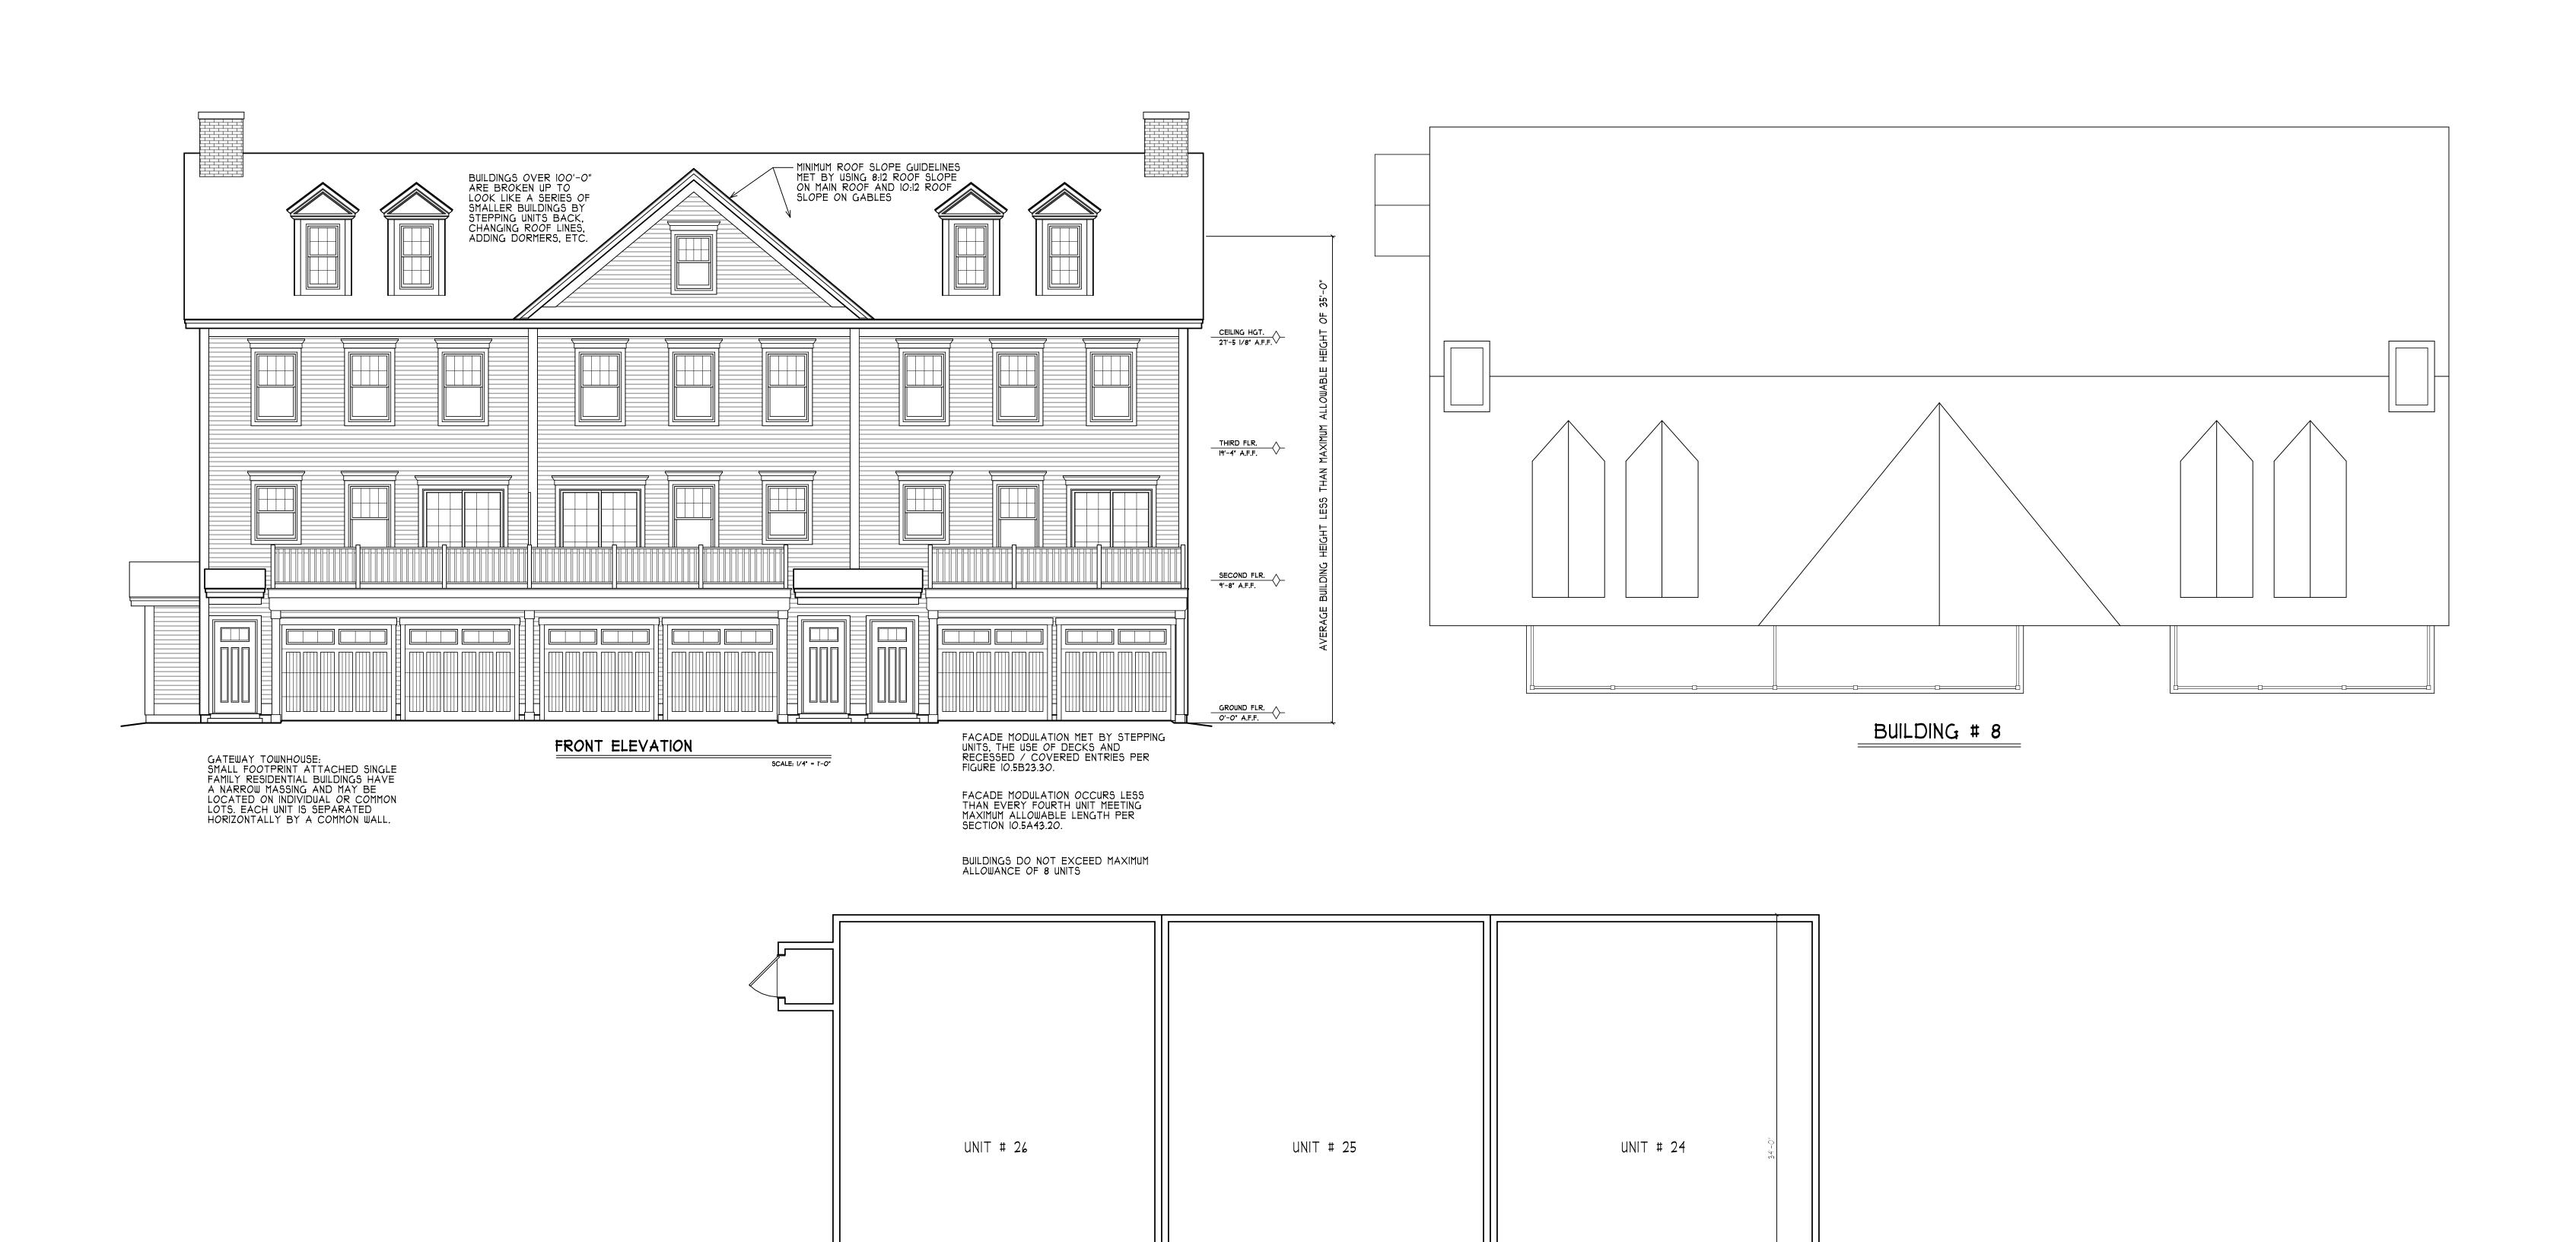


BUILDING # 8


r-----, r-----, lllr-----, r------,



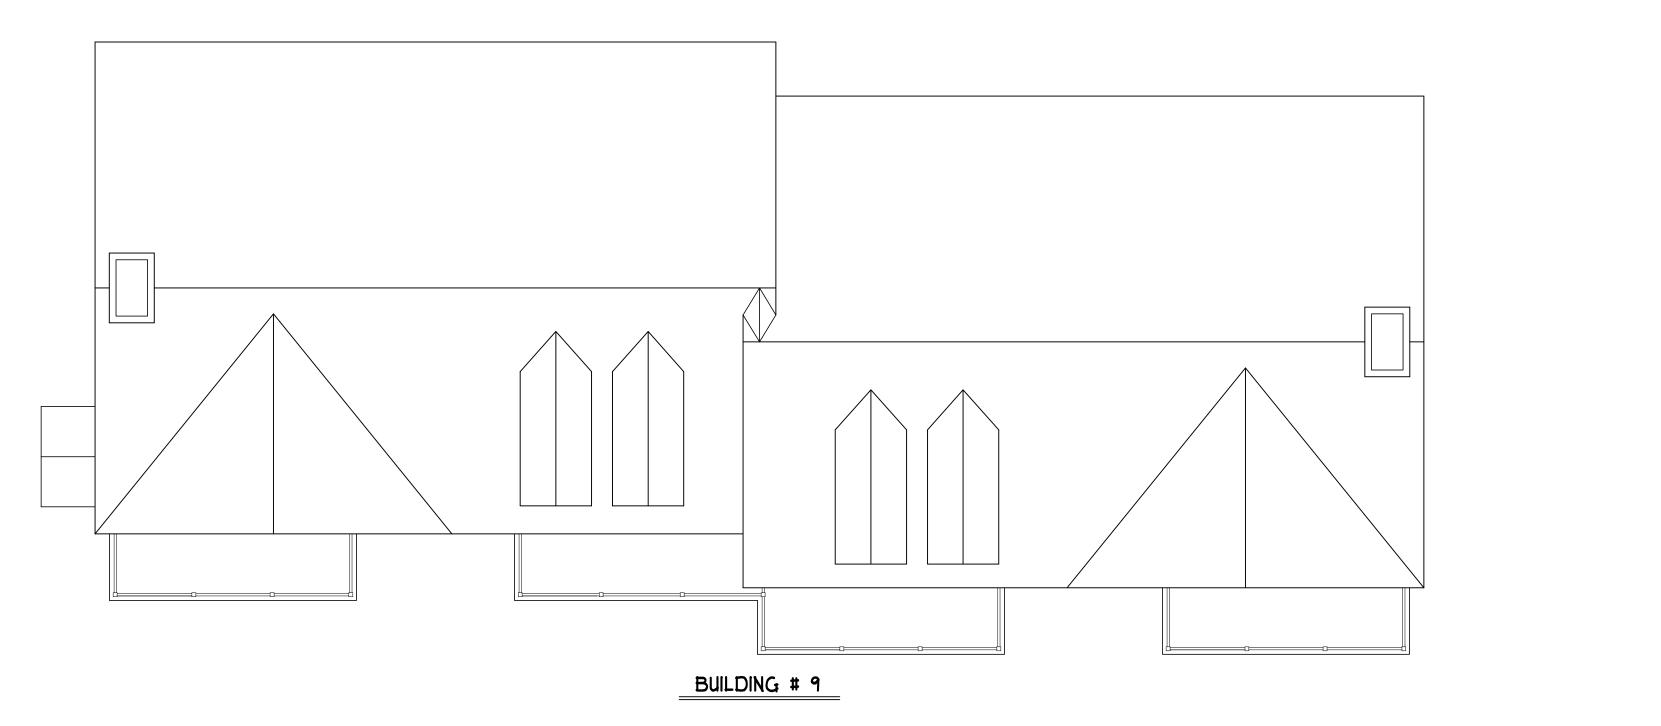

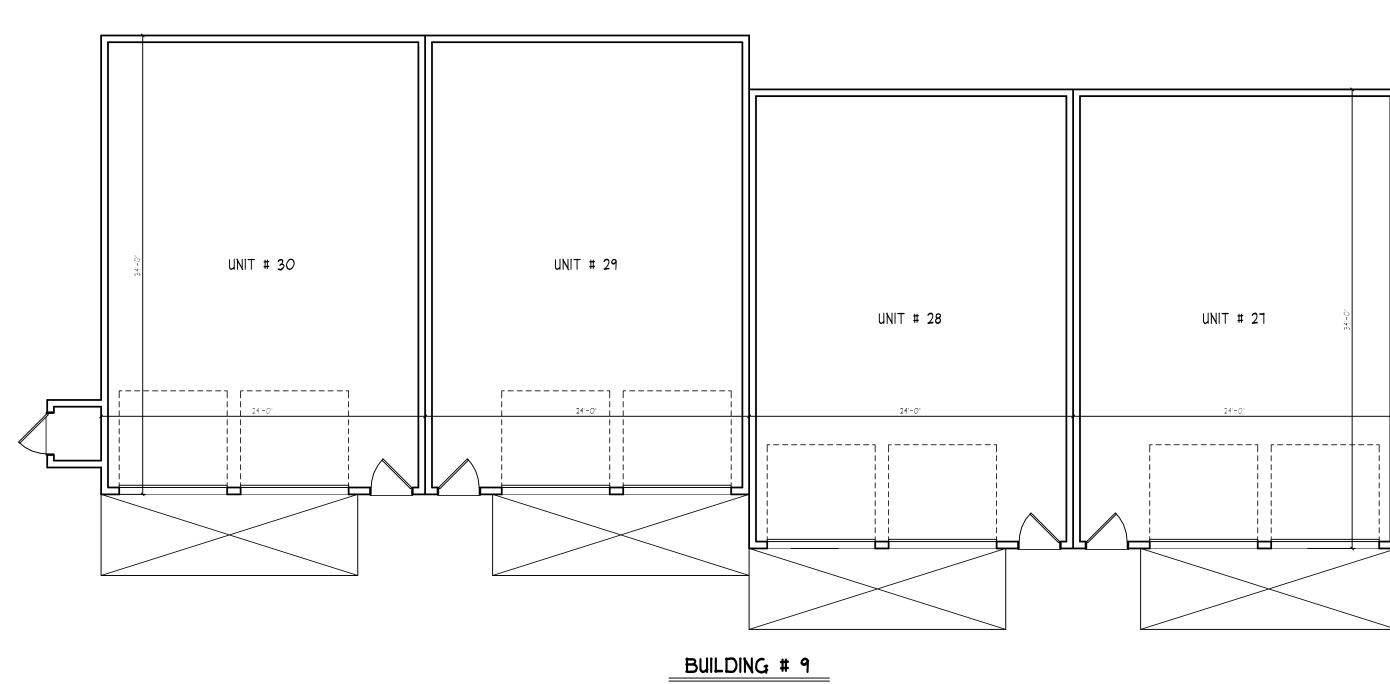



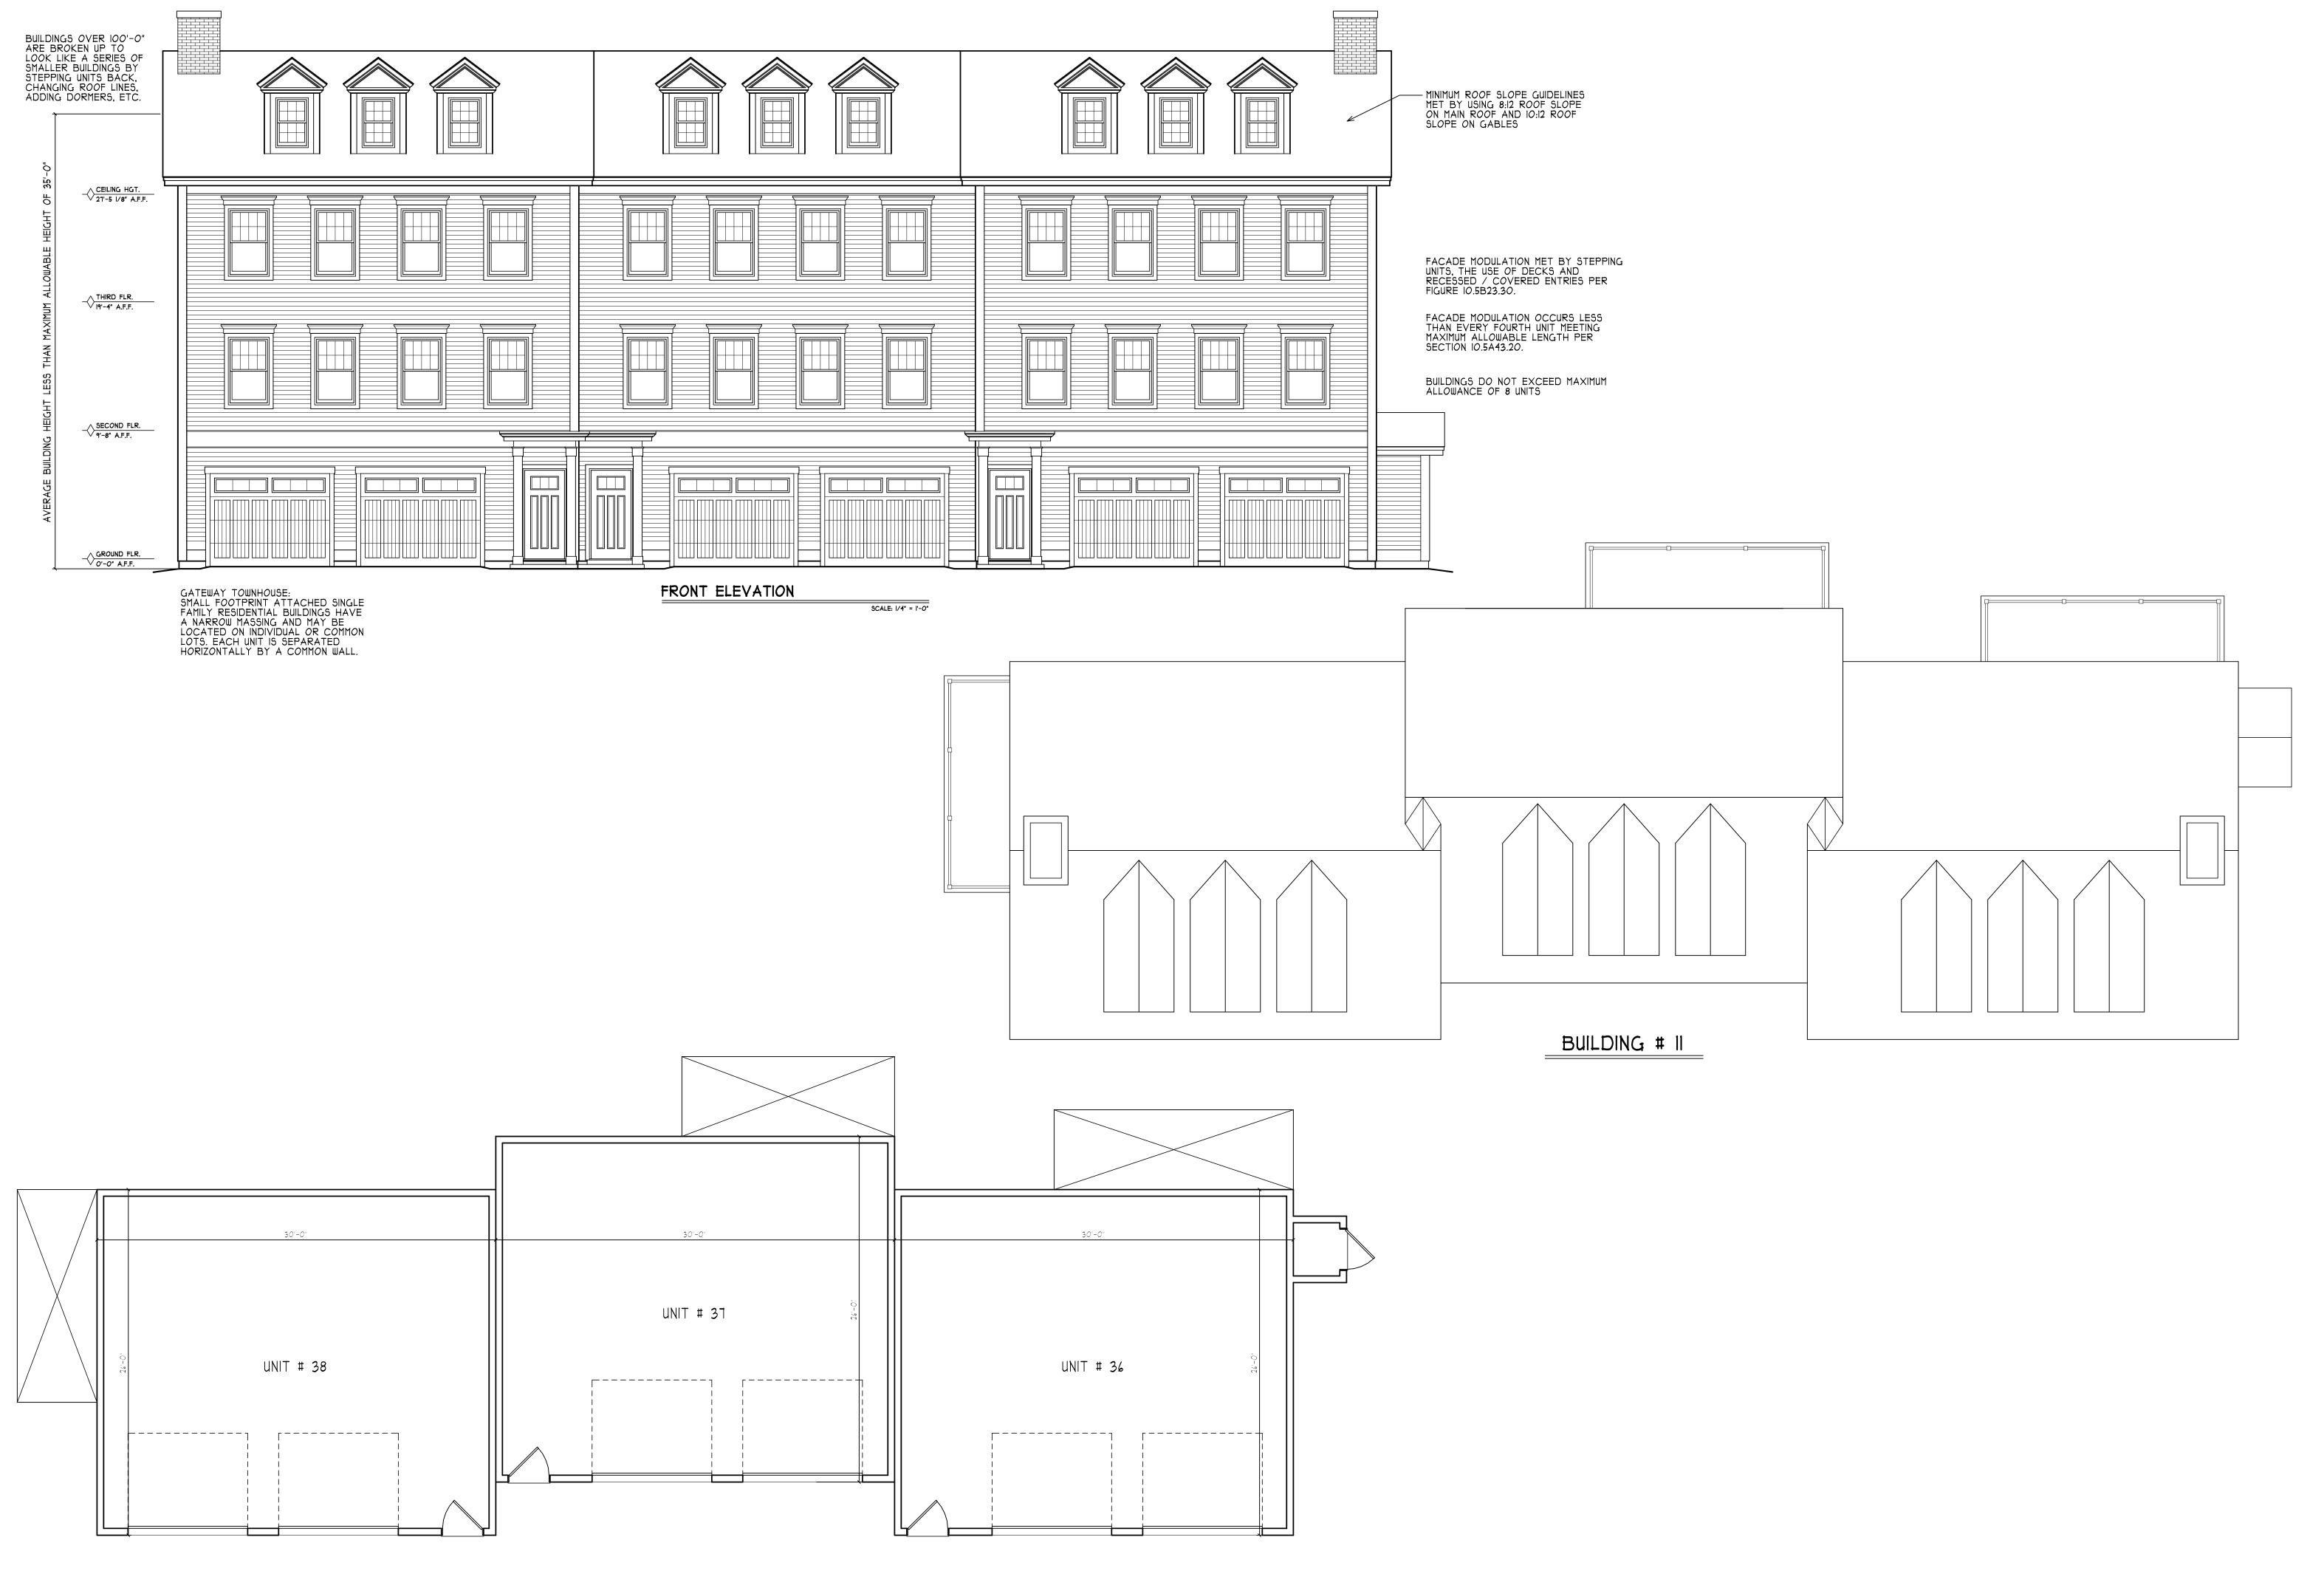



BUILDING # 12



BUILDING # 13