

AMBIT ENGINEERING, INC. CIVIL ENGINEERS AND LAND SURVEYORS

200 Griffin Road, Unit 3, Portsmouth, NH 03801
Phone (603) 430-9282 Fax 436-2315

12 August 2021

Dexter Legg, Chairman
City of Portsmouth Planning Board
1 Junkins Avenue
Portsmouth, NH 03801

**RE: Submission for Site Plan Approval at 180 Spaulding Turnpike, Tax Map 236 / Lot 39,
Proposed Showroom Addition**

Dear Chairman Legg and Planning Board Members:

On behalf of Spaulding Group, LLC (Applicant) we hereby submit the attached and enclosed Site Plans for **Site Plan Approval** for a Proposed Building Addition at 180 Spaulding Turnpike and request that we be placed on the agenda for your **August 19, 2021** TAC Meeting. As a Mazda automobile dealer franchisee, Seacoast Mazda has been directed by Mazda North America to seek all the necessary approvals to build a new showroom and customer service area. While clean and well maintained, the existing showroom and customer service area are in need of updating to provide a more functional, efficient and welcoming space. The proposed project involves demolishing the existing showroom, offices and service area and building a new showroom and customer service area on the existing footprint, adding a second floor over a portion the showroom for offices and storage space and expanding the showroom to include an enclosed customer service drive-in area. The new enclosed customer service drive-in area will be in the same location as the existing outdoor customer service drive-up area. The proposed new customer service drive-in area will align with the front and side of the building and thereby maintain the same setbacks from property boundaries that exist today. The plans include the associated site improvements for this addition.

The proposed project will increase the footprint of the existing building by approximately 2,412 square feet. This increase is largely represented by the conversion of the existing outdoor customer service drive-up area to an indoor customer service drive-in area. The proposed second floor office and storage space is approximately 2,230 GSF resulting in a total increase of gross square footage (GSF) of approximately 4,795 GSF. The project required Zoning Relief for building setback and other zone setback issues; said relief was granted by the Portsmouth Zoning Board on June 15, 2021. The Technical Advisory Committee reviewed the plans at the August 9, 2021 TAC Meeting and recommend approval with no conditions. The Portsmouth Conservation Commission reviewed our separate Conditional Use Permit application at their August 11, 2021 meeting and voted to recommend approval of this project.

The following plans are included in our submission:

- Cover Sheet – This shows the Development Team, Legend, Site Location, and Site Zoning.
- Standard Boundary Survey – This plan shows the results of a land survey of the property.
- Existing Conditions Plan C1 – This plan shows the existing site conditions and topography. The site is adjacent to wetlands on the northeast and southwest sides; those wetlands have been delineated and shown.
- Demolition Plan C2 – This plan shows the removal of the existing one story addition as well as a fence and some AC pads on the southeast side of the building. Those mechanicals will be placed on the roof or will be wall mounted.
- Site Plan C3 – This plan shows the site development; proposed building addition, concrete walkway, and ADA parking.
- Utility Plan C4 – This plan shows the site utilities in detail. Proposed sprinkler service and electric service are included. Existing site lighting will remain as is. Interior plumbing, electric load center, communications service, and mechanical system upgrades are proposed and will be shown on Building Permit plans.
- Grading Plan C5 - This plan shows the proposed building floor elevation, erosion control measures, and sidewalk grades.
- Detail Sheets D1 and D2 - These plans show the associated site construction details.
- Architectural Plans X1.1 to X2.1 and A1.1 to A2.1 – These plans show the existing and proposed Architecture.
- Exterior Rendering – This plans shows the completed building in a rendered view.

Also included in this submission is the following:

Site Plan Application Checklist
Green Building Statement

We look forward to the Planning Board review of this submission, and approval of the proposed design.

Sincerely,

John Chagnon

John R. Chagnon, PE
CC: Project Team



City of Portsmouth, New Hampshire

Site Plan Application Checklist

This site plan application checklist is a tool designed to assist the applicant in the planning process and for preparing the application for Planning Board review. The checklist is required to be completed and uploaded to the Site Plan application in the City's online permitting system. A pre-application conference with a member of the planning department is strongly encouraged as additional project information may be required depending on the size and scope. The applicant is cautioned that this checklist is only a guide and is not intended to be a complete list of all site plan review requirements. Please refer to the Site Plan review regulations for full details.

Applicant Responsibilities (Section 2.5.2): Applicable fees are due upon application submittal along with required attachments. The application shall be complete as submitted and provide adequate information for evaluation of the proposed site development. Waiver requests must be submitted in writing with appropriate justification.

Name of Applicant: Seacost Mazda Date Submitted: 7/19/21

Application # (in City's online permitting): LU-21-50

Site Address: 180 Spaulding Turnpike Map: 236 Lot: 39

Application Requirements			
<input checked="" type="checkbox"/>	Required Items for Submittal	Item Location (e.g. Page or Plan Sheet/Note #)	Waiver Requested
<input type="checkbox"/>	Complete application form submitted via the City's web-based permitting program (2.5.2.1(2.5.2.3A))	Online	N/A
<input type="checkbox"/>	All application documents, plans, supporting documentation and other materials uploaded to the application form in viewpoint in digital Portable Document Format (PDF). One hard copy of all plans and materials shall be submitted to the Planning Department by the published deadline. (2.5.2.8)	Yes	N/A

Site Plan Review Application Required Information			
<input checked="" type="checkbox"/>	Required Items for Submittal	Item Location (e.g. Page/line or Plan Sheet/Note #)	Waiver Requested
<input type="checkbox"/>	Statement that lists and describes "green" building components and systems. (2.5.3.1B)	Architect Letter	
<input type="checkbox"/>	Existing and proposed gross floor area and dimensions of all buildings and statement of uses and floor area for each floor. (2.5.3.1C)	Sheet C3	N/A
<input type="checkbox"/>	Tax map and lot number, and current zoning of all parcels under Site Plan Review. (2.5.3.1D)	Sheet C1	N/A

Site Plan Review Application Required Information			
<input checked="" type="checkbox"/>	Required Items for Submittal	Item Location (e.g. Page/line or Plan Sheet/Note #)	Waiver Requested
<input type="checkbox"/>	Owner's name, address, telephone number, and signature. Name, address, and telephone number of applicant if different from owner. (2.5.3.1E)	Cover Sheet	N/A
<input type="checkbox"/>	Names and addresses (including Tax Map and Lot number and zoning districts) of all direct abutting property owners (including properties located across abutting streets) and holders of existing conservation, preservation or agricultural preservation restrictions affecting the subject property. (2.5.3.1F)	Cover Sheet	N/A
<input type="checkbox"/>	Names, addresses and telephone numbers of all professionals involved in the site plan design. (2.5.3.1G)	Cover Sheet	N/A
<input type="checkbox"/>	List of reference plans. (2.5.3.1H)	Sheet C1	N/A
<input type="checkbox"/>	List of names and contact information of all public or private utilities servicing the site. (2.5.3.1I)	Cover Sheet	N/A

Site Plan Specifications			
<input checked="" type="checkbox"/>	Required Items for Submittal	Item Location (e.g. Page/line or Plan Sheet/Note #)	Waiver Requested
<input type="checkbox"/>	Full size plans shall not be larger than 22 inches by 34 inches with match lines as required, unless approved by the Planning Director.. (2.5.4.1A)	Required on all plan sheets	N/A
<input type="checkbox"/>	Scale: Not less than 1 inch = 60 feet and a graphic bar scale shall be included on all plans. (2.5.4.1B)	Required on all plan sheets	N/A
<input type="checkbox"/>	GIS data should be referenced to the coordinate system New Hampshire State Plane, NAD83 (1996), with units in feet. (2.5.4.1C)	Actually 2011 Update	N/A
<input type="checkbox"/>	Plans shall be drawn to scale and stamped by a NH licensed civil engineer. (2.5.4.1D)	Required on all plan sheets	N/A
<input type="checkbox"/>	Wetlands shall be delineated by a NH certified wetlands scientist and so stamped. (2.5.4.1E)	Sheet C1	N/A
<input type="checkbox"/>	Title (name of development project), north point, scale, legend. (2.5.4.2A)	Cover Sheet	N/A
<input type="checkbox"/>	Date plans first submitted, date and explanation of revisions. (2.5.4.2B)	Each Plan	N/A
<input type="checkbox"/>	Individual plan sheet title that clearly describes the information that is displayed. (2.5.4.2C)	Required on all plan sheets	N/A
<input type="checkbox"/>	Source and date of data displayed on the plan. (2.5.4.2D)	Site Survey	N/A

Site Plan Specifications – Required Exhibits and Data

<input checked="" type="checkbox"/>	Required Items for Submittal	Item Location (e.g. Page/line or Plan Sheet/Note #)	Waiver Requested
<input type="checkbox"/>	<p>1. Existing Conditions: (2.5.4.3A)</p> <ul style="list-style-type: none"> • Surveyed plan of site showing existing natural and built features; • Existing building footprints and gross floor area; • Existing parking areas and number of parking spaces provided; • Zoning district boundaries; • Existing, required, and proposed dimensional zoning requirements including building and open space coverage, yards and/or setbacks, and dwelling units per acre; • Existing impervious and disturbed areas; • Limits and type of existing vegetation; • Wetland delineation, wetland function and value assessment (including vernal pools); • SFHA, 100-year flood elevation line and BFE data, as required. 	<p align="center">Sheet C1 & Cover Sheet</p>	
<input type="checkbox"/>	<p>2. Buildings and Structures: (2.5.4.3B)</p> <ul style="list-style-type: none"> • Plan view: Use, size, dimensions, footings, overhangs, 1st fl. elevation; • Elevations: Height, massing, placement, materials, lighting, façade treatments; • Total Floor Area; • Number of Usable Floors; • Gross floor area by floor and use. 	<p align="center">Sheet C1 & C3</p>	
<input type="checkbox"/>	<p>3. Access and Circulation: (2.5.4.3C)</p> <ul style="list-style-type: none"> • Location/width of access ways within site; • Location of curbing, right of ways, edge of pavement and sidewalks; • Location, type, size and design of traffic signing (pavement markings); • Names/layout of existing abutting streets; • Driveway curb cuts for abutting prop. and public roads; • If subdivision; Names of all roads, right of way lines and easements noted; • AASHTO truck turning templates, description of minimum vehicle allowed being a WB-50 (unless otherwise approved by TAC). 	<p align="center">Sheet C3</p>	
<input type="checkbox"/>	<p>4. Parking and Loading: (2.5.4.3D)</p> <ul style="list-style-type: none"> • Location of off street parking/loading areas, landscaped areas/buffers; • Parking Calculations (# required and the # provided). 	<p align="center">Sheet C3</p>	
<input type="checkbox"/>	<p>5. Water Infrastructure: (2.5.4.3E)</p> <ul style="list-style-type: none"> • Size, type and location of water mains, shut-offs, hydrants & Engineering data; • Location of wells and monitoring wells (include protective radii). 	<p align="center">Sheet C4</p>	
<input type="checkbox"/>	<p>6. Sewer Infrastructure: (2.5.4.3F)</p> <ul style="list-style-type: none"> • Size, type and location of sanitary sewage facilities & Engineering data, including any onsite temporary facilities during construction period. 	<p align="center">Sheet C4</p>	

<input type="checkbox"/>	7. Utilities: (2.5.4.3G) <ul style="list-style-type: none"> The size, type and location of all above & below ground utilities; Size type and location of generator pads, transformers and other fixtures. 	Sheet C4	
<input type="checkbox"/>	8. Solid Waste Facilities: (2.5.4.3H) <ul style="list-style-type: none"> The size, type and location of solid waste facilities. 	Sheet C3	
<input type="checkbox"/>	9. Storm water Management: (2.5.4.3I) <ul style="list-style-type: none"> The location, elevation and layout of all storm-water drainage. The location of onsite snow storage areas and/or proposed off-site snow removal provisions. Location and containment measures for any salt storage facilities Location of proposed temporary and permanent material storage locations and distance from wetlands, water bodies, and stormwater structures. 	Sheet C5	
<input type="checkbox"/>	10. Outdoor Lighting: (2.5.4.3J) <ul style="list-style-type: none"> Type and placement of all lighting (exterior of building, parking lot and any other areas of the site) and photometric plan. 	No Change	
<input type="checkbox"/>	11. Indicate where dark sky friendly lighting measures have been implemented. (10.1)	No Change	
<input type="checkbox"/>	12. Landscaping: (2.5.4.3K) <ul style="list-style-type: none"> Identify all undisturbed area, existing vegetation and that which is to be retained; Location of any irrigation system and water source. 	N/A	
<input type="checkbox"/>	13. Contours and Elevation: (2.5.4.3L) <ul style="list-style-type: none"> Existing/Proposed contours (2 foot minimum) and finished grade elevations. 	Sheet C5	
<input type="checkbox"/>	14. Open Space: (2.5.4.3M) <ul style="list-style-type: none"> Type, extent and location of all existing/proposed open space. 	Sheet C3	
<input type="checkbox"/>	15. All easements, deed restrictions and non-public rights of ways. (2.5.4.3N)	Sheet C1	
<input type="checkbox"/>	16. Character/Civic District (All following information shall be included): (2.5.4.3P) <ul style="list-style-type: none"> Applicable Building Height (10.5A21.20 & 10.5A43.30); Applicable Special Requirements (10.5A21.30); Proposed building form/type (10.5A43); Proposed community space (10.5A46). 	N/A	
<input type="checkbox"/>	17. Special Flood Hazard Areas (2.5.4.3Q) <ul style="list-style-type: none"> The proposed development is consistent with the need to minimize flood damage; All public utilities and facilities are located and construction to minimize or eliminate flood damage; Adequate drainage is provided so as to reduce exposure to flood hazards. 	N/A	

Other Required Information			
<input checked="" type="checkbox"/>	Required Items for Submittal	Item Location (e.g. Page/line or Plan Sheet/Note #)	Waiver Requested
<input type="checkbox"/>	Traffic Impact Study or Trip Generation Report, as required. (3.2.1-2)	No Change	
<input type="checkbox"/>	Indicate where Low Impact Development Design practices have been incorporated. (7.1)	Green Statement	
<input type="checkbox"/>	Indicate whether the proposed development is located in a wellhead protection or aquifer protection area. Such determination shall be approved by the Director of the Dept. of Public Works. (7.3.1)	TBD	
<input type="checkbox"/>	Stormwater Management and Erosion Control Plan. (7.4)	Sheet C5	
<input type="checkbox"/>	Inspection and Maintenance Plan (7.6.5)		

Final Site Plan Approval Required Information			
<input checked="" type="checkbox"/>	Required Items for Submittal	Item Location (e.g. Page/line or Plan Sheet/Note #)	Waiver Requested
<input type="checkbox"/>	All local approvals, permits, easements and licenses required, including but not limited to: <ul style="list-style-type: none"> • Waivers; • Driveway permits; • Special exceptions; • Variances granted; • Easements; • Licenses. (2.5.3.2A)	Cover Sheet	
<input type="checkbox"/>	Exhibits, data, reports or studies that may have been required as part of the approval process, including but not limited to: <ul style="list-style-type: none"> • Calculations relating to stormwater runoff; • Information on composition and quantity of water demand and wastewater generated; • Information on air, water or land pollutants to be discharged, including standards, quantity, treatment and/or controls; • Estimates of traffic generation and counts pre- and post-construction; • Estimates of noise generation; • A Stormwater Management and Erosion Control Plan; • Endangered species and archaeological / historical studies; • Wetland and water body (coastal and inland) delineations; • Environmental impact studies. (2.5.3.2B)	Plan Set No Change in Impervious Area Proposed	
<input type="checkbox"/>	A document from each of the required private utility service providers indicating approval of the proposed site plan and indicating an ability to provide all required private utilities to the site. (2.5.3.2D)	TBD	

Final Site Plan Approval Required Information

<input checked="" type="checkbox"/>	Required Items for Submittal	Item Location (e.g. Page/line or Plan Sheet/Note #)	Waiver Requested
<input type="checkbox"/>	A list of any required state and federal permit applications required for the project and the status of same. (2.5.3.2E)	N/A	
<input type="checkbox"/>	A note shall be provided on the Site Plan stating: "All conditions on this Plan shall remain in effect in perpetuity pursuant to the requirements of the Site Plan Review Regulations." (2.5.4.2E)	Cover & Sheet C3	N/A
<input type="checkbox"/>	For site plans that involve land designated as "Special Flood Hazard Areas" (SFHA) by the National Flood Insurance Program (NFIP) confirmation that all necessary permits have been received from those governmental agencies from which approval is required by Federal or State law, including Section 404 of the Federal Water Pollution Control Act Amendments of 1972, 33 U.S.C. 1334. (2.5.4.2F)	N/A	
<input type="checkbox"/>	Plan sheets submitted for recording shall include the following notes: a. "This Site Plan shall be recorded in the Rockingham County Registry of Deeds." b. "All improvements shown on this Site Plan shall be constructed and maintained in accordance with the Plan by the property owner and all future property owners. No changes shall be made to this Site Plan without the express approval of the Portsmouth Planning Director." (2.13.3)	Sheet C3	N/A

Applicant's Signature: John Chagnon Date: 7-19-21

July 19, 2021

Seacoast Mazda Addition
180 Spaulding Turnpike

Site Plan Review

Green Building Statement

The existing building is 11,732sf consisting of a rear service pre-engineered building and a front showroom and customer waiting addition. This project will remove the front addition and replace it with a new showroom and sales offices. The rear service pre-engineered building will remain as is.

The design and materials are specified by Mazda corporate. Local architects can research and use alternate materials with their approval.

Building Envelope

- ✓ Design high performing thermal envelope that exceeds 2015 IECC baseline.
- ✓ Seek Energy Star certificates and rebates.
- ✓ Use low-VOC products for construction.

Materials

- ✓ Minimize waste during construction.
- ✓ Recycle during building operation.
- ✓ Source as many low-carbon footprint materials as budget allows.
- ✓ Source materials regionally within 500 miles as available.

Plumbing

- ✓ Low flow plumbing fixtures
- ✓ Explore using domestic hot water recirculation system to reduce water waste.

Mechanical

- ✓ Reduced mechanical systems through improved building envelope and air sealing.
- ✓ Utilized energy recover ventilator(s) to provide code required ventilation and exhaust.
- ✓ Explore using high efficiency gas fired systems.
- ✓ Utilize demand control ventilation.
- ✓ Install programmable system controls with automatic temperature setback.

Electrical

- ✓ LED lighting throughout.
- ✓ Occupancy sensor lighting controls.
- ✓ Daylight dimming.

PROPOSED BUILDING ADDITION SEACOAST MAZDA 180 SPAULDING TURNPIKE PORTSMOUTH NEW HAMPSHIRE SITE PERMIT PLANS

PROJECT PERMITS:
 PORTSMOUTH ZBA: APPROVED 6/15/21
 PORTSMOUTH SITE PLAN: PENDING
 PORTSMOUTH CUP (WETLANDS): PENDING


OWNER AND APPLICANT:
SPAULDING GROUP, LLC
 180 SPAULDING TURNPIKE
 PORTSMOUTH, N.H. 03801
 TEL. (603) 436-6811

ARCHITECT:
PORT ONE ARCHITECTS
 959 ISLINGTON STREET
 PORTSMOUTH, NH
 TEL. (603) 436-8891

CIVIL ENGINEER & LAND SURVEYOR:
AMBIT ENGINEERING, INC.
 200 GRIFFIN ROAD, UNIT 3
 PORTSMOUTH, N.H. 03801
 TEL. (603) 430-9282
 FAX (603) 436-2315

CORPORATE ARCHITECT:
CHANGE UP
 2056 BYERS ROAD
 DAYTON, OH
 TEL. (844) 804-7700

PORTSMOUTH ZONING MAP

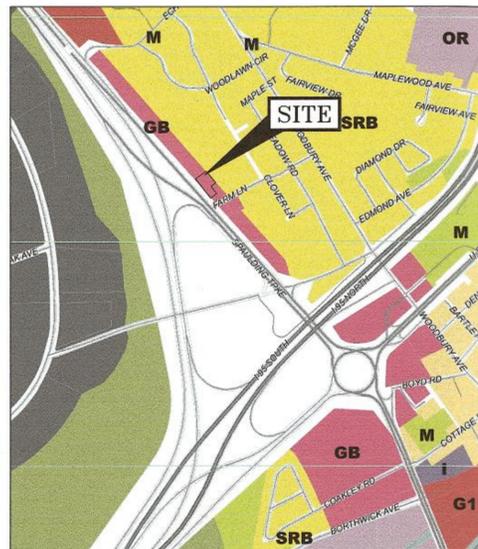

Legend

Character Districts

Character-Based Zoning Area
 (Refer to Zoning Map Sheet 2 of 2
 Character Districts Regulating Plan)

Residential Districts


- R Rural
- SRA Single Residence A
- SRB Single Residence B
- GRA General Residence A
- GRB General Residence B
- GRC General Residence C
- GA/MH Garden Apartment/Mobile Home Park

Mixed Residential Districts

- MRO Mixed Residential Office
- MRB Mixed Residential Business
- G1 Gateway Corridor
- G2 Gateway Center

Business Districts

- GB General Business
- B Business
- WB Waterfront Business

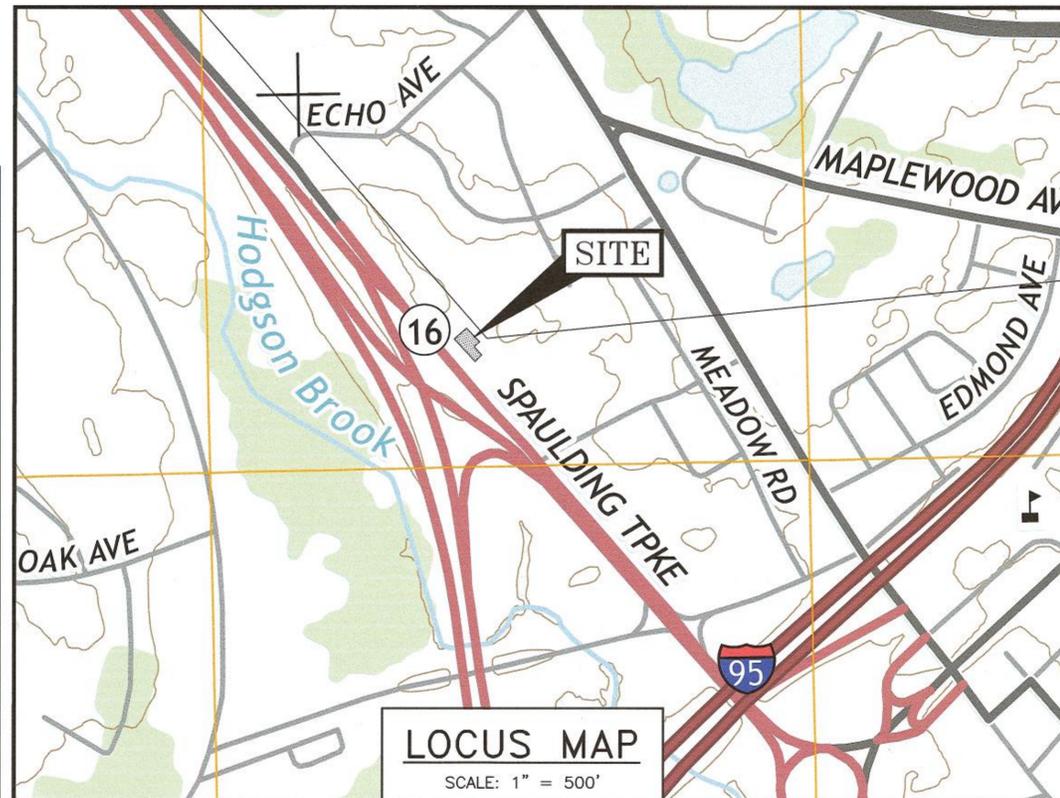

EXISTING	PROPOSED	
---	---	PROPERTY LINE
---	---	SETBACK
S	S	SEWER PIPE
SL	SL	SEWER LATERAL
G	G	GAS LINE
D	D	STORM DRAIN
W	W	WATER LINE
WS	WS	WATER SERVICE
UGE	UGE	UNDERGROUND ELECTRIC
OHW	OHW	OVERHEAD ELECTRIC/WIRES
---	---	FOUNDATION DRAIN
---	---	EDGE OF PAVEMENT (EP)
100	100	CONTOUR
97x3	98x0	SPOT ELEVATION
⊙	⊙	UTILITY POLE
⊙	⊙	WALL MOUNTED EXTERIOR LIGHTS
⊙	⊙	TRANSFORMER ON CONCRETE PAD
⊙	⊙	ELECTRIC HANDHOLD
⊙	⊙	SHUT OFFS (WATER/GAS)
⊙	⊙	GATE VALVE
⊙	⊙	HYDRANT
⊙	⊙	CATCH BASIN
⊙	⊙	SEWER MANHOLE
⊙	⊙	DRAIN MANHOLE
⊙	⊙	TELEPHONE MANHOLE
⊙	⊙	PARKING SPACE COUNT
⊙	⊙	PARKING METER
LSA	LSA	LANDSCAPED AREA
TBD	TBD	TO BE DETERMINED
CI	CI	CAST IRON PIPE
COP	COP	COPPER PIPE
DI	DI	DUCTILE IRON PIPE
PVC	PVC	POLYVINYL CHLORIDE PIPE
RCP	RCP	REINFORCED CONCRETE PIPE
AC	AC	ASBESTOS CEMENT PIPE
VC	VC	VITRIFIED CLAY PIPE
EP	EP	EDGE OF PAVEMENT
EL	EL	ELEVATION
FF	FF	FINISHED FLOOR
INV	INV	INVERT
S =	S =	SLOPE FT/FT
TBM	TBM	TEMPORARY BENCH MARK
TYP	TYP	TYPICAL
W.W.	W.W.	WINDOW WELL
1	1	PHOTO LOCATION



UTILITY CONTACTS

ELECTRIC:
 EVERSOURCE
 1700 LAFAYETTE ROAD
 PORTSMOUTH, N.H. 03801
 Tel. (603) 436-7708, Ext. 555.5678
 ATTN: MICHAEL BUSBY, P.E. (MANAGER)

NATURAL GAS:
 UNITIL
 325 WEST ROAD
 PORTSMOUTH, N.H. 03801
 Tel. (603) 294-5144
 ATTN: DAVE BEAULIEU

CABLE:
 COMCAST
 155 COMMERCE WAY
 PORTSMOUTH, N.H. 03801
 Tel. (603) 679-5695 (X1037)
 ATTN: MIKE COLLINS

SEWER & WATER:
 PORTSMOUTH DEPARTMENT OF PUBLIC WORKS
 680 PEVERLY HILL ROAD
 PORTSMOUTH, N.H. 03801
 Tel. (603) 427-1530
 ATTN: JIM TOW

COMMUNICATIONS:
 CONSOLIDATED
 COMMUNICATIONS
 JOE CONSIDINE
 1575 GREENLAND ROAD
 GREENLAND, N.H. 03840
 Tel. (603) 427-5525

INDEX OF SHEETS

DWG No.	Description
-	STANDARD BOUNDARY SURVEY PLAN
C1	EXISTING CONDITIONS PLAN
C2	DEMOLITION PLAN
C3	SITE PLAN
C4	UTILITY PLAN
C5	GRADING PLAN
	EXTERIOR RENDERING
	FLOOR PLANS
	ELEVATIONS

PORTSMOUTH APPROVAL CONDITIONS NOTE:
 ALL CONDITIONS ON THIS PLAN SET SHALL REMAIN IN EFFECT IN
 PERPETUITY PURSUANT TO THE REQUIREMENTS OF THE CITY OF
 PORTSMOUTH SITE PLAN REVIEW REGULATIONS.


APPROVED BY THE PORTSMOUTH PLANNING BOARD

CHAIRMAN _____ DATE _____

**PROPOSED BUILDING ADDITION
 SEACOAST MAZDA
 180 SPAULDING TURNPIKE
 PORTSMOUTH, N.H.**

AMBIT ENGINEERING, INC.
 Civil Engineers & Land Surveyors
 200 Griffin Road - Unit 3
 Portsmouth, N.H. 03801-7114
 Tel (603) 430-9282
 Fax (603) 436-2315

PLAN SET SUBMITTAL DATE: 19 JULY 2021

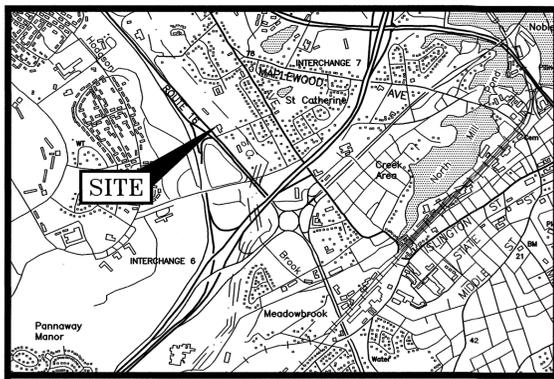


LOCATION MAP

SCALE: 1"=2,000'

LEGEND:

- N/F NOW OR FORMERLY
- RP RECORD OF PROBATE
- RCRD ROCKINGHAM COUNTY
- RR SPK REGISTRY OF DEEDS
- RR SPK RAILROAD SPIKE
- MAP 11/LOT 21
- IR FND IRON ROD FOUND
- IP FND IRON PIPE FOUND
- IR SET IRON ROD SET
- DH FND DRILL HOLE FOUND
- DH SET DRILL HOLE SET
- NHFB NHDOT BOUND FOUND
- TB TOWN BOUND
- BND w/DH BOUND WITH DRILL HOLE
- ST BND w/DH STONE BOUND WITH DRILL HOLE

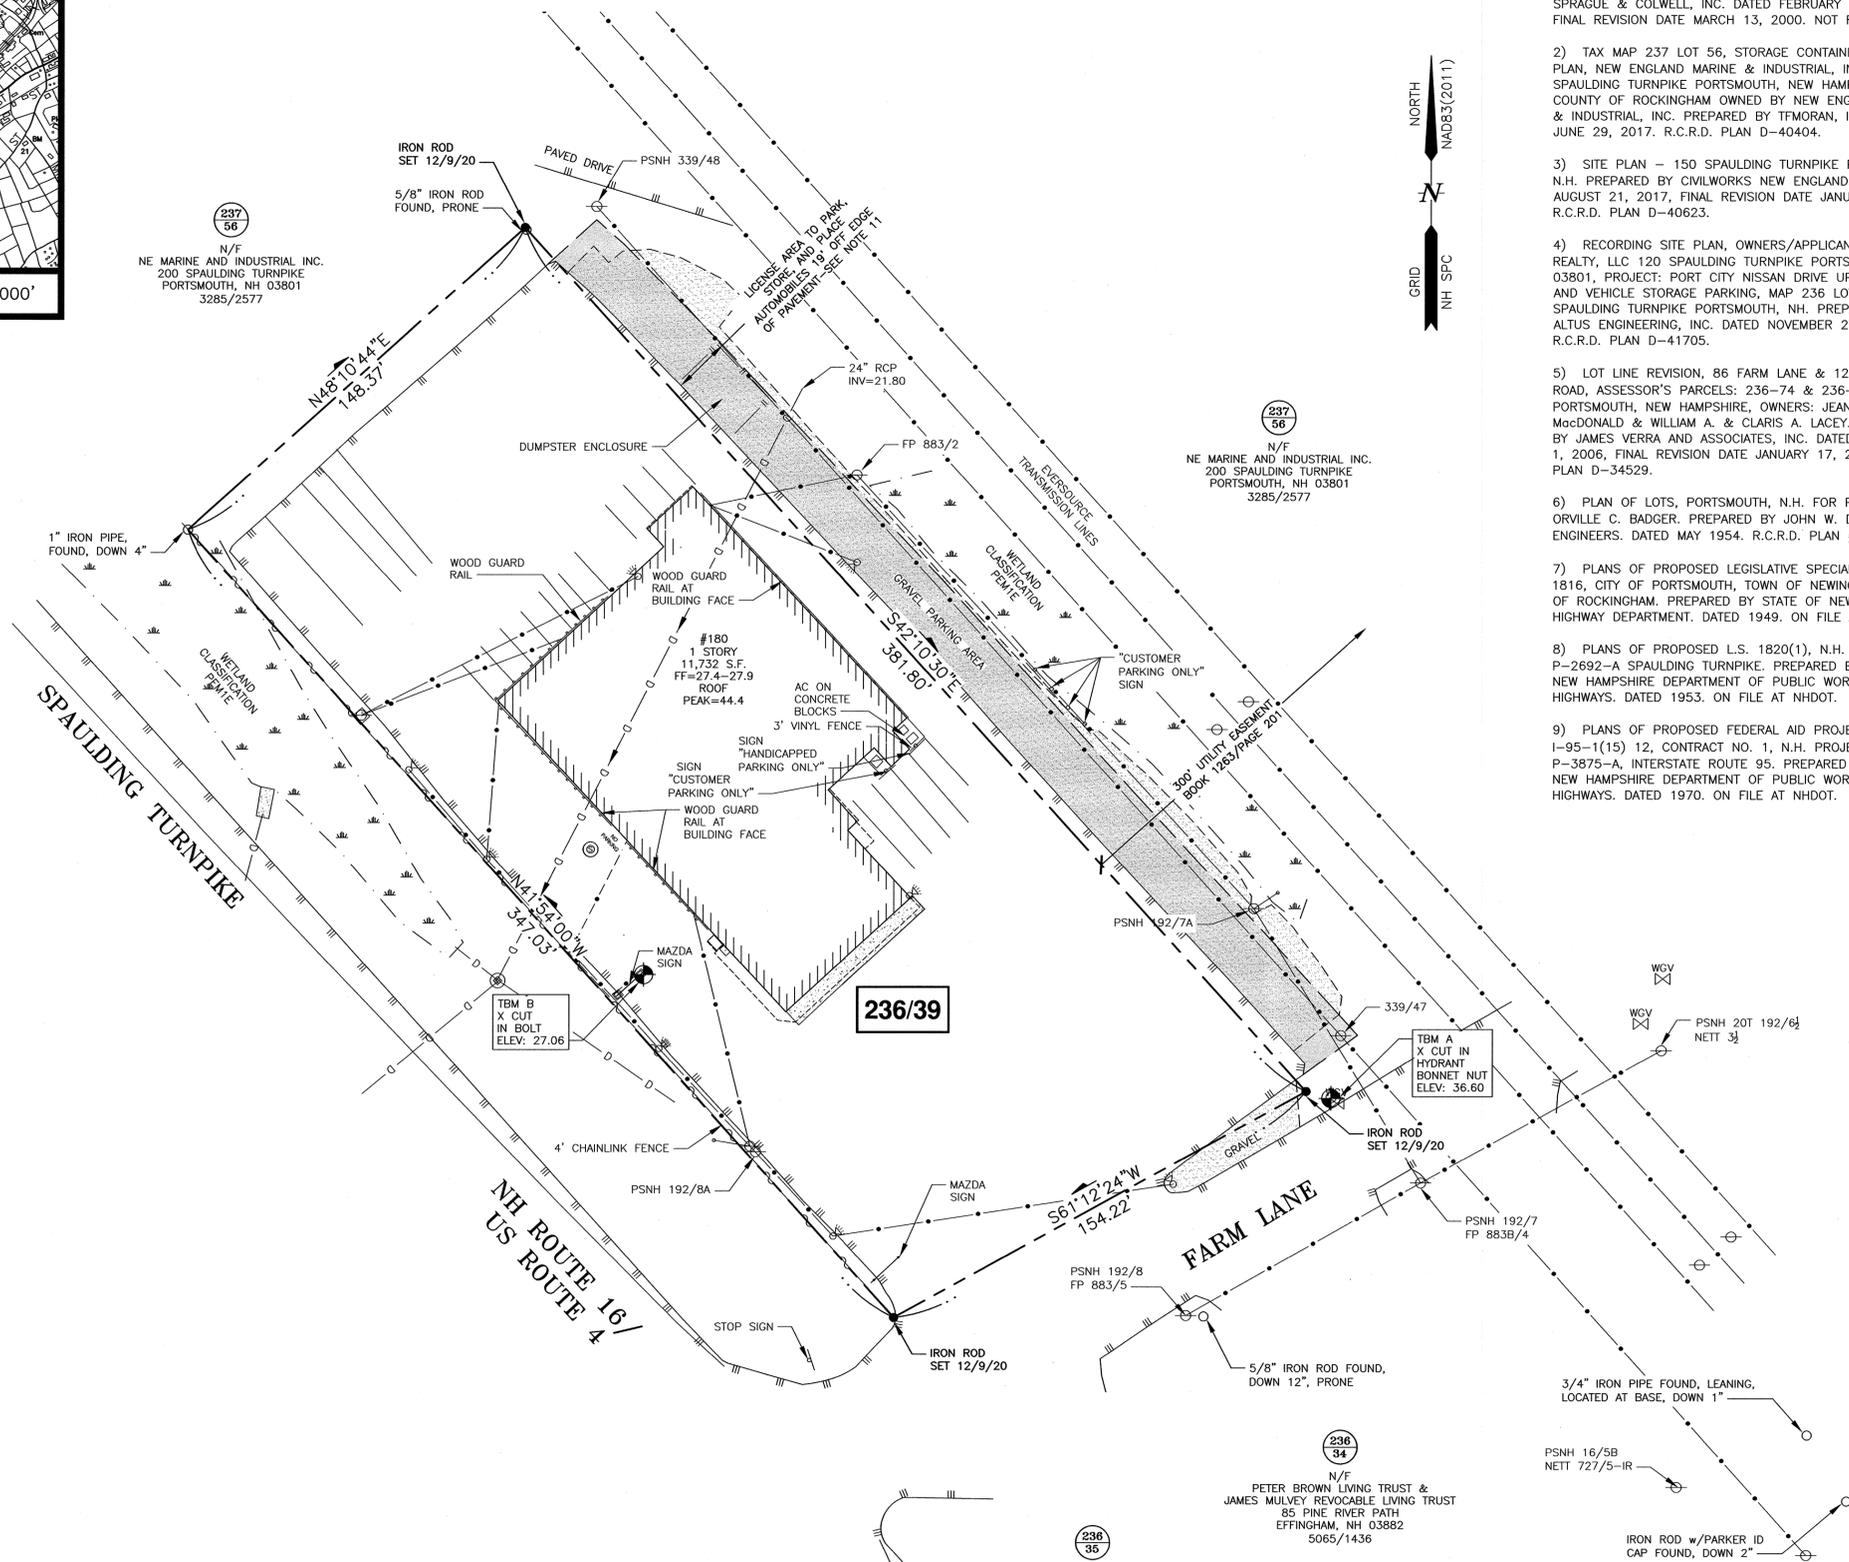

PLAN REFERENCES:

- 1) REQUEST FOR VARIANCE FOR SEACOAST VOLKSWAGEN - MAZDA, 180 SPAULDING TURNPIKE, COUNTY OF ROCKINGHAM, PORTSMOUTH, NH. PREPARED BY MILLETTE, SPRAGUE & COLWELL, INC. DATED FEBRUARY 14, 2000. FINAL REVISION DATE MARCH 13, 2000. NOT RECORDED.
- 2) TAX MAP 237 LOT 56, STORAGE CONTAINER LOCATION PLAN, NEW ENGLAND MARINE & INDUSTRIAL, INC., 200 SPAULDING TURNPIKE PORTSMOUTH, NEW HAMPSHIRE, COUNTY OF ROCKINGHAM OWNED BY NEW ENGLAND MARINE & INDUSTRIAL, INC. PREPARED BY TFMORAN, INC. DATED JUNE 29, 2017. R.C.R.D. PLAN D-40404.
- 3) SITE PLAN - 150 SPAULDING TURNPIKE PORTSMOUTH, N.H. PREPARED BY CIVILWORKS NEW ENGLAND. DATED AUGUST 21, 2017, FINAL REVISION DATE JANUARY 5, 2018. R.C.R.D. PLAN D-40623.
- 4) RECORDING SITE PLAN, OWNERS/APPLICANTS: TWO-WAY REALTY, LLC 120 SPAULDING TURNPIKE PORTSMOUTH, NH 03801, PROJECT: PORT CITY NISSAN DRIVE UP SERVICE BAY AND VEHICLE STORAGE PARKING, MAP 236 LOT 33, 120 SPAULDING TURNPIKE PORTSMOUTH, NH. PREPARED BY ALTUS ENGINEERING, INC. DATED NOVEMBER 27, 2018. R.C.R.D. PLAN D-41705.
- 5) LOT LINE REVISION, 86 FARM LANE & 125 MEADOW ROAD, ASSESSOR'S PARCELS: 236-74 & 236-68, PORTSMOUTH, NEW HAMPSHIRE, OWNERS: JEANNETTE MacDONALD & WILLIAM A. & CLARIS A. LACEY. PREPARED BY JAMES VERRA AND ASSOCIATES, INC. DATED DECEMBER 1, 2006, FINAL REVISION DATE JANUARY 17, 2007. R.C.R.D. PLAN D-34529.
- 6) PLAN OF LOTS, PORTSMOUTH, N.H. FOR PAUL C. & ORVILLE C. BADGER. PREPARED BY JOHN W. DURGIN CIVIL ENGINEERS. DATED MAY 1954. R.C.R.D. PLAN #02160.
- 7) PLANS OF PROPOSED LEGISLATIVE SPECIAL PROJECT LS 1816, CITY OF PORTSMOUTH, TOWN OF NEWINGTON, COUNTY OF ROCKINGHAM, PREPARED BY STATE OF NEW HAMPSHIRE HIGHWAY DEPARTMENT. DATED 1949. ON FILE AT NHDOT.
- 8) PLANS OF PROPOSED L.S. 1820(1), N.H. NO. P-2692-A SPAULDING TURNPIKE. PREPARED BY STATE OF NEW HAMPSHIRE DEPARTMENT OF PUBLIC WORKS AND HIGHWAYS. DATED 1953. ON FILE AT NHDOT.
- 9) PLANS OF PROPOSED FEDERAL AID PROJECT I-95-1(15) 12, CONTRACT NO. 1, N.H. PROJECT NO. P-3875-A, INTERSTATE ROUTE 95. PREPARED BY STATE OF NEW HAMPSHIRE DEPARTMENT OF PUBLIC WORKS AND HIGHWAYS. DATED 1970. ON FILE AT NHDOT.



AMBIT ENGINEERING, INC.
 Civil Engineers & Land Surveyors
 200 Griffin Road - Unit 3
 Portsmouth, N.H. 03801-7114
 Tel (603) 430-9282
 Fax (603) 436-2315

NOTES:

- 1) PARCEL IS SHOWN ON THE PORTSMOUTH ASSESSOR'S TAX MAP 236 AS LOT 39.
- 2) OWNERS OF RECORD: SPAULDING GROUP, LLC 180 SPAULDING TURNPIKE PORTSMOUTH, NH 03801 5886/1774
- 3) PARCEL IS NOT IN A FLOOD HAZARD ZONE AS SHOWN ON FIRM PANEL 33015C0260F. EFFECTIVE 1/29/2019.
- 4) EXISTING LOT AREA: 54,384 SF 1.2485 ACRES
- 5) PARCEL IS LOCATED IN THE GENERAL BUSINESS DISTRICT.
- 6) DIMENSIONAL REQUIREMENTS: MIN. LOT AREA: 43,560 SF FRONTAGE: 200 FT SETBACKS: FRONT: 30 FT SIDE: 30 FT REAR: 50 FT
 MAXIMUM STRUCTURE HEIGHT: 60 FT
 MAXIMUM BUILDING COVERAGE: 30%
 MINIMUM OPEN SPACE: 20%
- 7) THE PURPOSE OF THIS PLAN IS TO SHOW THE RESULT OF A STANDARD BOUNDARY SURVEY OF THE PARCEL.
- 8) VERTICAL DATUM IS NAVD88. BASIS OF VERTICAL DATUM IS REDUNDANT RTN GNSS OBSERVATIONS (±0.2').
- 9) PARCEL IS SUBJECT TO AN EASEMENT FOR INGRESS AND EGRESS FOR LAND NOW OF NEW ENGLAND MARINE AND INDUSTRIAL, INC. IN AS MUCH AS IT IS STILL IN EFFECT, LOCATION NOT PLOTTABLE. SEE R.C.R.D. 1566/184.
- 10) PARCEL IS SUBJECT TO A DRAINAGE AGREEMENT (R.C.R.D. 1564/229) & CONDITIONS AS MUCH AS THEY ARE STILL IN EFFECT (R.C.R.D. 1499/277).
- 11) LICENSE AREA FOR PARKING, STORAGE, AND PLACING AUTOMOBILES IS SHOWN PER PLAN REFERENCE 1 & R.C.R.D. PLAN D-40404. THE LICENSE AGREEMENT BETWEEN THE OWNERS OF PARCELS 237/56 AND 236/39 ALLOW FOR A 25' WIDE AREA TO PARK AND STORE VEHICLES. SEE CITY AGREEMENT TO LIMIT TO 19' FROM EDGE OF PAVEMENT.

"I CERTIFY THAT THIS PLAN WAS PREPARED UNDER MY DIRECT SUPERVISION, THAT IT IS THE RESULT OF A FIELD SURVEY BY THIS OFFICE AND HAS AN ACCURACY OF THE CLOSED TRAVERSE THAT EXCEEDS THE PRECISION OF 1:15,000."

PAUL A DOBBERSTEIN, LLS DATE 2/7/2021

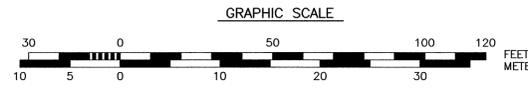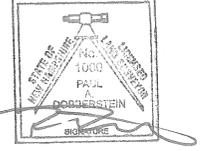

NO.	DESCRIPTION	DATE
1	ISSUED FOR APPROVAL	2/17/21
0	ISSUED FOR COMMENT	12/5/20

STANDARD BOUNDARY SURVEY
 TAX MAP 236 - LOT 39
 SEACOAST MAZDA
 FOR
 SPAULDING GROUP, LLC
 180 SPAULDING TURNPIKE
 CITY OF PORTSMOUTH
 COUNTY OF ROCKINGHAM
 STATE OF NEW HAMPSHIRE

IMPERVIOUS SURFACE AREAS (TO PROPERTY LINE)		
STRUCTURE	PRE-CONSTRUCTION IMPERVIOUS (S.F.)	POST-CONSTRUCTION IMPERVIOUS (S.F.)
BUILDING	11,732	14,144
PAVEMENT	40,360	37,652
GRAVEL	93	93
CONCRETE	344	600
CURBING	0	40
TOTAL	52,529	52,529
LOT SIZE	54,384	54,384
% LOT COVERAGE	96.6%	96.6%

- NOTES:**
- 1) PARCEL IS SHOWN ON THE PORTSMOUTH ASSESSOR'S TAX MAP 236 AS LOT 39.
 - 2) OWNERS OF RECORD:
 SPAULDING GROUP, LLC
 180 SPAULDING TURNPIKE
 PORTSMOUTH, NH 03801
 5886/1774
 PLAN REFERENCE 1
 - 3) PARCEL IS NOT IN A SPECIAL FLOOD HAZARD AREA AS SHOWN ON FIRM PANEL 33015C0260F. EFFECTIVE 1/29/2021.
 - 4) EXISTING LOT AREA:
 54,384 S.F.
 1.2485 ACRES
 - 5) PARCEL IS LOCATED IN THE GENERAL BUSINESS (GB) ZONING DISTRICT.
 - 6) DIMENSIONAL REQUIREMENTS:
 MIN. LOT AREA: 43,560 SF
 FRONTAGE: 200 FEET
 SETBACKS: FRONT 30 FEET
 SIDE 30 FEET
 REAR 50 FEET
 MAXIMUM STRUCTURE HEIGHT: 60 FEET
 MAXIMUM BUILDING COVERAGE: 30%
 MINIMUM OPEN SPACE: 20%
 - 7) THE PURPOSE OF THIS PLAN IS TO SHOW THE PROPOSED BUILDING ADDITION ON THE PROPERTY.
 - 8) VERTICAL DATUM IS NAVD88. BASIS OF VERTICAL DATUM IS REDUNDANT RTN GNSS OBSERVATIONS (±0.2').
 - 9) PROPOSED USE: SALES, LEASING, AND SERVICING OF VEHICLES.
 - 10) PARKING CALCULATION:
 SECTION 11.10 SALES OF VEHICLES
 15,852 S.F. GFA + 19,443 S.F. DISPLAY AREA.
 REQUIRED: 1 PER 600 S.F. GFA + 1 PER 2,000 S.F. OUTSIDE DISPLAY AREA.
 REQUIRED: 15,852/600 + 19,443 S.F./2,000
 27+10=37 SPACES REQUIRED.
 37 SPACES PROVIDED.
 - 11) THERE ARE 21 UNSTRIPED PARKING SPACES IN THE GRAVEL AREA.
 - 12) NO CHANGES TO EXTERIOR LIGHTING ARE PROPOSED. THERE WILL BE NO CHANGE TO THE CURRENT ON SITE PARKING OR DISPLAY AREA.

- PROJECT VARIANCES:**
- 10.531 TABLE OF DIMENSIONAL STANDARDS:
 REAR YARD: PROPOSED 15' SETBACK WHERE 50' IS REQUIRED.
 - 10.591 STRUCTURE SETBACK TO RESIDENTIAL DISTRICT:
 PROPOSED 15' SETBACK WHERE 100' IS REQUIRED.
 - 10.592.20 USE SETBACK FOR RESIDENTIAL DISTRICT:
 PROPOSED 0' SETBACK WHERE 200' IS REQUIRED.
 - 10.321 EXPANSION OF NONCONFORMING BUILDING:
 ITEMS (AS REQUIRED).
 - 10.1113.20 TO PERMIT OFF STREET PARKING SPACES IN THE FRONT YARD.
- APPROVED 6/15/21**


**BUILDING ADDITION
 SEACOAST MAZDA
 180 SPAULDING TURNPIKE
 PORTSMOUTH, N.H.**

NO.	DESCRIPTION	DATE
1	ISSUED FOR APPROVAL	7/19/21
0	ISSUED FOR COMMENT	2/17/21

REVISIONS

SCALE: 1"=30' DECEMBER 2020

SITE PLAN **C3**

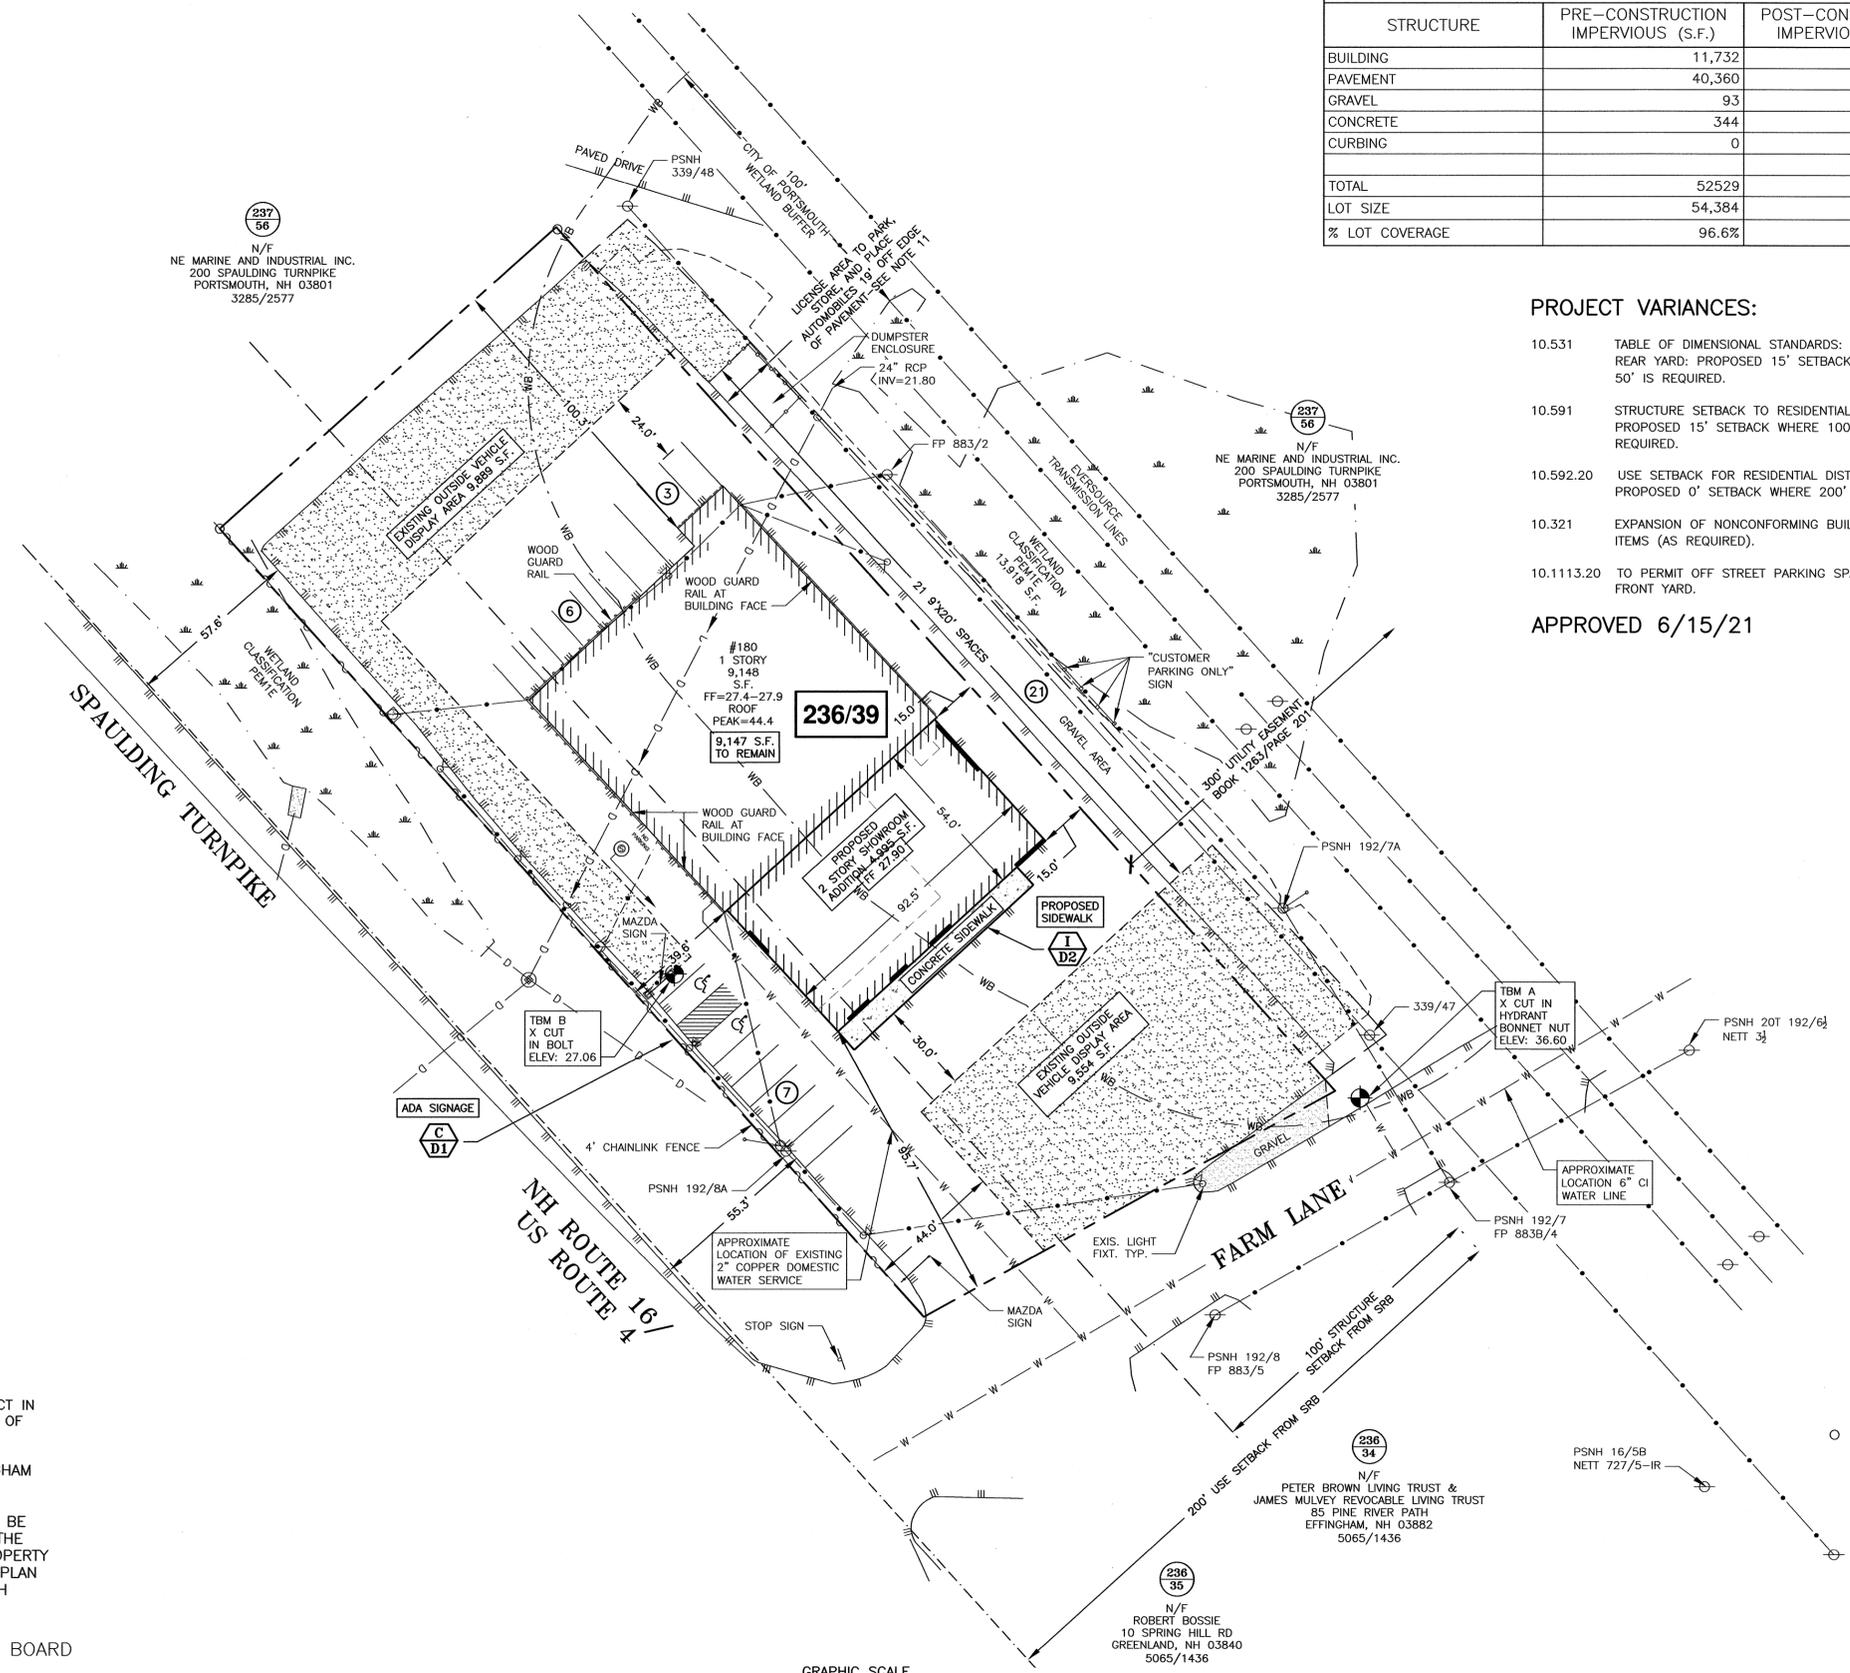


PORTSMOUTH APPROVAL CONDITIONS NOTE:
 ALL CONDITIONS ON THIS PLAN SET SHALL REMAIN IN EFFECT IN PERPETUITY PURSUANT TO THE REQUIREMENTS OF THE CITY OF PORTSMOUTH SITE PLAN REVIEW REGULATIONS.

THIS SITE PLAN SHALL BE RECORDED IN THE ROCKINGHAM COUNTY REGISTRY OF DEEDS.

ALL IMPROVEMENTS SHOWN ON THIS SITE PLAN SHALL BE CONSTRUCTED AND MAINTAINED IN ACCORDANCE WITH THE PLAN BY THE PROPERTY OWNER AND ALL FUTURE PROPERTY OWNERS. NO CHANGES SHALL BE MADE TO THIS SITE PLAN WITHOUT THE EXPRESS APPROVAL OF THE PORTSMOUTH PLANNING DIRECTOR.

APPROVED BY THE PORTSMOUTH PLANNING BOARD

CHAIRMAN _____ DATE _____

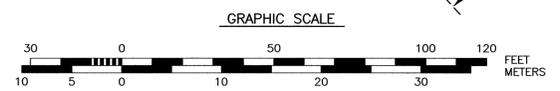

J:\03801\2021\1217\20210120.Dwg Plot: Plan & Seals\SitePlan.dwg Date: 2/20/21 10:58:48 AM





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Fax (603) 436-2315

NOTES:

- 1) THE CONTRACTOR SHALL NOTIFY DIG SAFE AT 1-888-DIG-SAFE (1-888-344-7233) AT LEAST 72 HOURS PRIOR TO COMMENCING ANY EXCAVATION ON PUBLIC OR PRIVATE PROPERTY WITHIN 100 FEET OF UNDERGROUND UTILITIES. THE EXCAVATOR IS RESPONSIBLE TO MAINTAIN MARKS. DIG SAFE TICKETS EXPIRE IN THIRTY DAYS.
- 2) UNDERGROUND UTILITY LOCATIONS ARE BASED UPON BEST AVAILABLE EVIDENCE AND ARE NOT FIELD VERIFIED. LOCATING AND PROTECTING ANY ABOVEGROUND OR UNDERGROUND UTILITIES IS THE SOLE RESPONSIBILITY OF THE CONTRACTOR AND/OR THE OWNER. UTILITY CONFLICTS SHOULD BE REPORTED AT ONCE TO THE DESIGN ENGINEER.
- 3) CONTRACTOR SHALL INSTALL AND MAINTAIN EROSION CONTROL MEASURES IN ACCORDANCE WITH THE "NEW HAMPSHIRE STORMWATER MANUAL, VOLUME 3, EROSION AND SEDIMENT CONTROLS DURING CONSTRUCTION. (NHDES DECEMBER 2008).
- 4) EXISTING SEWER CONNECTION IS VIA A FORCE MAIN TO GRAVITY SEWER MANHOLE IN FARM LANE (CITY UTILITY MAP). THE REVISED ADDITION WILL BE SERVICED INTERNALLY. MEP TO VERIFY EXISTING SEWAGE PUMP SYSTEM IS ADEQUATE FOR NEW BUILDING FIXTURE COUNT.

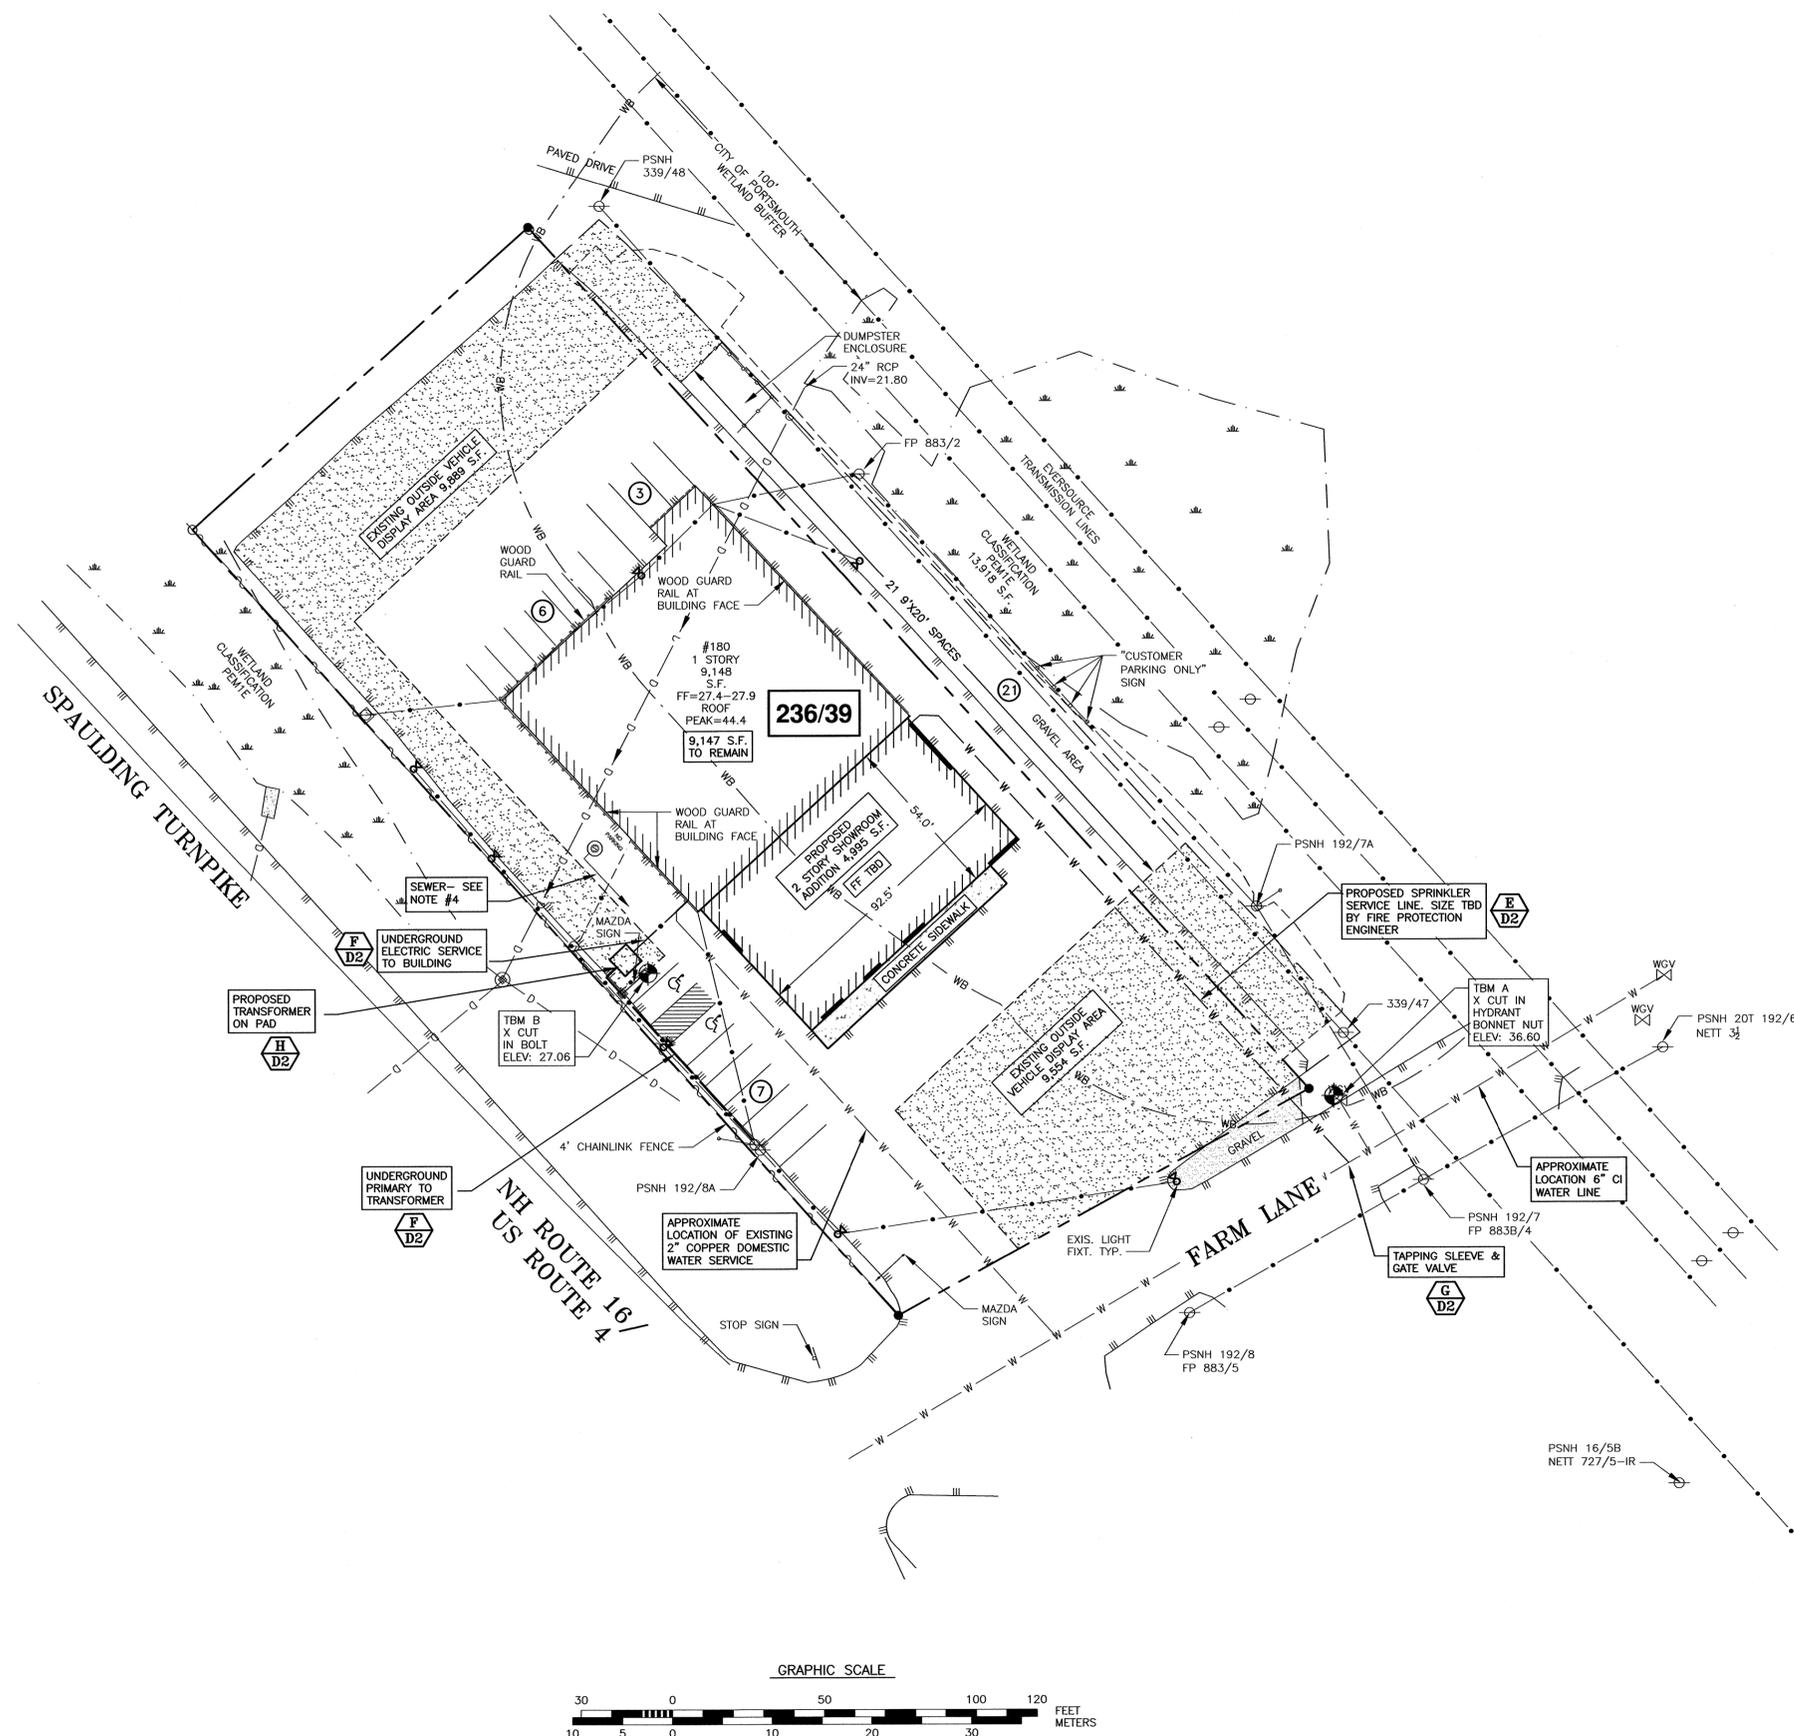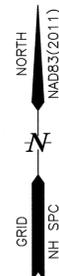

**BUILDING ADDITION
SEACOAST MAZDA
180 SPAULDING TURNPIKE
PORTSMOUTH, N.H.**


REVISIONS		
NO.	DESCRIPTION	DATE
0	ISSUED FOR APPROVAL	7/19/21



SCALE: 1"=30' DECEMBER 2020

**UTILITY
PLAN**

C4

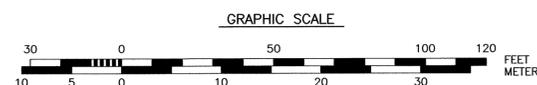




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- 3) CONTRACTOR SHALL INSTALL AND MAINTAIN EROSION CONTROL MEASURES IN ACCORDANCE WITH THE "NEW HAMPSHIRE STORMWATER MANUAL, VOLUME 3, EROSION AND SEDIMENT CONTROLS DURING CONSTRUCTION. (NHDES DECEMBER 2008).
- 4) CONTRACTOR SHALL COORDINATE SAWCUT AND PAVEMENT JOINT WITH DESIGN ENGINEER.

NORTH
NAD83(2011)
GRID
NH SPC



SPAULDING
TURNPIKE
NH ROUTE 16 /
US ROUTE 4

FARM LANE

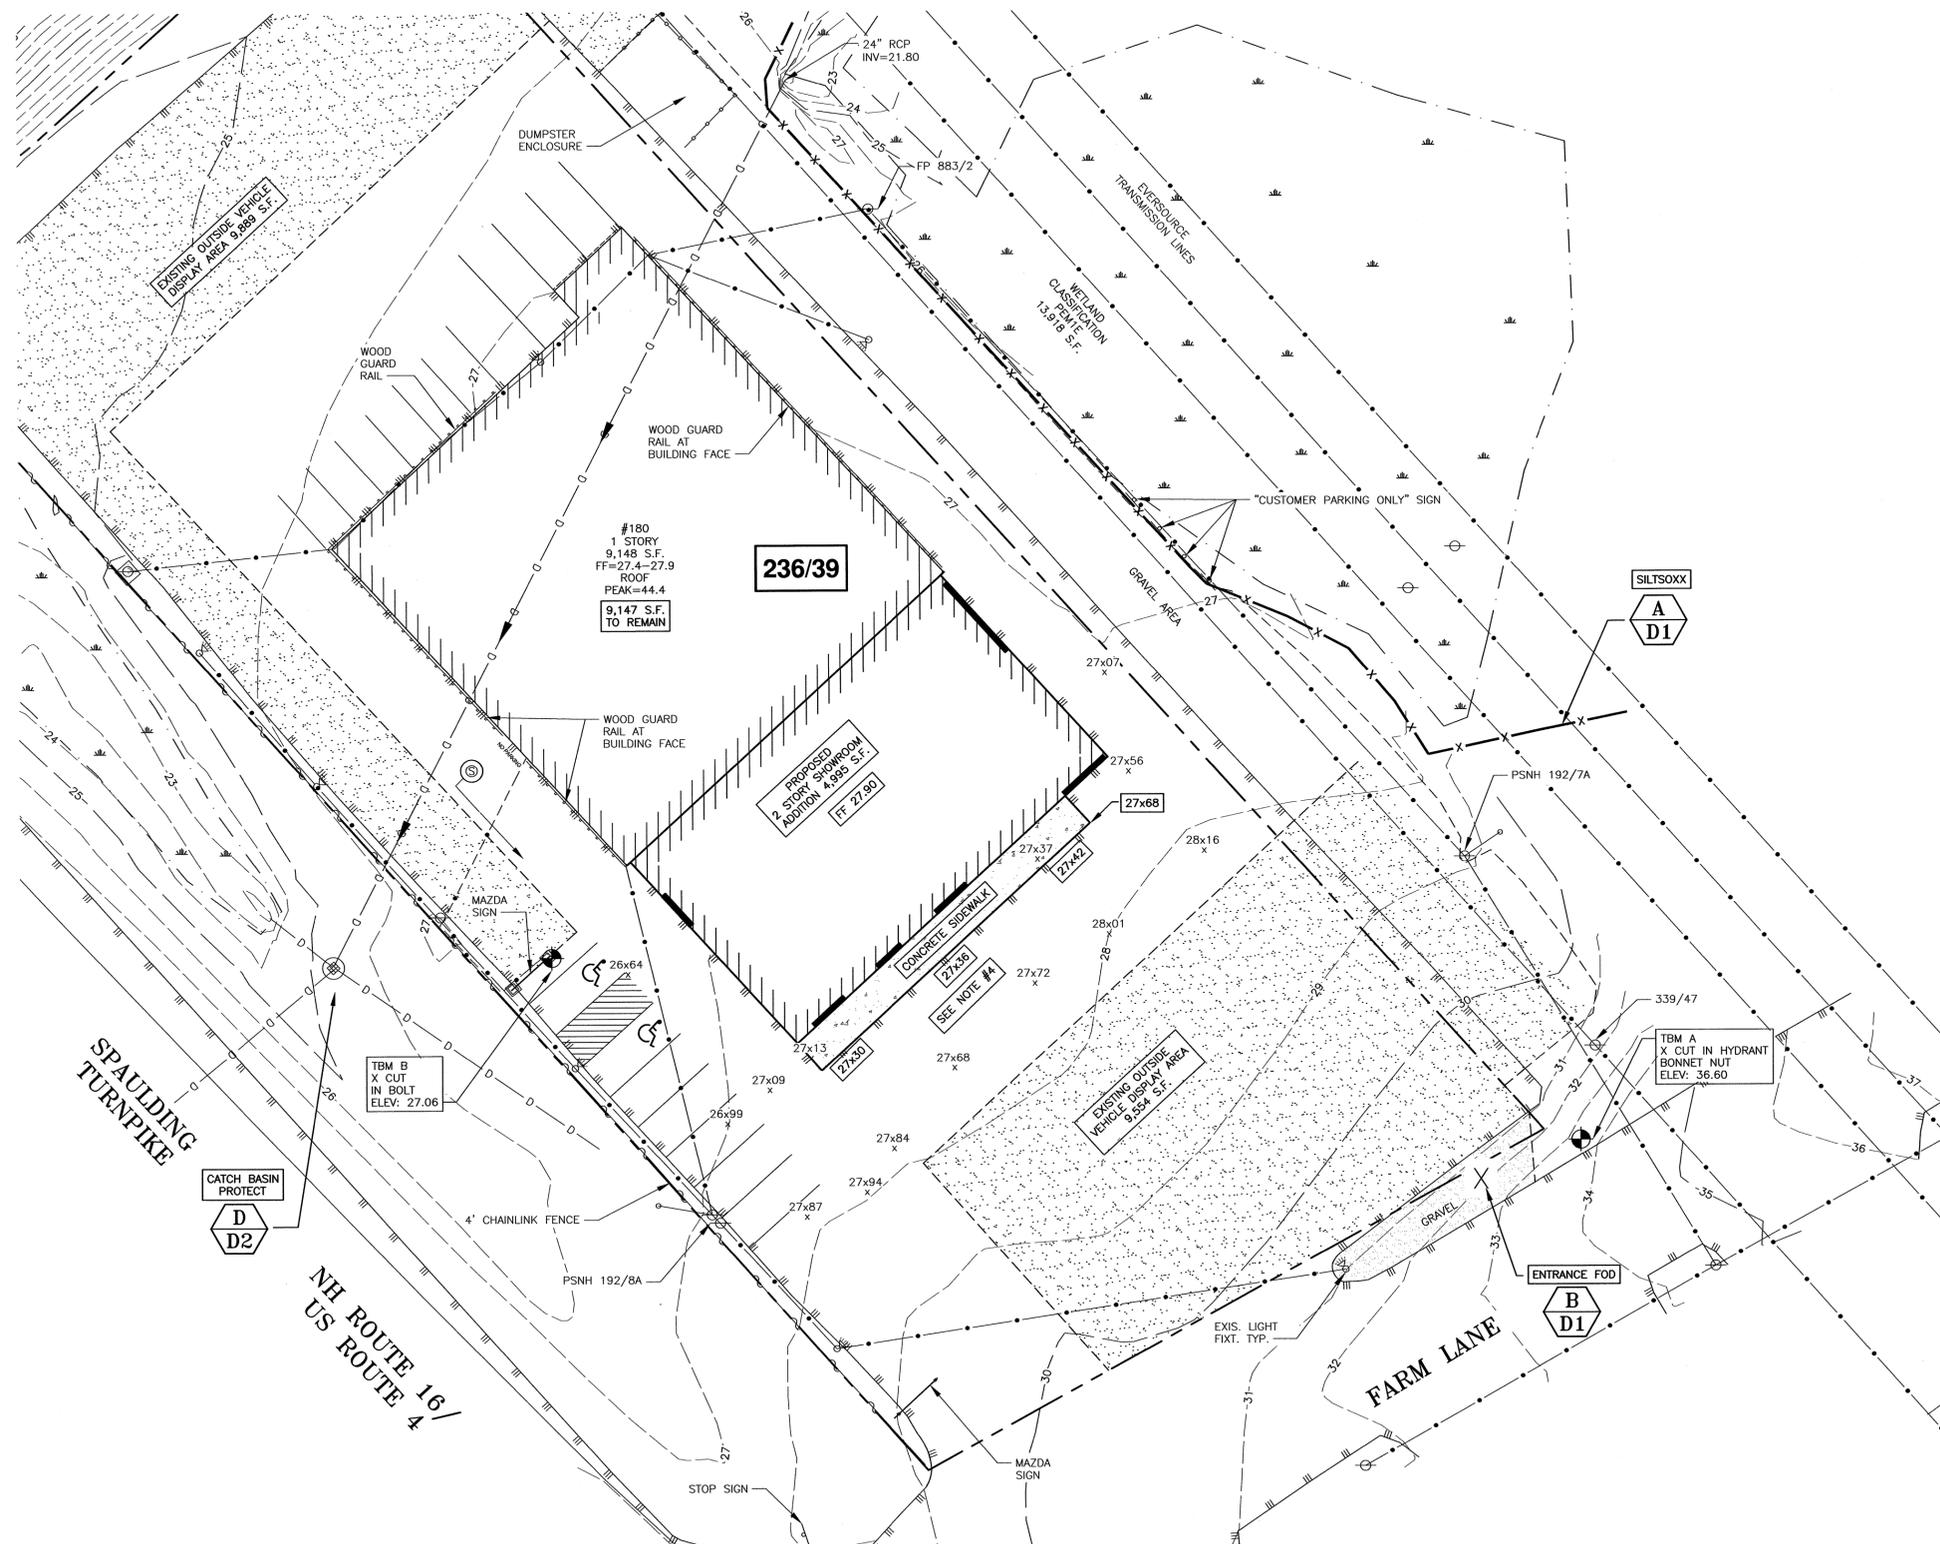236/39

#180
1 STORY
9,148 S.F.
FF=27.4-27.9
ROOF
PEAK=44.4
9,147 S.F.
TO REMAIN

PROPOSED
2 STORY SHOWROOM
ADDITION 9,990 S.F.
FF 27.90

CATCH BASIN
PROTECT
D
D2

ENTRANCE FOD
B
D1

SILTSOXX
A
D1

GRAPHIC SCALE



**BUILDING ADDITION
SEACOAST MAZDA
180 SPAULDING TURNPIKE
PORTSMOUTH, N.H.**

NO.	DESCRIPTION	DATE
0	ISSUED FOR APPROVAL	7/19/21
REVISIONS		



SCALE: 1' = 20' DECEMBER 2020

**GRADING
PLAN**

C5

EROSION CONTROL NOTES

CONSTRUCTION SEQUENCE

DO NOT BEGIN CONSTRUCTION UNTIL ALL LOCAL, STATE AND FEDERAL PERMITS HAVE BEEN APPLIED FOR AND RECEIVED.

IF REQUIRED THE CONTRACTOR SHALL OBTAIN AN NPDES PHASE II STORMWATER PERMIT AND SUBMIT A NOTICE OF INTENT (N.O.I) BEFORE BEGINNING CONSTRUCTION AND SHALL HAVE ON SITE A STORMWATER POLLUTION PREVENTION PLAN (S.W.P.P.P.) AVAILABLE FOR INSPECTION BY THE PERMITTING AUTHORITY DURING THE CONSTRUCTION. THE CONTRACTOR SHALL BE RESPONSIBLE FOR CARRYING OUT THE S.W.P.P.P. AND INSPECTING AND MAINTAINING ALL BMP'S CALLED FOR BY THE PLAN. THE CONTRACTOR SHALL SUBMIT A NOTICE OF TERMINATION (N.O.T.I) FORM TO THE REGIONAL EPA OFFICE WITHIN 30 DAYS OF FINAL STABILIZATION OF THE ENTIRE SITE OR TURNING OVER CONTROL OF THE SITE TO ANOTHER OPERATOR.

INSTALL PERIMETER CONTROLS, I.E., SILT/SOXX AND CATCH BASIN PROTECTION AROUND THE LIMITS OF DISTURBANCE BEFORE ANY EARTH MOVING OPERATIONS. THE USE OF HAYBALES IS NOT ALLOWED.

PLACE FODS AS NEEDED.

CUT AND GRUB ALL TREES, SHRUBS, SAPLINGS, BRUSH, VINES AND REMOVE OTHER DEBRIS AND RUBBISH AS REQUIRED. DEMOLISH BUILDINGS.

CONSTRUCT BUILDING ADDITION FOUNDATION.

LAYOUT AND INSTALL ALL BURIED UTILITIES AND SERVICES UP TO 10' OF THE PROPOSED BUILDING FOUNDATION. CAP AND MARK TERMINATIONS OR LOG SWING TIES.

CONSTRUCT BUILDING.

CONNECT UTILITIES.

CONSTRUCT SIDEWALK AND PAVEMENT.

AFTER BUILDINGS ARE COMPLETED, FINISH ANY LANDSCAPED WORK.

REMOVE TRAPPED SEDIMENTS FROM COLLECTION DEVICES AS APPROPRIATE, AND THEN REMOVE TEMPORARY EROSION CONTROL MEASURES UPON COMPLETION OF FINAL STABILIZATION OF THE SITE.

GENERAL CONSTRUCTION NOTES

THE EROSION CONTROL PROCEDURES SHALL CONFORM TO SECTION 645 OF THE "STANDARD SPECIFICATION FOR ROAD AND BRIDGE CONSTRUCTION" OF THE NHDOT, AND "STORM WATER MANAGEMENT AND EROSION AND SEDIMENT CONTROL HANDBOOK FOR URBAN AND DEVELOPING AREAS IN NEW HAMPSHIRE". THE PROJECT IS TO BE MANAGED IN A MANNER THAT MEETS THE REQUIREMENTS AND INTENT OF RSA 430:53 AND CHAPTER AGR 3800 RELATIVE TO INVASIVE SPECIES.

DURING CONSTRUCTION AND THEREAFTER, EROSION CONTROL MEASURES ARE TO BE IMPLEMENTED AS NOTED. THE SMALLEST PRACTICAL AREA OF LAND SHOULD BE EXPOSED AT ANY ONE TIME DURING DEVELOPMENT. NO DISTURBED AREA SHALL BE LEFT UNSTABILIZED FOR MORE THAN 45 DAYS.

ANY DISTURBED AREAS WHICH ARE TO BE LEFT TEMPORARILY, AND WHICH WILL BE REGRADED LATER DURING CONSTRUCTION SHALL BE MACHINE HAY MULCHED AND SEEDED WITH RYE GRASS TO PREVENT EROSION.

DUST CONTROL: IF TEMPORARY STABILIZATION PRACTICES, SUCH AS TEMPORARY VEGETATION AND MULCHING, DO NOT ADEQUATELY REDUCE DUST GENERATION, APPLICATION OF WATER OR CALCIUM CHLORIDE SHALL BE APPLIED IN ACCORDANCE WITH BEST MANAGEMENT PRACTICES.

SILT FENCES AND SILT/SOXX SHALL BE PERIODICALLY INSPECTED DURING THE LIFE OF THE PROJECT AND AFTER EACH STORM. ALL DAMAGED SILT FENCES AND SILT/SOXX SHALL BE REPAIRED. SEDIMENT DEPOSITS SHALL BE PERIODICALLY REMOVED AND DISPOSED IN A SECURED LOCATION.

AVOID THE USE OF FUTURE OPEN SPACES (LOAM AND SEED AREAS) WHEREVER POSSIBLE DURING CONSTRUCTION. CONSTRUCTION TRAFFIC SHALL USE THE ROADBEDS OF FUTURE ACCESS DRIVES AND PARKING AREAS.

ADDITIONAL TOPSOIL REQUIRED FOR THE ESTABLISHMENT OF VEGETATION SHALL BE STOCKPILED IN AMOUNTS NECESSARY TO COMPLETE FINISHED GRADING OF ALL EXPOSED AREAS--CONSTRUCT SILT FENCE OR SILT/SOXX AROUND TOPSOIL STOCKPILE.

AREAS TO BE FILLED SHALL BE CLEARED, GRUBBED AND STRIPPED OF TOPSOIL TO REMOVE TREES, VEGETATION, ROOTS OR OTHER OBJECTIONABLE MATERIAL. STUMPS SHALL BE DISPOSED OF IN AN APPROVED FACILITY.

ALL FILLS SHALL BE PLACED AND COMPACTED TO REDUCE EROSION, SLIPPAGE, SETTLEMENT, SUBSIDENCE OR OTHER RELATED PROBLEMS.

ALL NON-STRUCTURAL, SITE-FILL SHALL BE PLACED AND COMPACTED TO 90% MODIFIED PROCTOR DENSITY IN LAYERS NOT EXCEEDING 18 INCHES IN THICKNESS UNLESS OTHERWISE NOTED.

FROZEN MATERIAL OR SOFT, MUCKY OR HIGHLY COMPRESSIBLE MATERIAL, TRASH, WOODY DEBRIS, LEAVES, BRUSH OR ANY DELETERIOUS MATTER SHALL NOT BE INCORPORATED INTO FILLS.

FILL MATERIAL SHALL NOT BE PLACED ON FROZEN FOUNDATION SUBGRADE.

DURING CONSTRUCTION AND UNTIL ALL DEVELOPED AREAS ARE FULLY STABILIZED, ALL EROSION CONTROL MEASURES SHALL BE INSPECTED WEEKLY AND AFTER EACH ONE HALF INCH OF RAINFALL.

THE CONTRACTOR SHALL MODIFY OR ADD EROSION CONTROL MEASURES AS NECESSARY TO ACCOMMODATE PROJECT CONSTRUCTION.

ALL ROADWAYS AND PARKING AREAS SHALL BE STABILIZED WITHIN 72 HOURS OF ACHIEVING FINISHED GRADE. ALL CUT AND FILL SLOPES SHALL BE SEEDED/LOAMED WITHIN 72 HOURS OF ACHIEVING FINISHED GRADE.

AN AREA SHALL BE CONSIDERED STABLE IF ONE OF THE FOLLOWING HAS OCCURRED:

- BASE COURSE GRAVELS HAVE BEEN INSTALLED ON AREAS TO BE PAVED
- A MINIMUM OF 85% VEGETATED GROWTH HAS BEEN ESTABLISHED
- A MINIMUM OF 3 INCHES OF NON-EROSIVE MATERIAL SUCH AS STONE OR RIPRAP HAS BEEN INSTALLED
- EROSION CONTROL BLANKETS HAVE BEEN INSTALLED

VEGETATIVE PRACTICE

FOR PERMANENT MEASURES AND PLANTINGS:

LIMESTONE SHALL BE THOROUGHLY INCORPORATED INTO THE LOAM LAYER AT A RATE OF 2 TONS PER ACRE.

FERTILIZER SHALL BE SPREAD ON THE TOP LAYER OF LOAM AND WORKED INTO THE SURFACE. FERTILIZER APPLICATION RATE SHALL BE 500 POUNDS PER ACRE OF 10-20-20 FERTILIZER.

SEED SHALL BE SOWN AT THE RATES SHOWN IN THE TABLE BELOW. IMMEDIATELY BEFORE SEEDING, THE SOIL SHALL BE LIGHTLY RAKED. ONE HALF THE SEED SHALL BE SOWN IN ONE DIRECTION AND THE OTHER HALF AT RIGHT ANGLES TO THE ORIGINAL DIRECTION. IT SHALL BE LIGHTLY RAKED INTO THE SOIL TO A DEPTH NOT OVER 1/4 INCH AND ROLLED WITH A HAND ROLLER WEIGHING NOT OVER 100 POUNDS PER LINEAR FOOT OF WIDTH. HAY MULCH SHALL BE APPLIED IMMEDIATELY AFTER SEEDING AT A RATE OF 1.5 TO 2 TONS PER ACRE, AND SHALL BE HELD IN PLACE USING APPROPRIATE TECHNIQUES FROM THE EROSION AND SEDIMENT CONTROL HANDBOOK.

THE SURFACE SHALL BE WATERED AND KEPT MOIST WITH A FINE SPRAY AS REQUIRED, WITHOUT WASHING AWAY THE SOIL, UNTIL THE GRASS IS WELL ESTABLISHED. ANY AREAS WHICH ARE NOT SATISFACTORILY COVERED SHALL BE RESEED, AND ALL NOXIOUS WEEDS REMOVED.

A GRASS SEED MIXTURE CONTAINING THE FOLLOWING SEED REQUIREMENTS SHALL BE:

GENERAL COVER	PROPORTION	SEEDING RATE
CREeping RED FESCUE	50%	100 LBS/ACRE
KENTUCKY BLUEGRASS	50%	
SLOPE SEED (USED ON ALL SLOPES GREATER THAN OR EQUAL TO 3:1)		
CREeping RED FESCUE	42%	
TALL FESCUE	42%	48 LBS/ACRE
BIRDSFOOT TREFLOIL	16%	

IN NO CASE SHALL THE WEED CONTENT EXCEED ONE PERCENT BY WEIGHT. ALL SEED SHALL COMPLY WITH APPLICABLE STATE AND FEDERAL SEED LAWS.

FOR TEMPORARY PROTECTION OF DISTURBED AREAS:
MULCHING AND SEEDING SHALL BE APPLIED AT THE FOLLOWING RATES:
PERENNIAL RYE: 0.7 LBS/1,000 S.F.
MULCH: 1.5 TONS/ACRE

MAINTENANCE AND PROTECTION

THE CONTRACTOR SHALL MAINTAIN ALL LOAM & SEED AREAS UNTIL FINAL ACCEPTANCE AT THE COMPLETION OF THE CONTRACT. MAINTENANCE SHALL INCLUDE WATERING, WEEDING, REMOVAL OF STONES AND OTHER FOREIGN OBJECTS OVER 1/2 INCHES IN DIAMETER WHICH MAY APPEAR AND THE FIRST TWO (2) CUTTINGS OF GRASS NO CLOSER THAN TEN (10) DAYS APART. THE FIRST CUTTING SHALL BE ACCOMPLISHED WHEN THE GRASS IS FROM 2 1/2 TO 3 INCHES HIGH. ALL BARE AND DEAD SPOTS WHICH BECOME APPARENT SHALL BE PROPERLY PREPARED, LIMED AND FERTILIZED, AND RESEED BY THE CONTRACTOR AT HIS EXPENSE AS MANY TIMES AS NECESSARY TO SECURE GOOD GROWTH. THE ENTIRE AREA SHALL BE MAINTAINED, WATERED AND CUT UNTIL ACCEPTANCE OF THE LAWN BY THE OWNER'S REPRESENTATIVE.

THE CONTRACTOR SHALL TAKE WHATEVER MEASURES ARE NECESSARY TO PROTECT THE GRASS WHILE IT IS DEVELOPING.

TO BE ACCEPTABLE, SEEDED AREAS SHALL CONSIST OF A UNIFORM STAND OF AT LEAST 90 PERCENT ESTABLISHED PERMANENT GRASS SPECIES, WITH UNIFORM COUNT OF AT LEAST 100 PLANTS PER SQUARE FOOT.

SEEDED AREAS WILL BE FERTILIZED AND RESEED AS NECESSARY TO INSURE VEGETATIVE ESTABLISHMENT.

THE SWALES WILL BE CHECKED WEEKLY AND REPAIRED WHEN NECESSARY UNTIL ADEQUATE VEGETATION IS ESTABLISHED.

THE SILT FENCE OR SILT/SOXX BARRIER SHALL BE CHECKED AFTER EACH RAINFALL AND AT LEAST DAILY DURING PROLONGED RAINFALL.



SILT FENCING AND SILT/SOXX SHALL BE REMOVED ONCE VEGETATION IS ESTABLISHED, AND DISTURBED AREAS RESULTING FROM SILT FENCE AND SILT/SOXX REMOVAL SHALL BE PERMANENTLY SEEDED.

WINTER NOTES

ALL PROPOSED VEGETATED AREAS WHICH DO NOT EXHIBIT A MINIMUM OF 85% VEGETATIVE GROWTH BY OCTOBER 15TH, OR WHICH ARE DISTURBED AFTER OCTOBER 15TH, SHALL BE STABILIZED BY SEEDING AND INSTALLING EROSION CONTROL BLANKETS ON SLOPES GREATER THAN 3:1, AND SEEDING AND PLACING 3 TO 4 TONS OF MULCH PER ACRE, SECURED WITH ANCHORED NETTING, ELSEWHERE. THE INSTALLATION OF EROSION CONTROL BLANKETS OR MULCH AND NETTING SHALL NOT OCCUR OVER ACCUMULATED SNOW OR ON FROZEN GROUND AND SHALL BE COMPLETED IN ADVANCE OF THAW OR SPRING MELT EVENTS.

ALL DITCHES OR SWALES WHICH DO NOT EXHIBIT A MINIMUM OF 85% VEGETATIVE GROWTH BY OCTOBER 15TH, OR WHICH ARE DISTURBED AFTER OCTOBER 15TH, SHALL BE STABILIZED TEMPORARILY WITH STONE OR EROSION CONTROL BLANKETS APPROPRIATE FOR THE DESIGN FLOW CONDITIONS.

AFTER NOVEMBER 15TH, INCOMPLETE ROAD OR PARKING SURFACES, WHERE WORK HAS STOPPED FOR THE WINTER SEASON, SHALL BE PROTECTED WITH A MINIMUM OF 3 INCHES OF CRUSHED GRAVEL PER NHDOT ITEM 304.3.

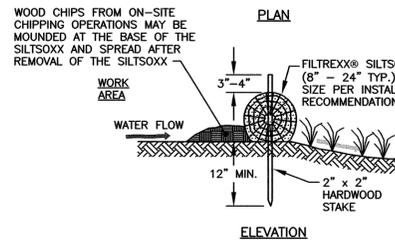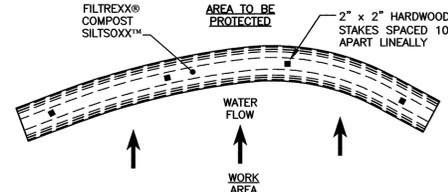

- NOTES:
1. ALL MATERIAL TO MEET FILTREXX SPECIFICATIONS.
 2. FILTREXX SYSTEM SHALL BE INSTALLED BY A CERTIFIED FILTREXX INSTALLER.
 3. THE CONTRACTOR SHALL MAINTAIN THE COMPOST FILTRATION SYSTEM IN A FUNCTIONAL CONDITION AT ALL TIMES. IT WILL BE ROUTINELY INSPECTED AND REPAIRED WHEN REQUIRED.
 4. SILT/SOXX DEPICTED IS FOR MINIMUM SLOPES, GREATER SLOPES MAY REQUIRE ADDITIONAL PLACEMENTS.
 5. THE COMPOST FILTER MATERIAL WILL BE DISPERSED ON SITE WHEN NO LONGER REQUIRED, AS DETERMINED BY THE ENGINEER.




FODS TRACKOUT CONTROL SYSTEM

INSTALLATION:

THE PURPOSE AND DESIGN OF THE FODS TRACKOUT CONTROL SYSTEM IS TO EFFECTIVELY REMOVE MOST SEDIMENT FROM VEHICLE TIRES AS THEY EXIT A DISTURBED LAND AREA ONTO A PAVED STREET. THIS MANUAL IS A PLATFORM FROM WHICH TO INSTALL A FODS TRACKOUT CONTROL SYSTEM. (NOTE: THIS IS NOT A ONE SIZE FITS ALL GUIDE.) THE INSTALLATION MAY NEED TO BE MODIFIED TO MEET THE EXISTING CONDITIONS, EXPECTATIONS, OR DEMANDS OF A PARTICULAR SITE. THIS IS A GUIDELINE. ULTIMATELY THE FODS TRACKOUT CONTROL SYSTEM SHOULD BE INSTALLED SAFELY WITH PROPER ANCHORING AND SIGNS PLACED AT THE ENTRANCE AND EXIT TO CAUTION USERS AND OTHERS.

KEY NOTES:

- A. FODS TRACKOUT CONTROL SYSTEM MAT.
- B. FODS SAFETY SIGN.
- C. ANCHOR POINT.
- D. SILT OR ORANGE CONSTRUCTION FENCE.

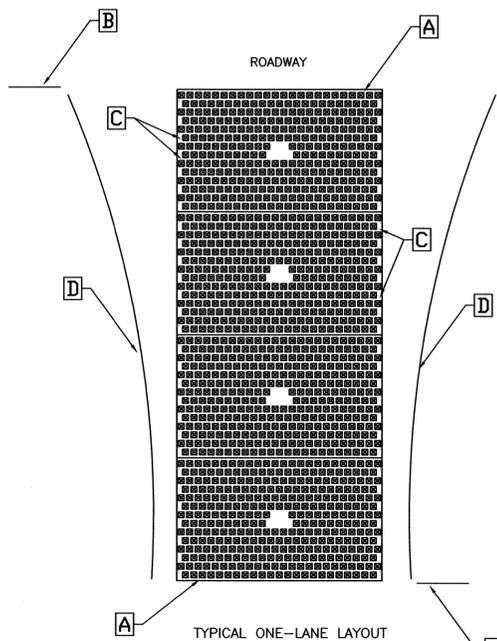

R7-8a
12" x 18"
SIGN ON POST


EACH SPACE SHALL HAVE THIS SIGN DISPLAYED PER ADA CODE

SIGNAGE

LEGEND SYMBOL



PROVIDE SIGN (PER ADA CODE) AT EACH HANDICAP ACCESSIBLE SPACE

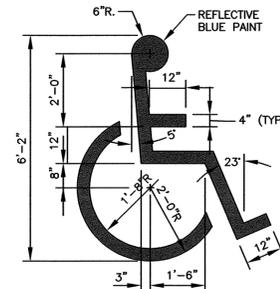



NOTES:

- 1) SYMBOL TO BE PAINTED IN ALL HANDICAPPED SPACES.
- 2) SYMBOL, PAINT AND SIGNAGE TO CONFORM TO AMERICANS WITH DISABILITIES ACT (ADA).
- 3) ALL VAN ACCESSIBLE SPACES SHALL HAVE "VAN ACCESSIBLE" PLATE INSTALLED ON SIGN POST BELOW HANDICAP SIGN.

HANDICAP ACCESSIBLE SYMBOL



HANDICAP PARKING DETAIL

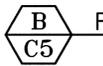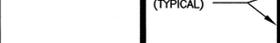

FODS (USE AS REQUIRED)

NTS




AMBIT ENGINEERING, INC.
Civil Engineers & Land Surveyors
200 Griffin Road - Unit 3
Portsmouth, N.H. 03801-7114
Tel (603) 430-8282
Fax (603) 436-2915

NOTES:

- 1) THE CONTRACTOR SHALL NOTIFY DIG SAFE AT 1-888-DIG-SAFE (1-888-344-7233) AT LEAST 72 HOURS PRIOR TO COMMENCING ANY EXCAVATION ON PUBLIC OR PRIVATE PROPERTY.
- 2) UNDERGROUND UTILITY LOCATIONS ARE BASED UPON BEST AVAILABLE EVIDENCE AND ARE NOT FIELD VERIFIED. LOCATING AND PROTECTING ANY ABOVEGROUND OR UNDERGROUND UTILITIES IS THE SOLE RESPONSIBILITY OF THE CONTRACTOR AND/OR THE OWNER. UTILITY CONFLICTS SHOULD BE REPORTED AT ONCE TO THE DESIGN ENGINEER.
- 3) CONTRACTOR SHALL INSTALL AND MAINTAIN EROSION CONTROL MEASURES IN ACCORDANCE WITH THE "NEW HAMPSHIRE STORMWATER MANUAL, VOLUME 3, EROSION AND SEDIMENT CONTROLS DURING CONSTRUCTION. (NHDES DECEMBER 2008).

BUILDING ADDITION SEACOAST MAZDA 180 SPAULDING TURNPIKE PORTSMOUTH, N.H.

NO.	DESCRIPTION	DATE
0	ISSUED FOR APPROVAL	7/19/21
REVISIONS		

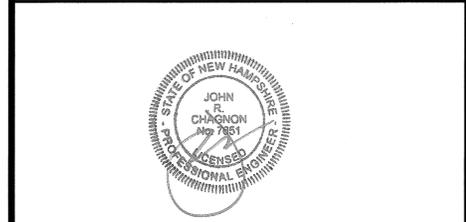


SCALE: AS SHOWN DECEMBER 2020

EROSION PROTECTION NOTES AND DETAILS

D1


- NOTES:**
- 1) THE CONTRACTOR SHALL NOTIFY DIG SAFE AT 1-888-DIG-SAFE (1-888-344-7233) AT LEAST 72 HOURS PRIOR TO COMMENCING ANY EXCAVATION ON PUBLIC OR PRIVATE PROPERTY.
 - 2) UNDERGROUND UTILITY LOCATIONS ARE BASED UPON BEST AVAILABLE EVIDENCE AND ARE NOT FIELD VERIFIED. LOCATING AND PROTECTING ANY ABOVEGROUND OR UNDERGROUND UTILITIES IS THE SOLE RESPONSIBILITY OF THE CONTRACTOR AND/OR THE OWNER. UTILITY CONFLICTS SHOULD BE REPORTED AT ONCE TO THE DESIGN ENGINEER.
 - 3) CONTRACTOR SHALL INSTALL AND MAINTAIN EROSION CONTROL MEASURES IN ACCORDANCE WITH THE "NEW HAMPSHIRE STORMWATER MANUAL, VOLUME 3, EROSION AND SEDIMENT CONTROLS DURING CONSTRUCTION. (NHDES DECEMBER 2008).

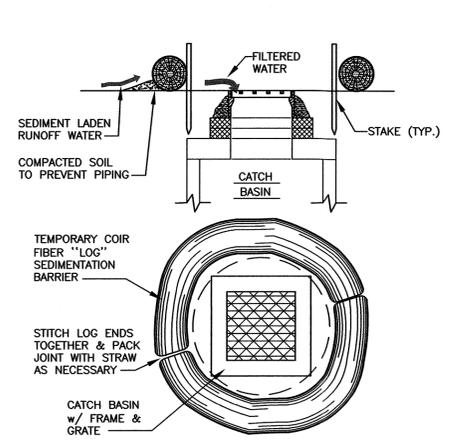

"SILT LOG" BARRIER AT CATCH BASIN INLET
 (AS NEEDED) NTS

NOTE:

1. PRIOR TO INSTALLATION, SILT LOGS SHALL BE KEPT DRY AND STORED IN THEIR ORIGINAL WRAPPING.
2. MINIMUM CROSS SECTIONAL DIAMETER OF SILT LOGS: 12".
3. SILT LOGS MAY BE CUT AND RE-STITCHED AS NEEDED PER MANUFACTURERS RECOMMENDATIONS.
4. SILT LOGS SHALL BE INSPECTED AFTER EACH STORM EVENT.
5. REMOVE ACCUMULATED SILT WHEN DEPTH REACHES ONE HALF OF SILT LOG DIAMETER.
6. IF LOGS ARE TOO STIFF TO BEND AROUND CATCH BASIN INLET, THEY MAY BE CUT AND LAID FLAT.

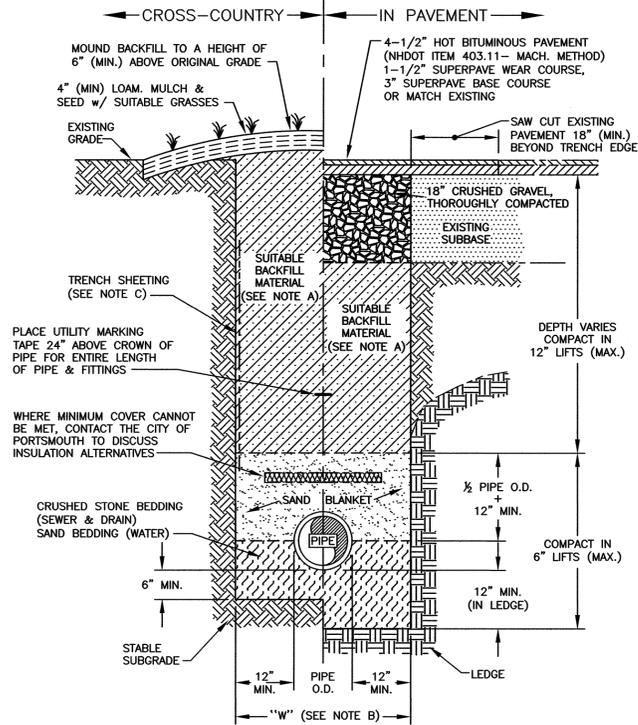

E TYPICAL PIPE TRENCH
 NTS

TRENCH NOTES:

A) TRENCH BACKFILL:
 - IN PAVED AREAS, SUITABLE MATERIAL FOR TRENCH BACKFILL SHALL BE THE NATURAL MATERIAL EXCAVATED DURING CONSTRUCTION, BUT SHALL EXCLUDE DEBRIS, PIECES OF PAVEMENT, ORGANIC MATTER, TOP SOIL, ALL WET OR SOFT MUCK, PEAT OR CLAY, ALL EXCAVATED LEDGE MATERIAL, AND ALL ROCKS OVER SIX INCHES IN LARGEST DIMENSION, OR ANY MATERIALS DEEMED TO BE UNACCEPTABLE BY THE ENGINEER.

- IN CROSS-COUNTRY CONSTRUCTION, SUITABLE MATERIAL SHALL BE AS DESCRIBED ABOVE, EXCEPT THAT THE ENGINEER MAY PERMIT THE USE OF TOP SOIL, LOAM, MUCK OR PEAT, IF HE IS SATISFIED THAT THE COMPLETED CONSTRUCTION WILL BE ENTIRELY STABLE.


B) "W" = MAXIMUM ALLOWABLE TRENCH WIDTH TO A PLANE 12 INCHES ABOVE THE PIPE. FOR PIPES 15 INCHES NOMINAL DIAMETER OR LESS, W SHALL BE NO MORE THAN 36 INCHES. FOR PIPES GREATER THAN 15 INCHES NOMINAL DIAMETER, W SHALL BE 24 INCHES PLUS PIPE O.D..

C) TRENCH SHEETING:
 IF REQUIRED, WHERE SHEETING IS PLACED ALONGSIDE THE PIPE AND EXTENDS BELOW MID-DIAMETER, IT SHALL BE CUT OFF AND LEFT IN PLACE TO AN ELEVATION NOT LESS THAN 1 FOOT ABOVE THE TOP OF THE PIPE. WHERE SHEETING IS ORDERED BY THE ENGINEER TO BE LEFT IN PLACE, IT SHALL BE CUT OFF AT LEAST 3 FEET BELOW FINISHED GRADE, BUT NOT LESS THAN 1 FOOT ABOVE THE TOP OF THE PIPE.



D) MINIMUM PIPE COVER FOR UTILITY MAINS (UNLESS GOVERNED BY OTHER CODES):
 6" MINIMUM FOR SEWER (IN PAVEMENT)
 4" MINIMUM FOR SEWER (CROSS COUNTRY)
 3" MINIMUM FOR STORMWATER DRAINS
 5" MINIMUM FOR WATER MAINS

E) ALL PAVEMENT CUTS SHALL BE REPAIRED BY THE INFRARED HEAT METHOD.

- NOTES:**
- 1) ALL CONDUIT TO BE U.L. LISTED, SCH. 80 UNDER ALL TRAVEL WAYS, & SCHED. 40 FOR THE REMAINDER.
 - 2) NORMAL CONDUIT SIZES FOR PSNH ARE 3 INCH FOR SINGLE PHASE PRIMARY AND SECONDARY VOLTAGE CABLES, 4 INCH FOR THREE PHASE SECONDARY, AND 5 INCH FOR THREE PHASE PRIMARY.
 - 3) ALL WORK TO CONFORM TO THE NATIONAL ELECTRICAL CODE (LATEST REVISION)
 - 4) INSTALL A 200# PULL ROPE FOR EACH CONDUIT
 - 5) VERIFY ALL CONDUIT SPECIFICATIONS WITH UTILITY COMPANY'S PRIOR TO ANY CONSTRUCTION.

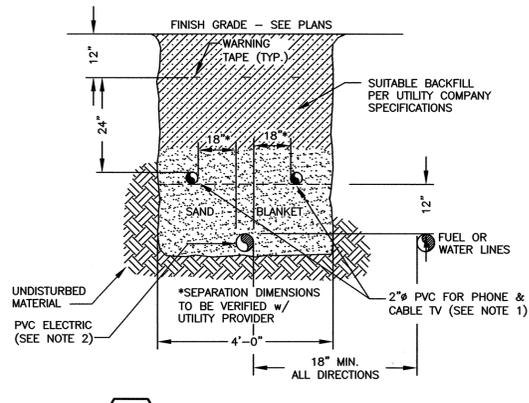


F BURIED ELEC/COMM CABLE
 NTS

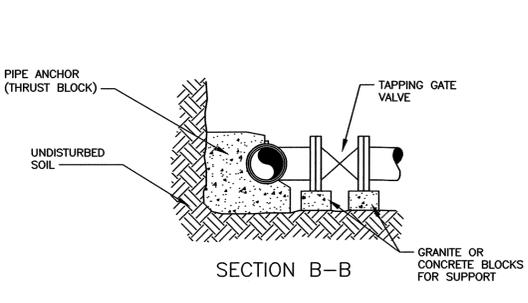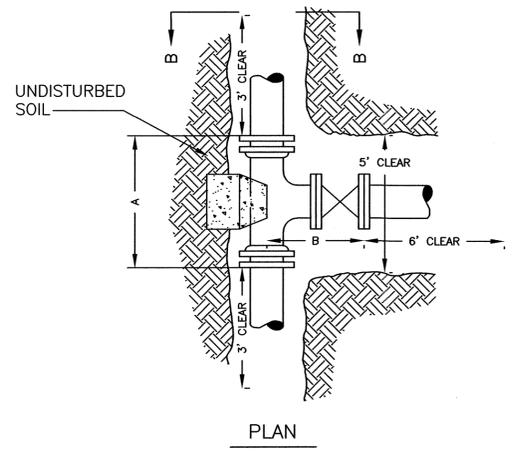

G TAPPING SLEEVE AND GATE (PORTSMOUTH)
 NTS

NOTES:


- 1) ALL MATERIALS SHALL BE APPROVED BY THE PORTSMOUTH WATER DEPARTMENT PRIOR TO INSTALLATION AND USE.
- 2) ALL JOINTS SHALL BE MECHANICAL.
- 3) "CLEAR" DIMENSIONS SHOWN ARE REQUIRED FOR WORKSPACE. NO JOINTS ON PIPE BEING TAPPED WITHIN "CLEAR" AREA
- 4) FORD TYPE STAINLESS STEEL TAPPING SADDLES OR APPROVED EQUAL ARE ALSO ACCEPTABLE.

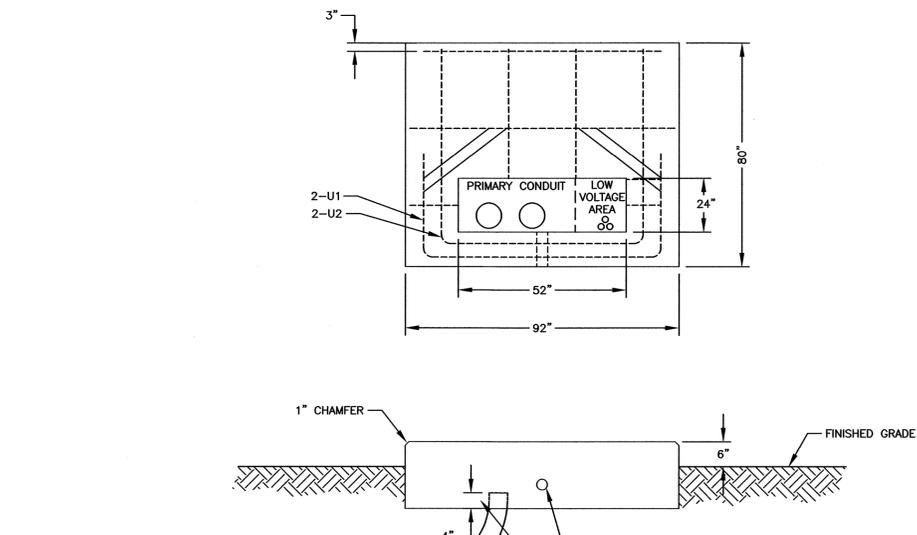

H TRANSFORMER FOUNDATION
 EVERSOURCE NTS

NOTES:

1. SEE SHEET "REQUIREMENTS FOR PAD MOUNTED TRANSFORMER SLAB DETAILS", EVERSOURCE SPECIFICATIONS.
2. SEE DTR 56.223 FOR GROUNDING GRID.
3. 1" PVC CONDUIT SLEEVE FOR GROUND GRID LEADS.
4. ALL REBAR TO BE #6.
5. CONDUITS CUT 4" ABOVE SLAB BASE.

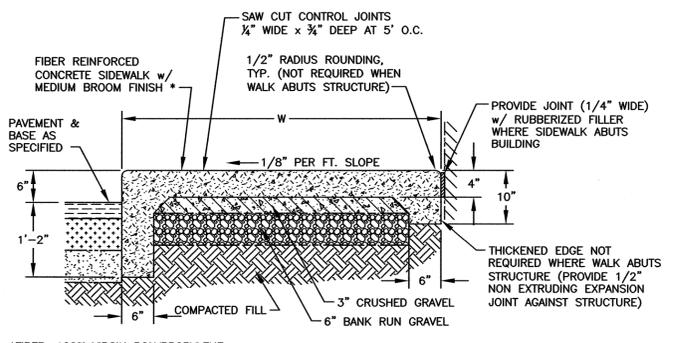

J CONCRETE WALK w/ CONCRETE CURB
 NTS

***FIBER: 100% VIRGIN POLYPROPYLENE SUCH AS GRACE MICROFIBER, ASTM C111B, TYPE 111, PAR.4.1.3 OR EQUAL. APPLIED @ 1 LB. PER C.Y.**

CROSS SECTION

SAW CUT CONTROL JOINTS 1/4" WIDE x 3/4" DEEP AT 5' O.C.

1/2" RADIUS ROUNDING, TYP. (NOT REQUIRED WHEN WALK ABUTS STRUCTURE)

PROVIDE JOINT (1/4" WIDE) w/ RUBBERIZED FILLER WHERE SIDEWALK ABUTS BUILDING

THICKENED EDGE NOT REQUIRED WHERE WALK ABUTS STRUCTURE (PROVIDE 1/2" NON EXTRUDING EXPANSION JOINT AGAINST STRUCTURE)

COMPACTED FILL

3" CRUSHED GRAVEL

6" BANK RUN GRAVEL

SAW CUT 1/4" WIDE x 3/4" DEEP SLOT (FILL w/ PREFORMED GASKET OR FILLER)

1/4"-3/8" PREFORMED GASKET OR FILLER ROUND ON 1/2" RADIUS

PROVIDE KEY AT CONSTRUCTION JOINTS

TROWELLED CONTROL JOINT


CONTROL JOINT @ 10' ON CENTER

EXPANSION JOINT @ 50' ON CENTER

CONSTRUCTION JOINT @ BREAK IN CONSTRUCTION

BUILDING ADDITION
SEACOAST MAZDA
180 SPAULDING TURNPIKE
PORTSMOUTH, N.H.

NO.	REVISIONS	DATE
0	ISSUED FOR APPROVAL	7/19/21

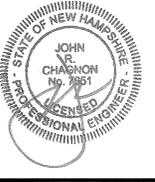

SCALE: AS SHOWN DECEMBER 2020

DETAILS **D2**

OWNER:

Seacoast Mazda
180 Spaulding Turnpike
Portsmouth, NH 03801

MEFPF:

STRUCTURAL:

CIVIL:

SUB-CONTRACTOR:

REVISION HISTORY:

#	DATE	ISSUANCE

SEAL:

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LOCUS MAP:



PROJECT NAME:

SEACOAST MAZDA
180 SPAULDING TURNPIKE
PORTSMOUTH, NH

DRAWING TITLE:

**EXISTING FIRST
FLOOR PLAN**


PROJECT No.:

DATE: 7/19/21

DRAWING SCALE: AS NOTED

DRAWING TITLE:

X1.1

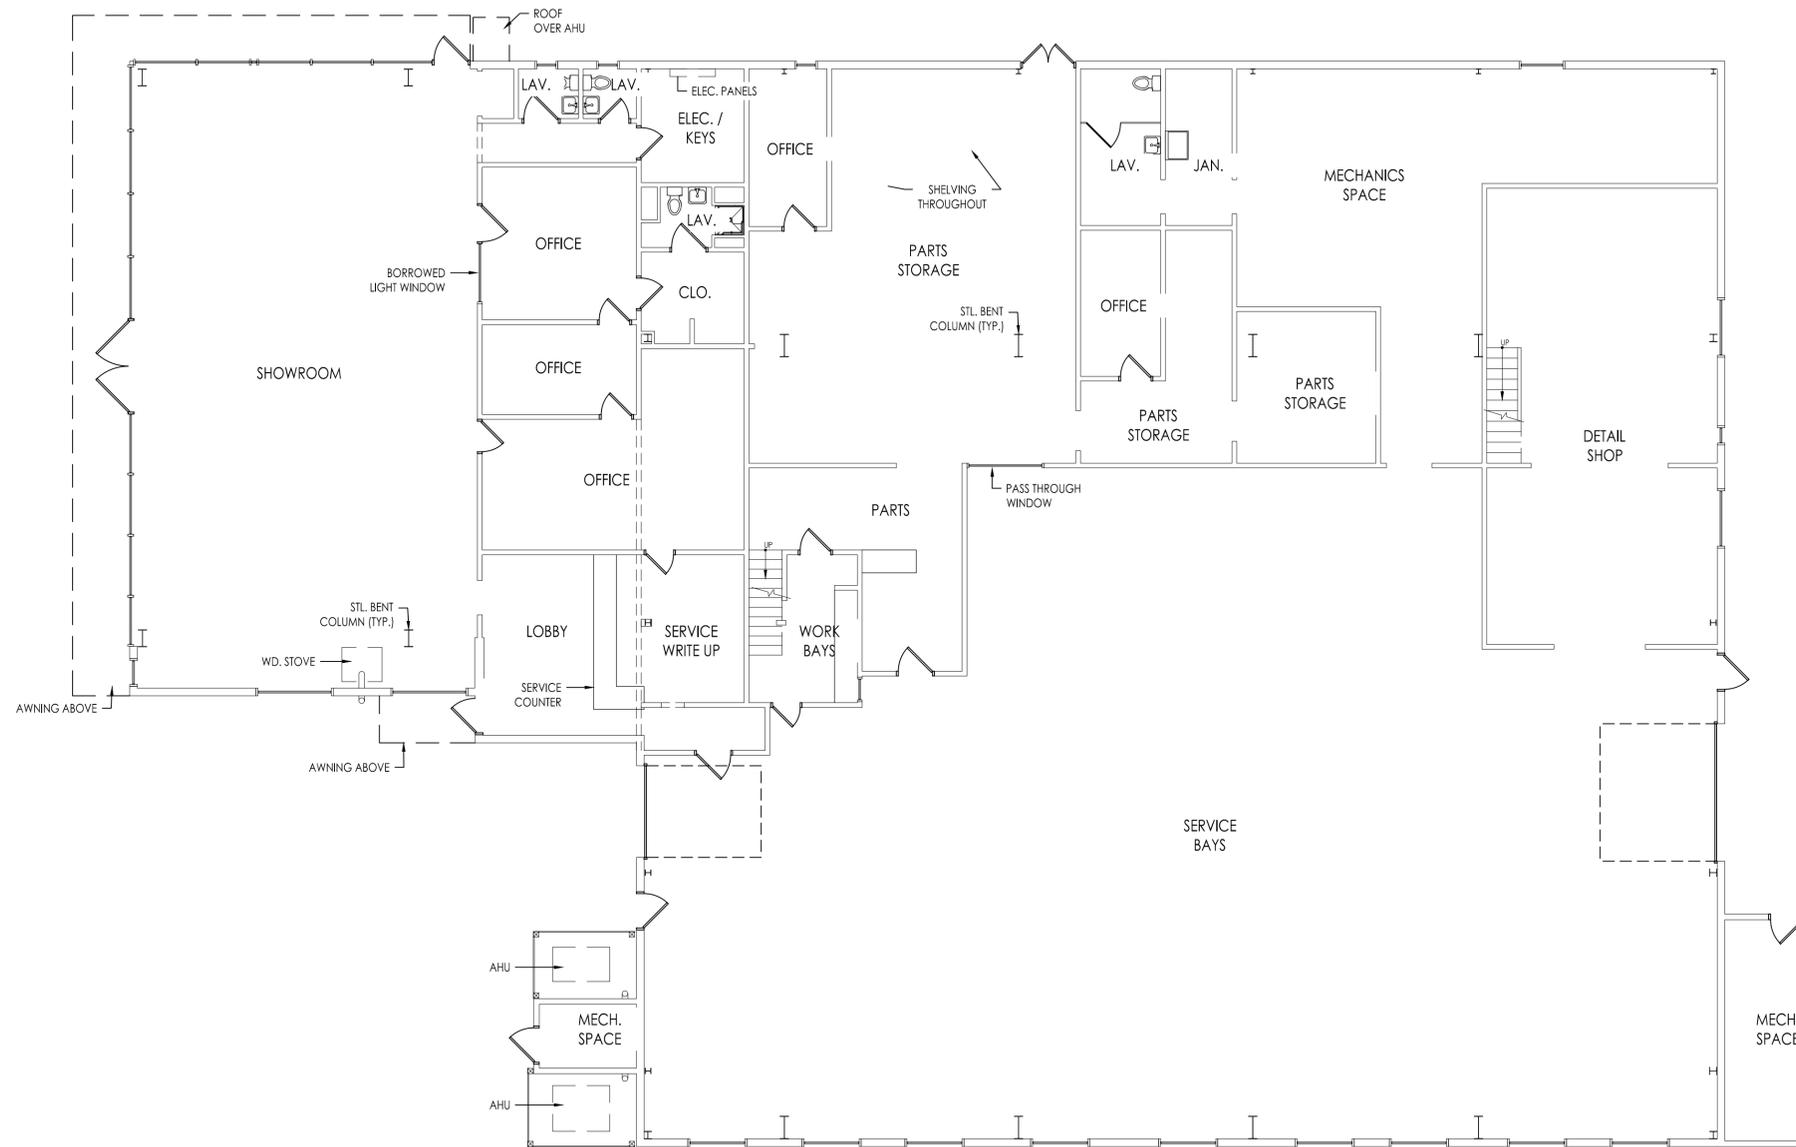

1 EXISTING FIRST FLOOR PLAN
SCALE: 1/8" = 1'-0"

OWNER:

Seacoast Mazda
180 Spaulding Turnpike
Portsmouth, NH 03801

MEFPF:

STRUCTURAL:

CIVIL:

SUB-CONTRACTOR:

REVISION HISTORY:

#	DATE	ISSUANCE

SEAL:

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LOCUS MAP:



PROJECT NAME:

SEACOAST MAZDA
180 SPAULDING TURNPIKE
PORTSMOUTH, NH

DRAWING TITLE:

EXISTING SECOND FLOOR PLAN

PROJECT No.:

DATE:


7/19/21

DRAWING SCALE:

AS NOTED

DRAWING TITLE:

X1.2

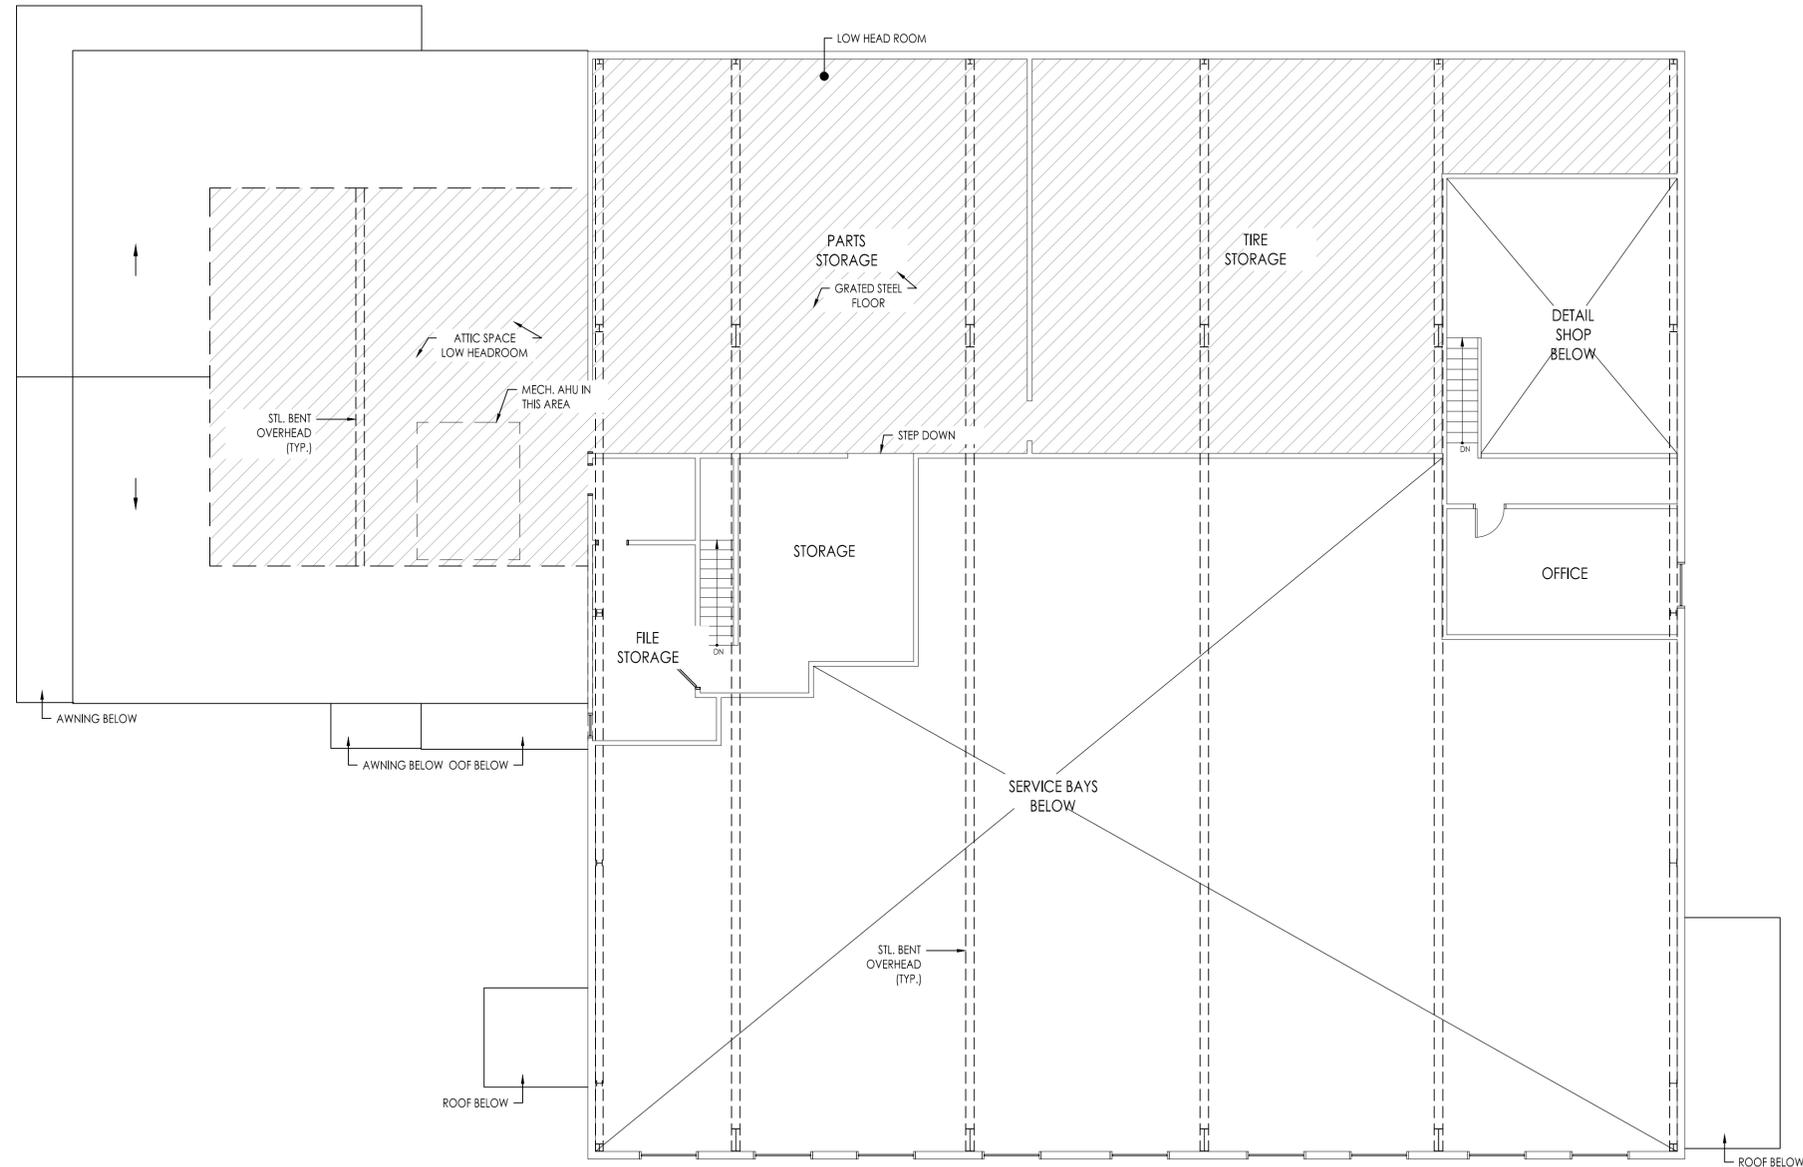

1 EXISTING SECOND FLOOR PLAN
SCALE: 1/8" = 1'-0"

OWNER:

Seacoast Mazda
180 Spaulding Turnpike
Portsmouth, NH 03801

MEPPP:

STRUCTURAL:

CIVIL:

SUB-CONTRACTOR:

REVISION HISTORY:

#	DATE	ISSUANCE

SEAL:

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LOCUS MAP:

PROJECT NAME:

SEACOAST MAZDA
180 SPAULDING TURNPIKE
PORTSMOUTH, NH

DRAWING TITLE:

EXISTING EXTERIOR ELEVATIONS

PROJECT No.:

DATE:


7/19/21

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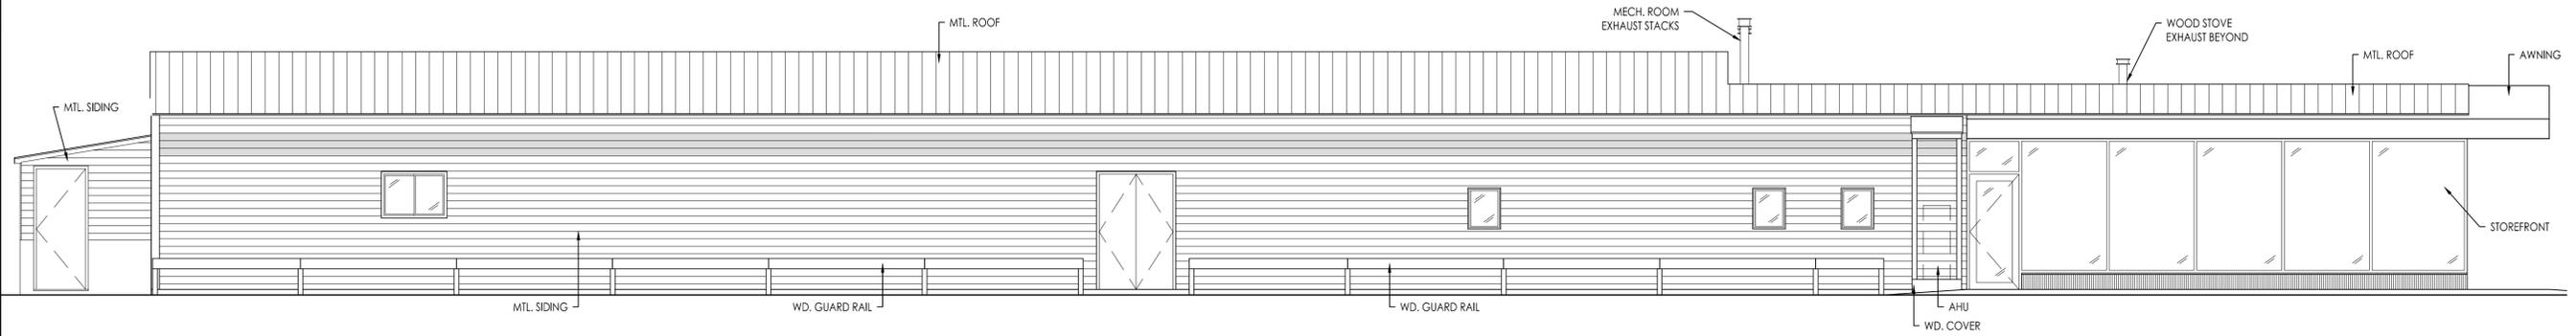
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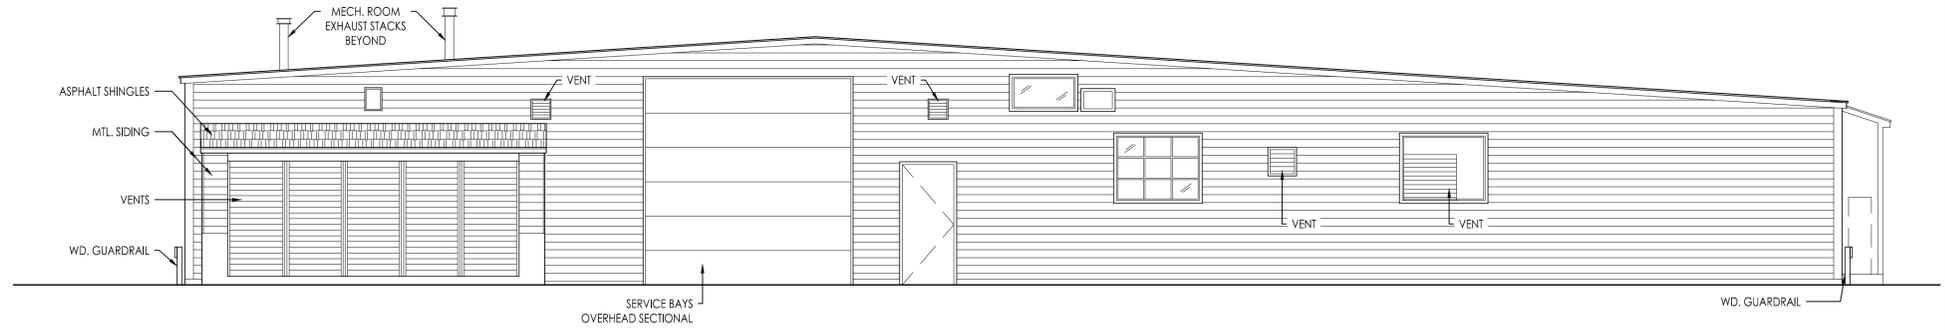
X2.1



1 EXISTING SOUTHEAST EXTERIOR ELEVATION
SCALE: 3/16" = 1'-0"

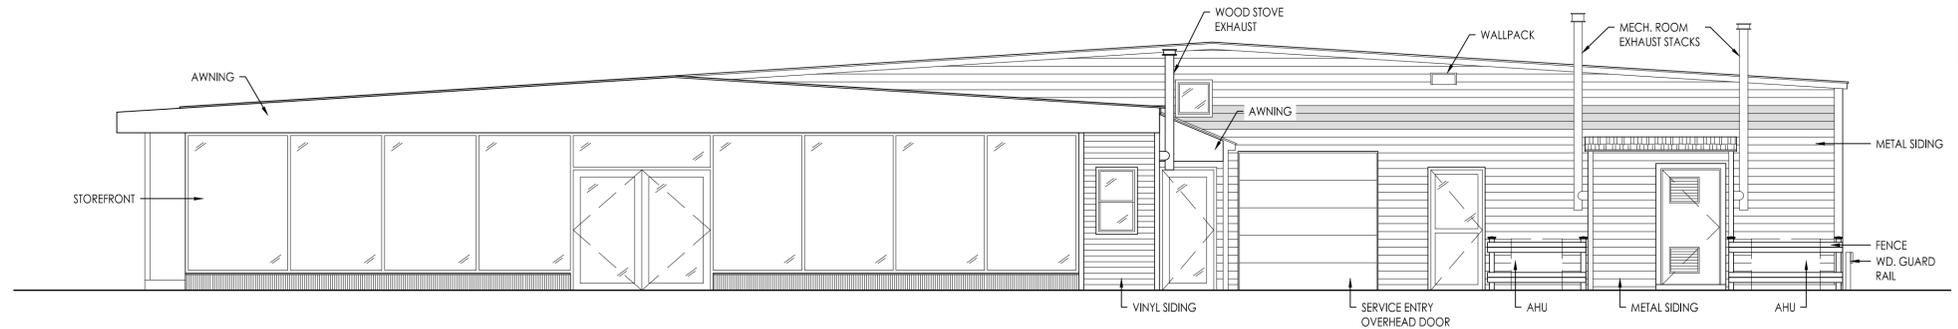

2 EXISTING SOUTHWEST EXTERIOR ELEVATION
SCALE: 3/16" = 1'-0"



3 EXISTING NORTHWEST EXTERIOR ELEVATION
SCALE: 3/16" = 1'-0"



4 EXISTING SOUTHWEST EXTERIOR ELEVATION
SCALE: 3/16" = 1'-0"

OWNER:

Seacoast Mazda
180 Spaulding Turnpike
Portsmouth, NH 03801

MEFPF:

STRUCTURAL:

CIVIL:

SUB-CONTRACTOR:

REVISION HISTORY:

#	DATE	ISSUANCE

SEAL:

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LOCUS MAP:

PROJECT NAME:

SEACOAST MAZDA
180 SPAULDING TURNPIKE
PORTSMOUTH, NH

DRAWING TITLE:

PROPOSED FIRST FLOOR PLAN


PROJECT No.:

DATE: 7/19/21

DRAWING SCALE: AS NOTED

DRAWING TITLE:

A1.1

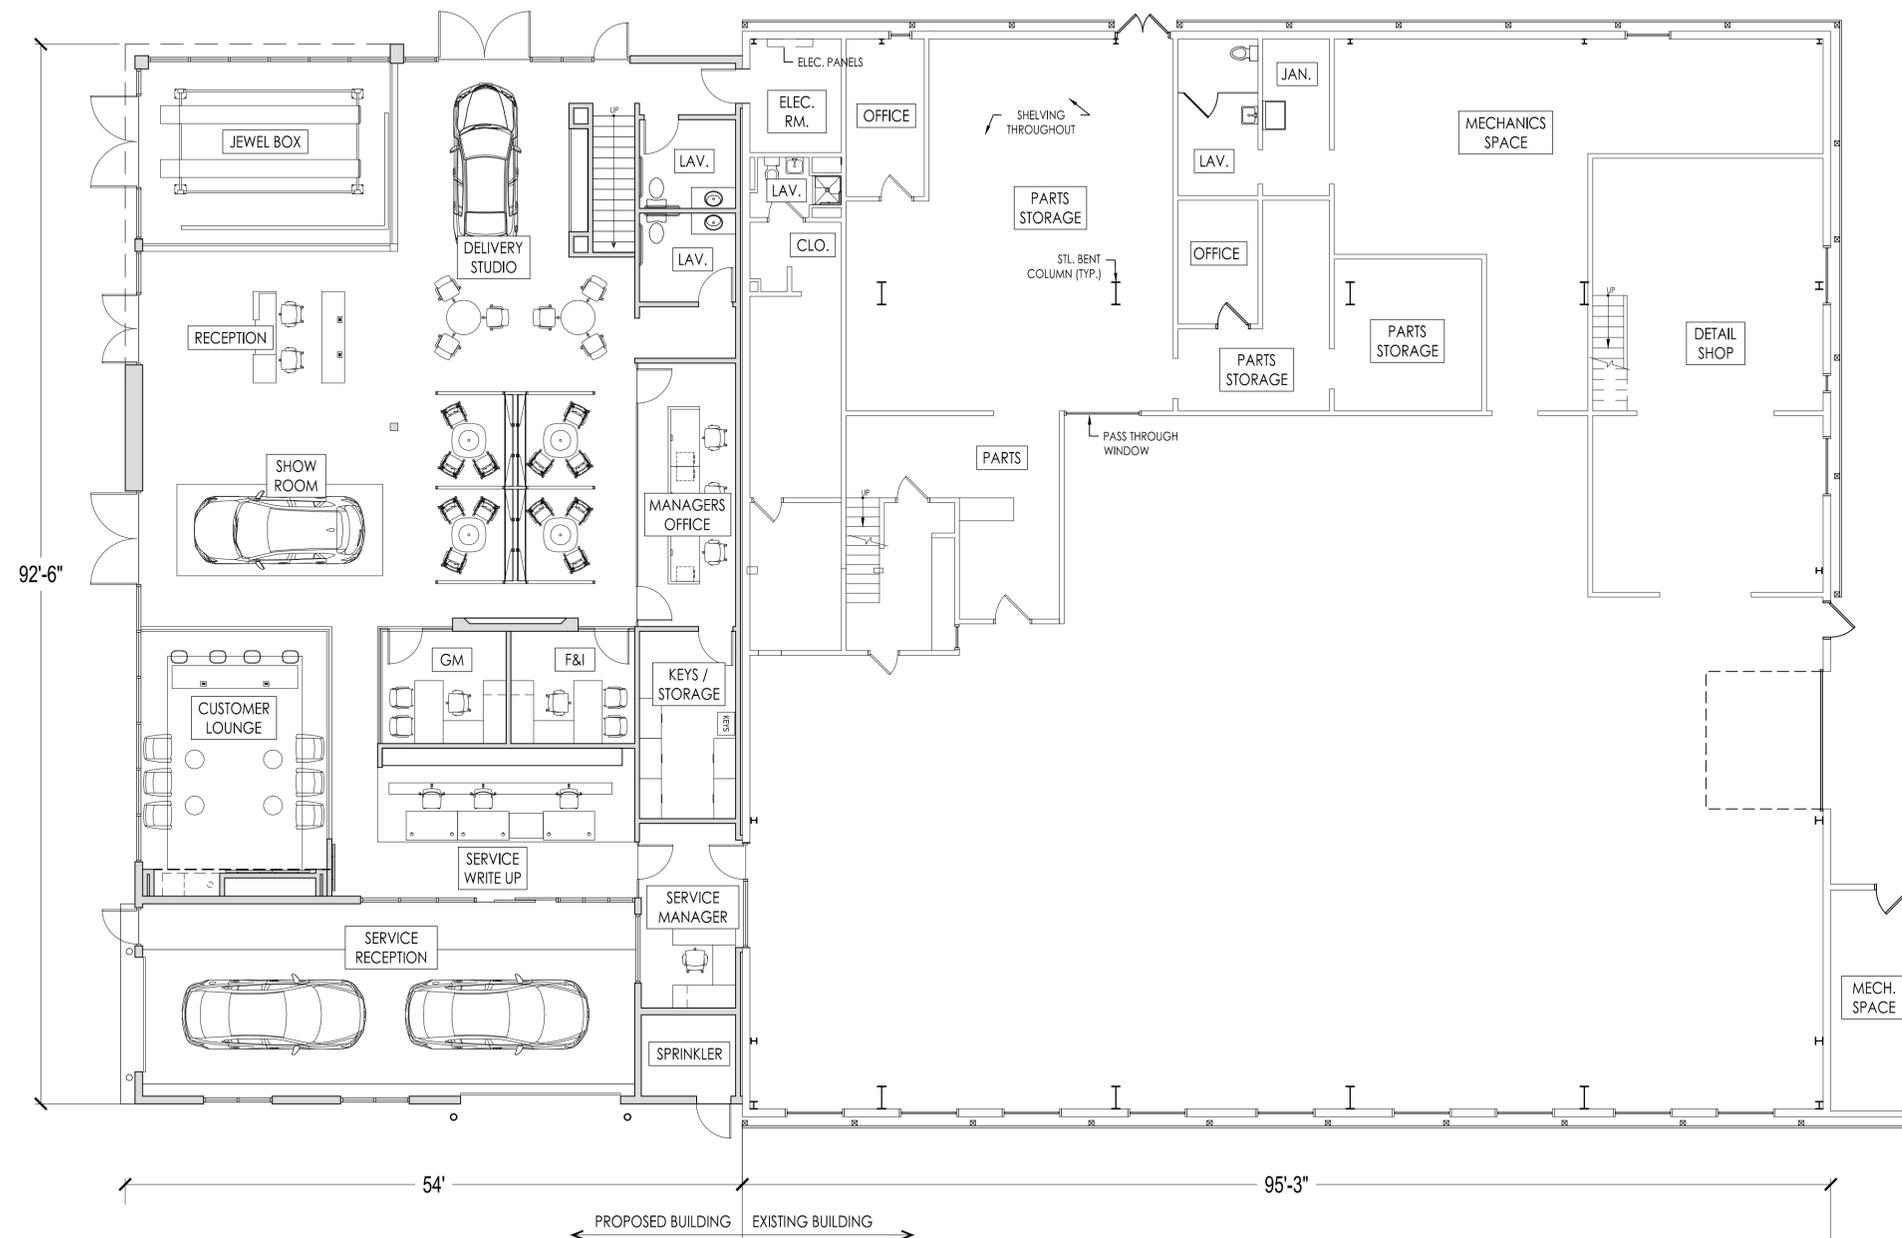

1 PROPOSED FIRST FLOOR PLAN
SCALE: 1/8" = 1'-0"

OWNER:

Seacoast Mazda
180 Spaulding Turnpike
Portsmouth, NH 03801

MEFPF:

STRUCTURAL:

CIVIL:

SUB-CONTRACTOR:

REVISION HISTORY:

#	DATE	ISSUANCE

SEAL:

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LOCUS MAP:



PROJECT NAME:

SEACOAST MAZDA
180 SPAULDING TURNPIKE
PORTSMOUTH, NH

DRAWING TITLE:

**PROPOSED SECOND
FLOOR PLAN**

PROJECT No.:

DATE:

7/19/21

DRAWING SCALE:


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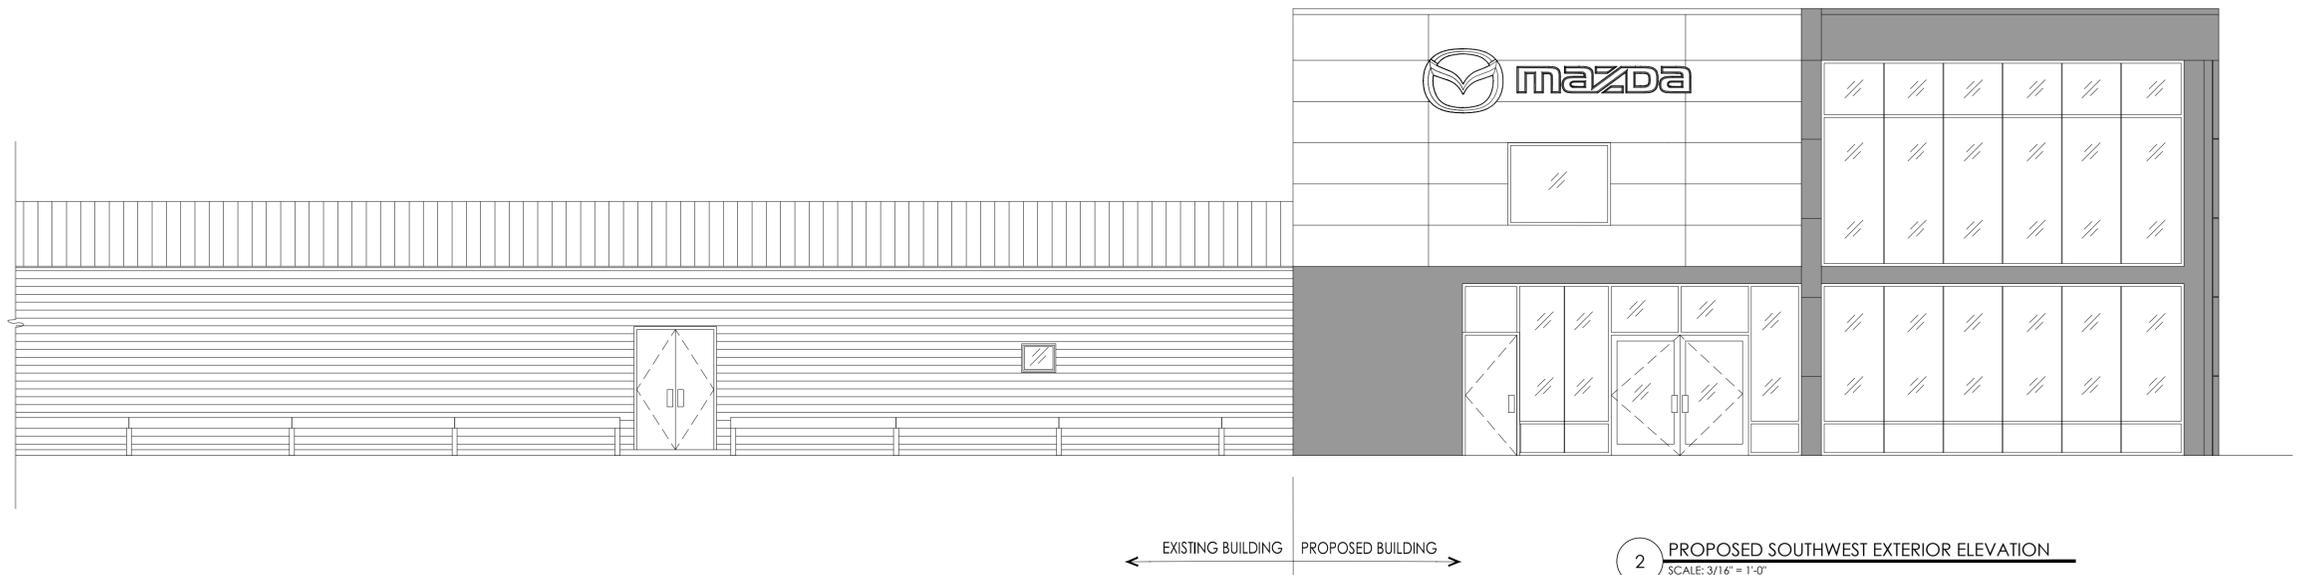
A1.2



1 PROPOSED SECOND FLOOR PLAN
SCALE: 1/8" = 1'-0"



1 PROPOSED SOUTHEAST EXTERIOR ELEVATION
SCALE: 3/16" = 1'-0"

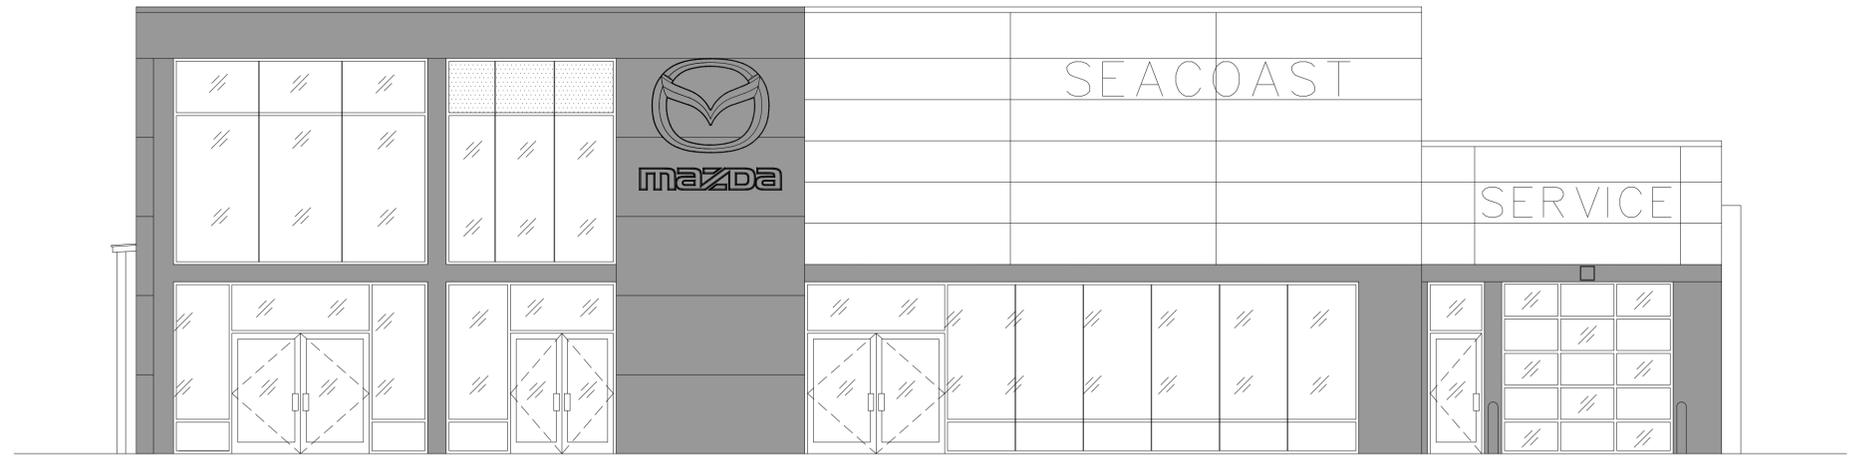

2 PROPOSED SOUTHWEST EXTERIOR ELEVATION
SCALE: 3/16" = 1'-0"



3 PROPOSED NORTHEAST EXTERIOR ELEVATION
SCALE: 3/16" = 1'-0"

#	DATE	ISSUANCE





	<p>SEACOAST MAZDA PORTSMOUTH, NH</p>	<p>PROJECT NO. MAZ03.73</p>	<p>CHECKED CU</p>	<p>DATE FEB '21</p>	<p>REVISED</p>	<p>SCALE Not to Scale</p>	<p>ChangeUp</p>	<p>2056 Byers Rd. Dayton, OH 45342 Phone: 844.804.7700</p>	<p>DRAWING TITLE EXTERIOR RENDERING</p>	<p>DWG NO.</p>
<p><small>These drawings are for communication of design intent only. These drawings are to specify size, shape, color, features and proportions, and are not to be used as fabrication drawings.</small></p>										