

Civil Site Planning Environmental Engineering

133 Court Street Portsmouth, NH 03801-4413

December 3, 2019

Juliet T. H. Walker, AICP, Planning Director City of Portsmouth Municipal Complex Planning Department 1 Junkins Avenue Portsmouth, New Hampshire 03801

Re:

Application for TAC Work Session Assessor's Map 135, Lots 29 & 30 160 & 168-170 Union Street Altus Project #P4823

Dear Juliet:

On behalf of the LCSG, LLC and Natasha & Matthew Goyette, Altus Engineering, Inc. (Altus) is pleased to submit plans for the December 10, 2019 TAC Work Session for the construction of a new single family residence and a four car garage with an apartment above on their property located at 160 & 168-170 Union Street.

In October, the zoning relief was granted to allow the two lots to be merged with a reduced dwelling density and setback relief. We are now developing the site plans for Site Plan Review Approval and look to the Technical Advisory Committee for their input on the design.

Attached are ten copies of the revised site plans (4 full, 6 reduced).

Please call us if you have any questions or need any additional information.

Sincerely

President

wde/4957 TAC work session cvr ltr


Enclosure

Ecopy: Matthew and Natasha Goyette

Jeremiah Johnson, McHenry Architecture

Tel: (603) 433-2335

E-mail: Altus@altus-eng.com

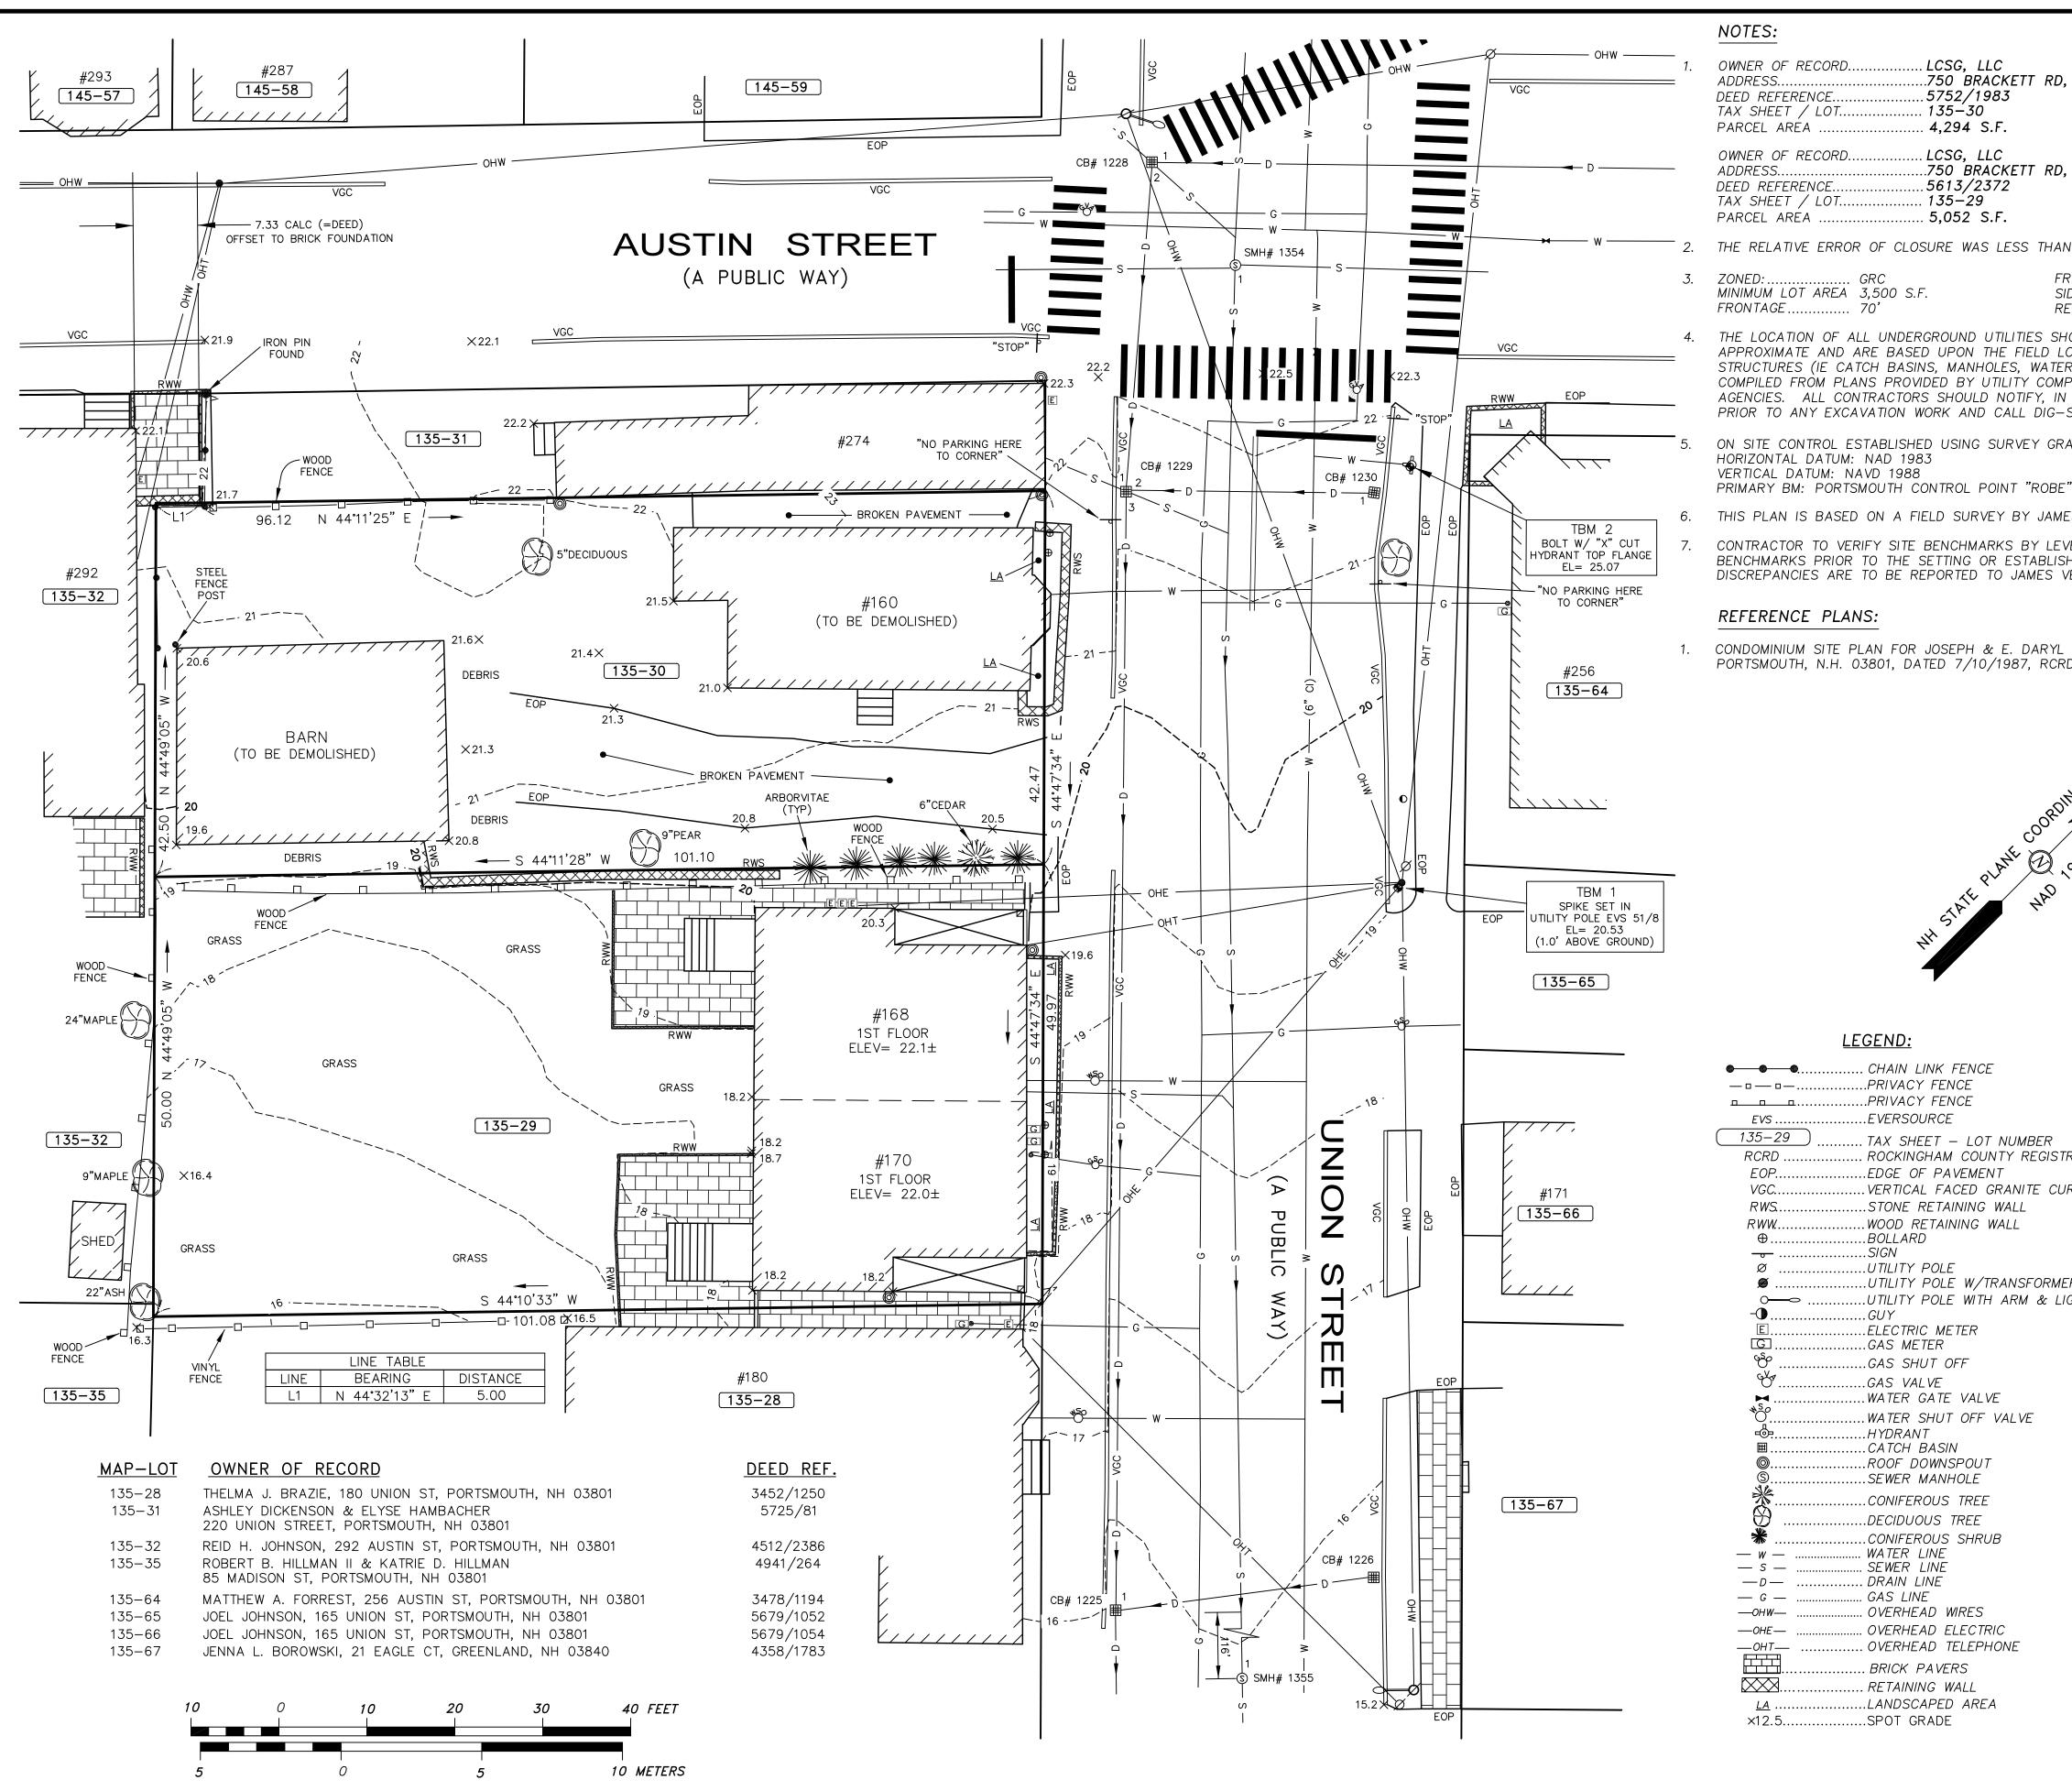

OWNER OF RECORD. LCSG, LLC .750 BRACKETT RD, RYE, NH 03870 ADDRESS.. DEED REFERENCE.. 5752/1983 TAX SHEET / LOT. 135–30 4,294 S.F. PARCEL AREA ...

OWNER OF RECORD. LCSG, LLC .750 BRACKETT RD, RYE, NH 03870 ADDRESS.. .5613/2372 DEED REFERENCE .. TAX SHEET / LOT. 135-29 . 5,052 S.F.

THE RELATIVE ERROR OF CLOSURE WAS LESS THAN 1 FOOT IN 15,000 FEET.

FRONT YARD SETBACK 5' MINIMUM LOT AREA 3,500 S.F. SIDE YARD SETBACK10' FRONTAGE 70' REAR YARD SETBACK......20'

THE LOCATION OF ALL UNDERGROUND UTILITIES SHOWN HEREON ARE APPROXIMATE AND ARE BASED UPON THE FIELD LOCATION OF ALL VISIBLE STRUCTURES (IE CATCH BASINS, MANHOLES, WATER GATES ETC.) AND INFORMATION COMPILED FROM PLANS PROVIDED BY UTILITY COMPANIES AND GOVERNMENTAL AGENCIES. ALL CONTRACTORS SHOULD NOTIFY, IN WRITING, SAID AGENCIES PRIOR TO ANY EXCAVATION WORK AND CALL DIG-SAFE @ 1-888-DIG-SAFE.


ON SITE CONTROL ESTABLISHED USING SURVEY GRADE GPS UNITS. HORIZONTAL DATUM: NAD 1983 VERTICAL DATUM: NAVD 1988

THIS PLAN IS BASED ON A FIELD SURVEY BY JAMES VERRA AND ASSOC., INC.

CONTRACTOR TO VERIFY SITE BENCHMARKS BY LEVELING BETWEEN 2 BENCHMARKS PRIOR TO THE SETTING OR ESTABLISHMENT OF ANY GRADES/ELEVATIONS. DISCREPANCIES ARE TO BE REPORTED TO JAMES VERRA AND ASSOC., INC.

REFERENCE PLANS:

CONDOMINIUM SITE PLAN FOR JOSEPH & E. DARYL RAUCH OF 306-308 AUSTIN STREET, PORTSMOUTH, N.H. 03801, DATED 7/10/1987, RCRD PLAN D-16712.

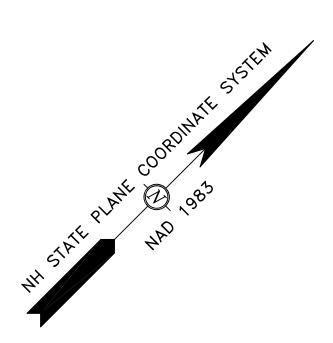

<u>LEGEND:</u>
● ● ●
135-29
VGCVERTICAL FACED GRANITE CURB RWSSTONE RETAINING WALL RWWWOOD RETAINING WALL ⊕BOLLARD
SIGN ØUTILITY POLE ØUTILITY POLE W/TRANSFORMER ○UTILITY POLE WITH ARM & LIGHTGUY
EELECTRIC METER G. GAS METER GAS SHUT OFF
©GAS VALVE MATER GATE VALVE MATER SHUT OFF VALVE HYDRANT
■CATCH BASIN ©ROOF DOWNSPOUT SSEWER MANHOLE CONIFEROUS TREE
The second secon

.DECIDUOUS TREE

OVERHEAD WIRES

BRICK PAVERS

...SPOT GRADE

RETAINING WALL ..LANDSCAPED AREA

OVERHEAD ELECTRIC

.. OVERHEAD TELEPHONE

WATER LINE

SEWER LINE

DRAIN LINE

GAS LINE

.CONIFEROUS SHRUB

DRAIN & SEWER TABLE

CB# 1225

RIM EL= 15.66 (1) INV IN 15"CMP= 11.95 CB# 1226 RIM EL= 15.63 CB# 1228 RIM EL= 23.36 (1) INV IN 12"HDPE= 19.21 (2) INV OUT 15"CMP= 18.46

CB# 1229 RIM EL= 21.24 (1) INV IN 15"CMP= 17.72 (2) INV IN 12"CMP= 17.66 (3) INV OUT 15"CMP= 15.44

CB# 1230 RIM EL= 21.30 (1) INV OUT 12"CMP= 18.05

SMH# 1354 RIM EL= 23.13 (1) INV OUT 8"VCP= 16.46 SMH# 1355 RIM EL= 14.20 (1) INV IN 8"VCP= 7.48




James Verra and Associates, Inc.

LAND SURVEYORS

101 SHATTUCK WAY - SUITE 8 NEWINGTON, N.H. 03801- 7876 603-436-3557 JOB NO: 23770 PLAN NO: 23770

<u>ENGINEER:</u>

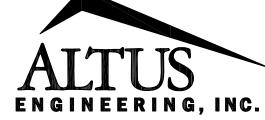

133 COURT STREET PORTSMOUTH, NH 03801 (603) 433-2335 www.ALTUS-ENG.com

ISSUED FOR:

ENGINEERING DESIGN

ISSUE DATE:

<u>REVISIONS</u>

DRAWN BY:

OCTOBER 17, 2018

JCS

1 ENGINEERING DESIGN JV 10/17/18

APPROVED BY: 23770.DWG DRAWING FILE: SCALE:

 $22" \times 34" - 1" = 10'$ $11" \times 17" - 1" = 20"$

OWNER/APPLICANT:

LCSG, LLC 160 & 168-170 UNION STREET PORTSMOUTH, N.H. ASSESSOR'S PARCELS MAP-LOT 135-30 & 135-29

> C/O LCSG, LLC 750 BRACKETT ROAD RYE, NH 03870 PORTSMOUTH, N.H.

DEED REFERENCES: RCRD 5752/1983 & 5613/2372

PROJECT:

PROPOSED SITE DEVELOPMENT **PLANS**


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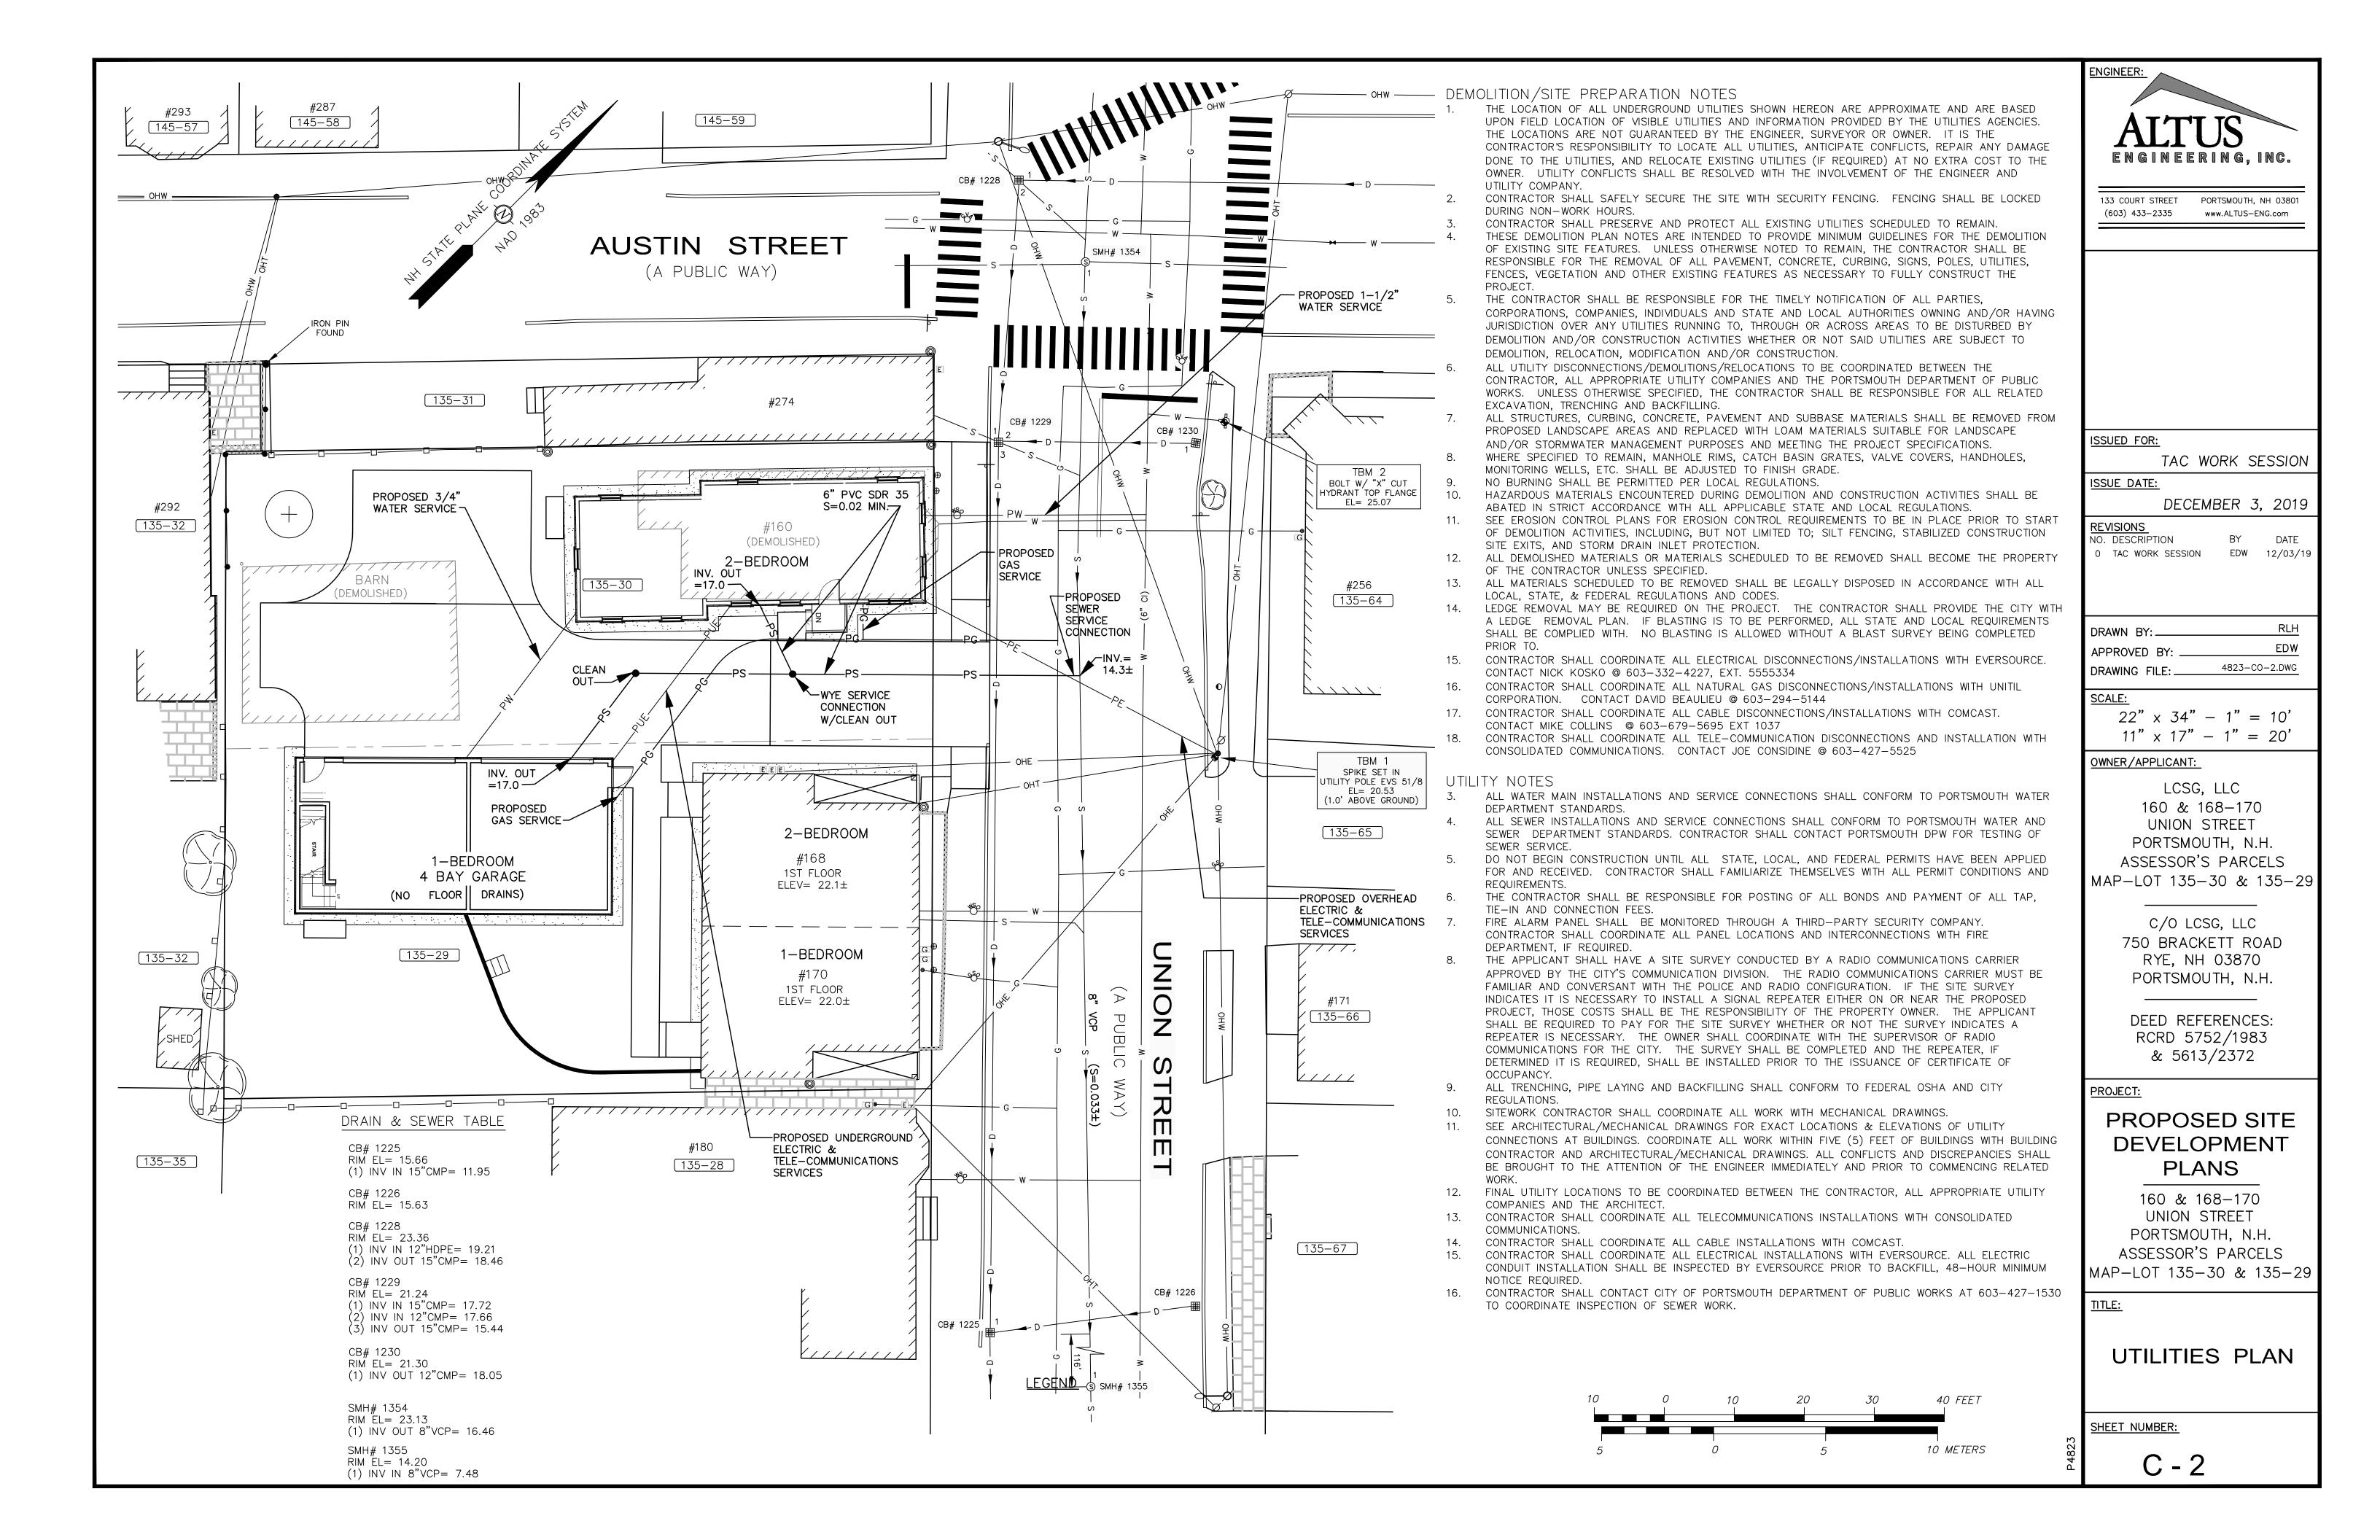
TITLE:


EXISTING CONDITIONS PLAN

SHEET NUMBER:

OF 1



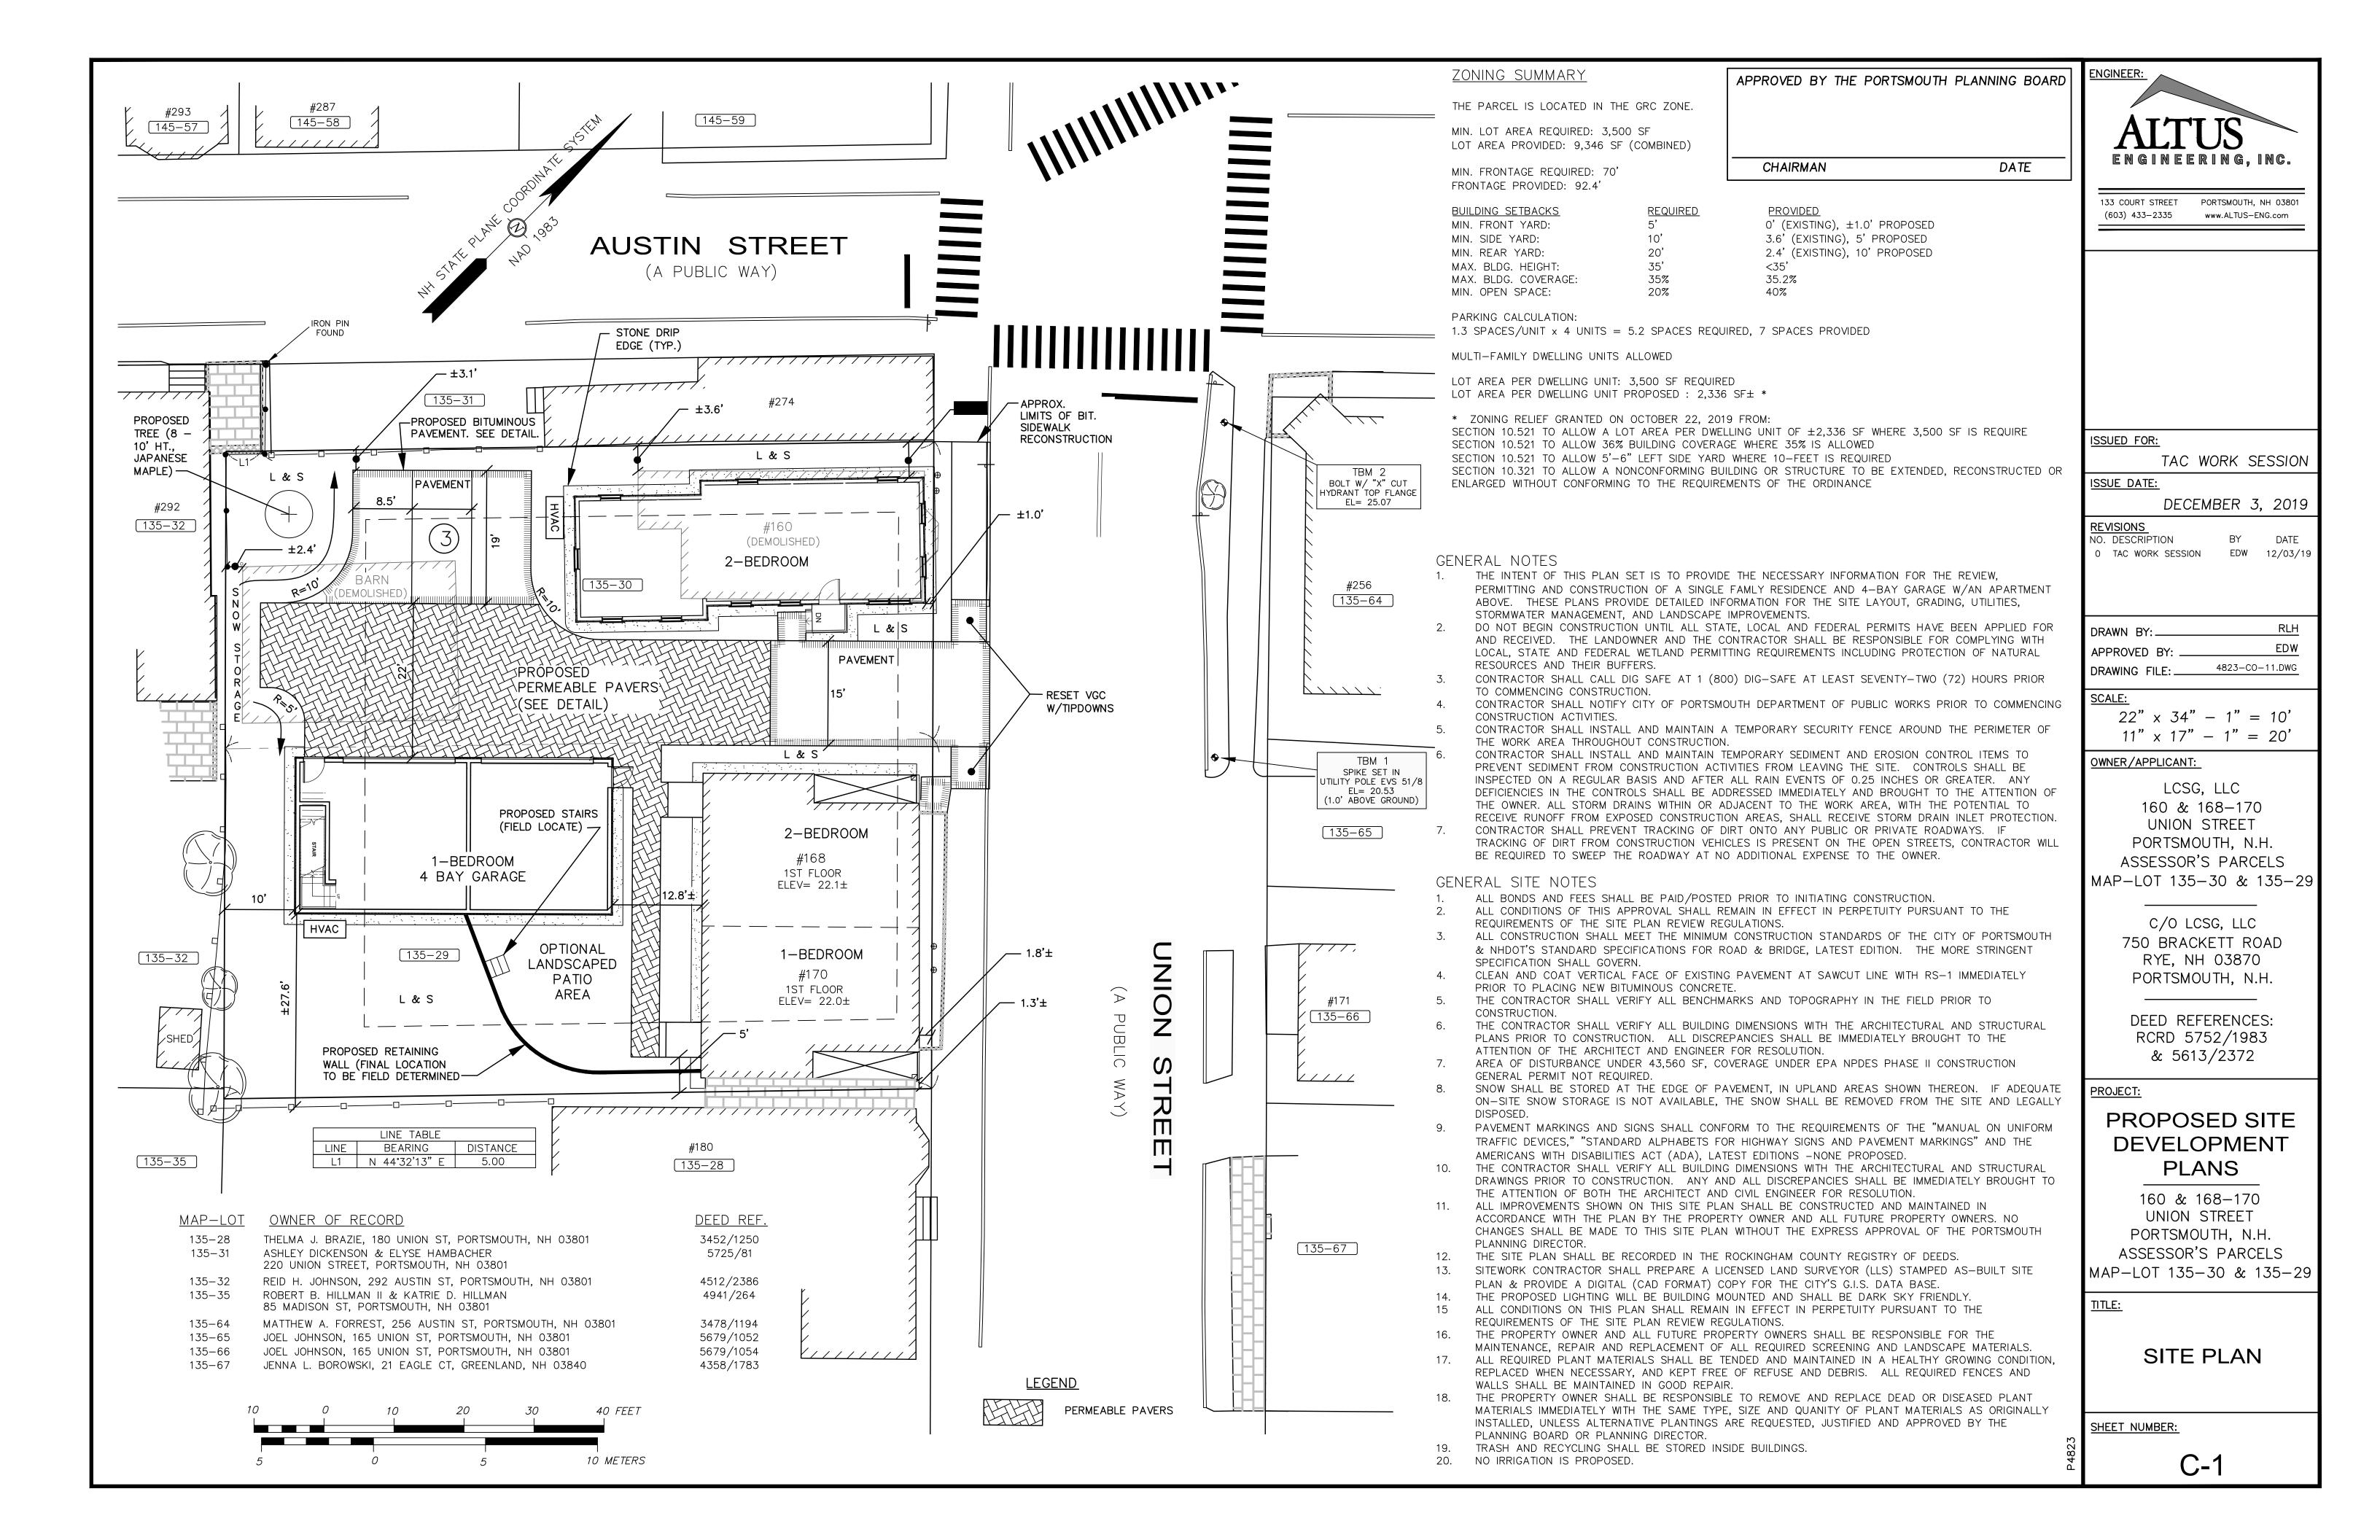

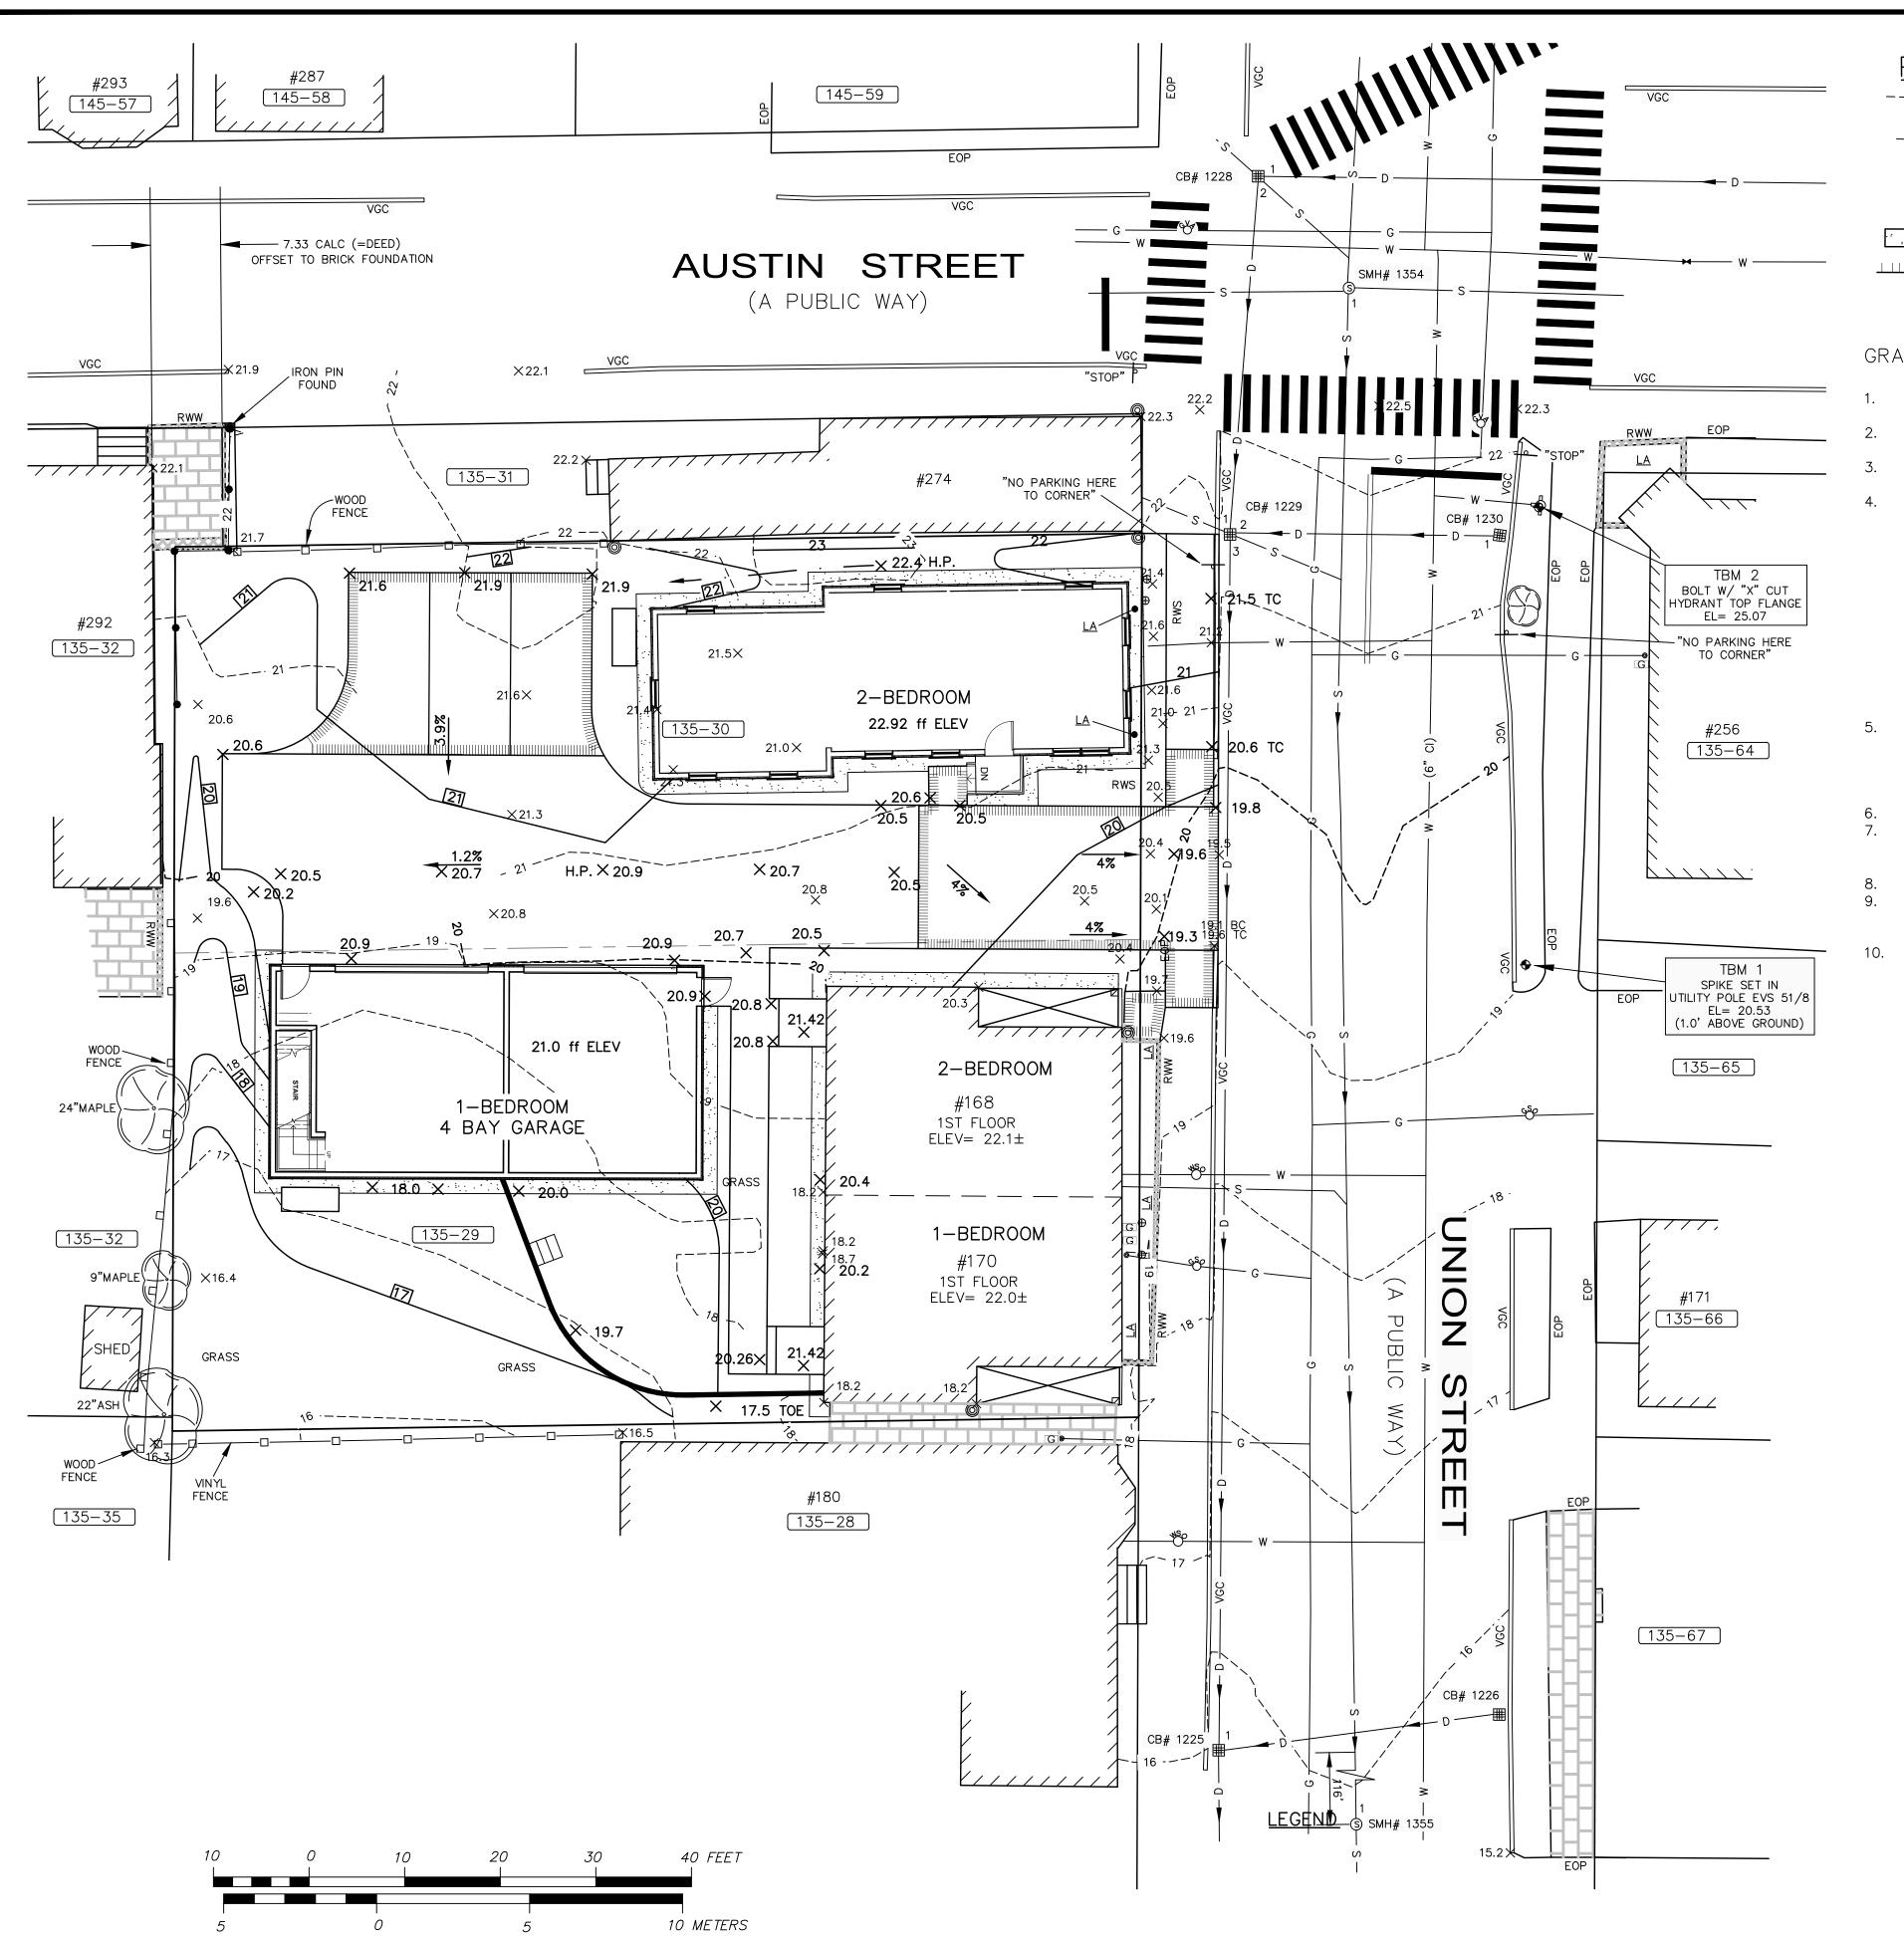

PROPOSED LEGEND

---- EXISTING CONTOUR

EXISTING SPOT GRADE ELEVATION PROPOSED SPOT GRADE ELEVATION $22.4 \times$

PROPOSED CONTOUR

PROPOSED STONE DRIP EDGE

GRADING AND DRAINAGE NOTES

- PRIOR TO CONSTRUCTION, CONTRACTOR SHALL FIELD VERIFY LOCATIONS AND ELEVATIONS OF ALL EXISTING UTILITIES SCHEDULED TO REMAIN.
- ALL BENCHMARKS AND TOPOGRAPHY SHALL BE FIELD VERIFIED BY THE CONTRACTOR PRIOR TO INITIATING CONSTRUCTION
- DEWATERING ACTIVITIES SHALL BE DONE IN ACCORDANCE WITH EPA AND NHDES REGULATIONS AND GUIDELINES.
- PROTECTION OF SUBGRADE: THE CONTRACTOR SHALL BE REQUIRED TO MAINTAIN STABLE, DEWATERED SUBGRADES FOR FOUNDATIONS, PAVEMENT AREAS, UTILITY TRENCHES AND OTHER AREAS DURING CONSTRUCTION. SUBGRADE DISTURBANCE MAY BE INFLUENCED BY EXCAVATION METHODS, MOISTURE, PRECIPITATION, GROUNDWATER CONTROL, AND CONSTRUCTION ACTIVITIES. THE CONTRACTOR SHALL TAKE PRECAUTIONS TO PREVENT SUBGRADE DISTURBANCE. SUCH PRECAUTIONS MAY INCLUDE DIVERTING STORMWATER RUNOFF AWAY FROM CONSTRUCTION AREAS, REDUCING TRAFFIC IN SENSITIVE AREAS, AND MAINTAINING AN EFFECTIVE DEWATERING PROGRAM. SOILS EXHIBITING HEAVING OR INSTABILITY SHALL BE OVER EXCAVATED TO MORE COMPETENT BEARING SOIL AND REPLACED WITH FREE DRAINING STRUCTURAL FILL IF THE EARTHWORK IS PERFORMED DURING FREEZING WEATHER, EXPOSED SUBGRADES ARE SUSCEPTIBLE TO FROST. NO FILL OR UTILITIES SHALL BE PLACED ON FROZEN GROUND. THIS WILL LIKELY REQUIRE REMOVAL OF THE FROZEN SOIL CRUST AT THE COMMENCEMENT OF EACH DAY'S OPERATIONS. THE FINAL SUBGRADE ELEVATION WILL ALSO REQUIRE AN APPROPRIATE DEGREE OF INSULATION AGAINST FREEZING.
- IF SUITABLE, EXCAVATED MATERIALS SHALL BE PLACED AS FILL WITHIN UPLAND AREAS ONLY AND SHALL NOT BE PLACED WITHIN WETLANDS. PLACEMENT OF BORROW MATERIALS SHALL BE PERFORMED IN A MANNER THAT PREVENTS LONG TERM DIFFERENTIAL SETTLEMENT. EXCESSIVELY WET MATERIALS SHALL BE STOCKPILED AND ALLOWED TO DRAIN BEFORE PLACEMENT. FROZEN MATERIAL SHALL NOT BE USED FOR CONSTRUCTION.
- ALL STORM DRAIN PIPE SHALL BE ADS N-12 OR EQUAL AND APPROVED BY THE ENGINEER. ALL CATCH BASIN, GATE VALVE COVERS, AND MANHOLE RIMS SHALL BE SET FLUSH WITH OR NO LESS THAN 0.1' BELOW FINISHED GRADE. ANY RIM OR VALVE COVER ABOVE SURROUNDING FINISHED GRADE WILL NOT BE ACCEPTED.
- ALL SPOT GRADES ARE AT THE FINISH GRADE AND BOTTOM OF CURB WHERE APPLICABLE. UNLESS OTHERWISE SPECIFIED, RETAINING WALL AND BUILDING PERIMETER DRAINS SHALL BE DIRECTED TO THE NEAREST DRAINAGE STRUCTURE. IF DEEMED APPROPRIATE, CONTRACTOR SHALL PROVIDE ADDITIONAL UNDERDRAINS AT THE DIRECTION OF THE ENGINEER.
- CONTRACTOR SHALL PROTECT ALL RAINGARDENS AND OTHER STORM MANAGEMENT DEVICES FROM CONSTRUCTION STORMWATER RUNOFF. TEMPORARY SEDIMENT BASINS SHALL BE CONSTRUCTED DURING CONSTRUCTION. STORMWATER SHALL NOT BE DIRECTED TO THE RAINGARDENS OR STORMWATER MANAGEMENT AREAS UNTIL THE WATERSHED ARE HAS BEEN STABILIZED.

DRAIN & SEWER TABLE

CB# 1225 RIM EL= 15.66 (1) INV IN 15"CMP= 11.95

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ENGINEER:

ENGINEERING, INC.

133 COURT STREET PORTSMOUTH, NH 03801 (603) 433-2335 www.ALTUS-ENG.com

ISSUED FOR:

TAC WORK SESSION

ISSUE DATE:

DECEMBER 3, 2019

DATE

RLH

EDW 12/02/19

REVISIONS NO. DESCRIPTION O TAC WORK SESSION

EDW APPROVED BY: 4823-CO-2.DWG DRAWING FILE: _

SCALE:

DRAWN BY:

 $22" \times 34" - 1" = 10"$ $11" \times 17" - 1" = 20"$

OWNER/APPLICANT:

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160 & 168-170 UNION STREET PORTSMOUTH, N.H. ASSESSOR'S PARCELS MAP-LOT 135-30 & 135-29

GRADING, DRAINAGE **EROSION CONTROL PLAN**

SHEET NUMBER:

C - 3





STREET ELEVATION

160 UNION STREET








REBUILT EXIT STAIR



REAR ELEVATION

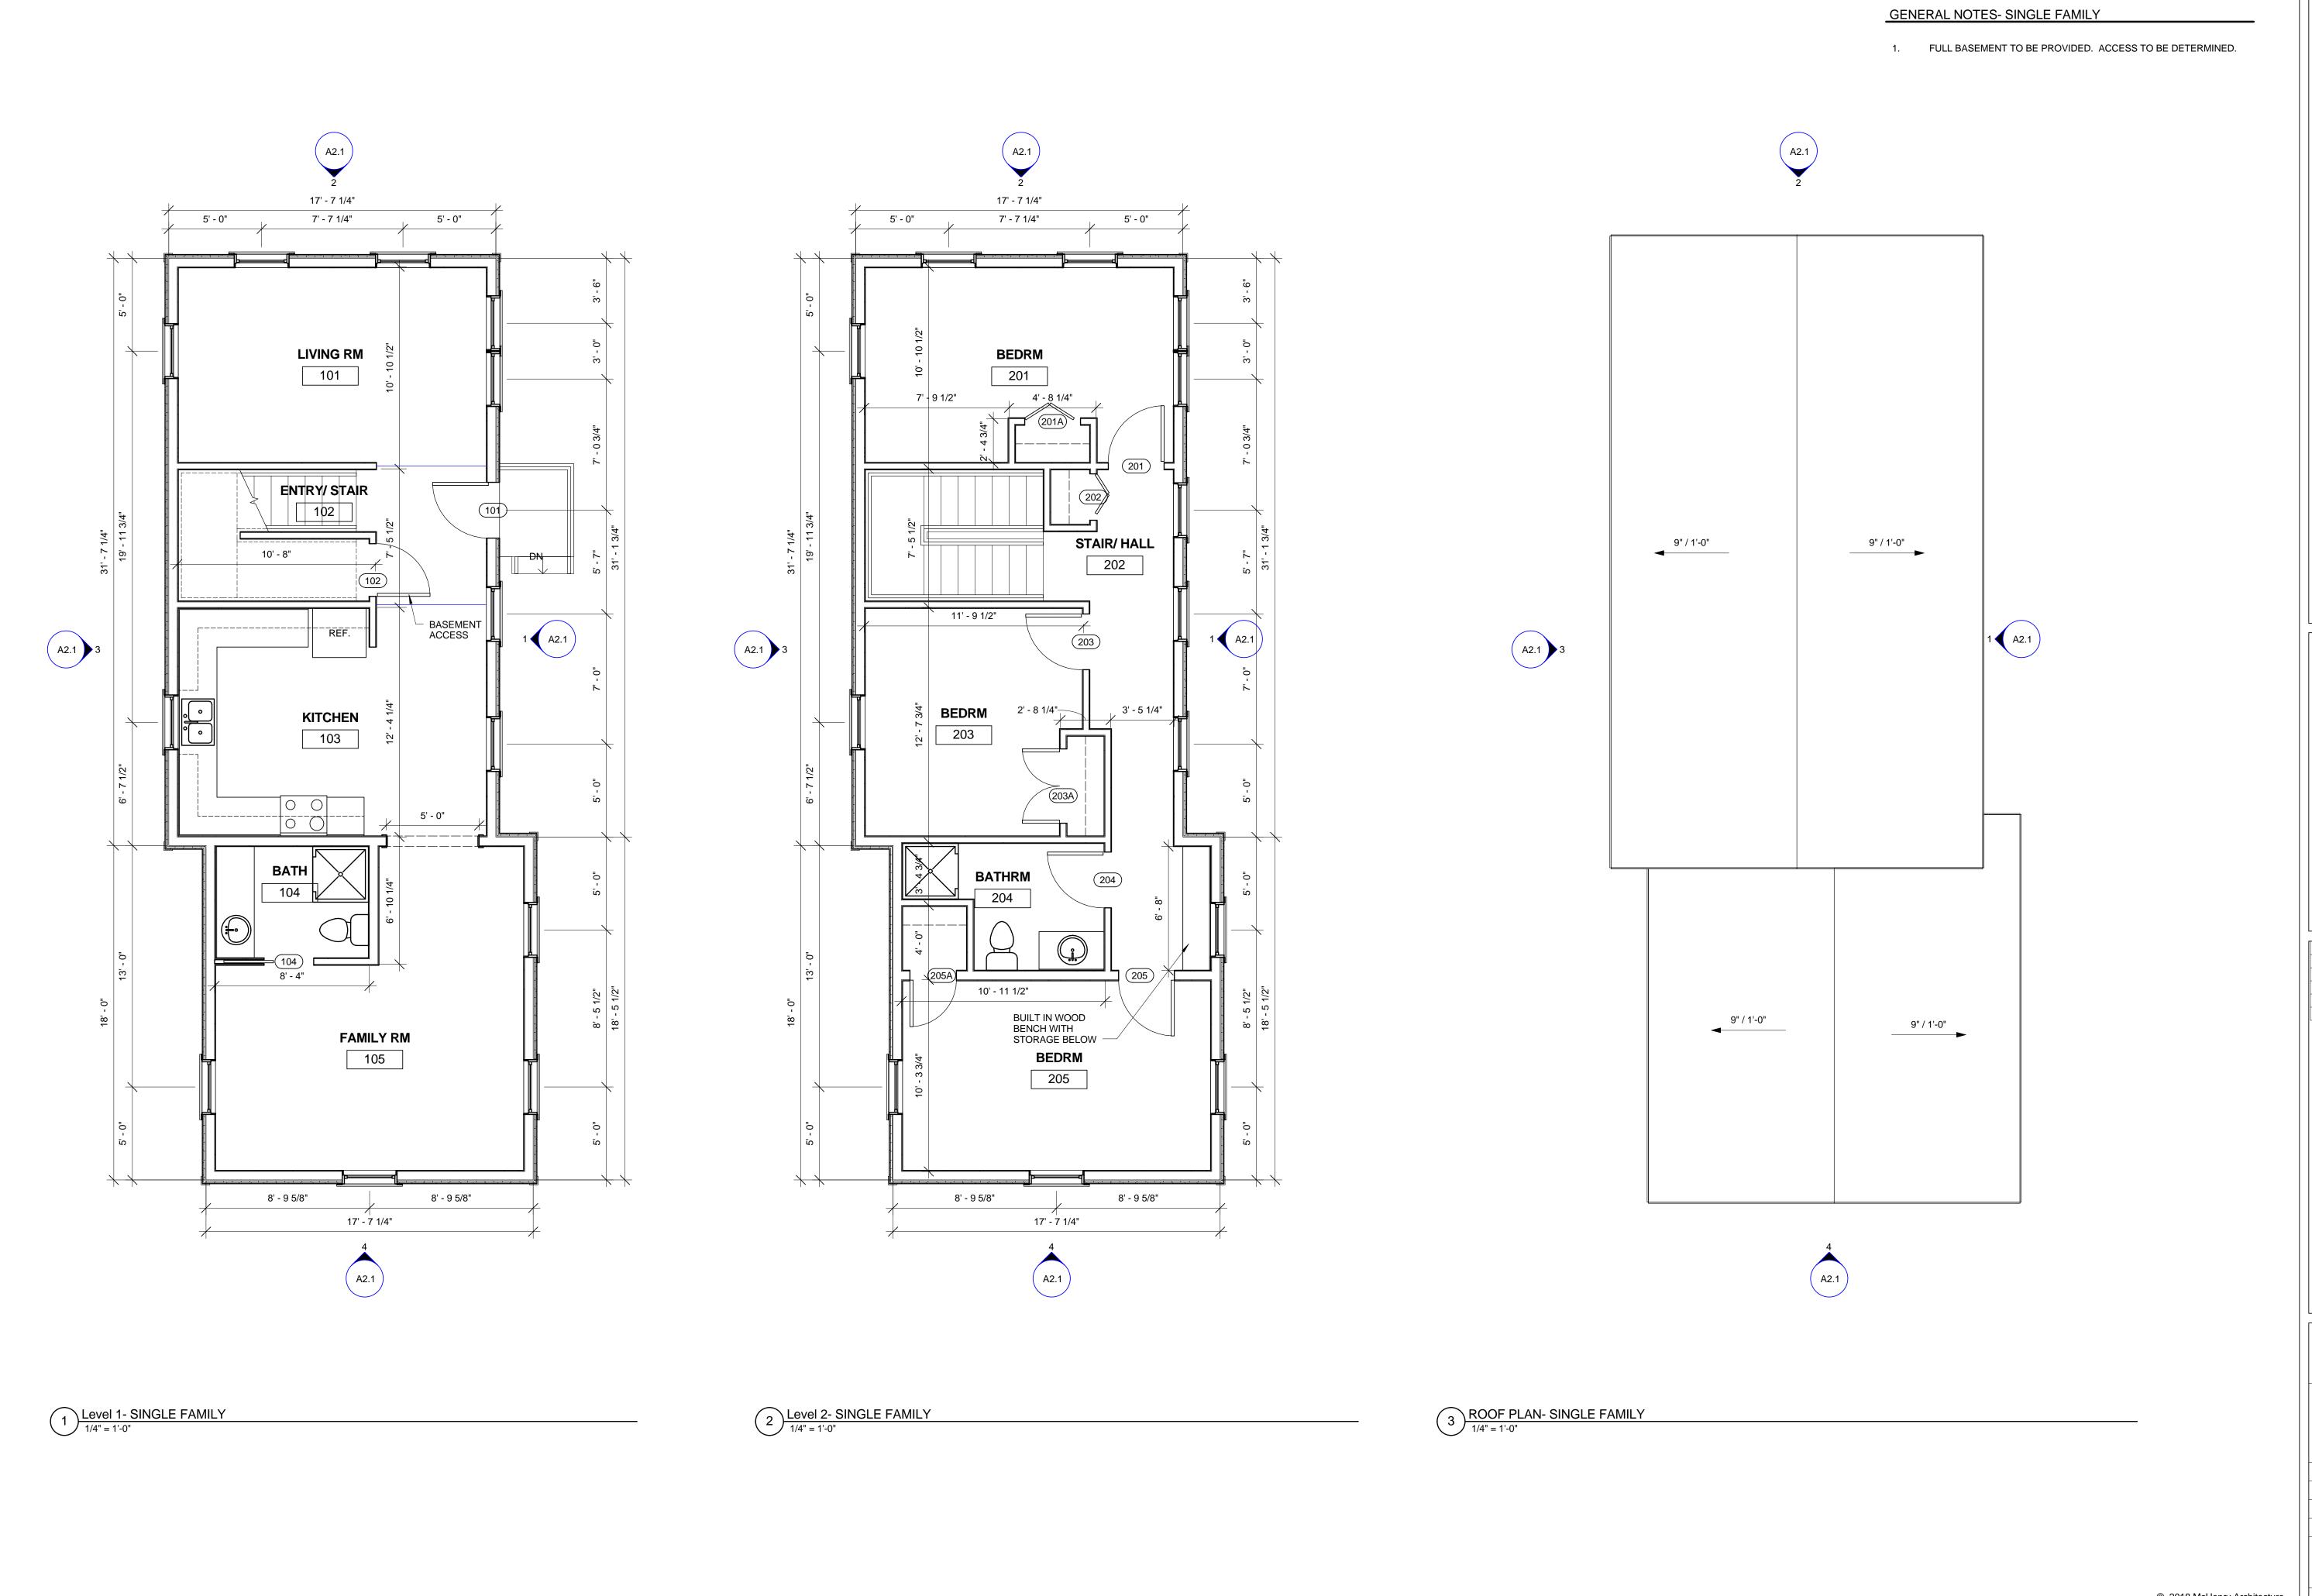

I Natasha Goyette Portsmouth, NH

McHENRY ARCHITECTURE

4 Market Street Portsmouth, New Hampshire 603.430.0274

NOT FOR CONSTRUCTION REVIEW SET ONLY

No.	Description	Da

160-170 Union Street Drawing Name: SINGLE FAMILY FLOOR PLANS 16093 Project number: 09/04/2019 Drawn by: MB Checked by:

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As indicated



160-170 Union Street Matthew and Natasha Goyette Portsmouth, NH

McHENRY ARCHITECTURE

4 Market Street Portsmouth, New Hampshire 603.430.0274

NOT FOR CONSTRUCTION REVIEW SET ONLY

No.	Description	Date

Project Name:
160-170 Union Street

Drawing Name:
EXTERIOR ELEVATIONSSINGLE FAMILY

Project number: 16093

Drawn by:
Checked by:

© 2018 McHenry Architecture

09/04/2019 MB JJ 1/4" = 1'-0"





160-170 Union Street
Matthew and Natasha Goyette

McHENRY ARCHITECTURE

4 Market Street Portsmouth, New Hampshire 603.430.0274

NOT FOR CONSTRUCTION REVIEW SET ONLY

No. Description Date

Project Name: 160-170 Union Street

Drawing Name:

EXTERIOR ELEVATIONS-APARTMENT (OPTION 2)

Project number: 16093

Date: 09/04/2019

Drawn by: MB

Checked by: JJ

A3.1

Scale: 1/4" = 1'-0"

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