

133 Court Street Portsmouth, NH 03801-4413

Juliet T. H. Walker, AICP, Planning Director City of Portsmouth Municipal Complex Planning Department 1 Junkins Avenue Portsmouth, New Hampshire 03801

Re: Application for Site Plan Approval Assessor's Map 145, Lot 292 32 Union Street Altus Project #P4972

Dear Juliet:

On behalf of Gwyn Burdell and Francis Delbene, Altus Engineering, Inc. (Altus) respectfully submits an application for Site Plan Review for the development of a one car garage and an apartment above at 32 Union Street where an existing duplex exists and will remain. The applicants obtained variances from the Board of Adjustment to allow for the project to proceed.

On November 5th, the Technical Advisory Committee voted to recommend approval to the Planning Board. Altus has revised the plans as recommended. The revisions include:

- Increasing the sewer service size from 4" to 6";
- Identify that parking stalls 1 and 2 will be assigned to the garage apartment. This is noted on site plan note 21.
- Modify the design to provide overhead electric and tele-communications services which requires a waiver.
- Realign the gas service to be more direct to the new building.

Enclosed please find two copies of the following:

- Site Plans (1 full sized, 1 reduced);
- Waiver request for overhead electrical service;
- Drainage memorandum;

Altus looks forward to presenting this project at the November 21st Planning Board hearing. Please call us if you have any questions or need any additional information.

\$incerely,

President

wde/4972 PB cvr ltr Enclosure

Ecopy: Frank Delbene and Gwyn Burdell

Tel: (603) 433-2335 E-mail: Altus@altus-eng.com

133 Court Street Portsmouth, NH 03801-4413

WAIVER REQUESTS Assessor's Map 145, Lot 292 32 Union Street

November 8, 2019

On behalf of Gwyn Burdell and Frank Delbene, Altus Engineering, Inc. request the following a waiver from the City of Portsmouth, New Hampshire Site Plan Review Regulations.

Article 8 Utility Standards
Section 8.1.2 All new and relocated wires, conduits and cables shall be located underground

The project was presented to the Technical Advisory Committee (TAC) having the proposed electrical, tele-communications, and cable services serviced underground from the utility pole on the east side of Union Street. TAC requested that we redesign the services to locate them overhead. TAC's reasoning is that Union Street at some point in the future will be reconstructed. The Department of Public Works would prefer not to have the utility services interfering with any potential new utility services in the street. Additionally, DPW indicated that the majority of the properties in this area is serviced with overhead utilities.

Wde/4972 waiver



City of Portsmouth, New Hampshire Site Plan Application Checklist

This site plan application checklist is a tool designed to assist the applicant in the planning process and for preparing the application for Planning Board review. A pre-application conference with a member of the planning department is strongly encouraged as additional project information may be required depending on the size and scope. The applicant is cautioned that this checklist is only a guide and is not intended to be a complete list of all site plan review requirements. Please refer to the Site Plan review regulations for full details.

Applicant Responsibilities (Section 2.5.2): Applicable fees are due upon application submittal along with required attachments. The application shall be complete as submitted and provide adequate information for evaluation of the proposed site development. Waiver requests must be submitted in writing with appropriate justification.

Name of Owner/Applicant: Frank Delbene & Gwyn Burde	II	Date Subn	nitted: _10	0/21/19		
Phone Number: 603-812-8379	E-mail: _	burdie110	7@hotmi	l.com		
Site Address: 32 Union Street			M	ap: <u>145</u>	_Lot: _2	.9
Zoning District: GRC	Lot area: _5	5,529	sq. ft.			

	Application Requirements					
V	Required Items for Submittal	Item Location (e.g. Page or Plan Sheet/Note #)	Waiver Requested			
	Fully executed and signed Application form. (2.5.2.3)	Application	N/A			
X	All application documents, plans, supporting documentation and other materials provided in digital Portable Document Format (PDF). (2.5.2.8)	Application package	N/A			

	Site Plan Review Application Required Information					
$\overline{\mathbf{A}}$	Required Items for Submittal Item Location					
		(e.g. Page/line or	Requested			
		Plan Sheet/Note #)	-			
X	Statement that lists and describes "green" building components and	In application package				
	systems.	m application package				
	(2.5.3.1A)					
X	Gross floor area and dimensions of all buildings and statement of		N/A			
	uses and floor area for each floor.	Architectural plans				
	(2.5.3.1B)					
X	Tax map and lot number, and current zoning of all parcels under Site	Title block, all civil sheets	N/A			
	Plan Review.	Title block, all civil sileets				
	(2.5.3.1C)					
X	Owner's name, address, telephone number, and signature. Name,	Cover sheet, application	N/A			
	address, and telephone number of applicant if different from owner.	package, above				
	(2.5.3.1D)					

Site Plan Application Checklist/April 2019

	Site Plan Review Application Required Info	ormation	
V	Required Items for Submittal	Item Location	Waiver
		(e.g. Page/line or Plan Sheet/Note #)	Requested
X	Names and addresses (including Tax Map and Lot number and zoning districts) of all direct abutting property owners (including properties located across abutting streets) and holders of existing conservation, preservation or agricultural preservation restrictions affecting the subject property.	Existing Conditions Plan, middle right	N/A
\square	(2.5.3.1E) Names, addresses and telephone numbers of all professionals involved in the site plan design. (2.5.3.1F)	Cover sheet, plan title block	N/A
X	List of reference plans. (2.5.3.1G)	Existing Conditions Plan, middle right	N/A
X	List of names and contact information of all public or private utilities servicing the site. (2.5.3.1H)	Demolition notes 16 thru 19.	N/A

	Site Plan Specifications				
	Required Items for Submittal	Item Location	Waiver		
		(e.g. Page/line or	Requested		
		Plan Sheet/Note #)			
X	Full size plans shall not be larger than 22 inches by 34 inches with	Required on all plan	N/A		
	match lines as required, unless approved by the Planning Director.	sheets			
	Submittals shall be a minimum of 11 inches by 17 inches as specified				
	by Planning Dept. staff. (2.5.4.1A)				
\mathbf{x}	Scale: Not less than 1 inch = 60 feet and a graphic bar scale shall be	Required on all plan	N/A		
	included on all plans.	sheets			
	(2.5.4.1B)				
x	GIS data should be referenced to the coordinate system New	Existing conditions plan,	N/A		
	Hampshire State Plane, NAD83 (1996), with units in feet.	note 6			
	(2.5.4.1C)				
X	Plans shall be drawn to scale.	Required on all plan	N/A		
	(2.5.4.1D)	sheets			
$\overline{\mathbf{x}}$	Plans shall be prepared and stamped by a NH licensed civil engineer.	Excluding survey plan	N/A		
	(2.5.4.1D)	and architectural plan			
X	Wetlands shall be delineated by a NH certified wetlands scientist	NA - no wetlands on lot	N/A		
	and so stamped. (2.5.4.1E)				
X	Title (name of development project), north point, scale, legend.	Title block, all sheets, scale & north all sheets excluding	N/A		
	(2.5.4.2A)	details, legend ec plan			
x	Date plans first submitted, date and explanation of revisions.	C	N/A		
	(2.5.4.2B)	Cover sheet, title block			
X	Individual plan sheet title that clearly describes the information that	Required on all plan	N/A		
	is displayed.	sheets			
	(2.5.4.2C)				
X	Source and date of data displayed on the plan.	Existing conditions plan	N/A		
	(2.5.4.2D)				

	Site Plan Specifications		
V	Required Items for Submittal	Item Location (e.g. Page/line or Plan Sheet/Note #)	Waiver Requested
	A note shall be provided on the Site Plan stating: "All conditions on this Plan shall remain in effect in perpetuity pursuant to the requirements of the Site Plan Review Regulations." (2.5.4.2E)	Note 15, sheet C-1	N/A
	Plan sheets submitted for recording shall include the following notes: a. "This Site Plan shall be recorded in the Rockingham County Registry of Deeds." b. "All improvements shown on this Site Plan shall be constructed and maintained in accordance with the Plan by the property owner and all future property owners. No changes shall be made to this Site Plan without the express approval of the Portsmouth Planning Director." (2.13.3)	Site Plan, sheet C-1 Note 13 Note 12	N/A
X	Plan sheets showing landscaping and screening shall also include the following additional notes: a. "The property owner and all future property owners shall be responsible for the maintenance, repair and replacement of all required screening and landscape materials." b. "All required plant materials shall be tended and maintained in a healthy growing condition, replaced when necessary, and kept free of refuse and debris. All required fences and walls shall be maintained in good repair." c. "The property owner shall be responsible to remove and replace dead or diseased plant materials immediately with the same type, size and quantity of plant materials as originally installed, unless alternative plantings are requested, justified and approved by the Planning Board or Planning Director." (2.13.4)	Site Plan, sheet C-1 Notes 16 thru 18	N/A

	Site Plan Specifications – Required Exhibits and Data					
Ø	Required Items for Submittal	Item Location (e.g. Page/line or Plan Sheet/Note #)	Waiver Requested			
	1. Existing Conditions: (2.5.4.3A)	,				
X	a. Surveyed plan of site showing existing natural and built features;	Existing Conditions Plan				
X	b. Zoning boundaries;	None - all in GRC district				
	c. Dimensional Regulations;	Existing Conditions Plan				
\mathbf{x}	d. Wetland delineation, wetland function and value assessment;	NA				
Ţ	e. SFHA, 100-year flood elevation line and BFE data.	Note 8 Existing Conditions Plan				
	2. Buildings and Structures: (2.5.4.3B)					
X	 Plan view: Use, size, dimensions, footings, overhangs, 1st fl. elevation; 	Sheet A1				
X	 Elevations: Height, massing, placement, materials, lighting, façade treatments; 	Sheet A1				
Ŋ	c. Total Floor Area;	Site Plan, Sheet C-1 - in building				
$\sqrt{\mathbf{x}}$	d. Number of Usable Floors;	Sheet A1				
x	e. Gross floor area by floor and use.	Site Plan, Sheet C-1				
	3. Access and Circulation: (2.5.4.3C)					
X	a. Location/width of access ways within site;	Site Plan, Sheet C-1				
X	 b. Location of curbing, right of ways, edge of pavement and sidewalks; 	Site Plan, Sheet C-1				
X	 Location, type, size and design of traffic signing (pavement markings); 	None				
X	d. Names/layout of existing abutting streets;	Site Plan, Sheet C-1				
X	e. Driveway curb cuts for abutting prop. and public roads;	Site Plan, sheet C-1				
X	 f. If subdivision; Names of all roads, right of way lines and easements noted; 	NA				
X	 g. AASHT0 truck turning templates, description of minimum vehicle allowed being a WB-50 (unless otherwise approved by TAC). 	NA				
	4. Parking and Loading: (2.5.4.3D)					
X	 a. Location of off street parking/loading areas, landscaped areas/buffers; 	Site Plan, Sheet C-1				
\mathbf{x}	b. Parking Calculations (# required and the # provided).	Site Plan, Sheet C-1, top right				
	5. Water Infrastructure: (2.5.4.3E)					
X	 Size, type and location of water mains, shut-offs, hydrants & Engineering data; 	Utilities Plan, Sheet C-2				
X	b. Location of wells and monitoring wells (include protective radii).	NA				
	6. Sewer Infrastructure: (2.5.4.3F)					
X	 Size, type and location of sanitary sewage facilities & Engineering data. 	Utilities Plan, Sheet C-2				
	7. Utilities: (2.5.4.3G)					
X	a. The size, type and location of all above & below ground utilities;	Utilities Plan, sheet C-2				
X	 Size type and location of generator pads, transformers and other fixtures. 	Utilities Plan, Sheet C-2				

	Site Plan Specifications – Required Exhibits and Data					
V	Required Items for Submittal	Item Location (e.g. Page/line or Plan Sheet/Note #)	Waiver Requested			
X	8. Solid Waste Facilities: (2.5.4.3H)					
X	a. The size, type and location of solid waste facilities.	Note 19, Sheet C-1				
	9. Storm water Management: (2.5.4.3I)					
X	a. The location, elevation and layout of all storm-water drainage.	Grading Plan, sheet C-3				
	10. 0 utdoor Lighting: (2.5.4.3J)					
X	a. Type and placement of all lighting (exterior of building, parking lot and any other areas of the site) and;b. photometric plan.	Building mounted only, Note 19, Site Plan, Sheet C-1				
X	 Indicate where dark sky friendly lighting measures have been implemented. (10.1) 	Note 19, Site Plan, Sheet C-1				
	12. Landscaping: (2.5.4.3K)					
X	 a. Identify all undisturbed area, existing vegetation and that which is to be retained; 	Grading Plan, Sheet C-3				
X	b. Location of any irrigation system and water source.	Site Plan, Sheet C-1, Note 20				
	13. Contours and Elevation: (2.5.4.3L)					
X	 a. Existing/Proposed contours (2 foot minimum) and finished grade elevations. 	Grading Plan, Sheet C-3				
	14. 0 pen Space: (2.5.4.3M)					
X	a. Type, extent and location of all existing/proposed open space.	Site Plan, Sheet C-1				
X	 All easements, deed restrictions and non-public rights of ways. (2.5.4.3N) 	NA				
X	Location of snow storage areas and/or off-site snow removal. (2.5.4.30)	Site Plan, Sheet C-1 and Note 8				
X	17. Character/Civic District (All following information shall be included): (2.5.4.30)	NA				
	a. Applicable Building Height (10.5A21.20 & 10.5A43.30);					
	b. Applicable Special Requirements (10.5A21.30);					
	c. Proposed building form/type (10.5A43);					
	d. Proposed community space (10.5A46).					

	Other Required Information					
	Required Items for Submittal	Item Location	Waiver			
		(e.g. Page/line or Plan Sheet/Note #)	Requested			
X	Traffic Impact Study or Trip Generation Report, as required. (Four (4) hardcopies of the full study/report and Six (6) summaries to be submitted with the Site Plan Application) (3.2.1-2)	NA				
X	Indicate where Low Impact Development Design practices have been incorporated. (7.1)	See green statement, application package				
X	Indicate whether the proposed development is located in a wellhead protection or aquifer protection area. Such determination shall be approved by the Director of the Dept. of Public Works. (7.3.1)	NA - project not in wellhead protection district				
X	Indicate where measures to minimize impervious surfaces have been implemented. (7.4.3)	See green statement, application package				
X	Calculation of the maximum effective impervious surface as a percentage of the site. (7.4.3.2)	See drainage memorandum				
X	Stormwater Management and Erosion Control Plan. (Four (4) hardcopies of the full plan/report and Six (6) summaries to be submitted with the Site Plan Application) (7.4.4.1)	Application package				

	Final Site Plan Approval Required Information				
\square	Required Items for Submittal	Item Location	Waiver		
		(e.g. Page/line or	Requested		
		Plan Sheet/Note #)			
X	All local approvals, permits, easements and licenses required,	variance relief stated on cover			
	including but not limited to:	sheet and site plan			
	a. Waivers;	1			
	b. Driveway permits;				
	c. Special exceptions;				
	d. Variances granted;				
	e. Easements;				
	f. Licenses.				
_	(2.5.3.2A)				
X	Exhibits, data, reports or studies that may have been required as	a. drainage computations in			
	part of the approval process, including but not limited to:	application			
	a. Calculations relating to stormwater runoff;	b. one bedroom apartment,			
	b. Information on composition and quantity of water demand	70 gpd/occupant			
	and wastewater generated;c. Information on air, water or land pollutants to be	d. NA			
	 Information on air, water or land pollutants to be discharged, including standards, quantity, treatment 	e. NA			
	and/or controls:	f. drainage computations			
	d. Estimates of traffic generation and counts pre- and post-	g. NA h. NA			
	construction;	i. NA			
	e. Estimates of noise generation;				
	f. A Stormwater Management and Erosion Control Plan;				
	g. Endangered species and archaeological / historical studies;				
	h. Wetland and water body (coastal and inland) delineations;				
	i. Environmental impact studies.				
	(2.5.3.2B)				
	·				

	Final Site Plan Approval Required Information					
Ø	Required Items for Submittal	Item Location (e.g. Page/line or Plan Sheet/Note #)	Waiver Requested			
X	A document from each of the required private utility service providers indicating approval of the proposed site plan and indicating an ability to provide all required private utilities to the site. (2.5.3.2D)	To be provided				
X	A list of any required state and federal permit applications required for the project and the status of same. (2.5.3.2E)	None required				

Applicant's Signature:	Eric D. Weinrieb, PE	Date: _	10/16/19
	Fig. D. Wainrigh. P.		

PROPOSED 1-UNIT APARTMENT

FOR

FRANK DELBENE

&

GWYN BURDELL

32 Union Street

Portsmouth, New Hampshire

Assessor's Parcel 145-29

OCTOBER 21, 2019 NOVEMBER 8, 2019

Issued for TAC Issued for PB

Sheet Index

Existing Conditions Plan (by James Verra and Assoc., Inc.)

Architectural Floor Plans and Elevations (Newmarket Plains, LLC)

Title

Site Plan

Utilities Plan

Grading Plan

Detail Sheet

Owner/Applicant:

Frank Delbene Gwyn Burdell

165 Grant Avenue Portsmouth, NH 03801


Sur veyor:

James Verra and Associates, Inc.

LAND SURVEYORS


101 SHATTUCK WAY - SUITE 8 NEWINGTON, N.H. 03801- 7876

Civil Engineer:

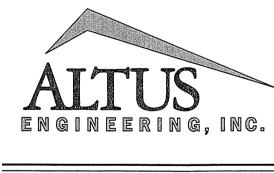

(603) 433-2335 www.ALTUS-ENG.com

Building Designer: NEWMARKET PLAINS, LLC 443 Wadleigh Falls Road Newmarket, NH 03857

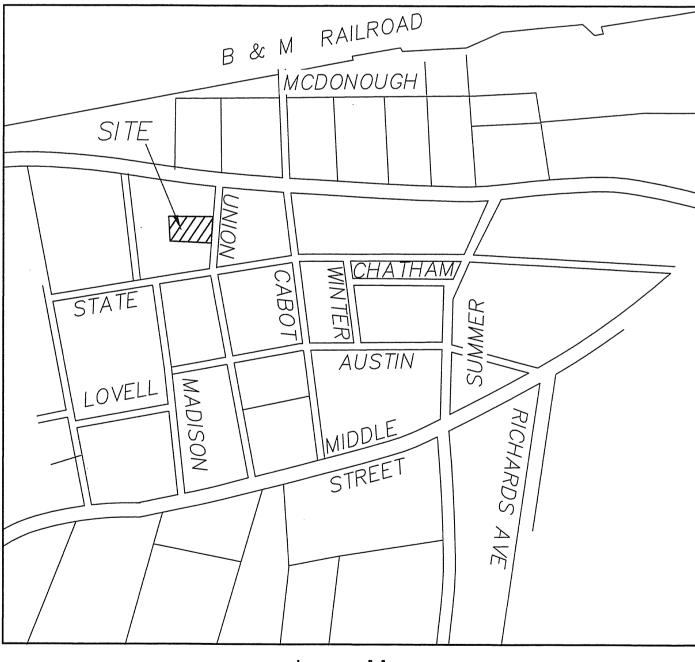

Locus Map Scale: Not to Scale

Permit Summary

Zoning Relief — The following Variances were Granted on June 19, 2018:

Section 10.521 to allow the construction of a 26' x 32' carriage house with a third dwelling with a lot area per dwelling unit of $\pm 1,887$ sf where 3,500 sf is required and a ± 6 -foot rear yard where 20-feet is required.

Zoning Relief — The following Variance was Granted on July 16, 2019: Section 10.521 to allow a lot area per dwelling unit of 1,843 sf where 3,500 sf is required.

Sheet

1 OF 1

C-1

No.: Rev.

Date

05/15/19


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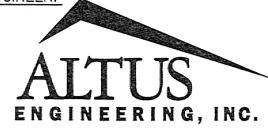
SURVEYOR: James Verra and

LAND SURVEYORS

Associates, Inc.

101 SHATTUCK WAY - SUITE 8 NEWINGTON, N.H. 03801- 7876 603-436-3557 JOB NO: 23793 PLAN NO: 23793

ENGINEER:

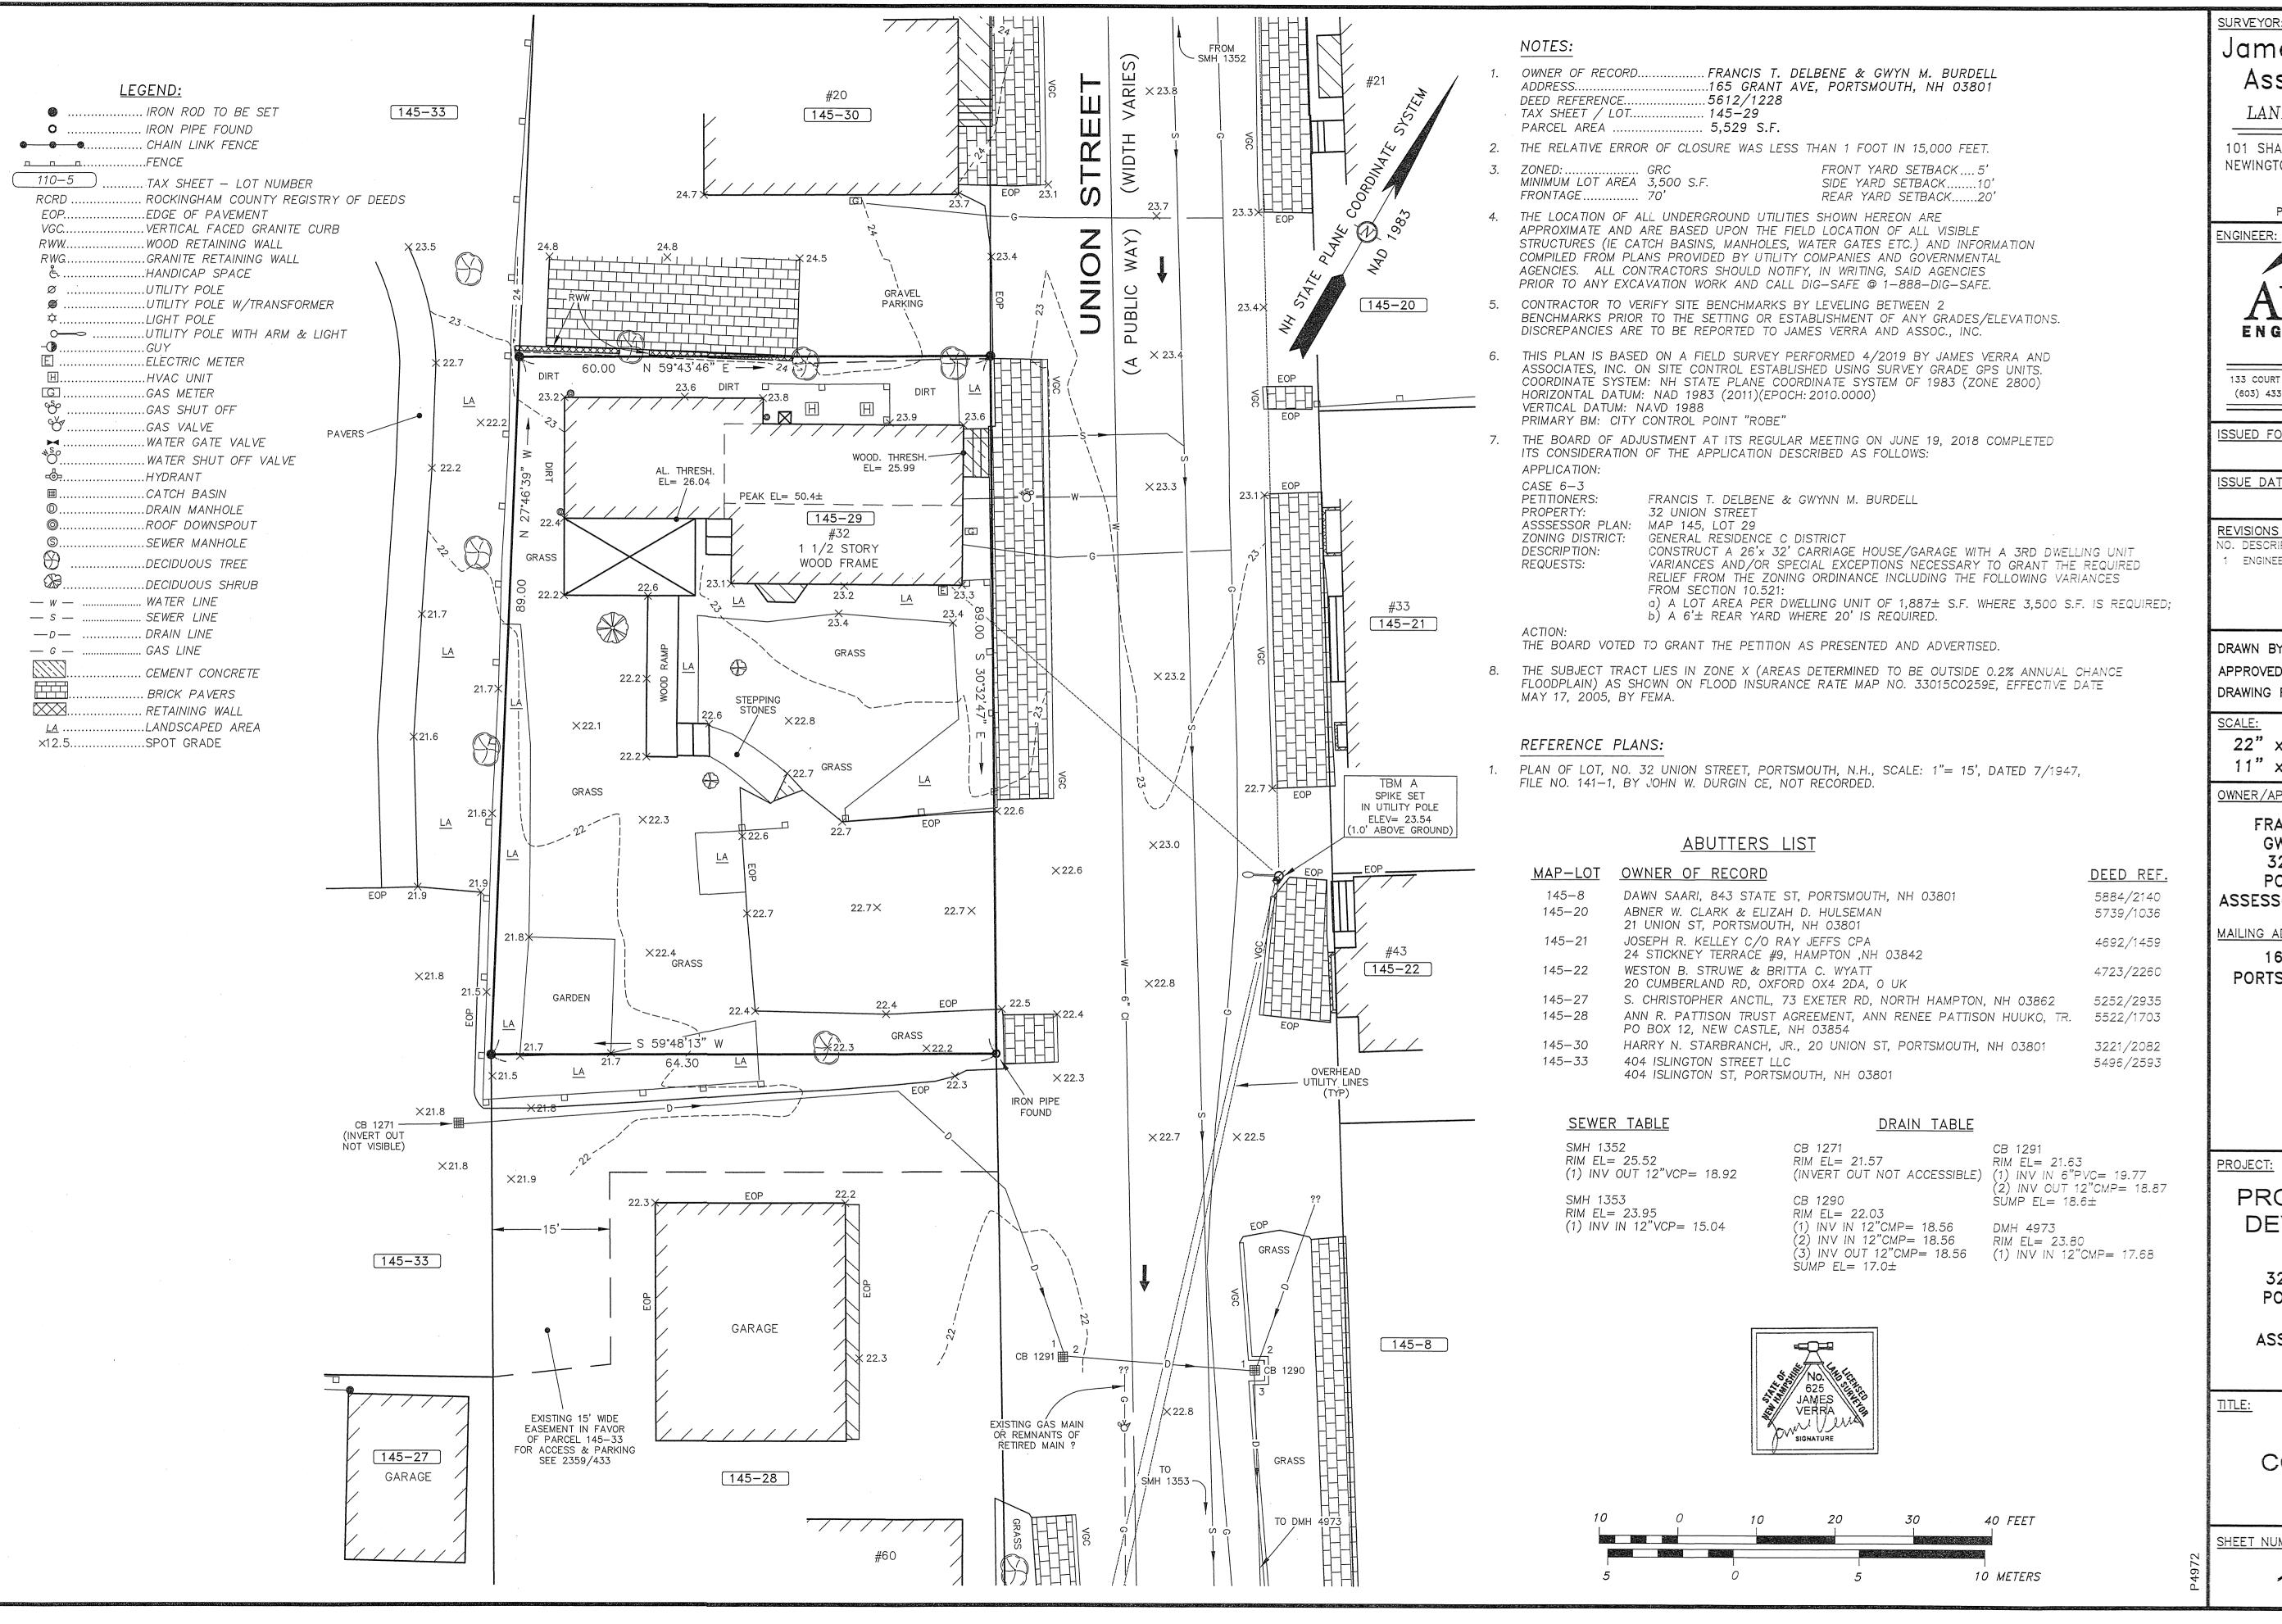

133 COURT STREET PORTSMOUTH, NH 03801 (603) 433-2335 www.ALTUS-ENG.com

ISSUED FOR:

ENGINEERING DESIGN

ISSUE DATE:

MAY 15, 2019

IO. DESCRIPTION ENGINEERING DESIGN JV 5/15/19

<u>JCS</u> DRAWN BY: APPROVED BY: 23793.DWG DRAWING FILE:

 $22" \times 34" - 1" = 10"$ $11" \times 17" - 1" = 20"$

OWNER/APPLICANT:

FRANCIS T. DELBENE GWYN M. BURDELL 32 UNION STREET PORTSMOUTH, N.H. ASSESSOR'S PARCEL 145-29

MAILING ADDRESS

165 GRANT AVENUE PORTSMOUTH, N.H. 03801

PROJECT:

PROPOSED SITE DEVELOPMENT **PLANS**


32 UNION STREET PORTSMOUTH, N.H.

ASSESSOR'S PARCEL 145-29

EXISTING CONDITIONS PLAN

SHEET NUMBER:

OF 1

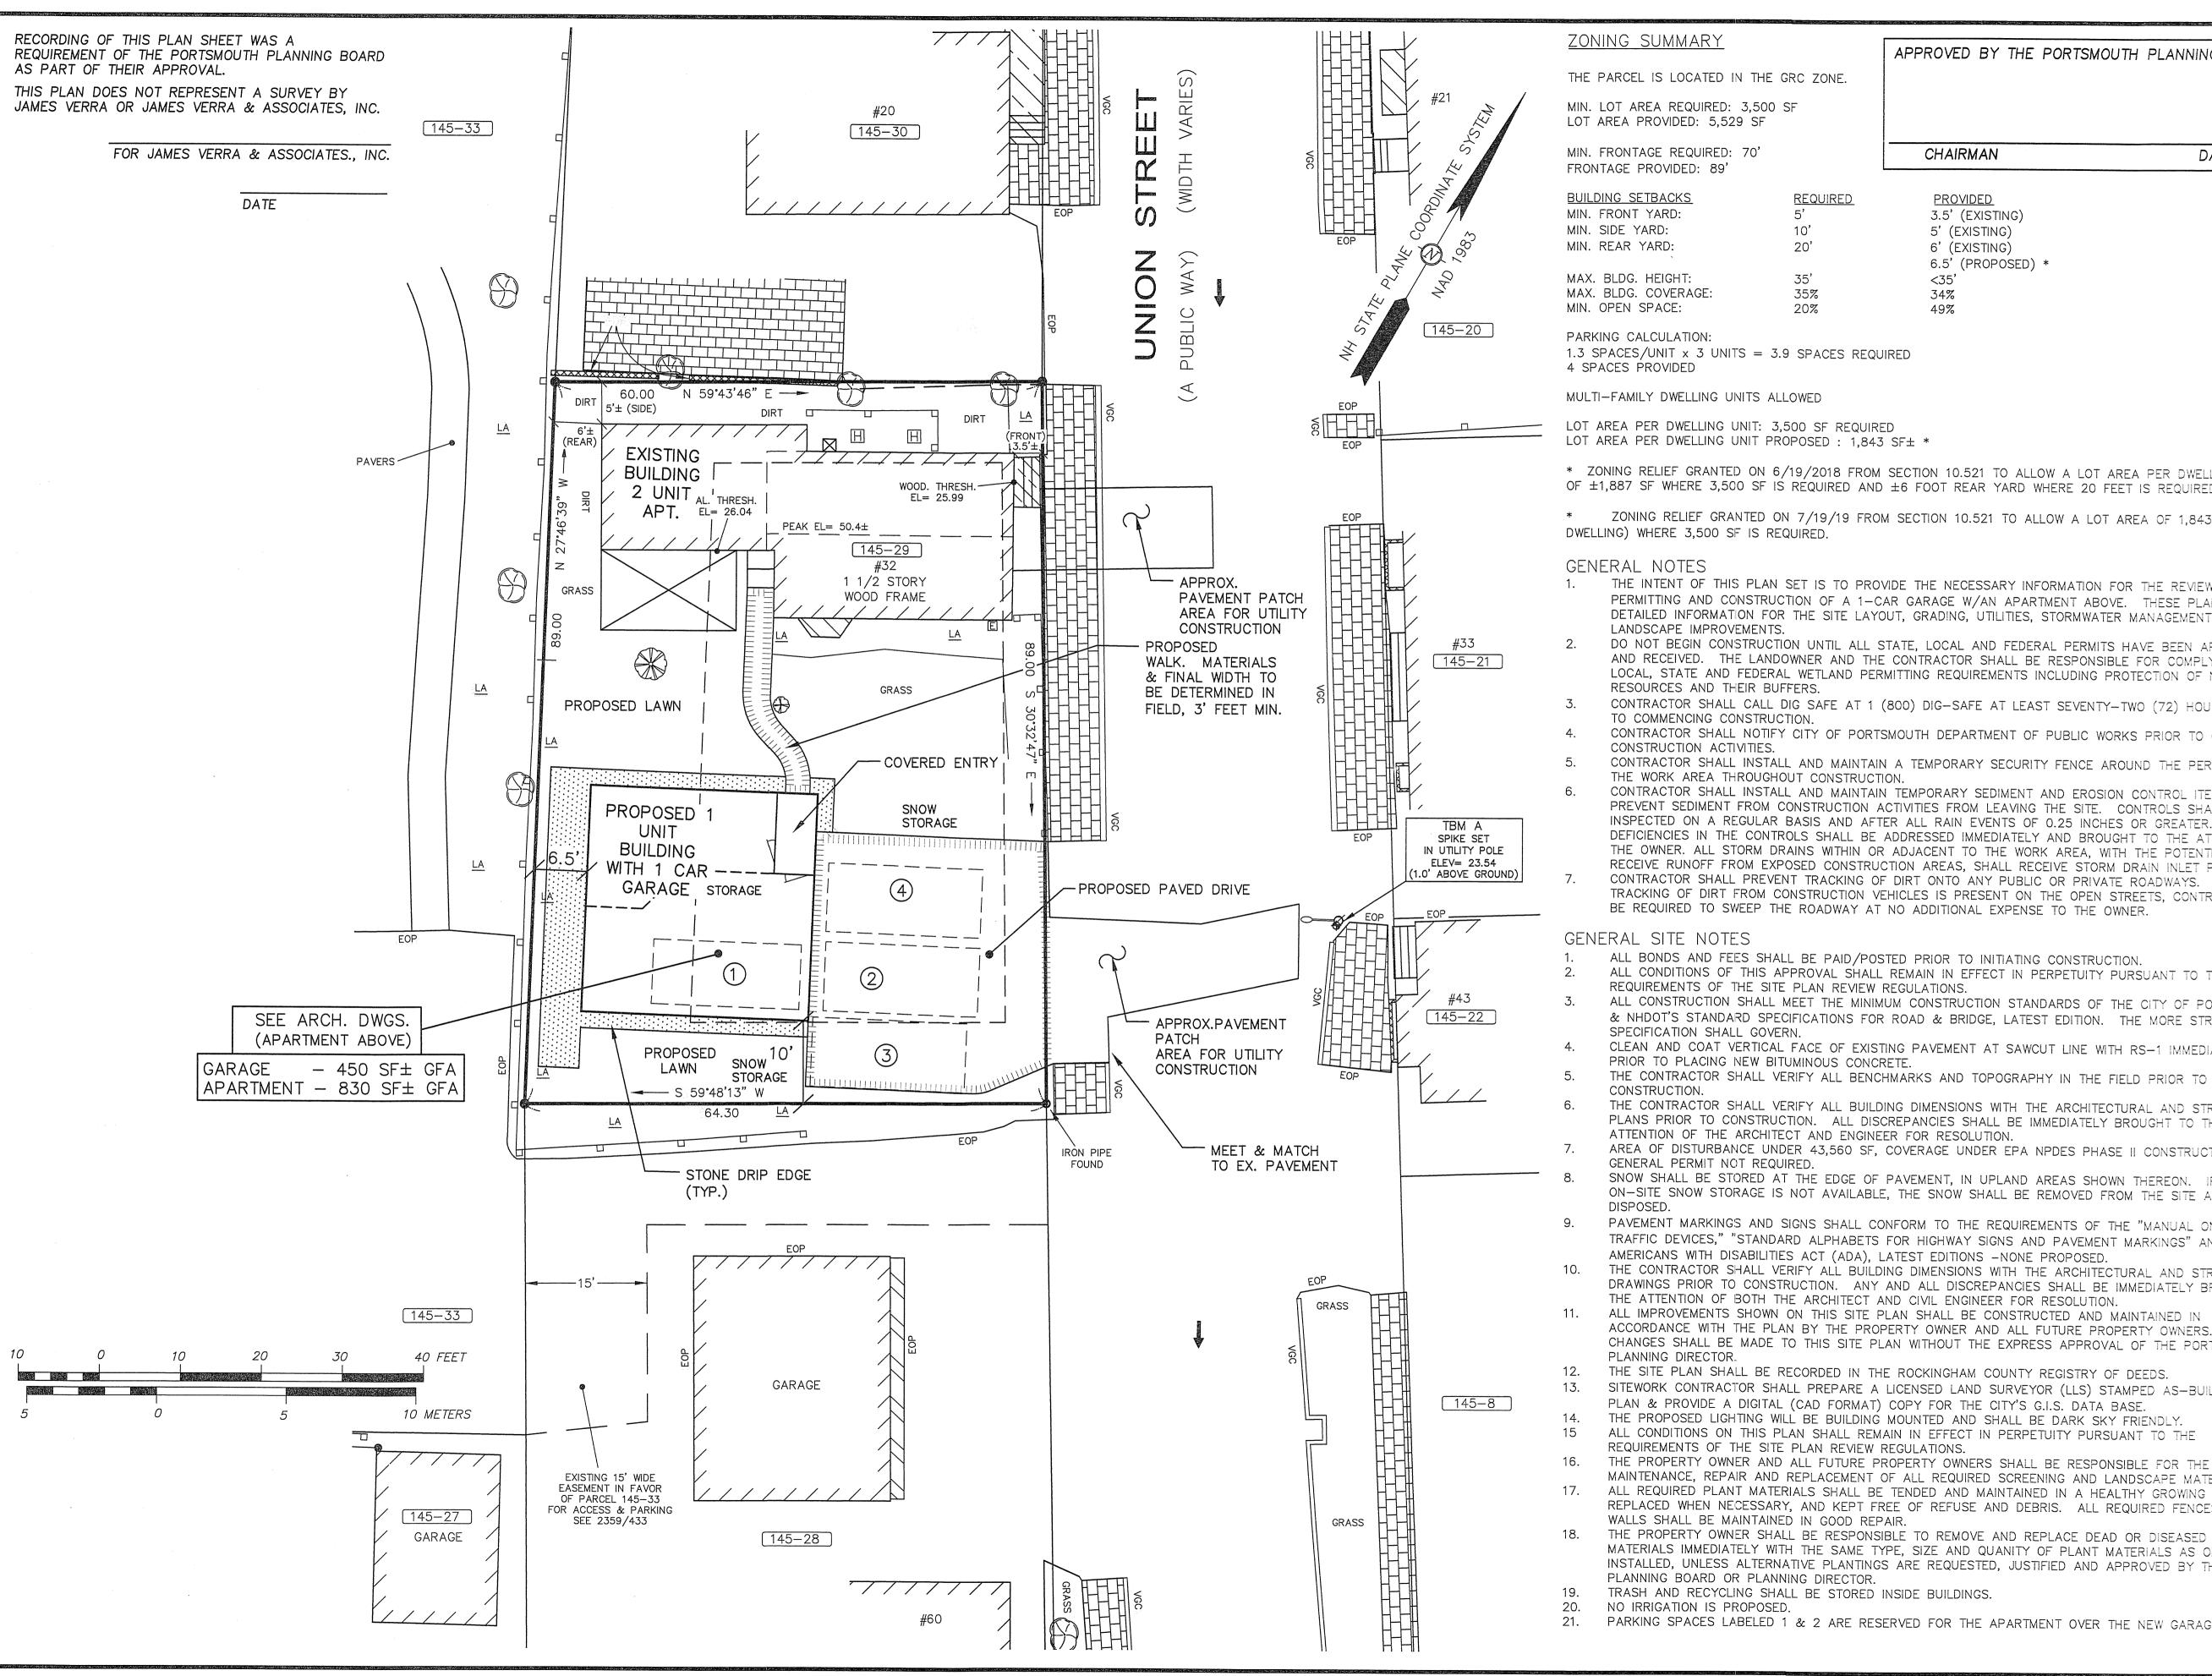

ZONING SUMMARY

MIN. LOT AREA REQUIRED: 3.500 SF LOT AREA PROVIDED: 5,529 SF

MIN. FRONTAGE REQUIRED: 70' FRONTAGE PROVIDED: 89'

BUILDING SETBACKS REQUIRED MIN. FRONT YARD: MIN. REAR YARD: 20' MAX. BLDG. HEIGHT:

PARKING CALCULATION: 1.3 SPACES/UNIT x 3 UNITS = 3.9 SPACES REQUIRED

35%

20%

MULTI-FAMILY DWELLING UNITS ALLOWED

LOT AREA PER DWELLING UNIT: 3,500 SF REQUIRED LOT AREA PER DWELLING UNIT PROPOSED : 1,843 SF± *

* ZONING RELIEF GRANTED ON 6/19/2018 FROM SECTION 10.521 TO ALLOW A LOT AREA PER DWELLING UNIT OF $\pm 1,887$ SF WHERE 3,500 SF IS REQUIRED AND ± 6 FOOT REAR YARD WHERE 20 FEET IS REQUIRED

* ZONING RELIEF GRANTED ON 7/19/19 FROM SECTION 10.521 TO ALLOW A LOT AREA OF 1,843 SF (PER DWELLING) WHERE 3,500 SF IS REQUIRED

CHAIRMAN

PROVIDED

3.5' (EXISTING)

5' (EXISTING)

6' (EXISTING) 6.5' (PROPOSED)

34%

49%

GENERAL NOTES

- THE INTENT OF THIS PLAN SET IS TO PROVIDE THE NECESSARY INFORMATION FOR THE REVIEW, PERMITTING AND CONSTRUCTION OF A 1-CAR GARAGE W/AN APARTMENT ABOVE. THESE PLANS PROVIDE DETAILED INFORMATION FOR THE SITE LAYOUT, GRADING, UTILITIES, STORMWATER MANAGEMENT, AND LANDSCAPE IMPROVEMENTS.
- DO NOT BEGIN CONSTRUCTION UNTIL ALL STATE, LOCAL AND FEDERAL PERMITS HAVE BEEN APPLIED FOR AND RECEIVED. THE LANDOWNER AND THE CONTRACTOR SHALL BE RESPONSIBLE FOR COMPLYING WITH LOCAL, STATE AND FEDERAL WETLAND PERMITTING REQUIREMENTS INCLUDING PROTECTION OF NATURAL RESOURCES AND THEIR BUFFERS
- CONTRACTOR SHALL CALL DIG SAFE AT 1 (800) DIG-SAFE AT LEAST SEVENTY-TWO (72) HOURS PRIOR TO COMMENCING CONSTRUCTION.
- CONTRACTOR SHALL NOTIFY CITY OF PORTSMOUTH DEPARTMENT OF PUBLIC WORKS PRIOR TO COMMENCING CONSTRUCTION ACTIVITIES.
- CONTRACTOR SHALL INSTALL AND MAINTAIN A TEMPORARY SECURITY FENCE AROUND THE PERIMETER OF THE WORK AREA THROUGHOUT CONSTRUCTION.
- CONTRACTOR SHALL INSTALL AND MAINTAIN TEMPORARY SEDIMENT AND EROSION CONTROL ITEMS TO PREVENT SEDIMENT FROM CONSTRUCTION ACTIVITIES FROM LEAVING THE SITE. CONTROLS SHALL BE INSPECTED ON A REGULAR BASIS AND AFTER ALL RAIN EVENTS OF 0.25 INCHES OR GREATER. ANY DEFICIENCIES IN THE CONTROLS SHALL BE ADDRESSED IMMEDIATELY AND BROUGHT TO THE ATTENTION OF THE OWNER. ALL STORM DRAINS WITHIN OR ADJACENT TO THE WORK AREA, WITH THE POTENTIAL TO
- RECEIVE RUNOFF FROM EXPOSED CONSTRUCTION AREAS, SHALL RECEIVE STORM DRAIN INLET PROTECTION. CONTRACTOR SHALL PREVENT TRACKING OF DIRT ONTO ANY PUBLIC OR PRIVATE ROADWAYS. IF TRACKING OF DIRT FROM CONSTRUCTION VEHICLES IS PRESENT ON THE OPEN STREETS, CONTRACTOR WILL BE REQUIRED TO SWEEP THE ROADWAY AT NO ADDITIONAL EXPENSE TO THE OWNER.

GENERAL SITE NOTES

ALL BONDS AND FEES SHALL BE PAID/POSTED PRIOR TO INITIATING CONSTRUCTION

ALL CONDITIONS OF THIS APPROVAL SHALL REMAIN IN EFFECT IN PERPETUITY PURSUANT TO THE

REQUIREMENTS OF THE SITE PLAN REVIEW REGULATIONS.

ALL CONSTRUCTION SHALL MEET THE MINIMUM CONSTRUCTION STANDARDS OF THE CITY OF PORTSMOUTH & NHDOT'S STANDARD SPECIFICATIONS FOR ROAD & BRIDGE, LATEST EDITION. THE MORE STRINGENT SPECIFICATION SHALL GOVERN.


- CLEAN AND COAT VERTICAL FACE OF EXISTING PAVEMENT AT SAWCUT LINE WITH RS-1 IMMEDIATELY PRIOR TO PLACING NEW BITUMINOUS CONCRETE.
- THE CONTRACTOR SHALL VERIFY ALL BENCHMARKS AND TOPOGRAPHY IN THE FIELD PRIOR TO
- CONSTRUCTION.
- THE CONTRACTOR SHALL VERIFY ALL BUILDING DIMENSIONS WITH THE ARCHITECTURAL AND STRUCTURAL PLANS PRIOR TO CONSTRUCTION. ALL DISCREPANCIES SHALL BE IMMEDIATELY BROUGHT TO THE ATTENTION OF THE ARCHITECT AND ENGINEER FOR RESOLUTION.
- AREA OF DISTURBANCE UNDER 43,560 SF, COVERAGE UNDER EPA NPDES PHASE II CONSTRUCTION GENERAL PERMIT NOT REQUIRED.
- SNOW SHALL BE STORED AT THE EDGE OF PAVEMENT, IN UPLAND AREAS SHOWN THEREON. IF ADEQUATE ON-SITE SNOW STORAGE IS NOT AVAILABLE, THE SNOW SHALL BE REMOVED FROM THE SITE AND LEGALLY
- PAVEMENT MARKINGS AND SIGNS SHALL CONFORM TO THE REQUIREMENTS OF THE "MANUAL ON UNIFORM TRAFFIC DEVICES," "STANDARD ALPHABETS FOR HIGHWAY SIGNS AND PAVEMENT MARKINGS" AND THE AMERICANS WITH DISABILITIES ACT (ADA), LATEST EDITIONS -NONE PROPOSED.
- THE CONTRACTOR SHALL VERIFY ALL BUILDING DIMENSIONS WITH THE ARCHITECTURAL AND STRUCTURAL DRAWINGS PRIOR TO CONSTRUCTION. ANY AND ALL DISCREPANCIES SHALL BE IMMEDIATELY BROUGHT TO THE ATTENTION OF BOTH THE ARCHITECT AND CIVIL ENGINEER FOR RESOLUTION.
- ALL IMPROVEMENTS SHOWN ON THIS SITE PLAN SHALL BE CONSTRUCTED AND MAINTAINED IN ACCORDANCE WITH THE PLAN BY THE PROPERTY OWNER AND ALL FUTURE PROPERTY OWNERS. NO CHANGES SHALL BE MADE TO THIS SITE PLAN WITHOUT THE EXPRESS APPROVAL OF THE PORTSMOUTH PLANNING DIRECTOR.
- THE SITE PLAN SHALL BE RECORDED IN THE ROCKINGHAM COUNTY REGISTRY OF DEEDS.
- SITEWORK CONTRACTOR SHALL PREPARE A LICENSED LAND SURVEYOR (LLS) STAMPED AS-BUILT SITE PLAN & PROVIDE A DIGITAL (CAD FORMAT) COPY FOR THE CITY'S G.I.S. DATA BASE.
- THE PROPOSED LIGHTING WILL BE BUILDING MOUNTED AND SHALL BE DARK SKY FRIENDLY.
- ALL CONDITIONS ON THIS PLAN SHALL REMAIN IN EFFECT IN PERPETUITY PURSUANT TO THE
- REQUIREMENTS OF THE SITE PLAN REVIEW REGULATIONS.
- MAINTENANCE, REPAIR AND REPLACEMENT OF ALL REQUIRED SCREENING AND LANDSCAPE MATERIALS. ALL REQUIRED PLANT MATERIALS SHALL BE TENDED AND MAINTAINED IN A HEALTHY GROWING CONDITION, REPLACED WHEN NECESSARY, AND KEPT FREE OF REFUSE AND DEBRIS. ALL REQUIRED FENCES AND
- WALLS SHALL BE MAINTAINED IN GOOD REPAIR. THE PROPERTY OWNER SHALL BE RESPONSIBLE TO REMOVE AND REPLACE DEAD OR DISEASED PLANT MATERIALS IMMEDIATELY WITH THE SAME TYPE, SIZE AND QUANITY OF PLANT MATERIALS AS ORIGINALLY
- INSTALLED, UNLESS ALTERNATIVE PLANTINGS ARE REQUESTED, JUSTIFIED AND APPROVED BY THE PLANNING BOARD OR PLANNING DIRECTOR.
- TRASH AND RECYCLING SHALL BE STORED INSIDE BUILDINGS.
- NO IRRIGATION IS PROPOSED.
- PARKING SPACES LABELED 1 & 2 ARE RESERVED FOR THE APARTMENT OVER THE NEW GARAGE.

ENGINEER APPROVED BY THE PORTSMOUTH PLANNING BOARD

DATE

133 COURT STREET PORTSMOUTH, NH 03801 (603) 433-2335 www.ALTUS-ENG.com

ENGINEERING, INC.

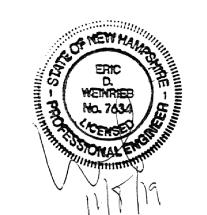

SSUED FOR:

PLANNING BOARD

ISSUE DATE:

NOVEMBER 8, 2019

REVISIONS NO. DESCRIPTION DATE O TAC WORKSHOP EDW 06/03/19 TAC EDW 10/21/19 PER TAC COMMENTS EDW 11/08/19

RLH DRAWN BY:. EDW APPROVED BY: 4972.DWG DRAWING FILE: _

SCALE:

 $22" \times 34" - 1" = 10"$ $11" \times 17" - 1" = 20"$

OWNER/APPLICANT:

FRANCIS T. DELBENE GWYN M. BURDELL 32 UNION STREET PORTSMOUTH, N.H. ASSESSOR'S PARCEL 145-29

MAILING ADDRESS

165 GRANT AVENUE PORTSMOUTH, N.H. 03801

PROJECT:

PROPOSED SITE DEVELOPMENT **PLANS**

32 UNION STREET PORTSMOUTH, N.H.


ASSESSOR'S PARCEL 145-29

TITLE:

SITE PLAN

SHEET NUMBER:

U-

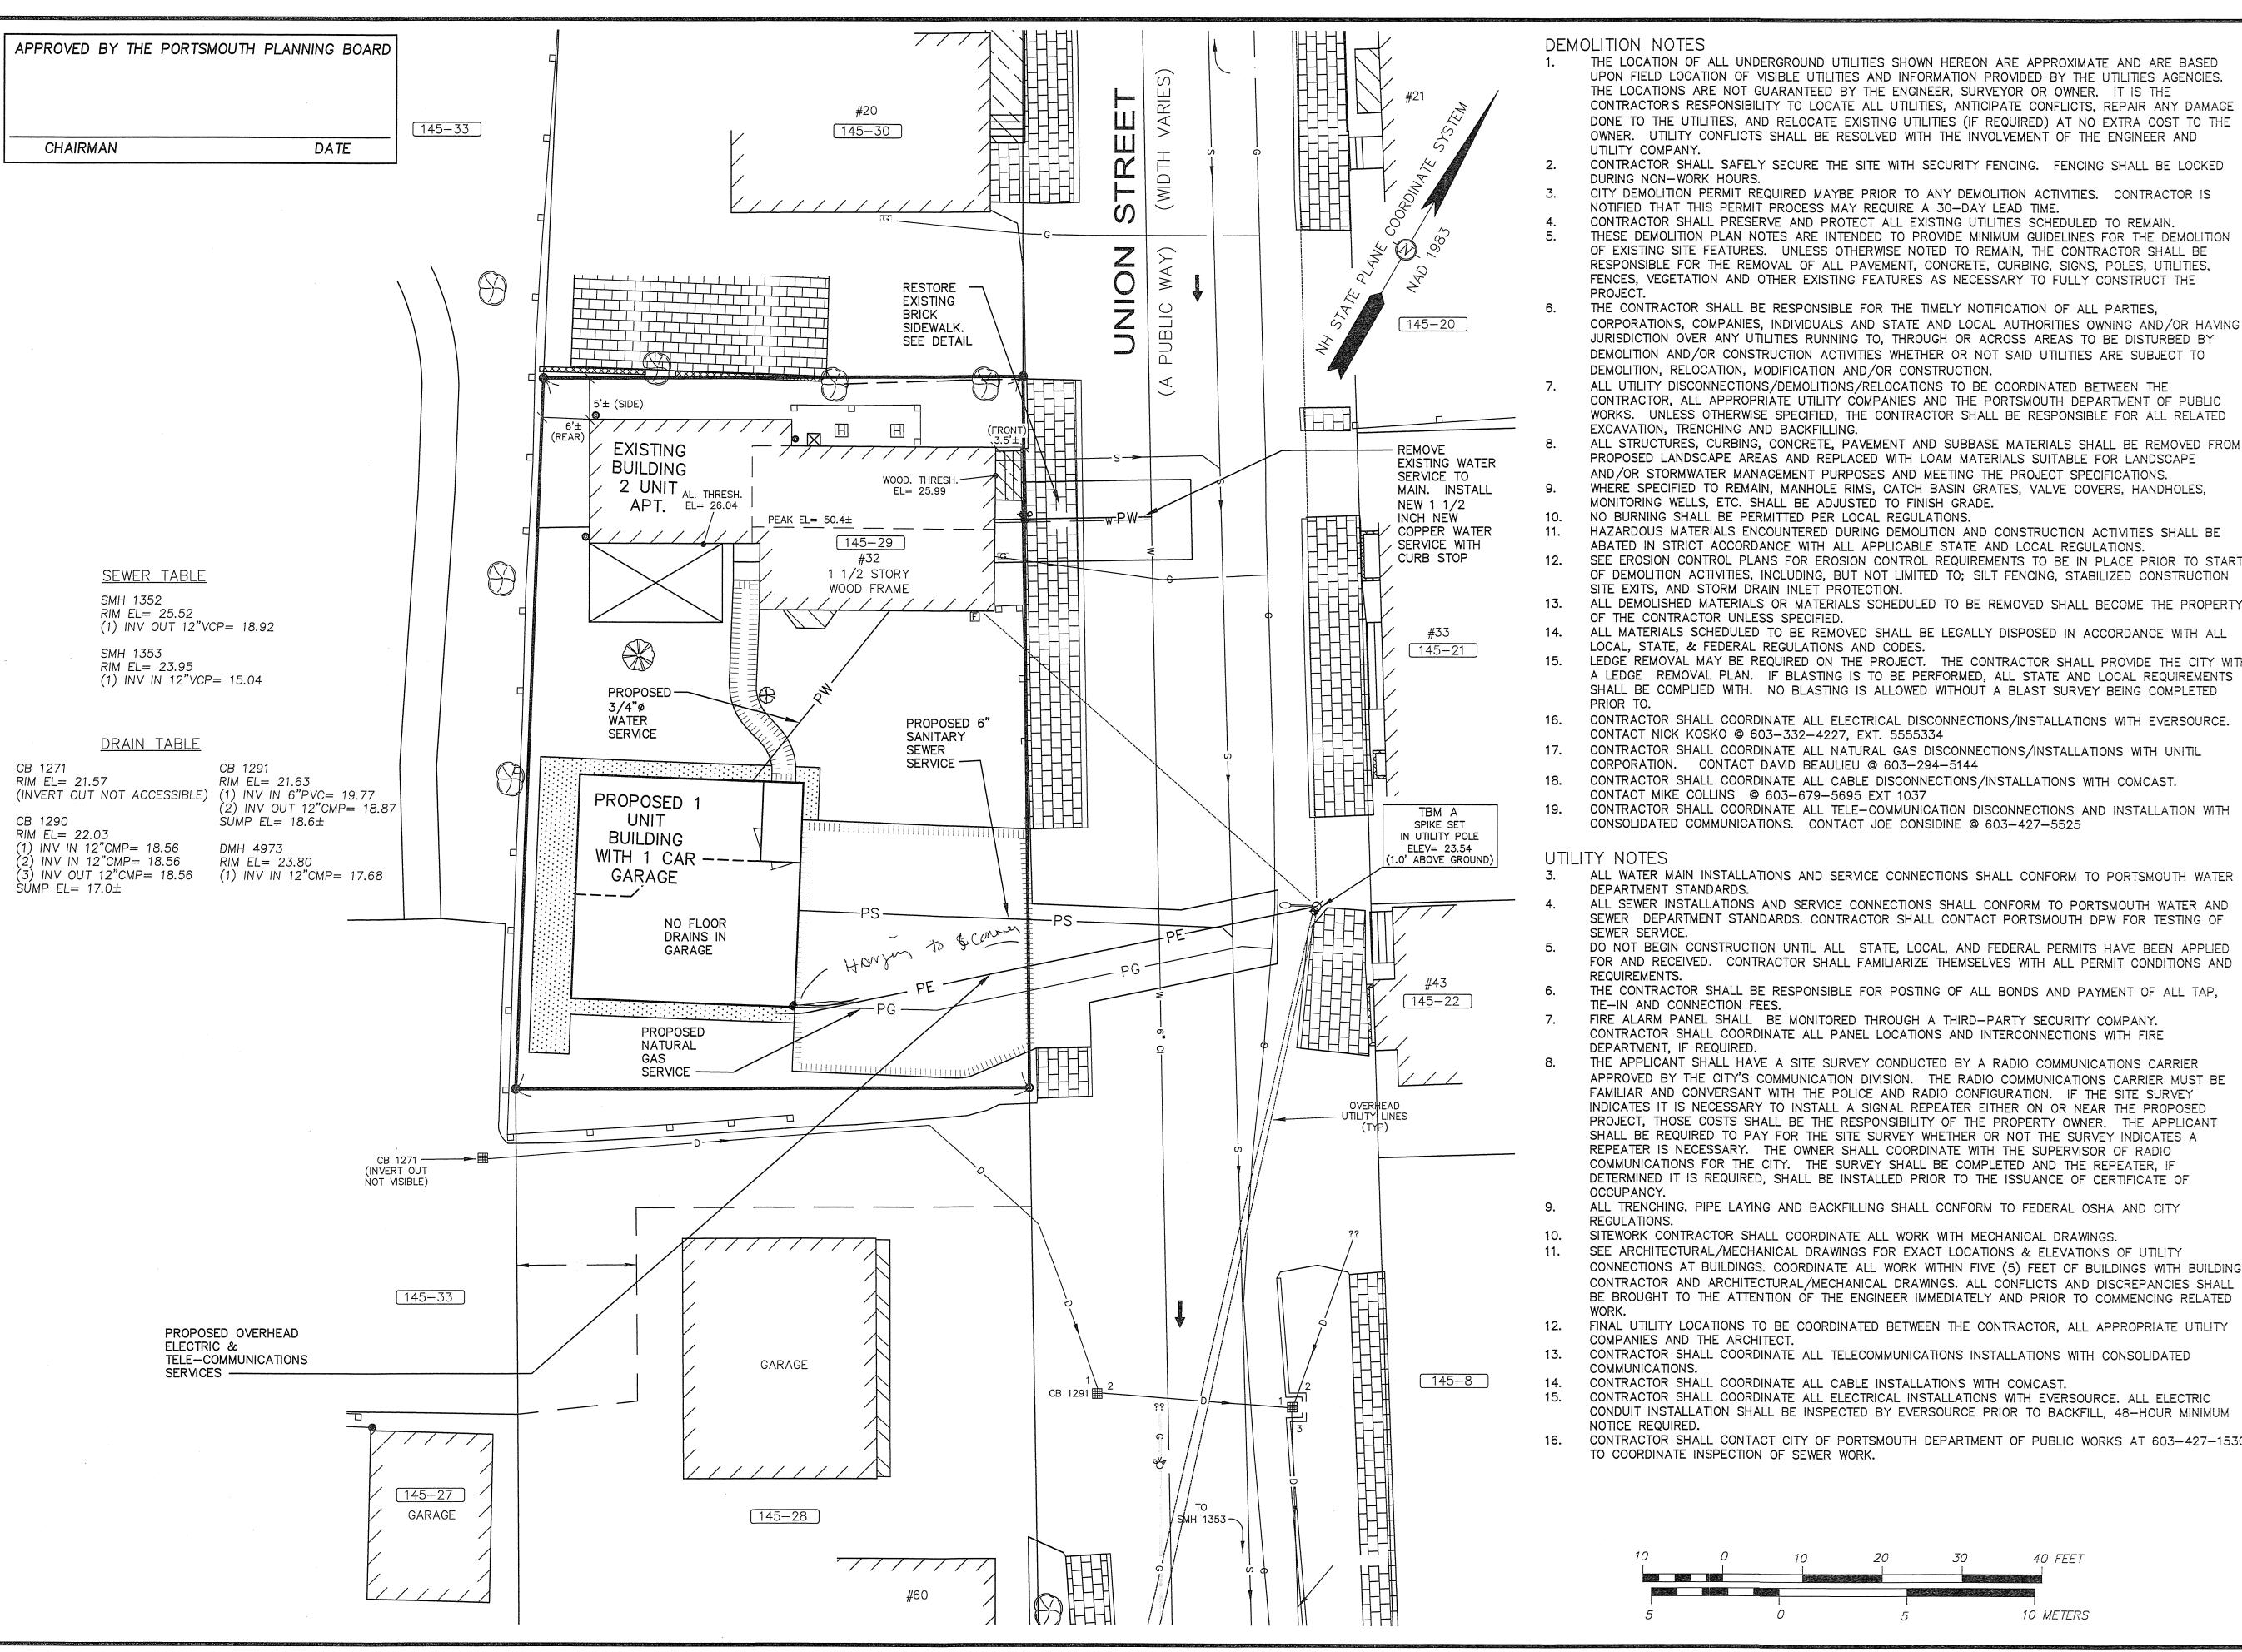

DEMOLITION NOTES

- THE LOCATION OF ALL UNDERGROUND UTILITIES SHOWN HEREON ARE APPROXIMATE AND ARE BASED UPON FIELD LOCATION OF VISIBLE UTILITIES AND INFORMATION PROVIDED BY THE UTILITIES AGENCIES. THE LOCATIONS ARE NOT GUARANTEED BY THE ENGINEER, SURVEYOR OR OWNER. IT IS THE CONTRACTOR'S RESPONSIBILITY TO LOCATE ALL UTILITIES, ANTICIPATE CONFLICTS, REPAIR ANY DAMAGE DONE TO THE UTILITIES, AND RELOCATE EXISTING UTILITIES (IF REQUIRED) AT NO EXTRA COST TO THE OWNER. UTILITY CONFLICTS SHALL BE RESOLVED WITH THE INVOLVEMENT OF THE ENGINEER AND UTILITY COMPANY.
- CONTRACTOR SHALL SAFELY SECURE THE SITE WITH SECURITY FENCING. FENCING SHALL BE LOCKED DURING NON-WORK HOURS.

CITY DEMOLITION PERMIT REQUIRED MAYBE PRIOR TO ANY DEMOLITION ACTIVITIES. CONTRACTOR IS

NOTIFIED THAT THIS PERMIT PROCESS MAY REQUIRE A 30-DAY LEAD TIME. CONTRACTOR SHALL PRESERVE AND PROTECT ALL EXISTING UTILITIES SCHEDULED TO REMAIN. THESE DEMOLITION PLAN NOTES ARE INTENDED TO PROVIDE MINIMUM GUIDELINES FOR THE DEMOLITION

OF EXISTING SITE FEATURES. UNLESS OTHERWISE NOTED TO REMAIN, THE CONTRACTOR SHALL BE RESPONSIBLE FOR THE REMOVAL OF ALL PAVEMENT, CONCRETE, CURBING, SIGNS, POLES, UTILITIES, FENCES, VEGETATION AND OTHER EXISTING FEATURES AS NECESSARY TO FULLY CONSTRUCT THE THE CONTRACTOR SHALL BE RESPONSIBLE FOR THE TIMELY NOTIFICATION OF ALL PARTIES,

CORPORATIONS, COMPANIES, INDIVIDUALS AND STATE AND LOCAL AUTHORITIES OWNING AND/OR HAVING JURISDICTION OVER ANY UTILITIES RUNNING TO, THROUGH OR ACROSS AREAS TO BE DISTURBED BY DEMOLITION AND/OR CONSTRUCTION ACTIVITIES WHETHER OR NOT SAID UTILITIES ARE SUBJECT TO DEMOLITION, RELOCATION, MODIFICATION AND/OR CONSTRUCTION.

ALL UTILITY DISCONNECTIONS/DEMOLITIONS/RELOCATIONS TO BE COORDINATED BETWEEN THE CONTRACTOR, ALL APPROPRIATE UTILITY COMPANIES AND THE PORTSMOUTH DEPARTMENT OF PUBLIC WORKS. UNLESS OTHERWISE SPECIFIED, THE CONTRACTOR SHALL BE RESPONSIBLE FOR ALL RELATED EXCAVATION, TRENCHING AND BACKFILLING.

ALL STRUCTURES, CURBING, CONCRETE, PAVEMENT AND SUBBASE MATERIALS SHALL BE REMOVED FROM PROPOSED LANDSCAPE AREAS AND REPLACED WITH LOAM MATERIALS SUITABLE FOR LANDSCAPE AND/OR STORMWATER MANAGEMENT PURPOSES AND MEETING THE PROJECT SPECIFICATIONS.

WHERE SPECIFIED TO REMAIN, MANHOLE RIMS, CATCH BASIN GRATES, VALVE COVERS, HANDHOLES, MONITORING WELLS, ETC. SHALL BE ADJUSTED TO FINISH GRADE.

NO BURNING SHALL BE PERMITTED PER LOCAL REGULATIONS.

HAZARDOUS MATERIALS ENCOUNTERED DURING DEMOLITION AND CONSTRUCTION ACTIVITIES SHALL BE

ABATED IN STRICT ACCORDANCE WITH ALL APPLICABLE STATE AND LOCAL REGULATIONS.

SEE EROSION CONTROL PLANS FOR EROSION CONTROL REQUIREMENTS TO BE IN PLACE PRIOR TO START OF DEMOLITION ACTIVITIES, INCLUDING, BUT NOT LIMITED TO; SILT FENCING, STABILIZED CONSTRUCTION SITE EXITS, AND STORM DRAIN INLET PROTECTION.

OF THE CONTRACTOR UNLESS SPECIFIED. ALL MATERIALS SCHEDULED TO BE REMOVED SHALL BE LEGALLY DISPOSED IN ACCORDANCE WITH ALL

LOCAL, STATE, & FEDERAL REGULATIONS AND CODES.

LEDGE REMOVAL MAY BE REQUIRED ON THE PROJECT. THE CONTRACTOR SHALL PROVIDE THE CITY WITH A LEDGE REMOVAL PLAN. IF BLASTING IS TO BE PERFORMED, ALL STATE AND LOCAL REQUIREMENTS SHALL BE COMPLIED WITH. NO BLASTING IS ALLOWED WITHOUT A BLAST SURVEY BEING COMPLETED PRIOR TO.

CONTRACTOR SHALL COORDINATE ALL ELECTRICAL DISCONNECTIONS/INSTALLATIONS WITH EVERSOURCE. CONTACT NICK KOSKO @ 603-332-4227, EXT. 5555334

CONTRACTOR SHALL COORDINATE ALL NATURAL GAS DISCONNECTIONS/INSTALLATIONS WITH UNITIL CORPORATION. CONTACT DAVID BEAULIEU @ 603-294-5144

CONTRACTOR SHALL COORDINATE ALL CABLE DISCONNECTIONS/INSTALLATIONS WITH COMCAST.

CONTACT MIKE COLLINS @ 603-679-5695 EXT 1037

CONTRACTOR SHALL COORDINATE ALL TELE-COMMUNICATION DISCONNECTIONS AND INSTALLATION WITH CONSOLIDATED COMMUNICATIONS. CONTACT JOE CONSIDINE @ 603-427-5525

ALL WATER MAIN INSTALLATIONS AND SERVICE CONNECTIONS SHALL CONFORM TO PORTSMOUTH WATER DEPARTMENT STANDARDS.

ALL SEWER INSTALLATIONS AND SERVICE CONNECTIONS SHALL CONFORM TO PORTSMOUTH WATER AND SEWER DEPARTMENT STANDARDS. CONTRACTOR SHALL CONTACT PORTSMOUTH DPW FOR TESTING OF

DO NOT BEGIN CONSTRUCTION UNTIL ALL STATE, LOCAL, AND FEDERAL PERMITS HAVE BEEN APPLIED FOR AND RECEIVED. CONTRACTOR SHALL FAMILIARIZE THEMSELVES WITH ALL PERMIT CONDITIONS AND

THE CONTRACTOR SHALL BE RESPONSIBLE FOR POSTING OF ALL BONDS AND PAYMENT OF ALL TAP, TIE-IN AND CONNECTION FEES.

FIRE ALARM PANEL SHALL BE MONITORED THROUGH A THIRD-PARTY SECURITY COMPANY. CONTRACTOR SHALL COORDINATE ALL PANEL LOCATIONS AND INTERCONNECTIONS WITH FIRE

DEPARTMENT, IF REQUIRED.

THE APPLICANT SHALL HAVE A SITE SURVEY CONDUCTED BY A RADIO COMMUNICATIONS CARRIER APPROVED BY THE CITY'S COMMUNICATION DIVISION. THE RADIO COMMUNICATIONS CARRIER MUST BE FAMILIAR AND CONVERSANT WITH THE POLICE AND RADIO CONFIGURATION. IF THE SITE SURVEY INDICATES IT IS NECESSARY TO INSTALL A SIGNAL REPEATER EITHER ON OR NEAR THE PROPOSED PROJECT, THOSE COSTS SHALL BE THE RESPONSIBILITY OF THE PROPERTY OWNER. THE APPLICANT SHALL BE REQUIRED TO PAY FOR THE SITE SURVEY WHETHER OR NOT THE SURVEY INDICATES A REPEATER IS NECESSARY. THE OWNER SHALL COORDINATE WITH THE SUPERVISOR OF RADIO COMMUNICATIONS FOR THE CITY. THE SURVEY SHALL BE COMPLETED AND THE REPEATER. IF DETERMINED IT IS REQUIRED, SHALL BE INSTALLED PRIOR TO THE ISSUANCE OF CERTIFICATE OF

ALL TRENCHING, PIPE LAYING AND BACKFILLING SHALL CONFORM TO FEDERAL OSHA AND CITY

SITEWORK CONTRACTOR SHALL COORDINATE ALL WORK WITH MECHANICAL DRAWINGS.

SEE ARCHITECTURAL/MECHANICAL DRAWINGS FOR EXACT LOCATIONS & ELEVATIONS OF UTILITY CONNECTIONS AT BUILDINGS. COORDINATE ALL WORK WITHIN FIVE (5) FEET OF BUILDINGS WITH BUILDING CONTRACTOR AND ARCHITECTURAL/MECHANICAL DRAWINGS. ALL CONFLICTS AND DISCREPANCIES SHALL BE BROUGHT TO THE ATTENTION OF THE ENGINEER IMMEDIATELY AND PRIOR TO COMMENCING RELATED

FINAL UTILITY LOCATIONS TO BE COORDINATED BETWEEN THE CONTRACTOR, ALL APPROPRIATE UTILITY COMPANIES AND THE ARCHITECT.

CONTRACTOR SHALL COORDINATE ALL TELECOMMUNICATIONS INSTALLATIONS WITH CONSOLIDATED

COMMUNICATIONS. CONTRACTOR SHALL COORDINATE ALL CABLE INSTALLATIONS WITH COMCAST.

CONTRACTOR SHALL COORDINATE ALL ELECTRICAL INSTALLATIONS WITH EVERSOURCE. ALL ELECTRIC CONDUIT INSTALLATION SHALL BE INSPECTED BY EVERSOURCE PRIOR TO BACKFILL, 48-HOUR MINIMUM

CONTRACTOR SHALL CONTACT CITY OF PORTSMOUTH DEPARTMENT OF PUBLIC WORKS AT 603-427-1530 TO COORDINATE INSPECTION OF SEWER WORK.

ENGINEERING, INC.

133 COURT STREET PORTSMOUTH, NH 03801 (603) 433-2335 www.ALTUS-ENG.com



ISSUED FOR:

PLANNING BOARD

ISSUE DATE:

NOVEMBER 8, 2019

REV	<u>ISIONS</u>		
NO.	DESCRIPTION	BY	DATE
0	TAC WORK SESSION	EDW	6/03/19
1	TAC SUBMISSION	EDW	10/21/19
2	PER TAC COMMENTS	EDW	11/08/19

DRAWN BY:	RLH
APPROVED BY:	EDW
DRAWING FILE:	4972.DWG

 $22" \times 34" - 1" = 10"$ $11" \times 17" - 1" = 20"$

DWNER/APPLICANT:

FRANCIS T. DELBENE GWYN M. BURDELL 32 UNION STREET PORTSMOUTH, N.H. ASSESSOR'S PARCEL 145-29

MAILING ADDRESS

165 GRANT AVENUE PORTSMOUTH, N.H. 03801

PROJECT:

PROPOSED SITE DEVELOPMENT **PLANS**

32 UNION STREET PORTSMOUTH, N.H.


ASSESSOR'S PARCEL 145-29

UTILITIES PLAN

SHEET NUMBER:

C-2


40 FEET 10 METERS

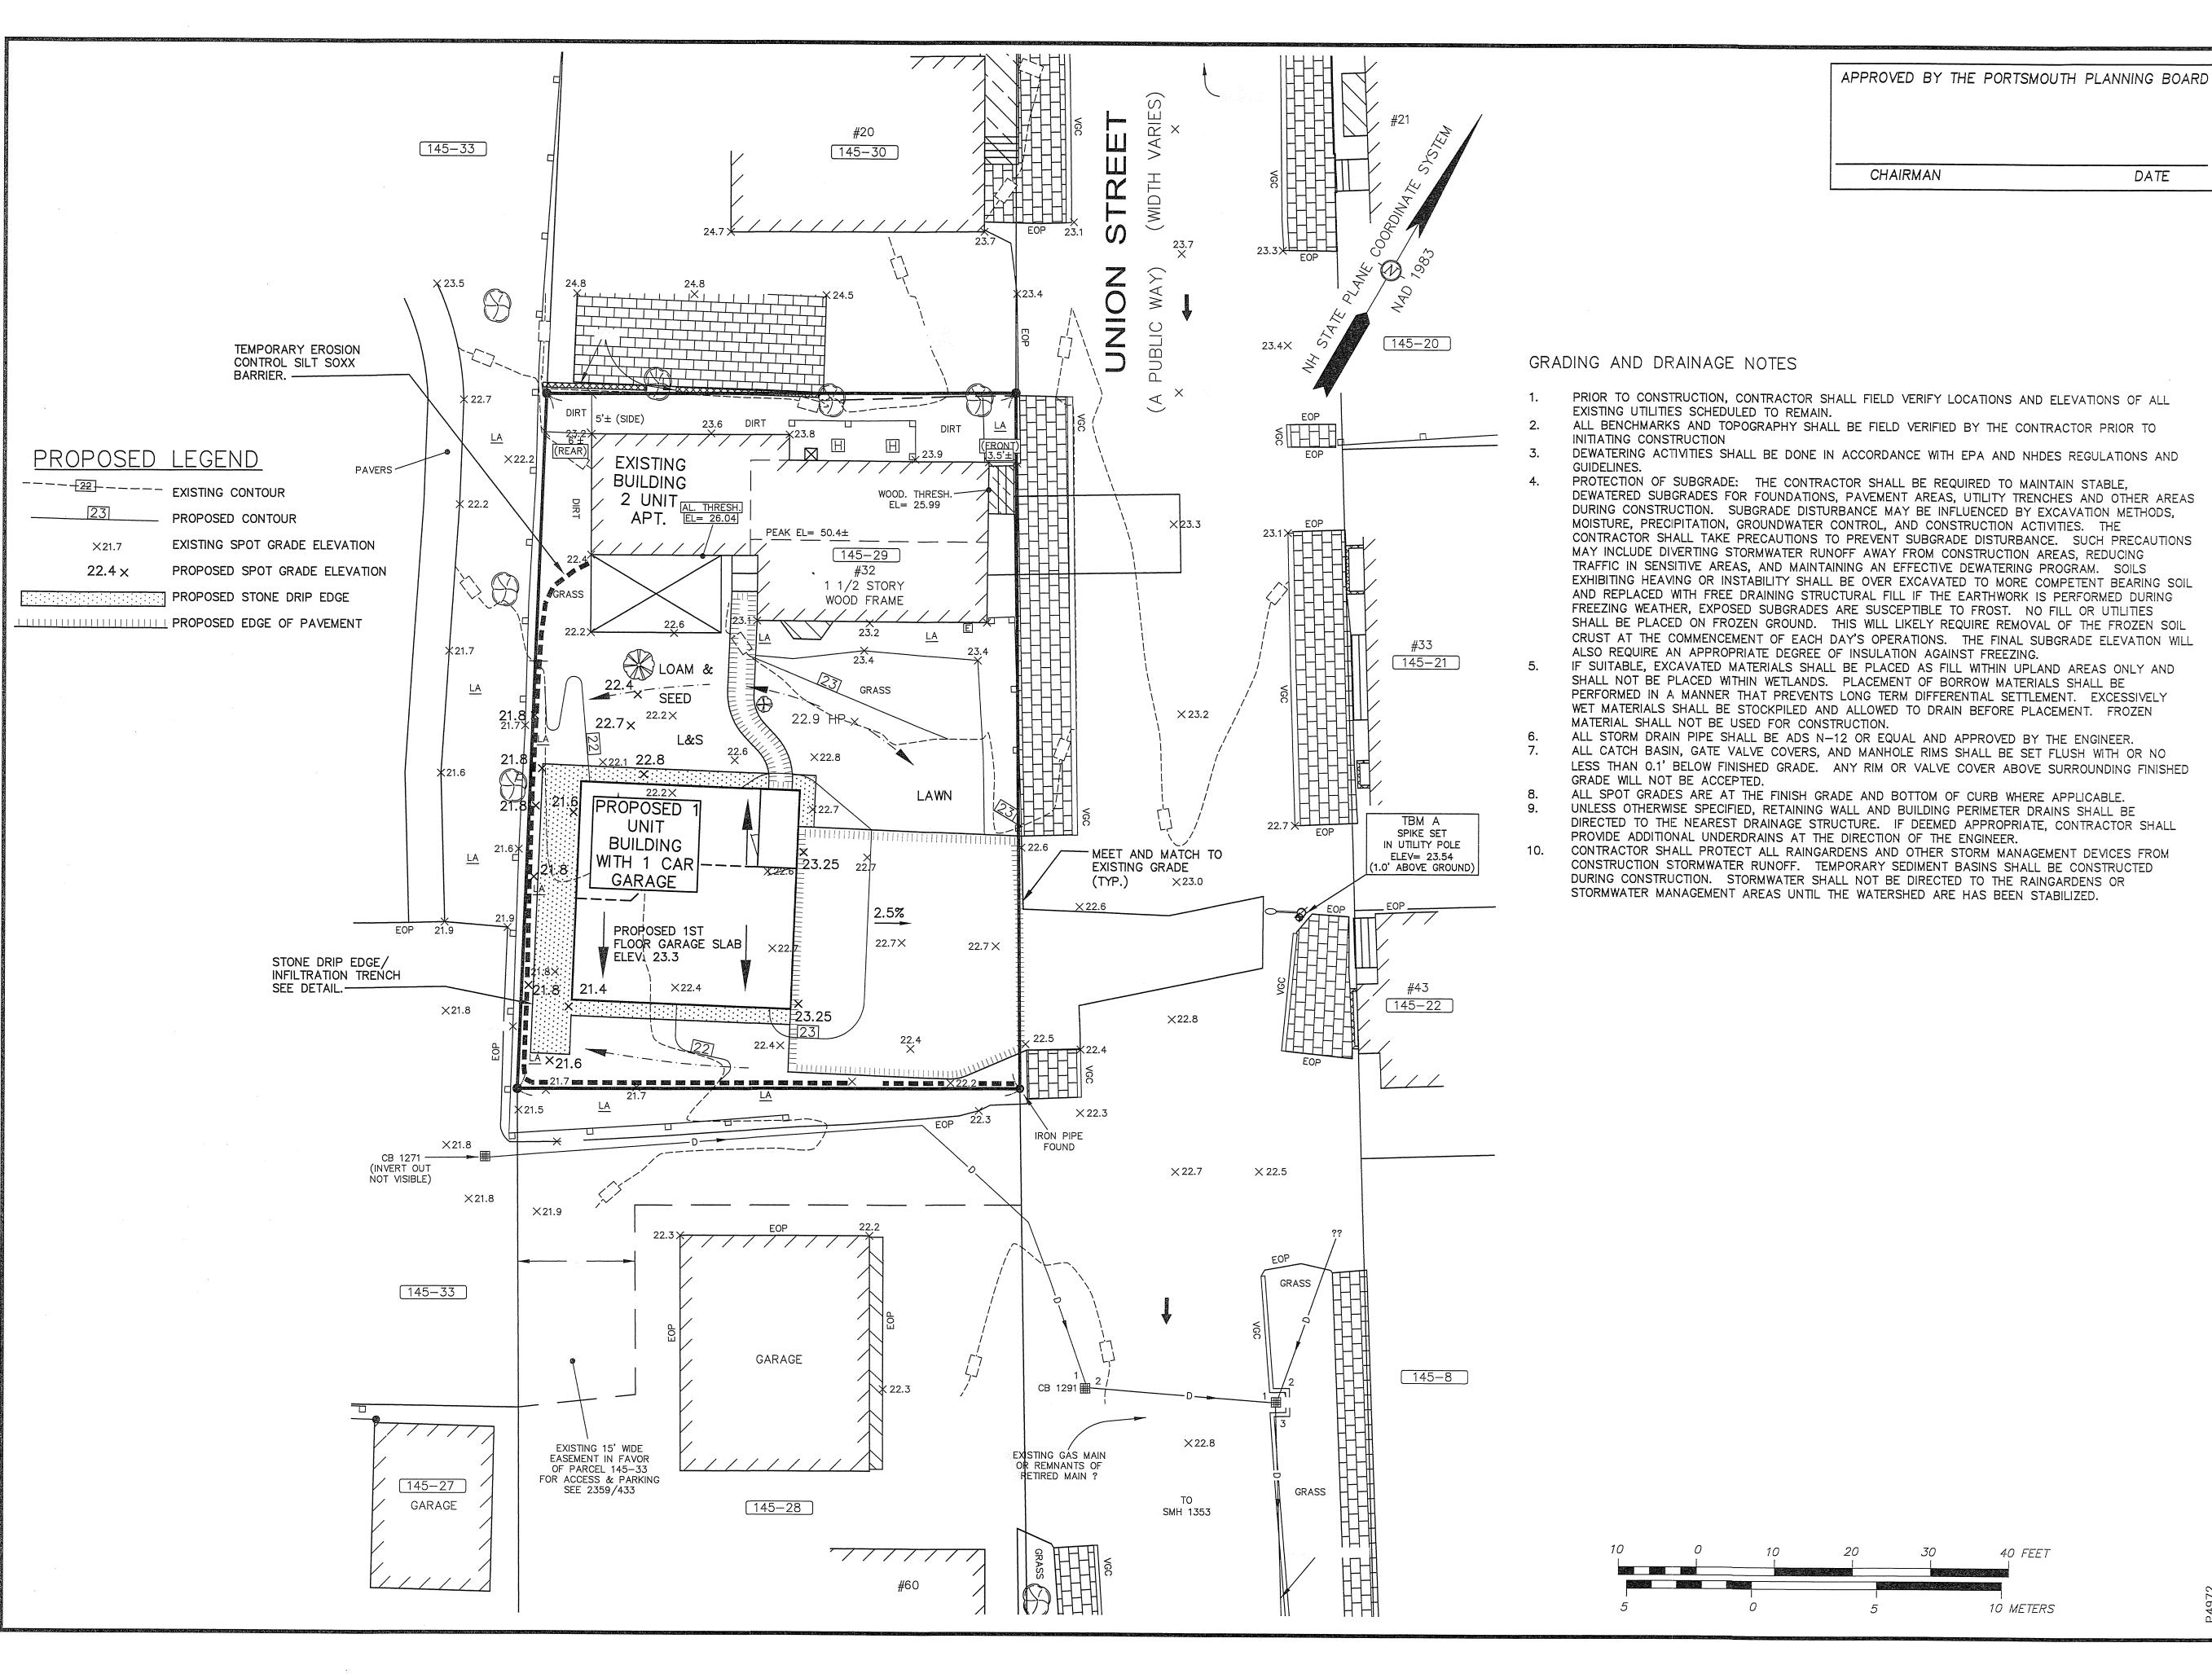

ENGINEER:

ENGINEERING, INC.

133 COURT STREET PORTSMOUTH, NH 03801 (603) 433-2335 www.ALTUS-ENG.com

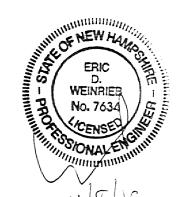

ISSUED FOR:

PLANNING BOARD

ISSUE DATE:

NOVEMBER 8, 2019

EDW 11/08/19

REVISIONS NO. DESCRIPTION

DATE O TAC WORKSHOP EDW 06/03/19 1 TAC EDW 10/21/19 2 PER TAC COMMENTS

RLH DRAWN BY:___ EDW APPROVED BY: _ 4972.DWG DRAWING FILE: _

SCALE:

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OWNER/APPLICANT:

FRANCIS T. DELBENE GWYN M. BURDELL 32 UNION STREET PORTSMOUTH, N.H. ASSESSOR'S PARCEL 145-29

MAILING ADDRESS

165 GRANT AVENUE PORTSMOUTH, N.H. 03801

PROJECT:

PROPOSED SITE DEVELOPMENT **PLANS**


32 UNION STREET PORTSMOUTH, N.H.

ASSESSOR'S PARCEL 145-29

GRADING PLAN

SHEET NUMBER:

C-3

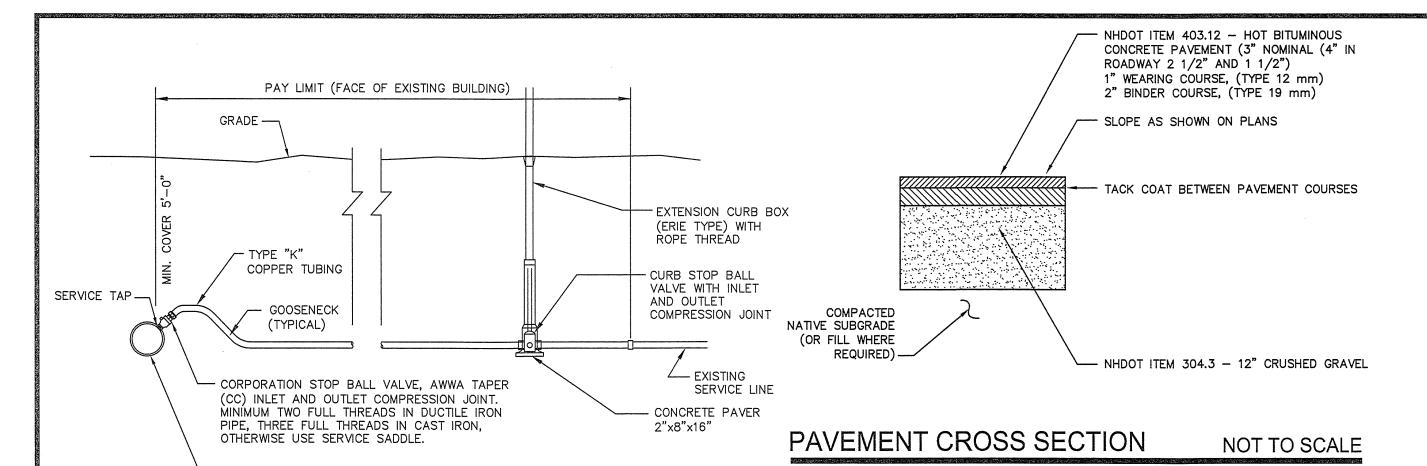

- BUILDING FACE

24" MIN. OR AS SHOWN

GRADE AS SHOWN

ON PLANS

DRIP EDGE DETAIL

FINISH GRADE

EXCAVATION AND BACKFILL IN ACCORDANCE WITH UTILITY COMPANY STANDARDS -

TRACER WIRE

(IF REQUIRED BY

UTILITY COMPANY)

AND INSTALLATION BY

UTILITY COMPANY-

SIEVE SIZE

200

AASHTO T 99, METHOD C.

GAS TRENCH

VERTICAL GRANITE

WEARING COURSE

(SEE PAVEMENT CROSS SECTION)

CURB WHERE

BINDER COURSE -

NHDOT ITEM #304.3

CRUSHED GRAVEL

CONCRETE

NOTES

SPECIFIED

NOTES

CAUTION TAPE-

SAND BLANKET/BARRIER

% FINER BY WEIGHT

90 - 100

0 - 15

1. CONTRACTOR TO COORDINATE WITH UTILITY COMPANY AND PROVIDE ALL

2. BACKFILL MATERIAL BELOW PAVED OR CONCRETE AREAS, BEDDING MATERIAL, AND SAND BLANKET SHALL BE COMPACTED TO NOT LESS THAN 95% OF AASHTO T 99, METHOD C. SUITABLE BACKFILL MATERIAL

EXCAVATION, COMPACTION AND BACKFILL FOR PIPE INSTALLATION WITHIN

BELOW LOAM AREAS SHALL BE COMPACTED TO NOT LESS THAN 90% OF

CONTRACTOR SHALL REUSE WHOLE, UNDAMAGED BRICKS FOR REPAIRS.

3. NEW BRICKS SHALL MATCH TO EXISTING. SAMPLES SHALL BE PROVIDED TO THE CITY

BRICK PATTERN SHALL MATCH TO EXISTING.

FOR APPROVAL PRIOR TO PURCHASING.

BRICK SIDEWALK DETAIL

ON PLAN NOT TO BE LESS

THAN 6" BEYOND DRIP LINE

-2 x 12 P.T., CONT, OR METAL EDGING

SLOPE AS SHOWN ON PLAN

-14" - 3/4" CRUSHED STONE

18" MAX.

≯ MIN. .

COVER

(MATERIAL AS APPROVED BY ARCHITECT OR OWNER)

- 4" THICK WASHED RIVER STONE, SIZE 1.5" TO 2.5", TAMPED TO

DEPTH OF 6". STONE COLOR TO BE APPROVED BY ARCHITECT.

NOT TO SCALE

SEE PAVEMENT

SECTION

SAND BEDDING. NHDOT 304.1 OR

AS SPECIFIED BY UTILITY COMPANY

NOT TO SCALE

- 1" LEVELING COURSE OF

1/3 PORTLAND CEMENT

— 4"−WIDE BITUMASTIC TAPE | AT BUILDING EXTERIOR

- COMPACTED NATIVE

CONCRETE BINDER

NOT TO SCALE

- 1.5" BITUMINOUS

SUBGRADE

- BRICK PAVERS


& 2/3 SAND

- 1. PROVIDE NEW LINE USING CONTINUOUS LENGTHS OF COPPER. NO COUPLING ALLOWED IN ROADWAY WITHOUT APPROVAL OF ENGINEER.
- 2. TAPS TO BE MADE AT APPROXIMATELY 2:00 & 10:00

- EXISTING WATER MAIN

- 3. PROVIDE FOR SERVICE LINE CONTRACTION AND EXPANSION BY INSTALLING "S" IN SERVICE LINE NEAR MAIN.
- 4. IF SERVICE IS INSTALLED WITH LESS THAN 5' COVER, INSULATE OVER LINE.
- REMOVE EXISTING CURB STOP.
- 6. CONNECT CURB STOP TO EXISTING SERVICE LINE AT PROPERTY LINE OR AT LOCATION APPROVED BY THE ENGINEER (NO COUPLING WITHOUT APPROVAL OF ENGINEER) AFTER PRESSURE TESTING AND DISINFECTION.
- 7. SHUT OFF EXISTING CORPORATION AND REMOVE OR ABANDON EXISTING SERVICE
- 8. CURB BOX SHALL BE SET IN THE GRASS/LANDSCAPE AREA BETWEEN CURB AND SIDEWALK UNLESS DIRECTED OTHERWISE.
- 9. 2" OR LARGER SERVICE CONNECTIONS SHALL USE A STAINLESS STEEL SERVICE SADDLE.

SERVICE CONNECTION DETAIL NOT TO SCALE

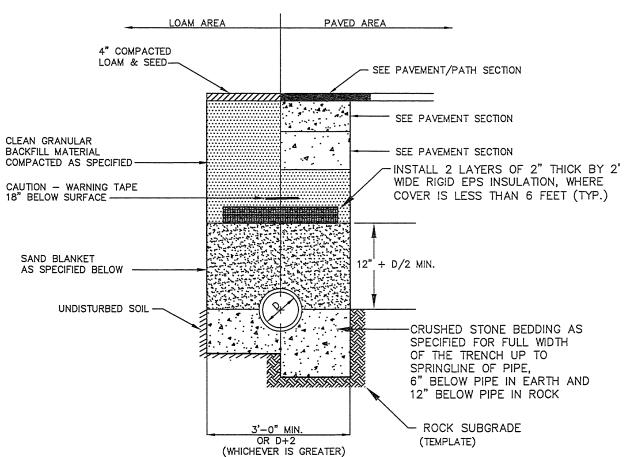

BACKFILL MATERIAL BELOW PAVED OR CONCRETE AREAS, BEDDING MATERIAL, AND SAND BLANKET SHALL BE COMPACTED TO NOT LESS THAN 95% OF AASHTO T99, METHOD C. SUITABLE BACKFILL MATERIAL BELOW LOAM AREAS SHALL BE COMPACTED TO NOT LESS THAN 90% OF AASHTO T 99,

SAN	ID BLANKET	CRUSHED	STONE BEDDING *
SIEVE SIZE	% FINER BY WEIGHT	SIEVE SIZE	% PASSING BY WEIGHT
1/2"	90 - 100	1"	100
200	0 — 15	3/4"	90 — 100
		3/8"	20 - 55
		# 4	0 - 10
		# 8	0 - 5
	T TO STANDARD STONE SIZE #67 IDOT STANDARD SPECIFICATIONS	7 - SECTION	

SEWER TRENCH SECTION

METHOD C.

NOT TO SCALE

EXCAVATED UTILITY TRENCH (SEE TRENCH SECTION) -

STANDARD TRENCH NOTES:

- 1. ORDERED EXCAVATION OF UNSUITABLE MATERIAL BELOW GRADE: BACKFILL AS STATED IN THE TECHNICAL SPECIFICATIONS OR AS SHOWN OF THE DRAWING.
- 2. BEDDING: SCREENED GRAVEL AND/OR CRUSHED STONE FREE FROM CLAY. LOAM, ORGANIC MATTER AND MEETING ASTM C33, STONE SIZE NO. 67.


PASSING 1 INCH SCREEN 90 - 100% PASSING 3/4 INCH SCREEN PASSING 3/8 INCH SCREEN 20 - 55% 0-10% PASSING #4 SIEVE

0-5% PASSING #8 SIEVE WHERE ORDERED BY THE ENGINEER TO STABILIZE THE BASE, SCREENED GRAVEL OR CRUSHED STONE 1-1/2 INCH TO 1/2 INCH SHALL BE USED.

- 3. SAND BLANKET: CLEAN SAND FREE FROM ORGANIC MATTER, SO GRADED THAT 90 100% PASSES 1/2 INCH SIEVE AND NOT MORE THAN 15% WILL PASS A #200 SIEVE. BLANKET MAY BE OMITTED FOR CAST-IRON, DUCTILE IRON, AND REINFORCED CONCRETE PIPE PROVIDED HOWEVER, THAT NO STONE LARGER THAN 2" IS IN CONTACT WITH THE PIPE.
- 4. SUITABLE MATERIAL: IN ROADS, ROAD SHOULDERS, WALKWAYS AND TRAVELED WAYS, SUITABLE MATERIAL FOR TRENCH BACKFILL SHALL BE THE NATURAL MATERIAL EXCAVATED DURING THE COURSE OF CONSTRUCTION, BUT SHALL EXCLUDE DEBRIS; PIECES OF PAVEMENT; ORGANIC MATTER; TOP SOIL; ALL WET OR SOFT MUCK, PEAT, OR CLAY; AL EXCAVATED LEDGE MATERIAL; ALL ROCKS OVER 6 INCHES IN LARGEST DIMENSION; AND ANY MATERIAL WHICH, AS DETERMINED BY THE ENGINEER, WILL NOT PROVIDE SUFFICIENT SUPPORT OR MAINTAIN THE COMPLETED CONSTRUCTION IN A STABLE CONDITION.
- 5. BASE COURSE AND PAVEMENT SHALL MEET THE REQUIREMENTS OF THE NEW HAMPSHIRE DEPARTMENT OF TRANSPORTATION'S LATEST EDITION OF THE STANDARD SPECIFICATIONS FOR HIGHWAYS AND BRIDGES - DIVISIONS 300 AND 400 RESPECTIVELY.
- 6. SHEETING, IF REQUIRED: WHERE SHEETING IS PLACED ALONGSIDE THE PIPE AND EXTENDS BELOW MID-DIAMETER, IT SHALL BE CUT OFF AND LEFT IN PLACE TO AN ELEVATION 1 FOOT ABOVE THE TOP OF PIPE. WHERE SHEETING IS ORDERED BY THE ENGINEER TO BE LEFT IN PLACE, IT SHALL BE CUT OFF AT LEAST 3 FEET BELOW FINISHED GRADE, BUT NOT LESS THAT 1 FOOT ABOVE THE TOP OF THE PIPE.
- 7. W = MAXIMUM ALLOWABLE TRENCH WIDTH TO A PLANE 12 INCHES ABOVE THE PIPE. FOR PIPES 15 INCHES NOMINAL DIAMETER OR LESS, W SHALL BE NO MORE THAN 36 INCHES. FOR PIPES GREATER THAN 15 INCHES IN NOMINAL DIAMETER, W SHALL BE 24 INCHES PLUS PIPE OUTSIDE DIAMETER (O.D.) ALSO, W SHALL BE THE PAYMENT WIDTH FOR LEDGE EXCAVATION AND FOR ORDERED EXCAVATION BELOW GRADE.
- 8. FOR CROSS COUNTRY CONSTRUCTION, BACKFILL OR FILL SHALL BE MOUNDED TO A HEIGHT OF 6 INCHES ABOVE THE ORIGINAL GROUND SURFACE.
- 9. CONCRETE FOR ENCASEMENT SHALL CONFORM TO THE NEW HAMPSHIRE DEPARTMENT OF PUBLIC WORKS AND HIGHWAYS STANDARD SPECIFICATION REQUIREMENTS FOR CLASS A (3000#) CONCRETE AS FOLLOWS: CEMENT: 6.0 BAGS PER CUBIC YARD WATER: 5.75 GALLONS PER BAG CEMENT MAXIMUM SIZE OF AGGREGATE: 1 INCH

CONCRETE ENCASEMENT IS NOT ALLOWED FOR PVC PIPE

- 10. CONCRETE FULL ENCASEMENT: IF FULL ENCASEMENT IS UTILIZED, DEPTH OF CONCRETE BELOW PIPE SHALL BE 1/4 I.D. (4" MINIMUM). BLOCK SUPPORT SHALL BE SOLID CONCRETE BLOCKS.
- 11. NEW HAMPSHIRE DEPARTMENT OF ENVIRONMENTAL SERVICES DESIGN STANDARDS REQUIRE TEN FEET (10') SEPARATION BETWEEN WATER AND SEWER. REFER TO CITY'S STANDARD SPECIFICATIONS FOR METHODS OF PROTECTION IN AREAS THAT CANNOT MEET THESE REQUIREMENTS.

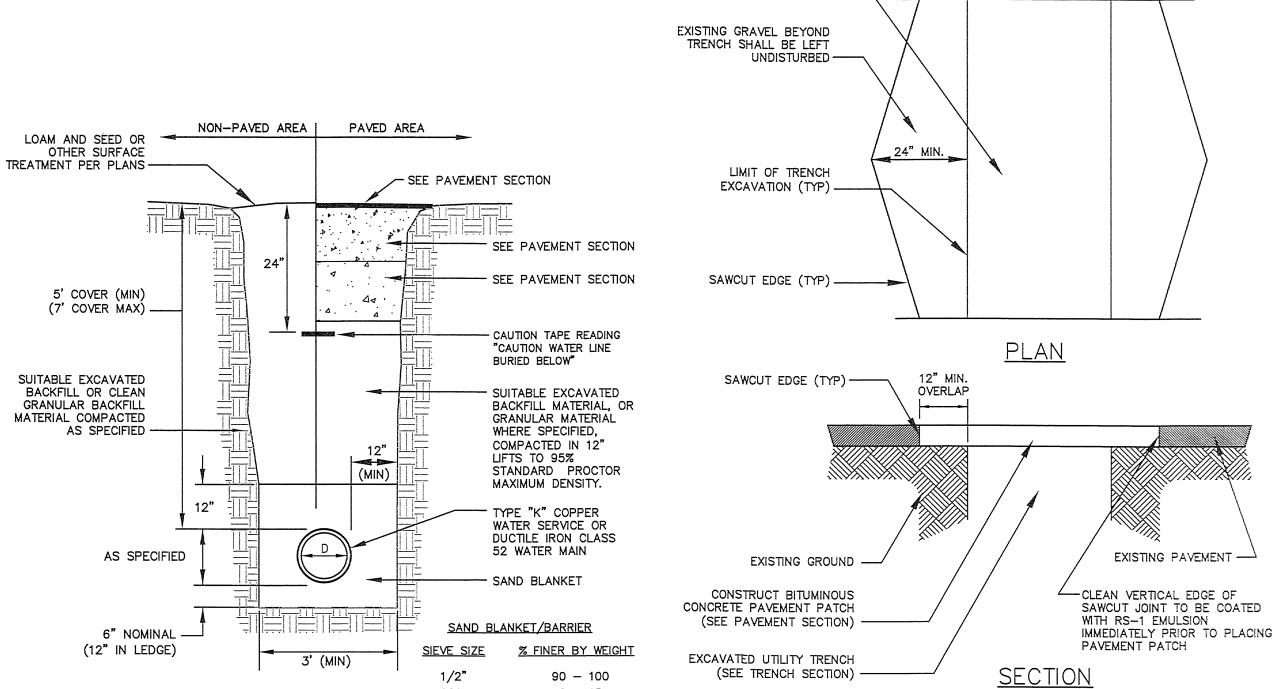

BACKFILL MATERIAL BELOW PAVED OR CONCRETE AREAS, BEDDING MATERIAL, AND SAND BLANKET SHALL BE COMPACTED TO NOT LESS THAN 95% OF AASHTO T 99, METHOD C. SUITABLE BACKFILL MATERIAL BELOW LOAM AREAS SHALL BE COMPACTED TO NOT LESS THAN 90% OF AASHTO T 99,

200


- 2. WATER MAINS SHALL BE POLY WRAPPED.
- 3. WATER MAINS SHALL HAVE 3 WEDGES PER JOINT.

WATER MAIN TRENCH


0 - 15

- MACHINE CUT EXISTING PAVEMENT.
- 2. ALL TEMPORARY, DAMAGED OR DEFECTIVE PAVEMENT SHALL BE REMOVED PRIOR TO PLACEMENT OF PERMANENT TRENCH REPAIRS.
- 3. DIAMOND PATCHES, SHALL BE REQUIRED FOR ALL TRENCHES CROSSING ROADWAY. DIAMOND PATCHES SHALL MEET NHDOT REQUIREMENTS.

NOT TO SCALE

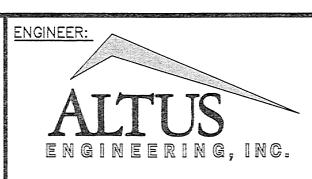

133 COURT STREET PORTSMOUTH, NH 03801 (603) 433-2335 www.ALTUS-ENG.com

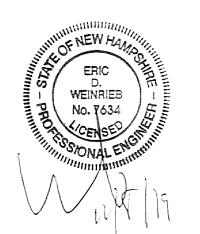

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TRENCH DETAIL

NOVEMBER 8, 2019

REVISIONS DESCRIPTION DATE O TAC WORKSHOP EDW 06/03/19 TAC EDW 10/21/19 EDW 11/08/19 PER TAC COMMENTS

DRAWN BY: _ EDW APPROVED BY: 4972.DWG DRAWING FILE:

22" x 34" - NOT TO SCALE 11" x 17" - NOT TO SCALE

OWNER/APPLICANT:

FRANCIS T. DELBENE GWYN M. BURDELL 32 UNION STREET PORTSMOUTH, N.H. ASSESSOR'S PARCEL 145-29

MAILING ADDRESS

165 GRANT AVENUE PORTSMOUTH, N.H. 03801

PROJECT:

PROPOSED SITE DEVELOPMENT **PLANS**

32 UNION STREET PORTSMOUTH, N.H.

ASSESSOR'S PARCEL

145 - 29


DETAIL SHEET

SHEET NUMBER:

C-4






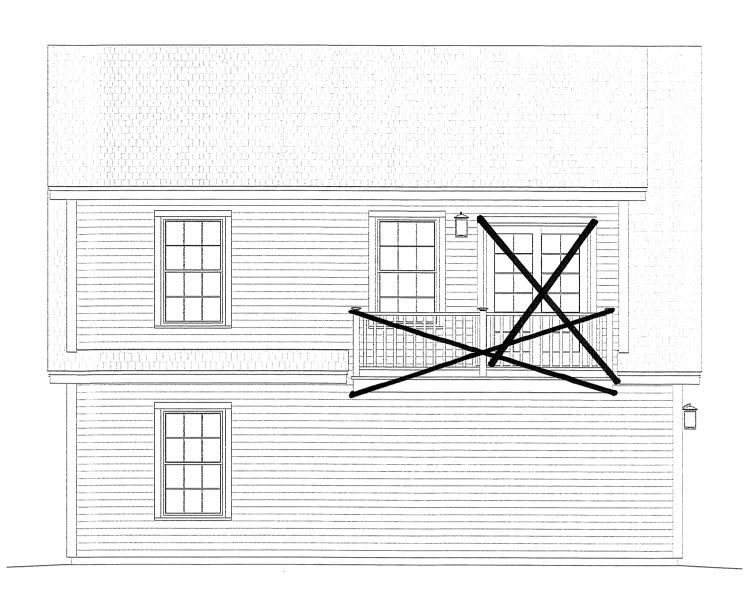

LEFT SIDE ELEVATION SCALE: 1/4" = 1'-0"

DECK NOT TO BE CONSTRUCTED

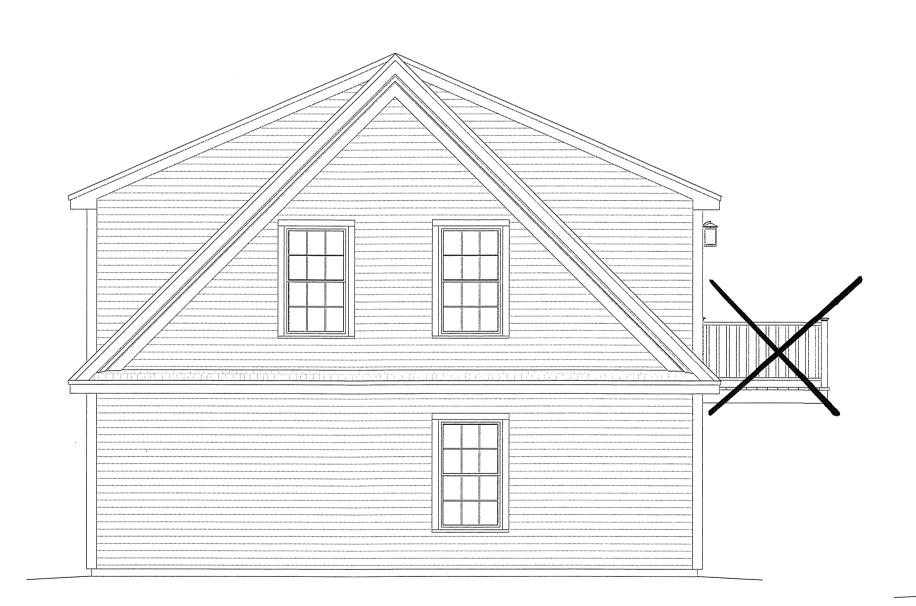

REAR ELEVATION SCALE: 4" = 1'-0"


FRONT ELEVATION

SCALE: 4" = 1'-0"

ELEVATION GRADES AND FOUNDATION DROPS SHOWN ARE CONCEPTUAL. FOUNDATION DROPS AND GRADE WILL BE DETERMINED ON SITE BY CONTRACTOR




RIGHT SIDE ELEVATION SCALE: 4" = 1'-0"

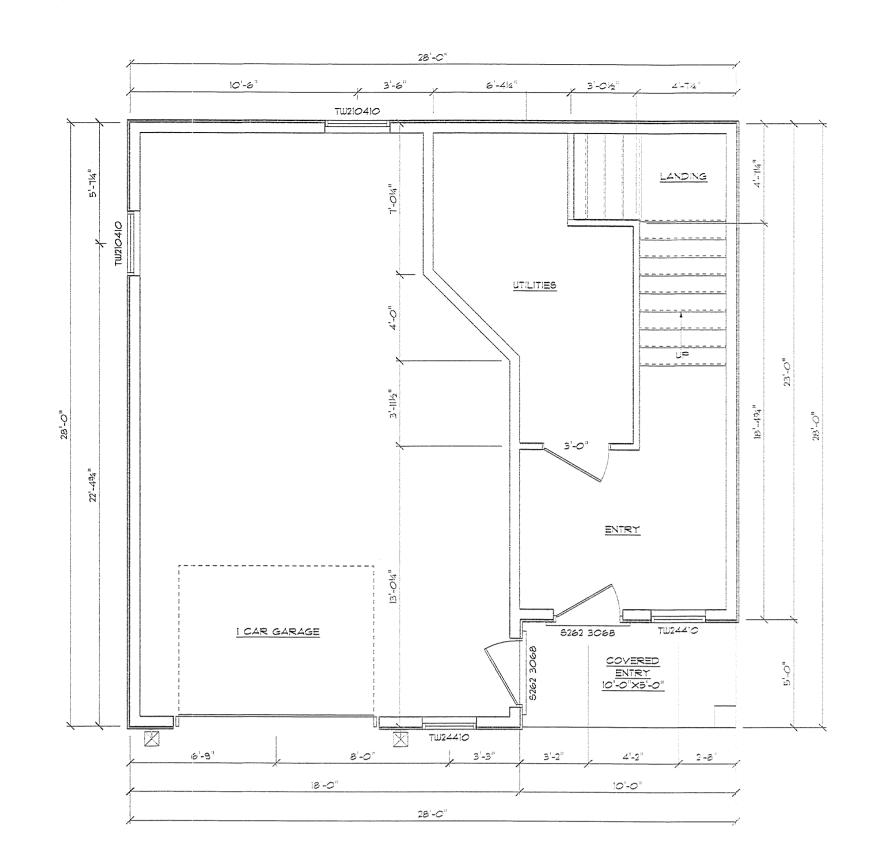

LEVEL ONE PLAN

SCALE: 14" = 1'-0"

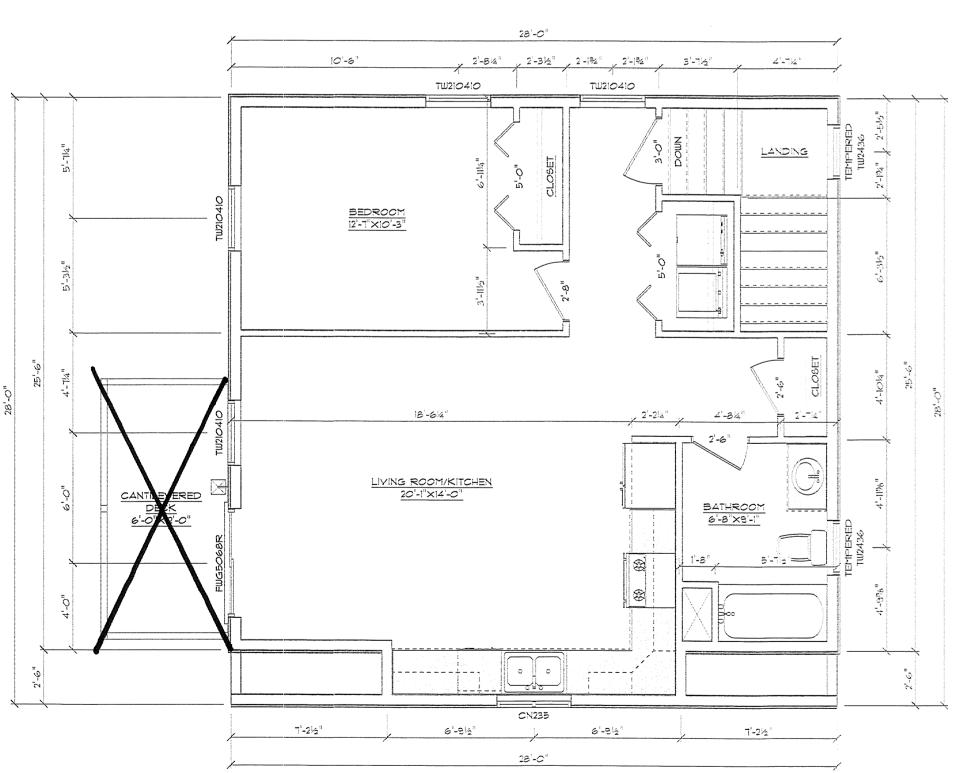

LEVEL TWO PLAN

749 SQUARE FEET SCALE: 1/4" = 1'-0"

MEMBER A AMERICAN INSTITUTE of BUILDING DESIGN SHEET NUMBER

PLAN NUMBER

4



133 Court Street Portsmouth, NH 03801-4413

October 18, 2019

Juliet T. H. Walker, AICP, Planning Director City of Portsmouth Municipal Complex Planning Department 1 Junkins Avenue Portsmouth, New Hampshire 03801

Re: Application for Site Plan Approval Assessor's Map 145, Lot 292 32 Union Street Altus Project #P4972

Dear Juliet:

On behalf of Gwyn Burdell and Francis Delbene, Altus Engineering, Inc. (Altus) respectfully submits an application for Site Plan Review for the development of a one car garage and an apartment above at 32 Union Street where an existing duplex exists and will remain. The applicants obtained variances from the Board of Adjustment to allow for the project to proceed.

Attached are ten copies of the following plans and documents for the Technical Advisory Committee's consideration:

- Site Plans (4 full sized, 6 reduced);
- Opinion of Sitework cost;
- Site Plan Review Checklist
- Green Statement:
- Letter of Authorization;
- Drainage Computations.

Also enclosed the application fee check in the sum of \$641.00

Altus looks forward to presenting this project at the November 5th TAC meeting. Please call us if you have any questions or need any additional information.

Sincerely

Eric D. Weinrieb, P

President

wde/4972 TAC cvr ltr

Enclosure

Ecopy: Frank Delbene and Gwyn Burdell



"Green" Statement" Assessor's Map 145 Lot 29 32 Union Street Altus Project P4972

Pursuant to Section 2.4.3.1(a) of the Site Plan Review Regulations, Altus Engineering, Inc. (Altus) respectfully submits the following list of the project's "green" components for the redevelopment of the property located at 32 Union Street:

- The new structure allows for more densification of development on a relatively small footprint. Thus maximizing development in an urban area.
- The new building will be code compliant building that will meet or exceed all applicable current energy codes.
- The new development will manage runoff discharge in a responsible way. The new impervious area from the building will discharge into stone drip edges and a stone infiltration basin to mitigate the additional runoff.
- The proposed site lighting will be building mounted and will be dark sky friendly.
- The new building will have covered parking which reduces the transport of contaminants during rainfall events.

Wde/4972-App-City-Site-GreenStatment

32 UNION STREET APPLICATION FEE SPREADSHEET October 18, 2019

P4972

TOTAL APPLICATION FEE		\$641
plus \$10.00 per 1,000 SF of development area	3,300 SF	\$33
plus \$5.00 per \$1,000 of site work cost	\$21,579	\$108
All developments		\$500



133 Court Street Portsmouth, NH 03801-4413

Delbene & Burdell

32 Union Street Portsmouth, NH

PRELIMINARY OPINION OF SITEWORK COST

DATE:

16-Oct-19

PROJECT:

4972

ITEM DESCRIPTION	QUANTITY	UNIT	UNIT PRICE	TOTAL COST
SITEWORK DEMOLITION				
DEMOLITION DEMOLITION AND MOBILIZATION	1	LS	\$2,000.00	\$2,000.00
PAVEMENT SAWCUT		LF	\$4.50	\$562.50
SEWER SERVICE				
4-INCH GRAVITY SDR 35	55	LF	\$35.00	\$1,925
			*	* ',
/ATER SERVICE DOMESTIC WATER SERVICES	47	LF	\$32.00	\$1.504
WATER TAPS AND CURB STOPS		EA	\$32.00 \$500.00	\$1,504 \$500
			404 0.00	****
AS SERVICE GAS SERVICES	65	LF	#26.00	£4 COC
GAS SERVICES	65	LF	\$26.00	\$1,690
LECTRIC/PHONE/CABLE SERVICES				
UNDERGROUND ELECTRIC AND TELE-COMMUNICATION CONDUITS	68	LF	\$34.00	\$2,312
TORM DRAINAGE SYSTEM				
EROSION CONTROL RIPRAP AND DRIP EDGE	1	LS	\$1,500.00	\$1,500
EDIMENT AND EROSION CONTROL				
TEMPORARY EROSION CONTROL	1	LS	\$450.00	\$450
AGGREGATE BASE COURSES				
12" GRAVEL (NHDOT 304.2)		CY	\$18.00	\$1,440
6" CRUSHED GRAVEL (NHDOT 304.3)		CY	\$22.00	\$880
CUTS AND FILLS	250	CY	\$12.00	\$3,000
OT BITUMINOUS PAVEMENT				
2.5" BASE COURSE		TONS	\$110.00	\$990
1.5" WEARING COURSE	5	TONS	\$110.00	\$550
LOAM AND SEED - TURF ESTABLISHMENT	1	LS	\$750.00	\$750
WALKWAYS		SY	\$35.00	\$525
REPAIR BRICK SIDEWALK		LS	\$1,000.00	\$1,000
LIGHTING				
LIGHTING	NIC			
SUBTOTAL				\$21,579
		7	OTAL:	\$21,579
		-		7=.,0.0

EXCLUSIONS: ITEMS EXCLUDED FROM THIS ESTIMATE INCLUDE, BUT ARE NOT LIMITED TO, THOSE ITEMS SPECIFIED ABOVE AS BEING NOT INCLUDED IN THIS ESTIMATE AND THE FOLLOWING: LEDGE REMOVAL, TAPPING FEES, INSPECTIONS, UTILITY SERVICE FEES

Tel: (603) 433-2335

E-mail: Altus@altus-eng.com



133 Court Street Portsmouth, NH 03801-4413

DRAINAGE MEMO

Assessor's Map 145, Lot 292 32 Union Street Altus Project #P4972

Gwyn Burdell and Francis Delbene are proposing to add construct a one car garage and an apartment above at the property located at 32 Union Street, where an existing duplex exists and will remain. The property is identified as Assessor's Parcel 145-29 and is 5,529 square feet in size. The applicants have obtained variances from the Board of Adjustment to allow for the project to proceed. The existing site drains to two locations identified as Point of Analysis (POA) #1 and #2 on the attached drainage plans. POA #1 is located to the rear of lot and is a catch basin located on the adjacent parcel 145-33. POA #2 is the surface runoff that flows to the Union Street drainage system. Both flows eventually meet at CB #1291. However, this analysis separated the two locations to specifically show that there would not be an increase to the runoff to the catch basin located on parcel 145-33.

The proposed development will construct an 18-inch deep stone drip edge around the perimeter of the new building and extend the drip edge to a 5 foot wide retention and treatment area in behind the building. This will provide retention and first flush treatment for the new impervious areas. The Pre and Post-Development conditions were modeled using the Northeast Regional Climate Center rainfall intensities with a 15% increase for Seacoast communities. The results were then compared to analyze the Pre and Post development conditions. The table below shows the results of the modeling.

	Stormwate				
Description	1 year	2 Year	10 Year	25 Year	50 Year
Rainfall Intensity (inches)	3.05	3.68	5.58	7.07	8.46
Results	cfs	cfs	cfs	cfs	cfs
POA #1			1		
PRE-Development	0.12	0.17	0.32	0.44	0.56
POST-Development	0.03	0.09	0.31	0.41	0.52
Change	(0.09)	(0.08)	(0.01)	(0.03)	(0.04)
POA #2					
PRE-Development	0.05	0.07	0.12	0.16	0.19
POST-Development	0.08	0.10	0.17	0.23	0.28
Change	0.03	0.03	0.05	0.07	0.09
TOTALS	(0.06)	(0.05)	0.04	0.04	0.05

The storm water flows from the site are minimal. The results show that Post-development runoff flows are managed so that there is not an increase to POA #1. There is a minor increase to the flows that go to Union Street due to the regrading of the driveway to slope towards the road. This results in a negligible increase of less than 0.1 cfs for all storms, including the 50 year storm event. As the above table demonstrates, the proposed project will not negatively impact the adjacent parcels or downstream stormwater conditions.

Extreme Precipitation Tables

Northeast Regional Climate Center

Data represents point estimates calculated from partial duration series. All precipitation amounts are displayed in inches.

Smoothing

State

New Hampshire

Location

Longitude 70.771 degrees West

Latitude Elevation

43.085 degrees North

Date/Time Wed, 28 Aug 2019 16:06:47 -0400

Extreme Precipitation Estimates

	5min	10min	15min	30min	60min	120min		1hr	2hr	3hr	6hr	12hr	24hr	48hr		1day	2day	4day	7day	10day	
1yr	0.26	0.40	0.50	0.65	0.81	1.04	1yr	0.70	0.98	1.21	1.56	2.02	2.65	2.91	1yr	2.35	2.80	3.21	3.93	4.53	1yr
2yr	0.32	0.50	0.62	0.81	1.02	1.30	2yr	0.88	1.18	1.51	1.93	2.48	3.20	3.56	2yr	2.83	3.42	3.92	4.67	5.31	2yr
5yr	0.37	0.58	0.73	0.97	1.24	1.60	5yr	1.07	1.46	1.88	2.42	3.13	4.05	4.56	5yr	3.59	4.39	5.02	5.91	6.68	5yr
10yr	0.41	0.65	0.82	1.11	1.45	1.88	10yr	1.25	1.72	2.22	2.88	3.74	4.85	5.51	10yr	4.29	5.30	6.06	7.08	7.95	10yr
25yr	0.48	0.76	0.96	1.33	1.77	2.33	25yr	1.52	2.13	2.76	3.61	4.72	6.15	7.07	25yr	5.44	6.80	7.76	8.98	10.01	25yr
50yr	0.53	0.85	1.09	1.53	2.06	2.74	50yr	1.78	2.52	3.27	4.30	5.64	7.36	8.55	50yr	6.51	8.22	9.37	10.76	11.93	50yr
100yr	0.59	0.96	1.24	1.76	2.40	3.24	100yr	2.07	2.96	3.88	5.13	6.74	8.82	10.34	100yr	7.80	9.94	11.32	12.90	14.22	100yr
200yr	0.67	1.09	1.42	2.03	2.80															16.95	
500yr	0.79	1.30	1.70	2.46	3.45															21.40	

Lower Confidence Limits

	5min	10min	15min	30min	60min	120min		1hr	2hr	3hr	6hr	12hr	24hr	48hr		1day	2day	4day	7day	10day	
1yr	0.23	0.36	0.44	0.59	0.73	0.88	1yr	0.63	0.86	0.92	1.32	1.67	2.22	2.48	1yr	1.96	2.38	2.85	3.16	3.86	1vr
2yr	0.31	().49	0.60	0.81	1.00	1.19	2yr	0.86	1.16	1.36	1.82	2.34	3.05	3.44	2yr	2.70	3.31	3.81	4.53	5.06	2yr
5yr	0.35	0.54	0.67	0.92	1.17	1.40	5yr	1.01	1.37	1.61	2.12	2.74	3.77	4.17	5yr	3.34	4.01	4.70	5.51	6.21	5vr
10yr	0.38	0.59	0.73	1.02	1.32	1.60	10yr	1.14	1.56	1.81	2.39	3.06	4.35	4.84	10yr	3.85	4.65	5.41	6.38	7.16	10yr
25yr	0.44	0.67	0.83	1.18	1.56	1.90	25yr	1.34	1.86	2.10	2.76	3.55	4.67	5.86	25yr	4.13	5.63	6.60	7.74	8.63	25vr
50yr	0.48	0.73	0.91	1.31	1.76	2.16	50yr	1.52	2.12	2.34	3.09	3.94	5.27	6.76	50yr	4.66	6.50	7.66	8.97	9.96	50vr
100yr	0.53	0.81	1.01	1.46	2.00	2.47	100yr	1.73	2.41	2.62	3.43	4.37	5.91	7.80	100yr	5.23	7.50	8.89	10.42	11.48	100vr
200yr	0.59	0.89	1.12	1.63	2.27	2.81	200yr	1.96	2.75	2.93	3.80	4.82	6.61	8.99	200yr	5.85	8.64	10.30	12.10	13.27	200yr
500yr	0.68	1.01	1.31	1.90	2.70	3.36	500yr	2.33	3.29	3.40	4.35	5.49	7.67	10.85	500vr	6.79	10.43	12.53	14.79	16.05	500yr

Upper Confidence Limits

	5min	10min	15min	30min	60min	120min		1hr	2hr	3hr	6hr	12hr	24hr	48hr		1day	2day	4day	7day	10day	
1yr	0.28	().44	0.54	0.72	0.89	1.08	1yr	0.77	1.06	1.25	1.74	2.21	2.98	3.15	1yr	CONTRACTOR OF THE PARTY OF THE	-	3.57	4.37	5.03	1vr
2yr	0.34	0.52	0.64	0.86	1.06	1.27	2yr	0.92	1.24	1.48	1.96	2.52	3.42	3.69	2yr	3.03	3.55	4.08	4.82	5.62	2vr
5yr	0.40	0.62	0.76	1.05	1.33	1.62	5yr	1.15	1.58	1.88	2.53	3.25	4.33	4.95	5yr	3.83	4.76	5.36	6.35	7.13	5vr
10yr	0.47	0.72	0.89	1.24	1.60	1.97	10yr	1.38	1.93	2.28	3.10	3.95	5.32	6.19	10yr	4.71	5.95	6.80	7.81	8.73	10yr
25yr	0.57	0.87	1.08	1.55	2.04	2.56	25yr	1.76	2.50	2.95	4.06	5.14	7.79	8.32	25yr	6.89	8.00	9.13	10.31	11.38	25yr
50yr	0.67	1.02	1.26	1.82	2.45	3.11	50yr	2.11	3.04	3.59	4.99	6.30	9.76	10.44	50yr	8.64	10.04	11.41	12.69	13.93	50yr
100yr	0.78	1.18	1.48	2.14	2.94	3.79	100yr	2.54	3.70	4.36	6.14	7.73	12.22	13.08	100yr	10.82	12.58	14.28	15.65	17.05	100yr
200yr	0.92	1.38	1.75	2.53	3.53	4.62	200yr	3.04	4.51	5.32	7.55	PLANT THE PARTY NAMED IN COLUMN TWO	Consideration of the last	CONTRACTOR STREET	THE RESIDENCE OF THE PARTY OF	- Named and Address of the Owner, where the Owner, which	_	-	A THE PARTY OF THE	20.88	200yr
500yr	1.14	1.69	2.17	3.16	4.49	COLUMN TO SERVICE DE LA COLUMN TO SERVICE DESCRICE DE LA COLUMN TO SERVICE DE	THE RESERVE THE PERSON NAMED IN COLUMN 1	Proposition and a	G oorancement	PARTICIPATION OF THE PARTY OF T	STATE OF THE PARTY NAMED IN PORTY	A CONTRACTOR OF THE PARTY OF TH	CHORNAL METAWARDINA	Описансирациональности	PROMINENTERSON	TOTAL PROPERTY OF THE PARTY OF	CONTRACTOR OF THE PARTY OF	Accessor - Contraction	-	27.30	



