


- LEGEND:**
- IRON ROD TO BE SET
 - IRON PIPE FOUND
 - CHAIN LINK FENCE
 - FENCE
 - 110-5 TAX SHEET - LOT NUMBER
 - RCRD ROCKINGHAM COUNTY REGISTRY OF DEEDS
 - EOP EDGE OF PAVEMENT
 - VGC VERTICAL FACED GRANITE CURB
 - RWW WOOD RETAINING WALL
 - RWG GRANITE RETAINING WALL
 - HANDICAP SPACE
 - UTILITY POLE
 - UTILITY POLE W/TRANSFORMER
 - LIGHT POLE
 - UTILITY POLE WITH ARM & LIGHT
 - GUY
 - ELECTRIC METER
 - HVAC UNIT
 - GAS METER
 - GAS SHUT OFF
 - GAS VALVE
 - WATER GATE VALVE
 - WATER SHUT OFF VALVE
 - HYDRANT
 - CATCH BASIN
 - DRAIN MANHOLE
 - ROOF DOWNSPOUT
 - SEWER MANHOLE
 - DECIDUOUS TREE
 - DECIDUOUS SHRUB
 - W - WATER LINE
 - S - SEWER LINE
 - D - DRAIN LINE
 - G - GAS LINE
 - ▨ CEMENT CONCRETE
 - ▨ BRICK PAVERS
 - ▨ RETAINING WALL
 - LA LANDSCAPED AREA
 - x12.5 SPOT GRADE

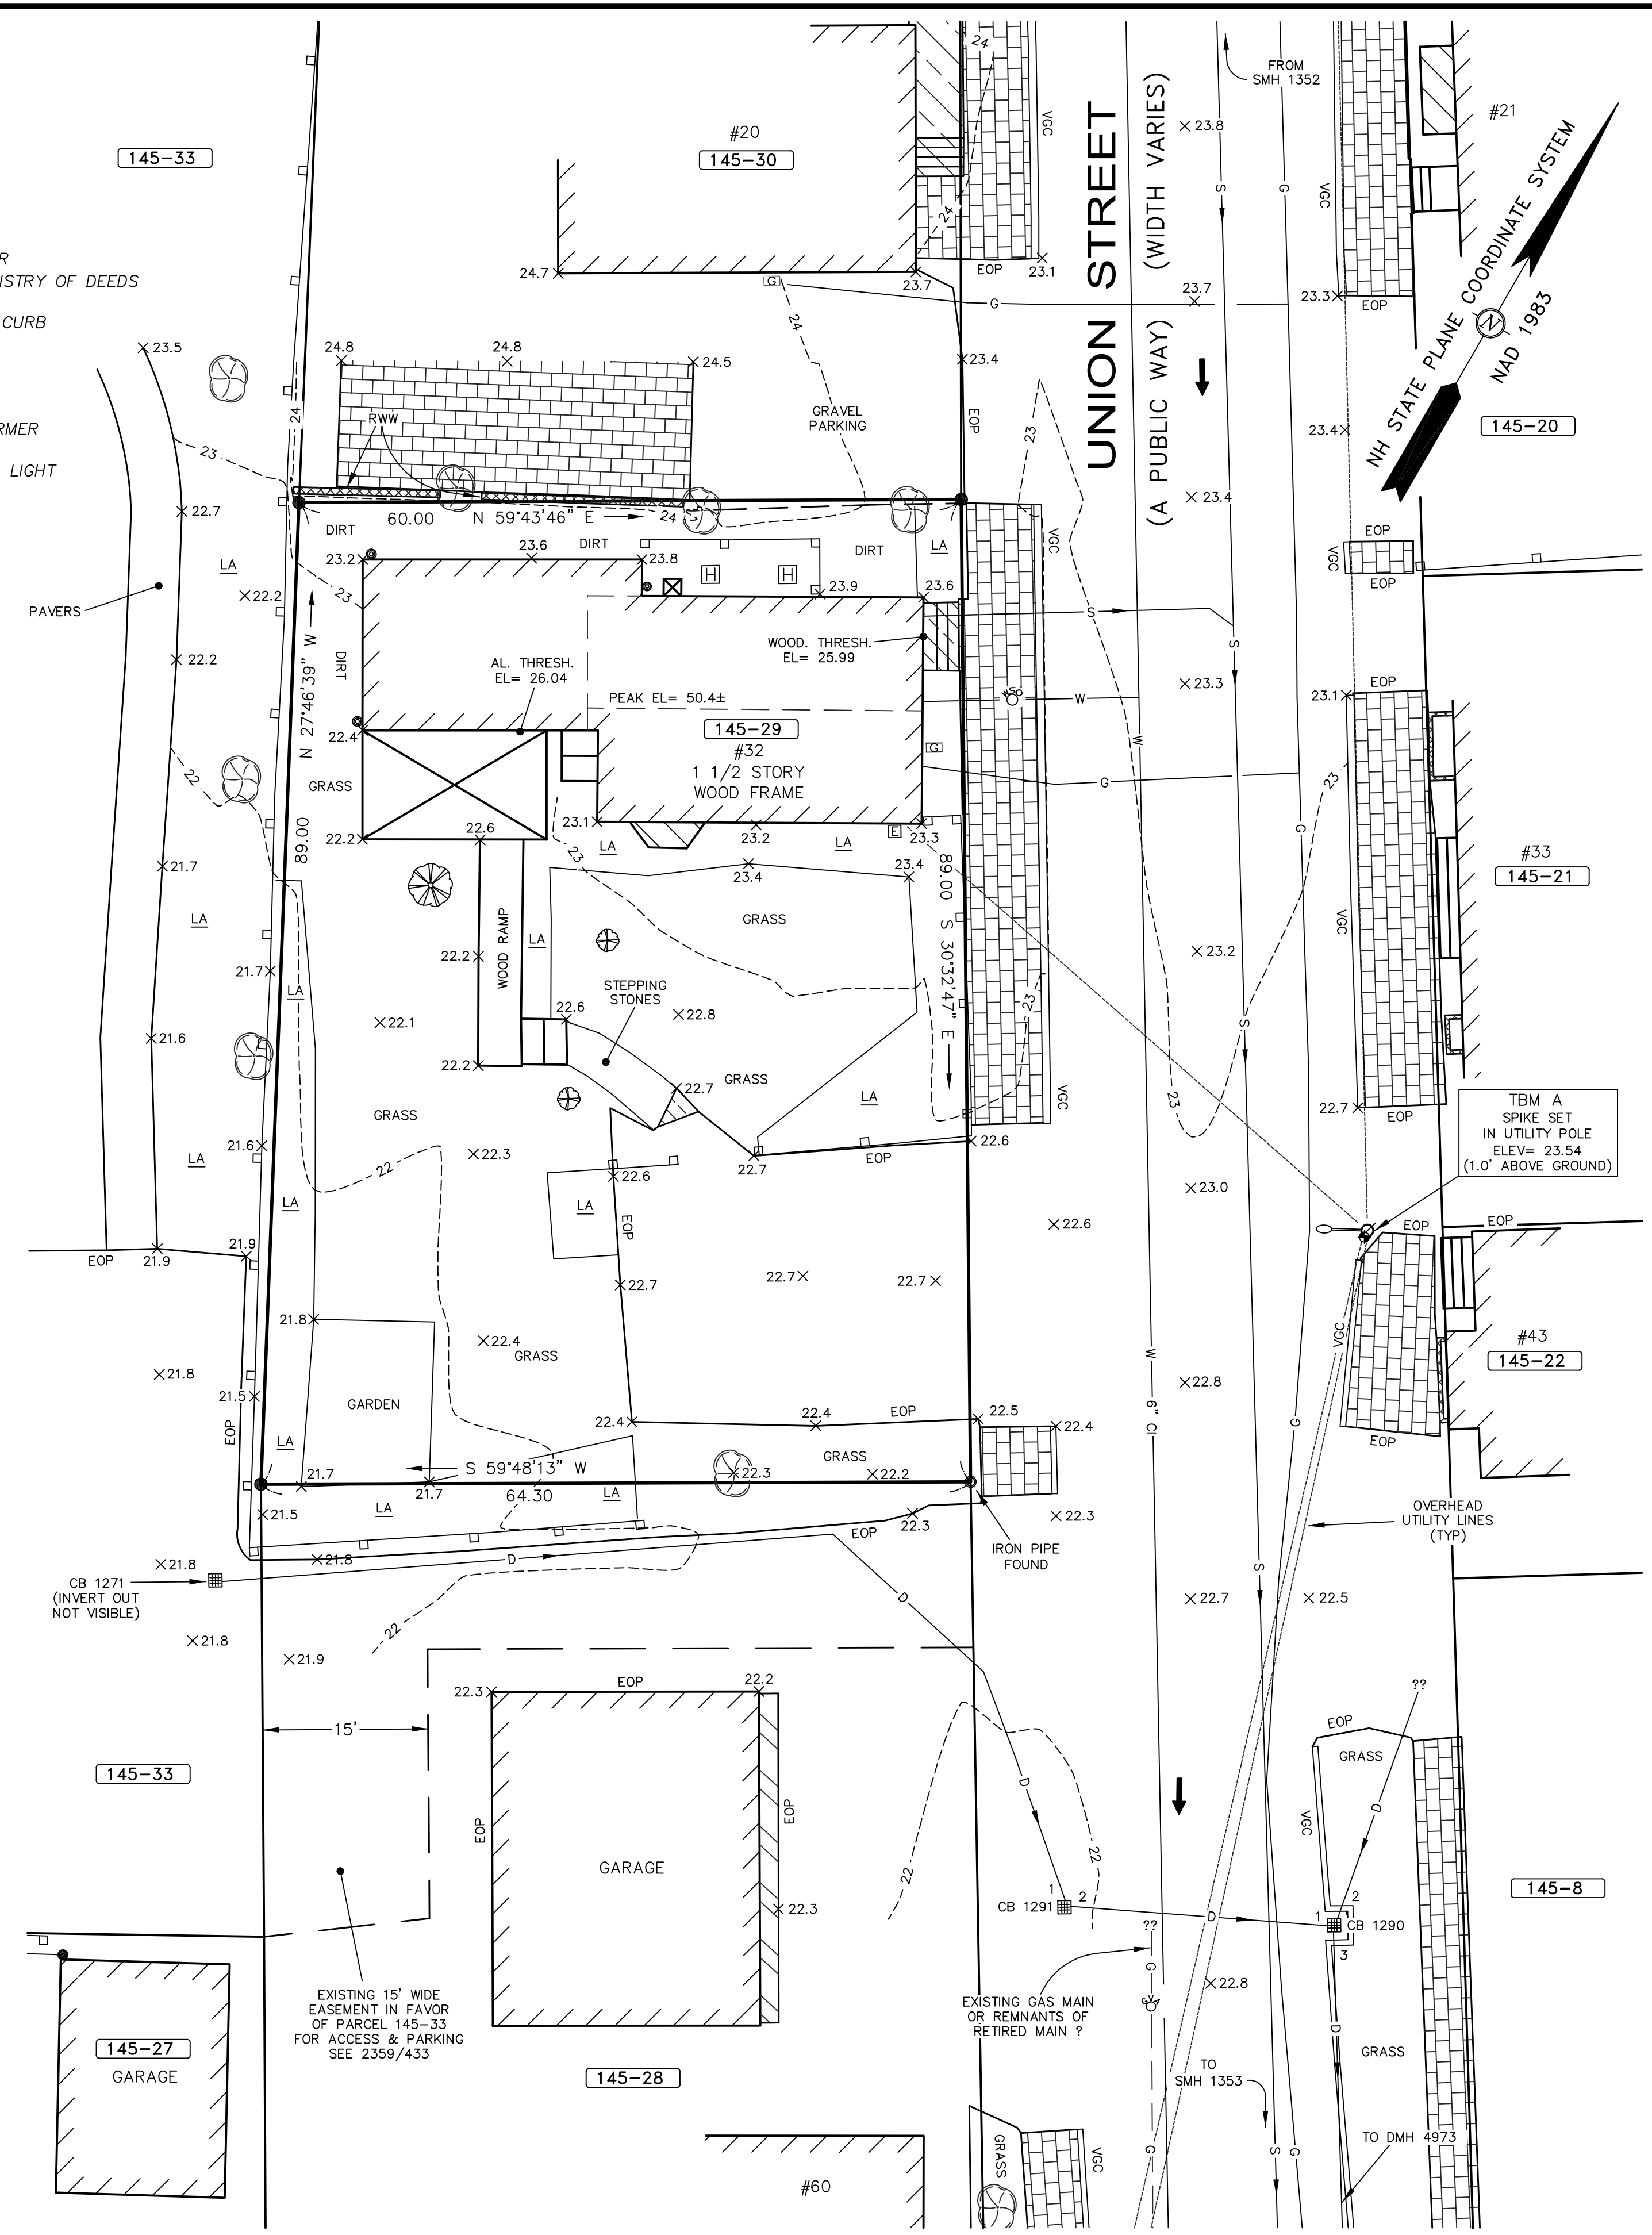



- NOTES:**
- OWNER OF RECORD.....FRANCIS T. DELBENE & GWYN M. BURDELL
ADDRESS.....165 GRANT AVE, PORTSMOUTH, NH 03801
DEED REFERENCE.....5612/1228
TAX SHEET / LOT.....145-29
PARCEL AREA 5,529 S.F.
 - THE RELATIVE ERROR OF CLOSURE WAS LESS THAN 1 FOOT IN 15,000 FEET.
 - ZONED:.....GRC FRONT YARD SETBACK.....5'
MINIMUM LOT AREA 3,500 S.F. SIDE YARD SETBACK.....10'
FRONTAGE.....70' REAR YARD SETBACK.....20'
 - THE LOCATION OF ALL UNDERGROUND UTILITIES SHOWN HEREON ARE APPROXIMATE AND ARE BASED UPON THE FIELD LOCATION OF ALL VISIBLE STRUCTURES (IE CATCH BASINS, MANHOLES, WATER GATES ETC.) AND INFORMATION COMPILED FROM PLANS PROVIDED BY UTILITY COMPANIES AND GOVERNMENTAL AGENCIES. ALL CONTRACTORS SHOULD NOTIFY, IN WRITING, SAID AGENCIES PRIOR TO ANY EXCAVATION WORK AND CALL DIG-SAFE @ 1-888-DIG-SAFE.
 - CONTRACTOR TO VERIFY SITE BENCHMARKS BY LEVELING BETWEEN 2 BENCHMARKS PRIOR TO THE SETTING OR ESTABLISHMENT OF ANY GRADES/ELEVATIONS. DISCREPANCIES ARE TO BE REPORTED TO JAMES VERRA AND ASSOC., INC.
 - THIS PLAN IS BASED ON A FIELD SURVEY PERFORMED 4/2019 BY JAMES VERRA AND ASSOCIATES, INC. ON SITE CONTROL ESTABLISHED USING SURVEY GRADE GPS UNITS. COORDINATE SYSTEM: NH STATE PLANE COORDINATE SYSTEM OF 1983 (ZONE 2800) HORIZONTAL DATUM: NAD 1983 (2011)(EPOCH:2010.0000) VERTICAL DATUM: NAVD 1988 PRIMARY BM: CITY CONTROL POINT "ROBE"
 - THE BOARD OF ADJUSTMENT AT ITS REGULAR MEETING ON JUNE 19, 2018 COMPLETED ITS CONSIDERATION OF THE APPLICATION DESCRIBED AS FOLLOWS:
APPLICATION:
CASE 6-3
PETITIONERS: FRANCIS T. DELBENE & GWYNN M. BURDELL
PROPERTY: 32 UNION STREET
ASSESSOR PLAN: MAP 145, LOT 29
ZONING DISTRICT: GENERAL RESIDENCE C DISTRICT
DESCRIPTION: CONSTRUCT A 26'x 32' CARRIAGE HOUSE/GARAGE WITH A 3RD DWELLING UNIT VARIANCES AND/OR SPECIAL EXCEPTIONS NECESSARY TO GRANT THE REQUIRED RELIEF FROM THE ZONING ORDINANCE INCLUDING THE FOLLOWING VARIANCES FROM SECTION 10.521:
a) A LOT AREA PER DWELLING UNIT OF 1,887± S.F. WHERE 3,500 S.F. IS REQUIRED;
b) A 6'± REAR YARD WHERE 20' IS REQUIRED.
- ACTION:**
THE BOARD VOTED TO GRANT THE PETITION AS PRESENTED AND ADVERTISED.
- THE SUBJECT TRACT LIES IN ZONE X (AREAS DETERMINED TO BE OUTSIDE 0.2% ANNUAL CHANCE FLOODPLAIN) AS SHOWN ON FLOOD INSURANCE RATE MAP NO. 33015C0259E, EFFECTIVE DATE MAY 17, 2005, BY FEMA.

- REFERENCE PLANS:**
- PLAN OF LOT, NO. 32 UNION STREET, PORTSMOUTH, N.H., SCALE: 1"= 15', DATED 7/1947, FILE NO. 141-1, BY JOHN W. DURGIN CE, NOT RECORDED.

ABUTTERS LIST

MAP-LOT	OWNER OF RECORD	DEED REF.
145-8	DAWN SAARI, 843 STATE ST, PORTSMOUTH, NH 03801	5884/2140
145-20	ABNER W. CLARK & ELIZAH D. HULSEMAN 21 UNION ST, PORTSMOUTH, NH 03801	5739/1036
145-21	JOSEPH R. KELLEY C/O RAY JEFFS CPA 24 STICKNEY TERRACE #9, HAMPTON, NH 03842	4692/1459
145-22	WESTON B. STRUWE & BRITTA C. WYATT 20 CUMBERLAND RD, OXFORD OX4 2DA, O UK	4723/2260
145-27	S. CHRISTOPHER ANCTL, 73 EXETER RD, NORTH HAMPTON, NH 03862	5252/2935
145-28	ANN R. PATTISON TRUST AGREEMENT, ANN RENEE PATTISON HUUKO, TR. PO BOX 12, NEW CASTLE, NH 03854	5522/1703
145-30	HARRY N. STARBRANCH, JR., 20 UNION ST, PORTSMOUTH, NH 03801	3221/2082
145-33	404 ISLINGTON STREET LLC 404 ISLINGTON ST, PORTSMOUTH, NH 03801	5496/2593

SEWER TABLE	DRAIN TABLE
SMH 1352 RIM EL= 25.52 (1) INV OUT 12"VCP= 18.92	CB 1271 RIM EL= 21.57 (INVERT OUT NOT ACCESSIBLE)
SMH 1353 RIM EL= 23.95 (1) INV IN 12"VCP= 15.04	CB 1290 RIM EL= 22.03 (1) INV IN 12"VCP= 18.56 (2) INV IN 12"VCP= 18.56 (3) INV OUT 12"VCP= 18.56 SUMP EL= 17.0±
	CB 1291 RIM EL= 21.63 (1) INV IN 6"VCP= 19.77 (2) INV OUT 12"VCP= 18.87 SUMP EL= 18.6±
	DMH 4973 RIM EL= 23.80 (1) INV IN 12"VCP= 17.68

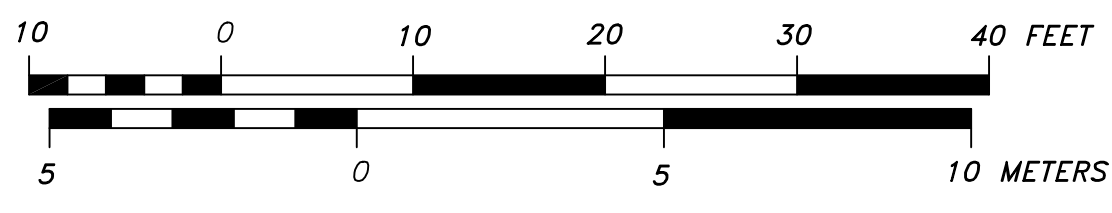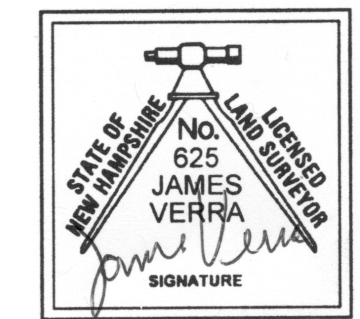

SURVEYOR:
James Verra and Associates, Inc.
LAND SURVEYORS
101 SHATTUCK WAY - SUITE 8
NEWINGTON, N.H. 03801- 7876
603-436-3557
JOB NO: 23793
PLAN NO: 23793

ENGINEER:
ALTUS ENGINEERING, INC.
133 COURT STREET PORTSMOUTH, NH 03801
(603) 433-2335 www.ALTUS-ENG.com

ISSUED FOR:
ENGINEERING DESIGN

ISSUE DATE:
MAY 15, 2019

REVISIONS

NO.	DESCRIPTION	BY	DATE
1	ENGINEERING DESIGN	JV	5/15/19

DRAWN BY: JCS
APPROVED BY: JV
DRAWING FILE: 23793.DWG

SCALE:
22" x 34" - 1" = 10'
11" x 17" - 1" = 20'

OWNER/APPLICANT:
FRANCIS T. DELBENE
GWYN M. BURDELL
32 UNION STREET
PORTSMOUTH, N.H.
ASSESSOR'S PARCEL 145-29


MAILING ADDRESS:
165 GRANT AVENUE
PORTSMOUTH, N.H. 03801

PROJECT:
PROPOSED SITE DEVELOPMENT PLANS
32 UNION STREET
PORTSMOUTH, N.H.
ASSESSOR'S PARCEL 145-29

TITLE:
EXISTING CONDITIONS PLAN

SHEET NUMBER:
1 OF 1

P4972

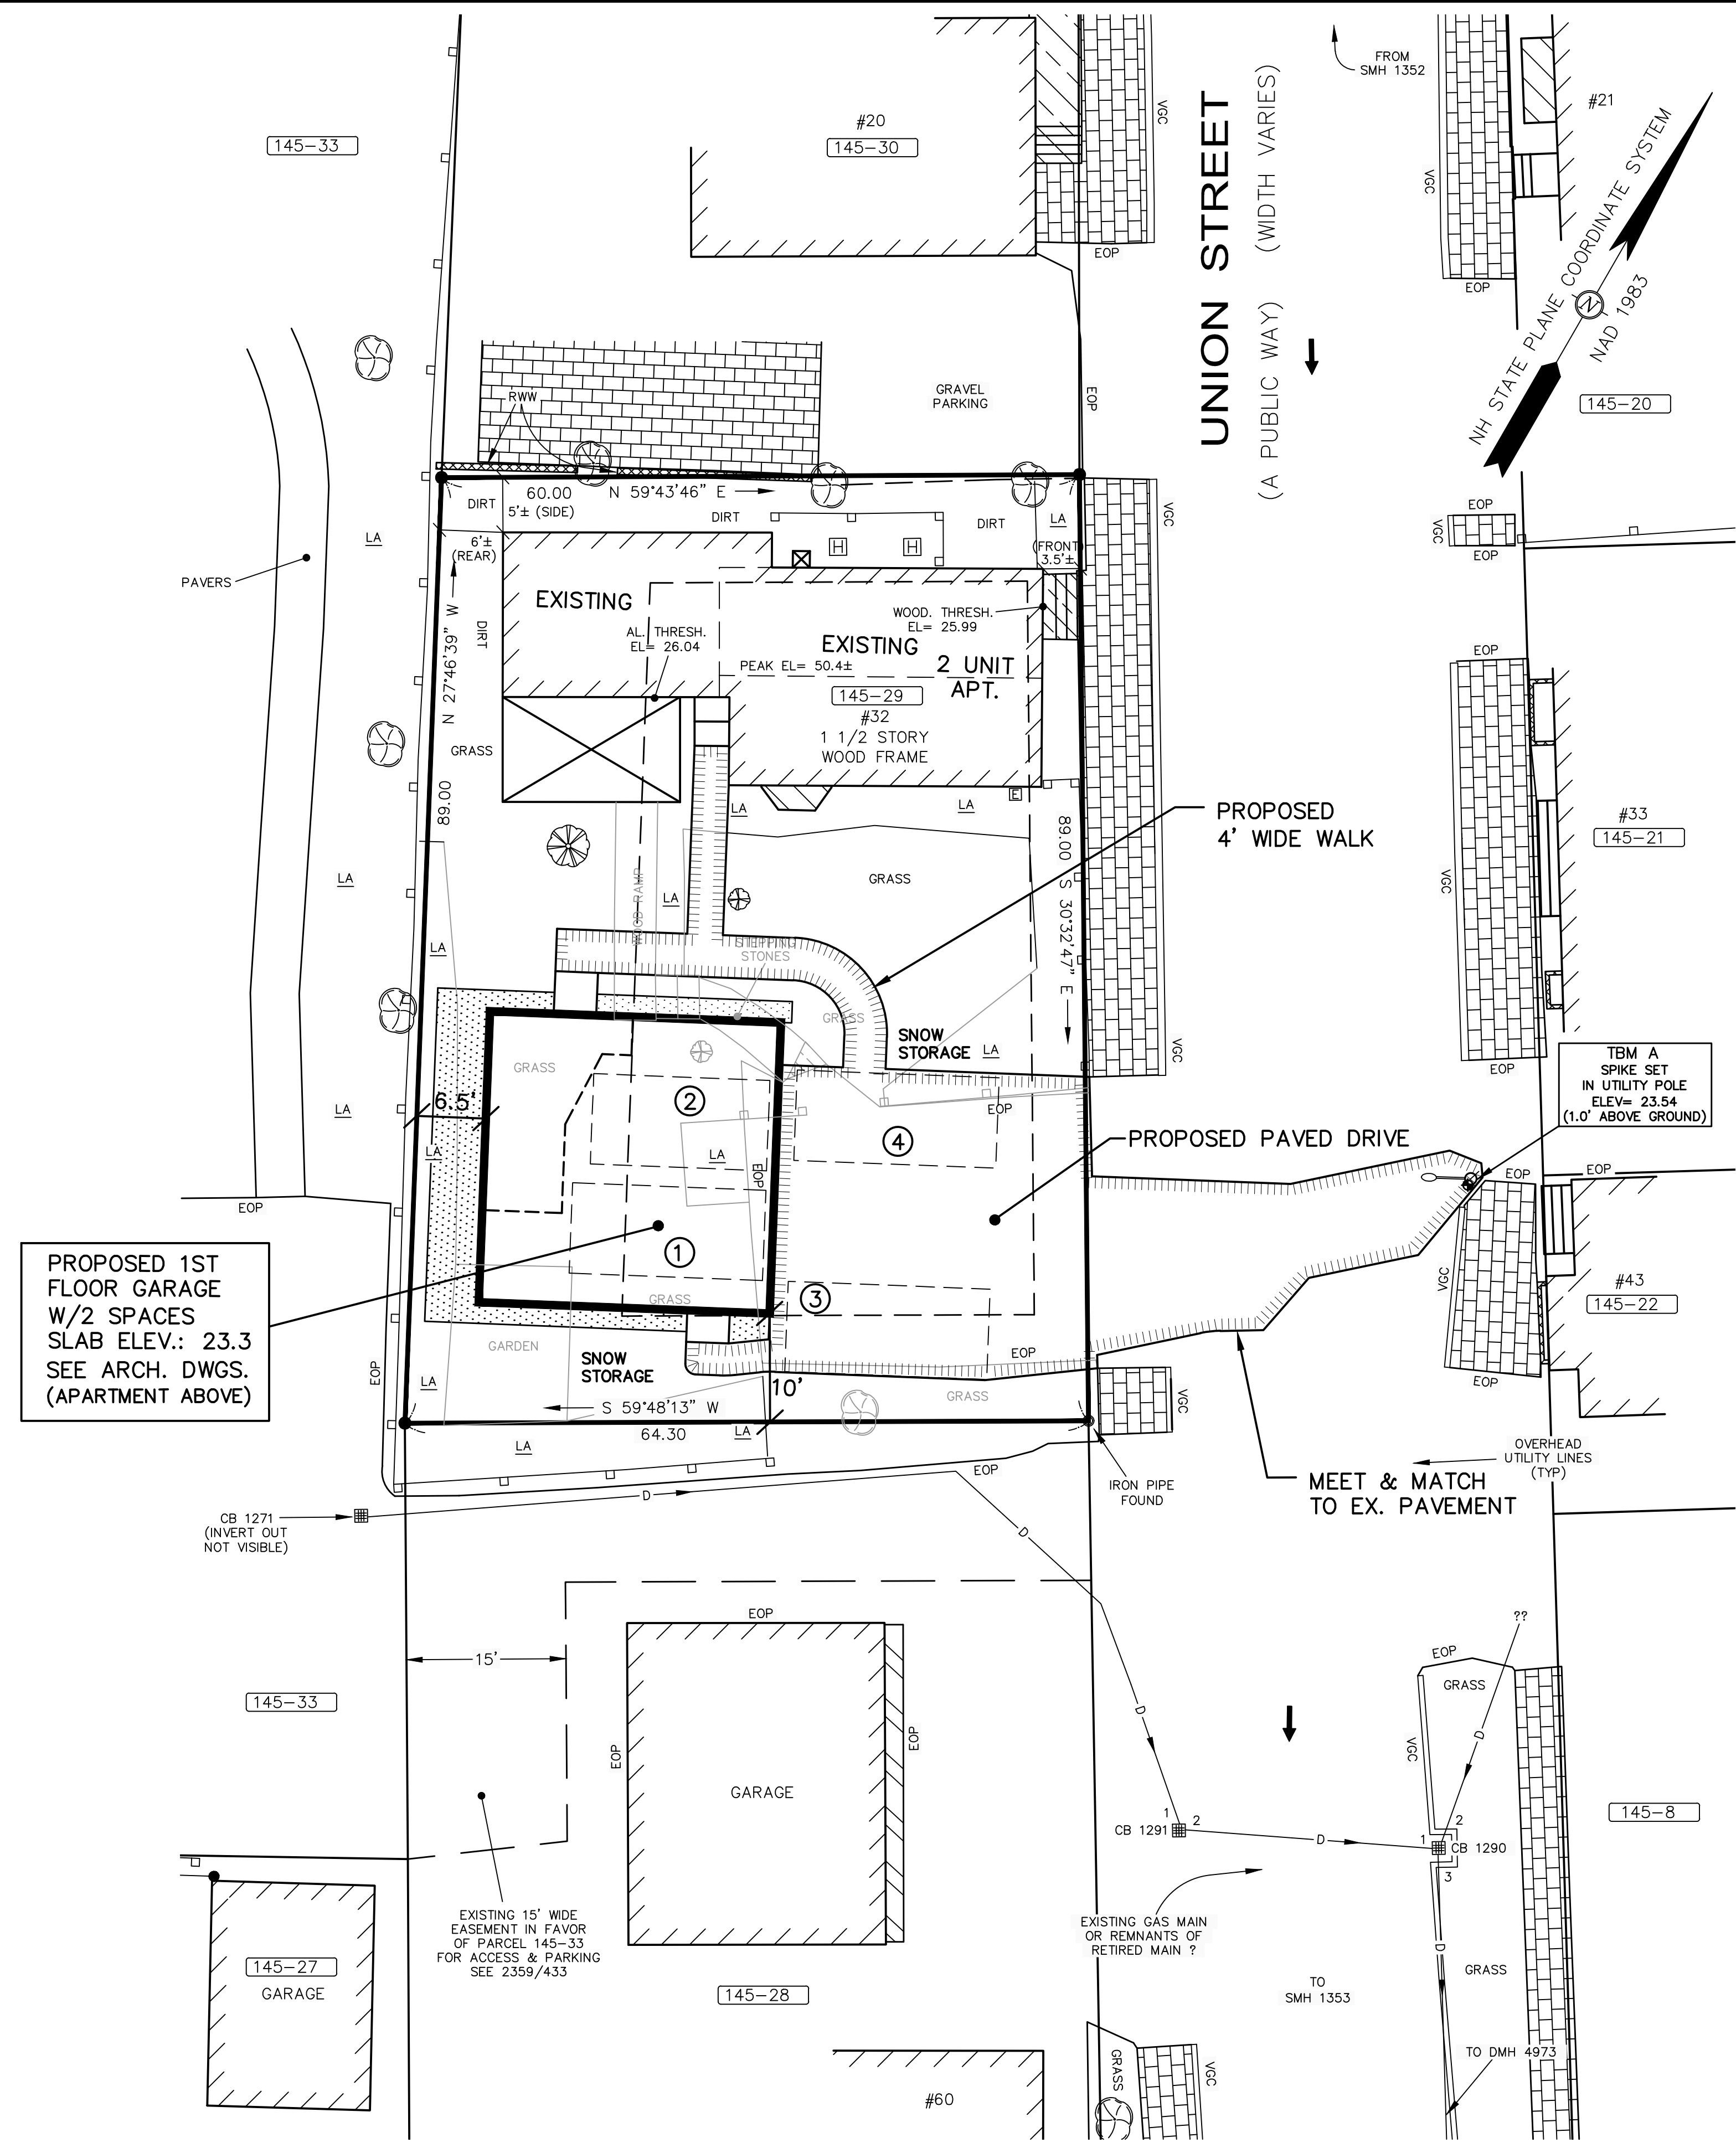

APPROVED BY THE PORTSMOUTH PLANNING BOARD

CHAIRMAN _____ DATE _____

ZONING SUMMARY

THE PARCEL IS LOCATED IN THE GRC ZONE.

MIN. LOT AREA REQUIRED: 3,500 SF
 LOT AREA PROVIDED: 5,529 SF

MIN. FRONTAGE REQUIRED: 70'
 FRONTAGE PROVIDED: 89'

BUILDING SETBACKS	REQUIRED	PROVIDED
MIN. FRONT YARD:	5'	3.5' (EXISTING)
MIN. SIDE YARD:	10'	5' (EXISTING)
MIN. REAR YARD:	20'	6' (EXISTING)
		6.5' (PROPOSED) *
MAX. BLDG. HEIGHT:	35'	<35'
MAX. BLDG. COVERAGE:	35%	34%
MIN. OPEN SPACE:	20%	42%

PARKING CALCULATION:
 1.3 SPACES/UNIT x 3 UNITS = 3.9 SPACES REQUIRED
 4 SPACES PROVIDED

MULTI-FAMILY DWELLING UNITS ALLOWED

LOT AREA PER DWELLING UNIT: 3,500 SF REQUIRED
 LOT AREA PER DWELLING UNIT PROPOSED : 1,843 SF± *


* ZONING RELIEF GRANTED 6/19/2018

GENERAL NOTES

1. THE INTENT OF THIS PLAN SET IS TO PROVIDE THE NECESSARY INFORMATION FOR THE REVIEW, PERMITTING AND CONSTRUCTION OF A 2-CAR GARAGE W/AN APARTMENT ABOVE. THESE PLANS PROVIDE DETAILED INFORMATION FOR THE SITE LAYOUT, GRADING, UTILITIES, STORMWATER MANAGEMENT, AND LANDSCAPE IMPROVEMENTS.
2. DO NOT BEGIN CONSTRUCTION UNTIL ALL STATE, LOCAL AND FEDERAL PERMITS HAVE BEEN APPLIED FOR AND RECEIVED. THE LANDOWNER AND THE CONTRACTOR SHALL BE RESPONSIBLE FOR COMPLYING WITH LOCAL, STATE AND FEDERAL WETLAND PERMITTING REQUIREMENTS INCLUDING PROTECTION OF NATURAL RESOURCES AND THEIR BUFFERS.
3. CONTRACTOR SHALL CALL DIG SAFE AT 1 (800) DIG-SAFE AT LEAST SEVENTY-TWO (72) HOURS PRIOR TO COMMENCING CONSTRUCTION.
4. CONTRACTOR SHALL NOTIFY CITY OF PORTSMOUTH DEPARTMENT OF PUBLIC WORKS PRIOR TO COMMENCING CONSTRUCTION ACTIVITIES.
5. CONTRACTOR SHALL INSTALL AND MAINTAIN A TEMPORARY SECURITY FENCE AROUND THE PERIMETER OF THE WORK AREA THROUGHOUT CONSTRUCTION.
6. CONTRACTOR SHALL INSTALL AND MAINTAIN TEMPORARY SEDIMENT AND EROSION CONTROL ITEMS TO PREVENT SEDIMENT FROM CONSTRUCTION ACTIVITIES FROM LEAVING THE SITE. CONTROLS SHALL BE INSPECTED ON A REGULAR BASIS AND AFTER ALL RAIN EVENTS OF 0.25 INCHES OR GREATER. ANY DEFICIENCIES IN THE CONTROLS SHALL BE ADDRESSED IMMEDIATELY AND BROUGHT TO THE ATTENTION OF THE OWNER. ALL STORM DRAINS WITHIN OR ADJACENT TO THE WORK AREA, WITH THE POTENTIAL TO RECEIVE RUNOFF FROM EXPOSED CONSTRUCTION AREAS, SHALL RECEIVE STORM DRAIN INLET PROTECTION. CONTRACTOR SHALL PREVENT TRACKING OF DIRT ONTO ANY PUBLIC OR PRIVATE ROADWAYS. IF TRACKING OF DIRT FROM CONSTRUCTION VEHICLES IS PRESENT ON THE OPEN STREETS, CONTRACTOR WILL BE REQUIRED TO SWEEP THE ROADWAY AT NO ADDITIONAL EXPENSE TO THE OWNER.
- 7.

GENERAL SITE NOTES

1. ON JUNE 19, 2018 THE PORTSMOUTH BOARD OF ADJUSTMENT GRANTED THE FOLLOWING VARIANCES FROM SECTION 10.521:
 TO PROVIDE A LOT AREA PER DWELLING UNIT OF +/-1,887 SF WHERE 3,500 SF IS REQUIRED A +/- 6 FOOT REAR YARD WHERE 20- FEET IS REQUIRED.
2. ALL BONDS AND FEES SHALL BE PAID/POSTED PRIOR TO INITIATING CONSTRUCTION.
3. ALL CONDITIONS OF THIS APPROVAL SHALL REMAIN IN EFFECT IN PERPETUITY PURSUANT TO THE REQUIREMENTS OF THE SITE PLAN REVIEW REGULATIONS.
4. ALL CONSTRUCTION SHALL MEET THE MINIMUM CONSTRUCTION STANDARDS OF THE CITY OF PORTSMOUTH & NHDOT'S STANDARD SPECIFICATIONS FOR ROAD & BRIDGE, LATEST EDITION. THE MORE STRINGENT SPECIFICATION SHALL GOVERN.
5. CLEAN AND COAT VERTICAL FACE OF EXISTING PAVEMENT AT SAWCUT LINE WITH RS-1 IMMEDIATELY PRIOR TO PLACING NEW BITUMINOUS CONCRETE.
6. THE CONTRACTOR SHALL VERIFY ALL BENCHMARKS AND TOPOGRAPHY IN THE FIELD PRIOR TO CONSTRUCTION.
7. THE CONTRACTOR SHALL VERIFY ALL BUILDING DIMENSIONS WITH THE ARCHITECTURAL AND STRUCTURAL PLANS PRIOR TO CONSTRUCTION. ALL DISCREPANCIES SHALL BE IMMEDIATELY BROUGHT TO THE ATTENTION OF THE ARCHITECT AND ENGINEER FOR RESOLUTION.
8. AREA OF DISTURBANCE UNDER 43,560 SF, COVERAGE UNDER EPA NPDES PHASE II CONSTRUCTION GENERAL PERMIT NOT REQUIRED
9. SNOW SHALL BE STORED AT THE EDGE OF PAVEMENT, IN UPLAND AREAS SHOWN THEREON. NO SNOW STORAGE SHALL BE PROVIDED IN THE LANDSCAPED ISLAND BETWEEN THE DRIVEWAY ENTRANCE AND EXIT THAT WOULD RESTRICT SITE VEHICULAR AND PEDESTRIAN SIGHT DISTANCE. IF ADEQUATE ON-SITE SNOW STORAGE IS NOT AVAILABLE, THE SNOW SHALL BE REMOVED FROM THE SITE AND LEGALLY DISPOSED. PAVEMENT MARKINGS - NONE PROPOSED.
10. PAVEMENT MARKINGS AND SIGNS SHALL CONFORM TO THE REQUIREMENTS OF THE "MANUAL ON UNIFORM TRAFFIC DEVICES," "STANDARD ALPHABETS FOR HIGHWAY SIGNS AND PAVEMENT MARKINGS" AND THE AMERICANS WITH DISABILITIES ACT (ADA), LATEST EDITIONS - NONE PROPOSED.
11. THE CONTRACTOR SHALL VERIFY ALL BUILDING DIMENSIONS WITH THE ARCHITECTURAL AND STRUCTURAL DRAWINGS PRIOR TO CONSTRUCTION. ANY AND ALL DISCREPANCIES SHALL BE IMMEDIATELY BROUGHT TO THE ATTENTION OF BOTH THE ARCHITECT AND CIVIL ENGINEER FOR RESOLUTION.
12. ALL IMPROVEMENTS SHOWN ON THIS SITE PLAN SHALL BE CONSTRUCTED AND MAINTAINED IN ACCORDANCE WITH THE PLAN BY THE PROPERTY OWNER AND ALL FUTURE PROPERTY OWNERS. NO CHANGES SHALL BE MADE TO THIS SITE PLAN WITHOUT THE EXPRESS APPROVAL OF THE PORTSMOUTH PLANNING DIRECTOR.
13. THE SITE PLAN SHALL BE RECORDED IN THE ROCKINGHAM COUNTY REGISTRY OF DEEDS.
14. SITEMARK CONTRACTOR SHALL PREPARE A LICENSED LAND SURVEYOR (LLS) STAMPED AS-BUILT SITE PLAN & PROVIDE A DIGITAL (CAD FORMAT) COPY FOR THE CITY'S G.I.S. DATA BASE.
15. THE PROPOSED LIGHTING WILL BE BUILDING MOUNTED AND SHALL BE DARK SKY FRIENDLY.
- 16.

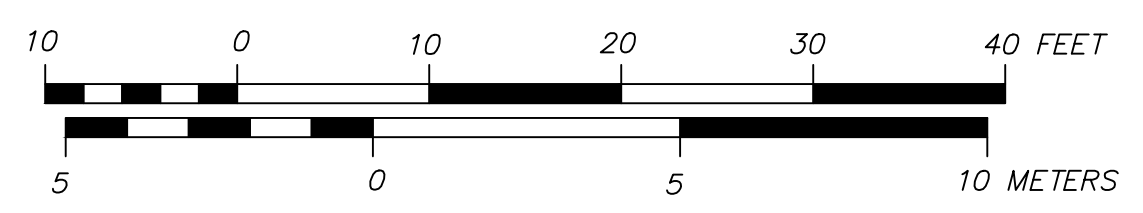

ENGINEER:

ALTUS
ENGINEERING, INC.

133 COURT STREET PORTSMOUTH, NH 03801
 (603) 433-2335 www.ALTUS-ENG.com

ISSUED FOR: TAC WORKSHOP

ISSUE DATE: JUNE 3, 2019

REVISIONS

NO.	DESCRIPTION	BY	DATE
0	TAC WORKSHOP	EDW	06/03/19

DRAWN BY: _____ RLH

APPROVED BY: _____ EDW

DRAWING FILE: 4972.DWG

SCALE:
 22" x 34" - 1" = 10'
 11" x 17" - 1" = 20'

OWNER/APPLICANT:
 FRANCIS T. DELBENE
 GWYN M. BURDELL
 32 UNION STREET
 PORTSMOUTH, N.H.
 ASSESSOR'S PARCEL 145-29

MAILING ADDRESS
 165 GRANT AVENUE
 PORTSMOUTH, N.H. 03801

PROJECT:
PROPOSED SITE DEVELOPMENT PLANS
 32 UNION STREET
 PORTSMOUTH, N.H.
 ASSESSOR'S PARCEL 145-29

TITLE:
SITE PLAN

SHEET NUMBER:
C-1

P4972

APPROVED BY THE PORTSMOUTH PLANNING BOARD

CHAIRMAN _____ DATE _____

145-33

#20
145-30

UNION STREET
(A PUBLIC WAY)
(WIDTH VARIES)

#21
145-20

NH STATE PLANE COORDINATE SYSTEM
NAD 1983

EXISTING
WOOD. THRESH.
EL= 25.99
AL. THRESH.
EL= 26.04
EXISTING 2 UNIT APT.
1 1/2 STORY WOOD FRAME
PEAK EL= 50.4±

PROPOSED SANITARY SEWER SERVICE

NO FLOOR DRAINS IN GARAGE

TM A SPIKE SET IN UTILITY POLE
ELEV= 23.54
(1.0' ABOVE GROUND)

#43
145-22

145-8

145-33

145-28

145-27
GARAGE

#60

SEWER TABLE

SMH 1352
RIM EL= 25.52
(1) INV OUT 12"VCP= 18.92

SMH 1353
RIM EL= 23.95
(1) INV IN 12"VCP= 15.04

DRAIN TABLE

CB 1271
RIM EL= 21.57
(INVERT OUT NOT ACCESSIBLE)

CB 1290
RIM EL= 22.03
(1) INV IN 12"CMP= 18.56
(2) INV IN 12"CMP= 18.56
(3) INV OUT 12"CMP= 18.56
SUMP EL= 17.0±

CB 1291
RIM EL= 21.63
(1) INV IN 6"PVC= 19.77
(2) INV OUT 12"CMP= 18.87
SUMP EL= 18.6±

DMH 4973
RIM EL= 23.80
(1) INV IN 12"CMP= 17.68

PROPOSED NATURAL GAS SERVICE

CB 1271
(INVERT OUT NOT VISIBLE)

PROPOSED 1" WATER SERVICE


PROPOSED UNDERGROUND ELECTRIC & TELE-COMMUNICATIONS CONDUITS

DEMOLITION NOTES

1. THE LOCATION OF ALL UNDERGROUND UTILITIES SHOWN HEREON ARE APPROXIMATE AND ARE BASED UPON FIELD LOCATION OF VISIBLE UTILITIES AND INFORMATION PROVIDED BY THE UTILITIES AGENCIES. THE LOCATIONS ARE NOT GUARANTEED BY THE ENGINEER, SURVEYOR OR OWNER. IT IS THE CONTRACTOR'S RESPONSIBILITY TO LOCATE ALL UTILITIES, ANTICIPATE CONFLICTS, REPAIR ANY DAMAGE DONE TO THE UTILITIES, AND RELOCATE EXISTING UTILITIES (IF REQUIRED) AT NO EXTRA COST TO THE OWNER. UTILITY CONFLICTS SHALL BE RESOLVED WITH THE INVOLVEMENT OF THE ENGINEER AND UTILITY COMPANY.
2. CONTRACTOR SHALL SAFELY SECURE THE SITE WITH SECURITY FENCING. FENCING SHALL BE LOCKED DURING NON-WORK HOURS.
3. CITY DEMOLITION PERMIT REQUIRED PRIOR TO ANY DEMOLITION ACTIVITIES. CONTRACTOR IS NOTIFIED THAT THIS PERMIT PROCESS MAY REQUIRE A 30-DAY LEAD TIME.
4. CONTRACTOR SHALL PRESERVE AND PROTECT ALL EXISTING UTILITIES SCHEDULED TO REMAIN. THIS DEMOLITION PLAN IS INTENDED TO PROVIDE MINIMUM GUIDELINES FOR THE DEMOLITION OF EXISTING SITE FEATURES. UNLESS OTHERWISE NOTED TO REMAIN, THE CONTRACTOR SHALL BE RESPONSIBLE FOR THE REMOVAL OF ALL PAVEMENT, CONCRETE, CURBING, SIGNS, POLES, UTILITIES, FENCES, VEGETATION AND OTHER EXISTING FEATURES AS NECESSARY TO FULLY CONSTRUCT THE PROJECT.
5. THE CONTRACTOR SHALL BE RESPONSIBLE FOR THE TIMELY NOTIFICATION OF ALL PARTIES, CORPORATIONS, COMPANIES, INDIVIDUALS AND STATE AND LOCAL AUTHORITIES OWNING AND/OR HAVING JURISDICTION OVER ANY UTILITIES RUNNING TO, THROUGH OR ACROSS AREAS TO BE DISTURBED BY DEMOLITION AND/OR CONSTRUCTION ACTIVITIES WHETHER OR NOT SAID UTILITIES ARE SUBJECT TO DEMOLITION, RELOCATION, MODIFICATION AND/OR CONSTRUCTION.
6. ALL UTILITY DISCONNECTIONS/DEMOLITIONS/RELOCATIONS TO BE COORDINATED BETWEEN THE CONTRACTOR, ALL APPROPRIATE UTILITY COMPANIES AND THE PORTSMOUTH DEPARTMENT OF PUBLIC WORKS. UNLESS OTHERWISE SPECIFIED, THE CONTRACTOR SHALL BE RESPONSIBLE FOR ALL RELATED EXCAVATION, TRENCHING AND BACKFILLING.
7. ALL STRUCTURES, CURBING, CONCRETE, PAVEMENT AND SUBBASE MATERIALS SHALL BE REMOVED FROM PROPOSED LANDSCAPE AREAS AND REPLACED WITH LOAM MATERIALS SUITABLE FOR LANDSCAPE AND/OR STORMWATER MANAGEMENT PURPOSES AND MEETING THE PROJECT SPECIFICATIONS. WHERE SPECIFIED TO REMAIN, MANHOLE RIMS, CATCH BASIN GRATES, VALVE COVERS, HANDHOLES, MONITORING WELLS, ETC. SHALL BE ADJUSTED TO FINISH GRADE.
8. NO BURNING SHALL BE PERMITTED PER LOCAL REGULATIONS.
9. HAZARDOUS MATERIALS ENCOUNTERED DURING DEMOLITION AND CONSTRUCTION ACTIVITIES SHALL BE ABATED IN STRICT ACCORDANCE WITH ALL APPLICABLE STATE AND LOCAL REGULATIONS.
10. SEE EROSION CONTROL PLANS FOR EROSION CONTROL REQUIREMENTS TO BE IN PLACE PRIOR TO START OF DEMOLITION ACTIVITIES INCLUDING, BUT NOT LIMITED TO; SILT FENCING, STABILIZED CONSTRUCTION SITE EXITS, AND STORM DRAIN INLET PROTECTION.
11. ALL DEMOLISHED MATERIALS OR MATERIALS SCHEDULED TO BE REMOVED SHALL BECOME THE PROPERTY OF THE CONTRACTOR UNLESS SPECIFIED.
12. ALL MATERIALS SCHEDULED TO BE REMOVED SHALL BE LEGALLY DISPOSED IN ACCORDANCE WITH ALL LOCAL, STATE, & FEDERAL REGULATIONS AND CODES.
13. LEDGE REMOVAL MAY BE REQUIRED ON THE PROJECT. THE CONTRACTOR SHALL PROVIDE THE CITY WITH A LEDGE REMOVAL PLAN. IF BLASTING IS TO BE PERFORMED, ALL STATE AND LOCAL REQUIREMENTS SHALL BE COMPLIED WITH. NO BLASTING IS ALLOWED WITHOUT A BLAST SURVEY BEING COMPLETED PRIOR TO.
14. CONTRACTOR SHALL COORDINATE ALL ELECTRICAL DISCONNECTIONS/INSTALLATIONS WITH EVERSOURCE. CONTACT NICK KOSKO @ 603-332-4227, EXT. 5555334
15. CONTRACTOR SHALL COORDINATE ALL NATURAL GAS DISCONNECTIONS/INSTALLATIONS WITH UNITIL CORPORATION. CONTACT DAVID BEAULIEU @ 603-294-5144
16. CONTRACTOR SHALL COORDINATE ALL CABLE DISCONNECTIONS/INSTALLATIONS WITH COMCAST.
17. CONTACT MIKE COLLINS @ 603-679-5695 EXT 1037
18. CONTRACTOR SHALL COORDINATE ALL TELE-COMMUNICATION DISCONNECTIONS AND INSTALLATION WITH CONSOLIDATED COMMUNICATIONS. CONTACT JOE CONSIDINE @ 603-427-5525

UTILITY NOTES

1. ALL WATER MAIN INSTALLATIONS AND SERVICE CONNECTIONS SHALL CONFORM TO PORTSMOUTH WATER DEPARTMENT STANDARDS.
2. ALL SEWER INSTALLATIONS AND SERVICE CONNECTIONS SHALL CONFORM TO PORTSMOUTH WATER AND SEWER DEPARTMENT STANDARDS. CONTRACTOR SHALL CONTACT PORTSMOUTH DPW FOR TESTING OF SEWER LINES.
3. DO NOT BEGIN CONSTRUCTION UNTIL ALL STATE, LOCAL, AND FEDERAL PERMITS HAVE BEEN APPLIED FOR AND RECEIVED. CONTRACTOR SHALL FAMILIARIZE THEMSELVES WITH ALL PERMIT CONDITIONS AND REQUIREMENTS.
4. THE CONTRACTOR SHALL BE RESPONSIBLE FOR POSTING OF ALL BONDS AND PAYMENT OF ALL TAP, TIE-IN AND CONNECTION FEES.
5. FIRE ALARM PANEL SHALL BE MONITORED THROUGH A THIRD-PARTY SECURITY COMPANY. CONTRACTOR SHALL COORDINATE ALL PANEL LOCATIONS AND INTERCONNECTIONS WITH FIRE DEPARTMENT.
6. THE APPLICANT SHALL HAVE A SITE SURVEY CONDUCTED BY A RADIO COMMUNICATIONS CARRIER APPROVED BY THE CITY'S COMMUNICATION DIVISION. THE RADIO COMMUNICATIONS CARRIER MUST BE FAMILIAR AND CONVERSANT WITH THE POLICE AND RADIO CONFIGURATION. IF THE SITE SURVEY INDICATES IT IS NECESSARY TO INSTALL A SIGNAL REPEATER EITHER ON OR NEAR THE PROPOSED PROJECT, THOSE COSTS SHALL BE THE RESPONSIBILITY OF THE PROPERTY OWNER. THE APPLICANT SHALL BE REQUIRED TO PAY FOR THE SITE SURVEY WHETHER OR NOT THE SURVEY INDICATES A REPEATER IS NECESSARY. THE OWNER SHALL COORDINATE WITH THE SUPERVISOR OF RADIO COMMUNICATIONS FOR THE CITY. THE SURVEY SHALL BE COMPLETED AND THE REPEATER, IF DETERMINED IT IS REQUIRED, SHALL BE INSTALLED PRIOR TO THE ISSUANCE OF CERTIFICATE OF OCCUPANCY.
7. ALL TRENCHING, PIPE LAYING AND BACKFILLING SHALL CONFORM TO FEDERAL OSHA AND CITY REGULATIONS.
8. SITEWORK CONTRACTOR SHALL COORDINATE ALL WORK WITH MECHANICAL DRAWINGS.
9. SEE ARCHITECTURAL/MECHANICAL DRAWINGS FOR EXACT LOCATIONS & ELEVATIONS OF UTILITY CONNECTIONS AT BUILDINGS. COORDINATE ALL WORK WITHIN FIVE (5) FEET OF BUILDINGS WITH BUILDING CONTRACTOR AND ARCHITECTURAL/MECHANICAL DRAWINGS. ALL CONFLICTS AND DISCREPANCIES SHALL BE BROUGHT TO THE ATTENTION OF THE ENGINEER IMMEDIATELY AND PRIOR TO COMMENCING RELATED WORK.
10. FINAL UTILITY LOCATIONS TO BE COORDINATED BETWEEN THE CONTRACTOR, ALL APPROPRIATE UTILITY COMPANIES AND THE ARCHITECT.
11. CONTRACTOR SHALL COORDINATE ALL TELECOMMUNICATIONS INSTALLATIONS WITH CONSOLIDATED COMMUNICATIONS.
12. CONTRACTOR SHALL COORDINATE ALL CABLE INSTALLATIONS WITH COMCAST.
13. CONTRACTOR SHALL COORDINATE ALL ELECTRICAL INSTALLATIONS WITH EVERSOURCE. ALL ELECTRIC CONDUIT INSTALLATION SHALL BE INSPECTED BY EVERSOURCE PRIOR TO BACKFILL, 48-HOUR MINIMUM NOTICE REQUIRED.
14. CONTRACTOR SHALL CONTACT CITY OF PORTSMOUTH DEPARTMENT OF PUBLIC WORKS AT 603-427-1530 TO COORDINATE INSPECTION OF SEWER WORK.

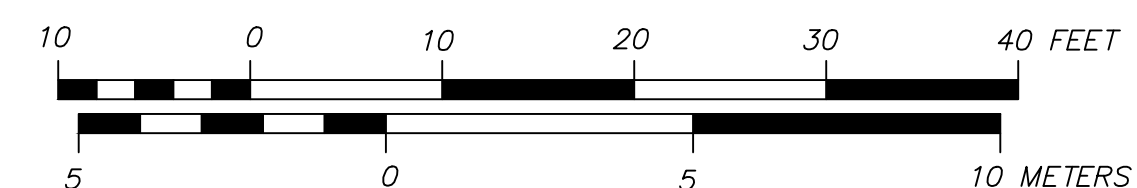

ENGINEER:

ALTUS
ENGINEERING, INC.

133 COURT STREET PORTSMOUTH, NH 03801
(603) 433-2335 www.ALTUS-ENG.com

ISSUED FOR:

TAC WORKSHOP

ISSUE DATE:

JUNE 3, 2019

REVISIONS

NO.	DESCRIPTION	BY	DATE
0	TAC WORKSHOP	EDW	06/03/19

DRAWN BY:

RLH

APPROVED BY:

EDW

DRAWING FILE:

4972.DWG

SCALE:

22" x 34" - 1" = 10'
11" x 17" - 1" = 20'

OWNER/APPLICANT:

FRANCIS T. DELBENE
GWYN M. BURDELL
32 UNION STREET
PORTSMOUTH, N.H.
ASSESSOR'S PARCEL 145-29

MAILING ADDRESS

165 GRANT AVENUE
PORTSMOUTH, N.H. 03801

PROJECT:

PROPOSED SITE
DEVELOPMENT
PLANS
32 UNION STREET
PORTSMOUTH, N.H.

ASSESSOR'S PARCEL
145-29


TITLE:

UTILITIES PLAN

SHEET NUMBER:

C-2

P4972

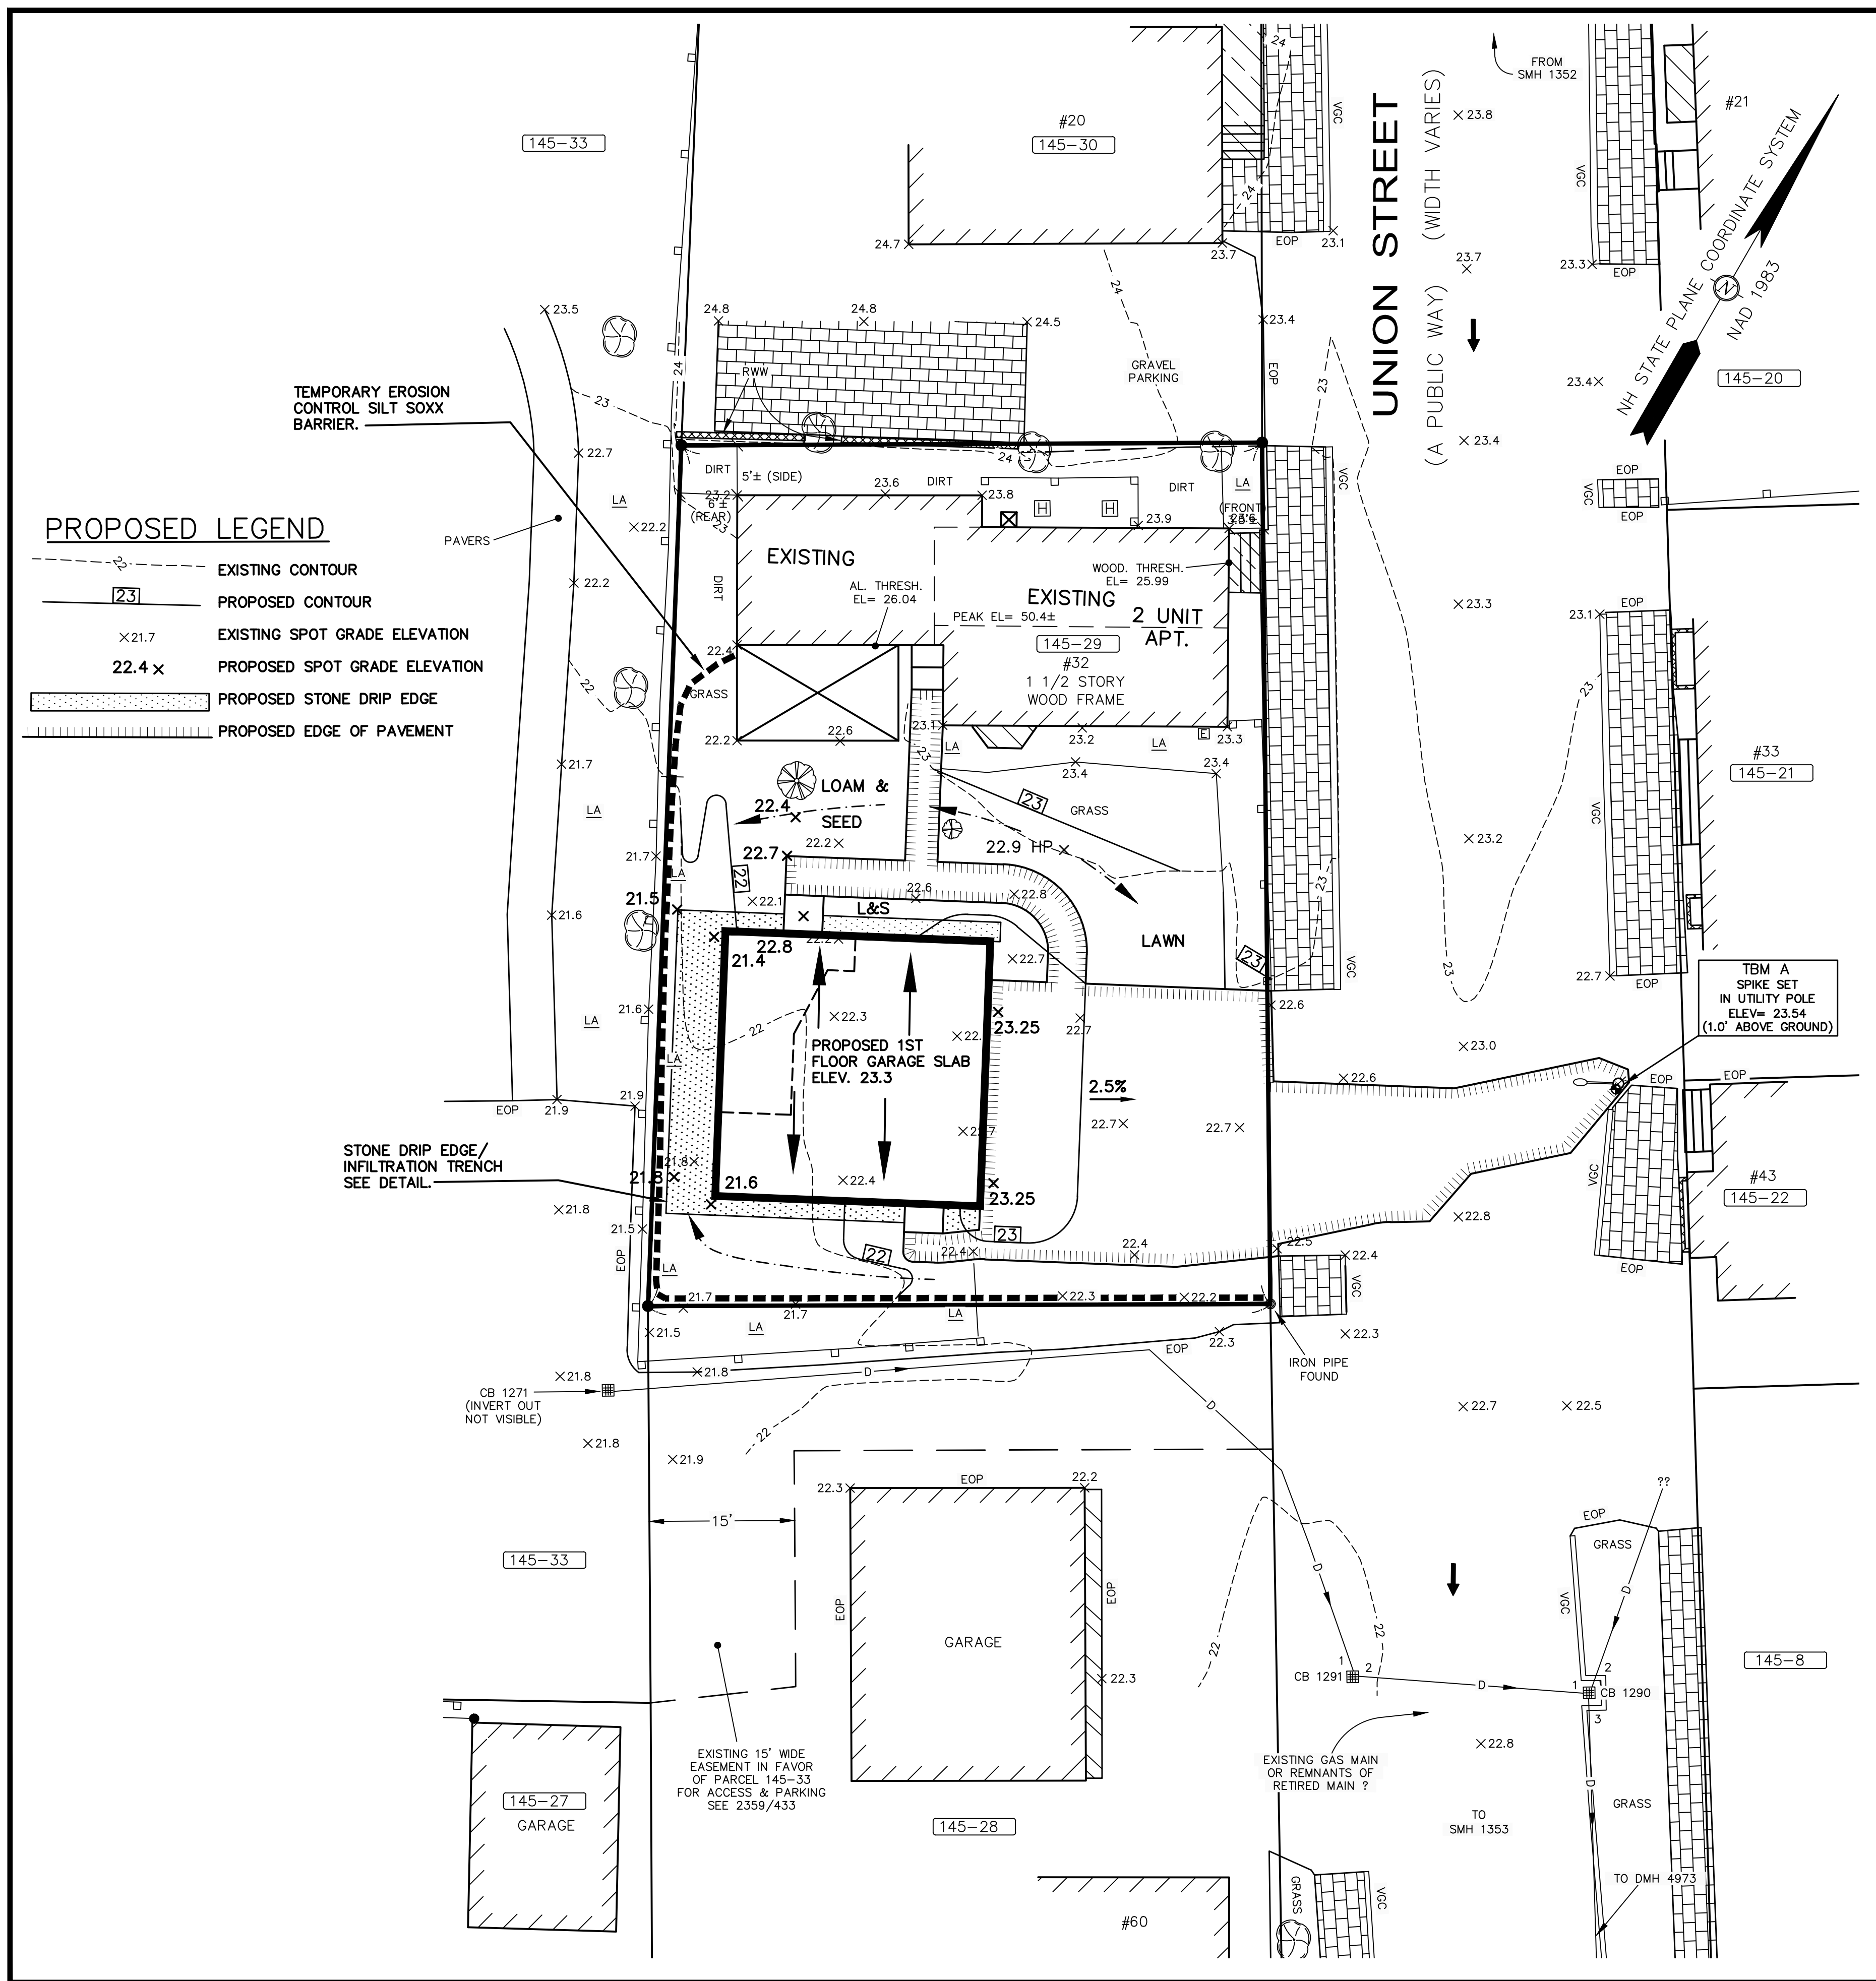

APPROVED BY THE PORTSMOUTH PLANNING BOARD

CHAIRMAN _____ DATE _____

ENGINEER:
ALTUS
 ENGINEERING, INC.
 133 COURT STREET PORTSMOUTH, NH 03801
 (603) 433-2335 www.ALTUS-ENG.com

PROPOSED LEGEND

- - - - - EXISTING CONTOUR
- 23 - - - - - PROPOSED CONTOUR
- X 21.7 EXISTING SPOT GRADE ELEVATION
- 22.4 x PROPOSED SPOT GRADE ELEVATION
- [Pattern] PROPOSED STONE DRIP EDGE
- [Pattern] PROPOSED EDGE OF PAVEMENT

GRADING AND DRAINAGE NOTES

1. PRIOR TO CONSTRUCTION, CONTRACTOR SHALL FIELD VERIFY LOCATIONS AND ELEVATIONS OF ALL EXISTING UTILITIES SCHEDULED TO REMAIN.
2. ALL BENCHMARKS AND TOPOGRAPHY SHALL BE FIELD VERIFIED BY THE CONTRACTOR PRIOR TO INITIATING CONSTRUCTION.
3. DEWATERING ACTIVITIES SHALL BE DONE IN ACCORDANCE WITH EPA AND NHDES REGULATIONS AND GUIDELINES.
4. PROTECTION OF SUBGRADE: THE CONTRACTOR SHALL BE REQUIRED TO MAINTAIN STABLE, DEWATERED SUBGRADES FOR FOUNDATIONS, PAVEMENT AREAS, UTILITY TRENCHES AND OTHER AREAS DURING CONSTRUCTION. SUBGRADE DISTURBANCE MAY BE INFLUENCED BY EXCAVATION METHODS, MOISTURE, PRECIPITATION, GROUNDWATER CONTROL, AND CONSTRUCTION ACTIVITIES. THE CONTRACTOR SHALL TAKE PRECAUTIONS TO PREVENT SUBGRADE DISTURBANCE. SUCH PRECAUTIONS MAY INCLUDE DIVERTING STORMWATER RUNOFF AWAY FROM CONSTRUCTION AREAS, REDUCING TRAFFIC IN SENSITIVE AREAS, AND MAINTAINING AN EFFECTIVE DEWATERING PROGRAM. SOILS EXHIBITING HEAVING OR INSTABILITY SHALL BE OVER EXCAVATED TO MORE COMPETENT BEARING SOIL AND BEARING SOIL AND REPLACED WITH FREE DRAINING STRUCTURAL FILL IF THE EARTHWORK IS PERFORMED DURING FREEZING WEATHER, EXPOSED SUBGRADES AREA SUSCEPTIBLE TO FROST. NO FILL OR UTILITIES SHALL BE PLACED ON FROZEN SOIL CRUST AT THE COMMENCEMENT OF EACH DAY'S OPERATIONS DEGREE OF INSULATION AGAINST FREEZING.
5. IF SUITABLE, EXCAVATED MATERIALS SHALL BE PLACED AS FILL WITHIN UPLAND AREAS ONLY AND SHALL NOT BE PLACED WITHIN WETLANDS. PLACEMENT OF BORROW MATERIALS SHALL BE PERFORMED IN A MANNER THAT PREVENTS LONG TERM DIFFERENTIAL SETTLEMENT. EXCESSIVELY WET MATERIALS SHALL BE STOCKPILED AND ALLOWED TO DRAIN BEFORE PLACEMENT. FROZEN MATERIAL SHALL NOT BE USED FOR CONSTRUCTION.
6. ALL STORM DRAIN PIPE SHALL BE ADS N-12 OR EQUAL AND APPROVED BY THE ENGINEER.
7. ALL CATCH BASIN, GATE VALVE COVERS, AND MANHOLE RIMS SHALL BE SET FLUSH WITH OR NO LESS THAN 0.1' BELOW FINISHED GRADE. ANY RIM OR VALVE COVER ABOVE SURROUNDING FINISHED GRADE WILL NOT BE ACCEPTED.
8. ALL SPOT GRADES ARE AT THE FINISH GRADE AND BOTTOM OF CURB WHERE APPLICABLE.
9. UNLESS OTHERWISE SPECIFIED, RETAINING WALL AND BUILDING PERIMETER DRAINS SHALL BE DIRECTED TO THE NEAREST DRAINAGE STRUCTURE. IF DEEMED APPROPRIATE, CONTRACTOR SHALL PROVIDE ADDITIONAL UNDERDRAINS AT THE DIRECTION OF THE ENGINEER.
10. CONTRACTOR SHALL PROTECT ALL RAINGARDENS AND OTHER STORM MANAGEMENT DEVICES FROM CONSTRUCTION STORMWATER RUNOFF. TEMPORARY SEDIMENT BASINS SHALL BE CONSTRUCTED DURING CONSTRUCTION. STORMWATER SHALL NOT BE DIRECTED TO THE RAINGARDENS UNTIL THE WATERSHED ARE HAS BEEN STABILIZED.

ISSUED FOR: TAC WORKSHOP

ISSUE DATE: JUNE 3, 2019

NO.	DESCRIPTION	BY	DATE
0	TAC WORKSHOP	EDW	06/03/19

DRAWN BY: _____ RLH
 APPROVED BY: _____ EDW
 DRAWING FILE: 4972.DWG

SCALE:
 22" x 34" - 1" = 10'
 11" x 17" - 1" = 20'

OWNER/APPLICANT:
 FRANCIS T. DELBENE
 GWYN M. BURDELL
 32 UNION STREET
 PORTSMOUTH, N.H.
 ASSESSOR'S PARCEL 145-29


MAILING ADDRESS
 165 GRANT AVENUE
 PORTSMOUTH, N.H. 03801

PROJECT:
PROPOSED SITE DEVELOPMENT PLANS
 32 UNION STREET
 PORTSMOUTH, N.H.
 ASSESSOR'S PARCEL 145-29

TITLE:
GRADING PLAN

SHEET NUMBER:
C-3


P4972

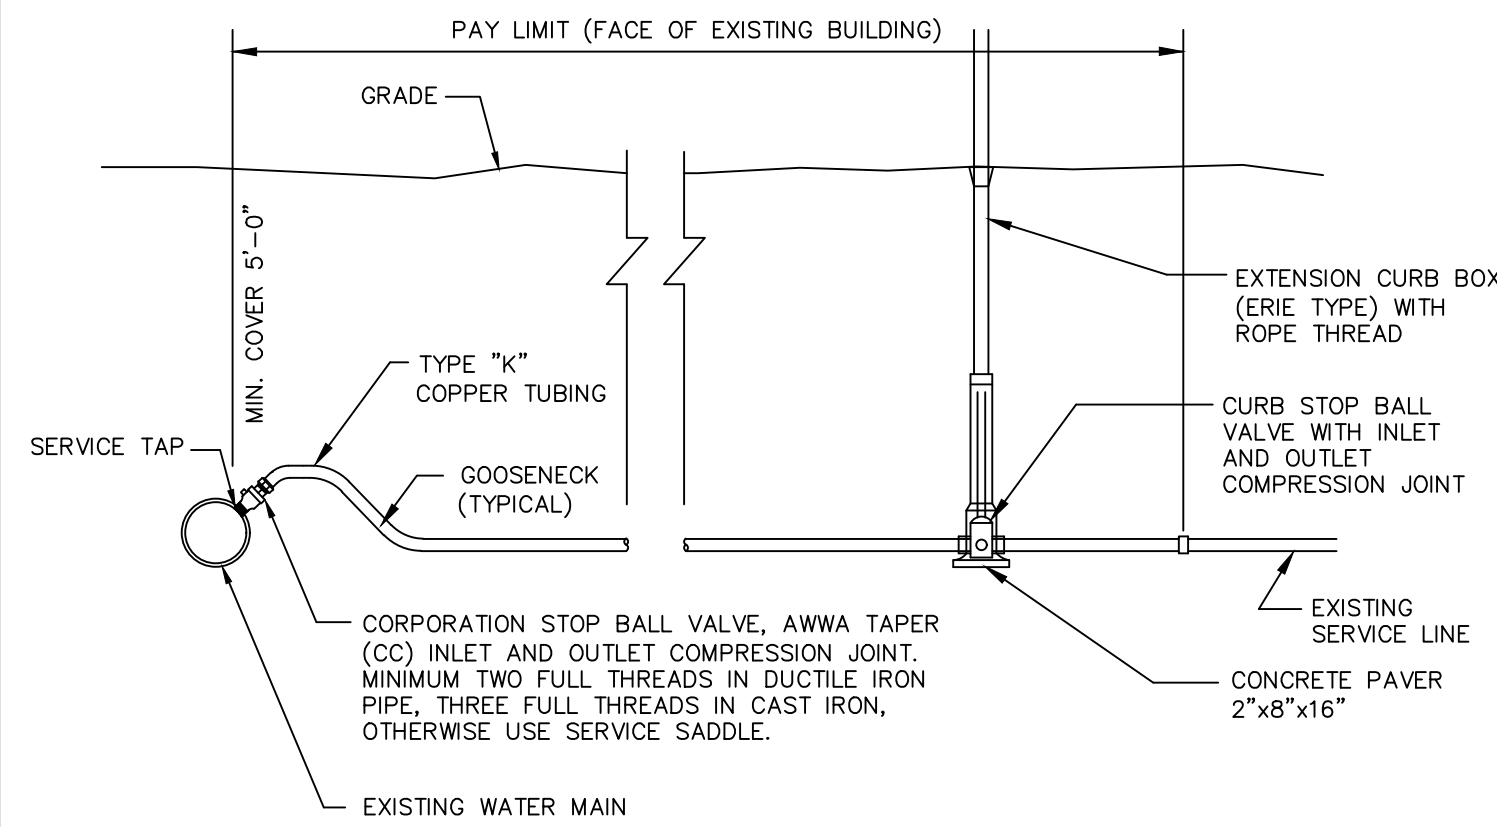


NOTES

1. PROVIDE NEW LINE USING CONTINUOUS LENGTHS OF COPPER. NO COUPLING ALLOWED IN ROADWAY WITHOUT APPROVAL OF ENGINEER.
2. TAPS TO BE MADE AT APPROXIMATELY 2:00 & 10:00
3. PROVIDE FOR SERVICE LINE CONTRACTION AND EXPANSION BY INSTALLING "S" IN SERVICE LINE NEAR MAIN.
4. IF SERVICE IS INSTALLED WITH LESS THAN 5' COVER, INSULATE OVER LINE.
5. REMOVE EXISTING CURB STOP.
6. CONNECT CURB STOP TO EXISTING SERVICE LINE AT PROPERTY LINE OR AT LOCATION APPROVED BY THE ENGINEER (NO COUPLING WITHOUT APPROVAL OF ENGINEER) AFTER PRESSURE TESTING AND DISINFECTION.
7. SHUT OFF EXISTING CORPORATION AND REMOVE OR ABANDON EXISTING SERVICE LINE.
8. CURB BOX SHALL BE SET IN THE GRASS/LANDSCAPE AREA BETWEEN CURB AND SIDEWALK UNLESS DIRECTED OTHERWISE.
9. 2" OR LARGER SERVICE CONNECTIONS SHALL USE A STAINLESS STEEL SERVICE SADDLE.


SERVICE CONNECTION DETAIL NOT TO SCALE

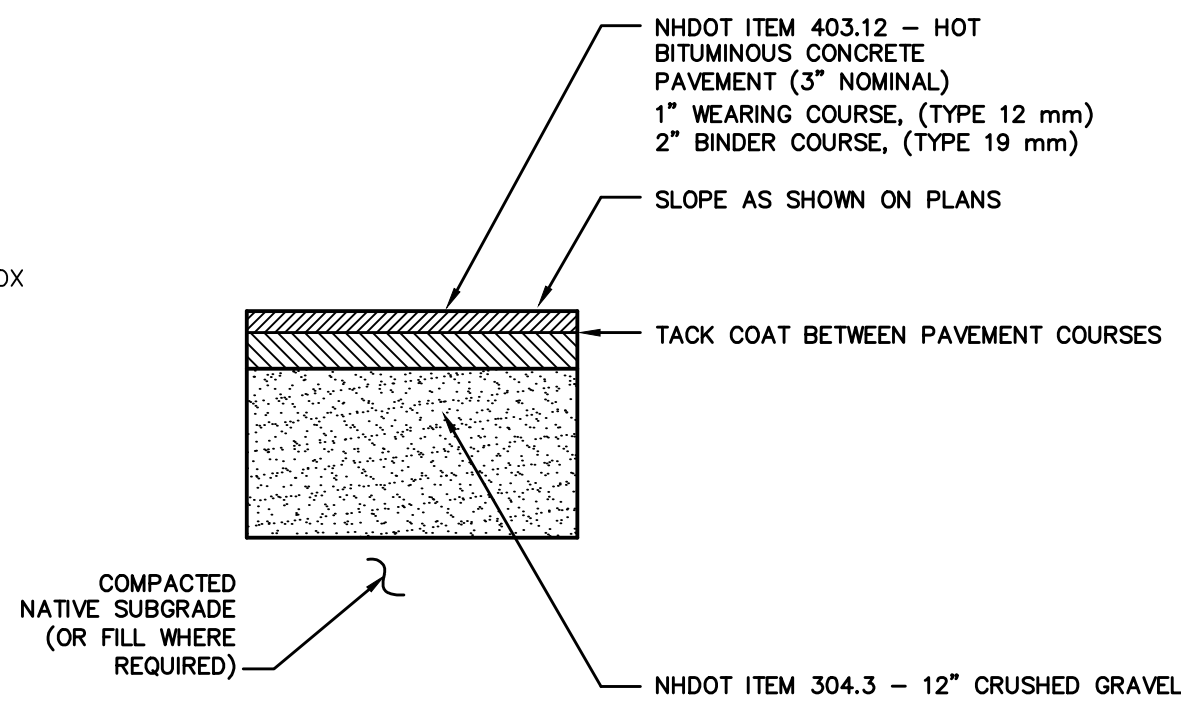

PAVEMENT CROSS SECTION NOT TO SCALE

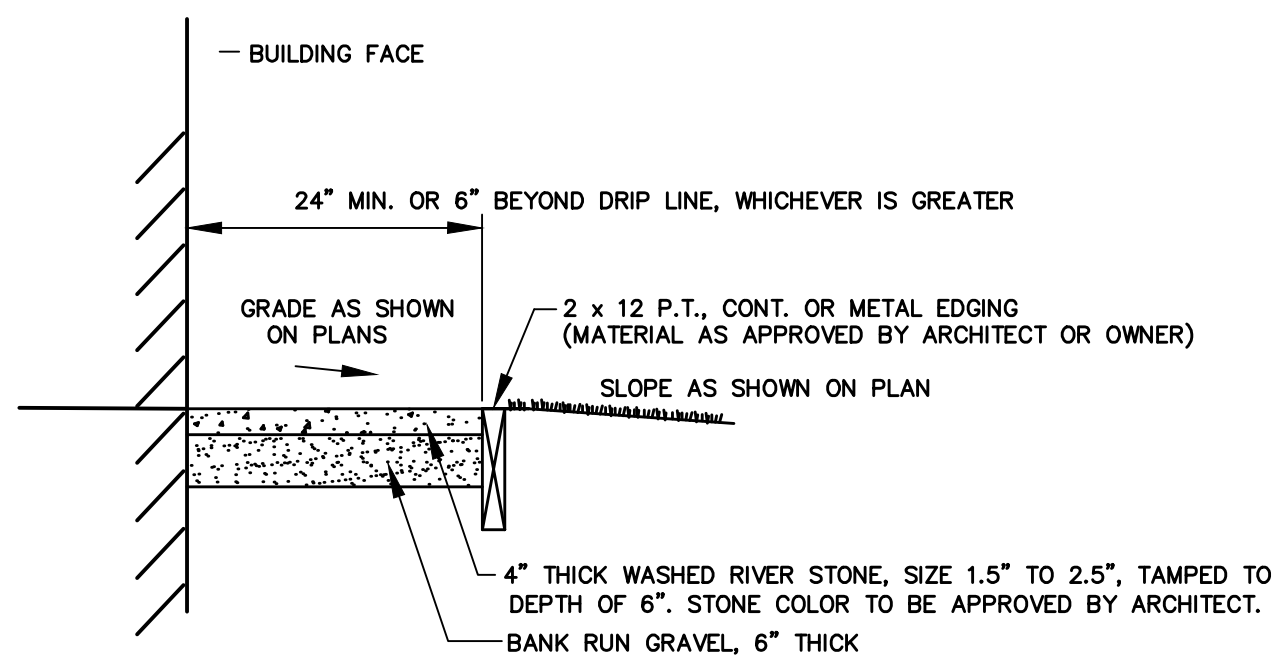


DRIP EDGE DETAIL NOT TO SCALE

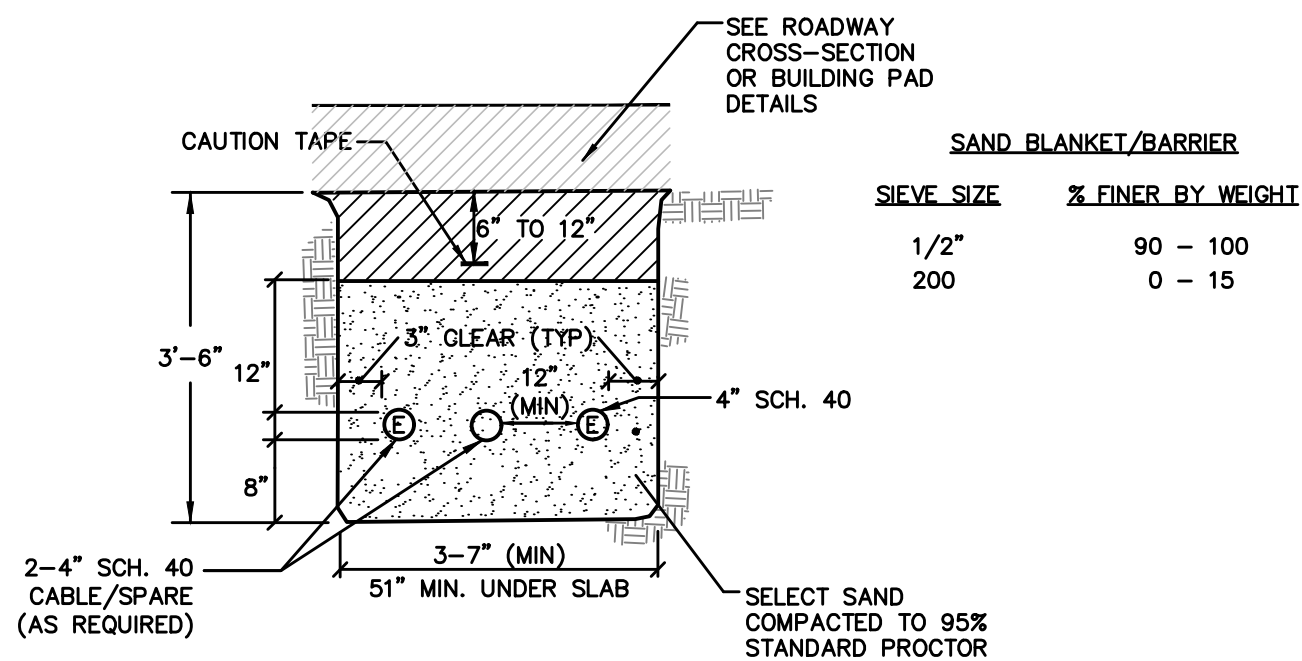

NOTES

1. ALL CONDUIT IS TO BE SCHEDULE 40 PVC, ELECTRICAL GRADE, GRAY IN COLOR AND INSTALLED PER THE MANUFACTURER'S RECOMMENDATIONS. A 10-FOOT HORIZONTAL SECTION OF RIGID GALVANIZED STEEL CONDUIT WILL BE REQUIRED AT EACH SWEEP, UNLESS IN THE OPINION OF THE SERVICE PROVIDER DESIGNER, THE SWEEP-PVC JOINT IS NOT SUBJECT TO FAILURE DURING PULLING OF THE CABLE. ALL JOINTS ARE TO BE WATERTIGHT.
2. ALL 90 DEGREE SWEEPS WILL BE MADE WITH RIGID GALVANIZED STEEL WITH A MINIMUM RADIUS OF 36 INCHES FOR PRIMARY CABLES AND 24 INCHES FOR SECONDARY CABLES.
3. BACKFILL MAY BE MADE WITH EXCAVATED MATERIAL OR COMPARABLE, UNLESS MATERIAL IS DEEMED UNSUITABLE BY SERVICE PROVIDER. BACKFILL SHALL BE FREE OF FROZEN LUMPS, ROCKS, DEBRIS, AND RUBBISH. ORGANIC MATERIAL SHALL NOT BE USED AS BACKFILL. BACKFILL SHALL BE IN 6-INCH LAYERS AND THOROUGHLY COMPACTED.
4. A SUITABLE PULLING STRING, CAPABLE OF 300 POUNDS OF PULL, MUST BE INSTALLED IN THE CONDUIT BEFORE SERVICE PROVIDER IS NOTIFIED TO INSTALL CABLE. THE STRING SHOULD BE BLOWN INTO THE CONDUIT AFTER THE RUN IS ASSEMBLED TO AVOID BONDING THE STRING TO THE CONDUIT. A MINIMUM OF TWENTY-FOUR (24") INCHES OF ROPE SLACK SHALL REMAIN AT THE END OF EACH DUCT. PULL ROPE SHALL BE INSTALLED IN ALL CONDUIT FOR FUTURE PULLS. PULL ROPE SHALL BE NYLON ROPE HAVING A MINIMUM TENSILE STRENGTH OF THREE HUNDRED (300#) LBS.
5. SERVICE PROVIDER SHALL BE GIVEN THE OPPORTUNITY TO INSPECT ALL CONDUIT PRIOR TO BACKFILL. THE CONTRACTOR IS RESPONSIBLE FOR ALL REPAIRS SHOULD SERVICE PROVIDER BE UNABLE TO INSTALL ITS CABLE IN A SUITABLE MANNER.
6. TYPICAL CONDUIT SIZES ARE 3-INCH FOR SINGLE PHASE PRIMARY AND SECONDARY VOLTAGE CABLES, 4-INCH FOR THREE PHASE SECONDARY, AND 5-INCH FOR THREE PHASE PRIMARY. HOWEVER, SERVICE PROVIDERS MAY REQUIRE DIFFERENT NUMBERS, TYPES AND SIZES OF CONDUIT THAN THOSE SHOWN HERE. THE CONTRACTOR SHALL BE RESPONSIBLE FOR VERIFYING ALL CONDUIT SIZES, TYPES AND NUMBERS WITH EACH SERVICE PROVIDER PRIOR TO ORDERING THEM.
7. ROUTING OF CONDUIT, LOCATION OF MANHOLES, TRANSFORMERS, CABINETS, HANDHOLES, ETC., SHALL BE DETERMINED BY SERVICE PROVIDER DESIGN PERSONNEL. THE CONTRACTOR SHALL COORDINATE WITH ALL SERVICE PROVIDERS PRIOR TO THE INSTALLATION OF ANY CONDUIT.
8. ALL CONDUIT INSTALLATIONS MUST CONFORM TO THE CURRENT EDITION OF THE NATIONAL ELECTRIC SAFETY CODE, STATE AND LOCAL CODES AND ORDINANCES, AND WHERE APPLICABLE, THE NATIONAL ELECTRIC CODE. WHERE REQUIRED BY UTILITY PROVIDER, CONDUIT SHALL BE SUPPORTED IN PLACE USING PIPE STANCHIONS PLACED EVERY FIVE (5') FEET ALONG THE CONDUIT RUN.
9. UNDER A BUILDING SLAB THE CONDUIT SHALL BE ENCASED IN 8" OF CONCRETE ON ALL SIDES.
10. ALL CONDUIT TERMINATIONS SHALL BE CAPPED TO PREVENT DEBRIS FROM ENTERING CONDUIT.

ELECTRIC / COMMUNICATION TRENCH NOT TO SCALE

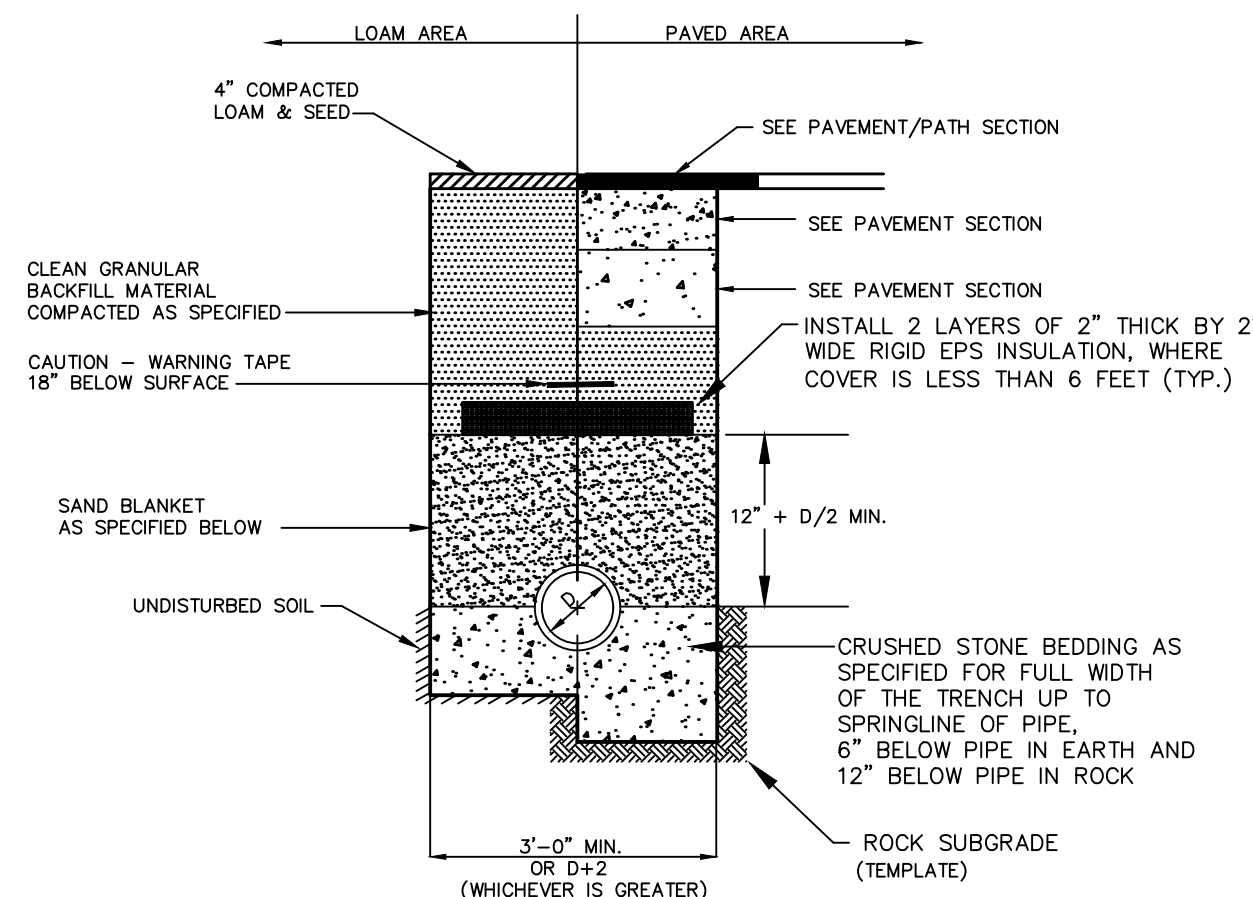


BACKFILL MATERIAL BELOW PAVED OR CONCRETE AREAS, BEDDING MATERIAL, AND SAND BLANKET SHALL BE COMPACTED TO NOT LESS THAN 95% OF AASHTO T 99, METHOD C. SUITABLE BACKFILL MATERIAL BELOW LOAM AREAS SHALL BE COMPACTED TO NOT LESS THAN 90% OF AASHTO T 99, METHOD C.

SAND BLANKET		CRUSHED STONE BEDDING *	
SIEVE SIZE	% FINER BY WEIGHT	SIEVE SIZE	% PASSING BY WEIGHT
1/2"	90 - 100	1"	100
200	0 - 15	3/4"	90 - 100
		3/8"	20 - 55
		# 4	0 - 10
		# 8	0 - 5

* EQUIVALENT TO STANDARD STONE SIZE #67 - SECTION 703 OF NHDOT STANDARD SPECIFICATIONS

SEWER TRENCH SECTION NOT TO SCALE

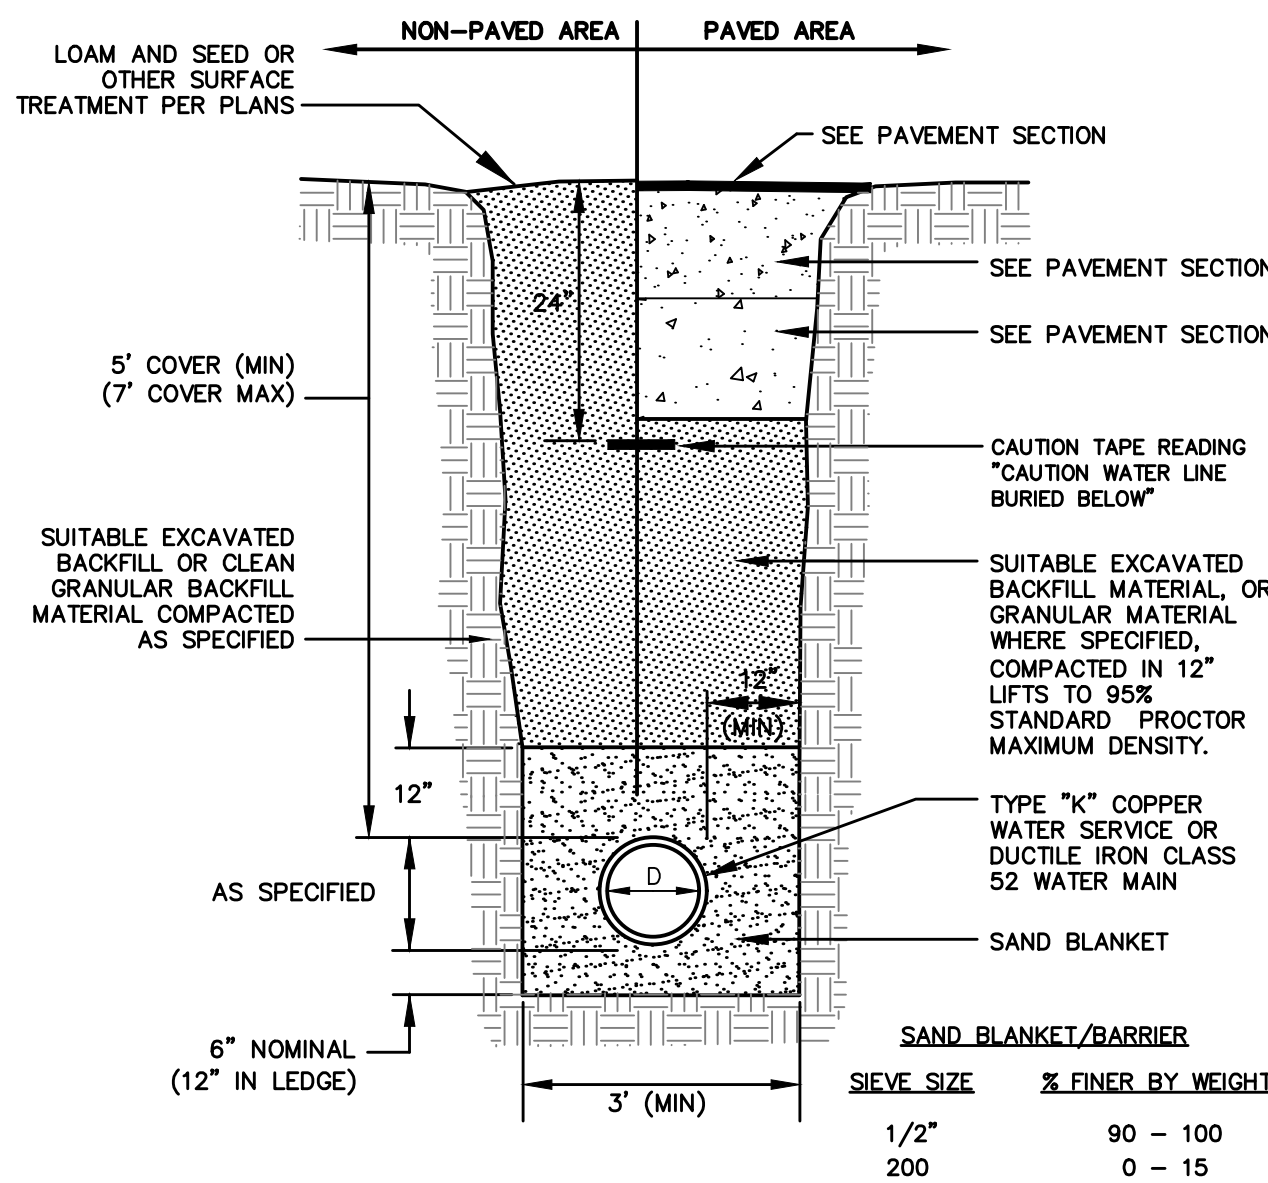

NOTES

1. BACKFILL MATERIAL BELOW PAVED OR CONCRETE AREAS, BEDDING MATERIAL, AND SAND BLANKET SHALL BE COMPACTED TO NOT LESS THAN 95% OF AASHTO T 99, METHOD C. SUITABLE BACKFILL MATERIAL BELOW LOAM AREAS SHALL BE COMPACTED TO NOT LESS THAN 90% OF AASHTO T 99, METHOD C.
2. WATER MAINS SHALL BE POLY WRAPPED.
3. WATER MAINS SHALL HAVE 3 WEDGES PER JOINT.

WATER MAIN TRENCH NOT TO SCALE

STANDARD TRENCH NOTES:


1. ORDERED EXCAVATION OF UNSUITABLE MATERIAL BELOW GRADE: BACKFILL AS STATED IN THE TECHNICAL SPECIFICATIONS OR AS SHOWN OF THE DRAWING.
2. BEDDING: SCREENED GRAVEL AND/OR CRUSHED STONE FREE FROM CLAY, LOAM, ORGANIC MATTER AND MEETING ASTM C33, STONE SIZE NO. 67.

100%	PASSING 1" INCH SCREEN
90 - 100%	PASSING 3/4" INCH SCREEN
20 - 55%	PASSING 3/8" INCH SCREEN
0-10%	PASSING #4 SIEVE
0-5%	PASSING #8 SIEVE

 WHERE ORDERED BY THE ENGINEER TO STABILIZE THE BASE, SCREENED GRAVEL OR CRUSHED STONE 1-1/2" INCH TO 1/2" INCH SHALL BE USED.
3. SAND BLANKET: CLEAN SAND FREE FROM ORGANIC MATTER, SO GRADED THAT 90 - 100% PASSES 1/2" INCH SIEVE AND NOT MORE THAN 15% WILL PASS A #200 SIEVE. BLANKET MAY BE OMITTED FOR CAST-IRON, DUCTILE IRON, AND REINFORCED CONCRETE PIPE PROVIDED HOWEVER, THAT NO STONE LARGER THAN 2" IS IN CONTACT WITH THE PIPE.
4. SUITABLE MATERIAL: IN ROADS, ROAD SHOULDERS, WALKWAYS AND TRAVELED WAYS, SUITABLE MATERIAL FOR TRENCH BACKFILL SHALL BE THE NATURAL MATERIAL EXCAVATED DURING THE COURSE OF CONSTRUCTION, BUT SHALL EXCLUDE DEBRIS; PIECES OF PAVEMENT; ORGANIC MATTER; TOP SOIL; ALL WET OR SOFT MUCK, PEAT, OR CLAY; ALL EXCAVATED LEDGE MATERIAL; ALL ROCKS OVER 6 INCHES IN LARGEST DIMENSION; AND ANY MATERIAL WHICH, AS DETERMINED BY THE ENGINEER, WILL NOT PROVIDE SUFFICIENT SUPPORT OR MAINTAIN THE COMPLETED CONSTRUCTION IN A STABLE CONDITION.
5. BASE COURSE AND PAVEMENT SHALL MEET THE REQUIREMENTS OF THE NEW HAMPSHIRE DEPARTMENT OF TRANSPORTATION'S LATEST EDITION OF THE STANDARD SPECIFICATIONS FOR HIGHWAYS AND BRIDGES - DIVISIONS 300 AND 400 RESPECTIVELY.
6. SHEETING, IF REQUIRED: WHERE SHEETING IS PLACED ALONGSIDE THE PIPE AND EXTENDS BELOW MID-DIAMETER, IT SHALL BE CUT OFF AND LEFT IN PLACE TO AN ELEVATION 1 FOOT ABOVE THE TOP OF PIPE. WHERE SHEETING IS ORDERED BY THE ENGINEER TO BE LEFT IN PLACE, IT SHALL BE CUT OFF AT LEAST 3 FEET BELOW FINISHED GRADE, BUT NOT LESS THAN 1 FOOT ABOVE THE TOP OF THE PIPE.
7. W = MAXIMUM ALLOWABLE TRENCH WIDTH TO A PLANE 12 INCHES ABOVE THE PIPE. FOR PIPES 15 INCHES NOMINAL DIAMETER OR LESS, W SHALL BE NO MORE THAN 36 INCHES. FOR PIPES GREATER THAN 15 INCHES IN NOMINAL DIAMETER, W SHALL BE 24 INCHES PLUS PIPE OUTSIDE DIAMETER (O.D.) ALSO, W SHALL BE THE PAYMENT WIDTH FOR LEDGE EXCAVATION AND FOR ORDERED EXCAVATION BELOW GRADE.
8. FOR CROSS COUNTRY CONSTRUCTION, BACKFILL OR FILL SHALL BE MOUND TO A HEIGHT OF 6 INCHES ABOVE THE ORIGINAL GROUND SURFACE.
9. CONCRETE FOR ENCASEMENT SHALL CONFORM TO THE NEW HAMPSHIRE DEPARTMENT OF PUBLIC WORKS AND HIGHWAYS STANDARD SPECIFICATION REQUIREMENTS FOR CLASS A (3000#) CONCRETE AS FOLLOWS:

CEMENT:	6.0 BAGS PER CUBIC YARD
WATER:	5.75 GALLONS PER BAG CEMENT
MAXIMUM SIZE OF AGGREGATE:	1 INCH

 CONCRETE ENCASEMENT IS NOT ALLOWED FOR PVC PIPE.
10. CONCRETE FULL ENCASEMENT: IF FULL ENCASEMENT IS UTILIZED, DEPTH OF CONCRETE BELOW PIPE SHALL BE 1/4 I.D. (4" MINIMUM). BLOCK SUPPORT SHALL BE SOLID CONCRETE BLOCKS.
11. NEW HAMPSHIRE DEPARTMENT OF ENVIRONMENTAL SERVICES DESIGN STANDARDS REQUIRE TEN FEET (10') SEPARATION BETWEEN WATER AND SEWER. REFER TO CITY'S STANDARD SPECIFICATIONS FOR METHODS OF PROTECTION IN AREAS THAT CANNOT MEET THESE REQUIREMENTS.

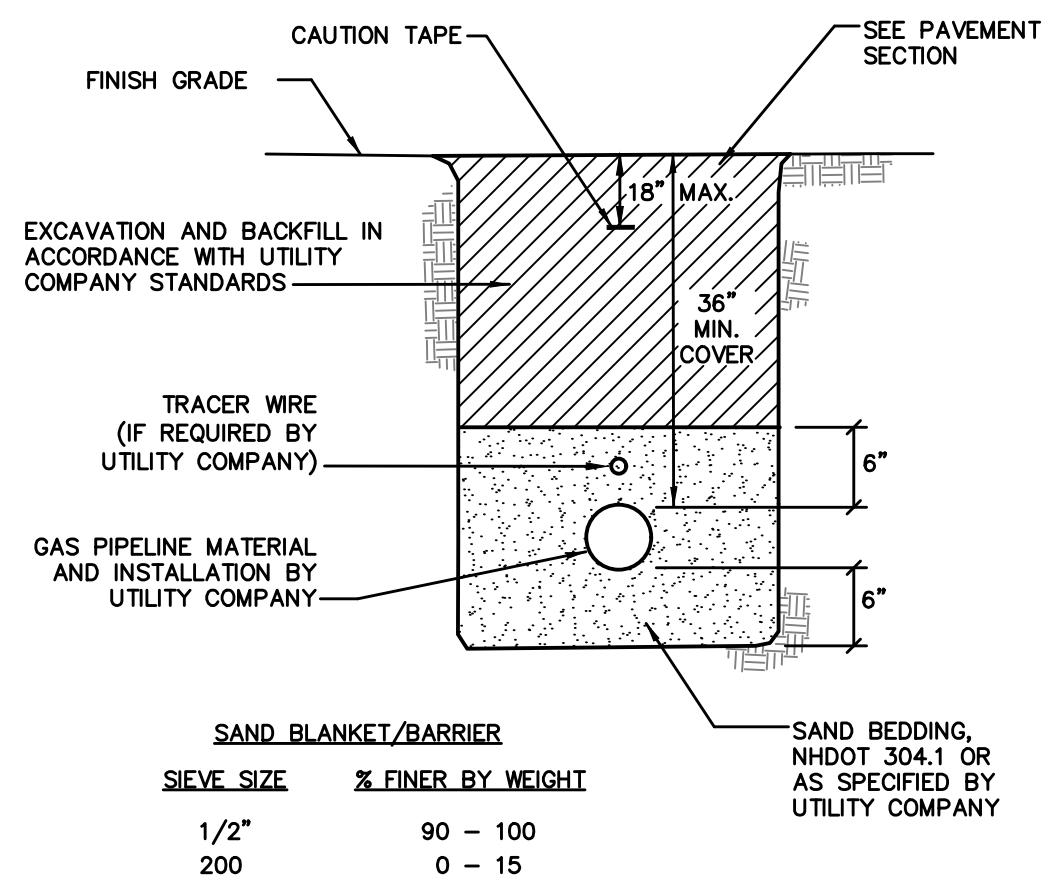


NOTES

1. CONTRACTOR TO COORDINATE WITH UTILITY COMPANY AND PROVIDE ALL EXCAVATION, COMPACTED AND BACKFILL FOR PIPE INSTALLATION WITHIN THE PROJECT SITE.
2. BACKFILL MATERIAL BELOW PAVED OR CONCRETE AREAS, BEDDING MATERIAL, AND SAND BLANKET SHALL BE COMPACTED TO NOT LESS THAN 95% OF AASHTO T 99, METHOD C. SUITABLE BACKFILL MATERIAL BELOW LOAM AREAS SHALL BE COMPACTED TO NOT LESS THAN 90% OF AASHTO T 99, METHOD C.

GAS TRENCH NOT TO SCALE

ENGINEER:

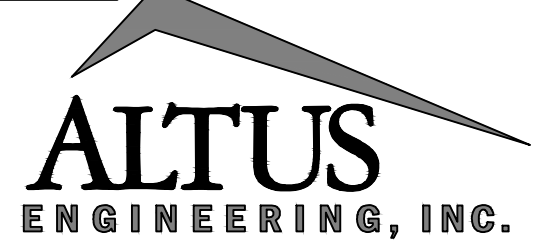

133 COURT STREET PORTSMOUTH, NH 03801
(603) 433-2335 www.ALTUS-ENG.com

ISSUED FOR:

TAC WORKSHOP

ISSUE DATE:

JUNE 3, 2019

REVISIONS

NO.	DESCRIPTION	BY	DATE
0	TAC WORKSHOP	EDW	06/03/19

DRAWN BY:

RLH

APPROVED BY:

EDW

DRAWING FILE:

4972.DWG

SCALE:

22" x 34" - NOT TO SCALE

11" x 17" - NOT TO SCALE

OWNER/APPLICANT:

FRANCIS T. DELBENE
GWYN M. BURDELL
32 UNION STREET
PORTSMOUTH, N.H.
ASSESSOR'S PARCEL 145-29

MAILING ADDRESS

165 GRANT AVENUE
PORTSMOUTH, N.H. 03801

PROJECT:

PROPOSED SITE
DEVELOPMENT
PLANS
32 UNION STREET
PORTSMOUTH, N.H.

ASSESSOR'S PARCEL
145-29

TITLE:

DETAIL SHEET

SHEET NUMBER:

C-4