

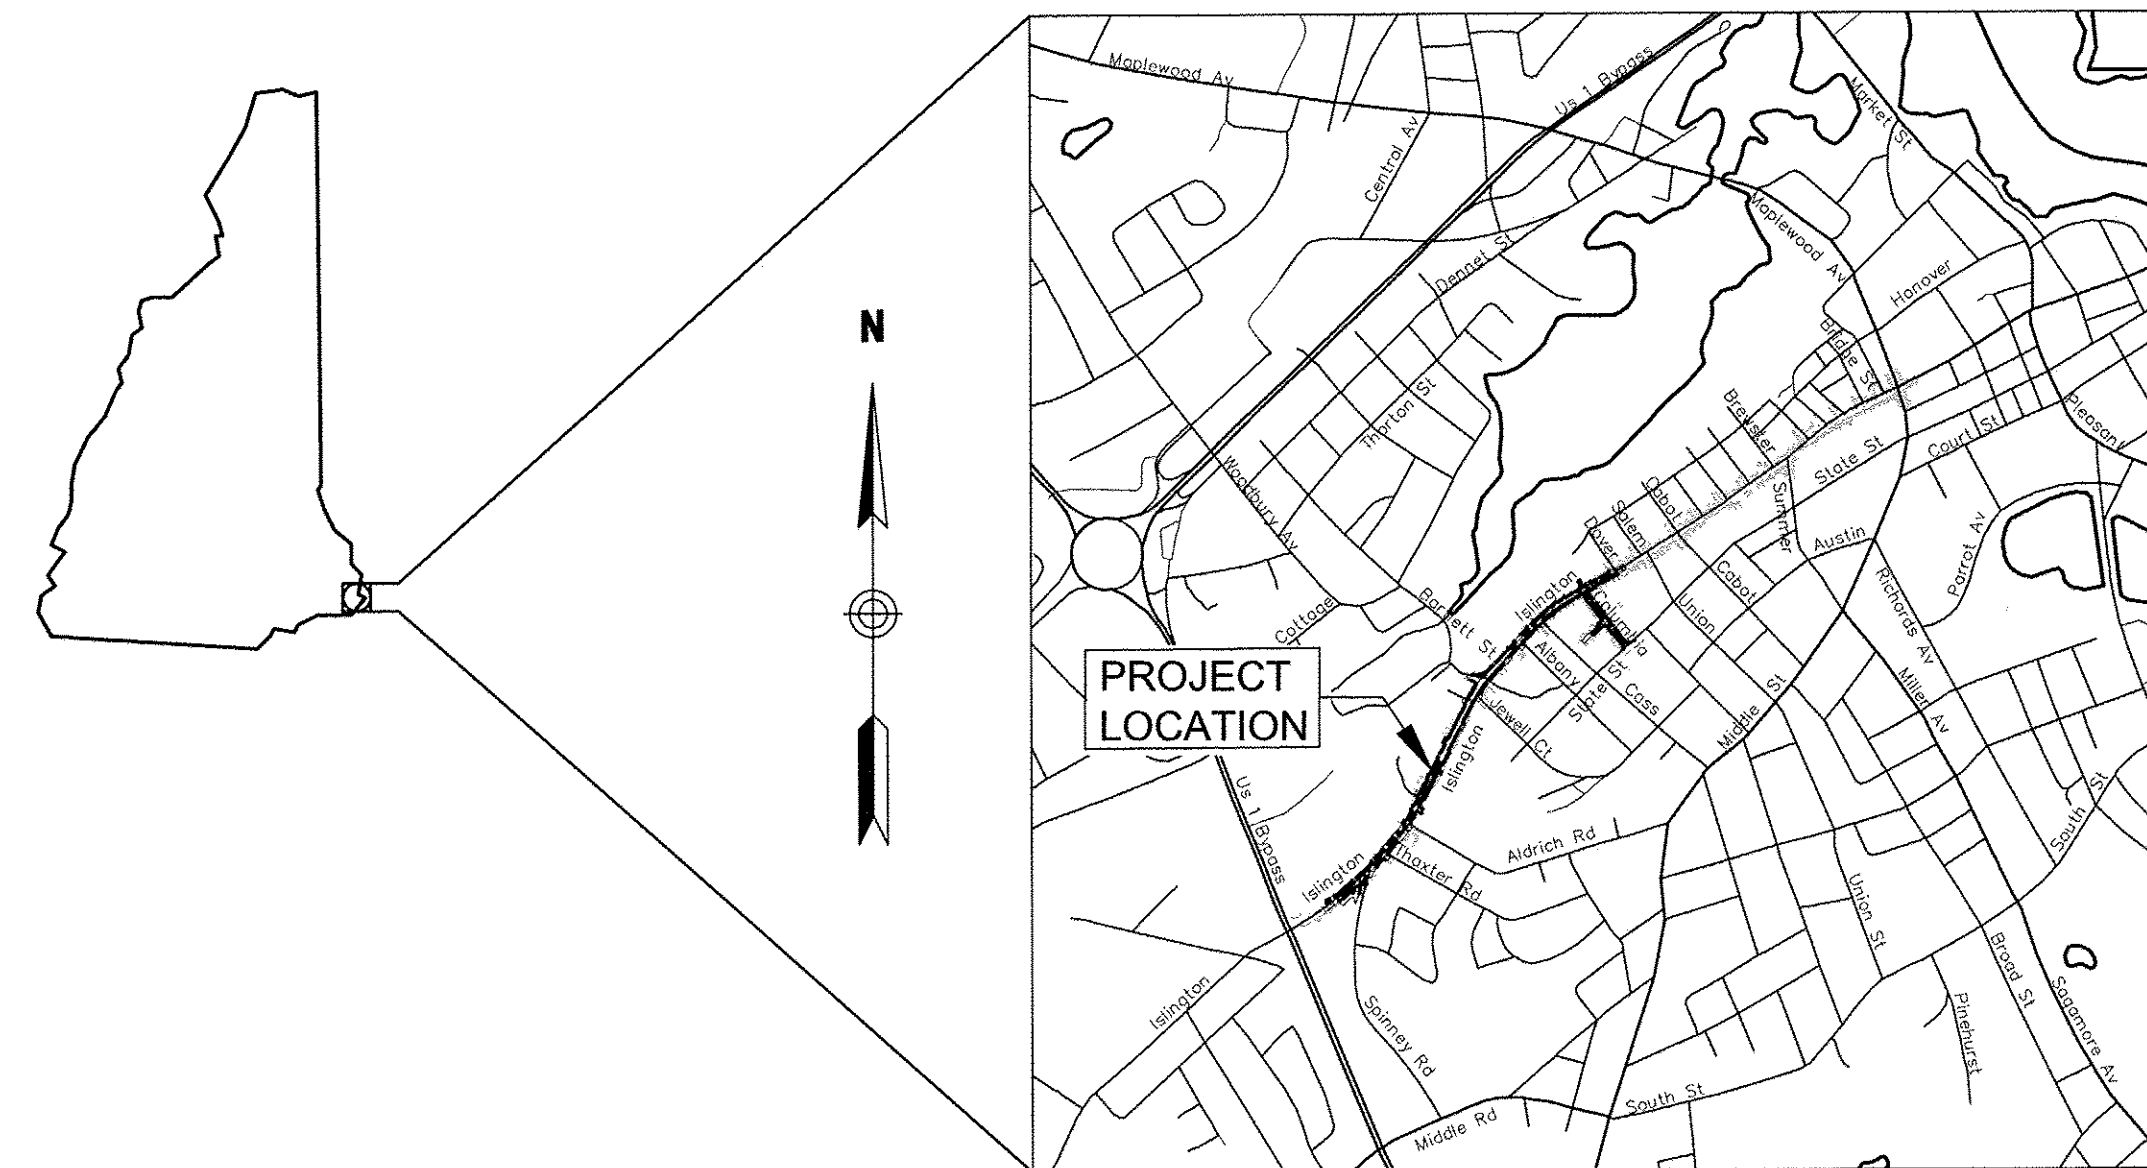


CITY OF PORTSMOUTH, NEW HAMPSHIRE
 DEPARTMENT OF PUBLIC WORKS
 PLANS OF PROPOSED
**ISLINGTON STREET
 CORRIDOR IMPROVEMENTS
 SEGMENT 1**

INDEX OF SHEETS	
SHEET NO.	DESCRIPTION
01	COVER SHEET
02	LEGEND & GENERAL NOTES
03	TYPICAL SECTIONS
05-13	DETAILS
14-20	GENERAL PLANS
21-27	PROFILES
28-35	GRADING & LAYOUT PLANS
36-37	TRAFFIC SIGNAL PLANS
38-45	PAVEMENT MARKING & SIGNING PLANS
46-52	LANDSCAPING & LIGHTING PLANS
53-73	CROSS SECTIONS
U-1 TO U-3	UTILITY INDEX & NOTES
U-4 TO U-9B	UTILITY PLANS & PROFILE
U-14 TO U-15	UTILITY DETAILS

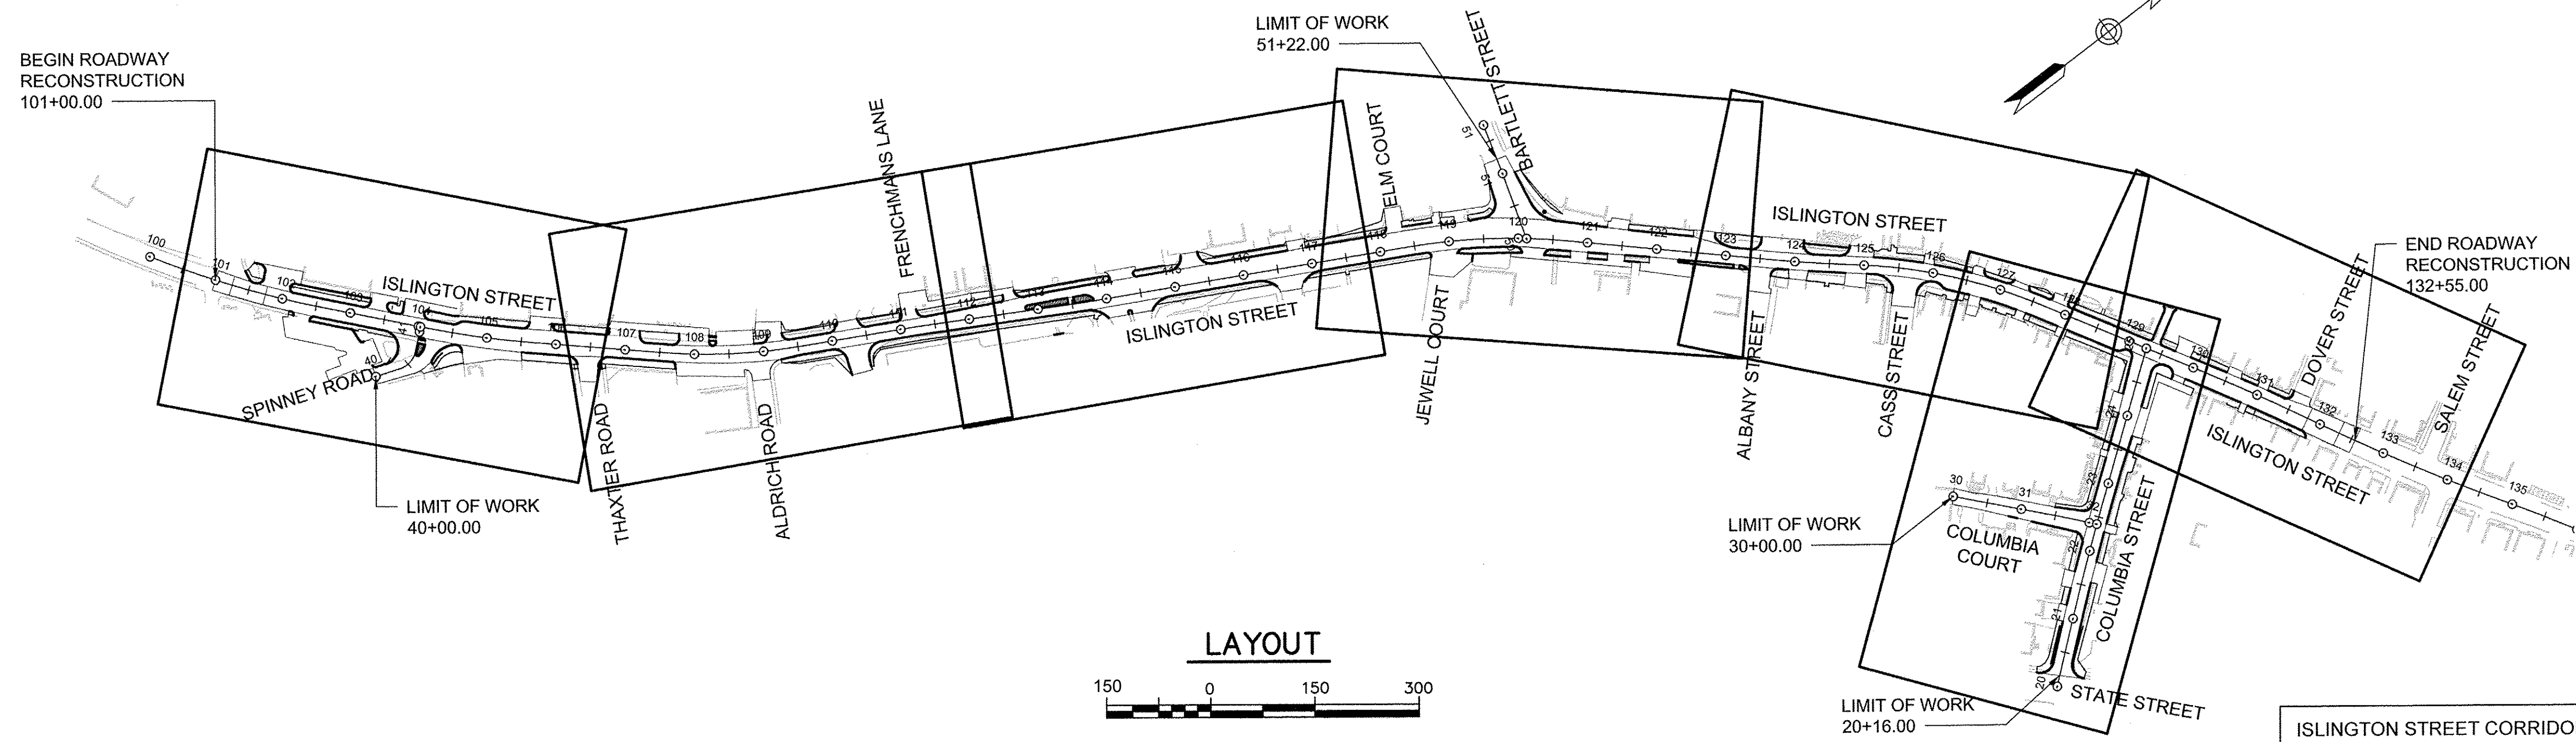

LOCATION MAP

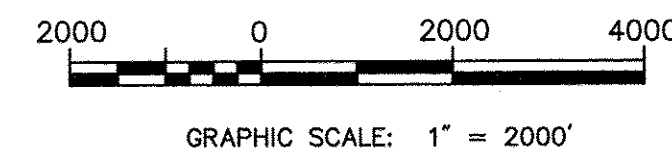


LAYOUT



REVISIONS AFTER PROPOSAL	STATION	DATE	NUMBER	DESCRIPTION

SDR PROCESSED	DATE	DATE	DATE	DATE
VHB	OCT 2017	11/13/18	11/13/18	
NEW DESIGN	KMH			
SHEET CHECKED	GLB			
AS BUILT DETAILS				

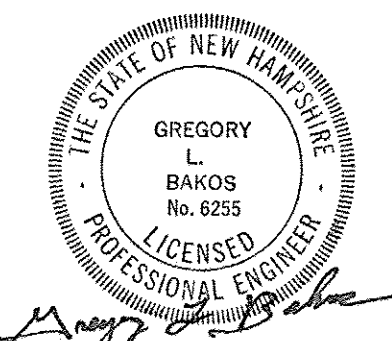

VHB SHEETS 1-73

ALL DRAINAGE, SEWER, AND WATER CONSTRUCTION SHALL BE PER SHEETS U-1 THROUGH U-15 BY UNDERWOOD ENGINEERS

ISLINGTON STREET CORRIDOR IMPROVEMENTS - SEGMENT 1				
CITY OF PORTSMOUTH, NEW HAMPSHIRE				
COVER SHEET				
DATE PLOTTED	VHB PROJECT NO.	DRAWING	CITY PROJECT NO.	SHEET NO.
13-Nov-18	52393.00	COV-Seg1	7176	01
			TOTAL SHEETS	88



LEGEND

ABBREVIATIONS

NOTES:

EXIST.	PROP.	EXIST.	PROP.

GENERAL

ABAN	ABANDON
ACR	ACCESSIBLE CURB RAMP
AD	ALGEBRAIC DIFFERENCE IN GRADE
ADJ	ADJUST
APPROX	APPROXIMATE
BIT	BITUMINOUS
BOW	BACK OF WALK
CONC	CONCRETE
DYL	DOUBLE YELLOW LINE
EL	ELEVATION
ELEV	ELEVATION
EXIST	EXISTING
FEE	FINISHED FLOOR ELEVATION
GRAN	GRANITE
GTD	GRADE TO DRAIN
HP	HIGH POINT
K	RATE OF VERTICAL CURVATURE
L	LEFT
LSA	LANDSCAPE AREA
LOD	LIMIT OF DISTURBANCE
LP	LOW POINT
MAX	MAXIMUM
MIN	MINIMUM
NO	NUMBER
NTS	NOT TO SCALE
OC	ON CENTER
PC	POINT OF CURVATURE
PCC	POINT OF COMPOUND CURVATURE
PERF	PERFORATED
PGL	PROPOSED GRADE LINE
PI	POINT OF INTERSECTION
PL	PROPERTY LINE
PRC	POINT OF REVERSE CURVATURE
PROP	PROPOSED
PT	POINT OF TANGENCY
PVC	POINT OF VERTICAL CURVATURE
PVI	POINT OF VERTICAL INTERSECTION
PVT	POINT OF VERTICAL TANGENCY
R	REMOVE/RIGHT
RET	RETAIN
R&D	REMOVE AND DISPOSE
ROW	RIGHT OF WAY
R&R	REMOVE AND RESET
SL	STOP LINE
SSD	STOPPING SIGHT DISTANCE
STA	STATION
SWL	SINGLE WHITE LINE
T	THERMOPLASTIC/TON
TS	TOP OF SLOPE
TW	TRAVEL WAY
TYP	TYPICAL
VAR	VARIES
VC	VERTICAL CURVE
XW	CROSSWALK

UTILITY

CB	CATCH BASIN
CMP	CORRUGATED METAL PIPE
CO	CLEANOUT
DCB	DOUBLE CATCH BASIN
DI	DROP INLET
DMH	DRAIN MANHOLE
CIP	CAST IRON PIPE
COND	CONDUIT
DIP	DUCTILE IRON PIPE
FES	FLARED END SECTION
FM	FORCE MAIN
F&G	FRAME AND GRATE
F&C	FRAME AND COVER
GI	GUTTER INLET
GT	GREASE TRAP
HDPE	HIGH DENSITY POLYETHYLENE PIPE
HH	HANDHOLE
HW	HEADWALL
HYD	HYDRANT
INV	INVERT ELEVATION
I=	INVERT ELEVATION
LP	LIGHT POLE
MES	METAL END SECTION
PWW	PAVED WATER WAY
PVC	POLYVINYLCHLORIDE PIPE
RPC	REINFORCED CONCRETE PIPE
R=	RIM ELEVATION
SMH	SEWER MANHOLE
TSV	TAPPING SLEEVE, VALVE AND BOX
UG	UNDERGROUND
UP	UTILITY POLE

SIGNING

	LEAVE
	REMOVE

CROSS SECTIONS

EXIST XXX.X	
PROP XXX.XX	

GENERAL

- CONTRACTOR SHALL NOTIFY "DIG-SAFE" (1-888-344-7233) AT LEAST 72 HOURS BEFORE EXCAVATING.
- CONTRACTOR SHALL BE RESPONSIBLE FOR SITE SECURITY AND JOB SAFETY. CONSTRUCTION ACTIVITIES SHALL BE IN ACCORDANCE WITH OSHA STANDARDS AND LOCAL REQUIREMENTS.
- ACCESSIBLE ROUTES, PARKING SPACES, RAMPS, SIDEWALKS AND WALKWAYS SHALL BE CONSTRUCTED IN CONFORMANCE WITH THE FEDERAL AMERICANS WITH DISABILITIES ACT AND WITH STATE AND LOCAL LAWS AND REGULATIONS (WHICHEVER ARE MORE STRINGENT).
- AREAS DISTURBED DURING CONSTRUCTION AND NOT RESTORED WITH IMPERVIOUS SURFACES (BUILDINGS, PAVEMENTS, WALKS, ETC.) SHALL RECEIVE 6 INCHES LOAM AND SEED.
- THE WORK UNDER THIS PROJECT SHALL BE CONSTRUCTED IN ACCORDANCE TO THE FOLLOWING STANDARDS, LISTED IN ORDER OF PRECEDENCE:
 - THE CITY OF PORTSMOUTH DESIGN STANDARDS
 - THE 2016 NEW HAMPSHIRE DEPARTMENT OF TRANSPORTATION STANDARD SPECIFICATIONS FOR ROAD AND BRIDGE CONSTRUCTION.
- UPON AWARD OF CONTRACT, CONTRACTOR SHALL MAKE NECESSARY CONSTRUCTION NOTIFICATIONS AND APPLY FOR AND OBTAIN NECESSARY PERMITS, PAY FEES, AND POST BONDS ASSOCIATED WITH THE WORK INDICATED ON THE DRAWINGS, IN THE SPECIFICATIONS, AND IN THE CONTRACT DOCUMENTS. DO NOT CLOSE OR OBSTRUCT ROADWAYS, SIDEWALKS, AND FIRE HYDRANTS, WITHOUT APPROPRIATE PERMITS.
- TRAFFIC SIGNAGE AND PAVEMENT MARKINGS SHALL CONFORM TO THE MANUAL OF UNIFORM TRAFFIC CONTROL DEVICES, AND THE NHDOT STANDARD PLANS FOR ROAD CONSTRUCTION (2010) NHDOT STANDARD SPECIFICATIONS FOR ROAD AND BRIDGE CONSTRUCTION (2016).
- AREAS OUTSIDE THE LIMITS OF PROPOSED WORK DISTURBED BY THE CONTRACTOR'S OPERATIONS SHALL BE RESTORED BY THE CONTRACTOR TO THEIR ORIGINAL CONDITION AT THE CONTRACTOR'S EXPENSE.
- IN THE EVENT THAT SUSPECTED CONTAMINATED SOIL, GROUNDWATER, AND OTHER MEDIA ARE ENCOUNTERED DURING EXCAVATION AND CONSTRUCTION ACTIVITIES BASED ON VISUAL, OLFACTORY, OR OTHER EVIDENCE, THE CONTRACTOR SHALL STOP WORK IN THE VICINITY OF THE SUSPECT MATERIAL TO AVOID FURTHER SPREADING OF THE MATERIAL. CONTRACTOR SHALL NOTIFY THE OWNER IMMEDIATELY SO THAT THE APPROPRIATE TESTING AND SUBSEQUENT ACTION CAN BE TAKEN.
- CONTRACTOR SHALL PREVENT DUST, SEDIMENT, AND DEBRIS FROM EXITING THE SITE AND SHALL BE RESPONSIBLE FOR CLEANUP, REPAIRS AND CORRECTIVE ACTION IF SUCH OCCURS.
- DAMAGE RESULTING FROM CONSTRUCTION LOADS SHALL BE REPAIRED BY THE CONTRACTOR AT NO ADDITIONAL COST TO OWNER.
- CONTRACTOR SHALL CONTROL STORMWATER RUNOFF DURING CONSTRUCTION TO PREVENT ADVERSE IMPACTS TO OFF SITE AREAS, AND SHALL BE RESPONSIBLE TO REPAIR RESULTING DAMAGES, IF ANY, AT NO COST TO OWNER.
- THIS PROJECT DISTURBS MORE THAN ONE ACRE OF LAND AND FALLS WITHIN THE NPDES CONSTRUCTION GENERAL PERMIT (CGP) PROGRAM AND EPA JURISDICTION. PRIOR TO THE START OF CONSTRUCTION CONTRACTOR IS TO FILE A CGP NOTICE OF INTENT WITH THE EPA AND PREPARE A STORMWATER POLLUTION PREVENTION PLAN IN ACCORDANCE WITH THE NPDES REGULATIONS. CONTRACTOR SHALL CONFIRM WASTE MANAGEMENT HAS ALSO FILED A NOTICE OF INTENT WITH THE EPA.

UTILITIES

- THE LOCATIONS, SIZES, AND TYPES OF EXISTING UTILITIES ARE SHOWN AS AN APPROXIMATE REPRESENTATION ONLY. THE OWNER OR ITS REPRESENTATIVE(S) HAVE NOT INDEPENDENTLY VERIFIED THIS INFORMATION AS SHOWN ON THE PLANS. THE UTILITY INFORMATION SHOWN DOES NOT GUARANTEE THE ACTUAL EXISTENCE, SERVICEABILITY, OR OTHER DATA CONCERNING THE UTILITIES; NOR DOES IT GUARANTEE AGAINST THE POSSIBILITY THAT ADDITIONAL UTILITIES MAY BE PRESENT THAT ARE NOT SHOWN ON THE PLANS. PRIOR TO ORDERING MATERIALS AND BEGINNING CONSTRUCTION, THE CONTRACTOR SHALL VERIFY AND DETERMINE THE EXACT LOCATIONS, SIZES, AND ELEVATIONS OF THE POINTS OF CONNECTIONS TO EXISTING UTILITIES AND SHALL CONFIRM THAT THERE ARE NO INTERFERENCES WITH EXISTING UTILITIES AND THE PROPOSED UTILITY ROUTES, INCLUDING ROUTES WITHIN THE PUBLIC RIGHTS OF WAY.
- WHERE AN EXISTING UTILITY IS FOUND TO CONFLICT WITH THE PROPOSED WORK, OR EXISTING CONDITIONS DIFFER FROM THOSE SHOWN SUCH THAT THE WORK CANNOT BE COMPLETED AS INTENDED, THE LOCATION, ELEVATION, AND SIZE OF THE UTILITY SHALL BE ACCURATELY DETERMINED WITHOUT DELAY BY THE CONTRACTOR, AND THE INFORMATION FURNISHED IN WRITING TO THE OWNER'S REPRESENTATIVE FOR THE RESOLUTION OF THE CONFLICT AND CONTRACTOR'S FAILURE TO NOTIFY PRIOR TO PERFORMING ADDITIONAL WORK RELEASES OWNER FROM OBLIGATIONS FOR ADDITIONAL PAYMENTS WHICH OTHERWISE MAY BE WARRANTED TO RESOLVE THE CONFLICT.
- SET CATCH BASIN RIMS, AND INVERTS OF SEWERS, DRAINS, AND DITCHES IN ACCORDANCE WITH ELEVATIONS ON THE PLANS AND CROSS-SECTIONS.

LAYOUT AND MATERIALS

- DIMENSIONS ARE FROM THE FACE OF CURB, FACE OF BUILDING, FACE OF WALL, AND CENTER LINE OF PAVEMENT MARKINGS, UNLESS OTHERWISE NOTED.
- PROPOSED BOUNDS AND ANY EXISTING PROPERTY LINE MONUMENTATION DISTURBED DURING CONSTRUCTION SHALL BE SET OR RESET BY A LICENSED LAND SURVEYOR (LLS).
- PRIOR TO START OF CONSTRUCTION, CONTRACTOR SHALL VERIFY EXISTING PAVEMENT ELEVATIONS AT INTERFACE WITH PROPOSED PAVEMENTS, AND EXISTING GROUND ELEVATIONS ADJACENT TO DRAINAGE OUTLETS TO ASSURE PROPER TRANSITIONS BETWEEN EXISTING AND PROPOSED FACILITIES.
- SYMBOLS AND LEGENDS OF PROJECT FEATURES ARE GRAPHIC REPRESENTATIONS AND ARE NOT NECESSARILY SCALED TO THEIR ACTUAL DIMENSIONS OR LOCATIONS ON THE DRAWINGS. THE CONTRACTOR SHALL REFER TO THE DETAIL SHEET DIMENSIONS, MANUFACTURERS' LITERATURE, SHOP DRAWINGS AND FIELD MEASUREMENTS OF SUPPLIED PRODUCTS FOR LAYOUT OF THE PROJECT FEATURES.
- CONTRACTOR SHALL NOT RELY SOLELY ON ELECTRONIC VERSIONS OF PLANS, SPECIFICATIONS, AND DATA FILES THAT ARE OBTAINED FROM THE DESIGNERS, BUT SHALL VERIFY LOCATION OF PROJECT FEATURES IN ACCORDANCE WITH THE PAPER COPIES OF THE PLANS AND SPECIFICATIONS THAT ARE SUPPLIED AS PART OF THE CONTRACT DOCUMENTS.
- ALL CURBING SHALL BE VERTICAL GRANITE CURB UNLESS OTHERWISE NOTED ON PLANS.

CONSTRUCTION SEQUENCE

- SURVEY, MARK AND/OR STAKE LIMITS OF WORK.
- INSTALL SILT FENCING, HAY BALES, CONSTRUCTION EXITS, ETC. PRIOR TO START OF CONSTRUCTION, TO BE MAINTAINED UNTIL COMPLETION OF CONSTRUCTION AND ESTABLISHMENT OF PERMANENT GROUND COVER.
- CLEAR AND GRUB ALL AREAS TO BE DISTURBED BY CONSTRUCTION.
- REPAIR, CLEAN, AND REPLACE ANY SEDIMENT CONTROLS DAMAGED DURING AND/OR AFTER RAINFALL EVENTS.
- STRIP LOAM WITHIN LIMITS OF WORK AND STOCKPILE EXCESS MATERIAL FOR REUSE.
- INSTALL DRAINAGE SYSTEM AND OTHER UTILITIES IN ACCORDANCE WITH THE PLANS AND DETAILS.
- INSTALL HAY BALES AND INLET PROTECTION AT ALL CATCH BASINS AS THEY ARE CONSTRUCTED, IN ACCORDANCE WITH THE DETAILS.
- PERFORM FINAL/FINE GRADING.
- PERFORM ALL REMAINING ROADWAY, SIDEWALK, AND PAVING CONSTRUCTION.
- LOAM AND SEED ALL DISTURBED AREAS.

CONSTRUCTION SEQUENCE (CONT.)

- REMOVE TEMPORARY EROSION CONTROL MEASURES, SILT FENCE, ETC. UPON COMPLETION OF CONSTRUCTION AND ESTABLISHMENT OF PERMANENT GROUND COVER.
- CLEAN ALL DRAINAGE BASINS, STRUCTURES, PIPES, AND SUMPS WITHIN THE PROJECT LIMITS OF ALL SILT AND DEBRIS.

EXISTING CONDITIONS INFORMATION

- BASE PLAN: SURVEY PERFORMED ON THE GROUND BY VANASSE HANGEN BRUSTLIN, INC.
- TOPOGRAPHY:
 - HORIZONTAL DATUM IS BASED ON NEW HAMPSHIRE STATE PLANE GRID COORDINATE SYSTEM, N.A.D. 83.
 - VERTICAL DATUM IS BASED ON N.A.V.D. 88

EROSION CONTROL

- PRIOR TO STARTING ANY OTHER WORK ON THE SITE, THE CONTRACTOR SHALL NOTIFY APPROPRIATE AGENCIES AND SHALL INSTALL EROSION CONTROL MEASURES AS SHOWN ON THE PLANS, CONTAINED IN THE SWPPP AND AS INSTALLED IN FEDERAL, STATE, AND LOCAL APPROVAL DOCUMENTS PERTAINING TO THIS PROJECT.
- CONTRACTOR SHALL INSPECT AND MAINTAIN EROSION CONTROL MEASURES, AND REMOVE SEDIMENT THEREFROM ON A WEEKLY BASIS AND WITHIN TWELVE HOURS AFTER EACH STORM EVENT (0.5" OF RAINFALL OR GREATER) AND DISPOSE OF SEDIMENTS IN AN UPLAND AREA SUCH THAT THEY DO NOT ENCUMBER OTHER DRAINAGE STRUCTURES AND PROTECTED AREAS.
- CONTRACTOR SHALL BE FULLY RESPONSIBLE TO CONTROL CONSTRUCTION SUCH THAT SEDIMENTATION SHALL NOT AFFECT REGULATORY PROTECTED AREAS, WHETHER SUCH SEDIMENTATION IS CAUSED BY WATER, WIND, OR DIRECT DEPOSIT.
- CONTRACTOR SHALL PERFORM CONSTRUCTION SEQUENCING SUCH THAT EARTH MATERIALS ARE EXPOSED FOR A MINIMUM OF TIME BEFORE THEY ARE COVERED, SEEDED, OR OTHERWISE STABILIZED TO PREVENT EROSION.
- UPON COMPLETION OF CONSTRUCTION AND ESTABLISHMENT OF PERMANENT GROUND COVER, CONTRACTOR SHALL REMOVE AND DISPOSE OF EROSION CONTROL MEASURES AND CLEAN SEDIMENT AND DEBRIS FROM ENTIRE DRAINAGE AND SEWER SYSTEMS.
- AREAS REMAINING UNSTABILIZED FOR A PERIOD OF MORE THAN 30 DAYS SHALL BE TEMPORARILY SEEDED AND MULCHED. HAY MULCH SHALL BE APPLIED AT A MINIMUM RATE OF 1-1/2 TONS/ACRE.
- PERMANENT SEEDING SHALL OCCUR BETWEEN APRIL 1 AND JUNE 1, AND/OR BETWEEN AUGUST 15 AND OCTOBER 15. ALL SEEDING FROM SEPTEMBER 15 SHALL BE HAY MULCHED.
- DUST SHALL BE CONTROLLED THROUGH THE USE OF CALCIUM CHLORIDE.
- SOILS TO BE STOCKPILED FOR A PERIOD OF MORE THAN 30 DAYS SHALL BE TEMPORARILY SEEDED AND MULCHED. CONTRACTOR SHALL INSTALL SILT FENCING ALONG DOWNHILL SIDE OF STOCKPILES.
- CONTRACTOR SHALL PROVIDE NECESSARY EROSION CONTROL MEASURES TO INSURE THAT SURFACE WATER RUN-OFF FROM UNSTABILIZED AREAS DOES NOT CARRY SILT, SEDIMENT, AND OTHER DEBRIS OUTSIDE OF THE LIMITS OF WORK.
- AN AREA SHALL BE CONSIDERED STABLE IF ONE OF THE FOLLOWING HAS OCCURRED:
 - BASE COURSE GRAVELS HAVE BEEN INSTALLED IN AREAS TO BE PAVED;
 - A MINIMUM OF 85% VEGETATED GROWTH HAS BEEN ESTABLISHED;
 - A MINIMUM OF 3 INCHES OF NON-EROSIVE MATERIAL, SUCH AS STONE OR RIPRAP, HAS BEEN INSTALLED;
 - EROSION CONTROL BLANKETS HAVE BEEN PROPERLY INSTALLED.
- ALL DITCHES, SWALES, AND DRAINAGE BASINS SHALL BE STABILIZED PRIOR TO DIRECTING RUNOFF TO THEM.
- ALL ROADWAYS AND PARKING LOTS SHALL BE STABILIZED WITHIN 72 HOURS OF ACHIEVING FINISHED GRADE.
- ALL CUT AND FILL SLOPES SHALL BE LOAMED AND SEEDED WITHIN 72 HOURS OF ACHIEVING FINISHED GRADE.
- ALL PERMANENT AND TEMPORARY SEEDING SHALL BE AS FOLLOWS (UNLESS OTHERWISE NOTED):

PERMANENT SEEDING	APPLICATION RATE (POUNDS/ACRE)	GERMINATION MINIMUM	PURITY MINIMUM
PARK SEED TYPE 15 (644.15)			
CREeping RED FESCUE	40	85%	96%
PERENNIAL RYEGRASS	50	90%	98%
KENTUCKY BLUEGRASS	25	85%	97%
RED TOP	5	80%	95%

TEMPORARY SEEDING	% WEIGHT	GERMINATION MINIMUM
WINTER RYE	80% MIN.	85%
RED FESCUE (CREeping)	4% MIN.	80%
PERENNIAL RYE GRASS	3% MIN.	90%
RED CLOVER	3% MIN.	90%
OTHER CROP GRASS	0.5% MAX.	
NOXIOUS WEED SEED	0.5% MAX.	
INERT MATTER	1.0% MAX.	

* TEMPORARY SEED FOR LAWNS/GRASSED AREAS SHALL ONLY BE PLANTED WHEN PERMANENT GRASSES CANNOT BE PLANTED DUE TO THE GROWING SEASON.

WINTER CONSTRUCTION

- ALL PROPOSED VEGETATED AREAS WHICH DO NOT EXHIBIT A MINIMUM OF 85% VEGETATIVE GROWTH BY OCTOBER 15TH, OR WHICH ARE DISTURBED AFTER OCTOBER 15TH, SHALL BE STABILIZED. STABILIZATION METHODS SHALL INCLUDE SEEDING AND INSTALLING EROSION CONTROL BLANKETS ON SLOPES GREATER THAN 3:1, AND SEEDING AND PLACING 3 TO 4 TONS OF MULCH PER ACRE, SECURED WITH ANCHORED NETTING, ELSEWHERE. THE INSTALLATION OF EROSION CONTROL BLANKETS OR MULCH AND NETTING SHALL NOT OCCUR OVER ACCUMULATED SNOW OR FROZEN GROUND AND SHALL BE COMPLETED IN ADVANCE OF THAW OR SPRING MELT EVENTS.
- ALL DITCHES OR SWALES WHICH DO NOT EXHIBIT A MINIMUM OF 85% VEGETATIVE GROWTH BY OCTOBER 15TH, OR WHICH ARE DISTURBED AFTER OCTOBER 15TH, SHALL BE TEMPORARILY STABILIZED WITH STONE OR EROSION CONTROL BLANKETS APPROPRIATE FOR THE DESIGN FLOW CONDITIONS.

DESCRIPTION

REVISIONS AFTER PROPOSAL

STATION

STATION

DATE


NUMBER

DATE

DATE

DATE

DATE

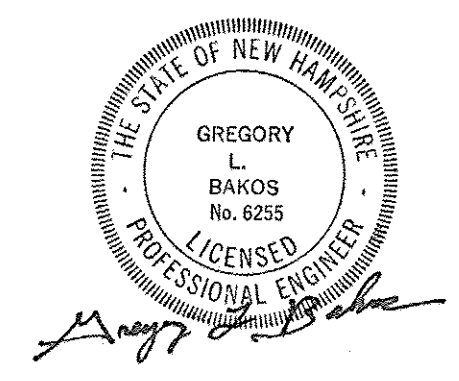

ISLINGTON STREET CORRIDOR IMPROVEMENTS - SEGMENT 1

CITY OF PORTSMOUTH, NEW HAMPSHIRE

LEGEND & GENERAL NOTES

DATE PLOTTED	VHB PROJECT NO.	DRAWING	CITY PROJECT NO.	SHEET NO.	TOTAL SHEETS
13-Nov-18	52393.00	LEG-Seg1	7176	02	88

REVISIONS AFTER PROPOSAL

STATION


STATION

DATE


NUMBER

DATE
OCT 2017
DATE 11/13/18
DATE 11/13/18
DATE


SDR PROCESSED VHB
NEW DESIGN KMH
SHEET CHECKED GJB
AS BUILT DETAILS

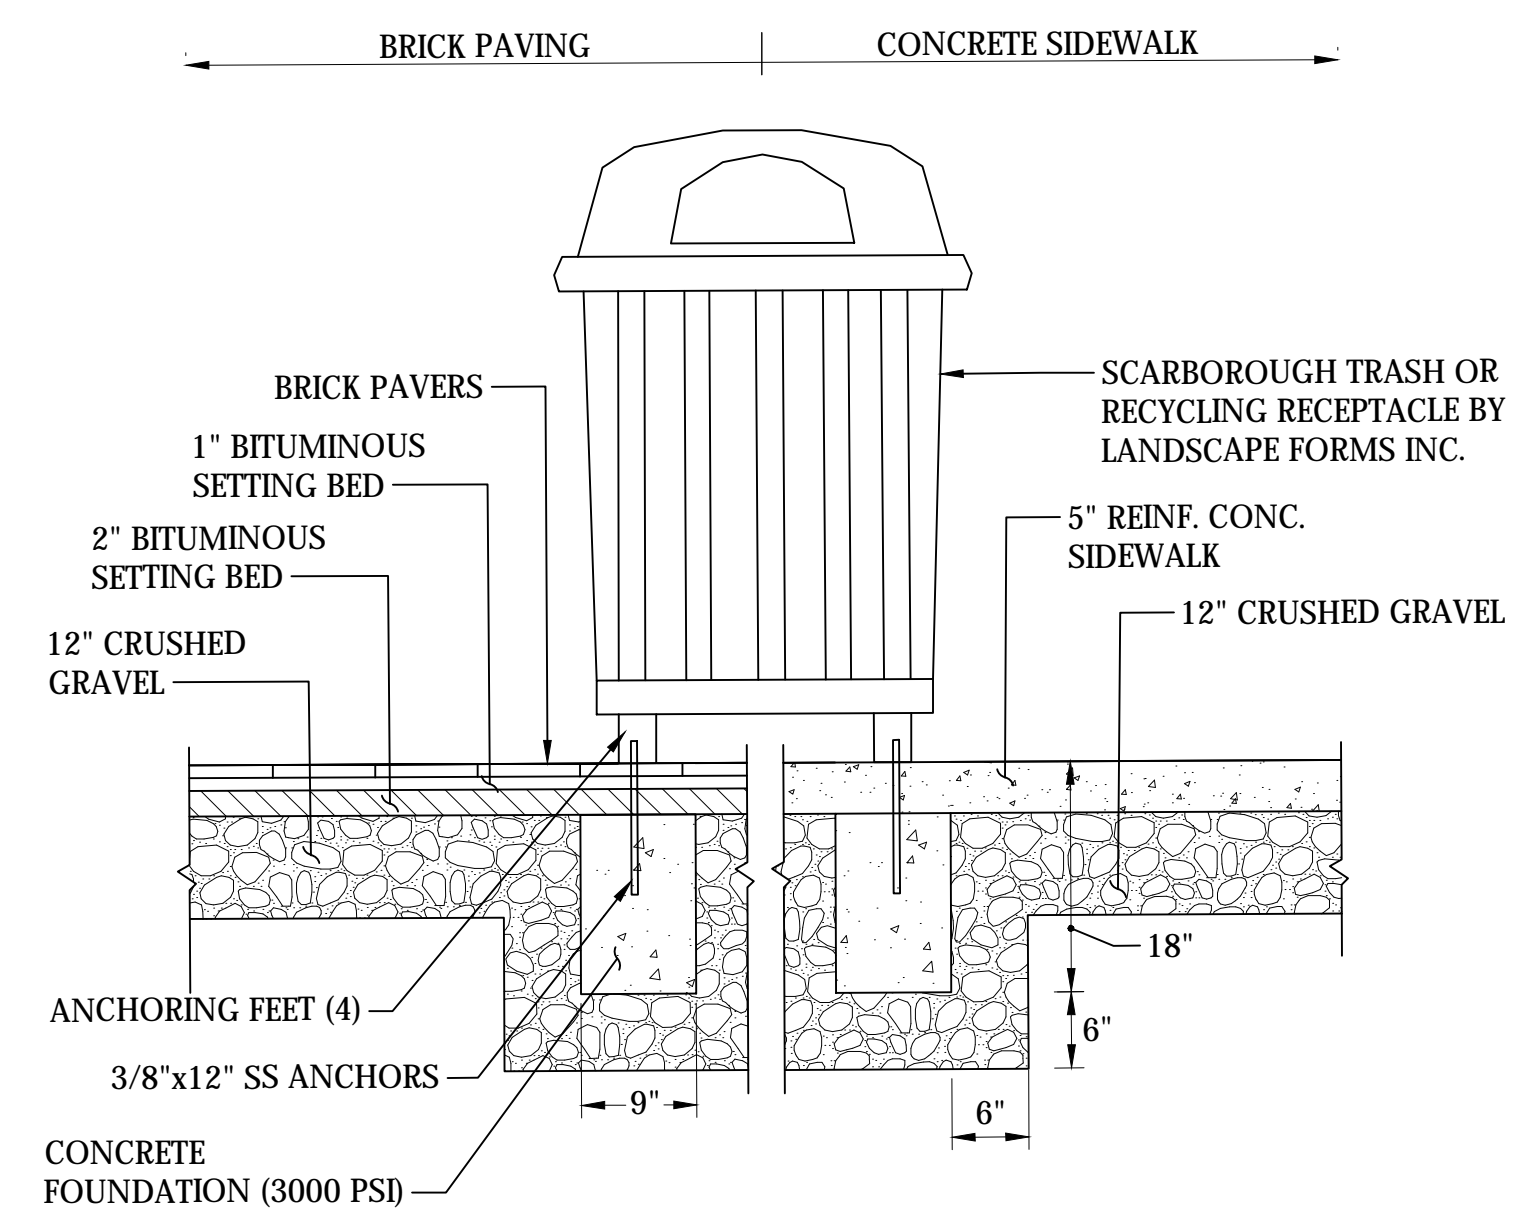


Trash Receptacle
N.T.S.

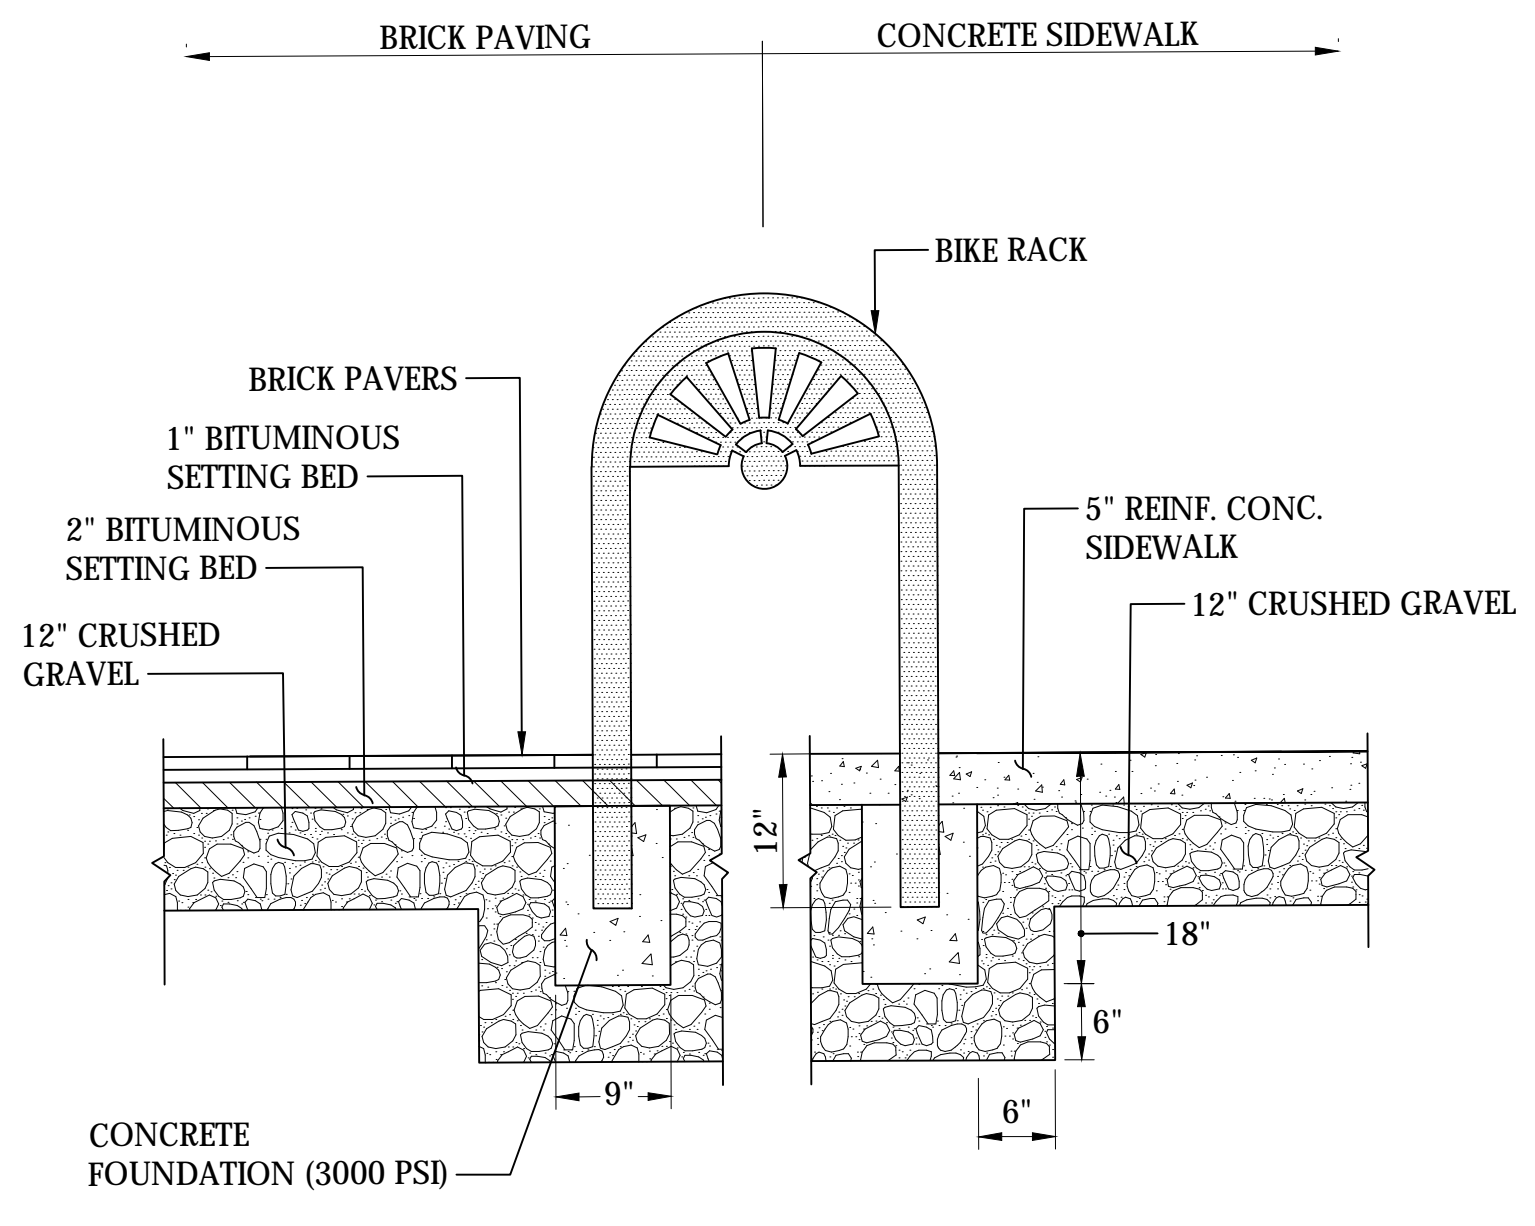


Bicycle Rack
N.T.S.

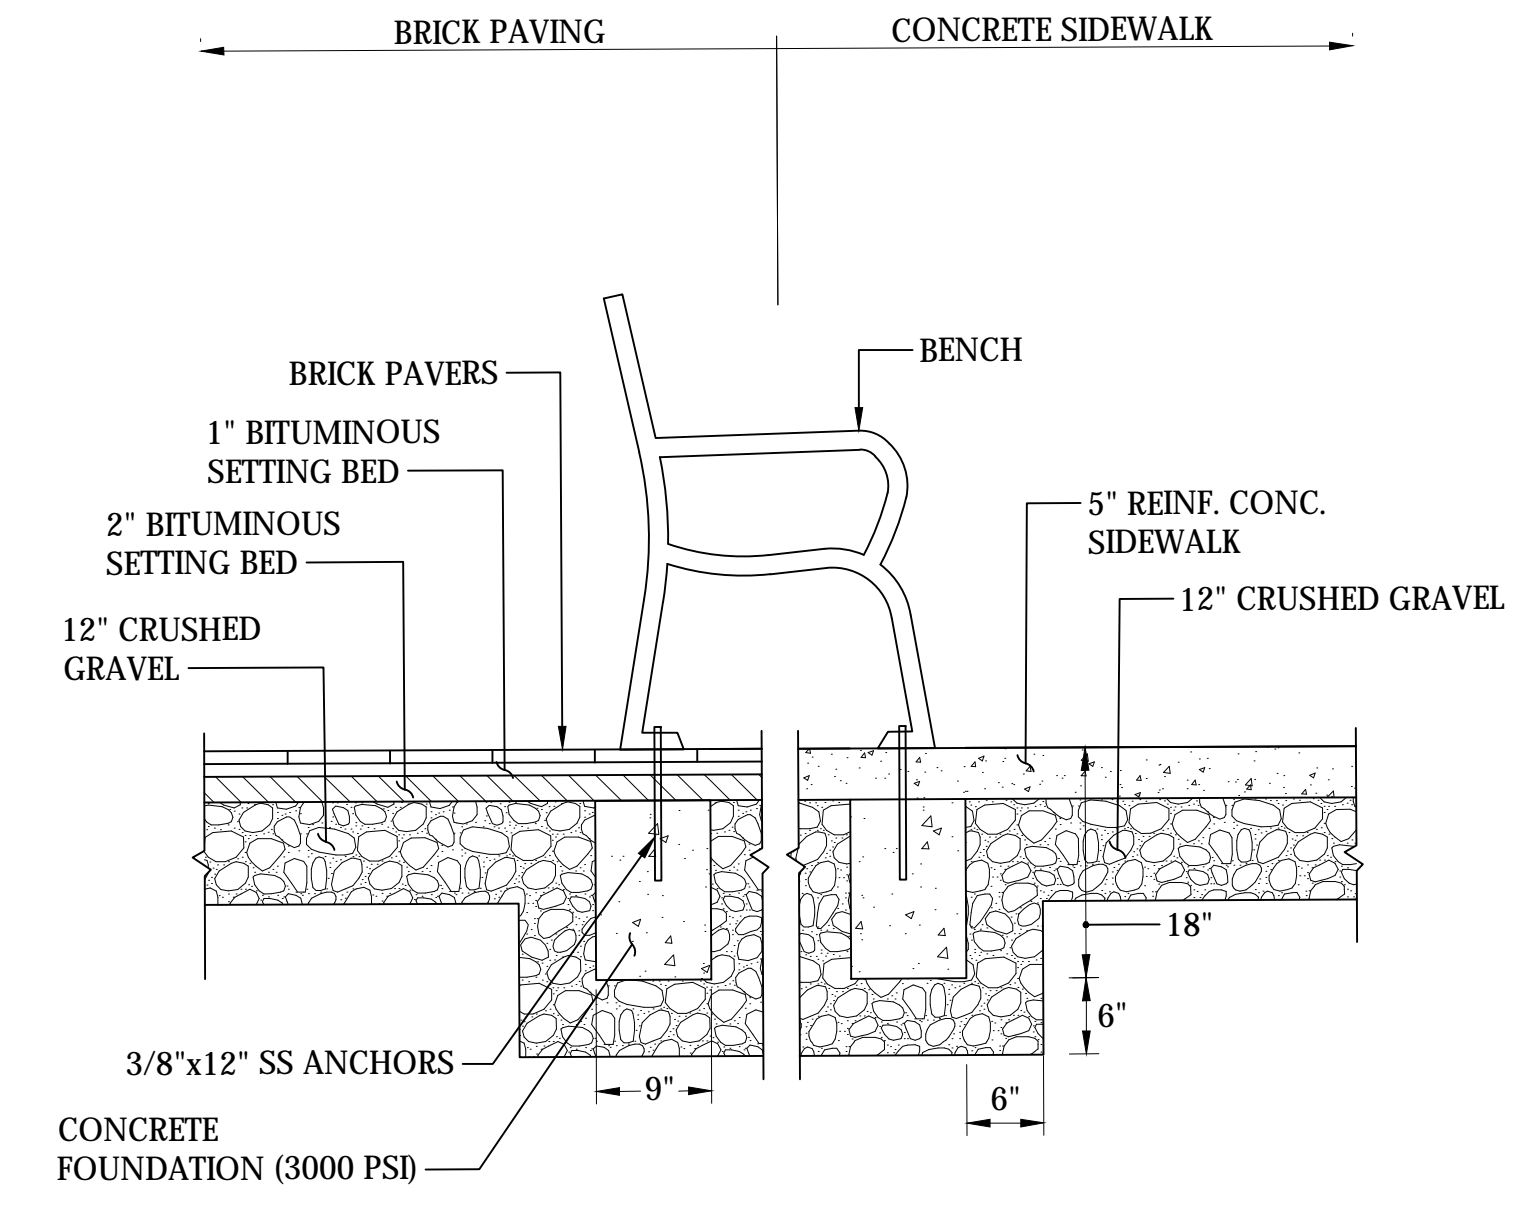


Victor Bench
N.T.S.

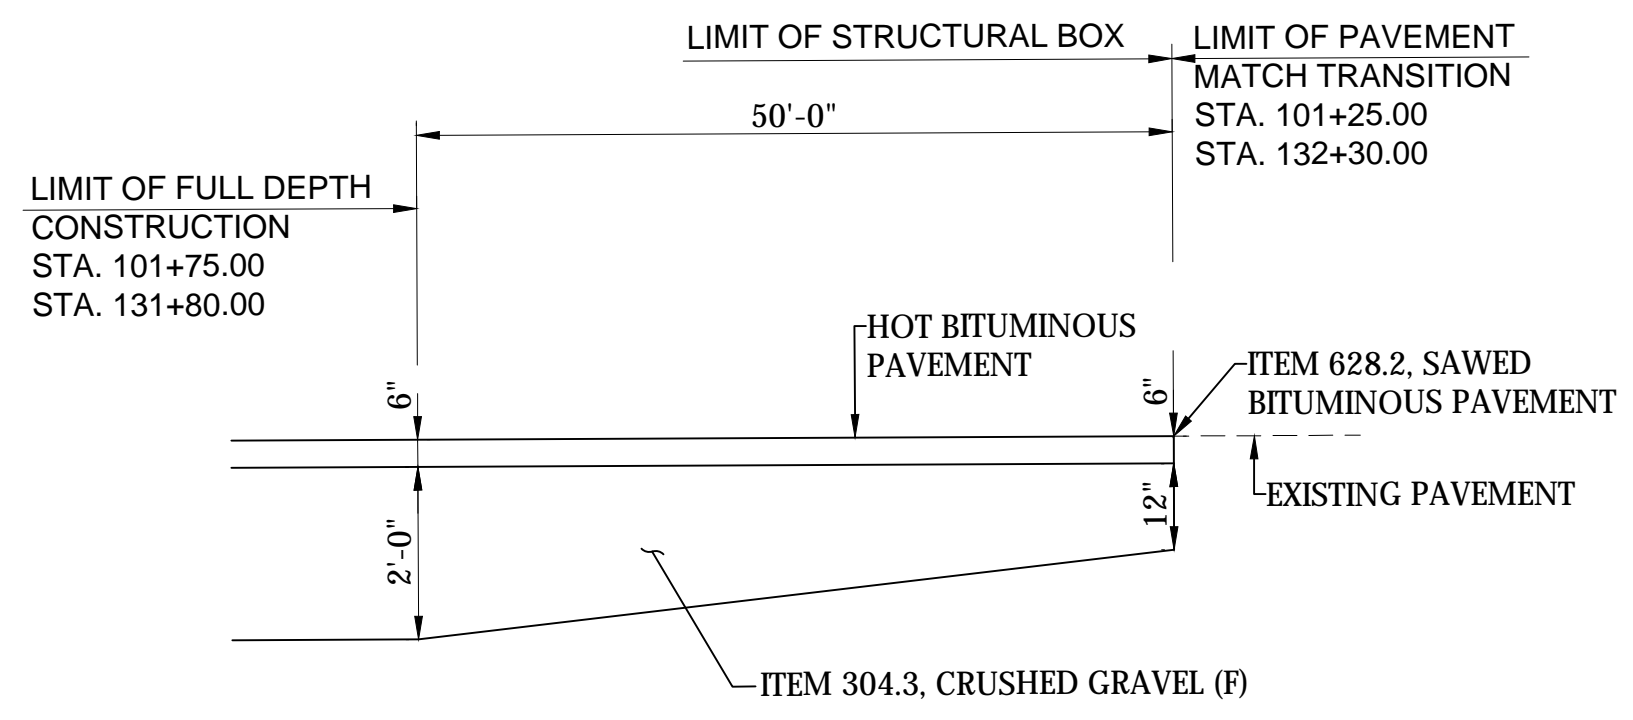


Full Depth Pavement Transition
N.T.S.

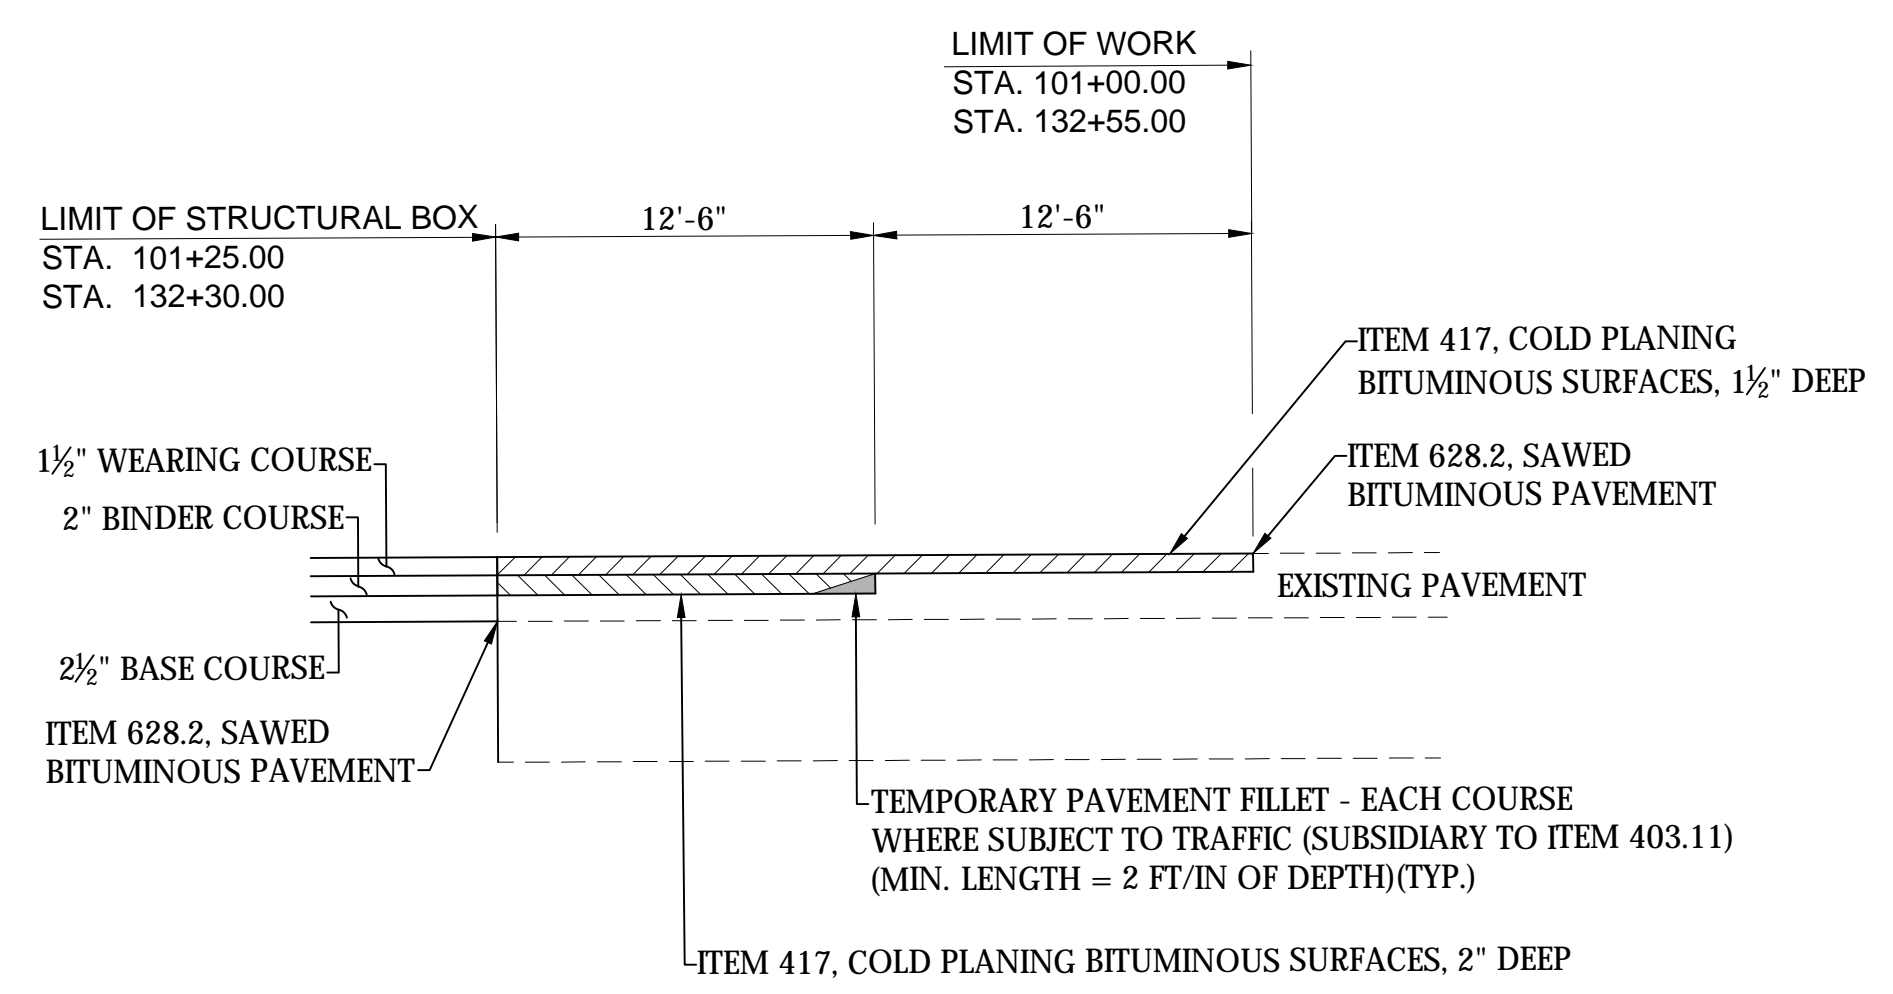

Pavement Match Transition
N.T.S.

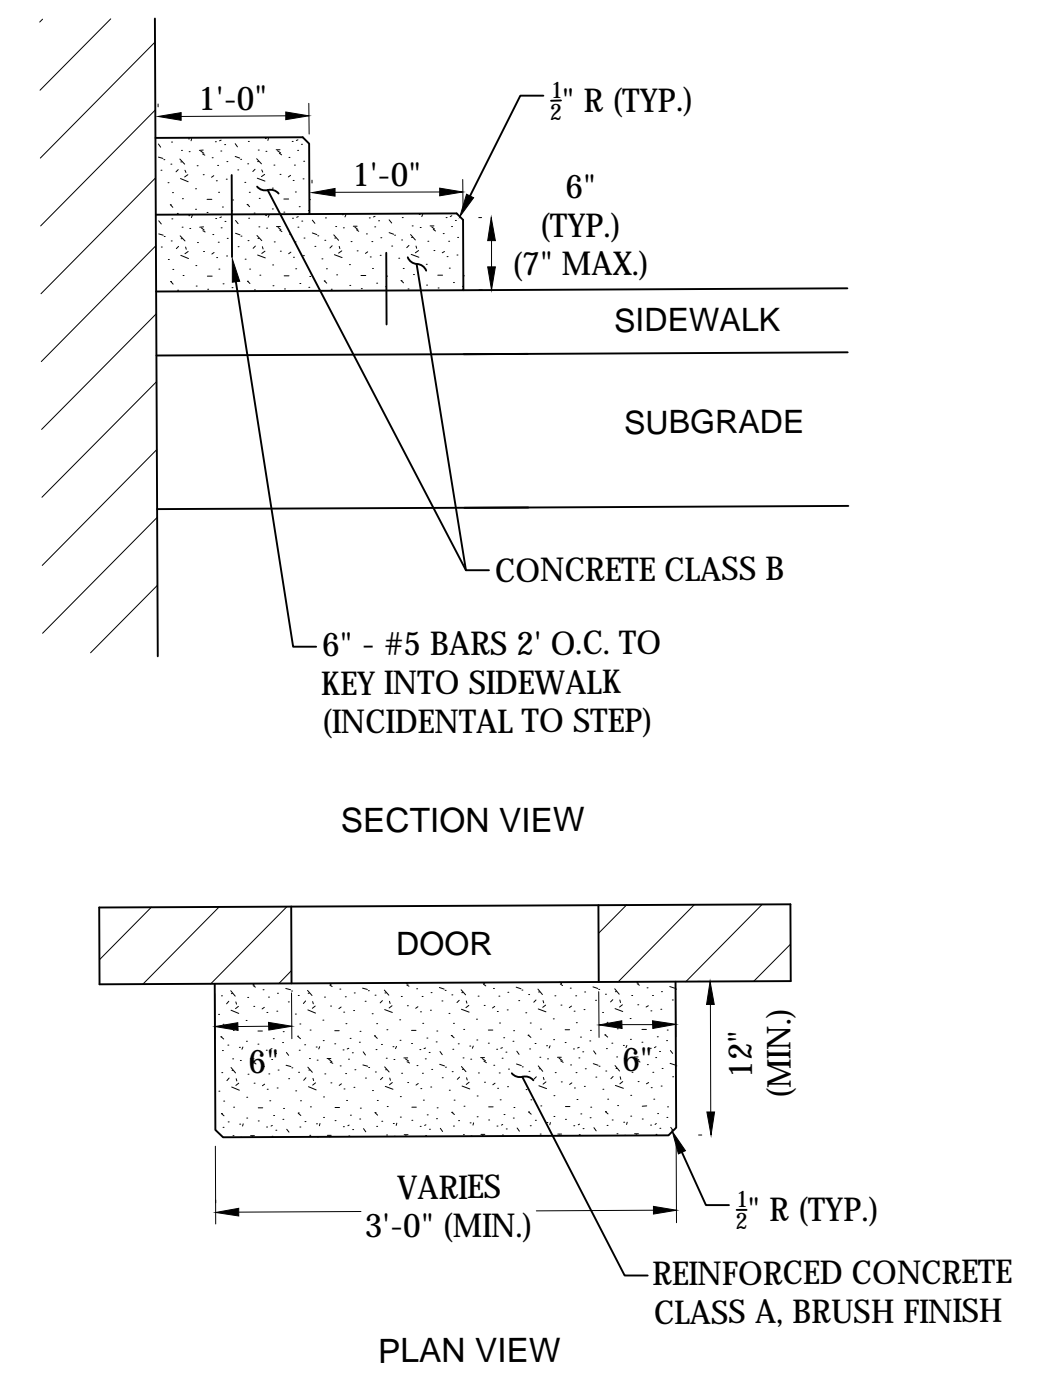

Concrete Step
N.T.S.

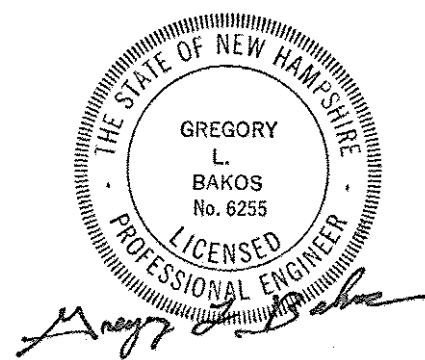

		ISLINGTON STREET CORRIDOR IMPROVEMENTS - SEGMENT 1			
		CITY OF PORTSMOUTH, NEW HAMPSHIRE			
		DETAILS			
		DATE PLOTTED 13-Nov-18	VHB PROJECT NO. 52393.00	DRAWING DET-Seg1	CITY PROJECT NO. 7176

REVISIONS AFTER PROPOSAL

STATION

STATION

DATE

NUMBER

DATE OCT 2017

DATE 11/13/18

DATE 11/13/18


DATE

VHB

KMH

GLB

AS BUILT DETAILS

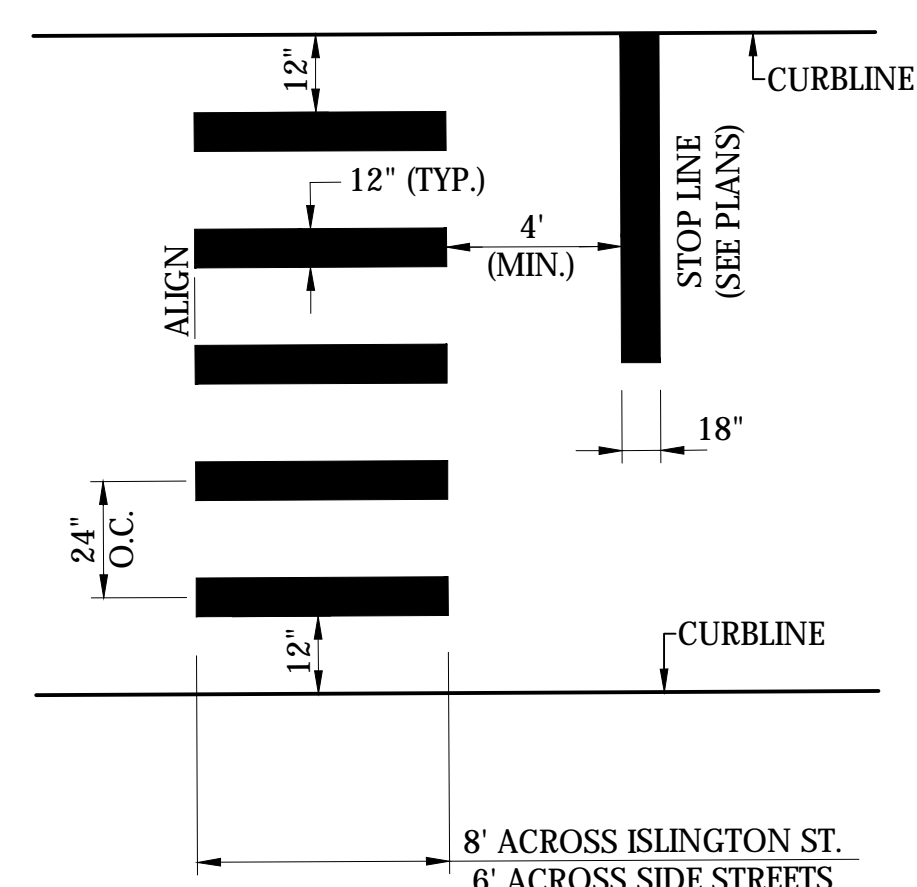


NOTES

1. TWELVE INCH (12") LINES SHALL BE APPLIED IN ONE APPLICATION. NO COMBINATION OF LINES (TWO - 6 INCH LINES) WILL BE ACCEPTED.
2. LONGITUDINAL CROSSWALK LINES TO BE PARALLEL TO CURBLINE.
3. ALL LONGITUDINAL CROSSWALK LINES TO BE THE SAME LENGTH AND PROPERLY ALIGNED.

Crosswalk

N.T.S.

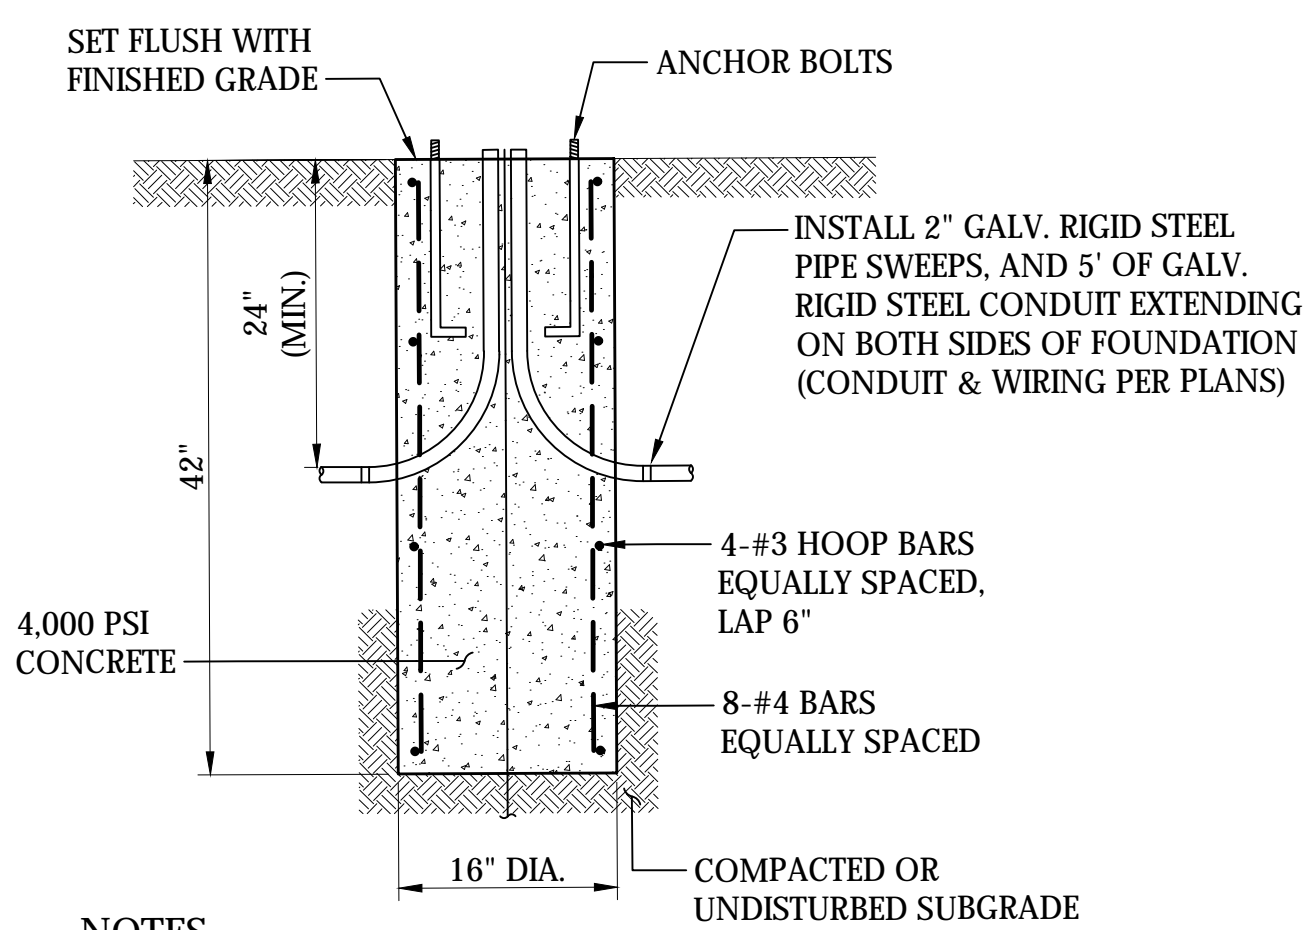


NOTES

1. ANCHORS AND BOLTS SHALL BE OF MATERIALS AND TO DIMENSIONS SPECIFIED BY LIGHT POLE MANUFACTURER.
2. GROUND WIRE AND GROUNDING ROD SHALL BE INCLUDED IN INSTALLATION PER POLE MANUFACTURER AND NATIONAL ELECTRICAL CODE

Light Pole Foundation

N.T.S.

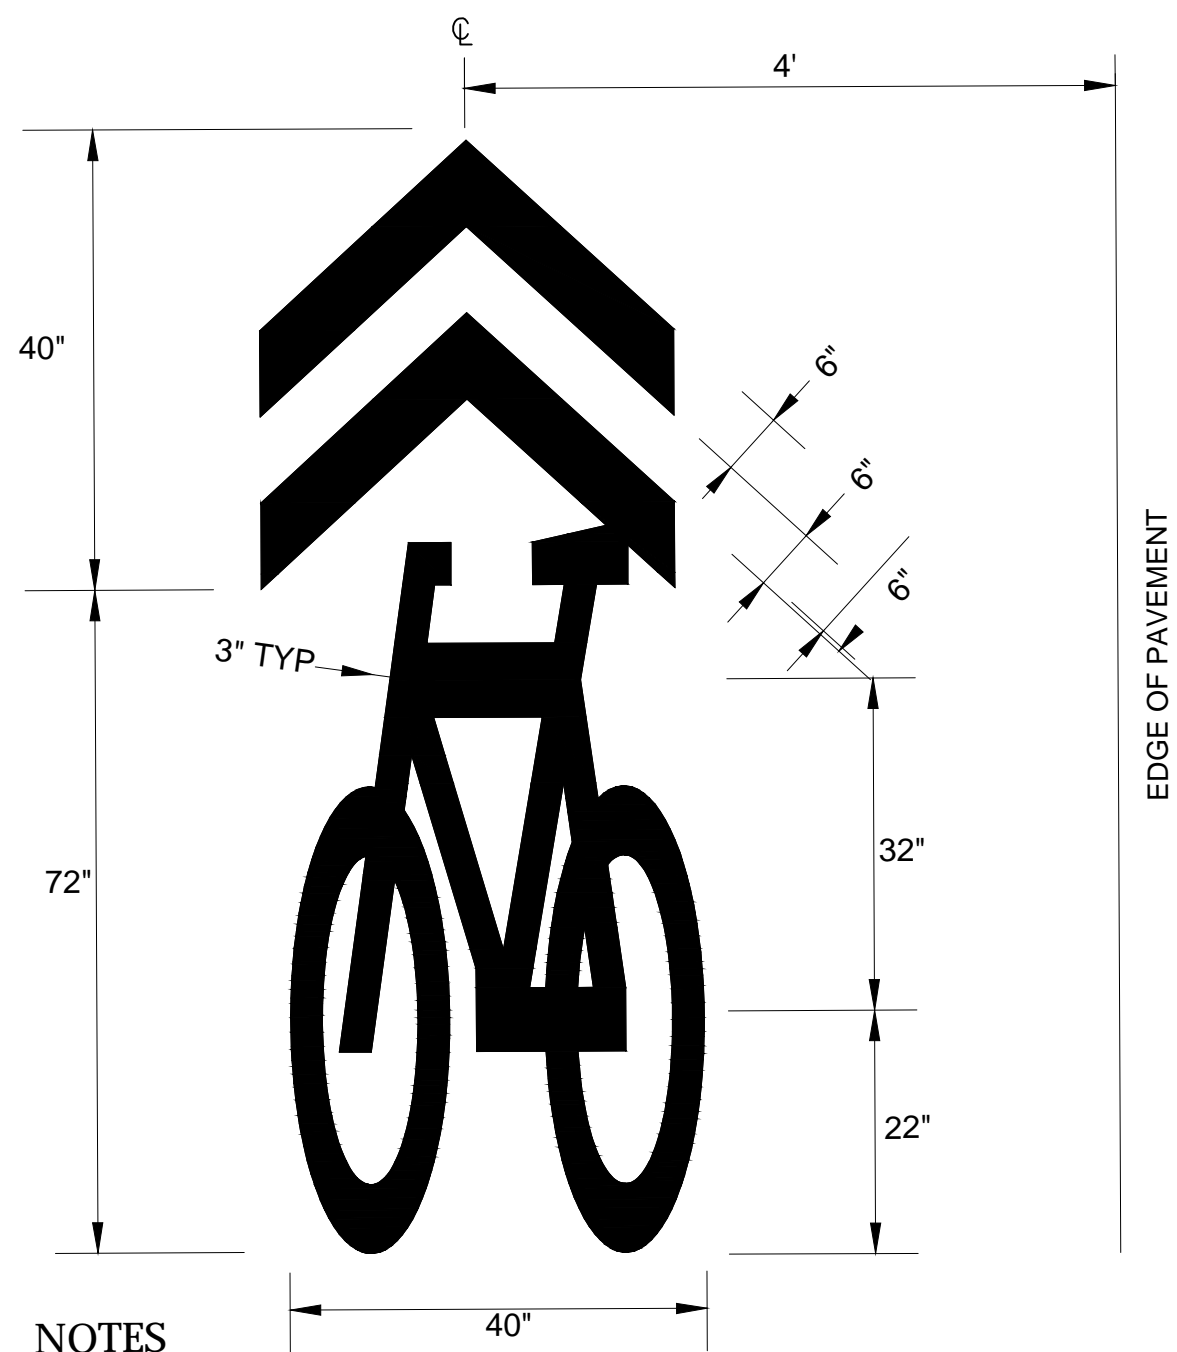


NOTES

1. SEE MUTCD FIGURE 9C-9 FOR MORE INFORMATION.
2. SHARED LANE MARKINGS SHALL BE REFLECTORIZED PAINT.

Bicycle Sharrows

N.T.S.

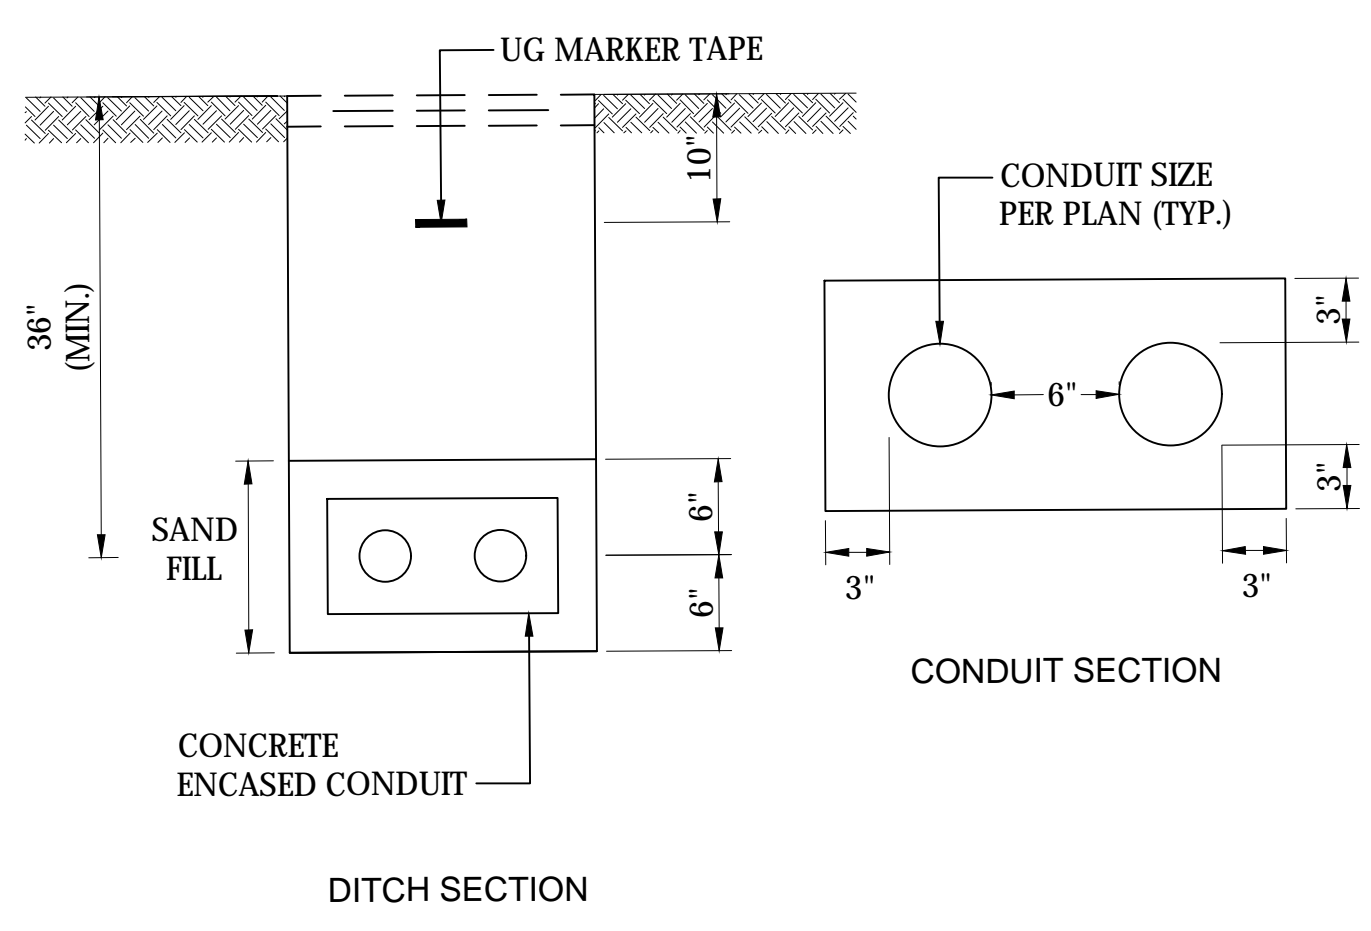


NOTES

1. CONCRETE ENCASE ALL CONDUITS CROSSING ROADWAYS.

Concrete Encased Conduit

N.T.S.

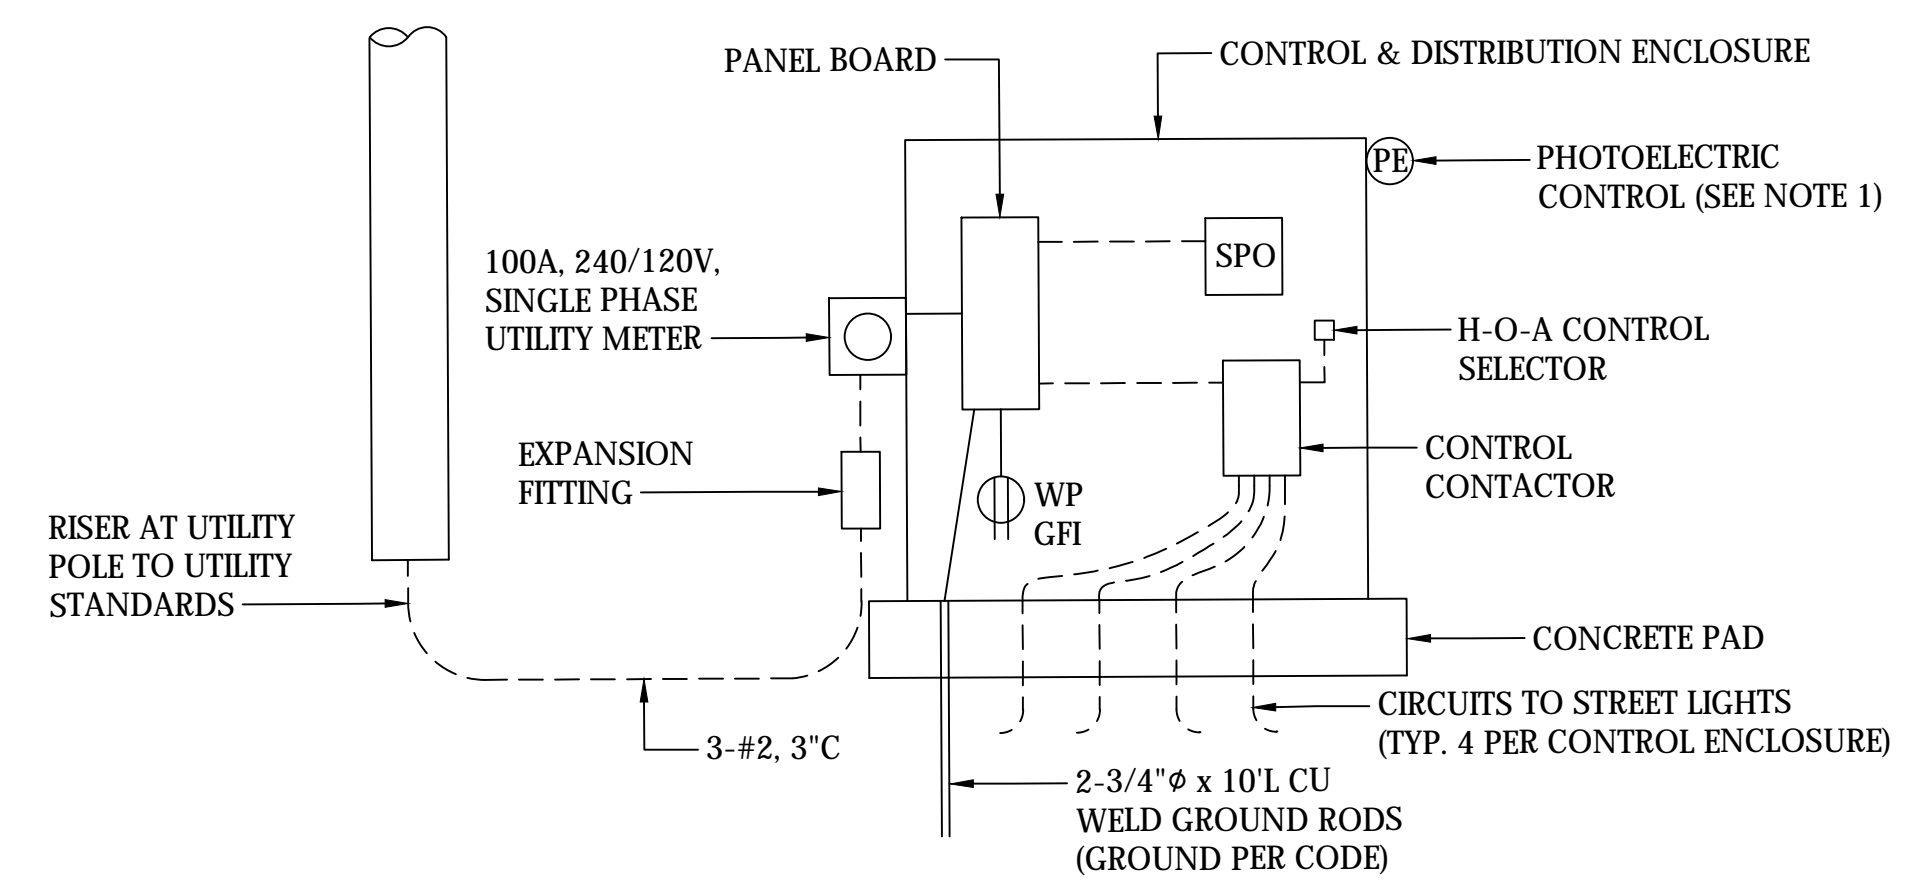

ESTIMATED EQUAL SIZES MOUNTED IN CONTROL & DISTRIBUTION ENCLOSURE


PANEL BOARD	20"W x 26"H x 5 3/4"D
SPO	20"W x 20"H x 7"D
H-O-A	4"W x 4 1/2"H x 3 1/2"D
CONTACTOR	4 1/2"W x 6"H x 4 1/2"D

NOTES

1. FIELD COORDINATE LOCATION OF PHOTOELECTRIC CONTROL WITH CITY AND RESIDENT ENGINEER. PROVIDE SHIELDING TO MINIMIZE EFFECTS OF VEHICLE, BUILDING, AND OTHER LIGHTING.

Typical Service One Line Diagram

N.T.S.

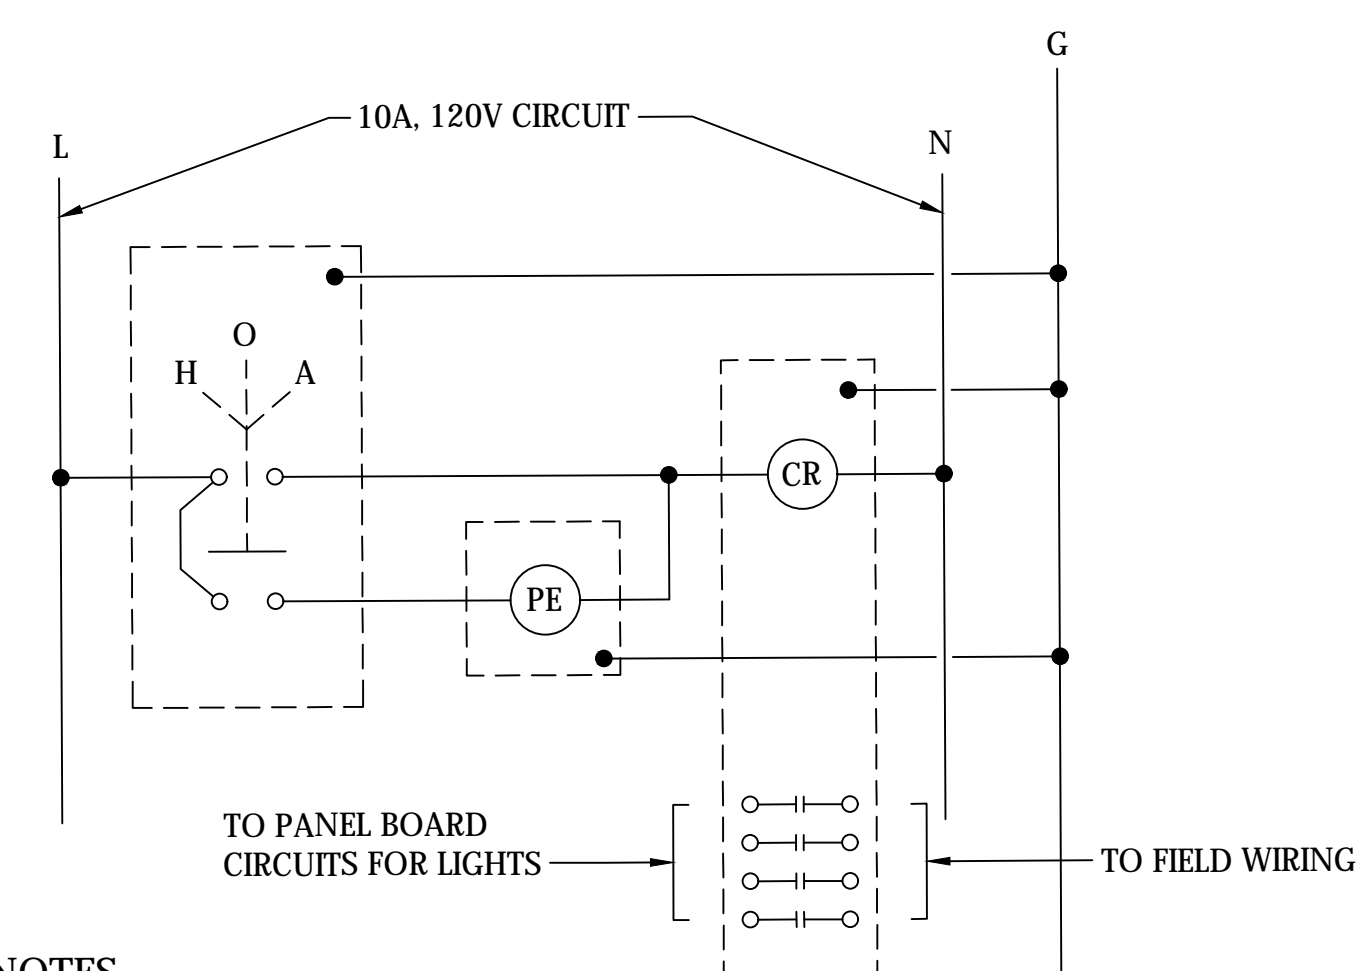


NOTES

1. H-O-A: ALLEN BRADLEY BULLETIN 800T, 3 POSITION, MAINTAINED CONTACT SELECTOR SWITCH ON NEMA 13 OVERSIZED ENCLOSURE. EQUALS BY SQUARE D, SIEMENS, GENERAL ELECTRIC.
2. CR: ALLEN BRADLEY BULLETIN 500, 4 POLE, NEMA 1 ENCLOSED, 4 POLE CONTACTOR, 120V AC CONTROL, 30A CONTACTS. EQUALS BY SQUARE D, SIEMENS, GENERAL ELECTRIC.
3. PE: PHOTOELECTRIC CONTROLLER, 120V AC, WITH WEATHERPROOF SOCKET, COORDINATE PHYSICAL LOCATION AND PROVIDE ALL REQUIRED SCREENING/SHIELDING TO INHIBIT INTERFERENCE FROM OTHER FIXED AND/OR MOBILE LIGHT SOURCES.

Typical Control W/D

N.T.S.

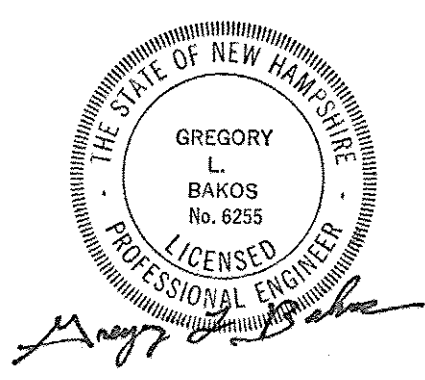

		ISLINGTON STREET CORRIDOR IMPROVEMENTS - SEGMENT 1					
		CITY OF PORTSMOUTH, NEW HAMPSHIRE					
		DETAILS					
		DATE PLOTTED	VHB PROJECT NO.	DRAWING	CITY PROJECT NO.	SHEET NO.	TOTAL SHEETS
		13-Nov-18	52393.00	DET-Seg1	7176	09	88

DESCRIPTION

REVISIONS AFTER PROPOSAL


STATION

DATE


NUMBER

DATE

AS BUILT DETAILS

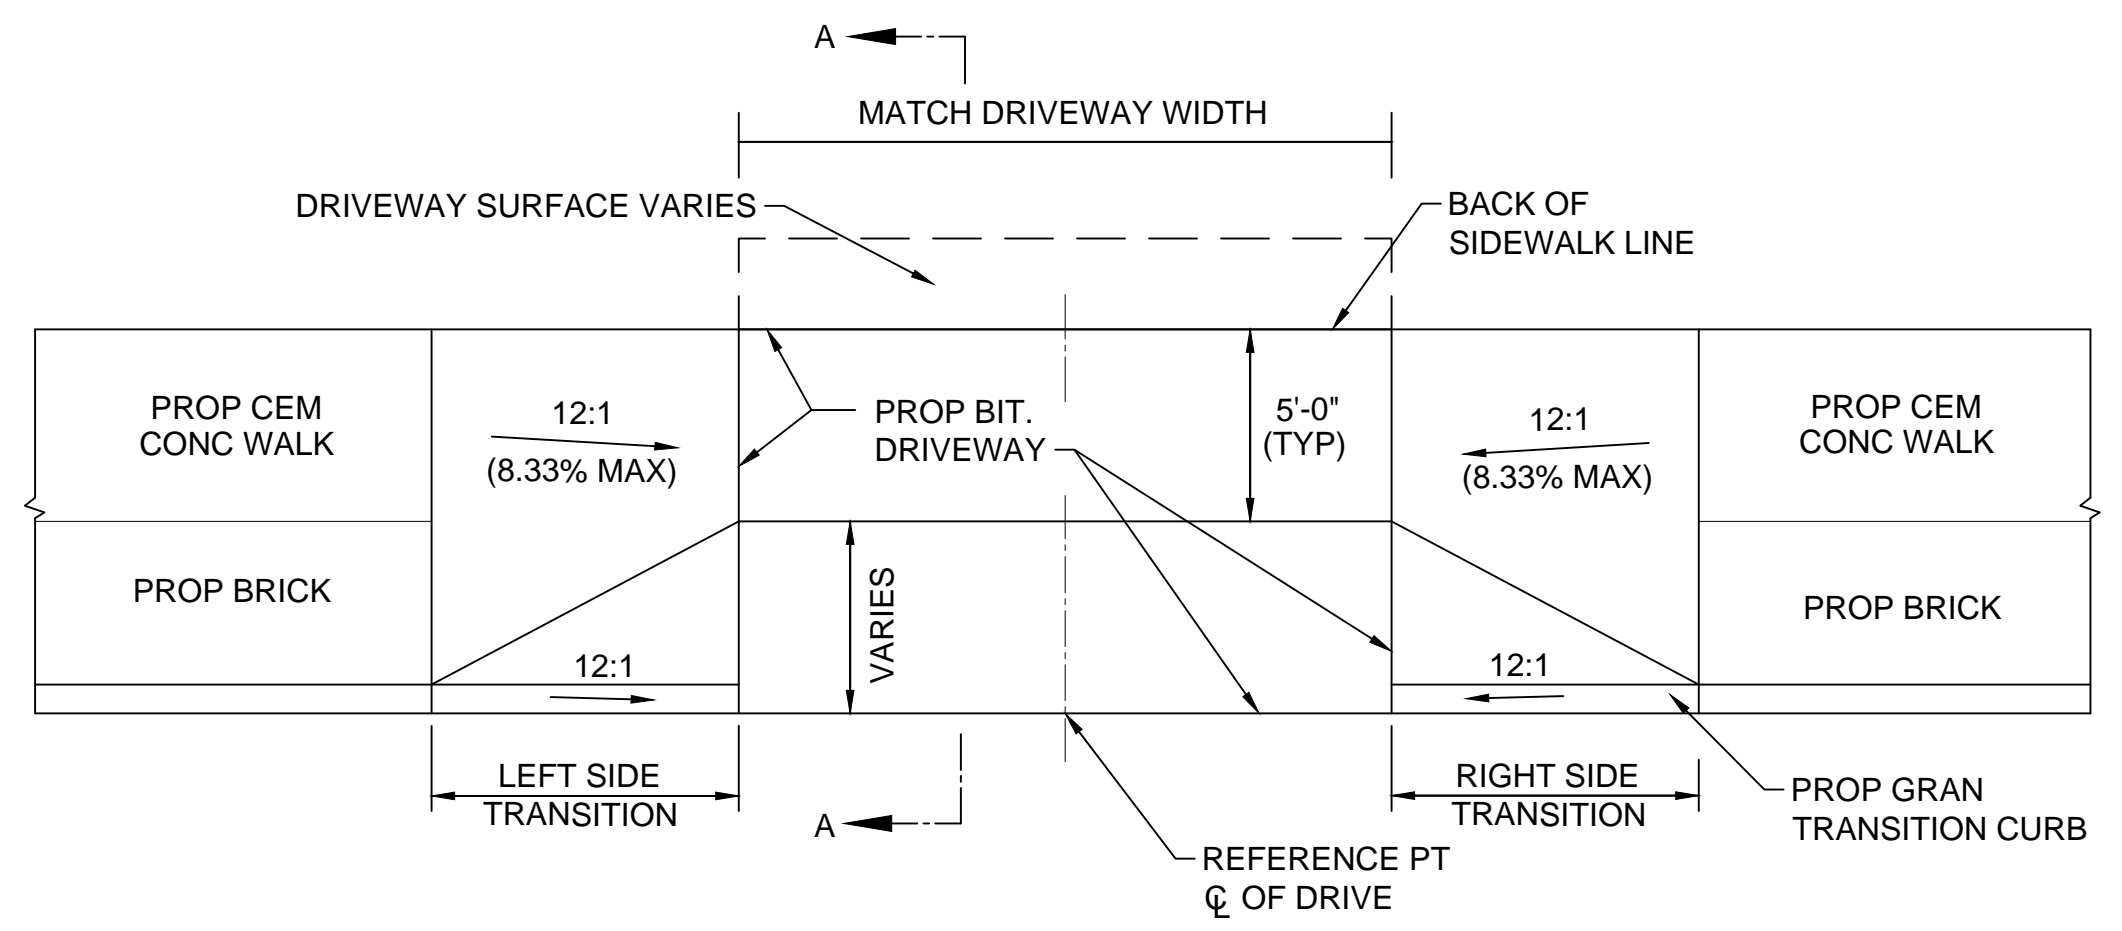

PLAN

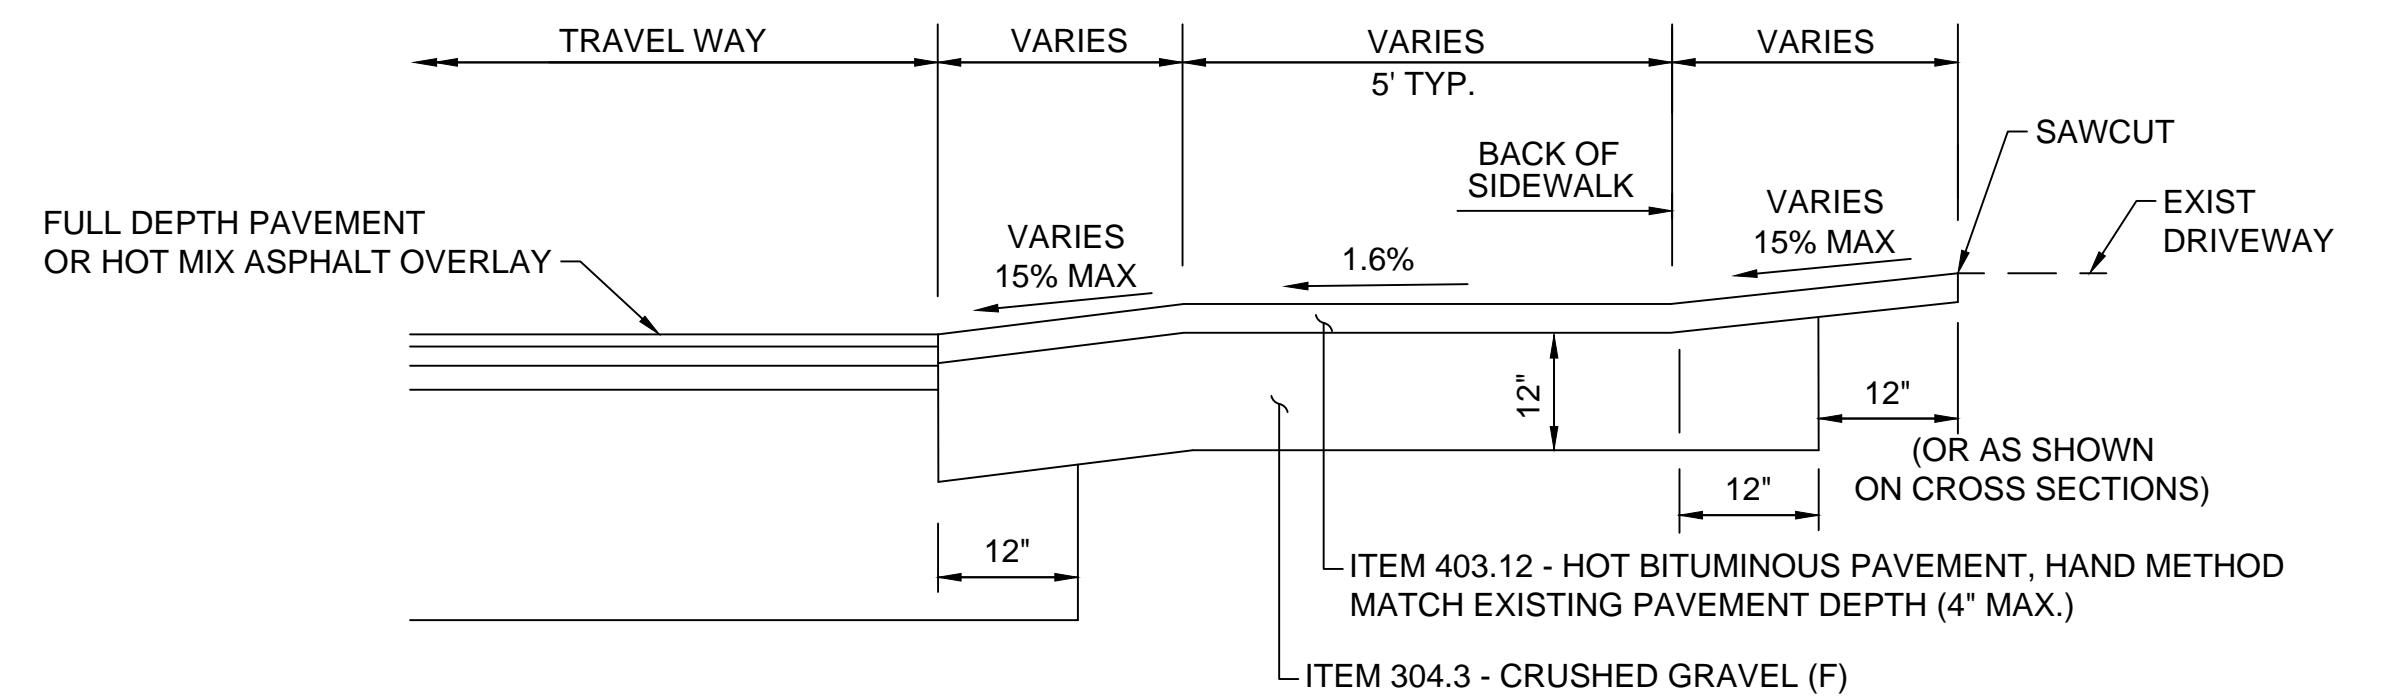


SECTION A-A

TYPICAL BITUMINOUS DRIVEWAY WITH SIDEWALK AND GRANITE TRANSITION CURB DETAIL A


SCALE: NTS

SIDEWALK RAMP DETAIL DRIVEWAY A TABLE						
NO.	LOCATION	SIDEWALK WIDTH	DRIVEWAY WIDTH	LEFT SIDE TRANS LENGTH	RIGHT SIDE TRANS LENGTH	OPENING ELEVATION
63	STA. 23+96.00 15.25' RT	VARIES	43'-6"	8'-0"	7'-0"	19.46'
65	STA. 23+40.00 13.00' LT	8'-6"	10'-0"	8'-0"	7'-0"	18.31'
66	STA. 22+37.00 13.00' RT	VARIES	12'-0"	7'-0"	7'-0"	17.39'
67	STA. 21+72.00 13.00' RT	9'-0"	30'-0"	7'-0"	7'-0"	17.29'
68	STA. 21+54.00 13.00' LT	VARIES	24'-0"	7'-0"	7'-0"	17.32'
69	STA. 21+05.00 13.00' LT	8'-0"	23'-9"	7'-0"	7'-0"	17.53'

NOTE:
ALL SIDEWALK TRANSITION RAMPS SHALL BE 6" REINFORCED CONCRETE SIDEWALK

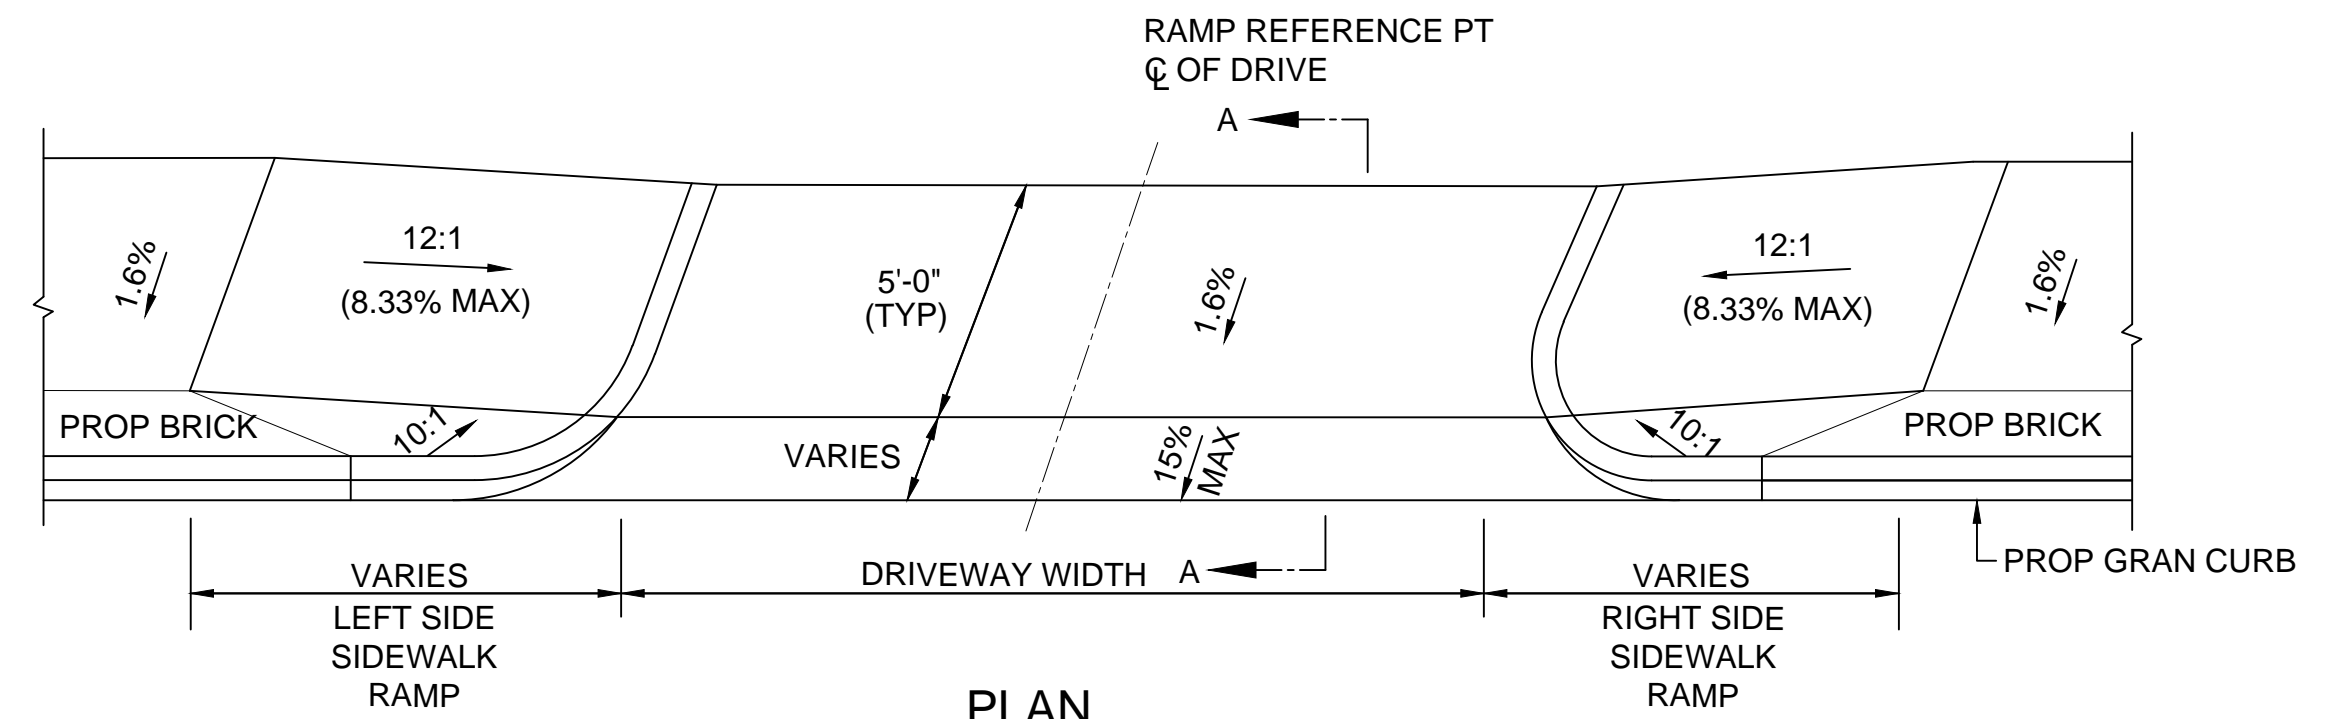

PLAN


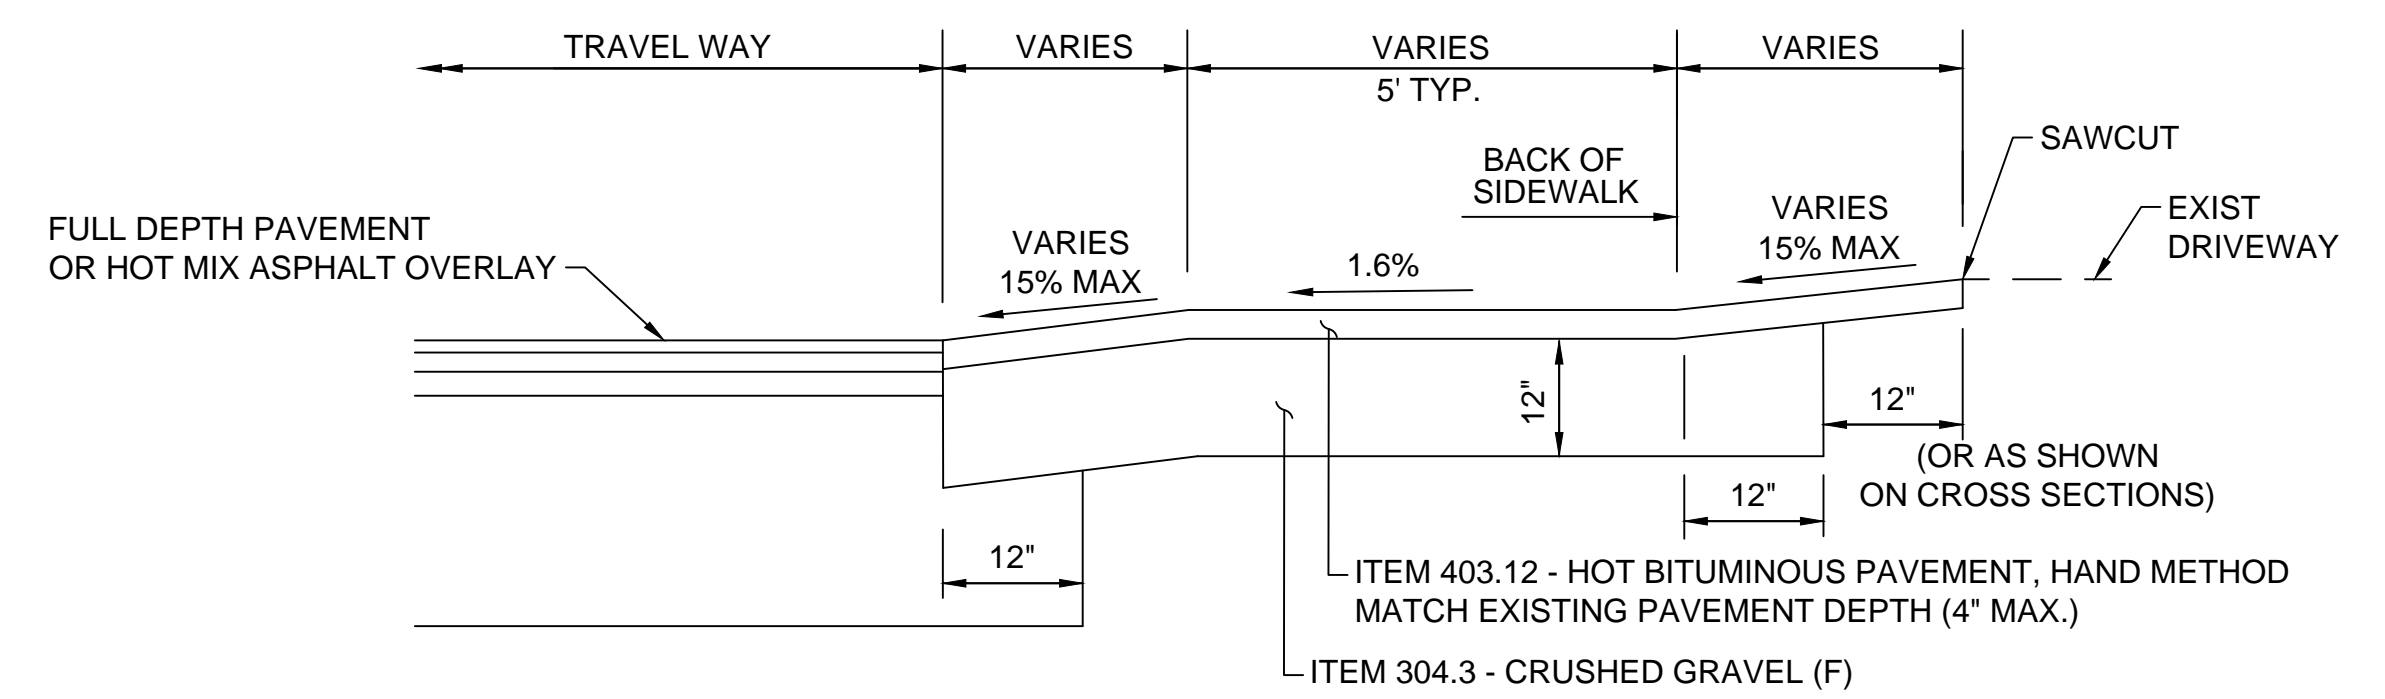


SECTION A-A

TYPICAL BITUMINOUS DRIVEWAY WITH SIDEWALK AND GRANITE TRANSITION CURB DETAIL B

SCALE: NTS

SIDEWALK RAMP DETAIL DRIVEWAY B TABLE						
NO.	LOCATION	SIDEWALK WIDTH	DRIVEWAY WIDTH	LEFT SIDE TRANS LENGTH	RIGHT SIDE TRANS LENGTH	OPENING ELEVATION
5	STA. 103+38.00 12.00' LT	5'-0"	24'-0"	7'-0"	7'-0"	29.65'
7	STA. 103+92.00 12.00' LT	5'-0"	30'-0"	7'-0"	7'-0"	29.20'
15	STA. 106+97.00 15.75' LT	5'-2"	44'-0"	7'-0"	7'-0"	26.74'
16	STA. 107+99.00 12.00' LT	5'-6"	43'-0"	7'-0"	N/A	27.08'
17	STA. 108+46.00 13.00' RT	5'-0"	98'-0"	MATCH EXISTING	7'-0"	27.57'
18	STA. 108+59.00 12.00' LT	5'-0"	54'-0"	N/A	7'-0"	27.59'
19	STA. 109+19.00 12.00' LT	5'-0"	20'-0"	7'-0"	7'-0"	28.05'
20	STA. 110+25.00 12.00' LT	5'-0"	36'-0"	8'-0"	7'-0"	27.63'
28	STA. 114+27.00 24.00' LT	5'-0"	35'-0"	7'-0"	7'-0"	20.82'
32	STA. 118+26.00 28.00' LT	5'-0"	23'-0"	9'-2"	7'-0"	13.68'
33	STA. 118+90.00 12.00' RT	5'-0"	38'-0"	7'-0"	9'-2"	12.38'
46	STA. 123+80.00 12.00' LT	5'-0"	60'-6"	7'-0"	7'-0"	19.65'
59	STA. 129+36.00 12.00' LT	VARIES	12'-0"	7'-0"	8'-0"	20.89'

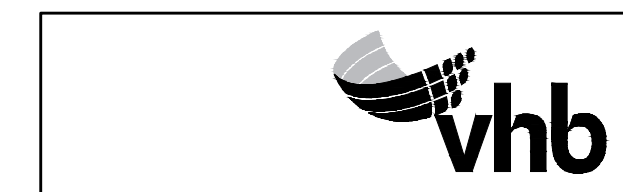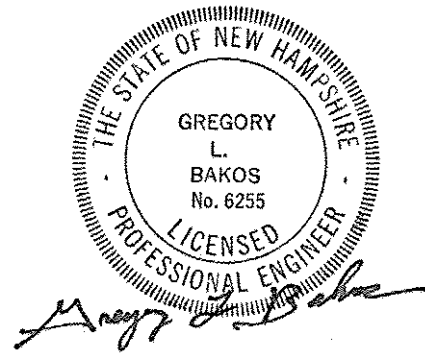

ISLINGTON STREET CORRIDOR IMPROVEMENTS - SEGMENT 1
CITY OF PORTSMOUTH, NEW HAMPSHIRE

DETAILS

DATE PLOTTED	VHB PROJECT NO.	DRAWING	CITY PROJECT NO.	SHEET NO.	TOTAL SHEETS
13-Nov-18	52393.00	DET_WCR-Seg1	7176	12	88

DESCRIPTION

REVISIONS AFTER PROPOSAL

STATION

DATE

NUMBER

DATE


DATE

VHB

KMH


GLB

AS BUILT DETAILS

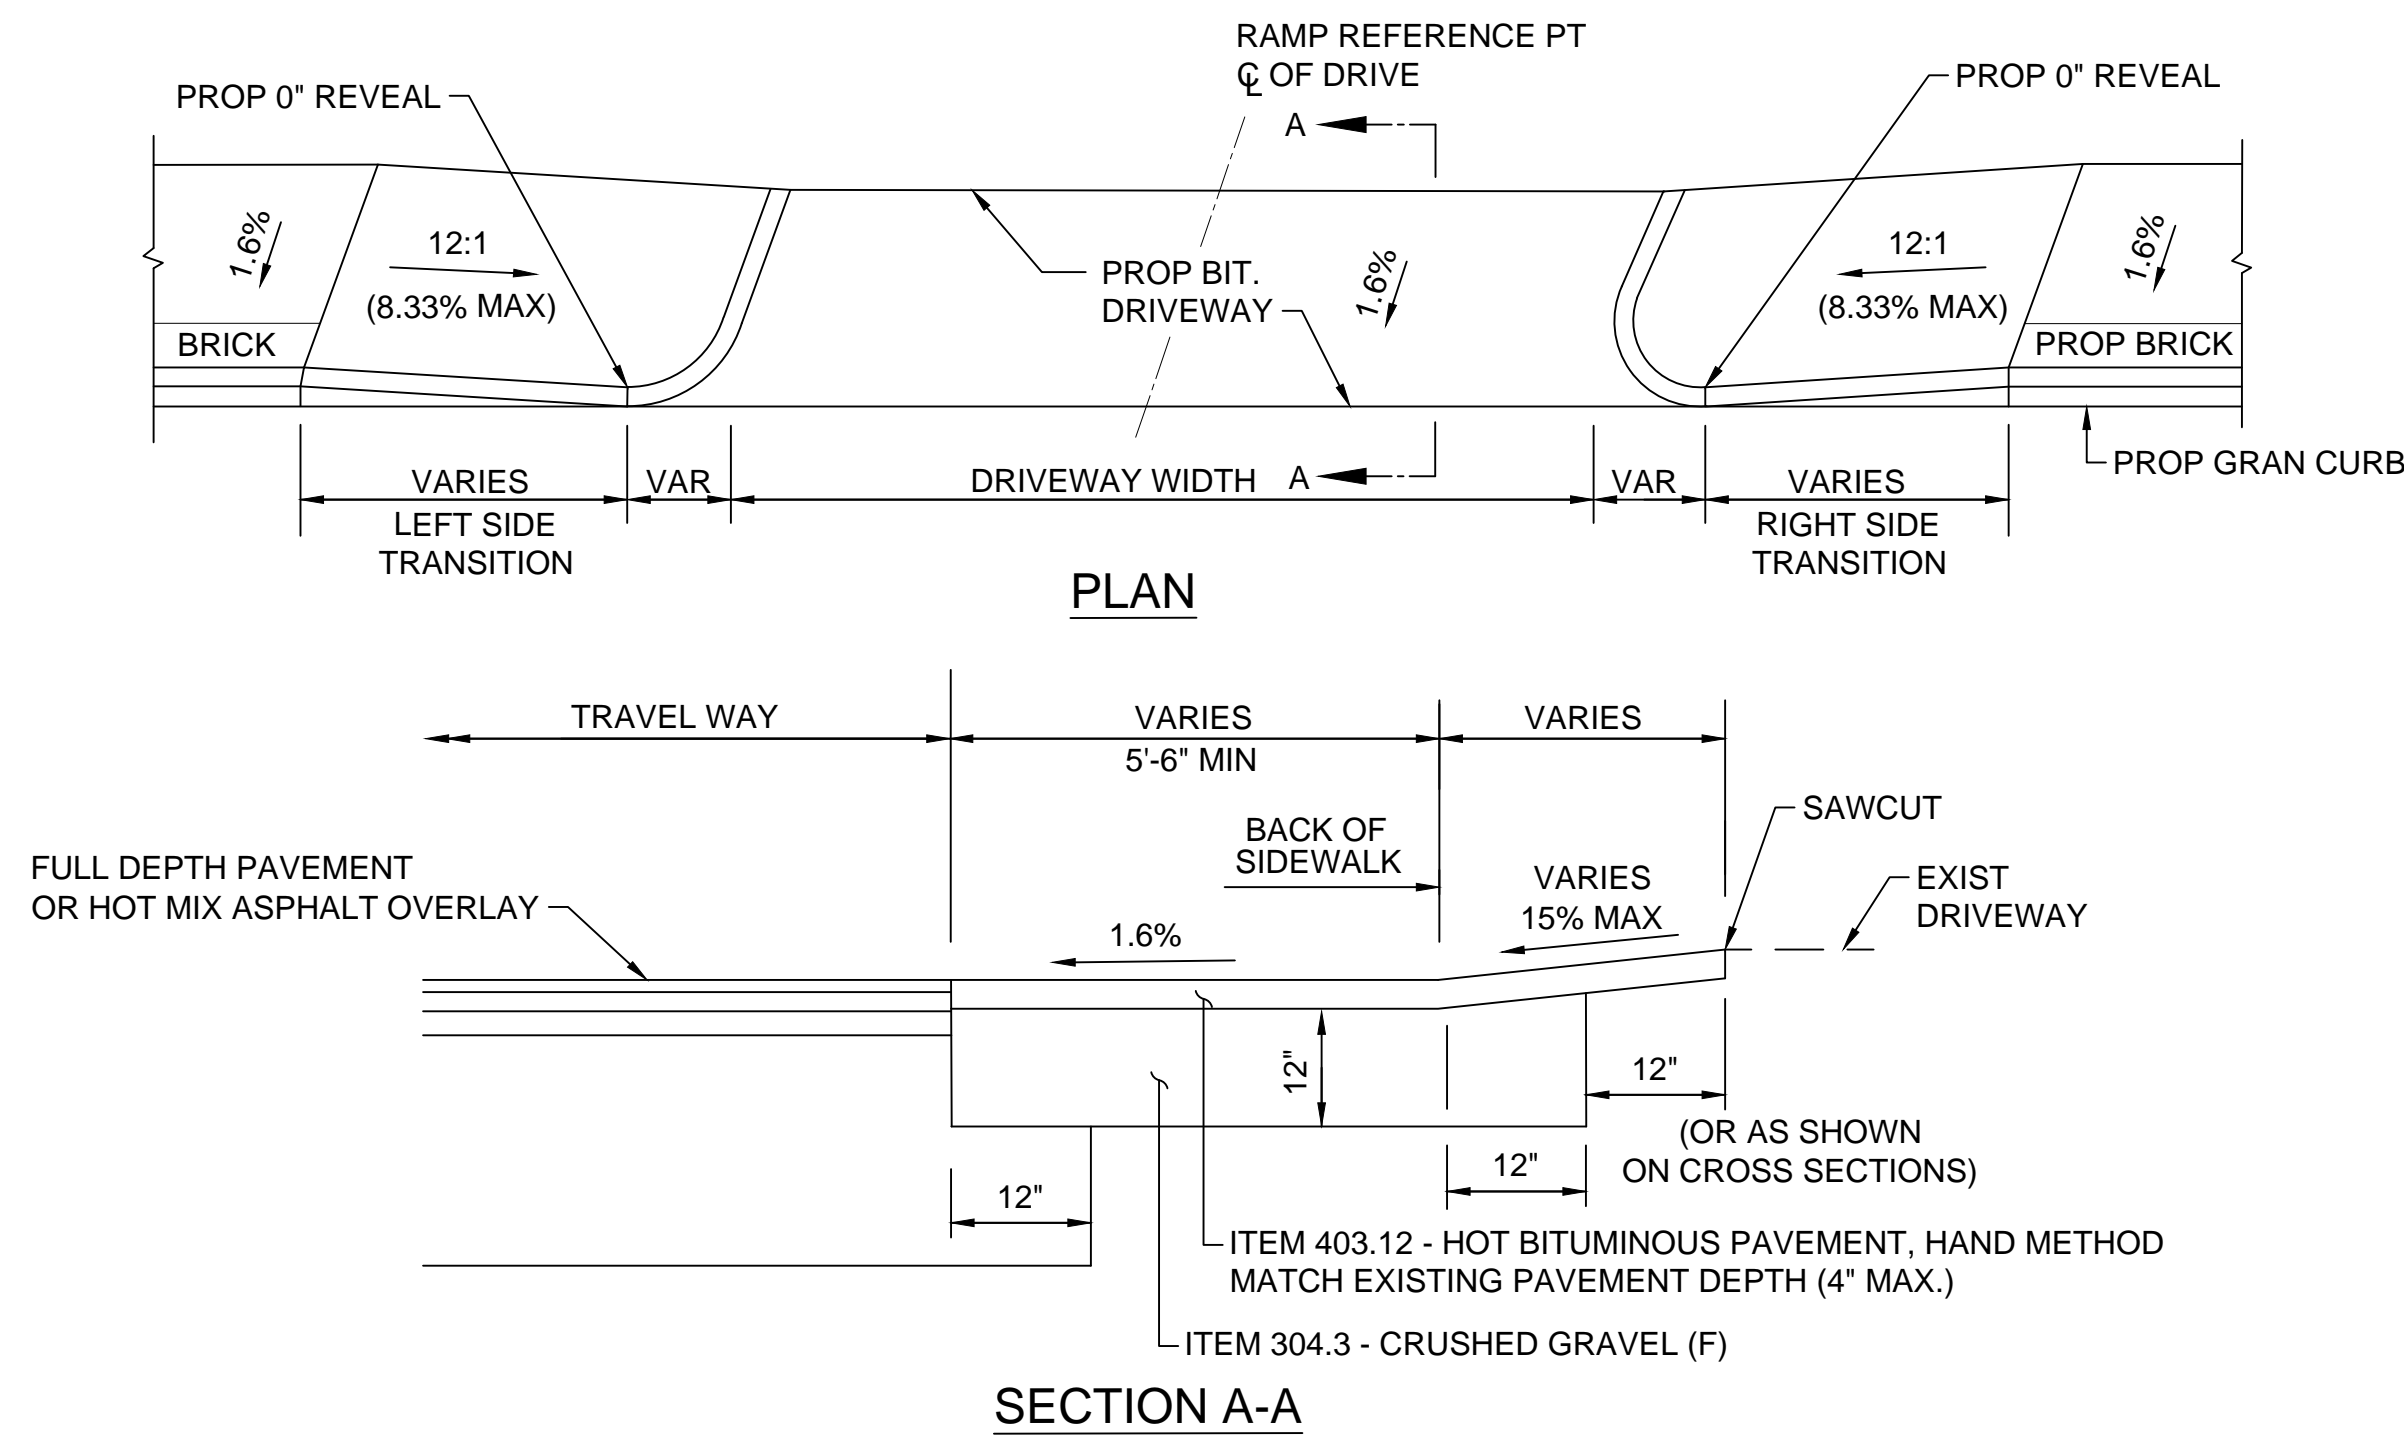

TYPICAL BITUMINOUS DRIVEWAY WITH SIDEWALK AND GRANITE TRANSITION CURB DETAIL C

SCALE: NTS

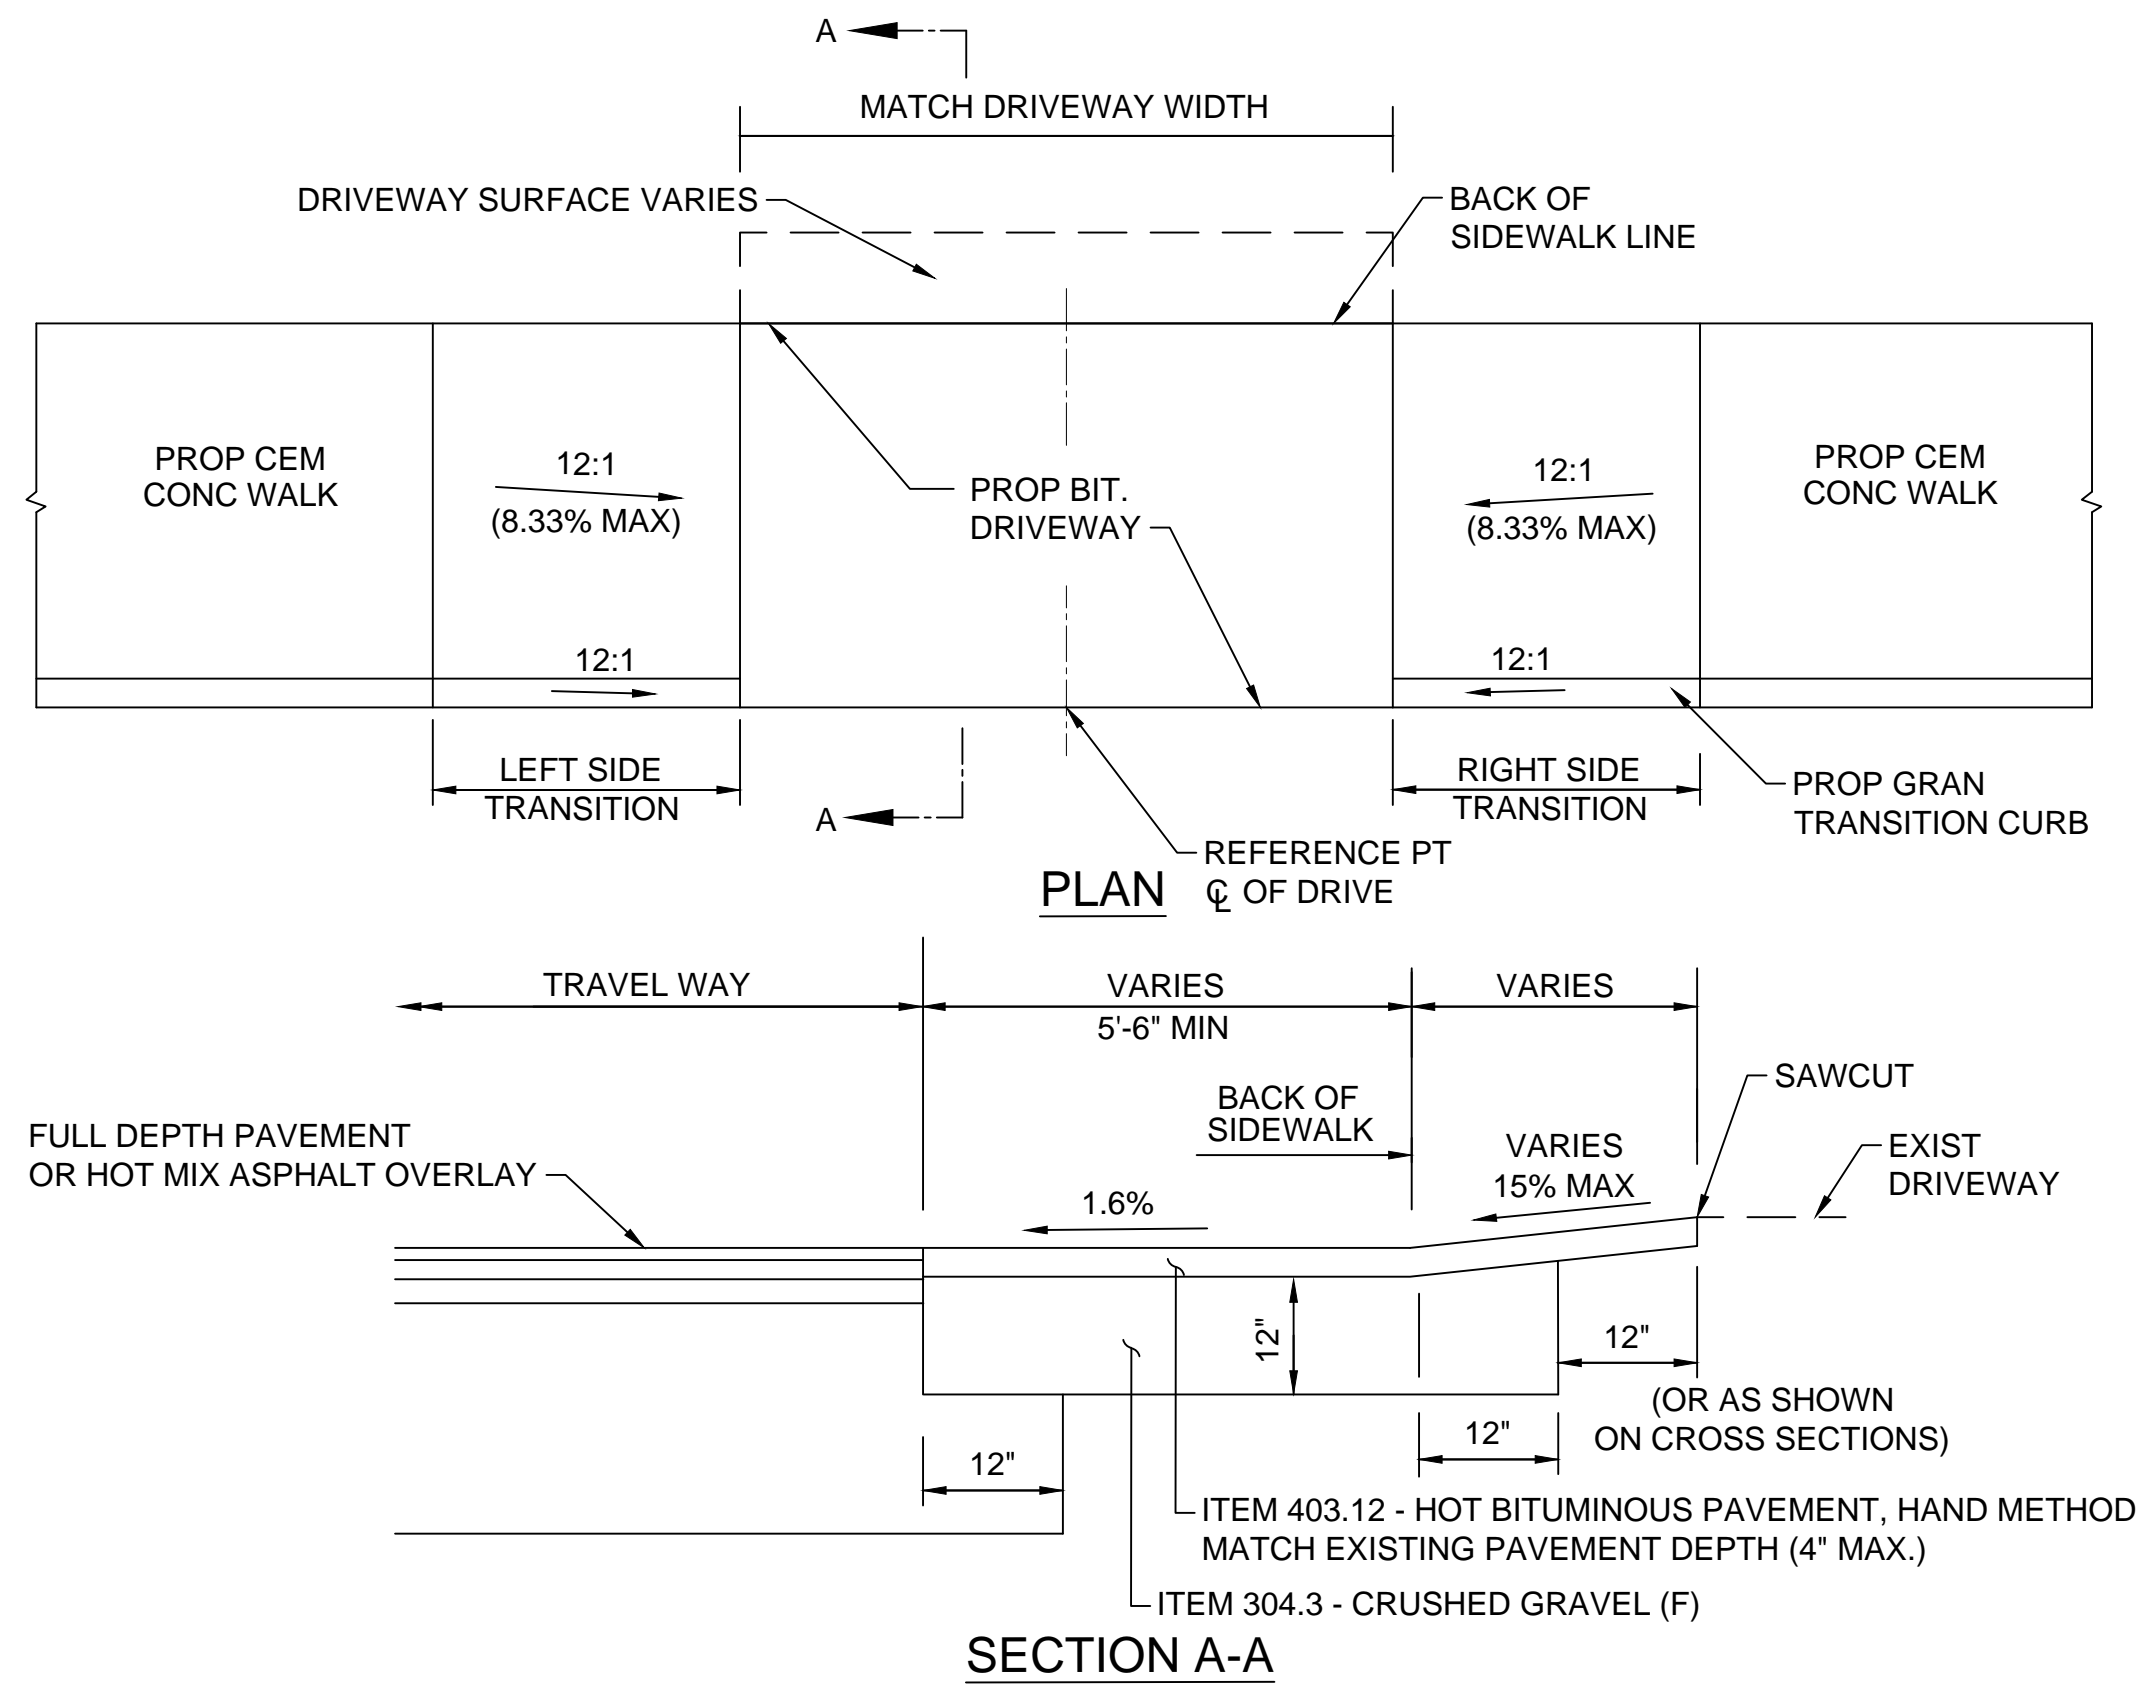

TYPICAL BITUMINOUS DRIVEWAY WITH SIDEWALK AND GRANITE TRANSITION CURB DETAIL D

SCALE: NTS

NOTE:

ALL SIDEWALK TRANSITION RAMPS SHALL BE 6" REINFORCED CONCRETE SIDEWALK

SIDEWALK RAMP DETAIL DRIVEWAY C TABLE

NO.	LOCATION	SIDEWALK WIDTH	DRIVEWAY WIDTH	LEFT SIDE TRANS LENGTH	RIGHT SIDE TRANS LENGTH	OPENING ELEVATION
2	STA. 102+33.00 15.00' RT	5'-0"	24'-0"	7'-0"	7'-0"	30.78'
29	STA. 115+28.00 24.00' LT	5'-0"	24'-0"	8'-0"	7'-0"	19.76'
52	STA. 126+65.00 12.00' LT	5'-0"	16'-0"	8'-0"	7'-0"	20.90'
54	STA. 127+26.00 12.00' LT	5'-0"	23'-6"	8'-0"	7'-0"	20.13'
57	STA. 127+86.00 12.00' LT	VARIES	24'-0"	7'-0"	7'-0"	19.52'

SIDEWALK RAMP DETAIL DRIVEWAY D TABLE

NO.	LOCATION	SIDEWALK WIDTH	DRIVEWAY WIDTH	LEFT SIDE TRANS LENGTH	RIGHT SIDE TRANS LENGTH	OPENING ELEVATION
31	STA. 116+82.00 24.00' LT	5'-0"	26'-0"	9'-2"	7'-0"	16.94'
34	STA. 118+85.00 28.00' LT	5'-0"	12'-6"	9'-2"	7'-0"	12.32'
35	STA. 119+21.00 26.00' LT	5'-0"	20'-0"	9'-2"	7'-0"	11.51'
39	STA. 120+89.50 13.75' RT	5'-0"	25'-0"	11'-0"	7'-0"	12.43'
40	STA. 121+43.00 12.75' RT	5'-0"	25'-0"	11'-0"	7'-0"	14.02'
41	STA. 121+42.00 24.25' LT	VARIES	30'-9"	7'-0"	11'-0"	13.76'
42	STA. 122+12.00 12.00' RT	5'-0"	41'-6"	N/A	7'-0"	16.30'
47	STA. 124+06.00 12.00' RT	5'-0"	29'-2"	7'-0"	7'-0"	19.90'
49	STA. 124+89.00 12.00' RT	5'-0"	30'-8"	7'-0"	7'-0"	20.48'
53	STA. 126+68.00 19.00' RT	5'-0"	17'-3"	7'-0"	8'-0"	20.75'
55	STA. 127+39.00 19.00' RT	5'-0"	14'-0"	8'-0"	7'-0"	19.97'
56	STA. 128+04.00 19.00' RT	5'-6"	14'-6"	7'-0"	7'-0"	19.54'
64	STA. 24+15.00 13.50' LT	VARIES	27'-9"	7'-0"	8'-0"	19.51'
74	STA. 31+43.00 11.00' LT	6'-0"	9'-8"	N/A	7'-0"	17.17'
80	STA. 130+59.00 12.00' LT	VARIES	22'-10"	7'-0"	13'-6"	24.93'
81	STA. 131+03.00 12.00' LT	VARIES	16'-0"	7'-0"	13'-6"	27.04'
83	STA. 130+88.00 19.00' RT	VARIES	10'-0"	13'-6"	7'-0"	26.03'



DATE PLOTTED
13-Nov-18

VHB PROJECT NO.
52393.00

DRAWING
DET_WCR-Seg1

CITY PROJECT NO.
7176

SHEET NO.
13




TOTAL SHEETS
88

ISLINGTON STREET CORRIDOR IMPROVEMENTS - SEGMENT 1


CITY OF PORTSMOUTH, NEW HAMPSHIRE

DETAILS

SDR PROCESSED	VHB	DATE	OCT 2017
NEW DESIGN	KMH	DATE	1/7/19
SHEET CHECKED	GLB	DATE	1/7/19
AS BUILT DETAILS		DATE	

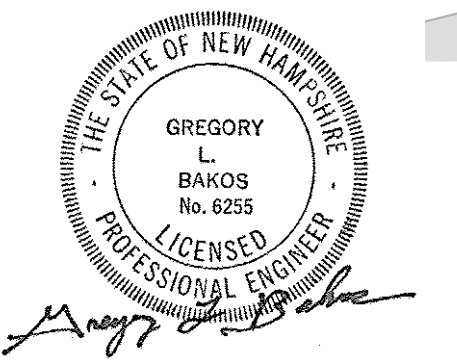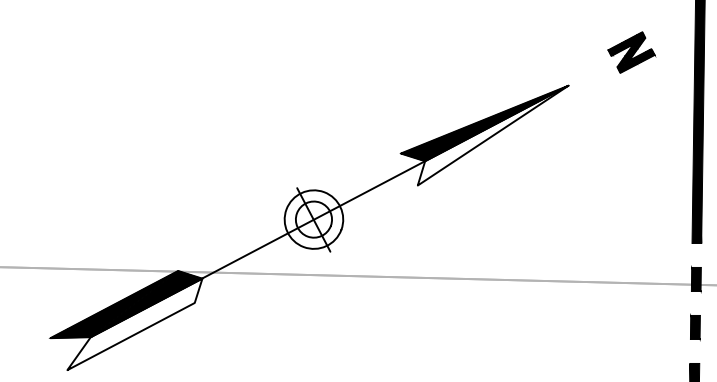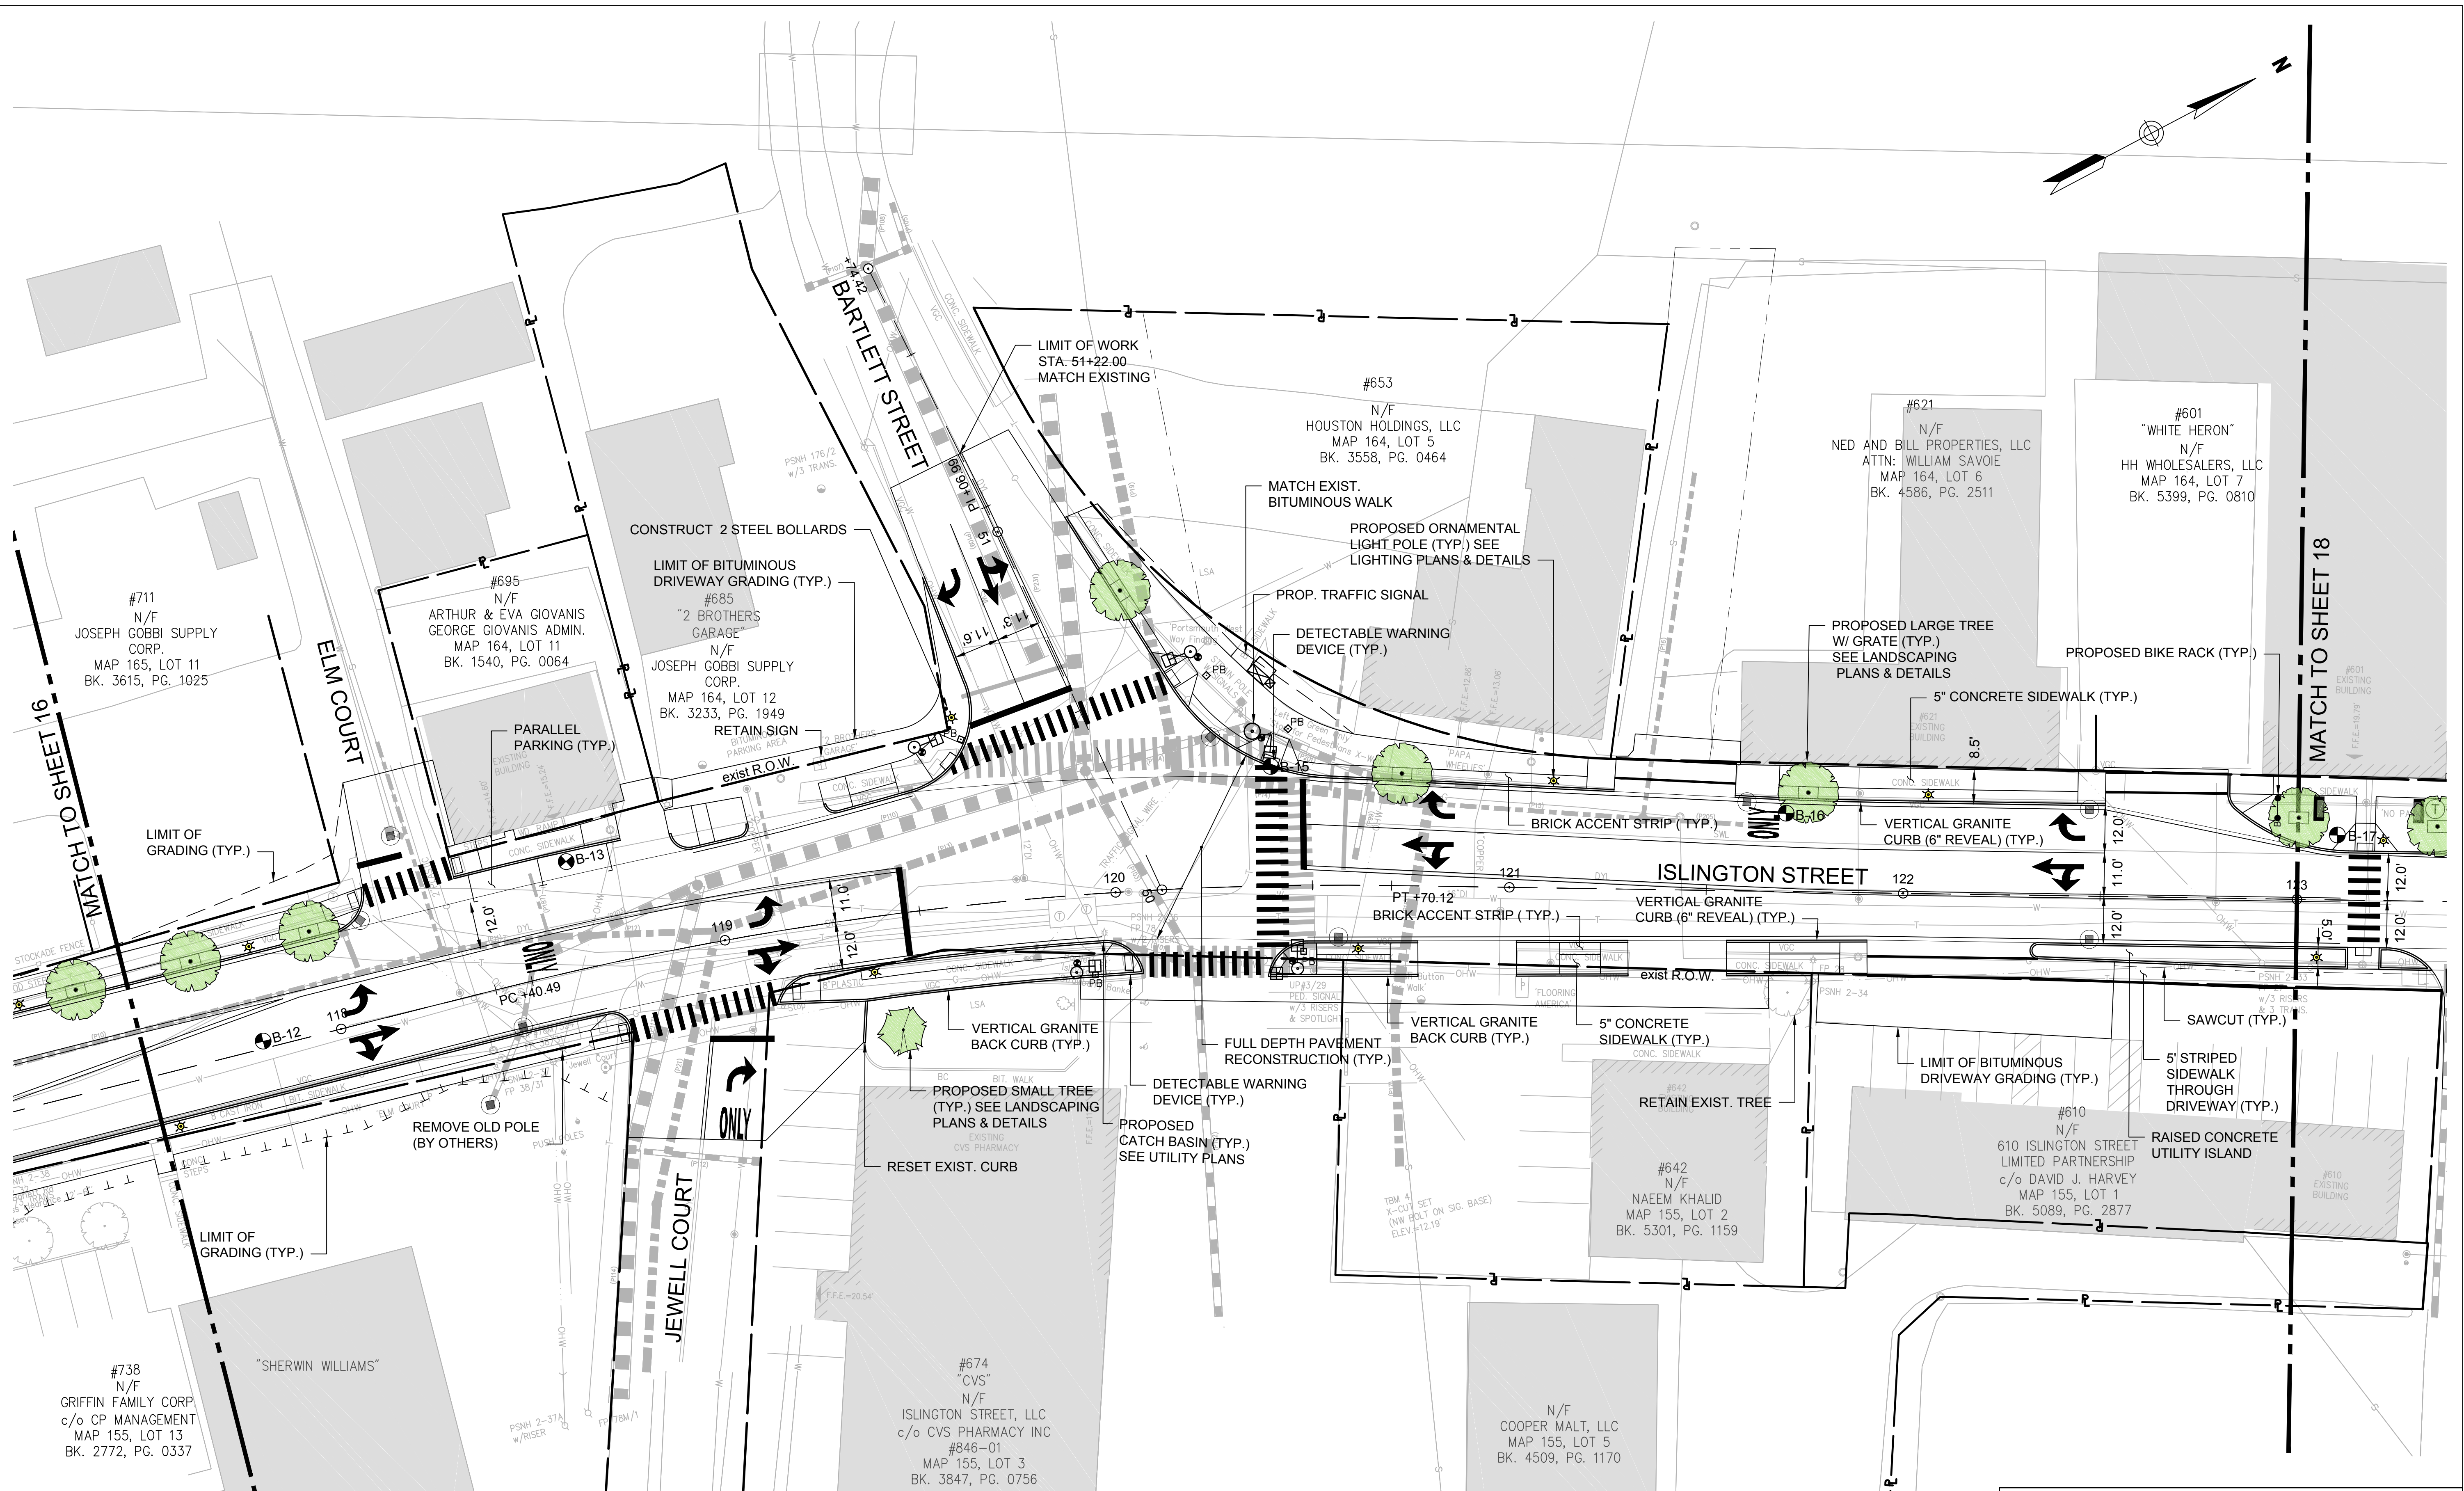


ISLINGTON STREET CORRIDOR IMPROVEMENTS - SEGMENT 1					
CITY OF PORTSMOUTH, NEW HAMPSHIRE					
GENERAL PLAN					
DATE PLOTTED	VHB PROJECT NO.	DRAWING	CITY PROJECT NO.	SHEET NO.	TOTAL SHEETS
7-Jan-19	52393.00	GEN-Seg1	7176	17	88

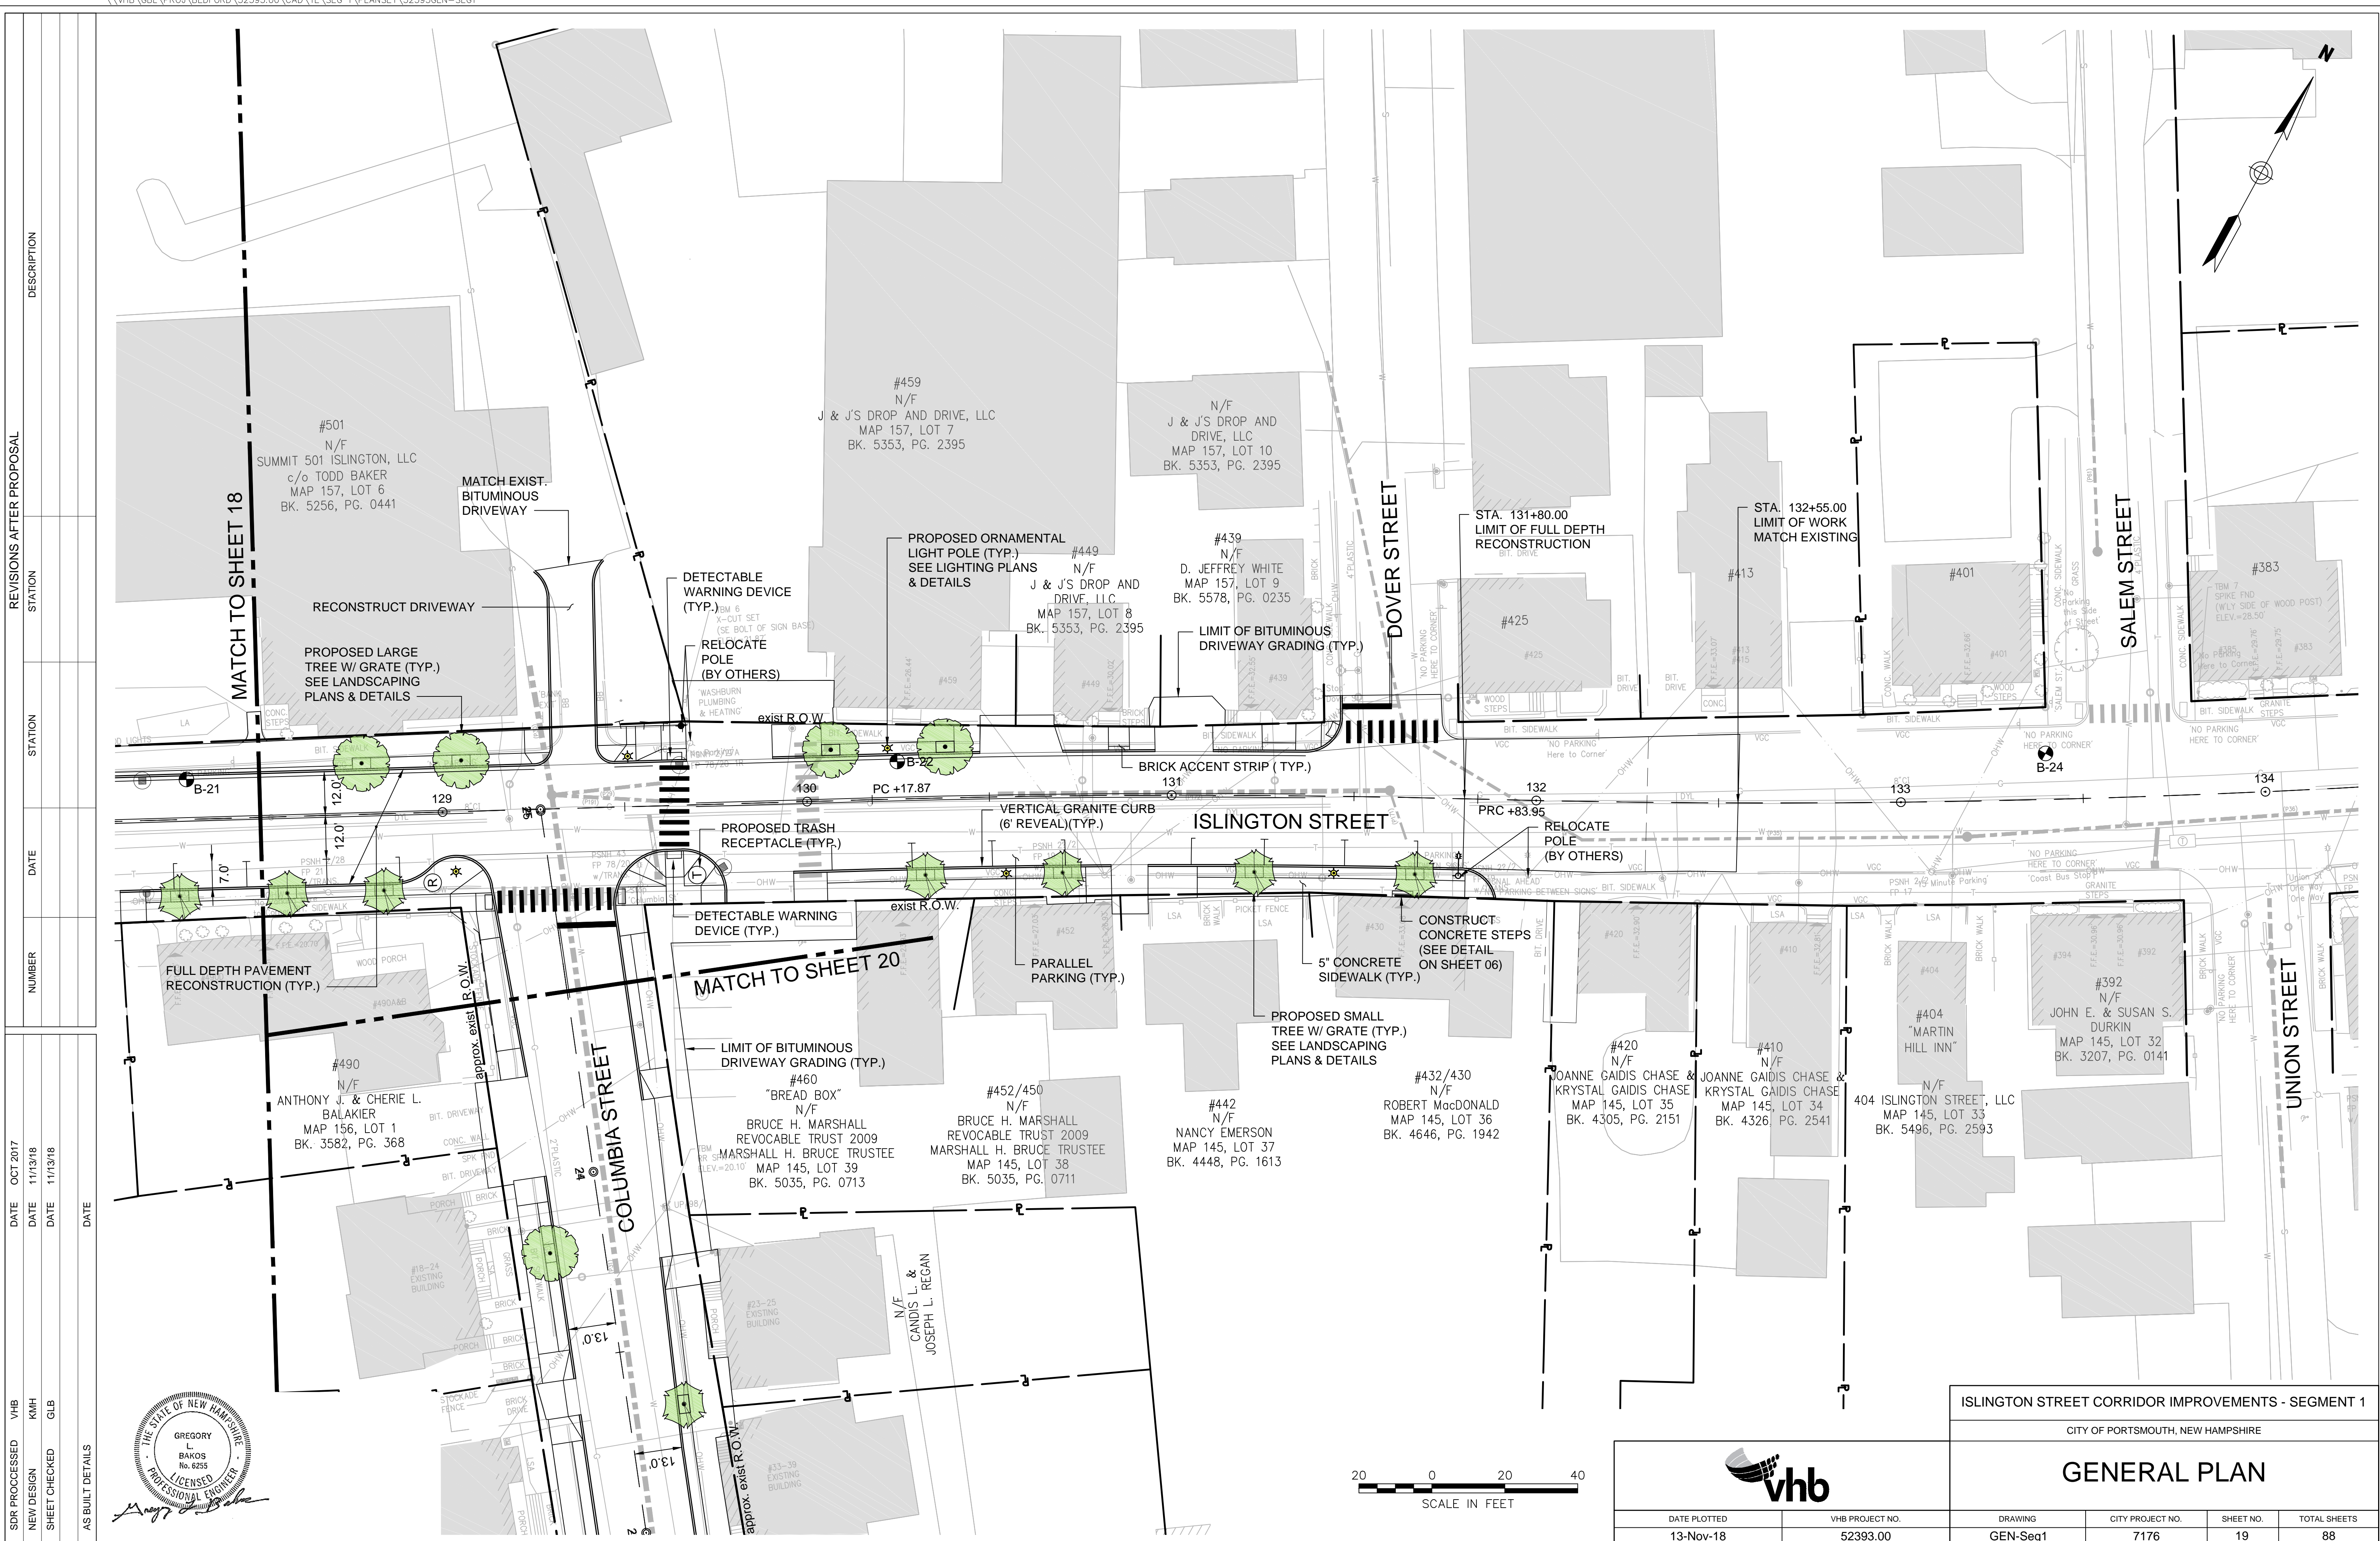

REVISIONS AFTER PROPOSAL	STATION	DATE	NUMBER	DESCRIPTION

SDR PROCESSED	VHB	DATE	OCT 2017
NEW DESIGN	KMH	DATE	11/13/18
SHEET CHECKED	GLB	DATE	11/13/18
AS BUILT DETAILS		DATE	

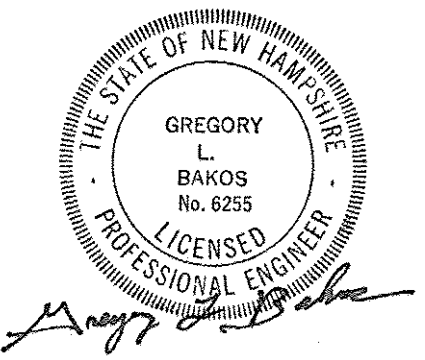

ISLINGTON STREET CORRIDOR IMPROVEMENTS - SEGMENT 1
CITY OF PORTSMOUTH, NEW HAMPSHIRE




GENERAL PLAN

DATE PLOTTED	VHB PROJECT NO.	DRAWING	CITY PROJECT NO.	SHEET NO.	TOTAL SHEETS
13-Nov-18	52393.00	GEN-Seg1	7176	19	88



REVISIONS AFTER PROPOSAL		STATION	DESCRIPTION

SDR PROCESSED	VHB	DATE	OCT 2017
NEW DESIGN	KMH	DATE	11/13/18
SHEET CHECKED	GLB	DATE	11/13/18
AS BUILT DETAILS		DATE	

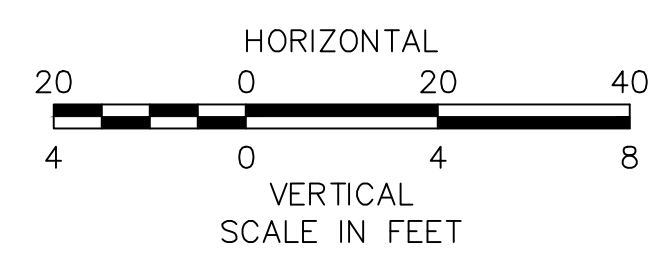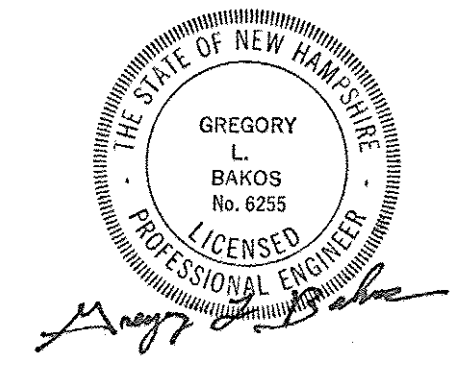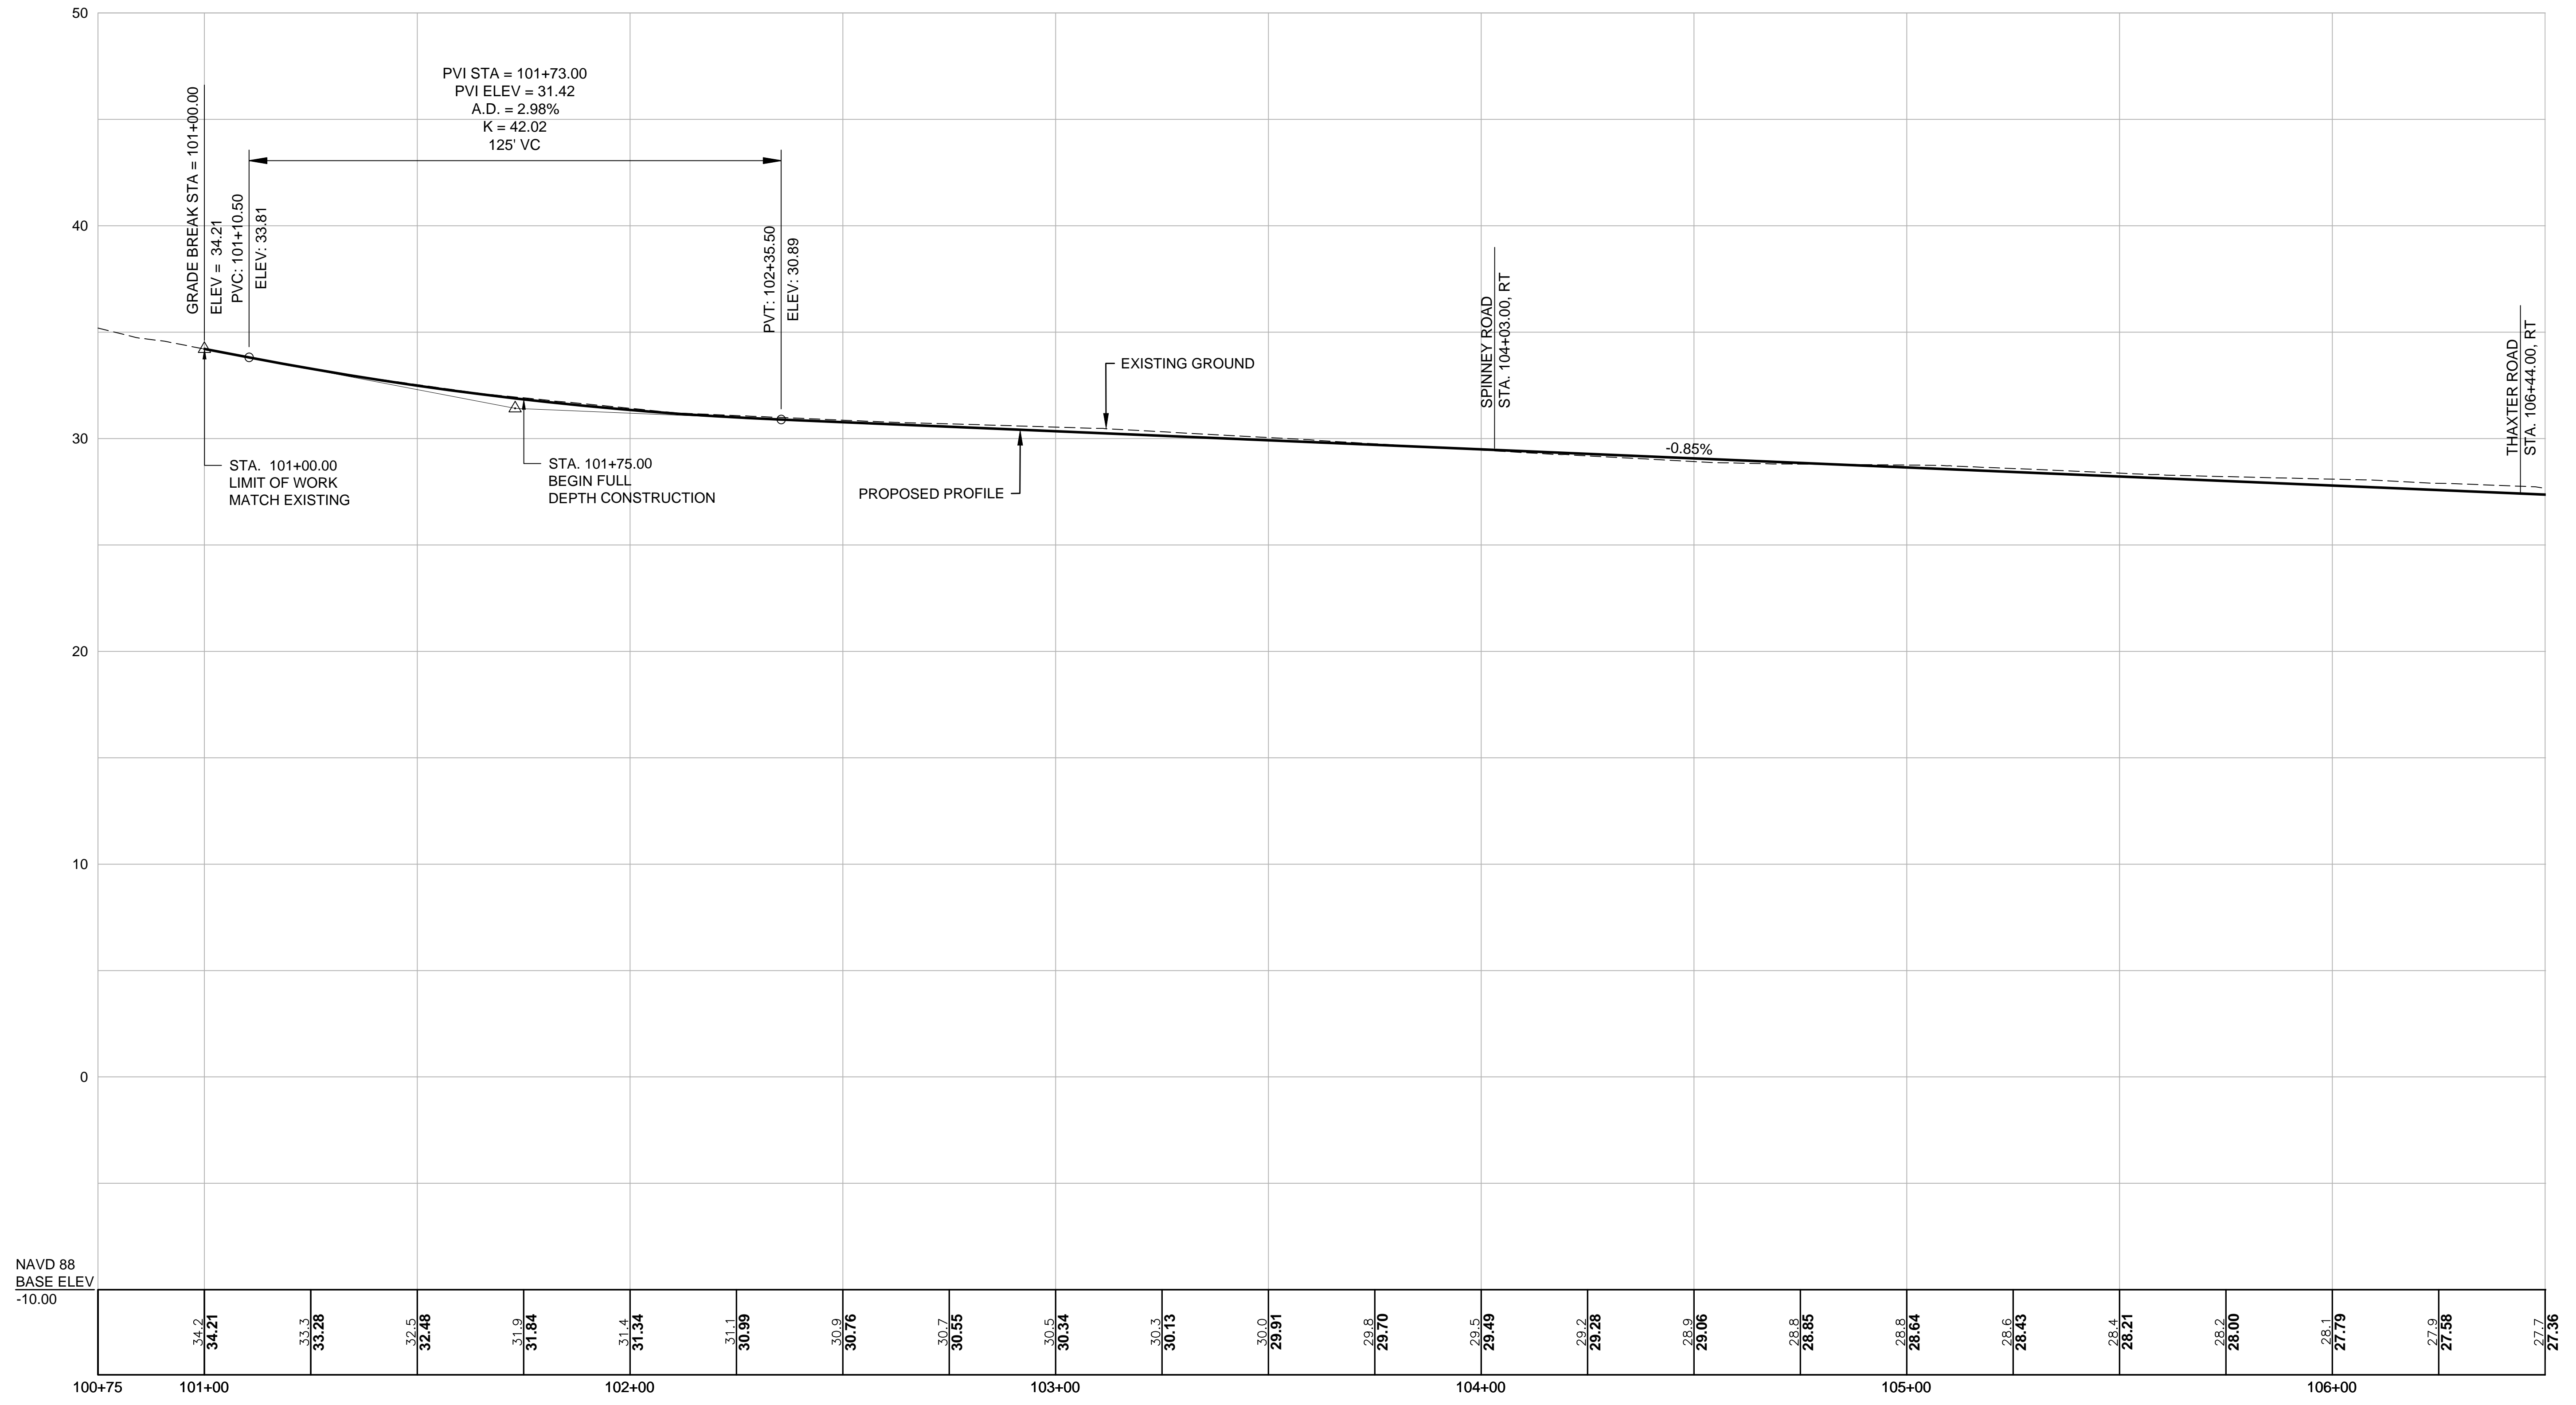


DATE PLOTTED	VHB PROJECT NO.
13-Nov-18	52393.00

ISLINGTON STREET CORRIDOR IMPROVEMENTS - SEGMENT 1			
CITY OF PORTSMOUTH, NEW HAMPSHIRE			
PROFILE			
DRAWING	CITY PROJECT NO.	SHEET NO.	TOTAL SHEETS
PRO-Seg1	7176	21	88




REVISIONS AFTER PROPOSAL

STATION	DESCRIPTION

NUMBER	DATE	STATION	DESCRIPTION

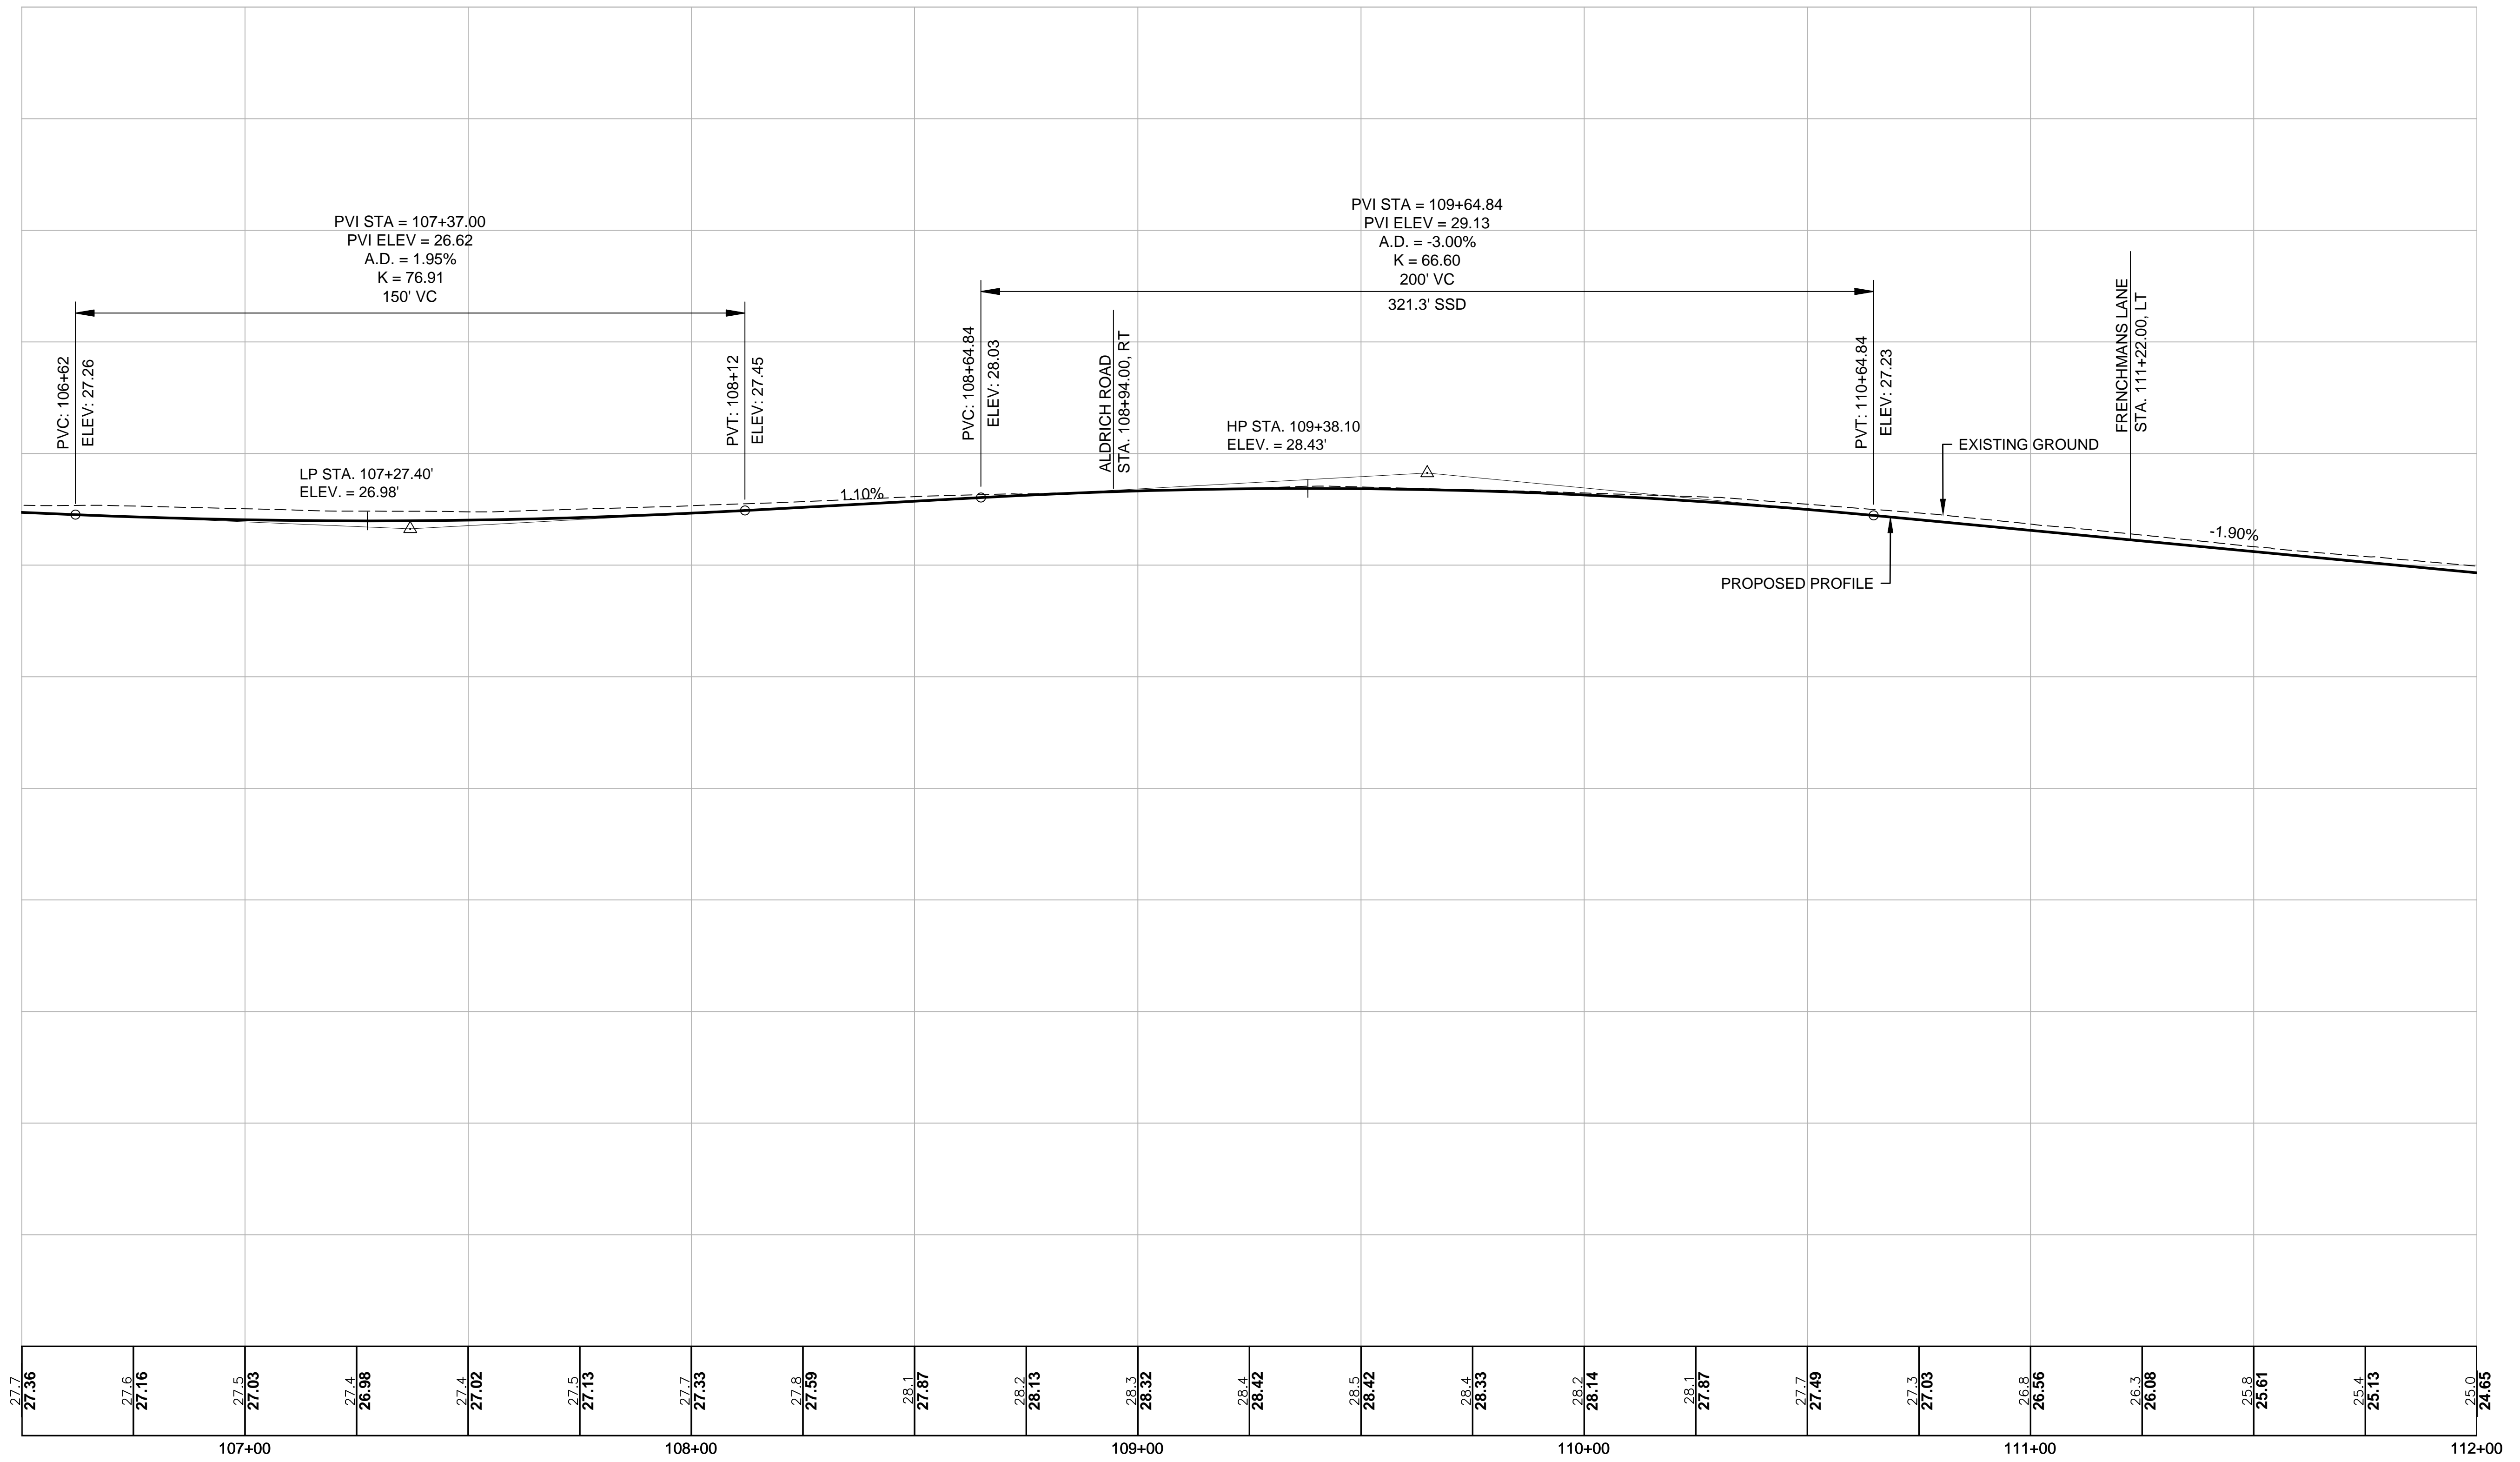

SDR PROCESSED	DATE
VHB	OCT 2017
NEW DESIGN	DATE
KMH	11/13/18
SHEET CHECKED	DATE
GLB	11/13/18
AS BUILT DETAILS	DATE


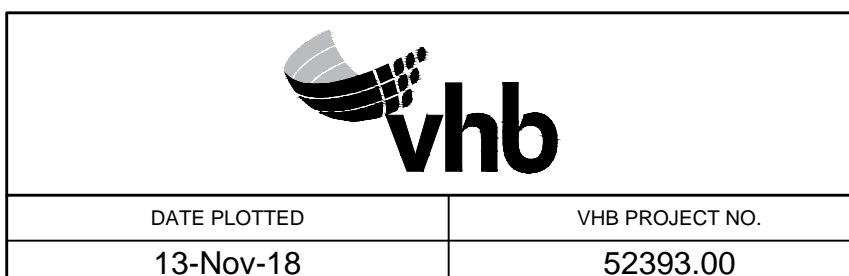
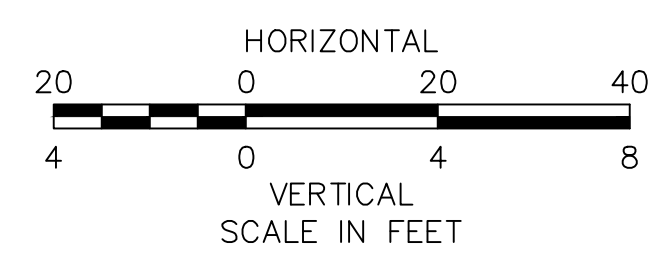
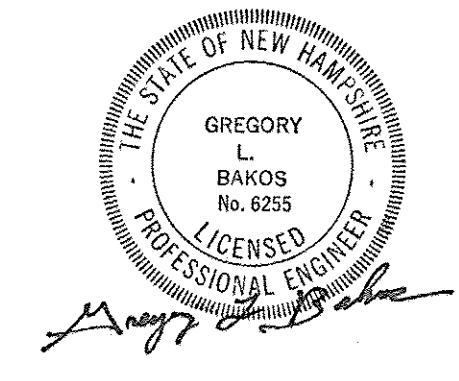


ISLINGTON STREET CORRIDOR IMPROVEMENTS - SEGMENT 1					
CITY OF PORTSMOUTH, NEW HAMPSHIRE					
PROFILE					
DATE PLOTTED	VHB PROJECT NO.	DRAWING	CITY PROJECT NO.	SHEET NO.	TOTAL SHEETS
13-Nov-18	52393.00	PRO-Seg1	7176	22	88

REVISIONS AFTER PROPOSAL

STATION	DESCRIPTION





NUMBER	DATE	STATION	DESCRIPTION

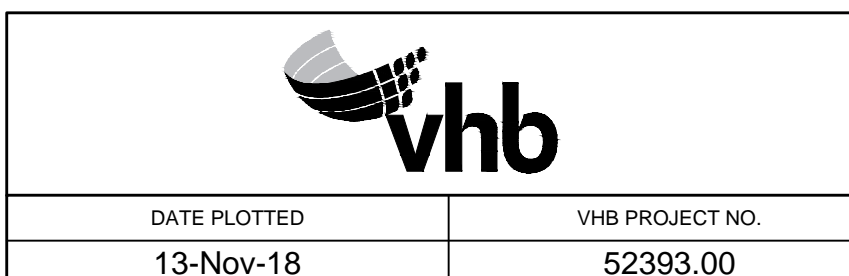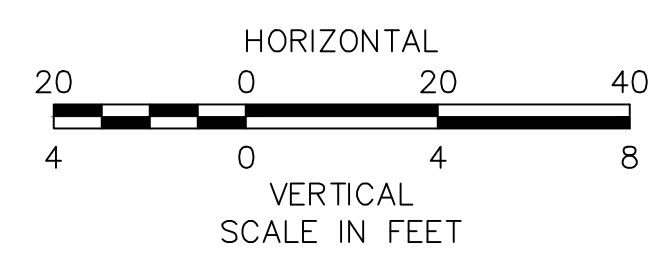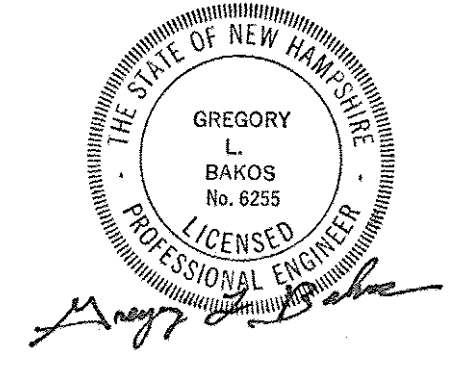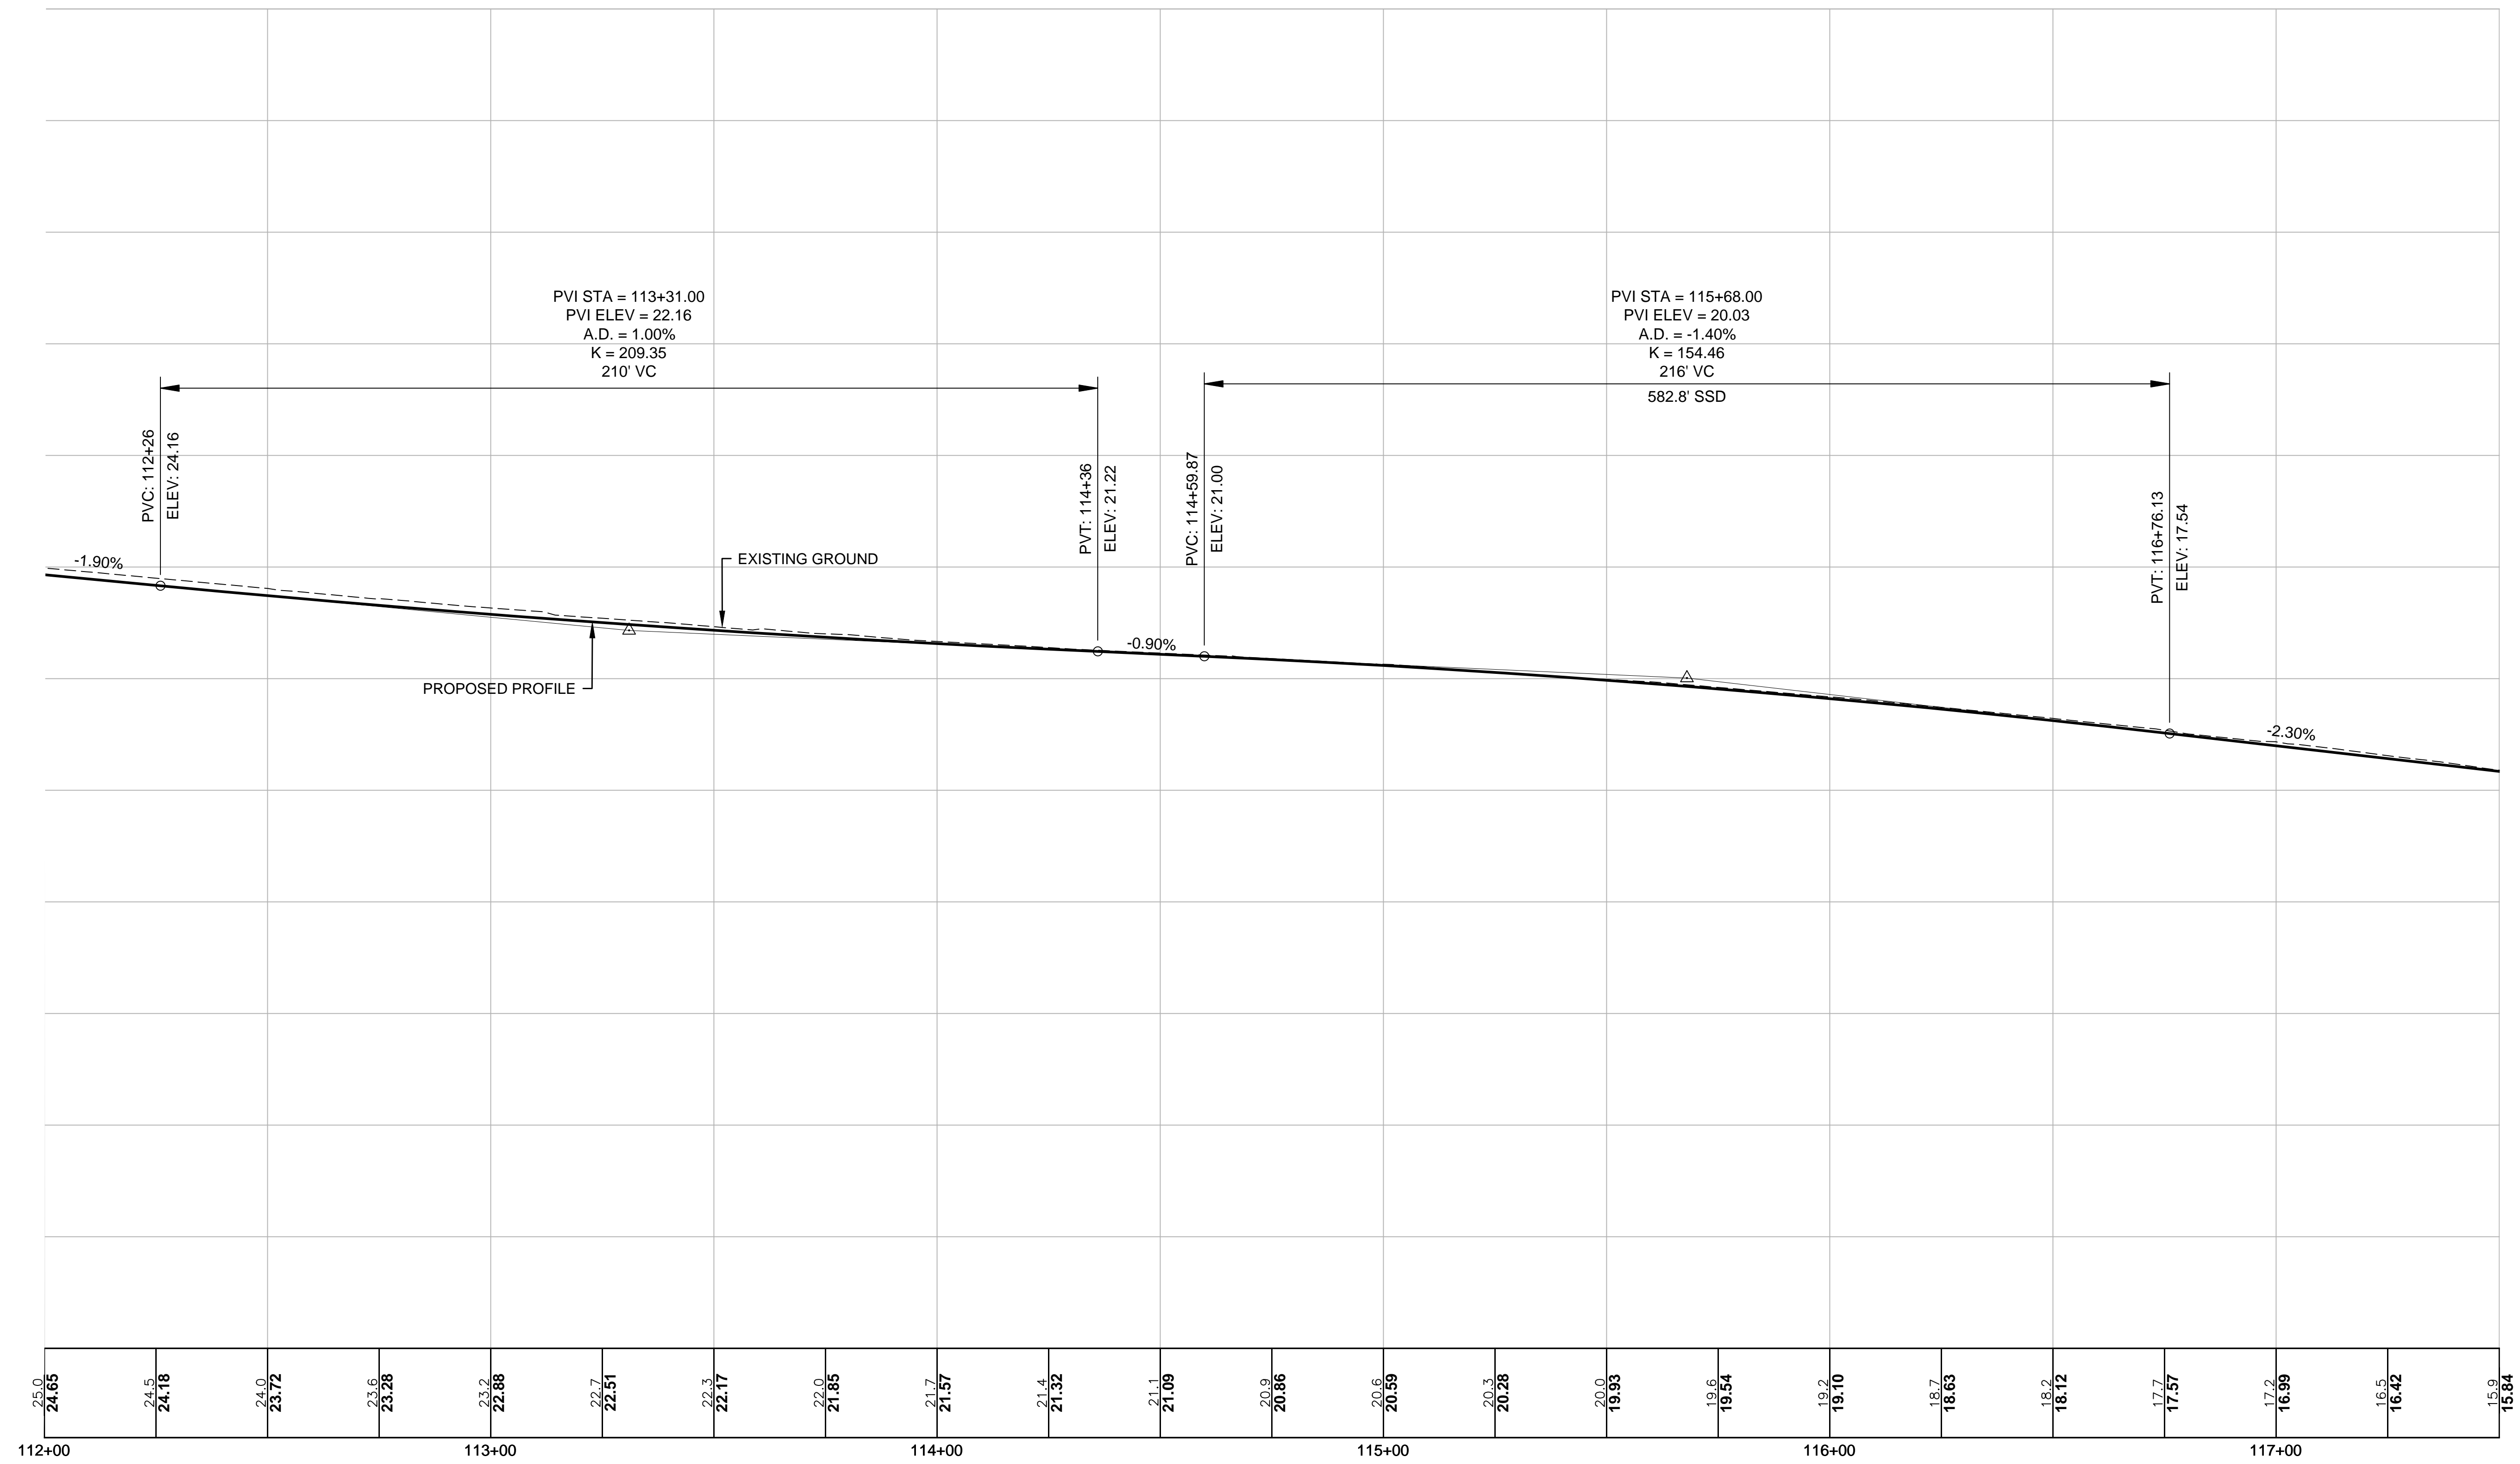

ISLINGTON STREET CORRIDOR IMPROVEMENTS - SEGMENT 1					
CITY OF PORTSMOUTH, NEW HAMPSHIRE					
PROFILE					
DATE PLOTTED	VHB PROJECT NO.	DRAWING	CITY PROJECT NO.	SHEET NO.	TOTAL SHEETS
13-Nov-18	52393.00	PRO-Seg1	7176	23	88

REVISIONS AFTER PROPOSAL		STATION	DESCRIPTION

SDR PROCESSED	VHB	DATE	OCT 2017
NEW DESIGN	KMH	DATE	11/13/18
SHEET CHECKED	GLB	DATE	11/13/18
AS BUILT DETAILS		DATE	

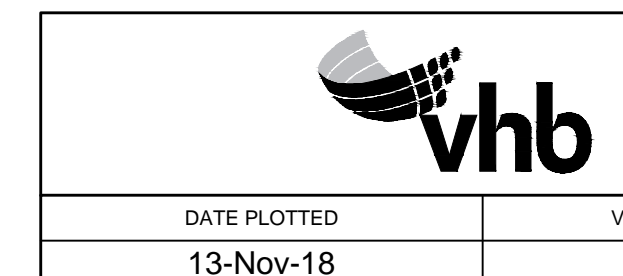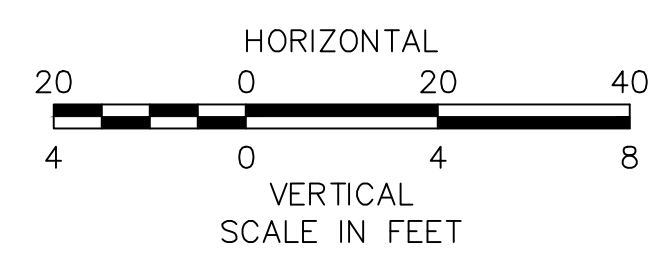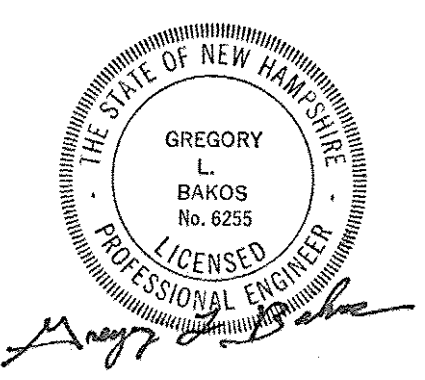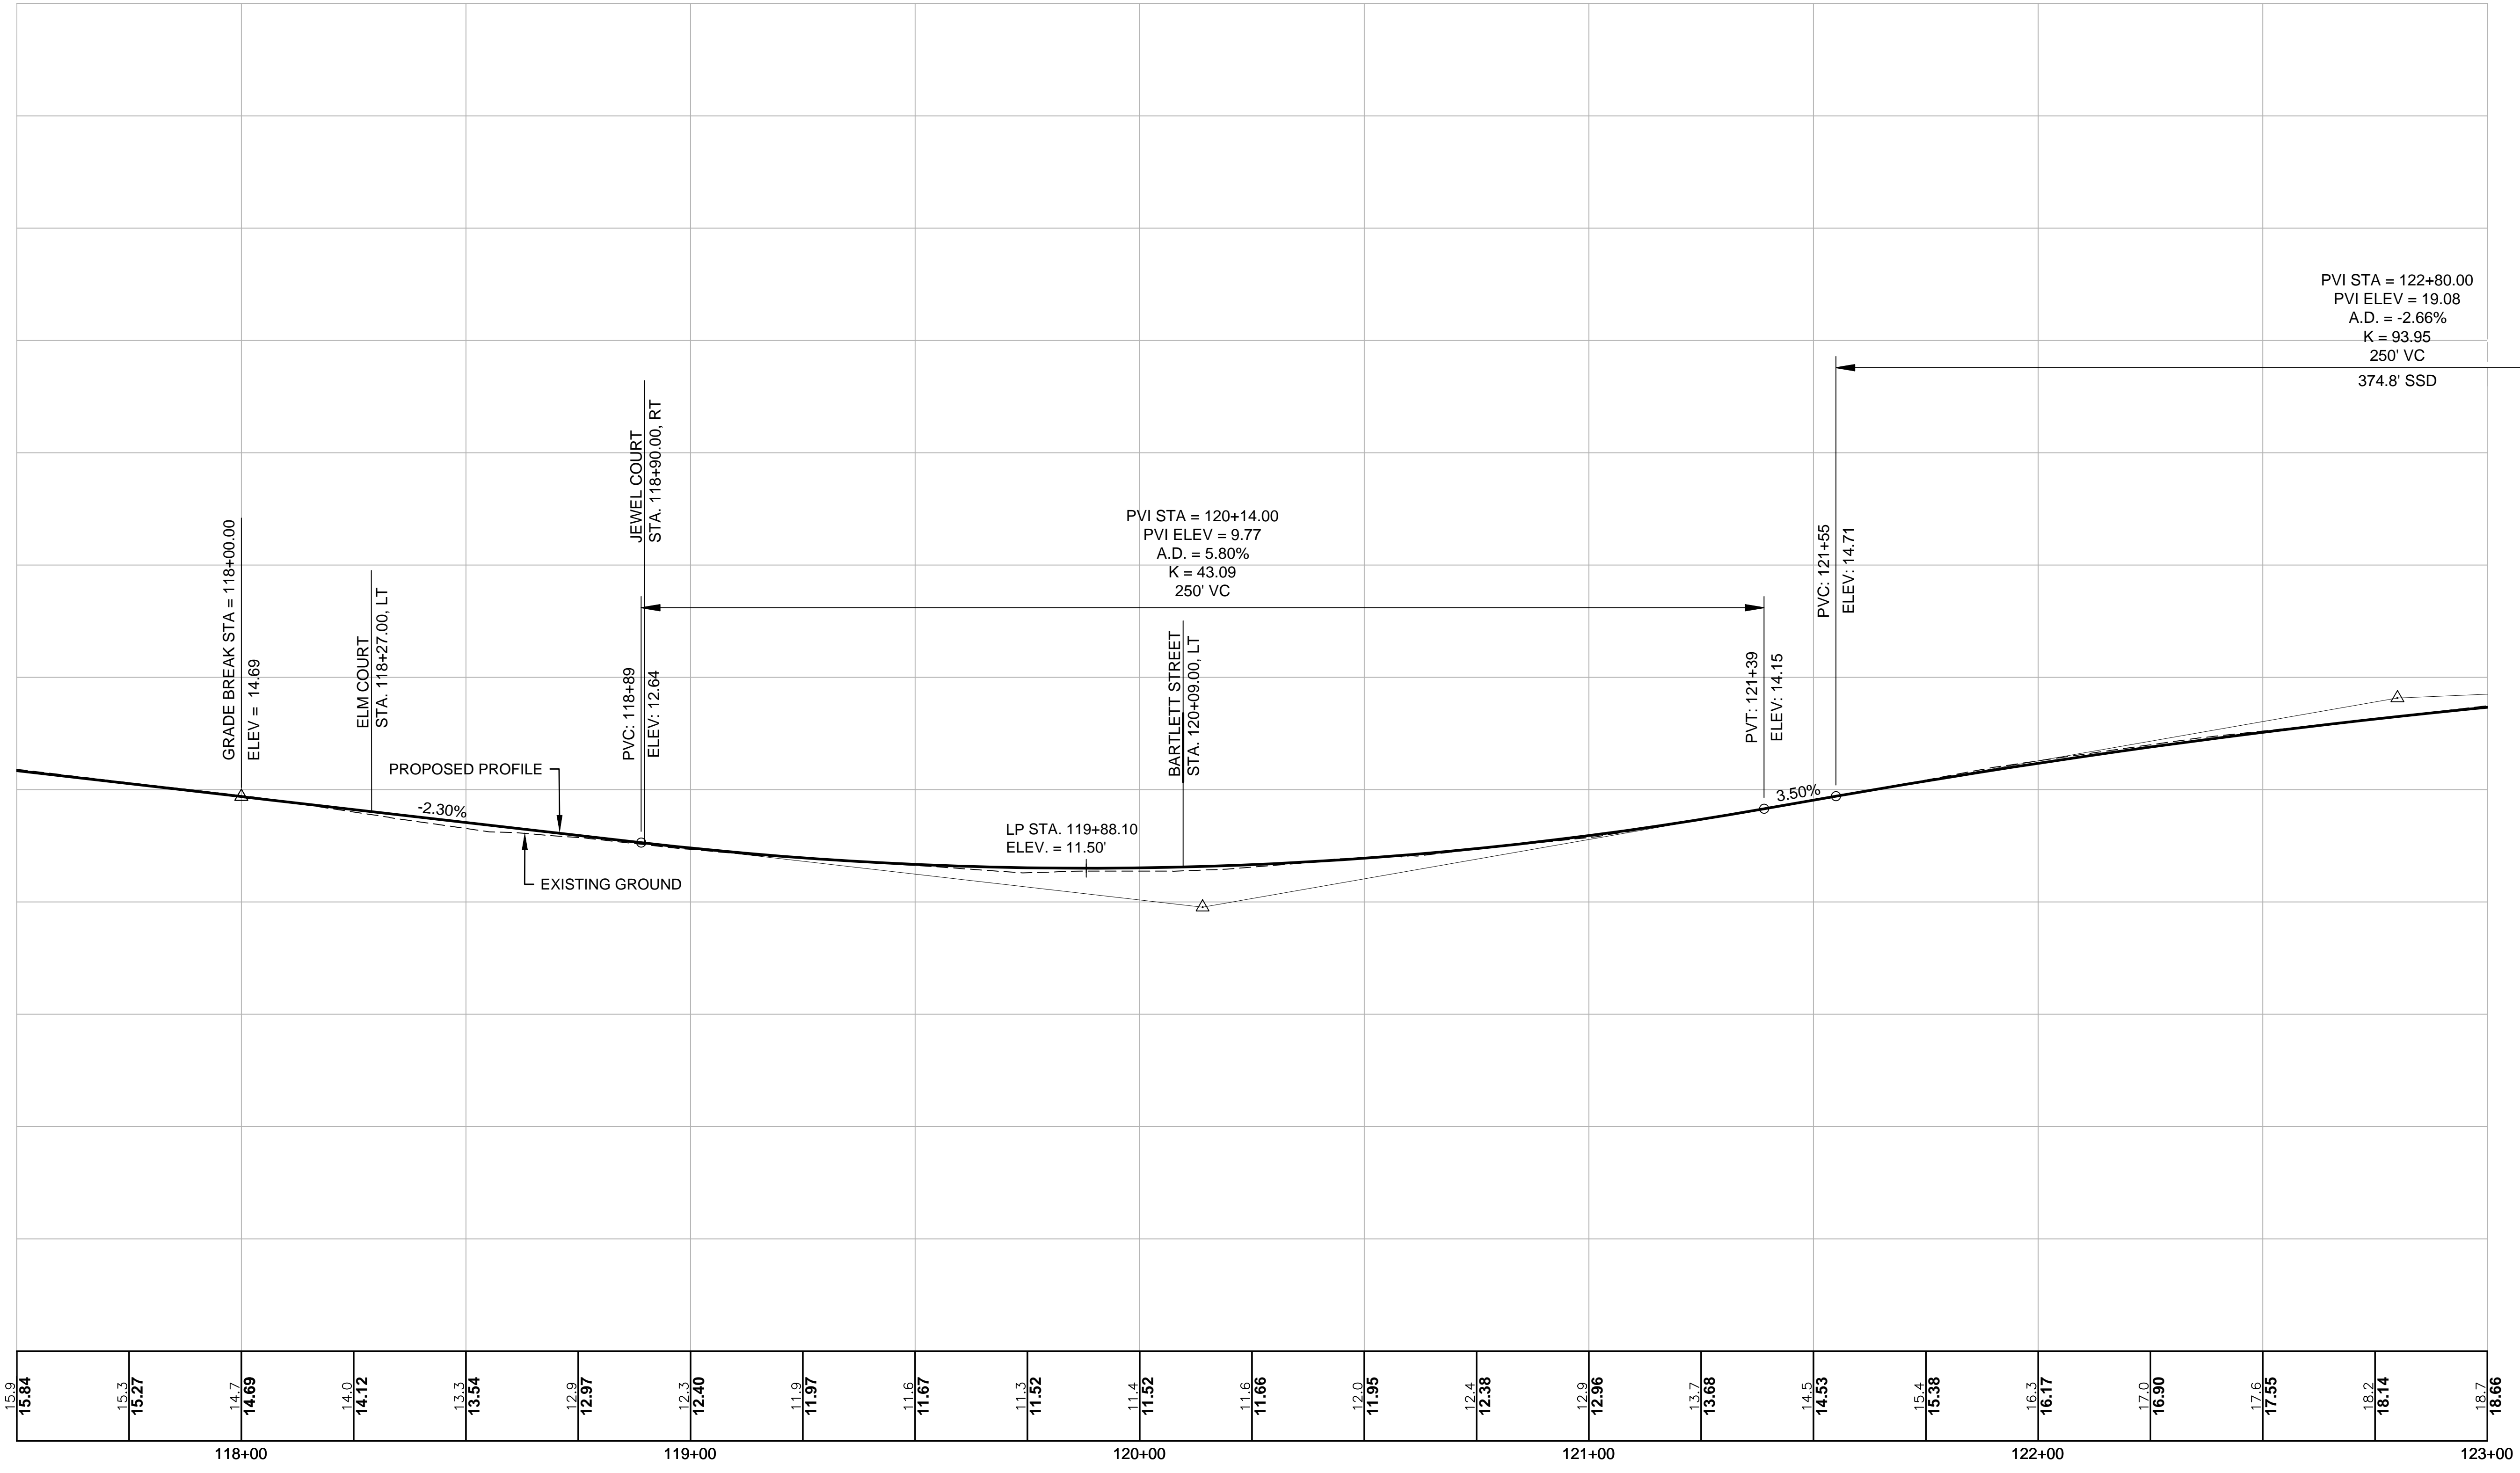

DATE PLOTTED	VHB PROJECT NO.	DRAWING	CITY PROJECT NO.	SHEET NO.	TOTAL SHEETS
13-Nov-18	52393.00	PRO-Seg1	7176	24	88

ISLINGTON STREET CORRIDOR IMPROVEMENTS - SEGMENT 1
CITY OF PORTSMOUTH, NEW HAMPSHIRE




PROFILE

REVISIONS AFTER PROPOSAL

STATION	DESCRIPTION

NUMBER	DATE	STATION	DESCRIPTION

SDR PROCESSED	DATE
VHB	OCT 2017
NEW DESIGN	DATE
KMH	11/13/18
SHEET CHECKED	DATE
GLB	11/13/18
AS BUILT DETAILS	DATE

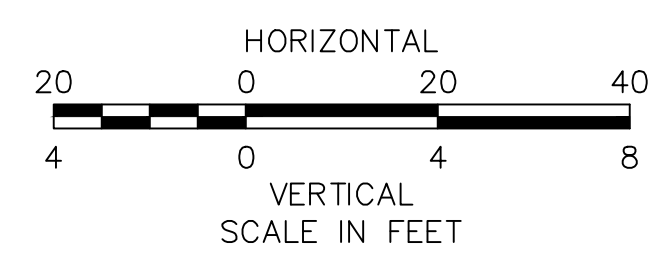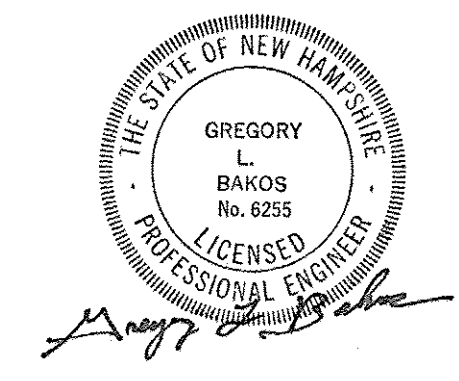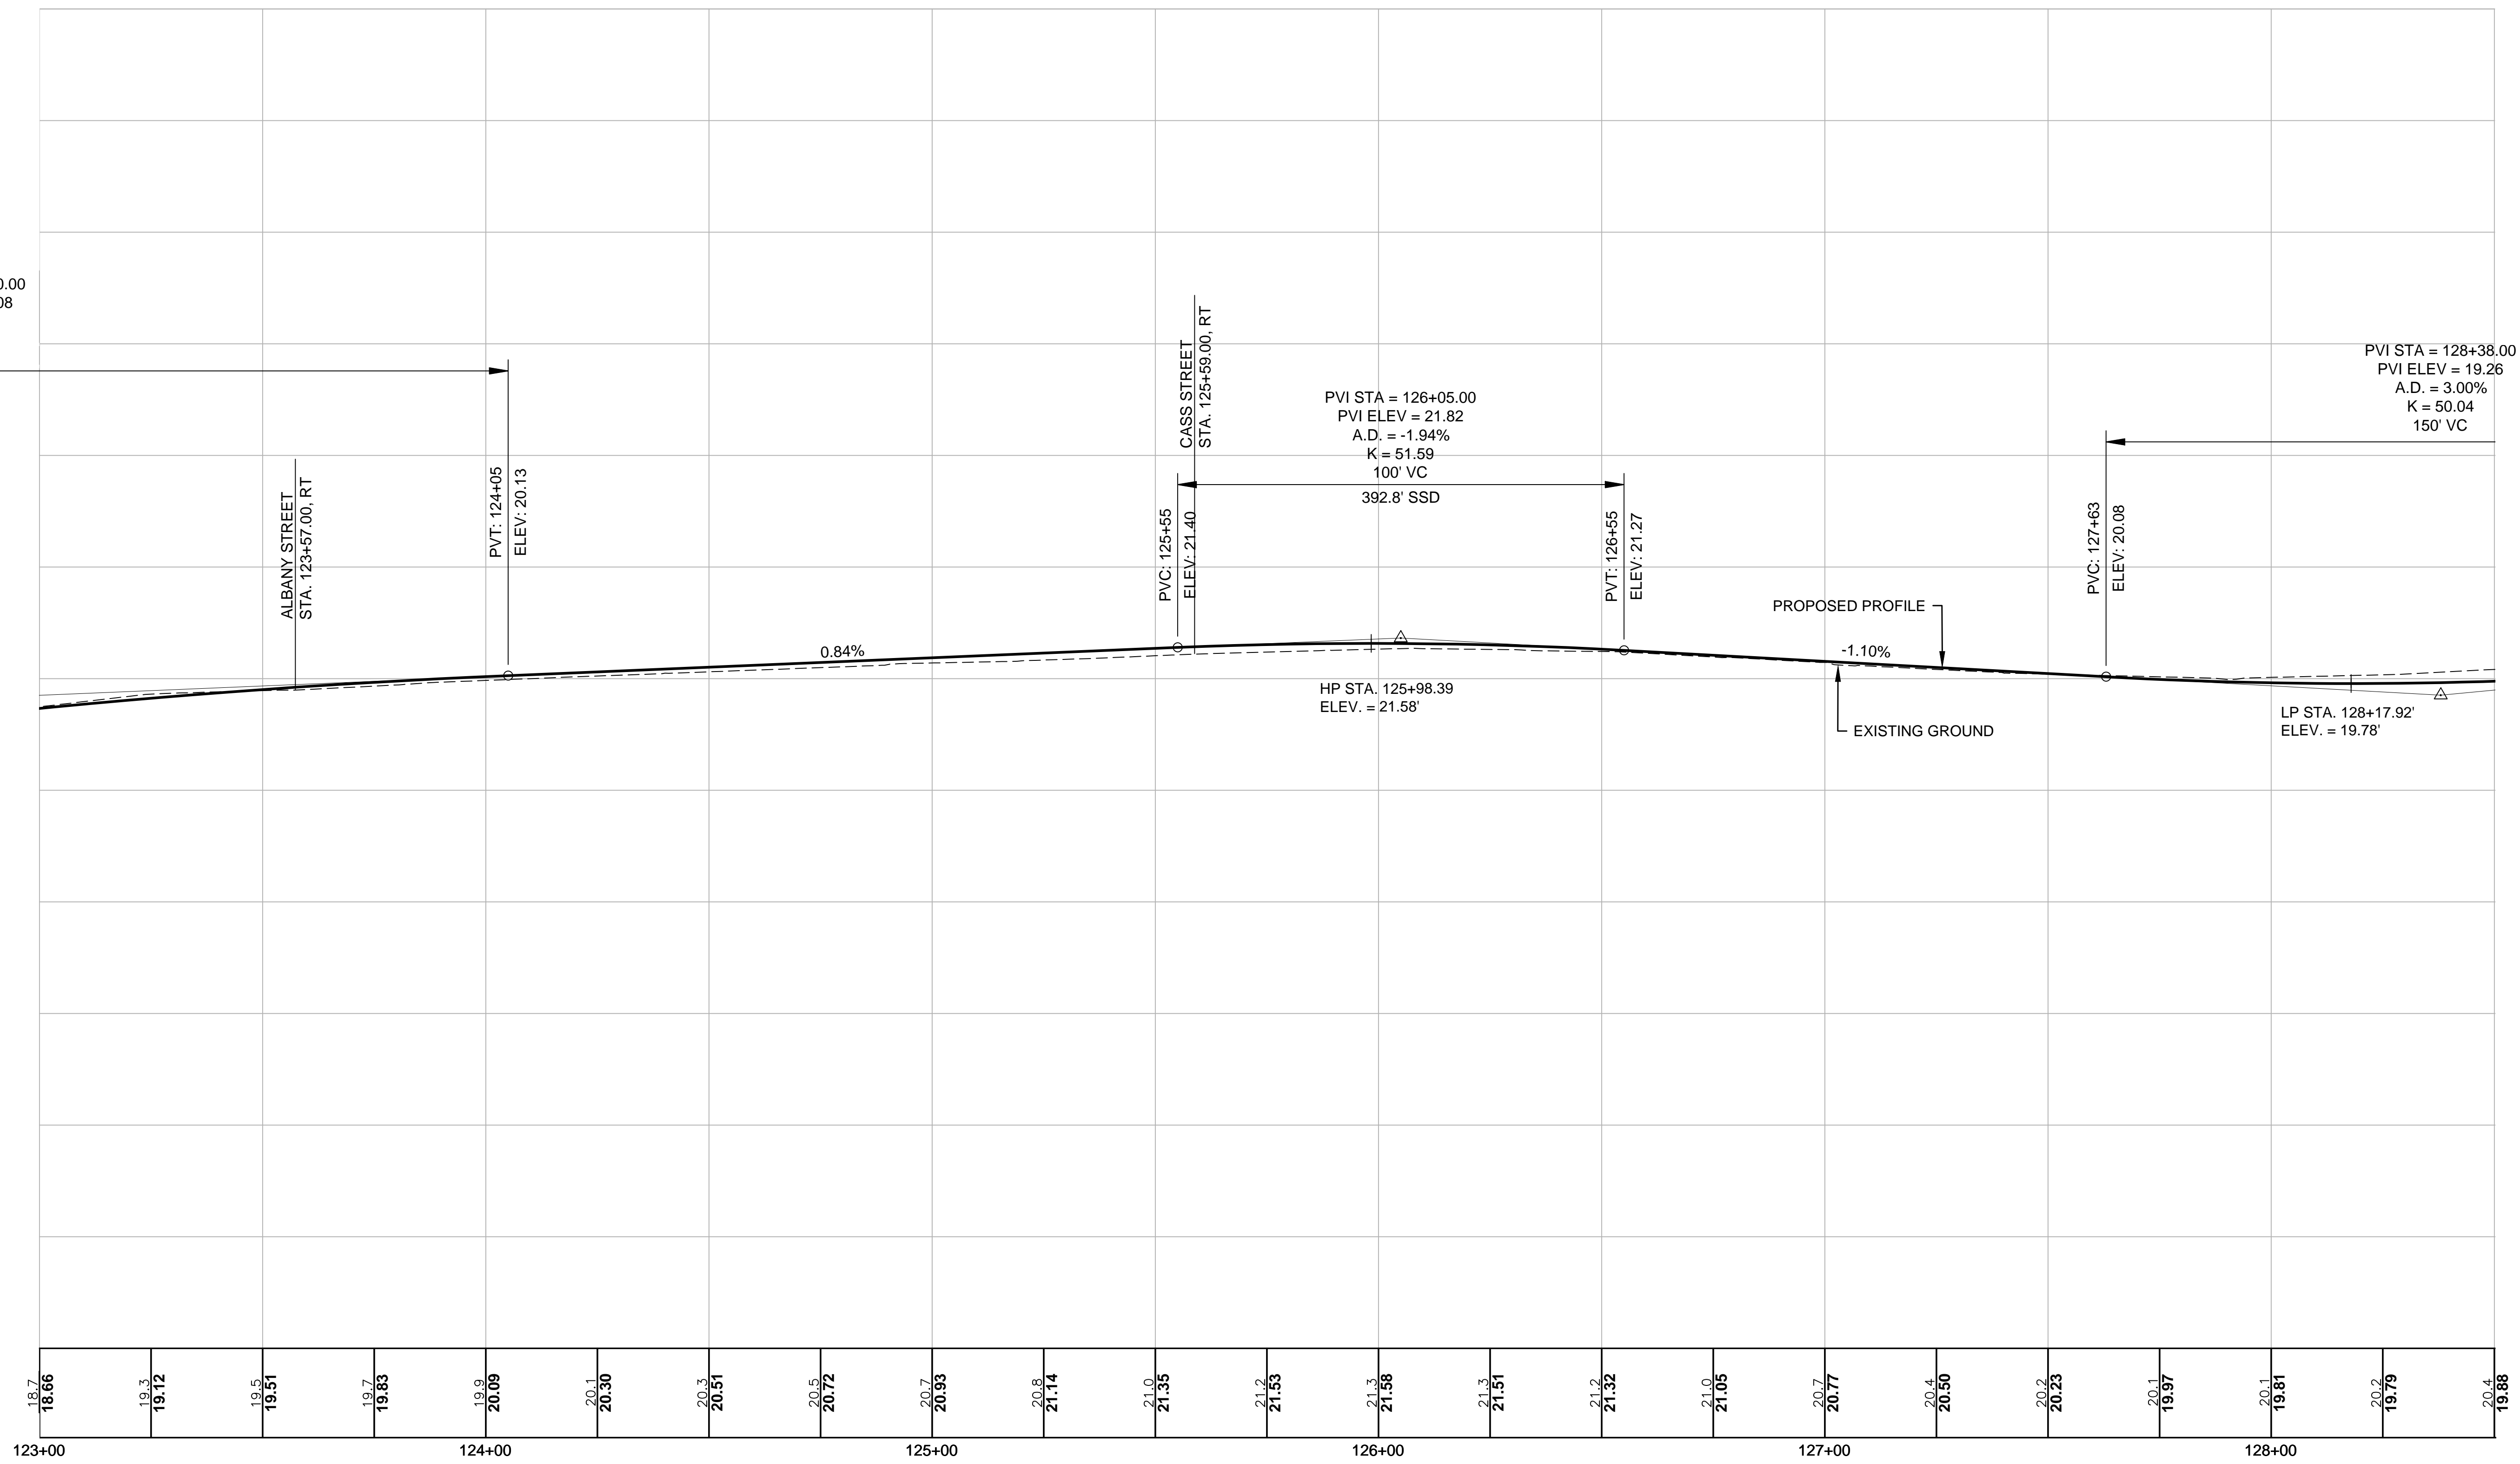





ISLINGTON STREET CORRIDOR IMPROVEMENTS - SEGMENT 1					
CITY OF PORTSMOUTH, NEW HAMPSHIRE					
PROFILE					
DATE PLOTTED	VHB PROJECT NO.	DRAWING	CITY PROJECT NO.	SHEET NO.	TOTAL SHEETS
13-Nov-18	52393.00	PRO-Seg1	7176	25	88

REVISIONS AFTER PROPOSAL

STATION	DESCRIPTION


NUMBER	DATE	STATION	DESCRIPTION

SDR PROCESSED	DATE
VHB	OCT 2017
NEW DESIGN	DATE
KMH	11/13/18
SHEET CHECKED	DATE
GLB	11/13/18
AS BUILT DETAILS	DATE

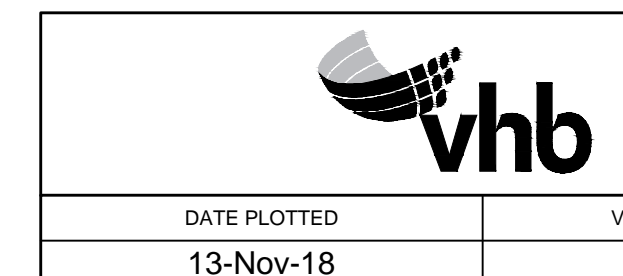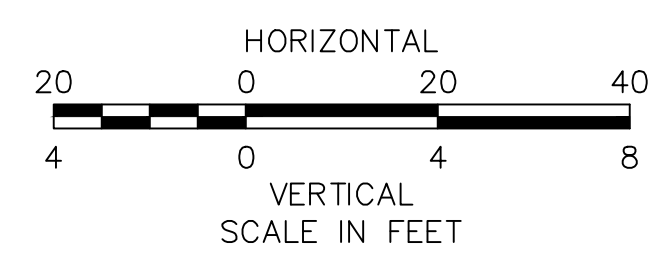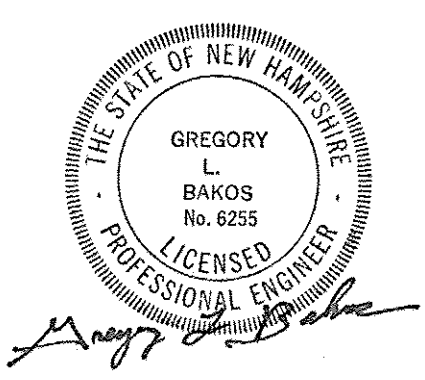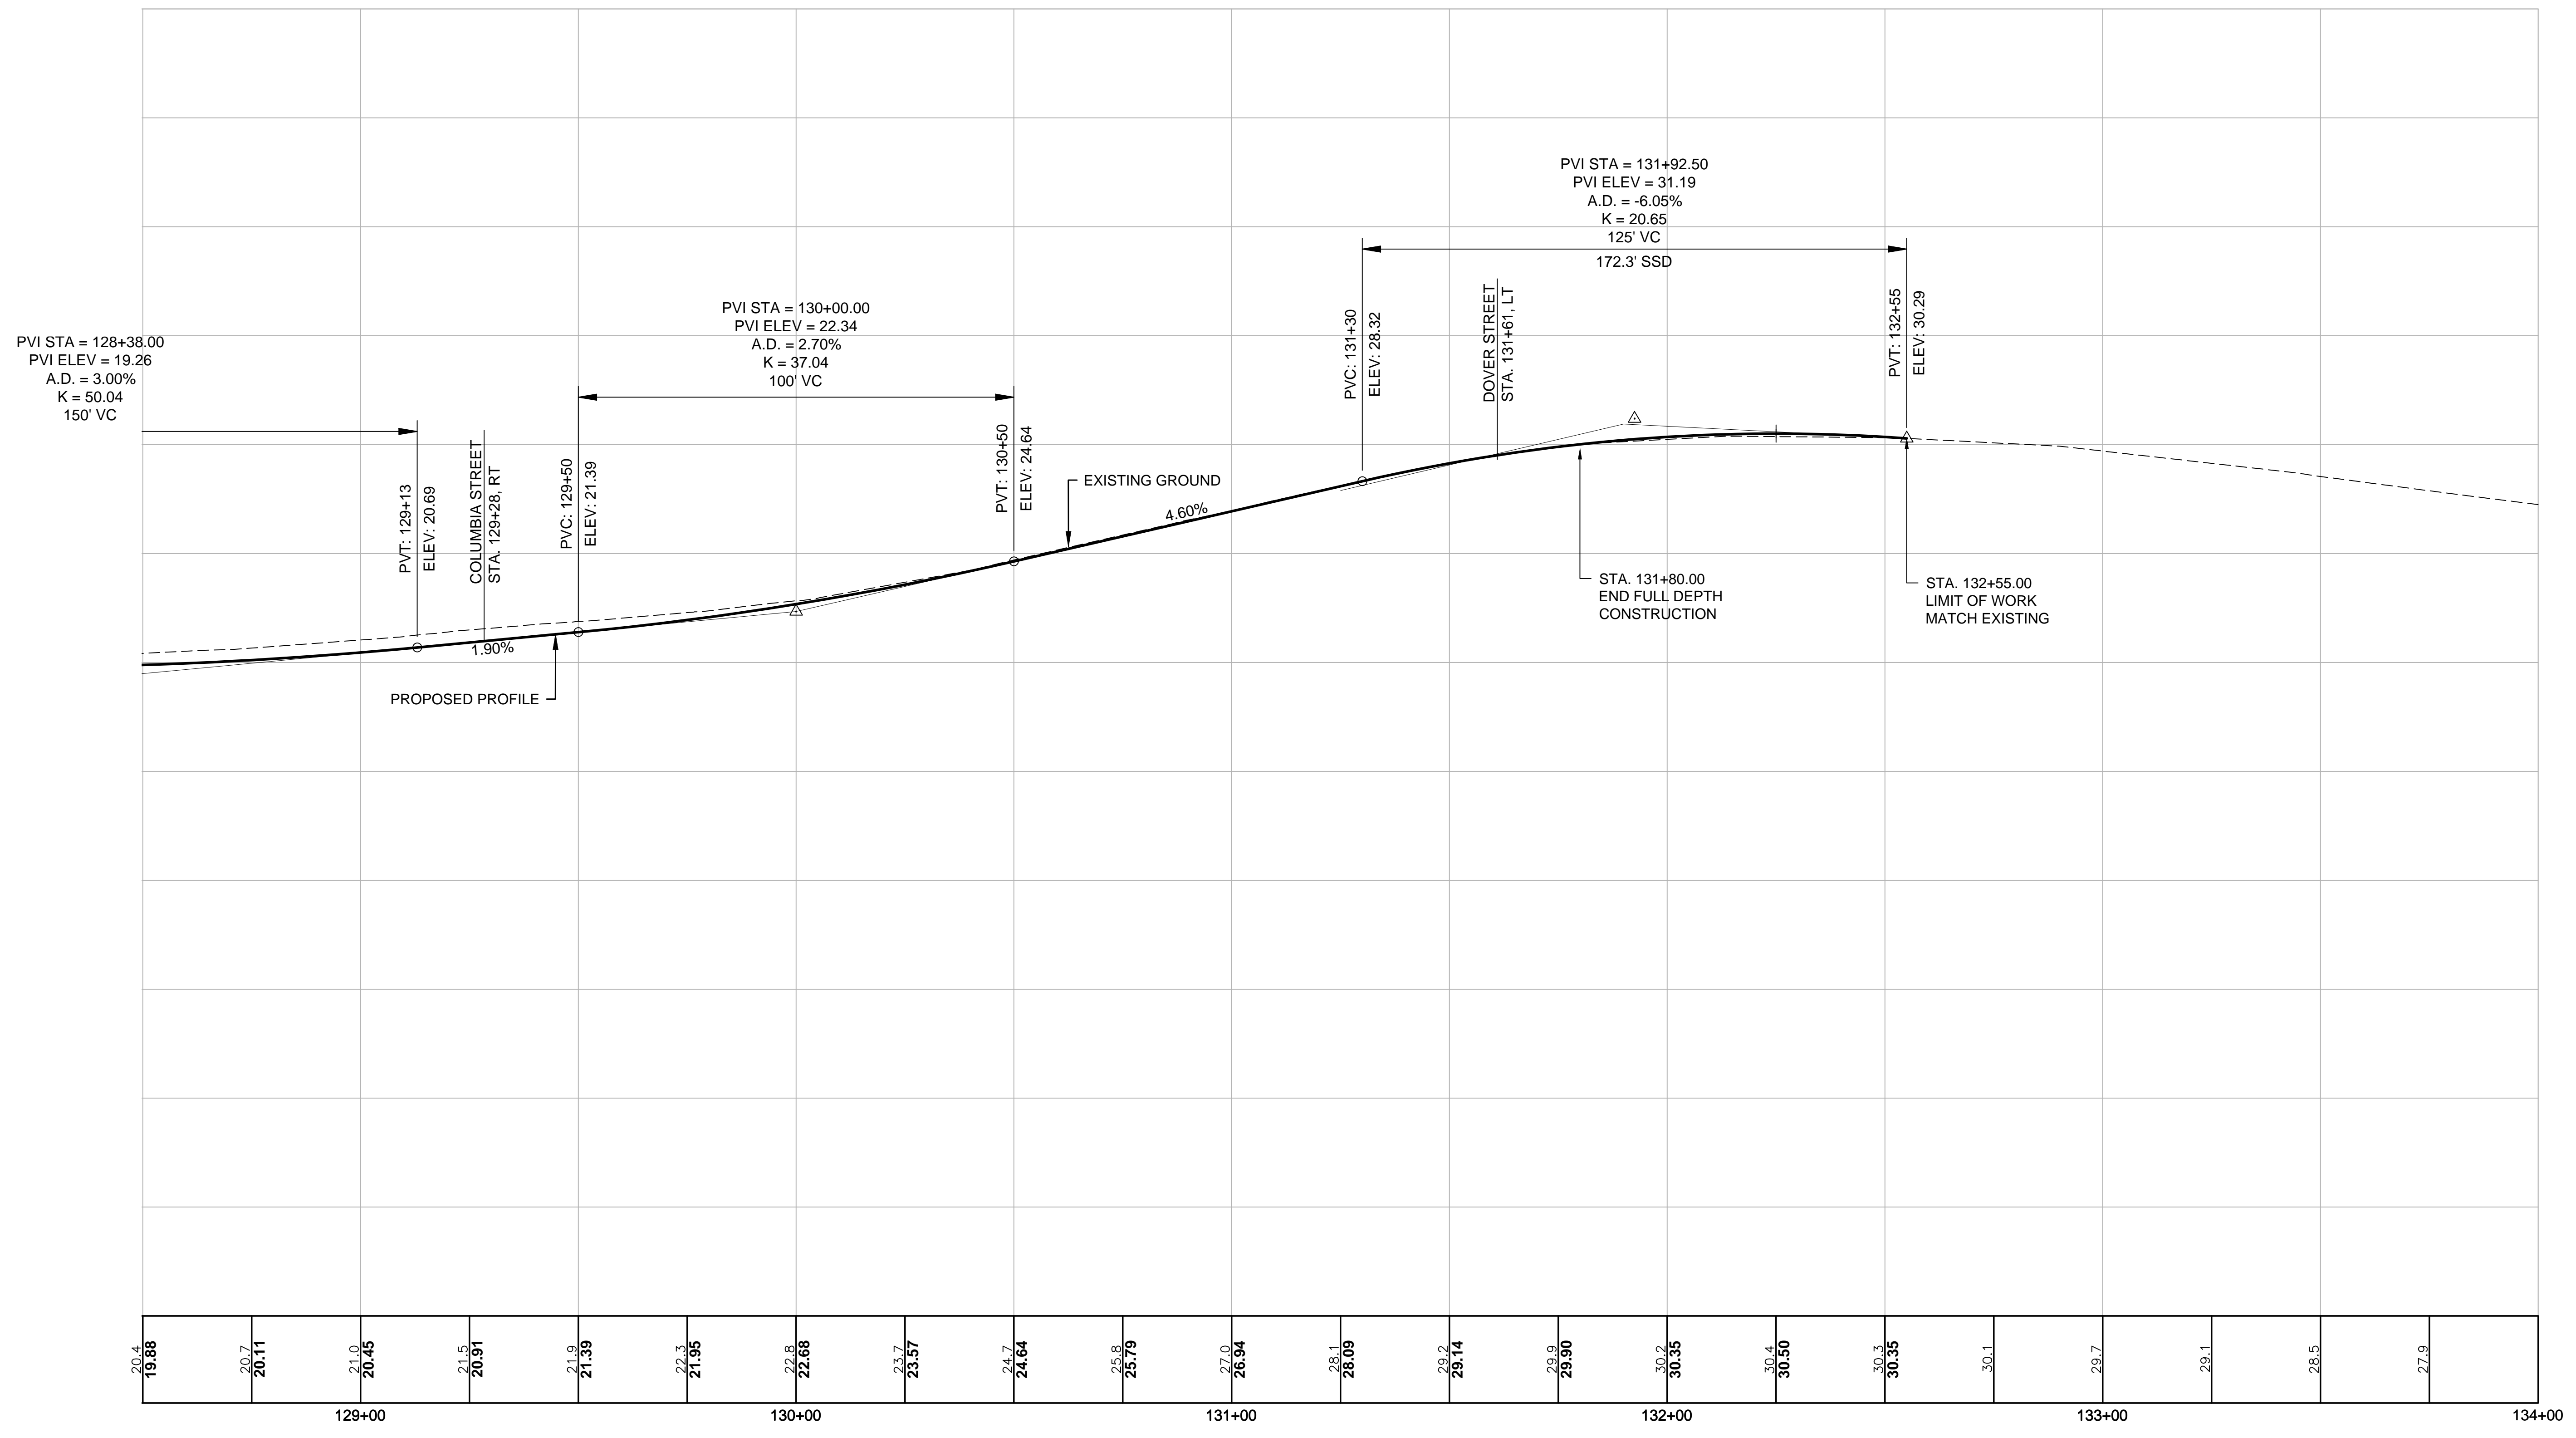


ISLINGTON STREET CORRIDOR IMPROVEMENTS - SEGMENT 1					
CITY OF PORTSMOUTH, NEW HAMPSHIRE					
PROFILE					
DATE PLOTTED	VHB PROJECT NO.	DRAWING	CITY PROJECT NO.	SHEET NO.	TOTAL SHEETS
13-Nov-18	52393.00	PRO-Seg1	7176	26	88

COLUMBIA STREET

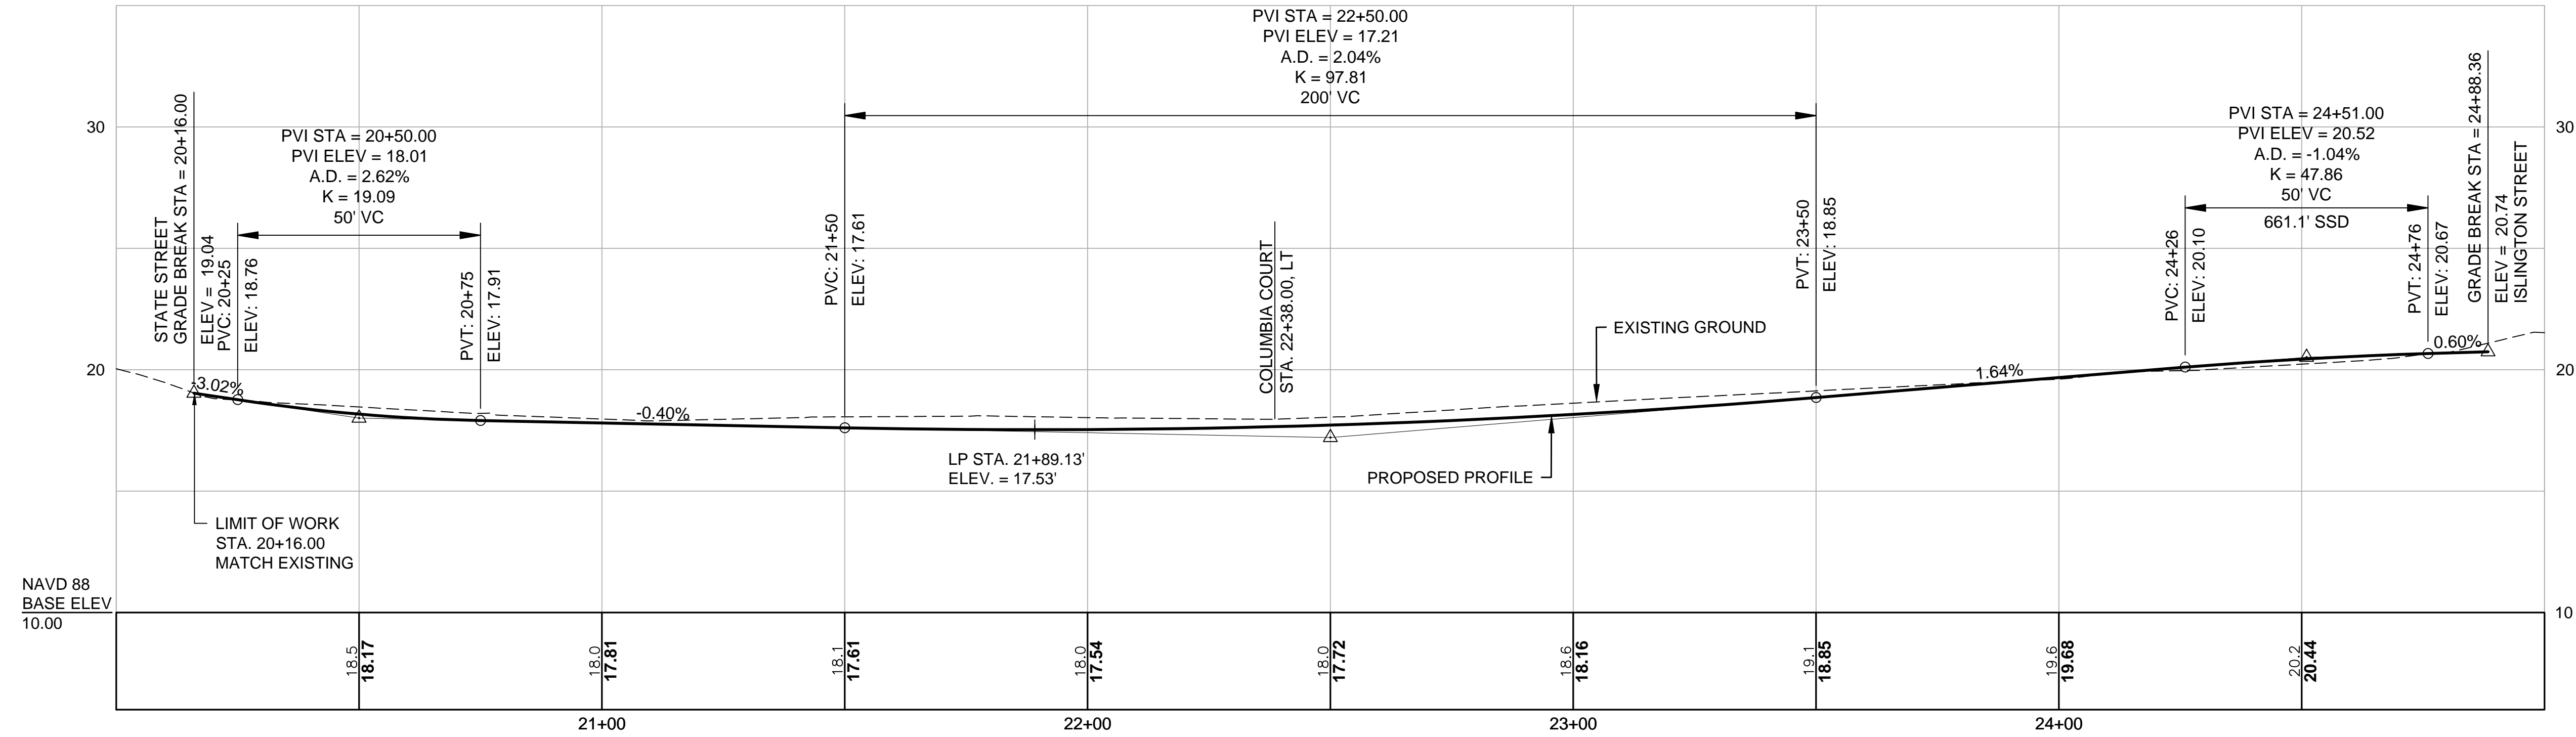




COLUMBIA COURT

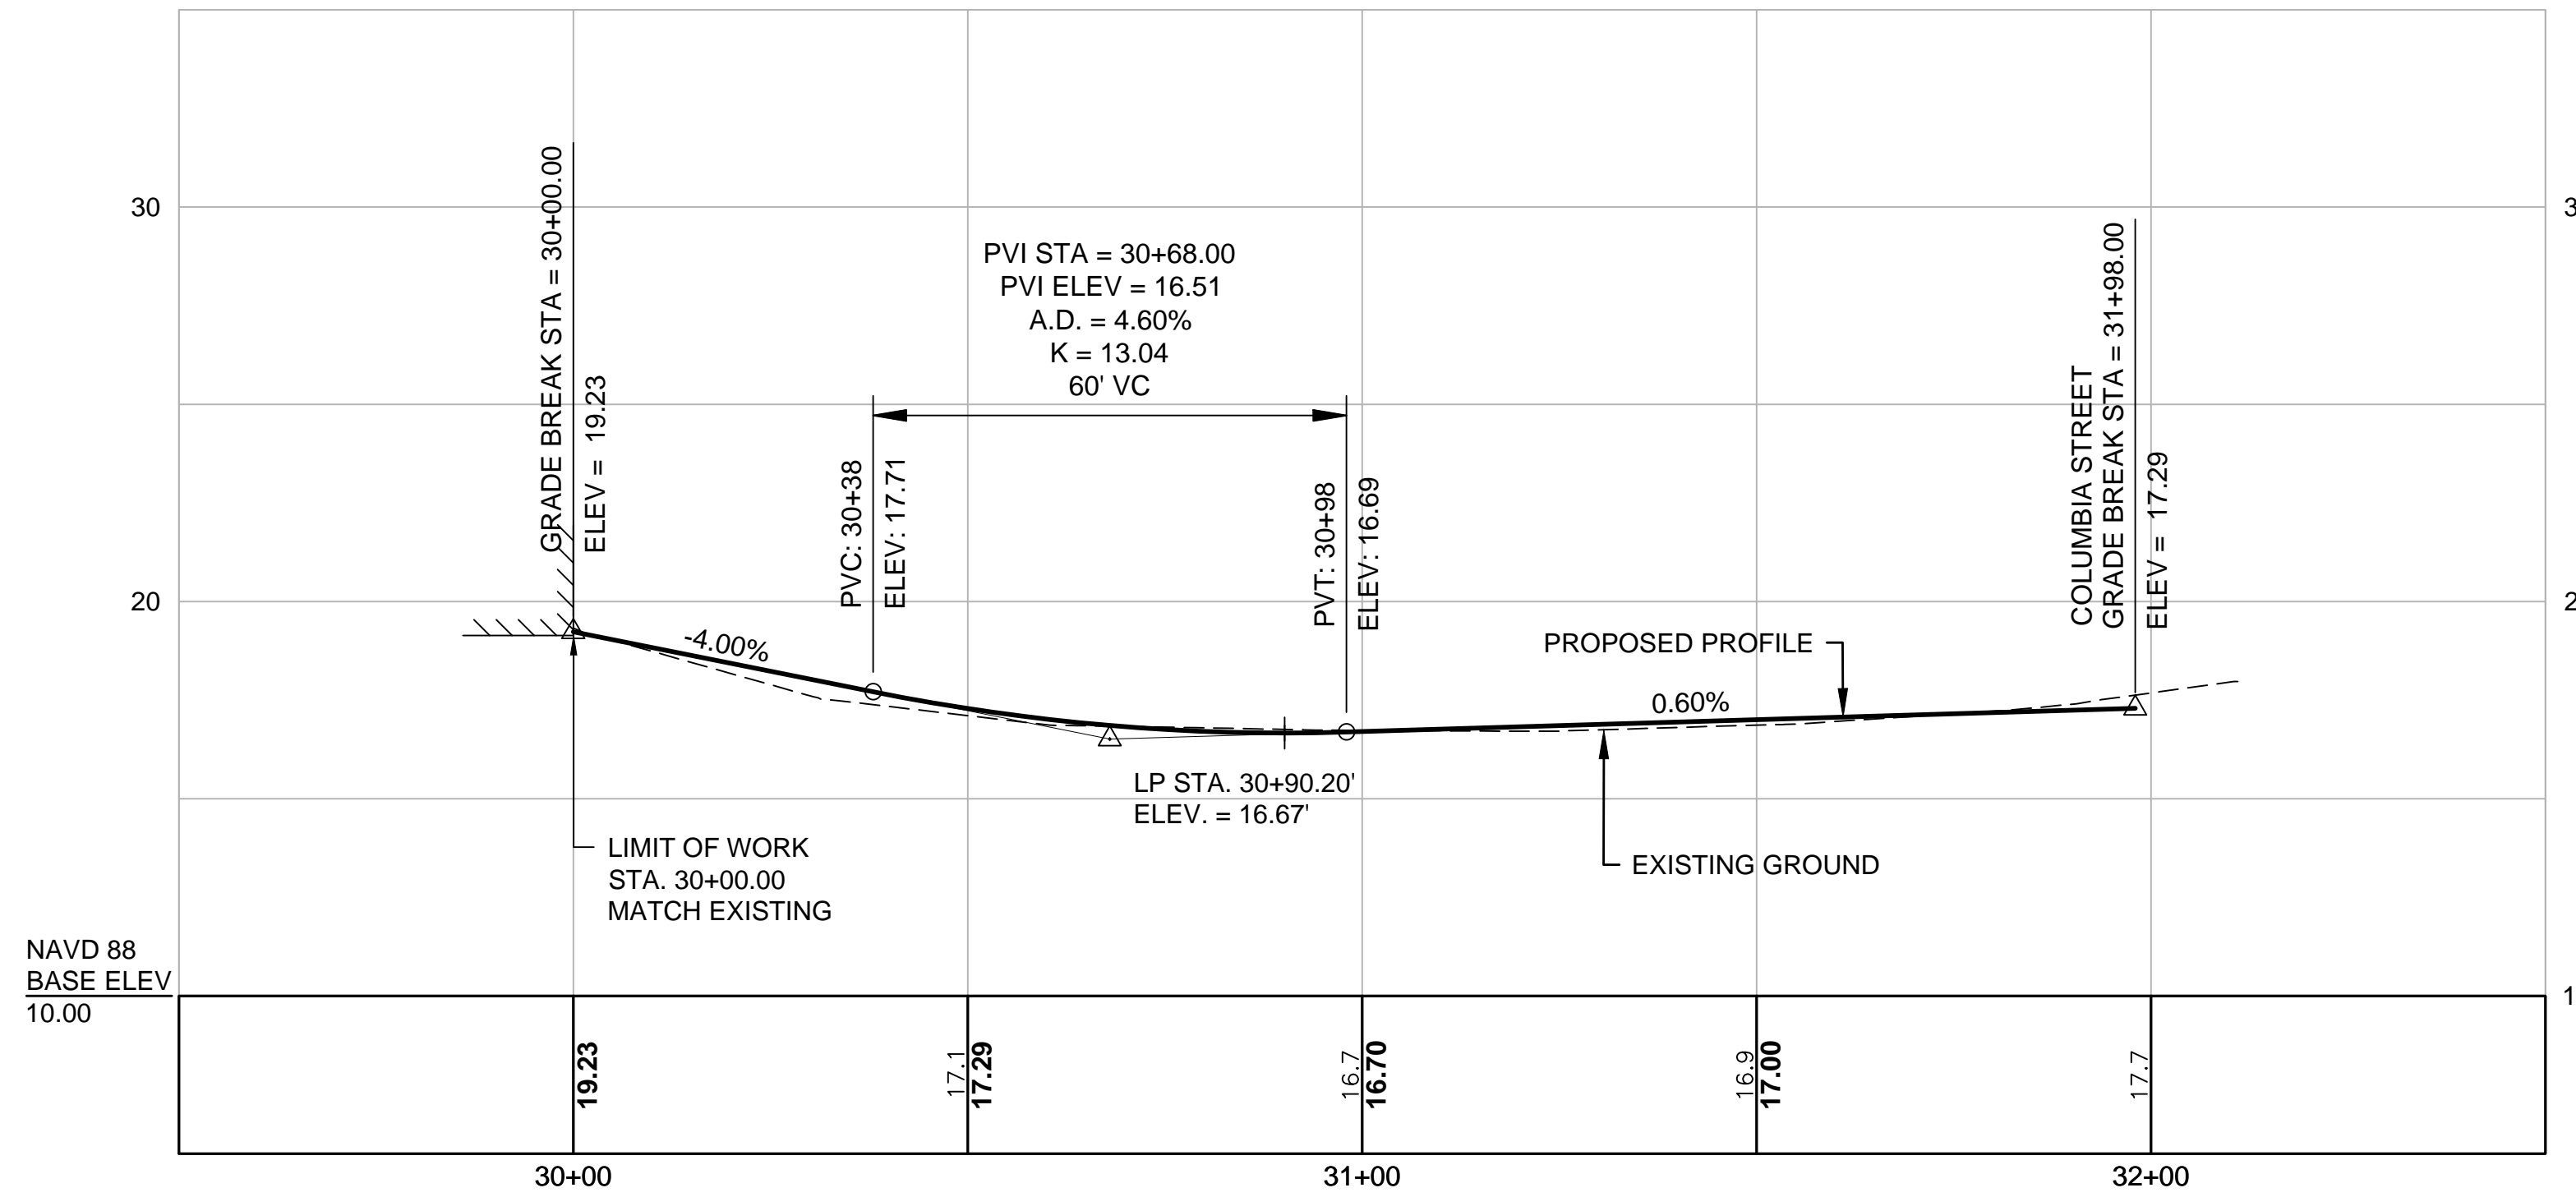

REVISIONS AFTER PROPOSAL

NUMBER	DATE	STATION	DESCRIPTION

SDR PROCESSED	VHB	DATE	OCT 2017
NEW DESIGN	KMH	DATE	11/13/18
SHEET CHECKED	GLB	DATE	11/13/18
AS BUILT DETAILS		DATE	

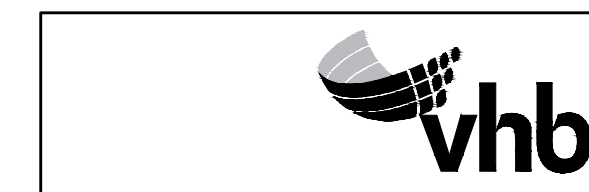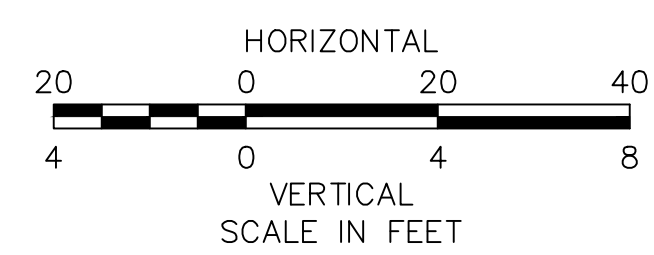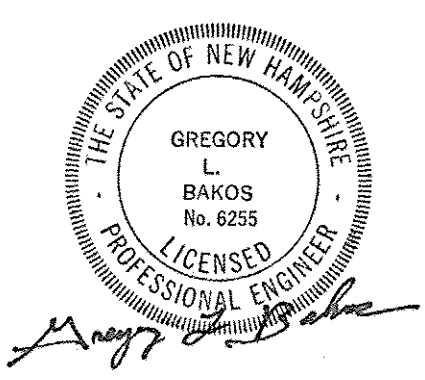

DATE PLOTTED	VHB PROJECT NO.
13-Nov-18	52393.00

ISLINGTON STREET CORRIDOR IMPROVEMENTS - SEGMENT 1				
CITY OF PORTSMOUTH, NEW HAMPSHIRE				
PROFILE				
DRAWING	CITY PROJECT NO.	SHEET NO.	TOTAL SHEETS	
PRO-Seg1	7176	27	88	

REVISIONS AFTER PROPOSAL

DESCRIPTION

STATION

STATION

DATE

NUMBER

DATE
OCT 2017

SDR PROCESSED
VHB

DATE
11/13/18

NEW DESIGN
KMH

DATE
11/13/18

SHEET CHECKED
GLB

DATE

AS BUILT DETAILS

ISLINGTON STREET CONSTRUCTION BASELINE DATA								
NUMBER	STARTING STATION	NORTHING	EASTING	CURVE DATA	LINE DATA	ENDING STATION	NORTHING	EASTING
C100	100+00.00	207572.163	1222299.998	R = 1420.30' Δ= 10°27'24" L=259.21' T=129.97'		102+59.21	207725.808	1222508.321
L100	102+59.21	207725.808	1222508.321		N48° 21' 42"E 160.62'	104+19.84	207832.530	1222628.362
C101	104+19.84	207832.530	1222628.362	R = 1200.00' Δ= 6°40'19" L=139.74' T=69.95'		105+59.57	207931.239	1222727.160
L101	105+59.57	207931.239	1222727.160		N41° 41' 23"E 196.77'	107+56.34	208078.176	1222858.028
C102	107+56.34	208078.176	1222858.028	R = 800.00' Δ= 13°57'41" L=194.94' T=97.95'		109+51.28	208238.029	1222968.752
L102	109+51.28	208238.029	1222968.752		N27° 43' 42"E 175.70'	111+26.97	208393.548	1223050.500
L103	111+26.97	208393.548	1223050.500		N29° 00' 57"E 240.08'	113+67.05	208603.496	1223166.953
L104	113+67.05	208603.496	1223166.953		N27° 31' 00"E 473.44'	118+40.49	209023.376	1223385.684
C103	118+40.49	209023.376	1223385.684	R = 875.00' Δ= 15°02'11" L=229.63' T=115.48'		120+70.12	209210.860	1223517.132
L105	120+70.12	209210.860	1223517.132		N42° 33' 12"E 293.07'	123+63.20	209426.752	1223715.330
C104	123+63.20	209426.752	1223715.330	R = 2000.00' Δ= 3°29'40" L=121.98' T=61.01'		124+85.18	209519.068	1223795.032
C105	124+85.18	209519.068	1223795.032	R = 760.00' Δ= 20°41'03" L=274.37' T=138.69'		127+59.54	209696.648	1224002.224
L106	127+59.54	209696.648	1224002.224		N59° 44' 35"E 258.32'	130+17.87	209826.812	1224225.357
C106	130+17.87	209826.812	1224225.357	R = 3000.00' Δ= 3°10'19" L=166.09' T=83.06'		131+83.95	209906.487	1224371.062
C107	131+83.95	209906.487	1224371.062	R = 3000.00' Δ= 6°00'30" L=314.60' T=157.45'		134+98.56	210064.139	1224643.145


HORIZONTAL CONTROL POINT DATA				
POINT NO.	STATION	OFFSET	NORTHING	EASTING
HC-3	102+90.98	19.72' LT	207761.6500	1222518.9562
HC-4	106+29.69	34.48' RT	207960.6644	1222799.5404
HC-9	120+48.50	42.35' LT	209222.6148	1223470.8187
HC-10	123+21.47	17.94' RT	209383.8870	1223700.3263
HC-11	126+03.57	20.97' LT	209620.4054	1223862.4455

SPINNEY ROAD CONSTRUCTION BASELINE DATA								
NUMBER	STARTING STATION	NORTHING	EASTING	CURVE DATA	LINE DATA	ENDING STATION	NORTHING	EASTING
L40	40+00.00	207727.058	1222633.962		N19° 17' 59"E 35.12'	40+35.12	207760.207	1222645.571
C40	40+35.12	207760.207	1222645.571	R = 36.00' Δ= 60°56'18" L=38.29' T=21.18'		40+73.41	207796.024	1222638.499
L41	40+73.41	207796.024	1222638.499		N41° 38' 18"W 33.97'	41+07.38	207821.413	1222615.927

BARTLETT STREET CONSTRUCTION BASELINE DATA								
NUMBER	STARTING STATION	NORTHING	EASTING	CURVE DATA	LINE DATA	ENDING STATION	NORTHING	EASTING
L50	50+00.00	209166.606	1223479.144		N72° 59' 23"W 106.99'	51+06.99	209197.905	1223376.836
L51	51+06.99	209197.905	1223376.836		N74° 38' 37"W 67.43'	51+74.42	209215.762	1223311.816

COLUMBIA STREET CONSTRUCTION BASELINE DATA								
NUMBER	STARTING STATION	NORTHING	EASTING	CURVE DATA	LINE DATA	ENDING STATION	NORTHING	EASTING
L20	20+00.00	209386.361	1224454.377		N39° 45' 18"W 92.92'	20+92.92	209457.799	1224394.952
C20	20+92.92	209457.799	1224394.952	R = 3500.00' Δ= 2°49'38" L=172.70' T=86.37'		22+65.62	209593.240	1224287.828
L21	22+65.62	209593.240	1224287.828		N36° 55' 41"W 234.82'	25+00.45	209780.953	1224146.745

COLUMBIA COURT CONSTRUCTION BASELINE DATA								
NUMBER	STARTING STATION	NORTHING	EASTING	CURVE DATA	LINE DATA	ENDING STATION	NORTHING	EASTING
L30	30+00.00	209431.678	1224146.369		N47° 52' 43"E 149.89'	31+49.89	209532.208	1224257.545
C30	31+49.89	209532.208	1224257.545	R = 1000.00' Δ= 1°31'38" L=26.66' T=13.33'		31+76.54	209549.821	1224277.553
L31	31+76.54	209549.821	1224277.553		N49° 24' 22"E 34.47'	32+11.01	209572.250	1224303.727

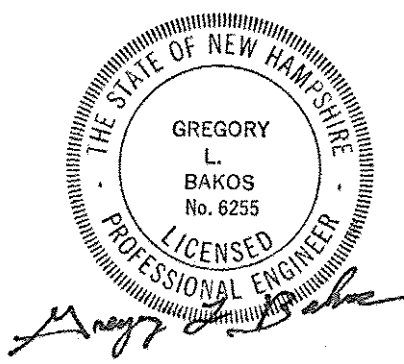

DATE PLOTTED	VHB PROJECT NO.
13-Nov-18	52393.00

ISLINGTON STREET CORRIDOR IMPROVEMENTS - SEGMENT 1				
CITY OF PORTSMOUTH, NEW HAMPSHIRE				
GRADING & LAYOUT PLAN				
DRAWING	CITY PROJECT NO.	SHEET NO.	TOTAL SHEETS	
GRADE-Seg1	7176	28	88	

REVISIONS AFTER PROPOSAL

STATION

STATION

DATE

NUMBER

DATE

DATE

DATE

VHB

KMH




GLB

AS BUILT DETAILS

CURB TABLE	
NUMBER	LENGTH
T-1	13.45
T-2	2.37
T-3	8.79
T-4	7.86
T-6	3.28
T-7	109.90
T-10	56.79
T-11	9.33
T-12	9.01
T-13	13.78
T-17	34.51
T-20	67.87

CURB TABLE		
NUMBER	LENGTH	RADIUS
1	8.26'	10.00'
2	16.40'	10.00'
3	15.71'	10.00'
4	7.66'	5.00'
5	7.87'	5.00'
6	45.87'	1408.30'
10	15.60'	10.00'
11	3.96'	2.50'
12	8.46'	5.00'
14	14.49'	10.00'
15	7.85'	5.00'

CURB TABLE		
NUMBER	LENGTH	RADIUS
26	12.42'	10.00'
27	12.42'	10.00'
28	32.77'	1188.00'
29	10.56'	15.00'
30	10.32'	15.00'
31	81.12'	1181.00'
32	15.73'	10.00'
33	15.71'	10.00'

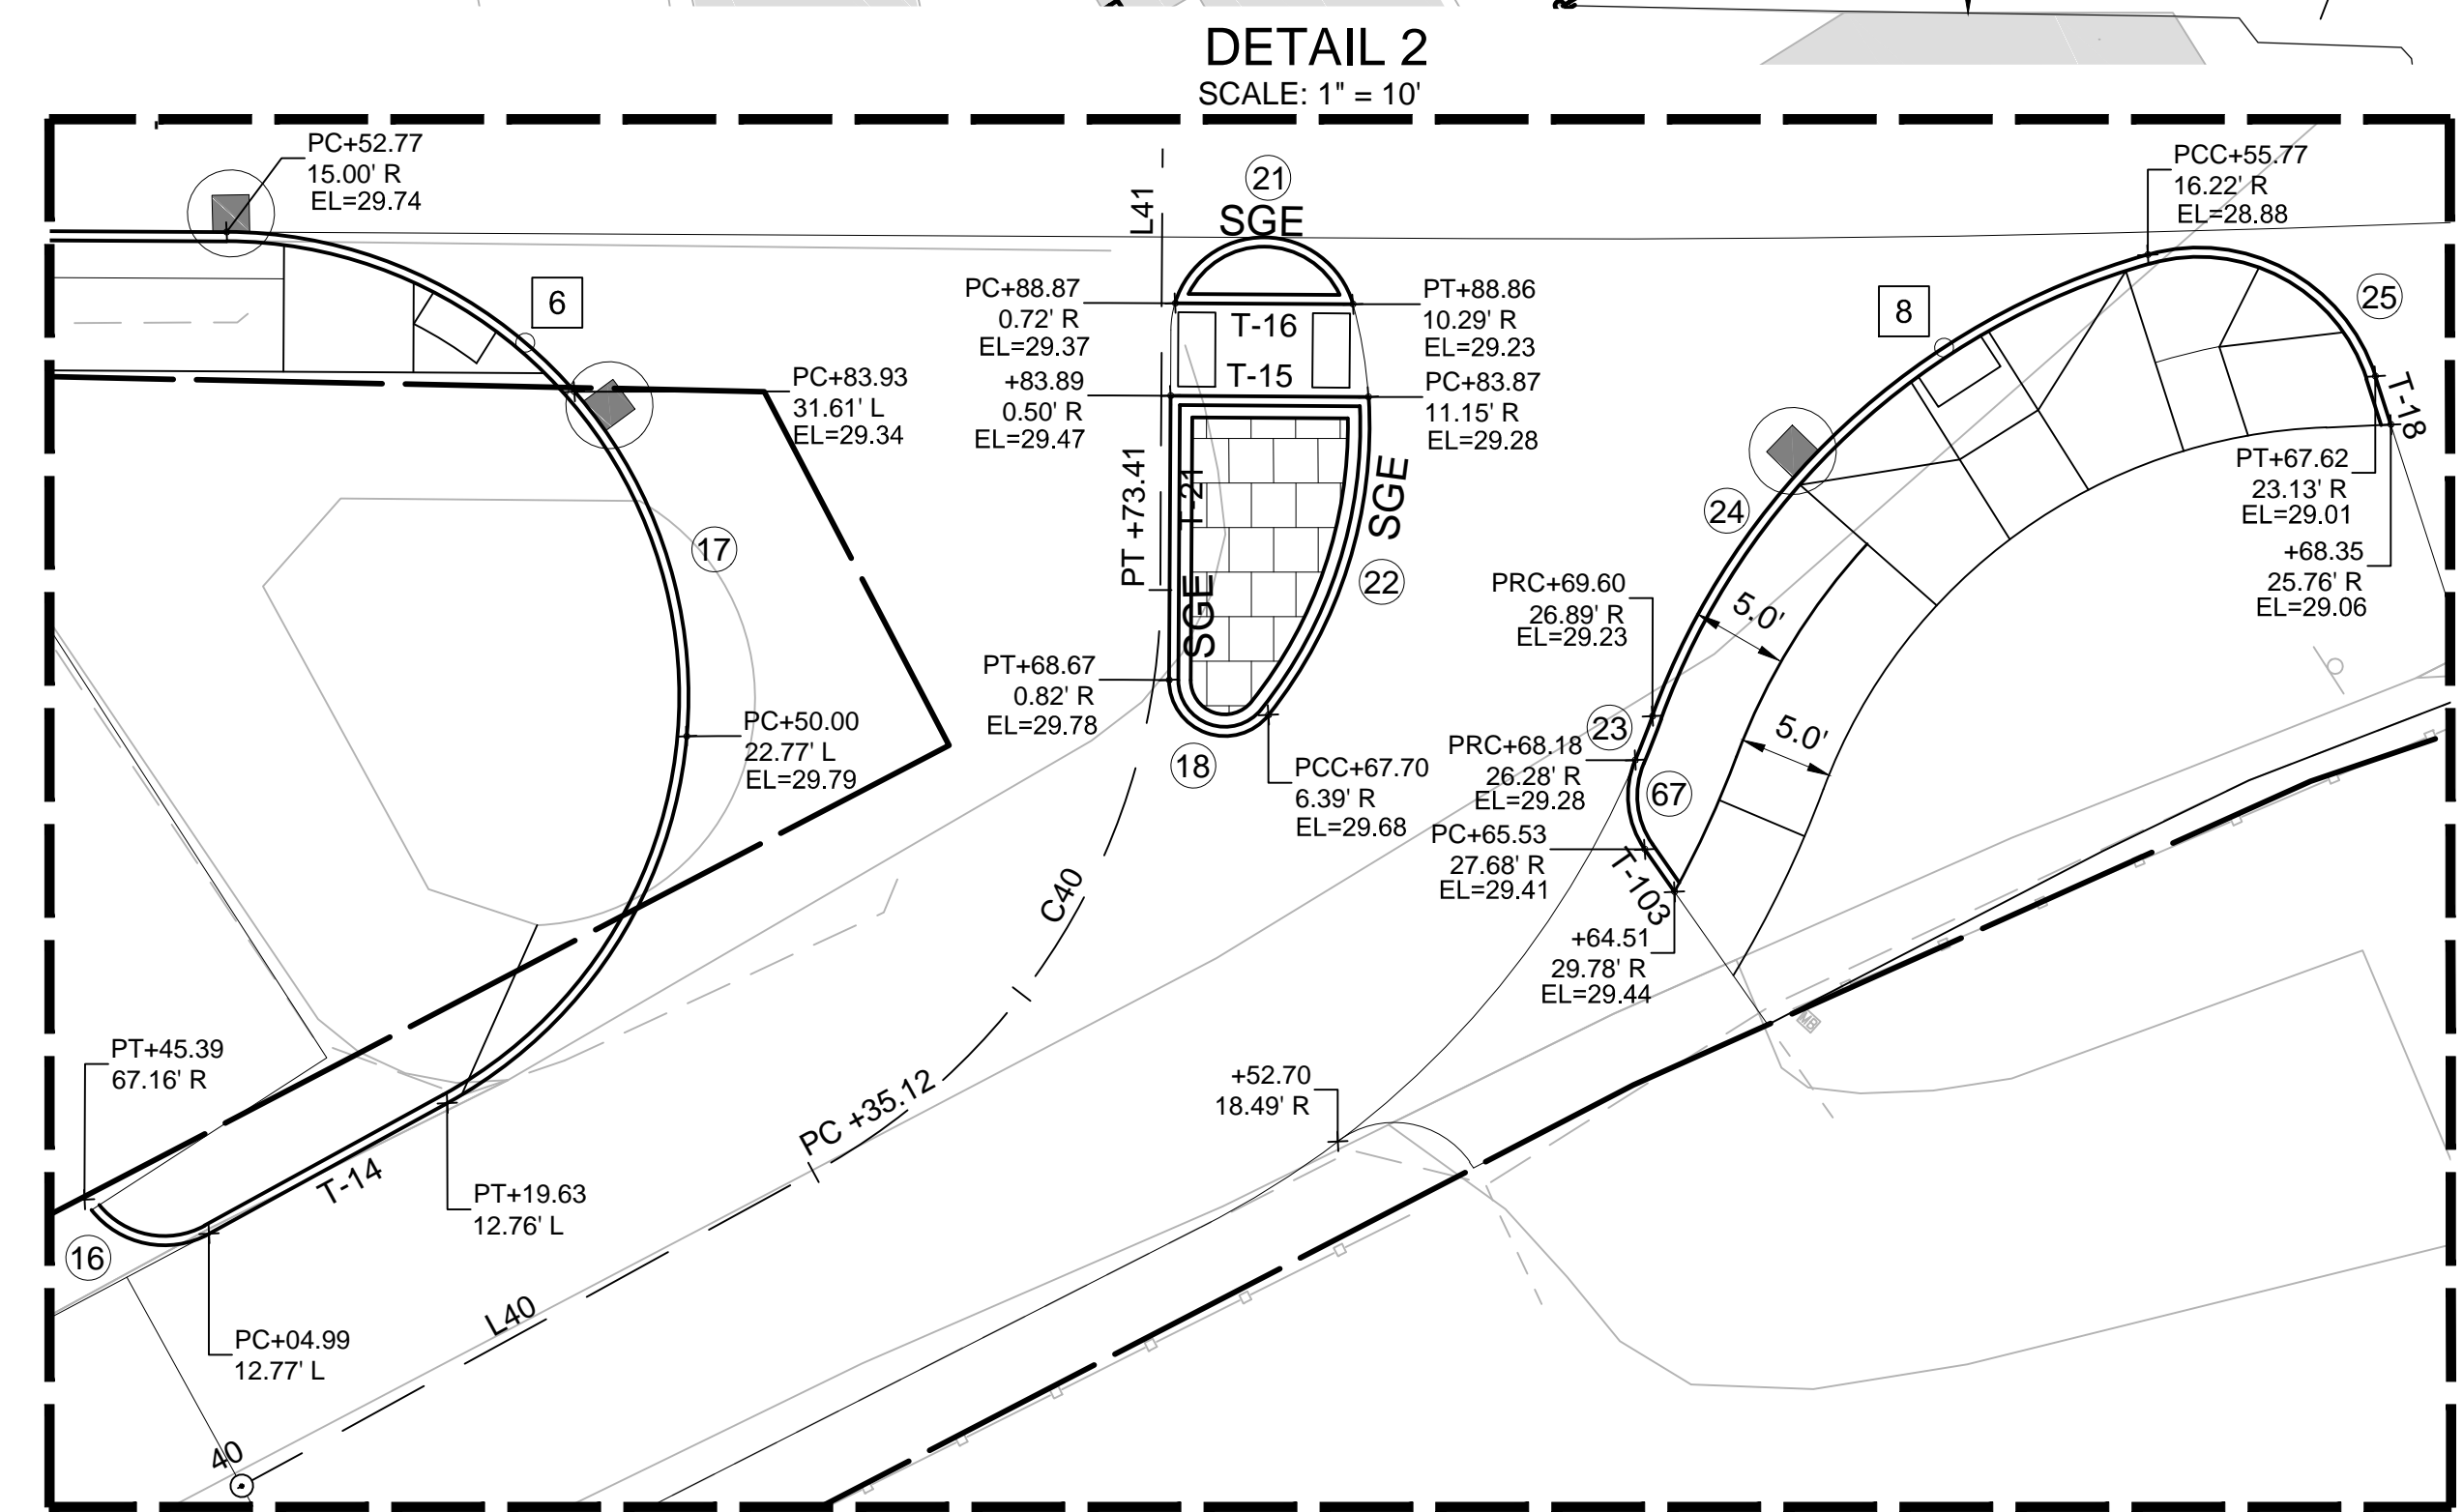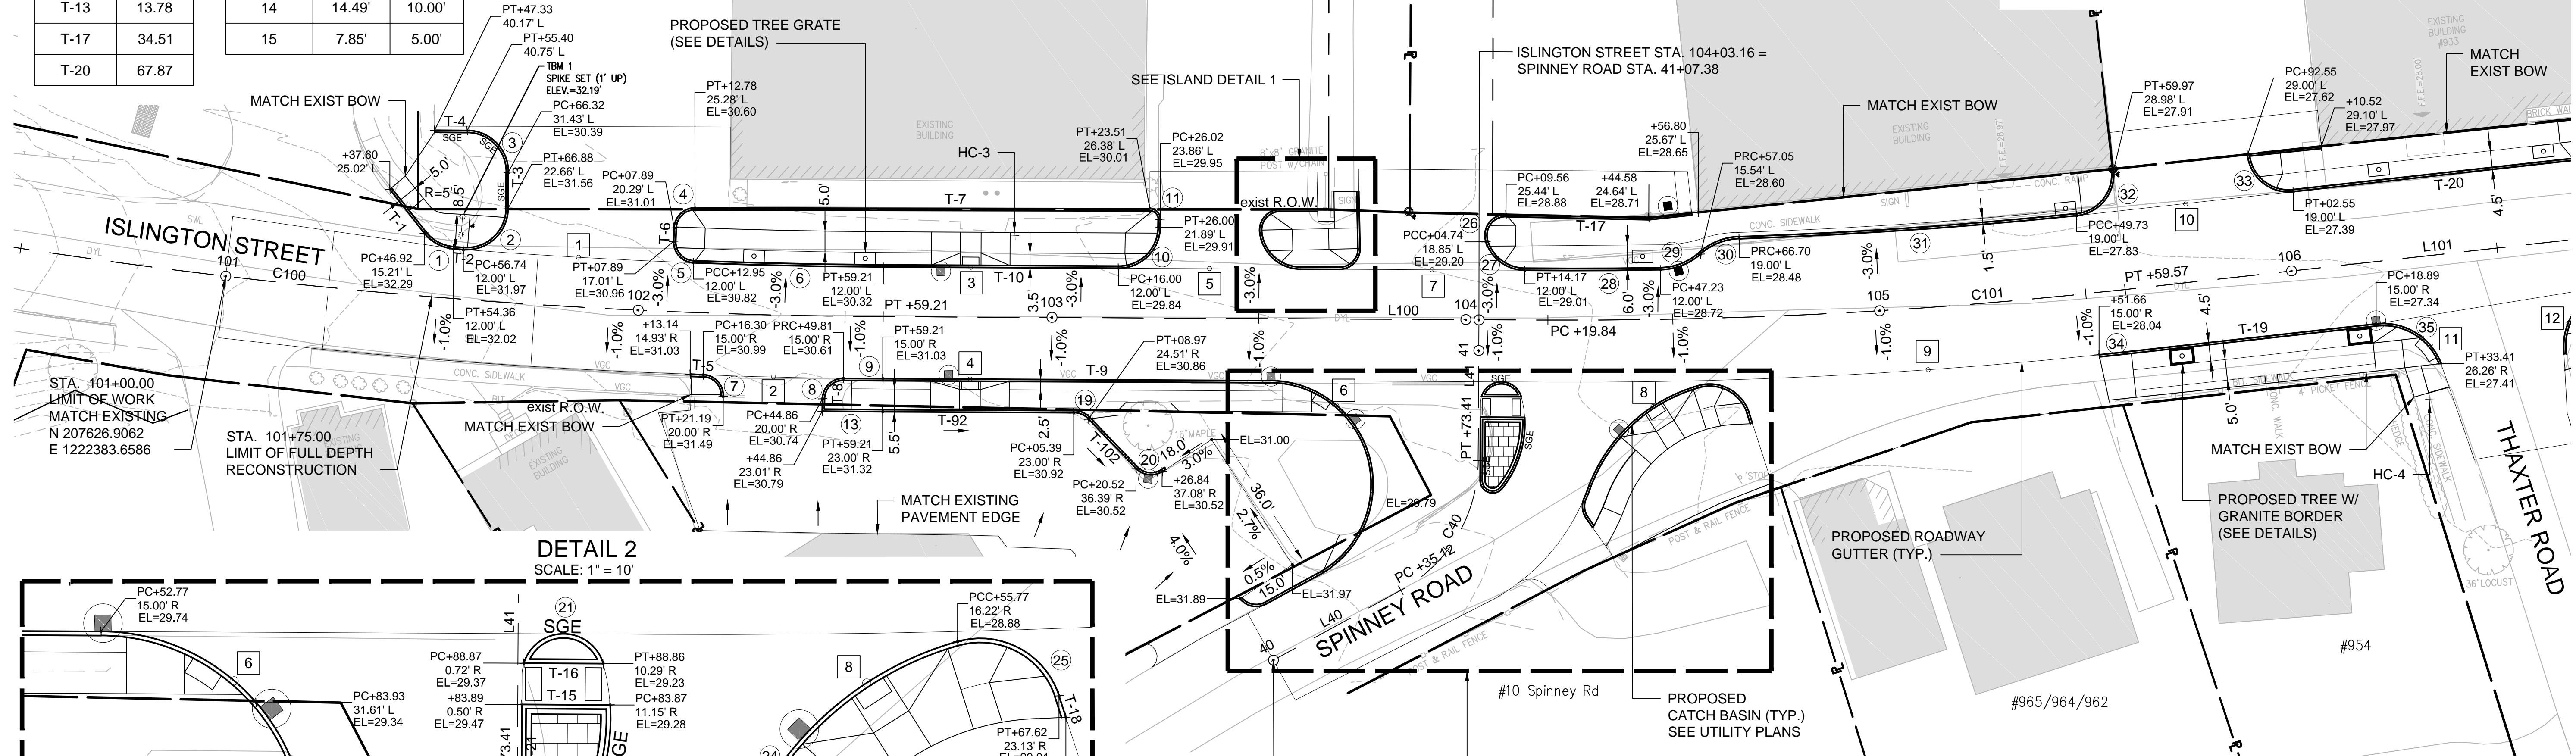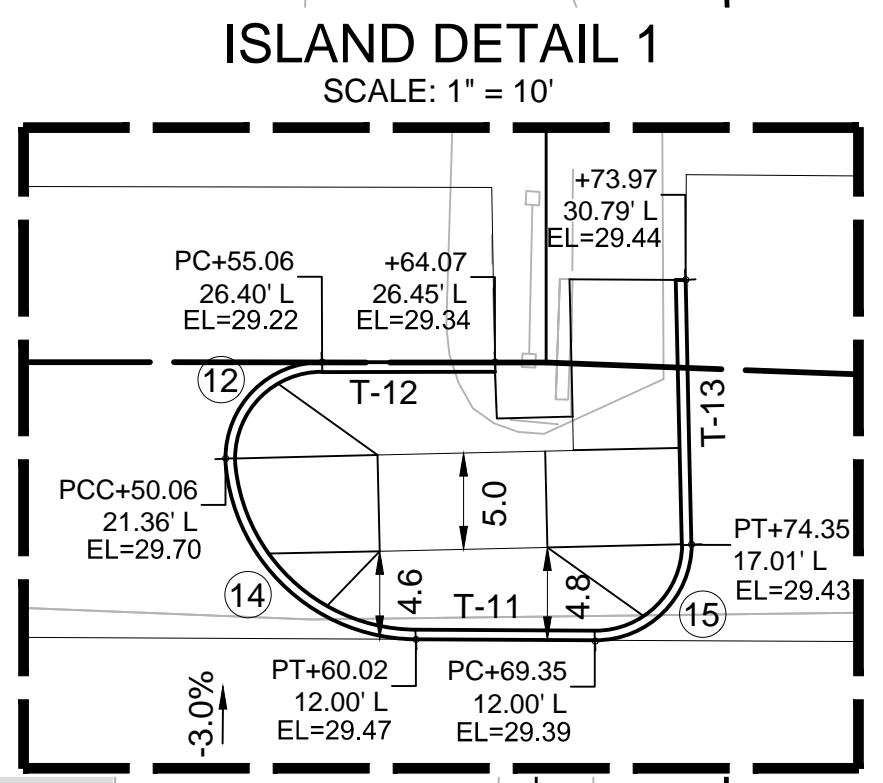

CURB TABLE		
NUMBER	LENGTH	RADIUS
16	7.68'	5.00'
17	65.87'	25.00'
18	7.43'	3.00'
21	12.78'	5.00'
22	18.36'	25.00'
23	2.98'	50.00'
24	37.86'	40.00'
25	15.35'	10.00'
67	5.05'	5.00'

CURB TABLE		
NUMBER	LENGTH	RADIUS
7	7.89'	5.00'
8	7.85'	5.00'
9	9.51'	1435.30'
13	14.80'	1443.30'
19	3.99'	5.00'
20	6.89'	5.00'

CURB TABLE	
NUMBER	LENGTH
T-5	3.19
T-8	3.01
T-9	93.55
T-14	14.63
T-15	10.65
T-16	9.58
T-18	2.74
T-19	59.31
T-21	15.31
T-92	46.17
T-102	16.56
T-103	2.79


CURB TABLE		
NUMBER	LENGTH	RADIUS
34	8.01'	1215.00'
35	19.78'	15.00'
36	22.71'	15.00'

LEGEND


- # ADA RAMP/DRIVEWAY NO. (SEE DETAILS)
- ① CURB CURVE NO.
- T-# CURB TANGENT NO.
- C# ALIGNMENT CURVE NO.
- L# ALIGNMENT TANGENT NO.

NOTES:

1. ALL CURBING TO BE VERTICAL GRANITE CURB (VGC) UNLESS NOTED OTHERWISE
2. ALL ELEVATIONS LISTED ARE BOTTOM OF CURB ELEVATIONS.

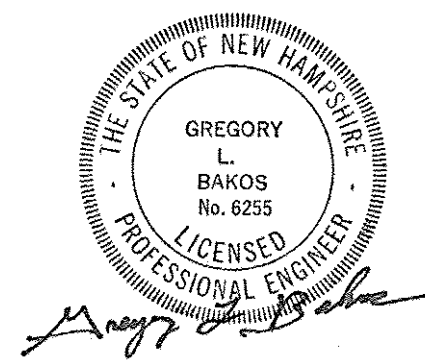

BACK CURB DETAIL
STA. 102+45 TO STA. 103+05, RT

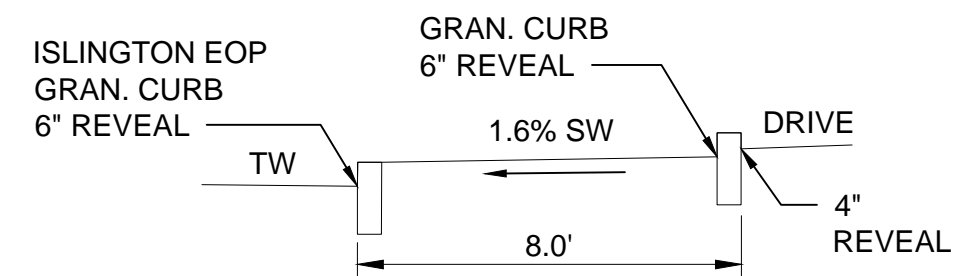

ISLINGTON STREET CORRIDOR IMPROVEMENTS - SEGMENT 1

CITY OF PORTSMOUTH, NEW HAMPSHIRE

GRADING & LAYOUT PLAN

		DATE PLOTTED	VHB PROJECT NO.	DRAWING	CITY PROJECT NO.	SHEET NO.	TOTAL SHEETS
		13-Nov-18	52393.00	GRADE-Seg1	7176	29	88

REVISIONS AFTER PROPOSAL

STATION

STATION

DATE

NUMBER

DATE

SDR PROCESSED VHB

DATE

NEW DESIGN KMVH

DATE



SHEET CHECKED GLB

DATE

AS BUILT DETAILS

CURB TABLE		
NUMBER	LENGTH	RADIUS
37	7.87'	5.00'
38	14.31'	10.00'
39	10.29'	788.00'
40	15.94'	10.00'
42	15.47'	5.00'
43	10.53'	788.00'
44	13.38'	10.00'
45	16.90'	10.00'
46	10.70'	10.00'
48	11.70'	10.00'
50	15.63'	10.00'
51	19.71'	12.00'

CURB TABLE	
NUMBER	LENGTH
T-22	4.68
T-24	8.18
T-25	26.62
T-27	6.76
T-28	10.06
T-29	10.02
T-31	3.47
T-32	57.92
T-33	9.08
T-36	8.49
T-37	42.57
T-39	6.88
T-41	109.58

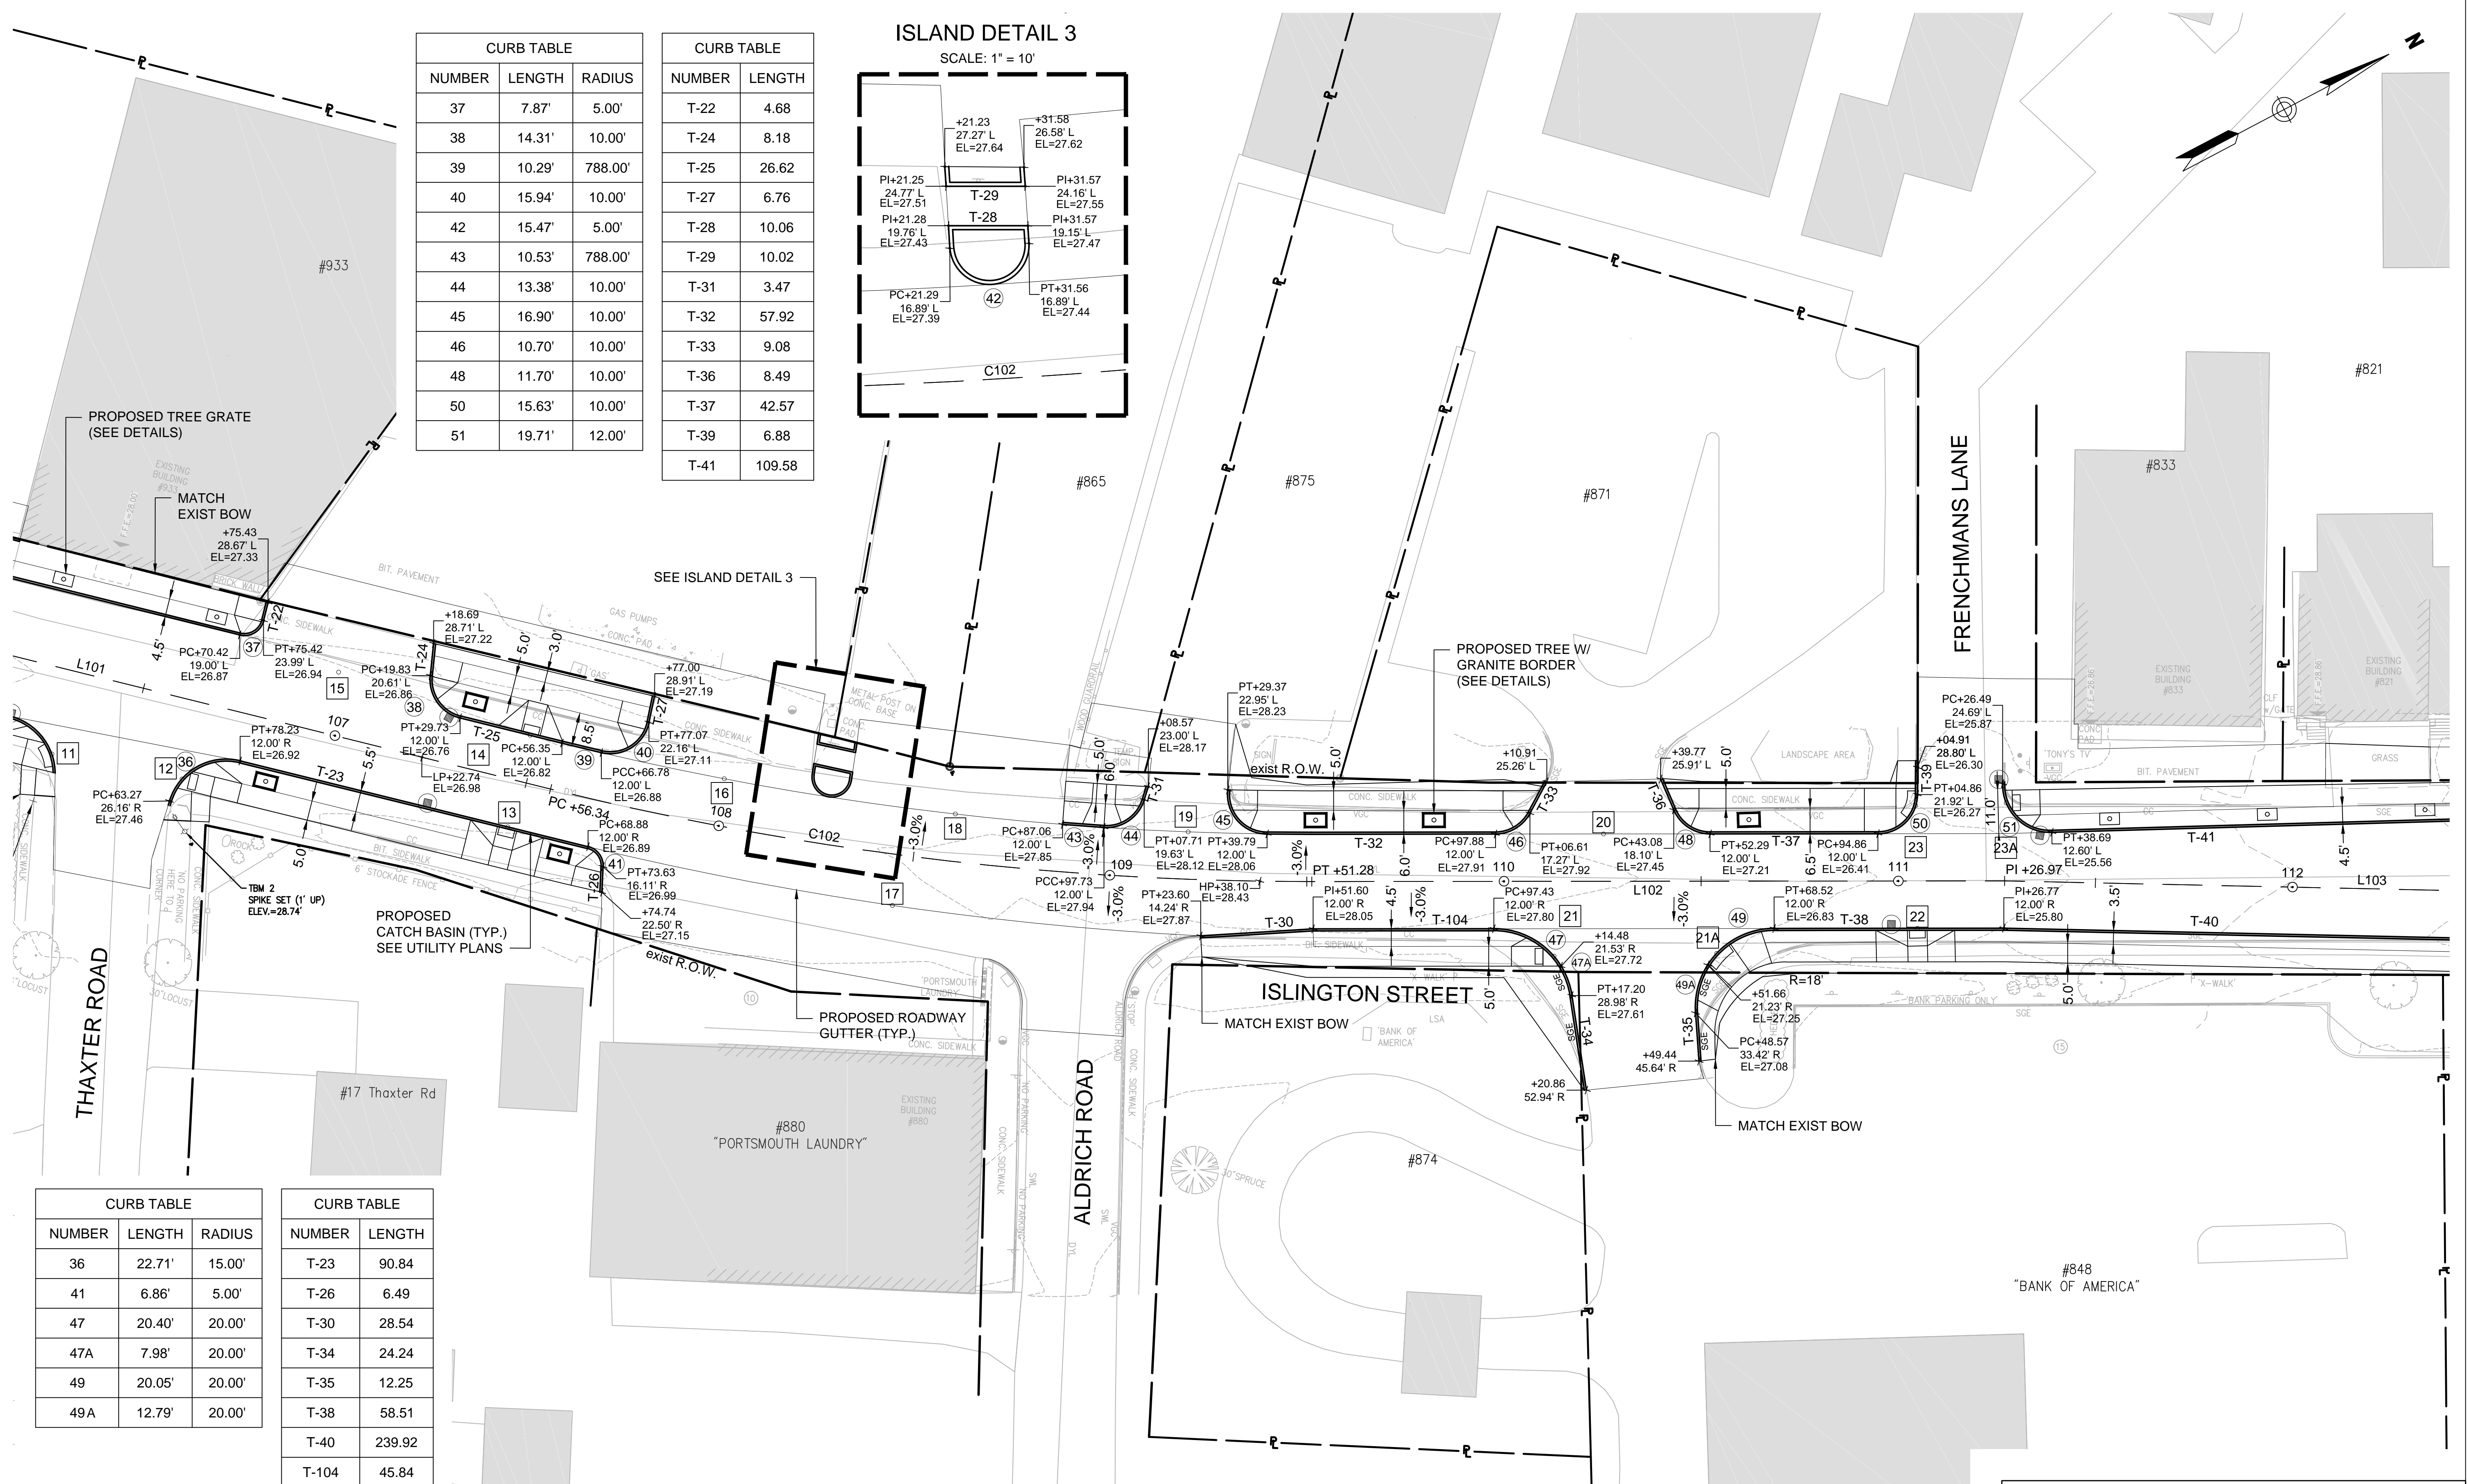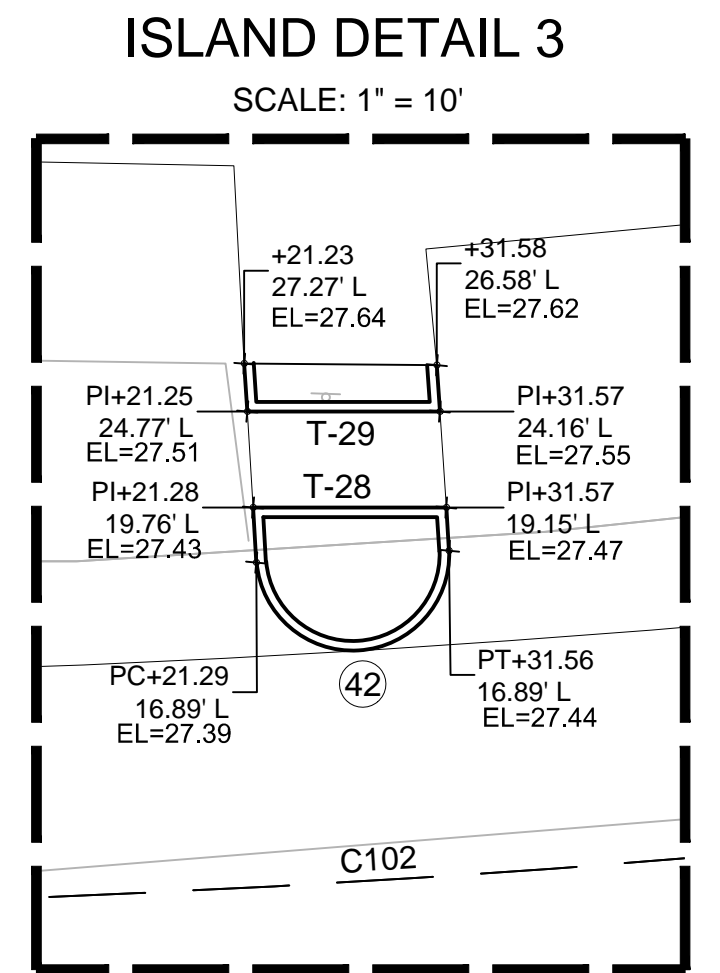

CURB TABLE		
NUMBER	LENGTH	RADIUS
36	22.71'	15.00'
41	6.86'	5.00'
47	20.40'	20.00'
47A	7.98'	20.00'
49	20.05'	20.00'
49A	12.79'	20.00'


CURB TABLE	
NUMBER	LENGTH
T-23	90.84
T-26	6.49
T-30	28.54
T-34	24.24
T-35	12.25
T-38	58.51
T-40	239.92
T-104	45.84

LEGEND

- # ADA RAMP/DRIVEWAY NO. (SEE DETAILS)
- ⊕ CURB CURVE NO.
- T-# CURB TANGENT NO.
- C # ALIGNMENT CURVE NO.
- L # ALIGNMENT TANGENT NO.

NOTES:

1. ALL CURBING TO BE VERTICAL GRANITE CURB (VGC) UNLESS NOTED OTHERWISE
2. ALL ELEVATIONS LISTED ARE BOTTOM OF CURB ELEVATIONS.

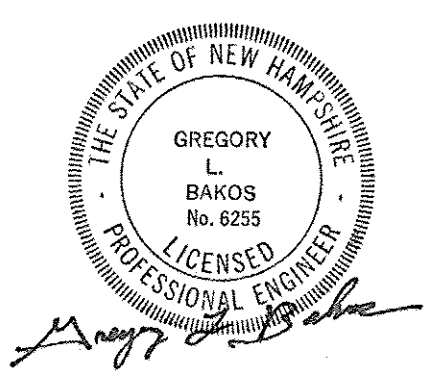

ISLINGTON STREET CORRIDOR IMPROVEMENTS - SEGMENT 1
CITY OF PORTSMOUTH, NEW HAMPSHIRE

GRADING & LAYOUT PLAN


DATE PLOTTED		VHB PROJECT NO.		DRAWING		CITY PROJECT NO.		SHEET NO.		TOTAL SHEETS	
13-Nov-18		52393.00		GRADE-Seg1		7176		30		88	



SDR PROCESSED	VHB	DATE	OCT 2017
NEW DESIGN	KMH	DATE	11/13/18
SHEET CHECKED	GLB	DATE	11/13/18
AS BUILT DETAILS		DATE	

CURB TABLE		
NUMBER	LENGTH	RADIUS
52	7.72'	5.00'
53	14.23'	12.00'
53A	4.29'	12.00'
54	10.78'	3.43'
55	17.04'	20.00'
56	4.60'	2.00'
59	7.85'	5.00'
60	10.81'	5.00'
62	18.51'	20.00'
62A	12.16'	20.00'
63	18.55'	20.00'
63A	12.87'	20.00'

CURB TABLE	
NUMBER	LENGTH
T-42	84.55
T-43	59.51
T-44	59.09
T-45	9.26
T-46	9.45
T-47	12.76
T-49	36.64
T-52	46.98
T-54	109.11
T-55	109.28
T-96	14.54

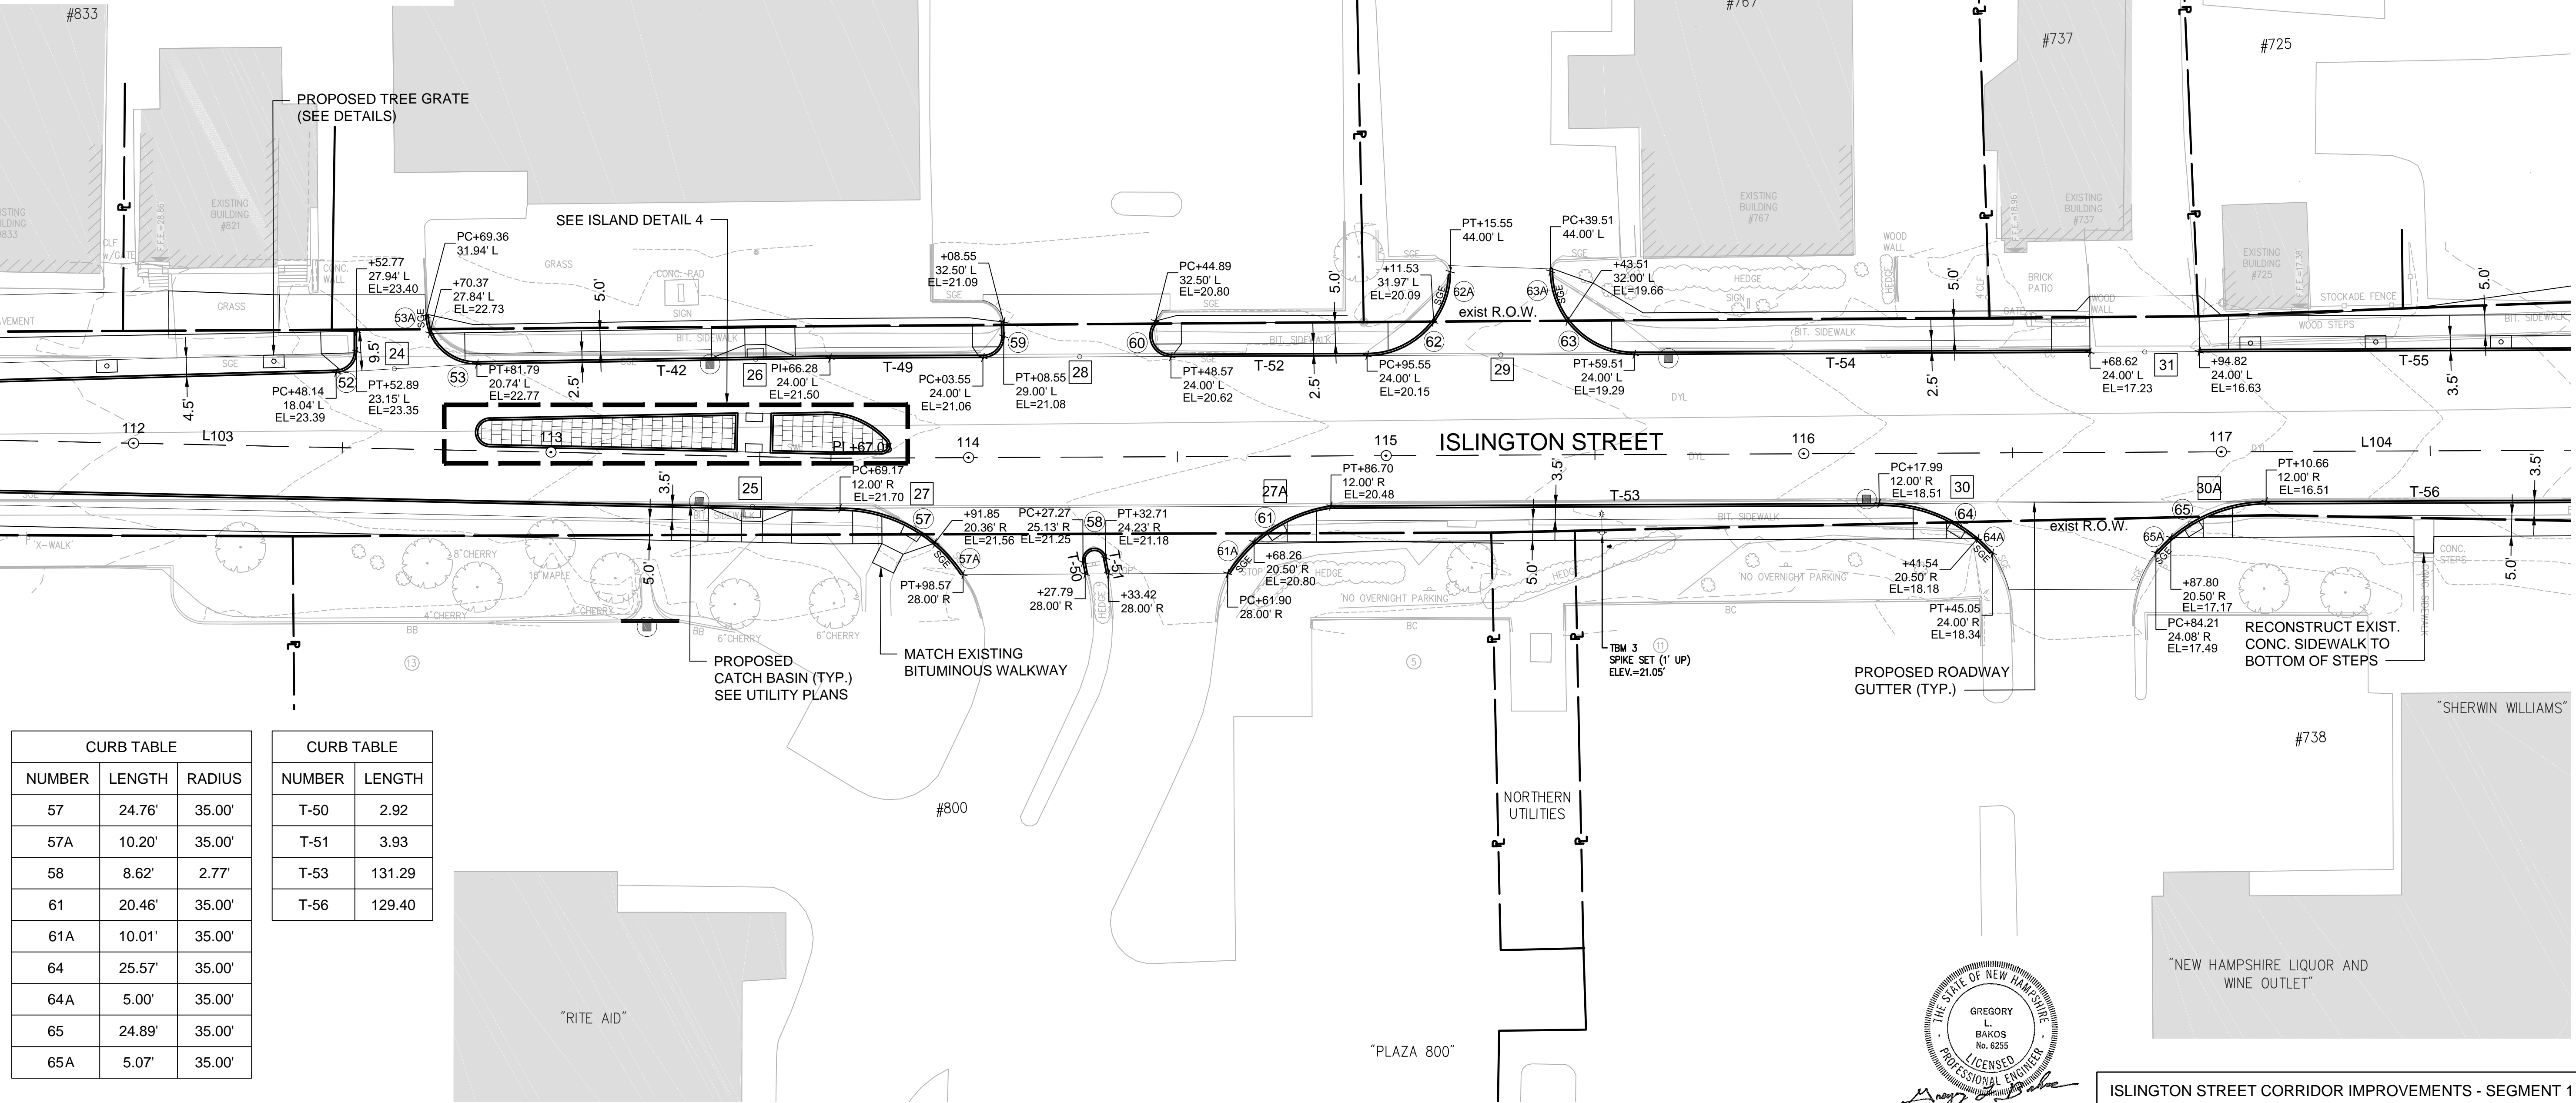

CURB TABLE		
NUMBER	LENGTH	RADIUS
57	24.76'	35.00'
57A	10.20'	35.00'
58	8.62'	2.77'
61	20.46'	35.00'
61A	10.01'	35.00'
64	25.57'	35.00'
64A	5.00'	35.00'
65	24.89'	35.00'
65A	5.07'	35.00'




CURB TABLE	
NUMBER	LENGTH
T-50	2.92
T-51	3.93
T-53	131.29
T-56	129.40

LEGEND

- # ADA RAMP/DRIVEWAY NO. (SEE DETAILS)
- ⊕ CURB CURVE NO.
- T-# CURB TANGENT NO.
- C# ALIGNMENT CURVE NO.
- L# ALIGNMENT TANGENT NO.

NOTES:

- ALL CURBING TO BE VERTICAL GRANITE CURB (VGC) UNLESS NOTED OTHERWISE
- ALL ELEVATIONS LISTED ARE BOTTOM OF CURB ELEVATIONS.

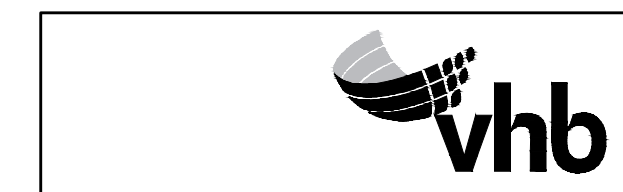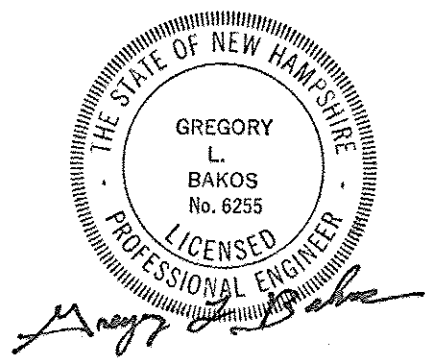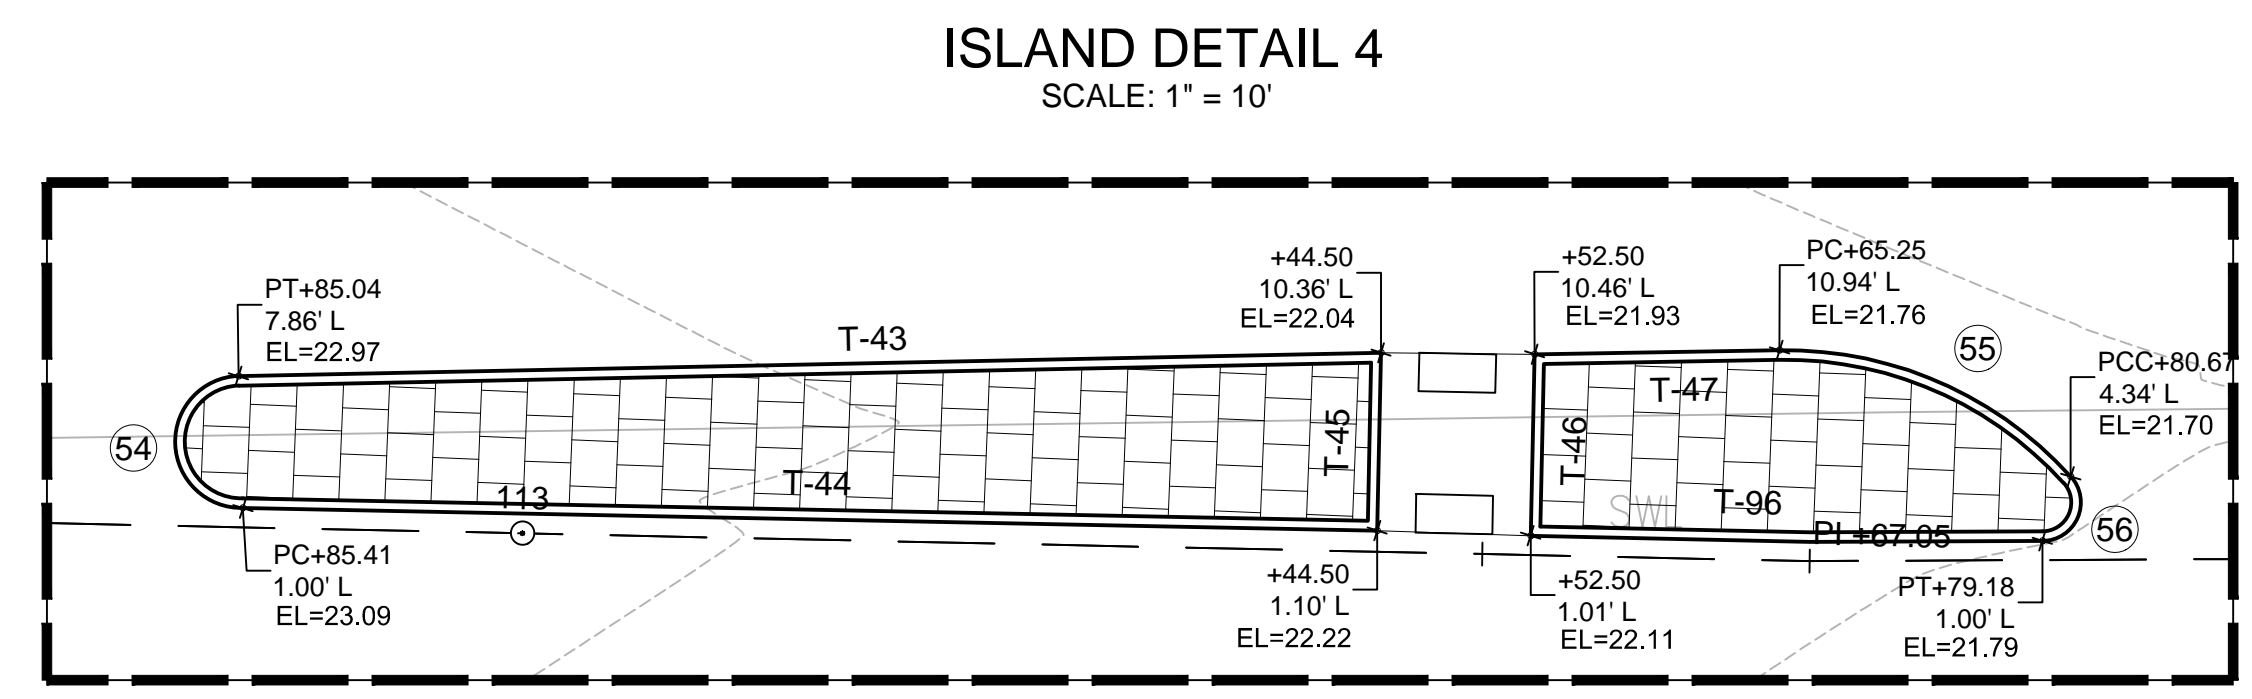

DATE PLOTTED	VHB PROJECT NO.	DRAWING	CITY PROJECT NO.	SHEET NO.	TOTAL SHEETS
13-Nov-18	52393.00	GRADE-Seg1	7176	31	88

ISLINGTON STREET CORRIDOR IMPROVEMENTS - SEGMENT 1
CITY OF PORTSMOUTH, NEW HAMPSHIRE
GRADING & LAYOUT PLAN


SDR PROCESSED VHB DATE OCT 2017
 NEW DESIGN KMV DATE 11/13/18
 SHEET CHECKED GLB DATE 11/13/18
 AS BUILT DETAILS

REVISIONS AFTER PROPOSAL
 STATION
 STATION
 DATE
 NUMBER




CURB TABLE		
NUMBER	LENGTH	RADIUS
86	23.56'	15.00'
89	23.68'	15.00'
90	36.94'	1988.00'
92	23.20'	15.00'
96	71.89'	772.00'
100	54.96'	772.00'
102	15.06'	10.00'
104	25.48'	772.00'
105	14.04'	10.00'
106	6.30'	5.00'
107	16.77'	772.00'
108	8.12'	5.00'
110	7.85'	5.00'

CURB TABLE	
NUMBER	LENGTH
T-76	3.93
T-77	5.28
T-80	9.97
T-82	122.35
T-87	8.04

ISLAND DETAIL 6
SCALE: 1" = 10'

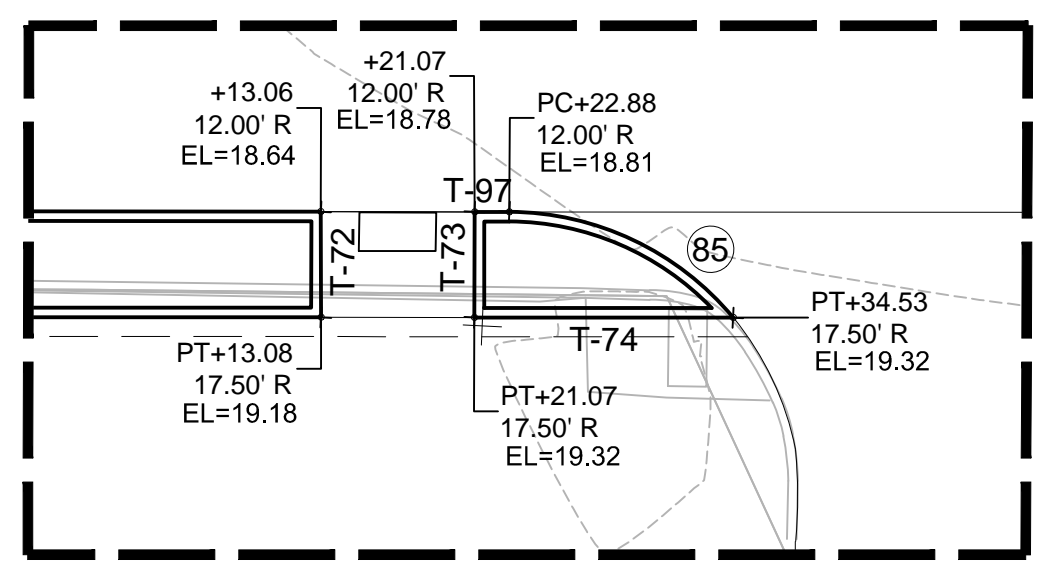


SIDEWALK DETAIL 2
SCALE: 1" = 10'

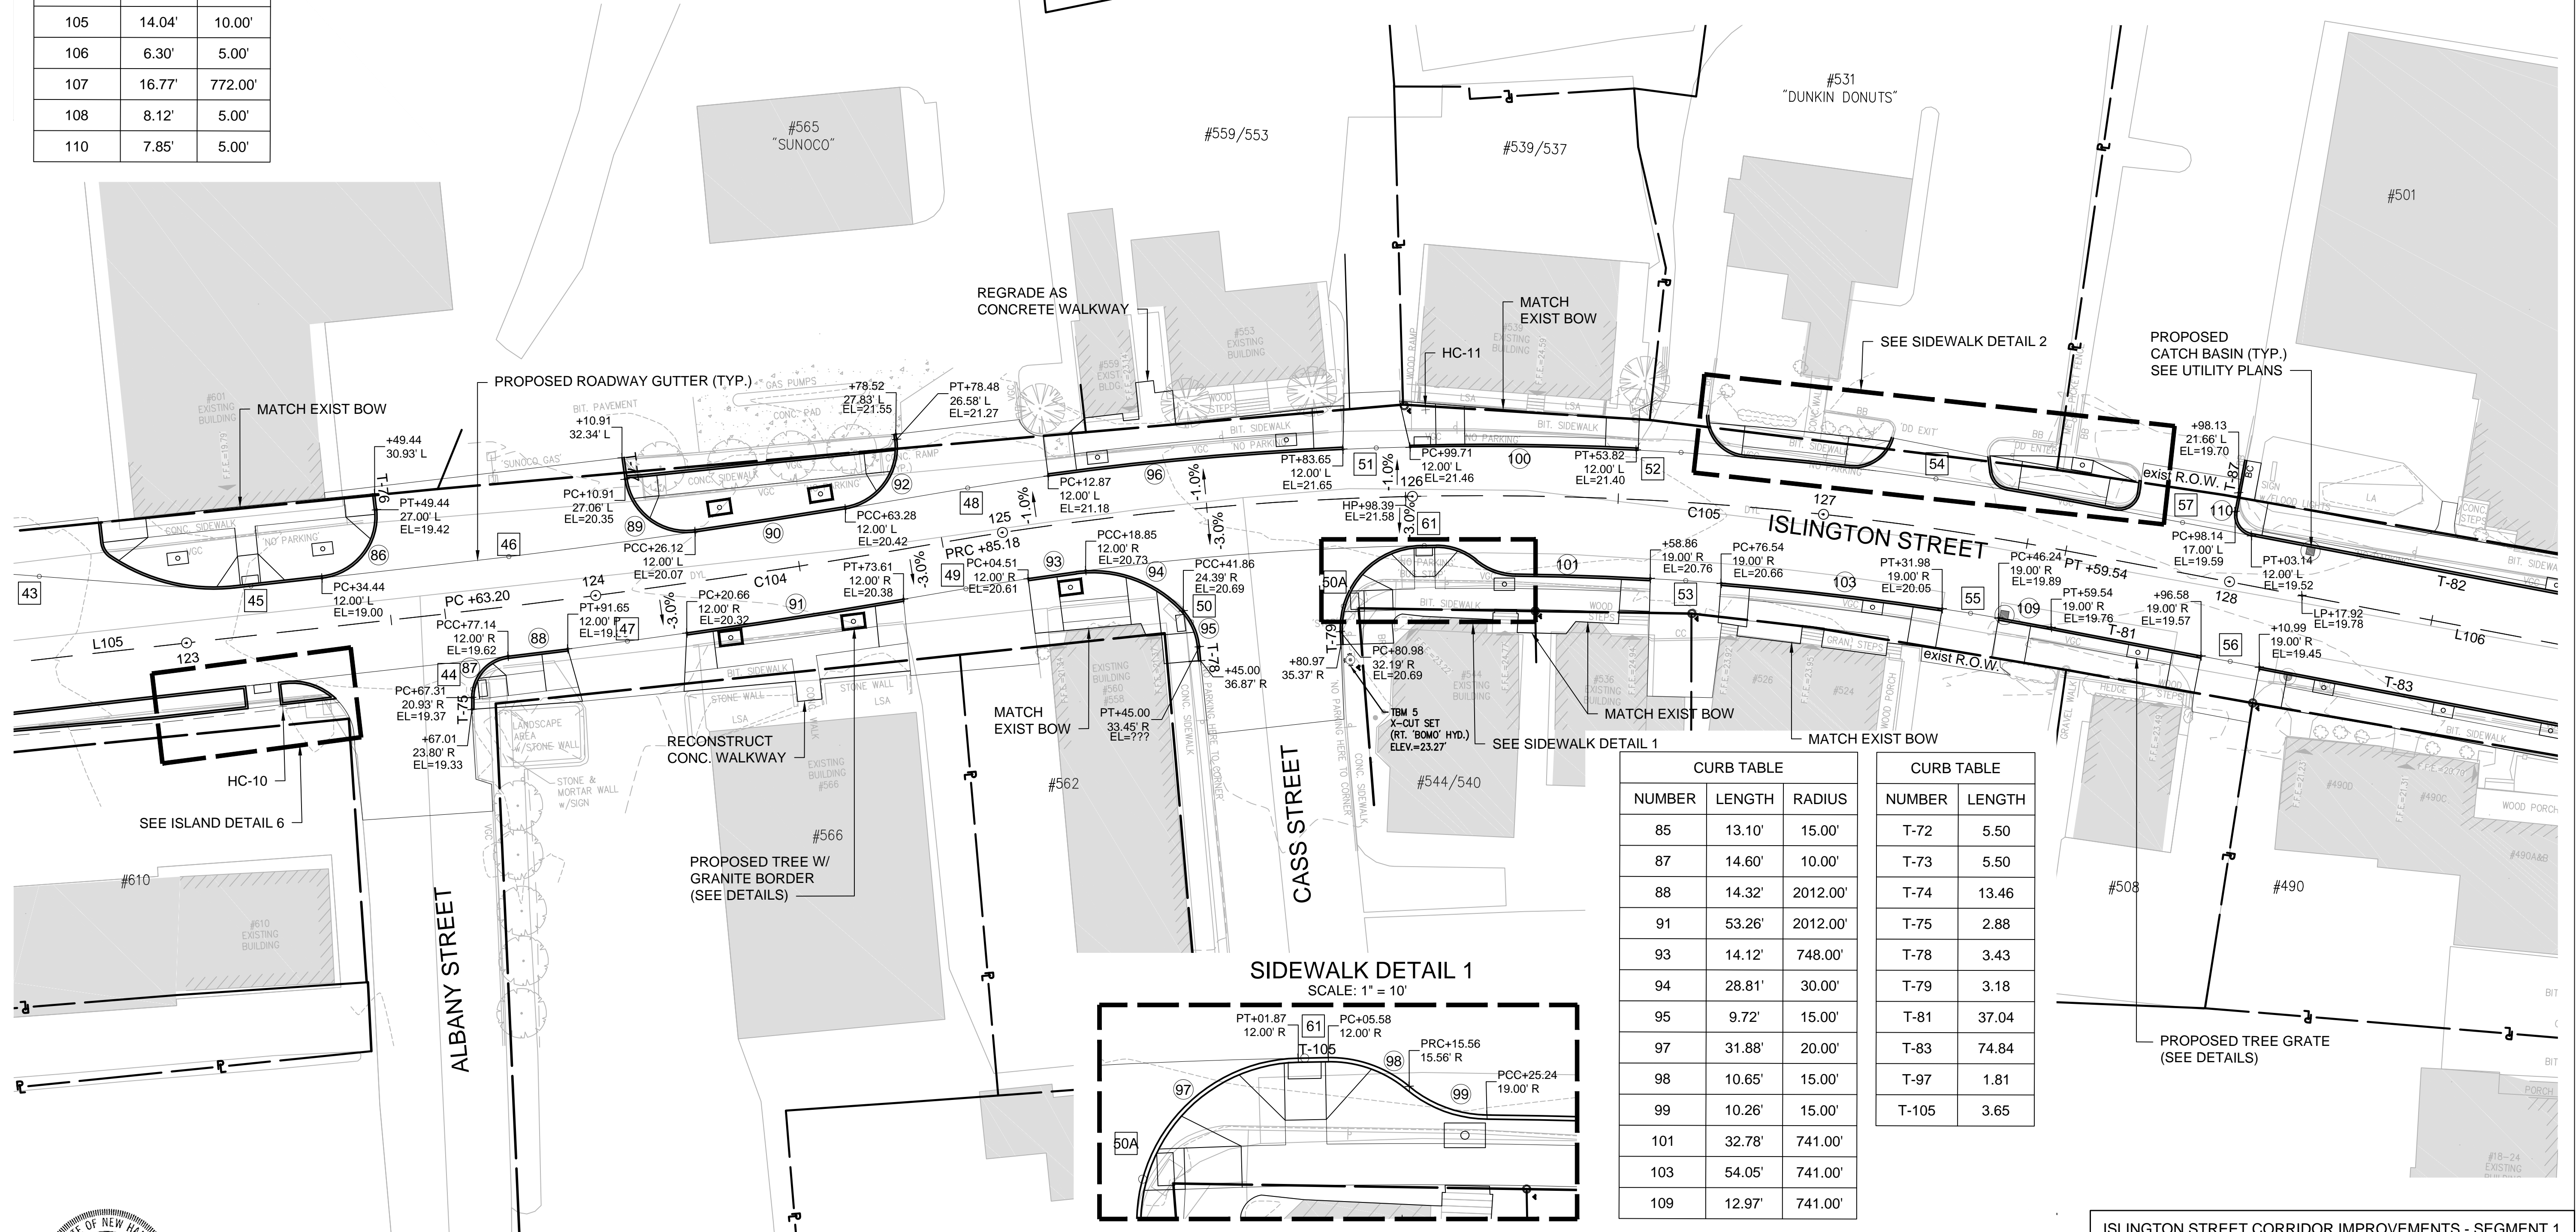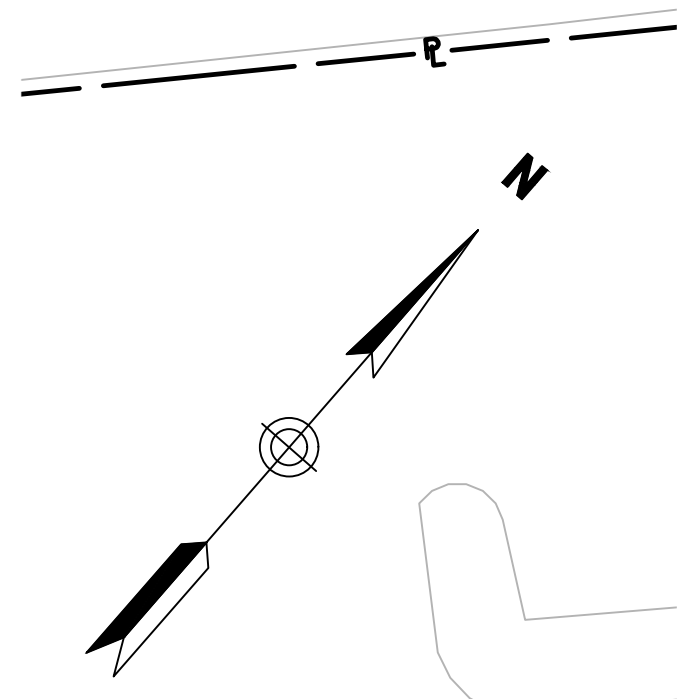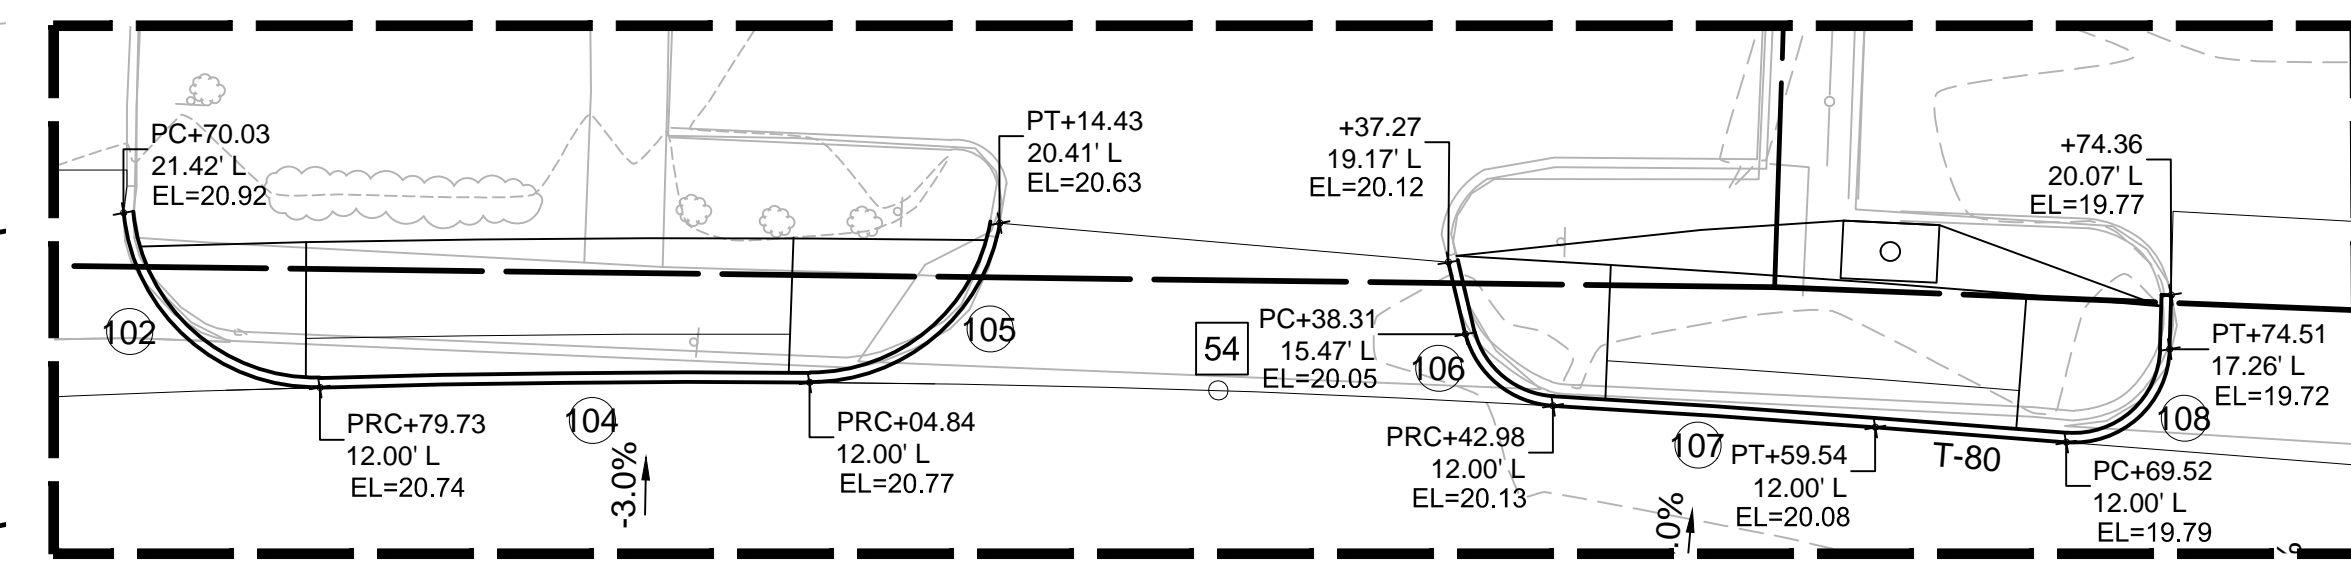

CURB TABLE		
NUMBER	LENGTH	RADIUS
85	13.10'	15.00'
87	14.60'	10.00'
88	14.32'	2012.00'
91	53.26'	2012.00'
93	14.12'	748.00'
94	28.81'	30.00'
95	9.72'	15.00'
97	31.88'	20.00'
98	10.65'	15.00'
99	10.26'	15.00'
101	32.78'	741.00'
103	54.05'	741.00'
109	12.97'	741.00'

CURB TABLE	
NUMBER	LENGTH
T-72	5.50
T-73	5.50
T-74	13.46
T-75	2.88
T-78	3.43
T-79	3.18
T-81	37.04
T-83	74.84
T-97	1.81
T-105	3.65

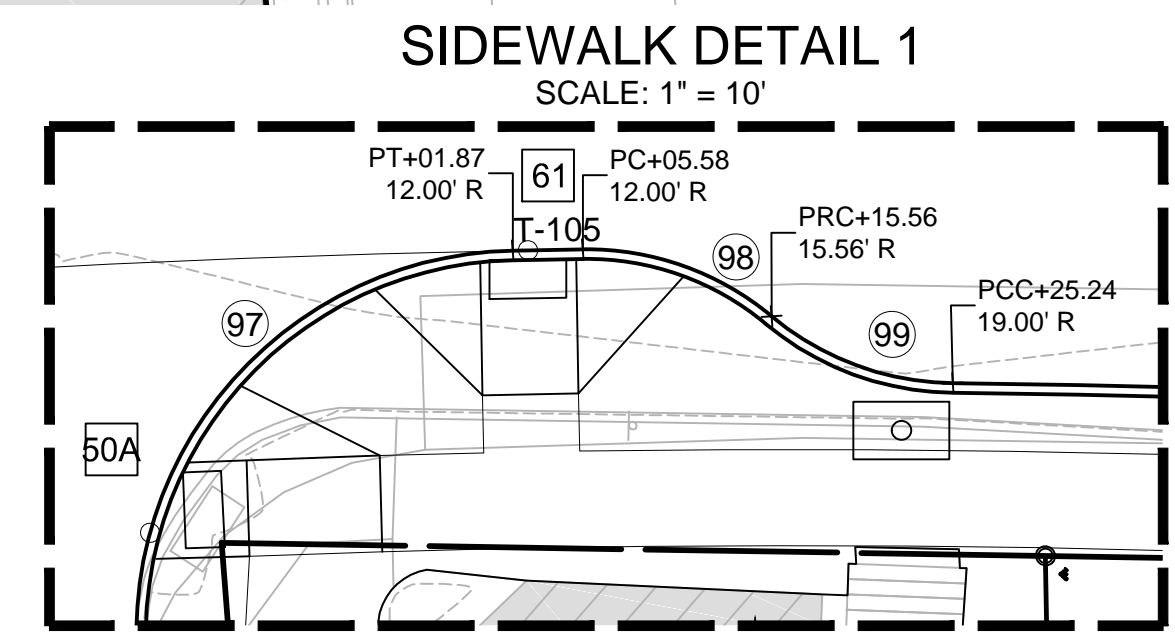


LEGEND

- # ADA RAMP/DRIVEWAY NO. (SEE DETAILS)
- ⊙ CURB CURVE NO.
- T-# CURB TANGENT NO.
- C # ALIGNMENT CURVE NO.
- L # ALIGNMENT TANGENT NO.

NOTES:

1. ALL CURBING TO BE VERTICAL GRANITE CURB (VGC) UNLESS NOTED OTHERWISE
2. ALL ELEVATIONS LISTED ARE BOTTOM OF CURB ELEVATIONS.

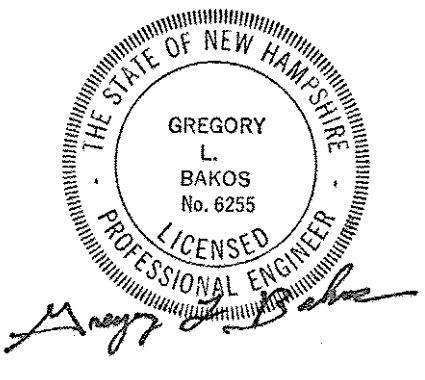


ISLINGTON STREET CORRIDOR IMPROVEMENTS - SEGMENT 1
 CITY OF PORTSMOUTH, NEW HAMPSHIRE


GRADING & LAYOUT PLAN

DATE PLOTTED	VHB PROJECT NO.	DRAWING	CITY PROJECT NO.	SHEET NO.	TOTAL SHEETS
13-Nov-18	52393.00	GRADE-Seg1	7176	33	88

SDR PROCESSED	VHB	DATE	OCT 2017
NEW DESIGN	MLG	DATE	1/7/19
SHEET CHECKED	MDS	DATE	1/7/19
AS BUILT DETAILS		DATE	

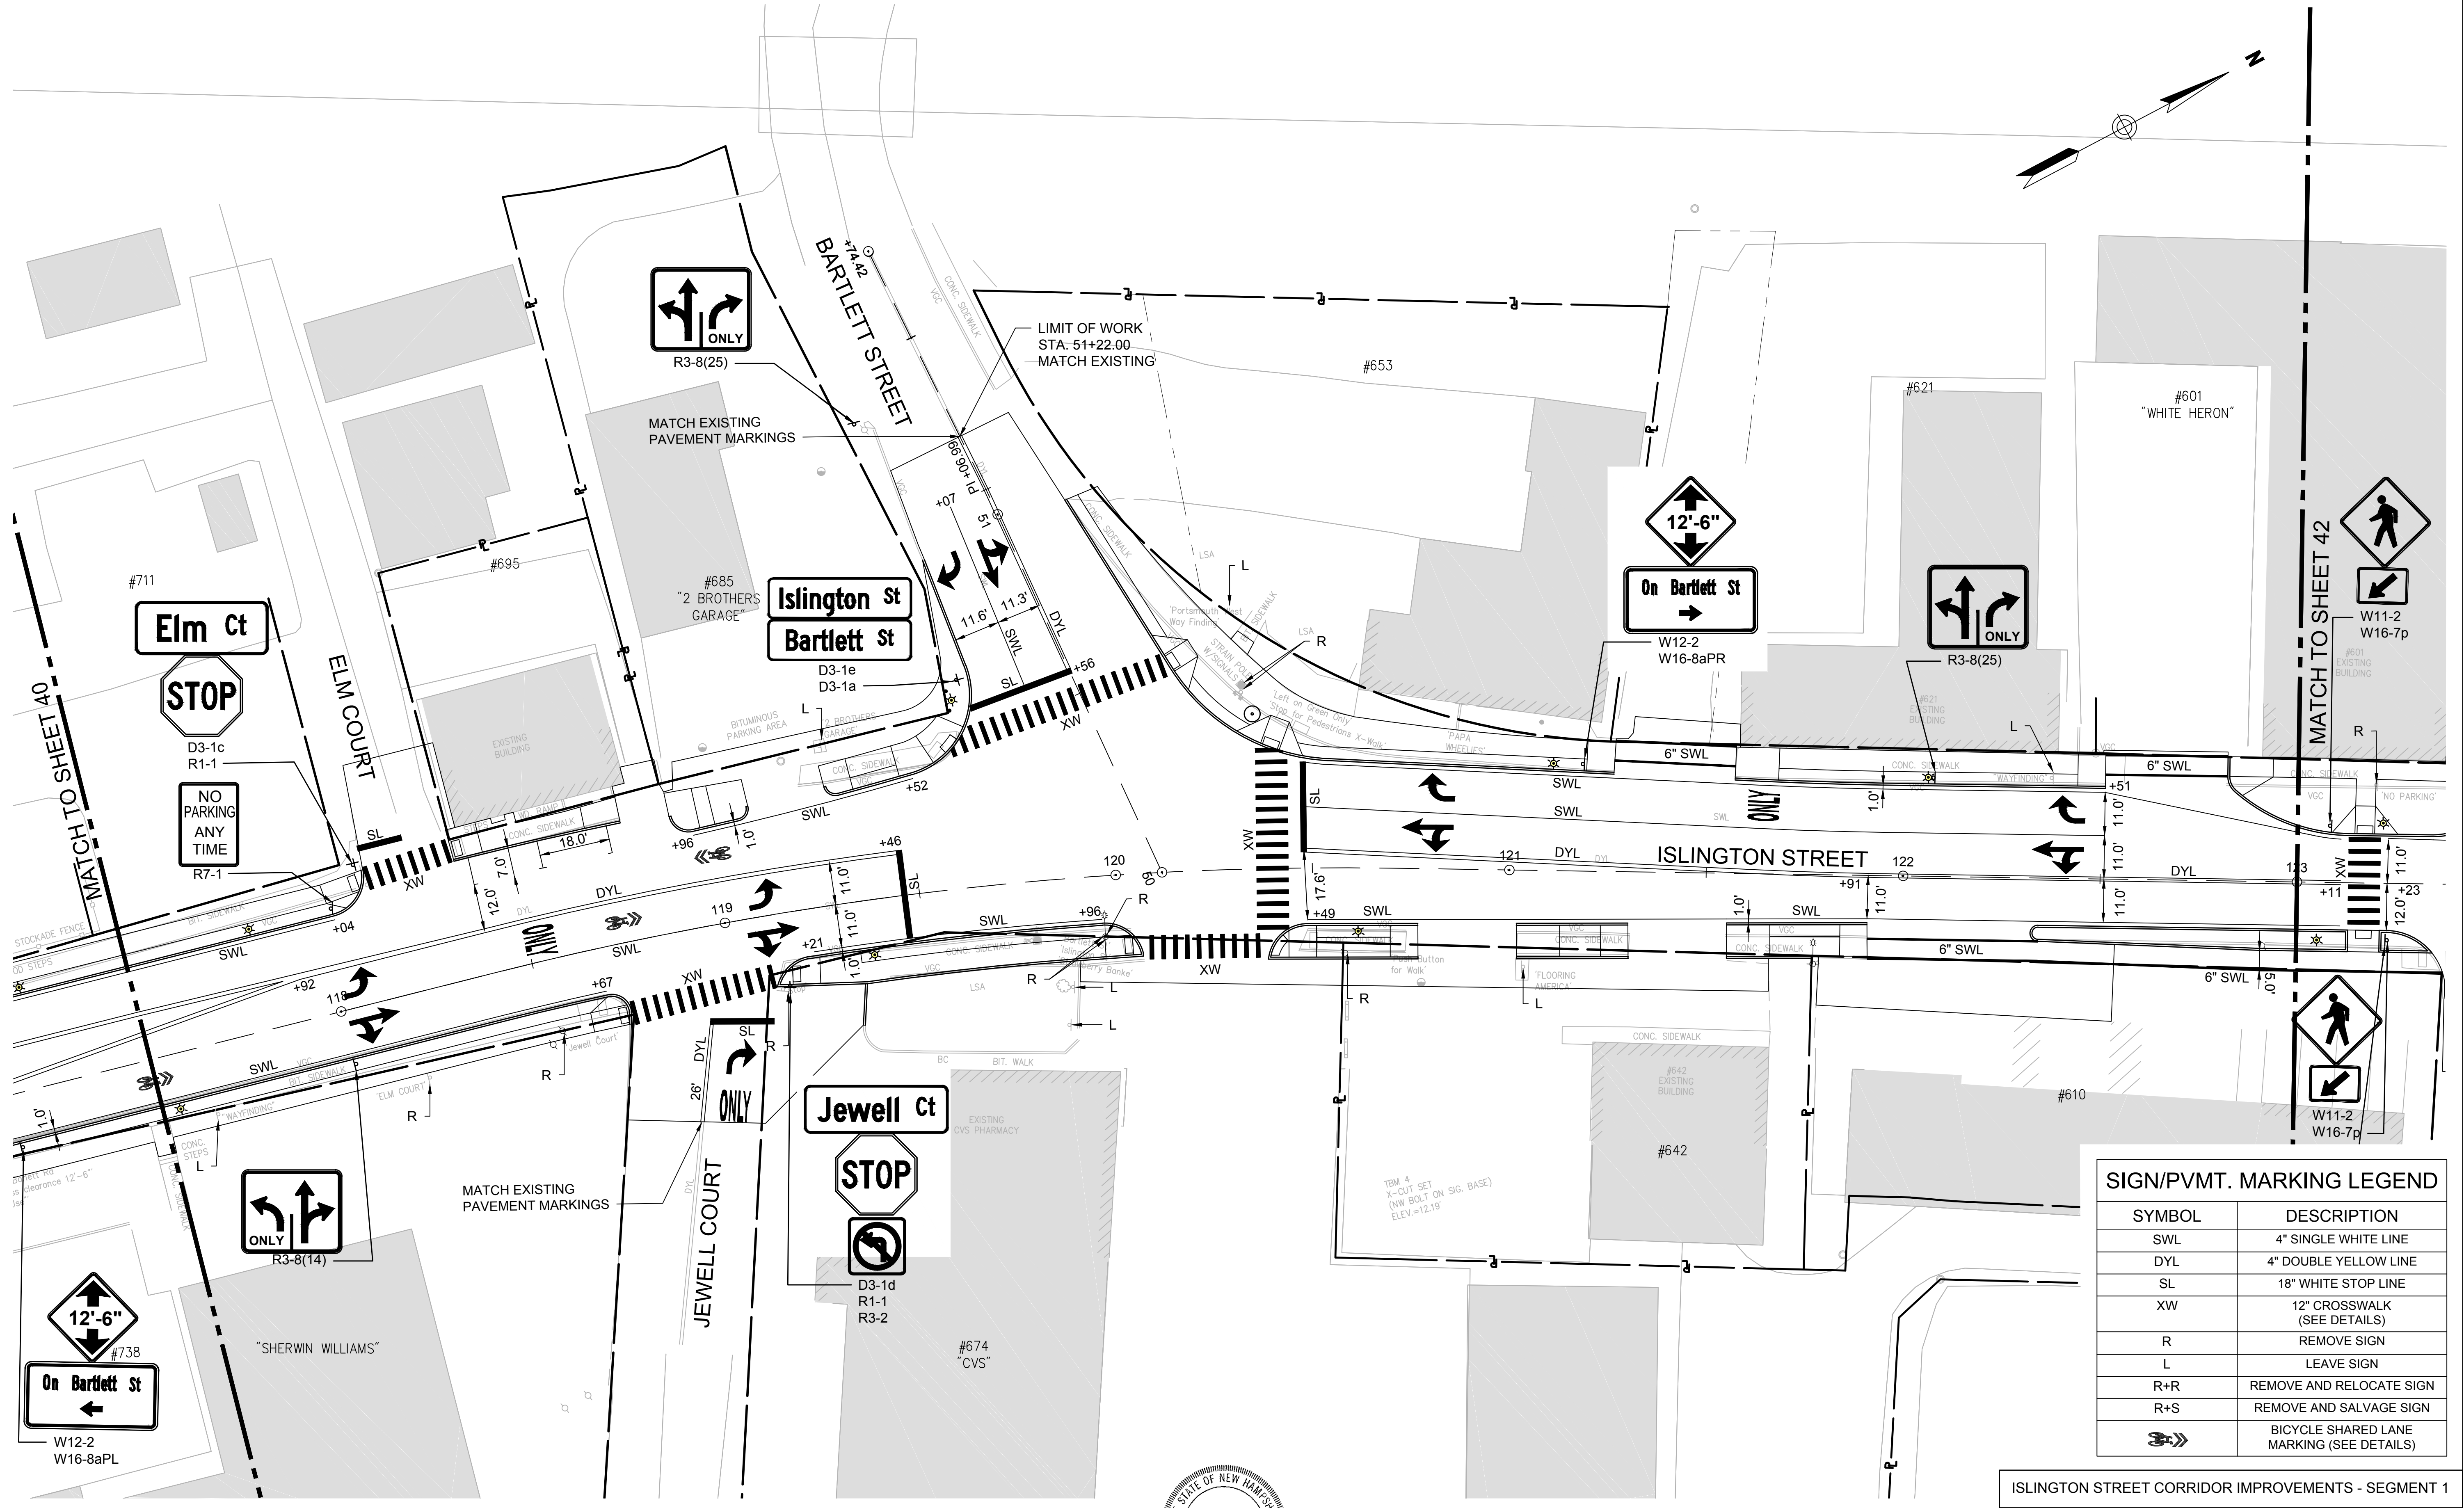

- NOTES:
1. ALL CROSSWALKS, STOP LINES, ARROWS, AND LEGENDS SHALL BE THERMOPLASTIC MARKINGS. CROSSWALKS SHALL BE 6' WIDE CROSSING SIDE ROADS AND DRIVEWAYS AND 8' WIDE CROSSING ISLINGTON STREET.
 - 2.

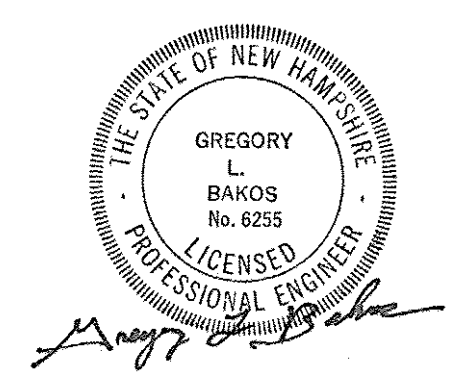

SYMBOL	DESCRIPTION
SWL	4" SINGLE WHITE LINE
DYL	4" DOUBLE YELLOW LINE
SL	18" WHITE STOP LINE
XW	12" CROSSWALK (SEE DETAILS)
R	REMOVE SIGN
L	LEAVE SIGN
R+R	REMOVE AND RELOCATE SIGN
R+S	REMOVE AND SALVAGE SIGN
	BICYCLE SHARED LANE MARKING (SEE DETAILS)


ISLINGTON STREET CORRIDOR IMPROVEMENTS - SEGMENT 1
 CITY OF PORTSMOUTH, NEW HAMPSHIRE

PAVEMENT MARKING & SIGNING PLAN

DATE PLOTTED	VHB PROJECT NO.	DRAWING	CITY PROJECT NO.	SHEET NO.	TOTAL SHEETS
7-Jan-19	52393.00	PMSIGN-SEG1	7176	41	88



PROPOSED TREES				
KEY	BOTANICAL NAME	COMMON NAME	QTY	COMMENTS
AG	ACER GRISEUM	PAPERBARK MAPLE	1	
ED	EVODIA DANIELLII	KOREAN EVODIA	2	
GD	GYMNOCLADUS DIOICA	KENTUCKY COFFEETREE	1	
GF	GINKGO FASTIGIATA	FASTIGATE GINKO	2	
LXW	LABURNUM X WATERERI	GOLDEN CHAINTREE	1	
MG	METASEQUOIA GLYPTOSTROBODES	DAWN REDWOOD	1	
TOTAL:			8	

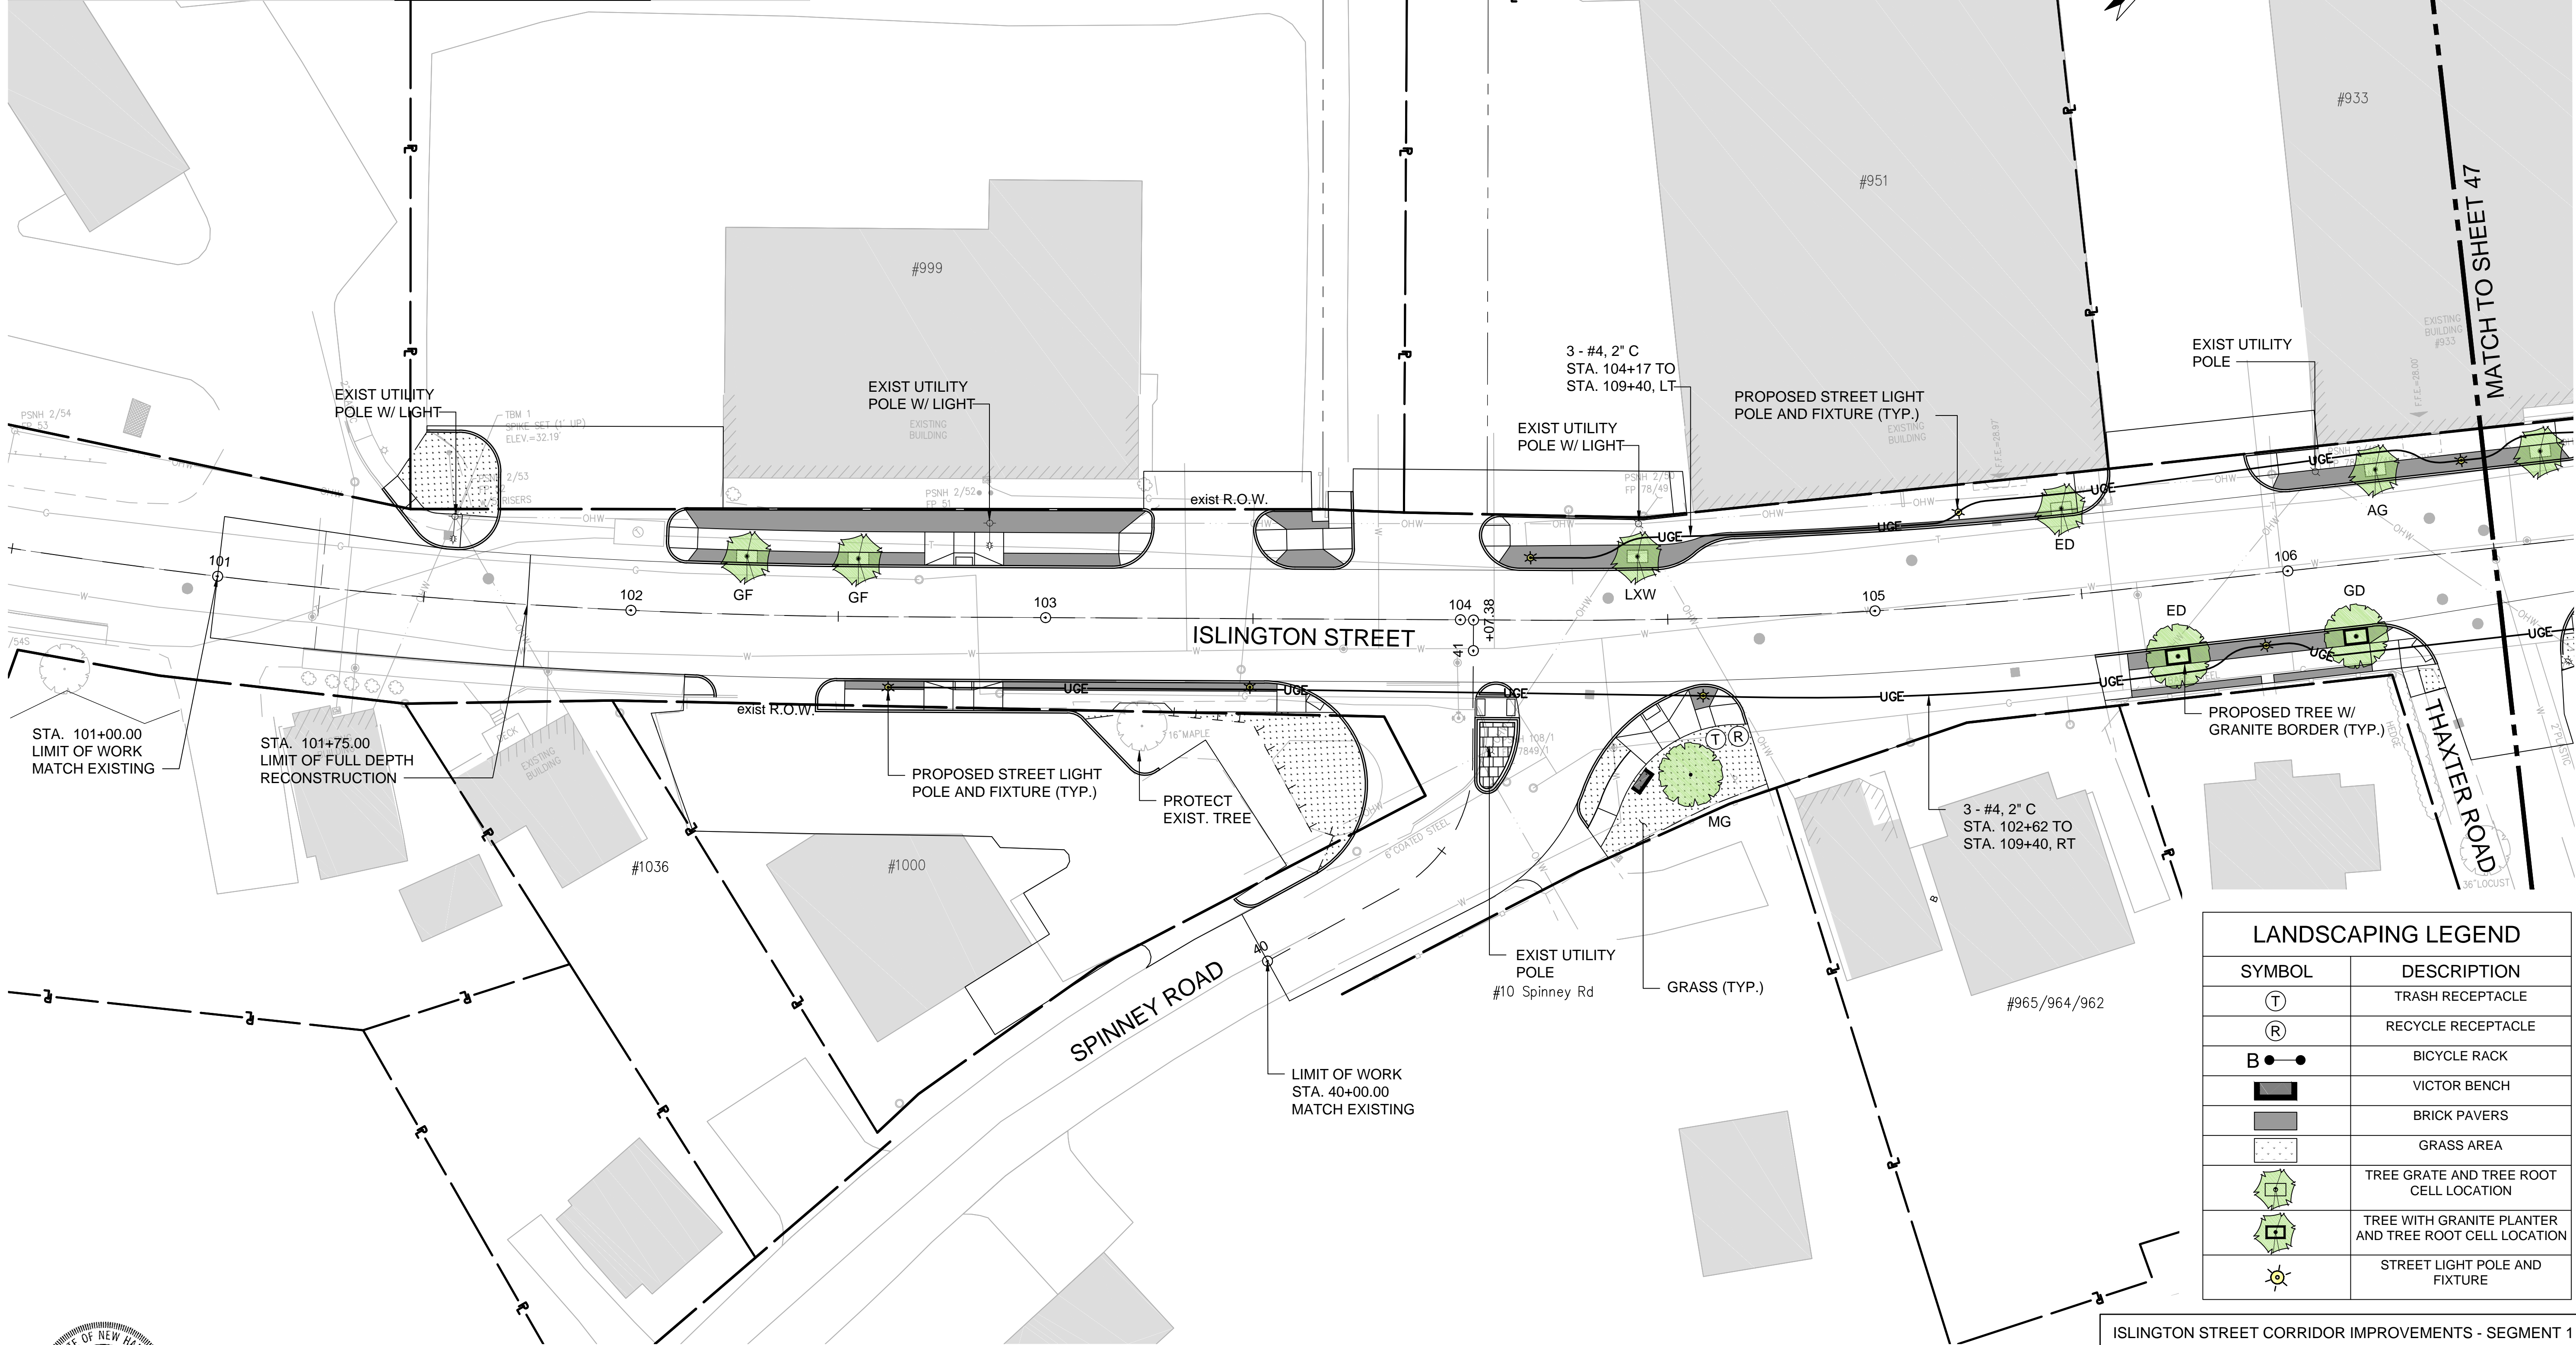

LANDSCAPING LEGEND	
SYMBOL	DESCRIPTION
(T)	TRASH RECEPTACLE
(R)	RECYCLE RECEPTACLE
B ● ●	BICYCLE RACK
▬	VICTOR BENCH
▬	BRICK PAVERS
▬	GRASS AREA
⊕	TREE GRATE AND TREE ROOT CELL LOCATION
⊕	TREE WITH GRANITE PLANTER AND TREE ROOT CELL LOCATION
☼	STREET LIGHT POLE AND FIXTURE

- NOTES:**
- ALL LIGHTING CONDUIT SHALL BE 2" PVC SCHEDULE 40, AND SCHEDULE 80 UNDER ROADWAYS.
 - ALL TREES SHALL BE 2" - 2 1/2" CAL.




ISLINGTON STREET CORRIDOR IMPROVEMENTS - SEGMENT 1

CITY OF PORTSMOUTH, NEW HAMPSHIRE

LANDSCAPING & LIGHTING PLAN

DATE PLOTTED	VHB PROJECT NO.	DRAWING	CITY PROJECT NO.	SHEET NO.	TOTAL SHEETS
13-Nov-18	52393.00	LD-Seg1	7176	46	88

SDR PROCESSED	VHB	DATE	\$SDR DATES
NEW DESIGN	KMH	DATE	11/13/18
SHEET CHECKED	GLB	DATE	11/13/18
AS BUILT DETAILS		DATE	

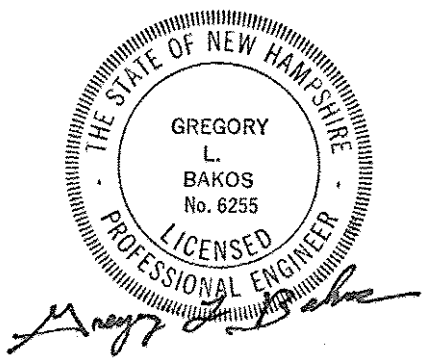


PROPOSED TREES				
KEY	BOTANICAL NAME	COMMON NAME	QTY	COMMENTS
AT	ACER TARTARICUM	TARTARIAN MAPLE (SINGLE STEM)	1	SINGLE STEM
CJ	CERCIDIPHYLLUM JAPONICUM	KATSURA TREE	1	
CR	CHIONANTHUS RETUSUS	CHINESE FRINGETREE	1	
GF	GINKGO FASTIGIATA	FASTIGATE GINKO	2	
LS	LIQUIDAMBAR STYRACIFLUA	SWEET GUM	2	
MA	MAACKIA AMURENSIS	AMUR MAACKIA	1	
NS	NYSSA SYLVATICA	BLACK GUM	1	
PP	PARROTIA PERSICA	PERSIAN IRONWOOD/PARROTIA	1	/PERSIAN PARROTIA
PS	PRUNUS SUBHIRTILLA	HIGAN CHERRY	1	
SR	SYRINGA RETICULATA	JAPANESE TREE LILAC	3	
TOTAL:			14	



LANDSCAPING LEGEND	
SYMBOL	DESCRIPTION
(T)	TRASH RECEPTACLE
(R)	RECYCLE RECEPTACLE
B ● ●	BICYCLE RACK
■	VICTOR BENCH
■	BRICK PAVERS
■	GRASS AREA
(Tree symbol)	TREE GRATE AND TREE ROOT CELL LOCATION
(Tree symbol)	TREE WITH GRANITE PLANTER AND TREE ROOT CELL LOCATION
(Light pole symbol)	STREET LIGHT POLE AND FIXTURE

NOTE:
 1. ALL LIGHTING CONDUIT SHALL BE 2" PVC SCHEDULE 40, AND SCHEDULE 80 UNDER ROADWAYS.
 2. ALL TREES SHALL BE 2" - 2 1/2" CAL.

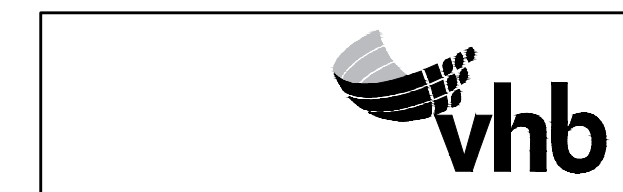


DATE PLOTTED	VHB PROJECT NO.	DRAWING	CITY PROJECT NO.	SHEET NO.	TOTAL SHEETS
13-Nov-18	52393.00	LD-Seg1	7176	50	88

ISLINGTON STREET CORRIDOR IMPROVEMENTS - SEGMENT 1
 CITY OF PORTSMOUTH, NEW HAMPSHIRE

LANDSCAPING & LIGHTING PLAN

SDR PROCESSED	VHB	DATE	11/13/18
	KMH	DATE	11/13/18
NEW DESIGN	GLB	DATE	11/13/18
SHEET CHECKED		DATE	
AS BUILT DETAILS		DATE	

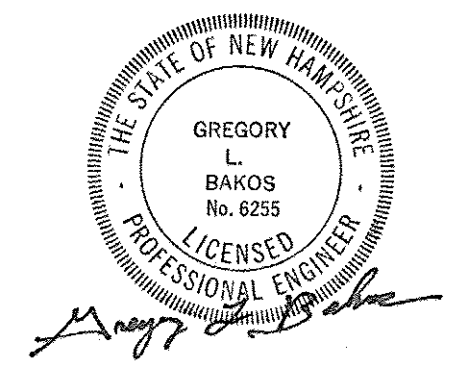

REVISIONS AFTER PROPOSAL	STATION	DESCRIPTION

DESCRIPTION

REVISIONS AFTER PROPOSAL

STATION

STATION

DATE

NUMBER

DATE

DATE

DATE

VHB

KMH

GLB

AS BUILT DETAILS









OCT 2017

11/13/18

11/13/18

NEW DESIGN

SHEET CHECKED

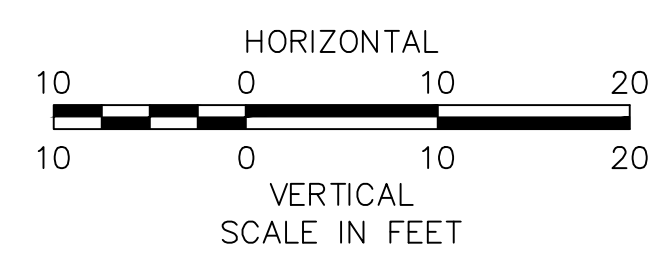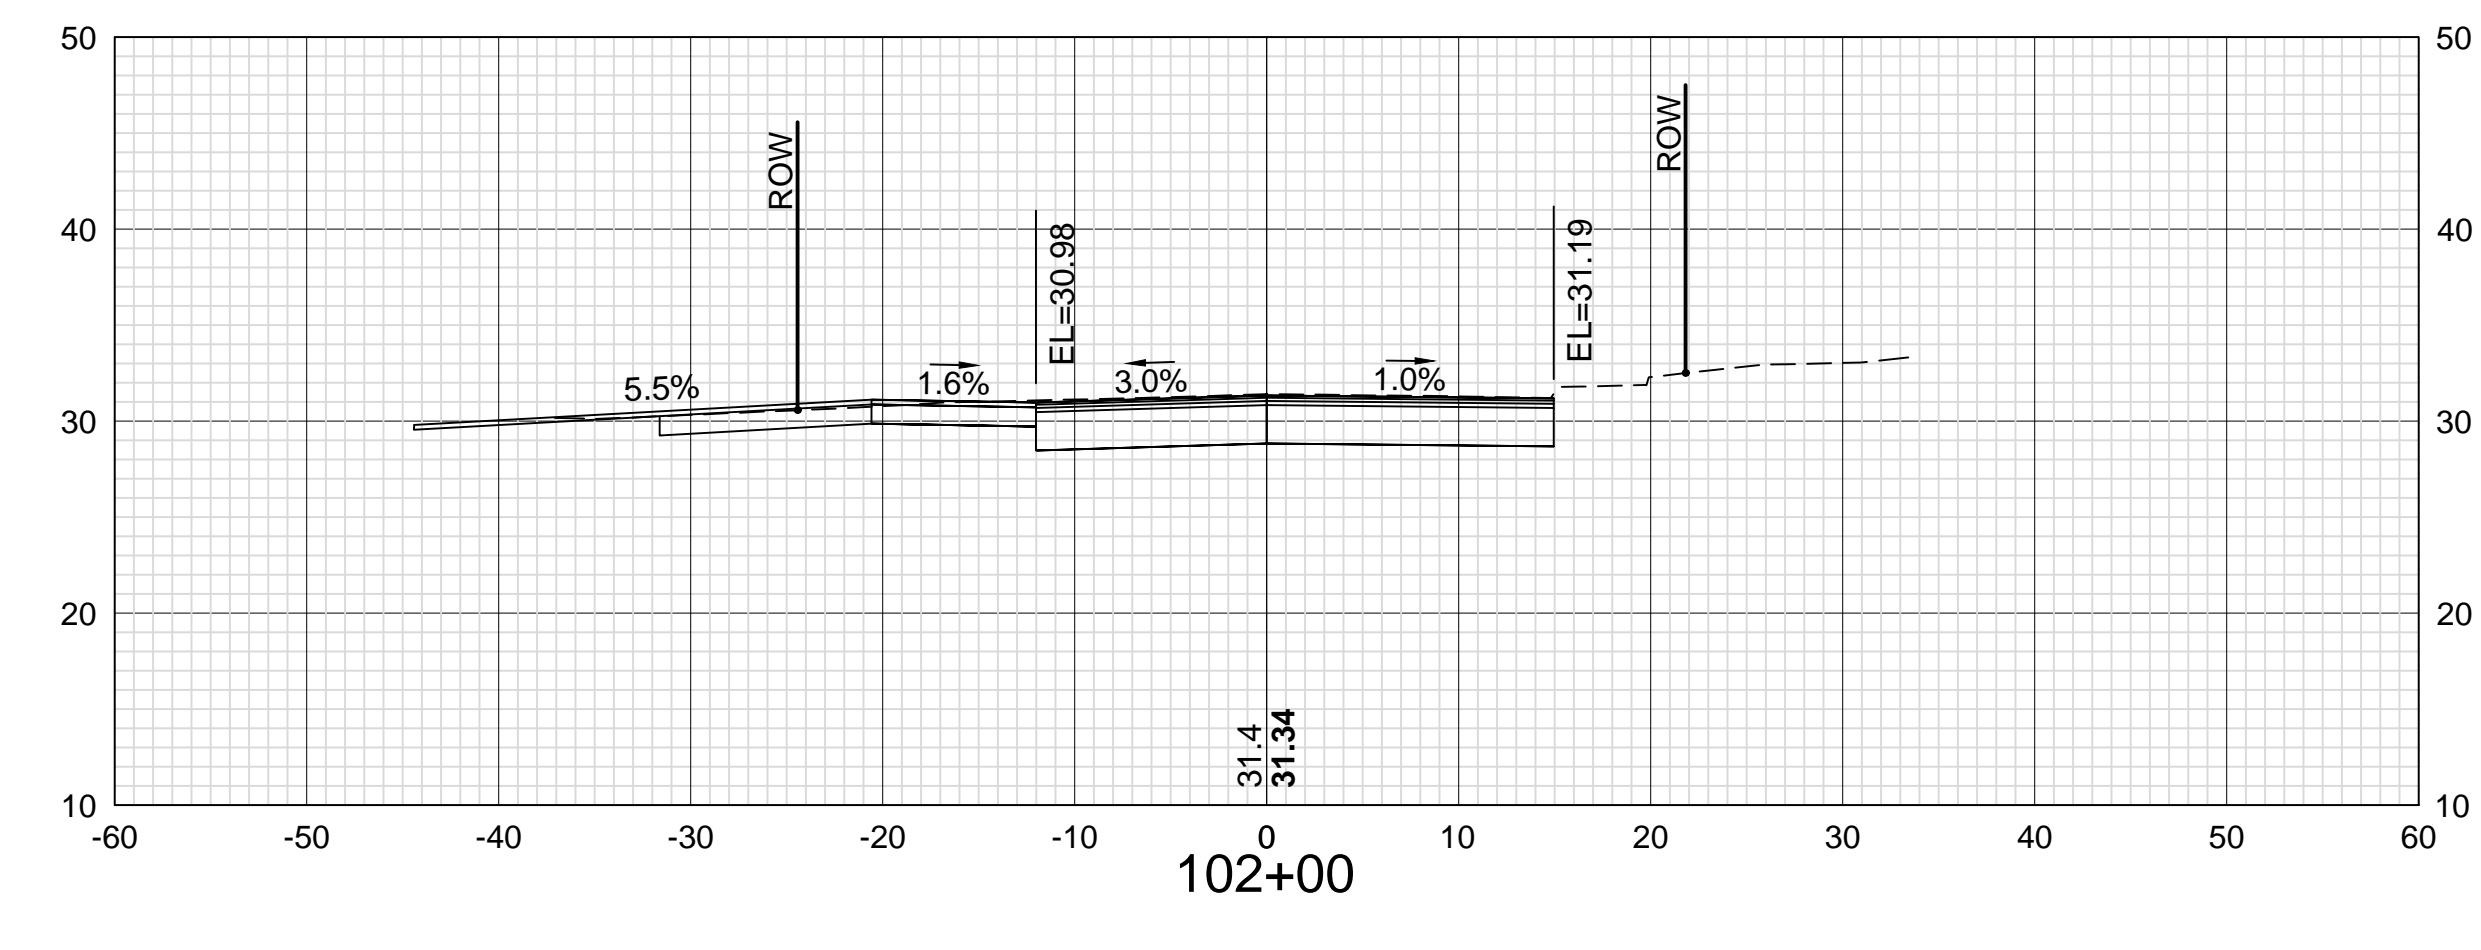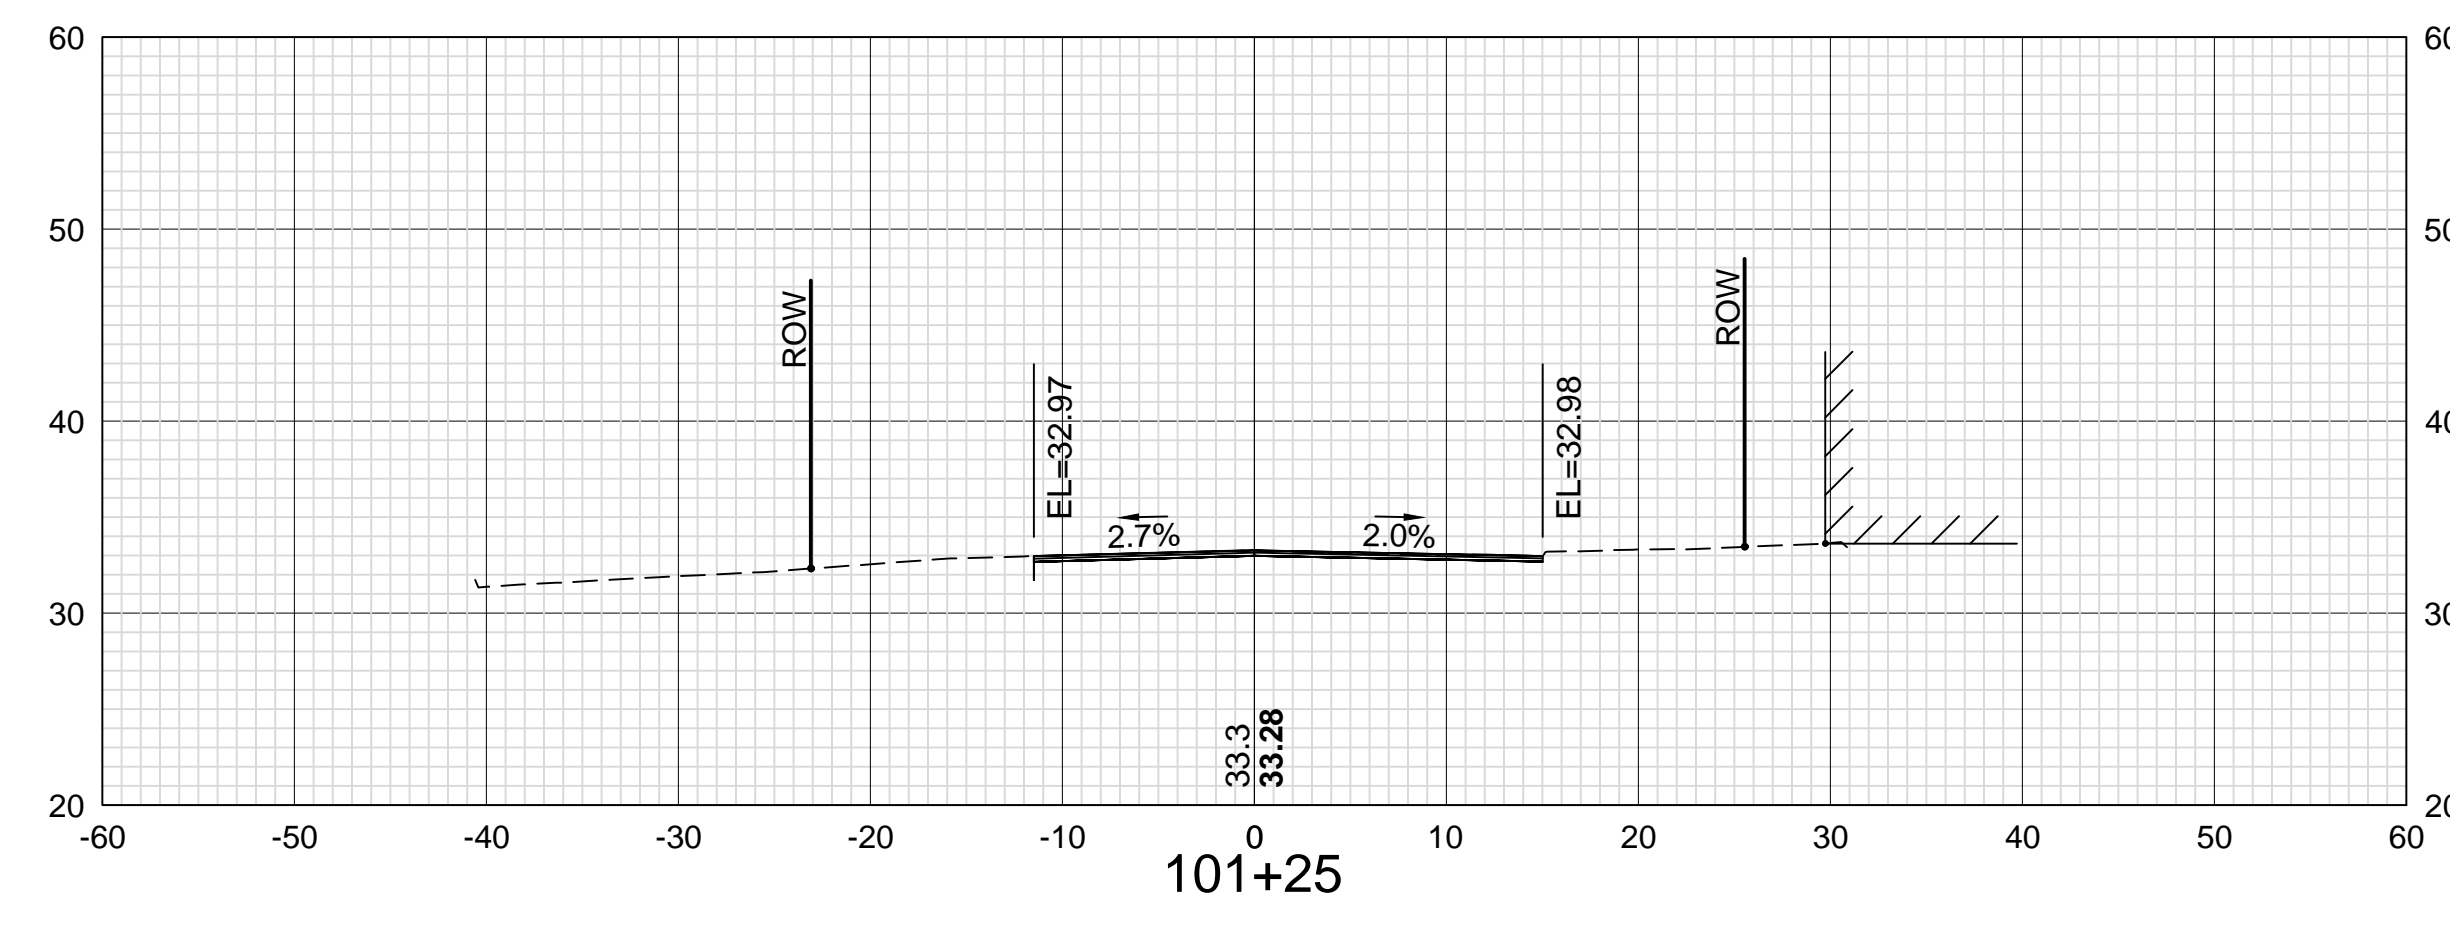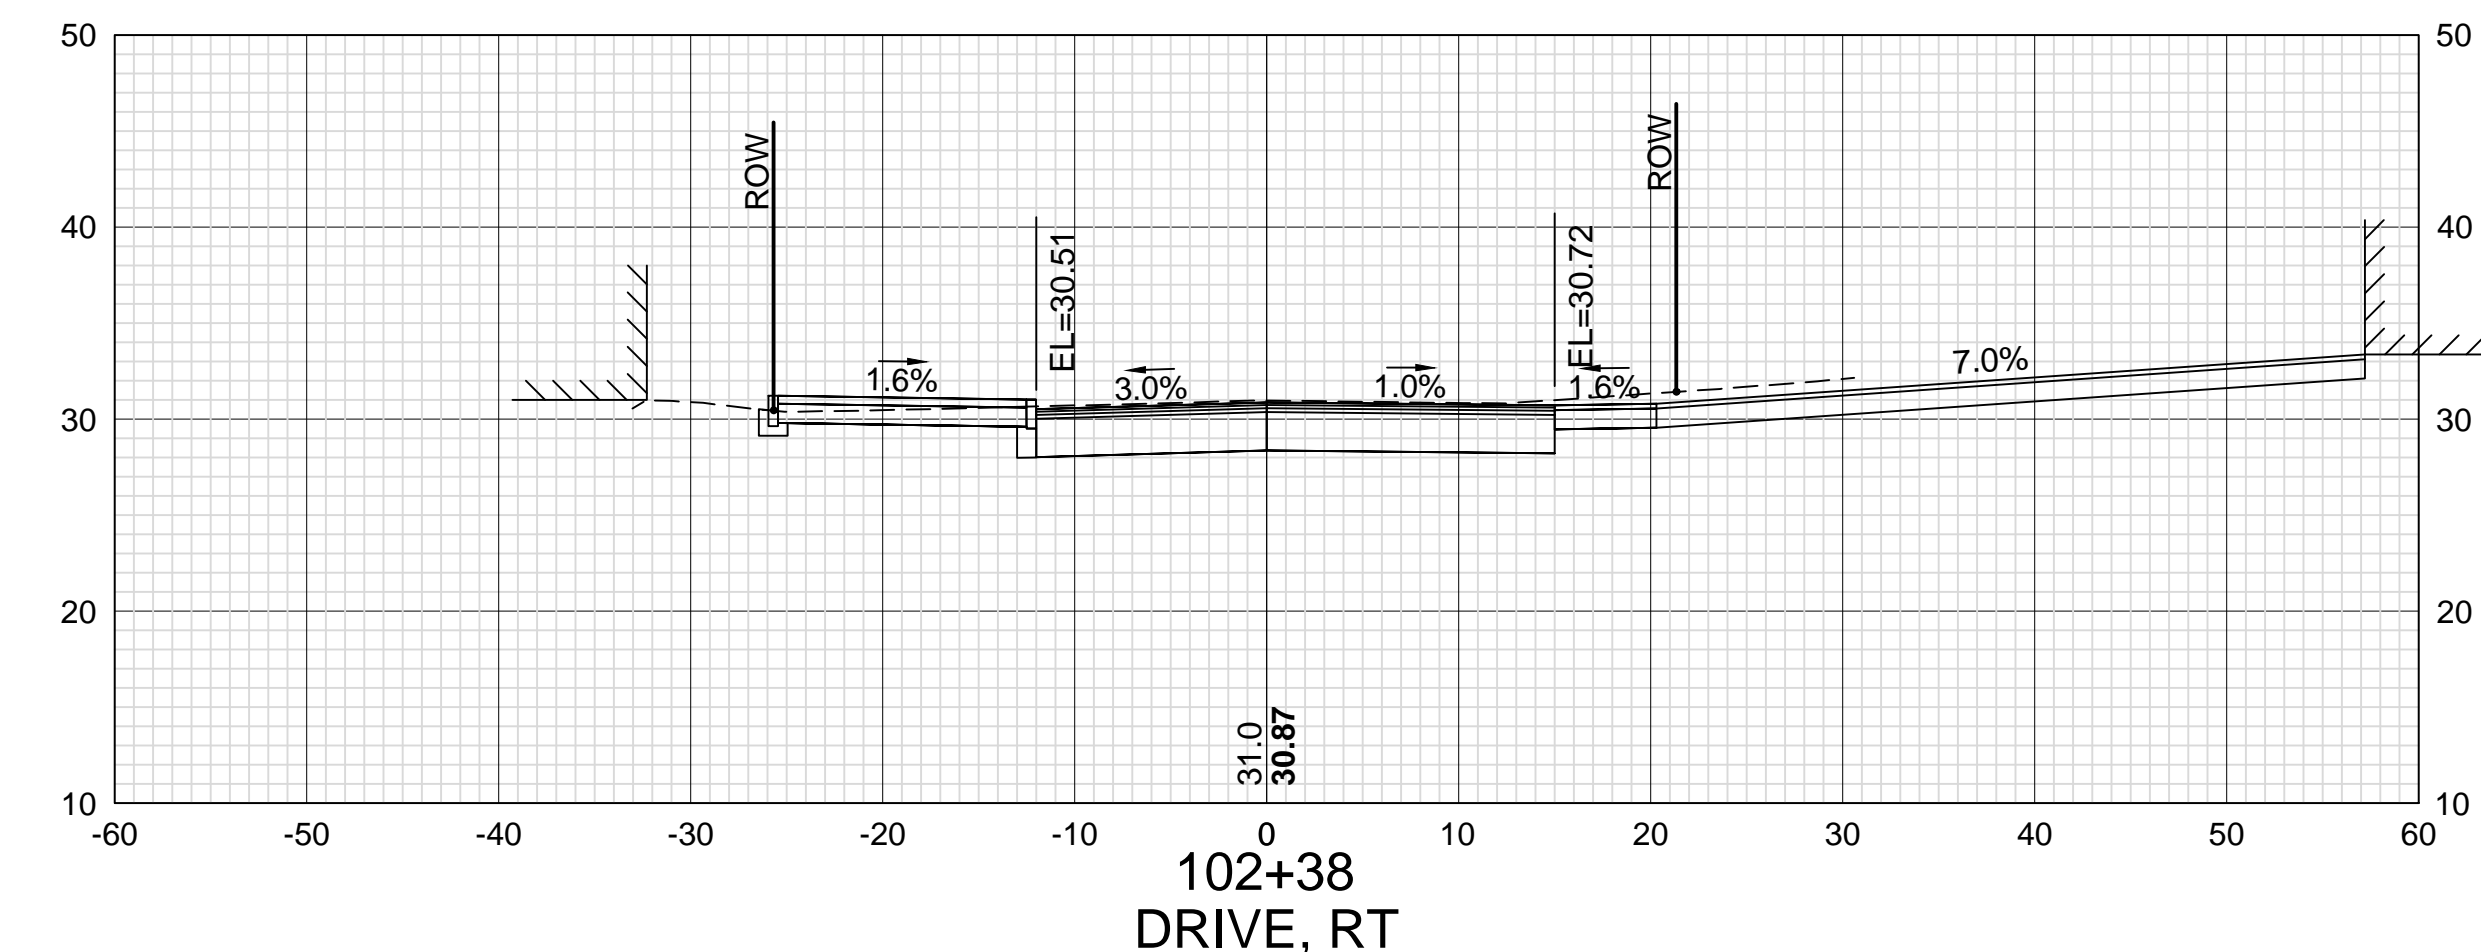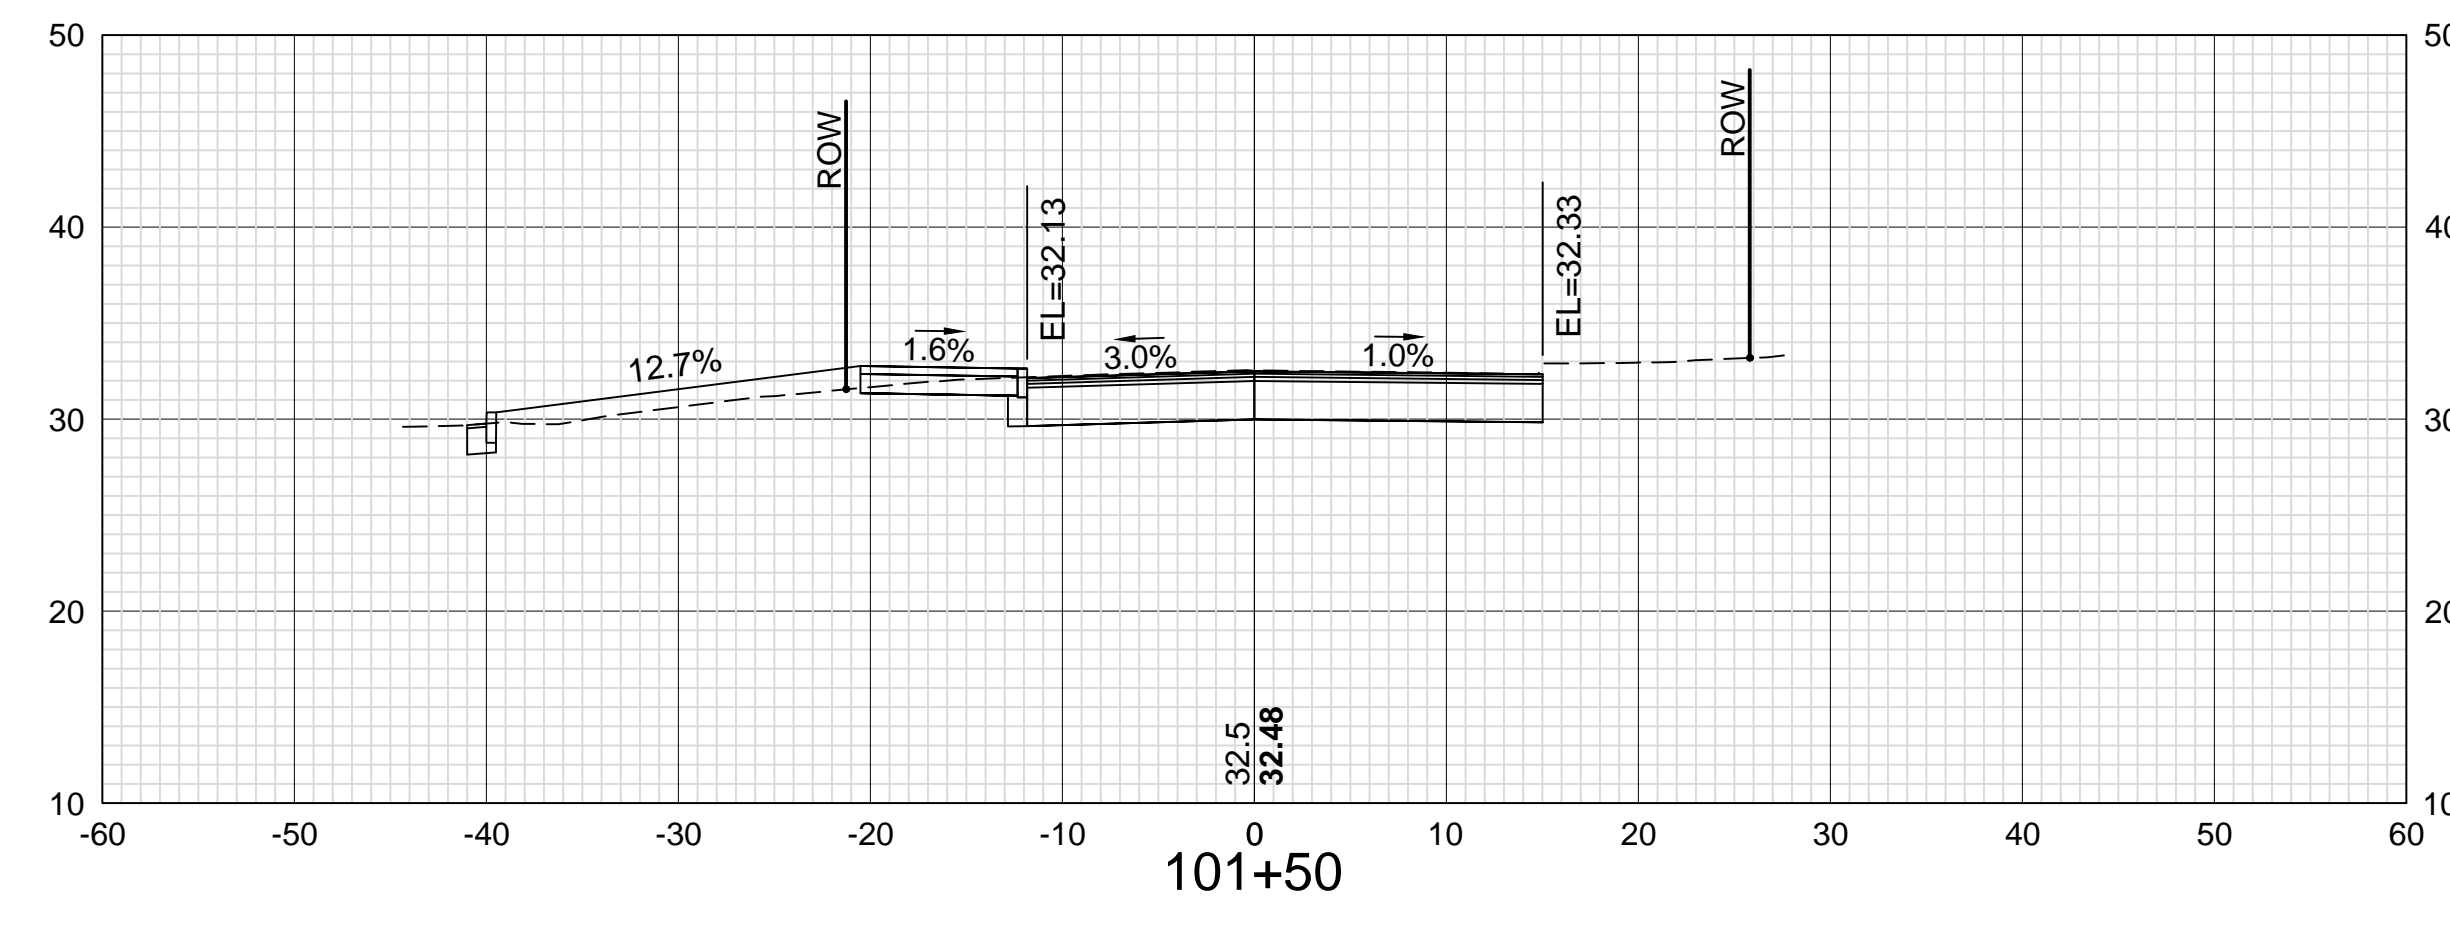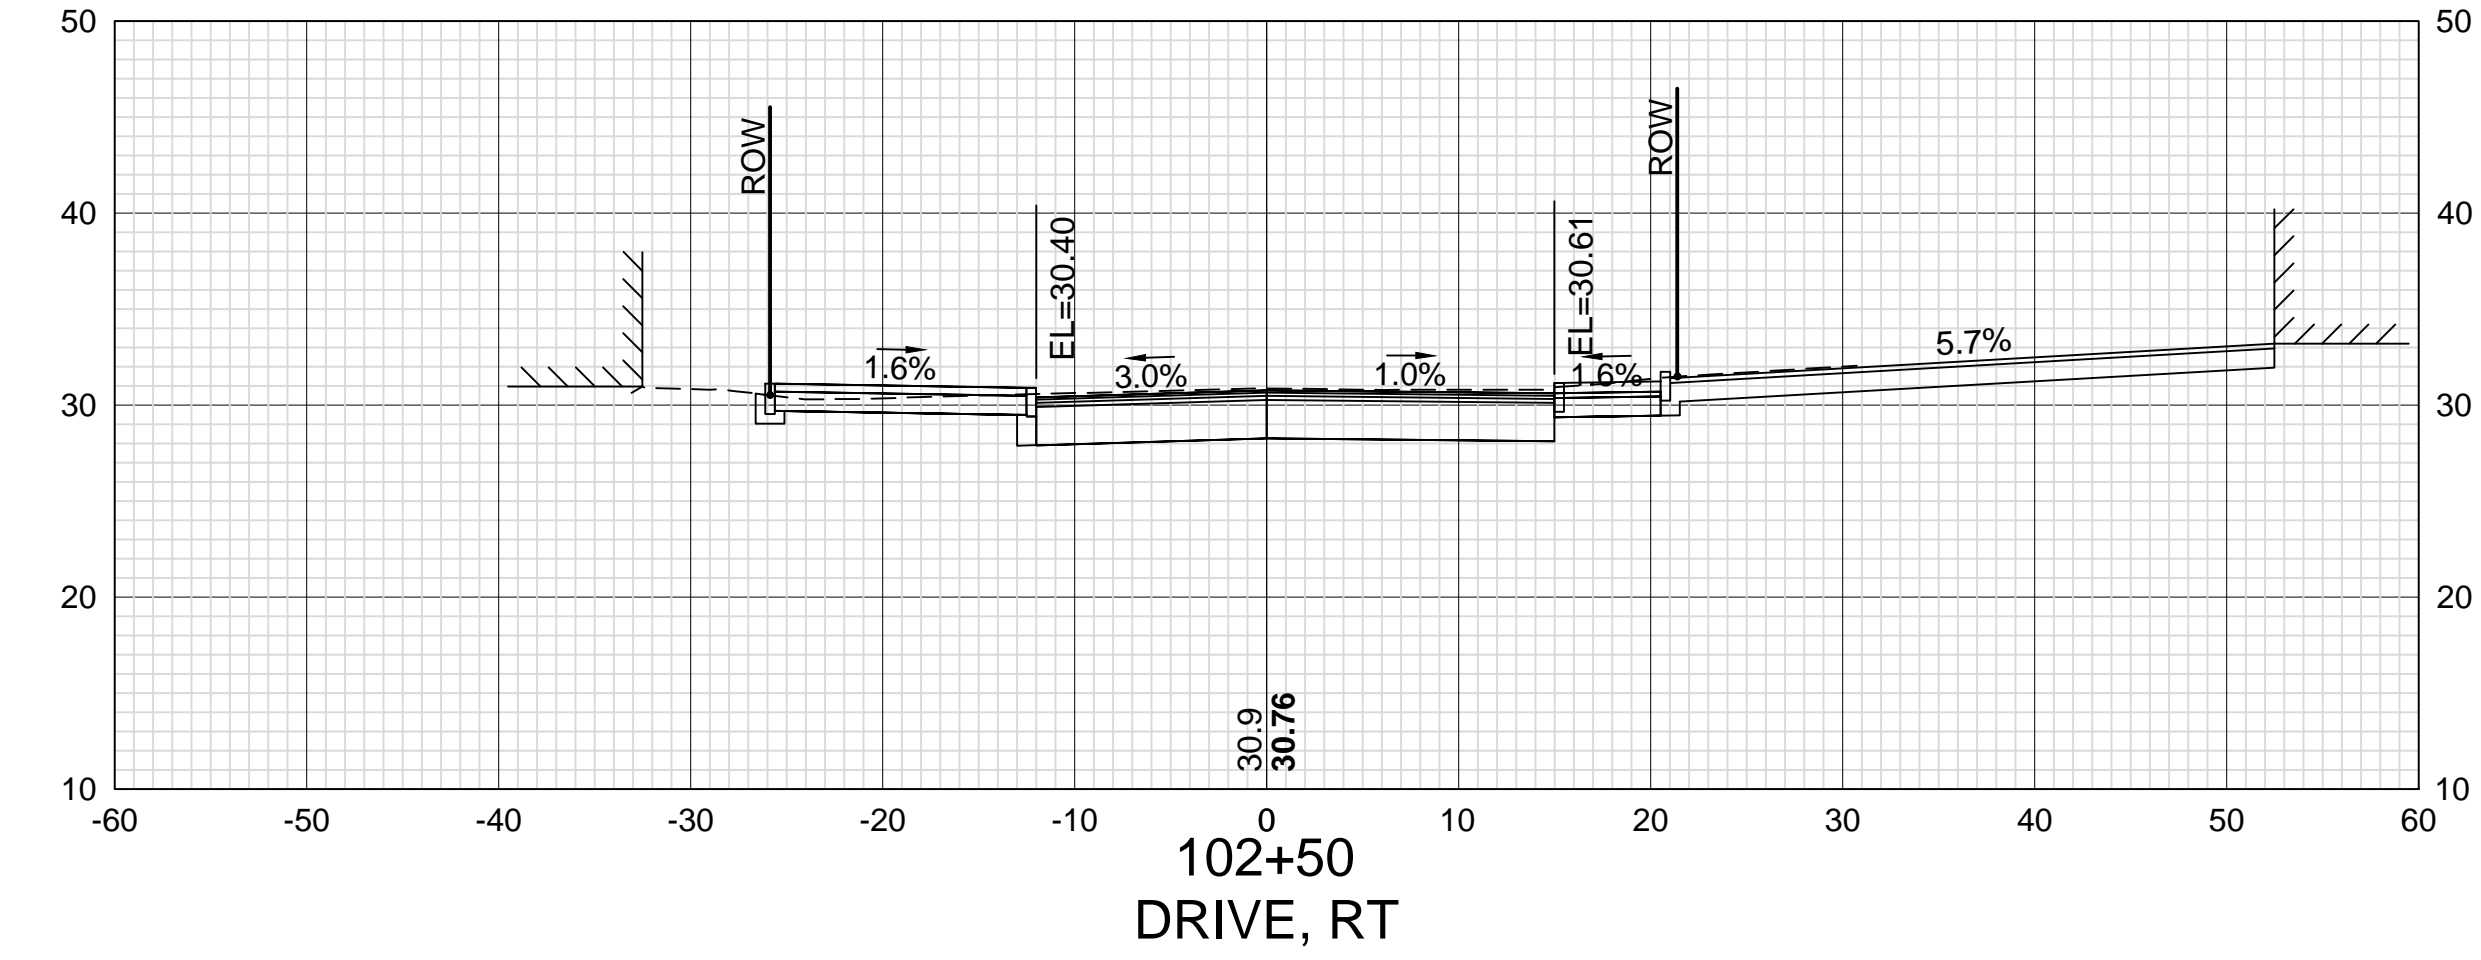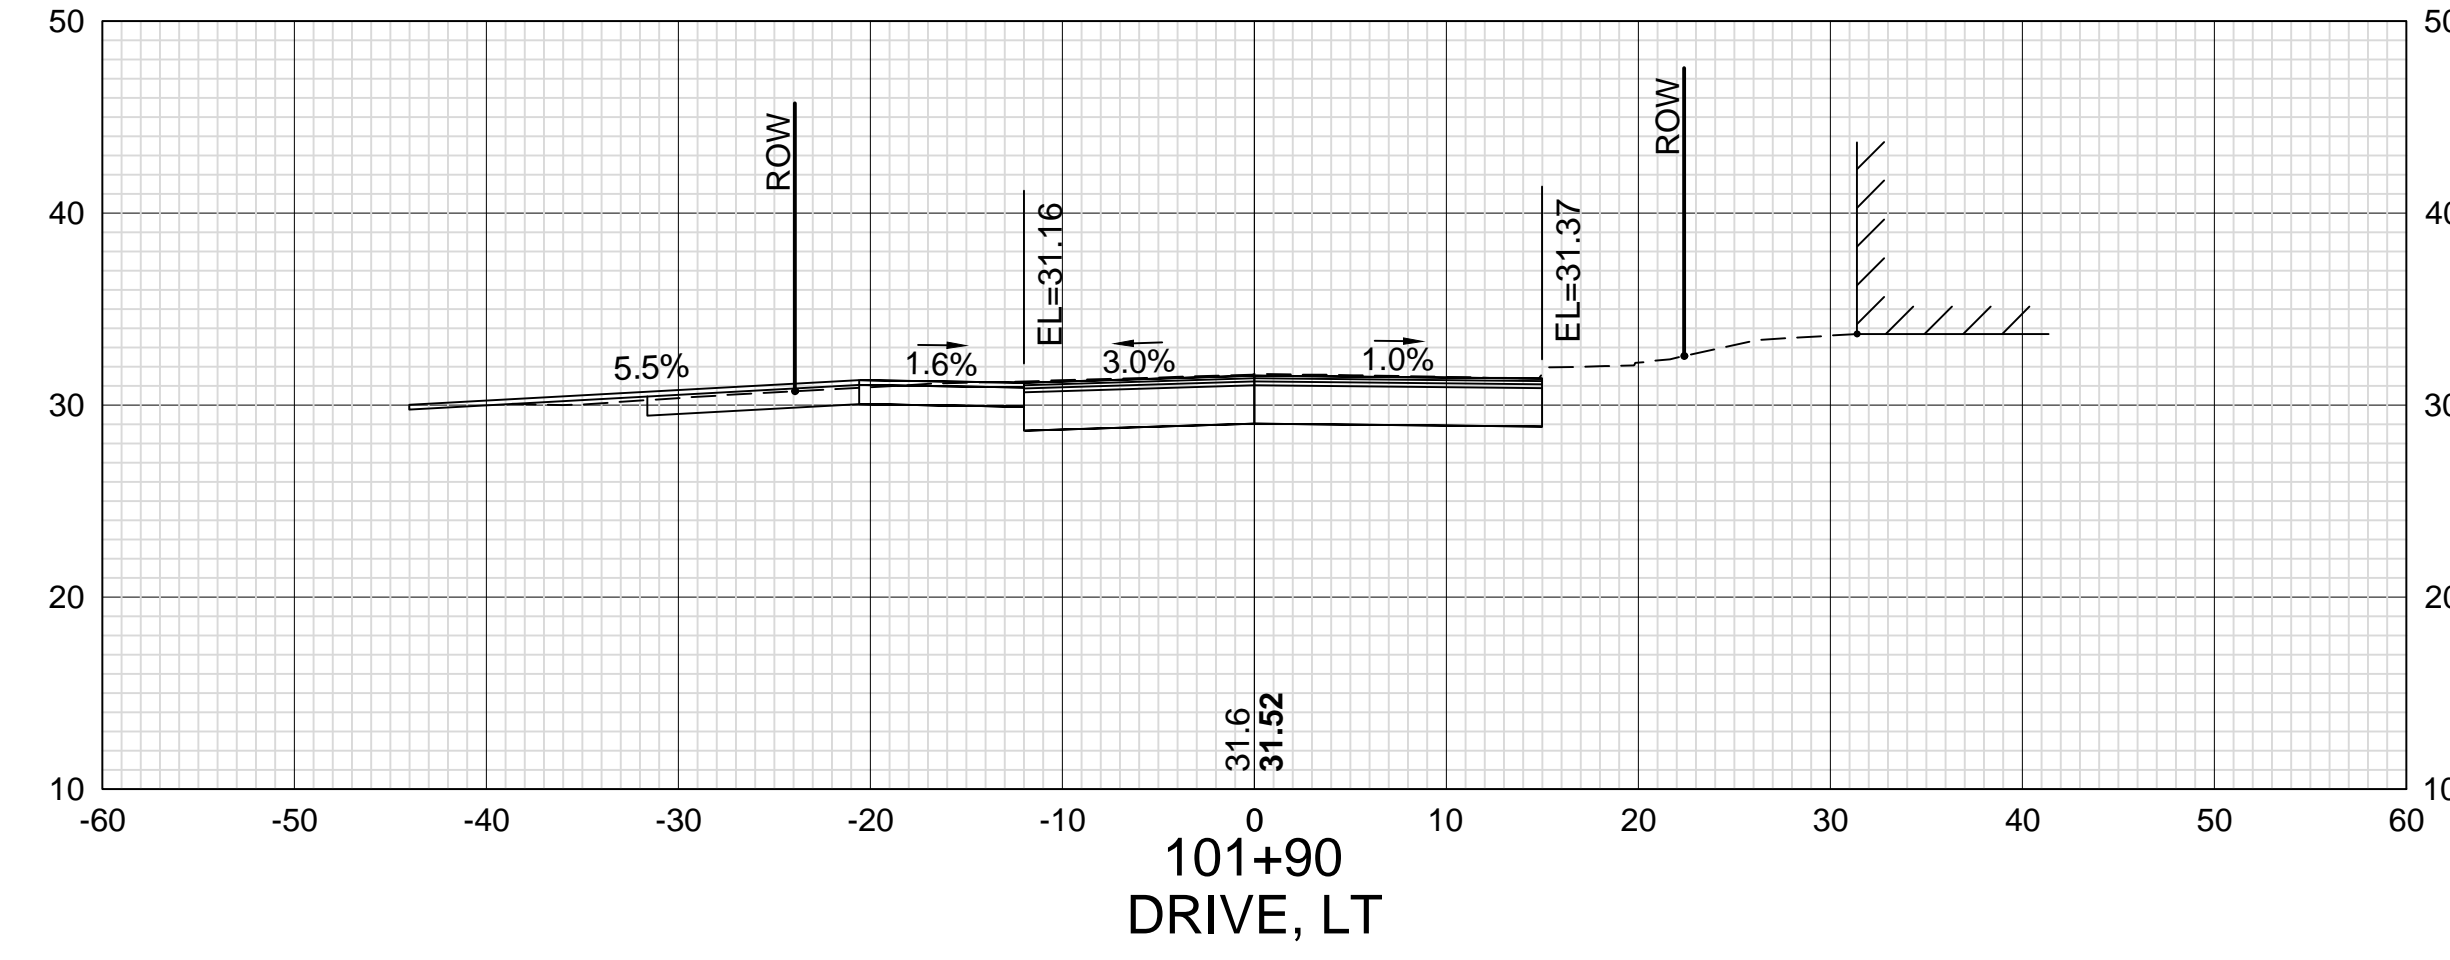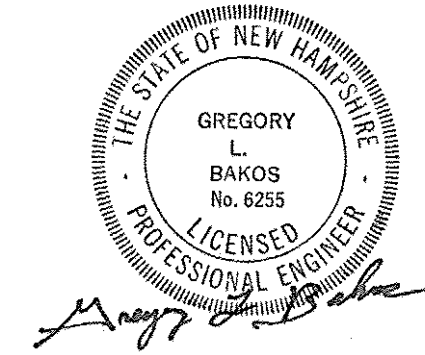

DATE PLOTTED	VHB PROJECT NO.
13-Nov-18	52393.00

ISLINGTON STREET CORRIDOR IMPROVEMENTS - SEGMENT 1			
CITY OF PORTSMOUTH, NEW HAMPSHIRE			
CROSS SECTIONS			
ISLINGTON STREET			
DRAWING	CITY PROJECT NO.	SHEET NO.	TOTAL SHEETS
XS-Seg1	7176	53	88



DESCRIPTION

REVISIONS AFTER PROPOSAL

STATION

STATION

DATE

NUMBER

DATE

DATE

DATE









DATE

SDR PROCESSED VHB

NEW DESIGN KMH

SHEET CHECKED GLB

AS BUILT DETAILS

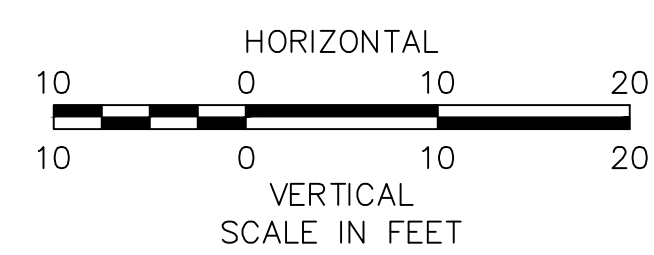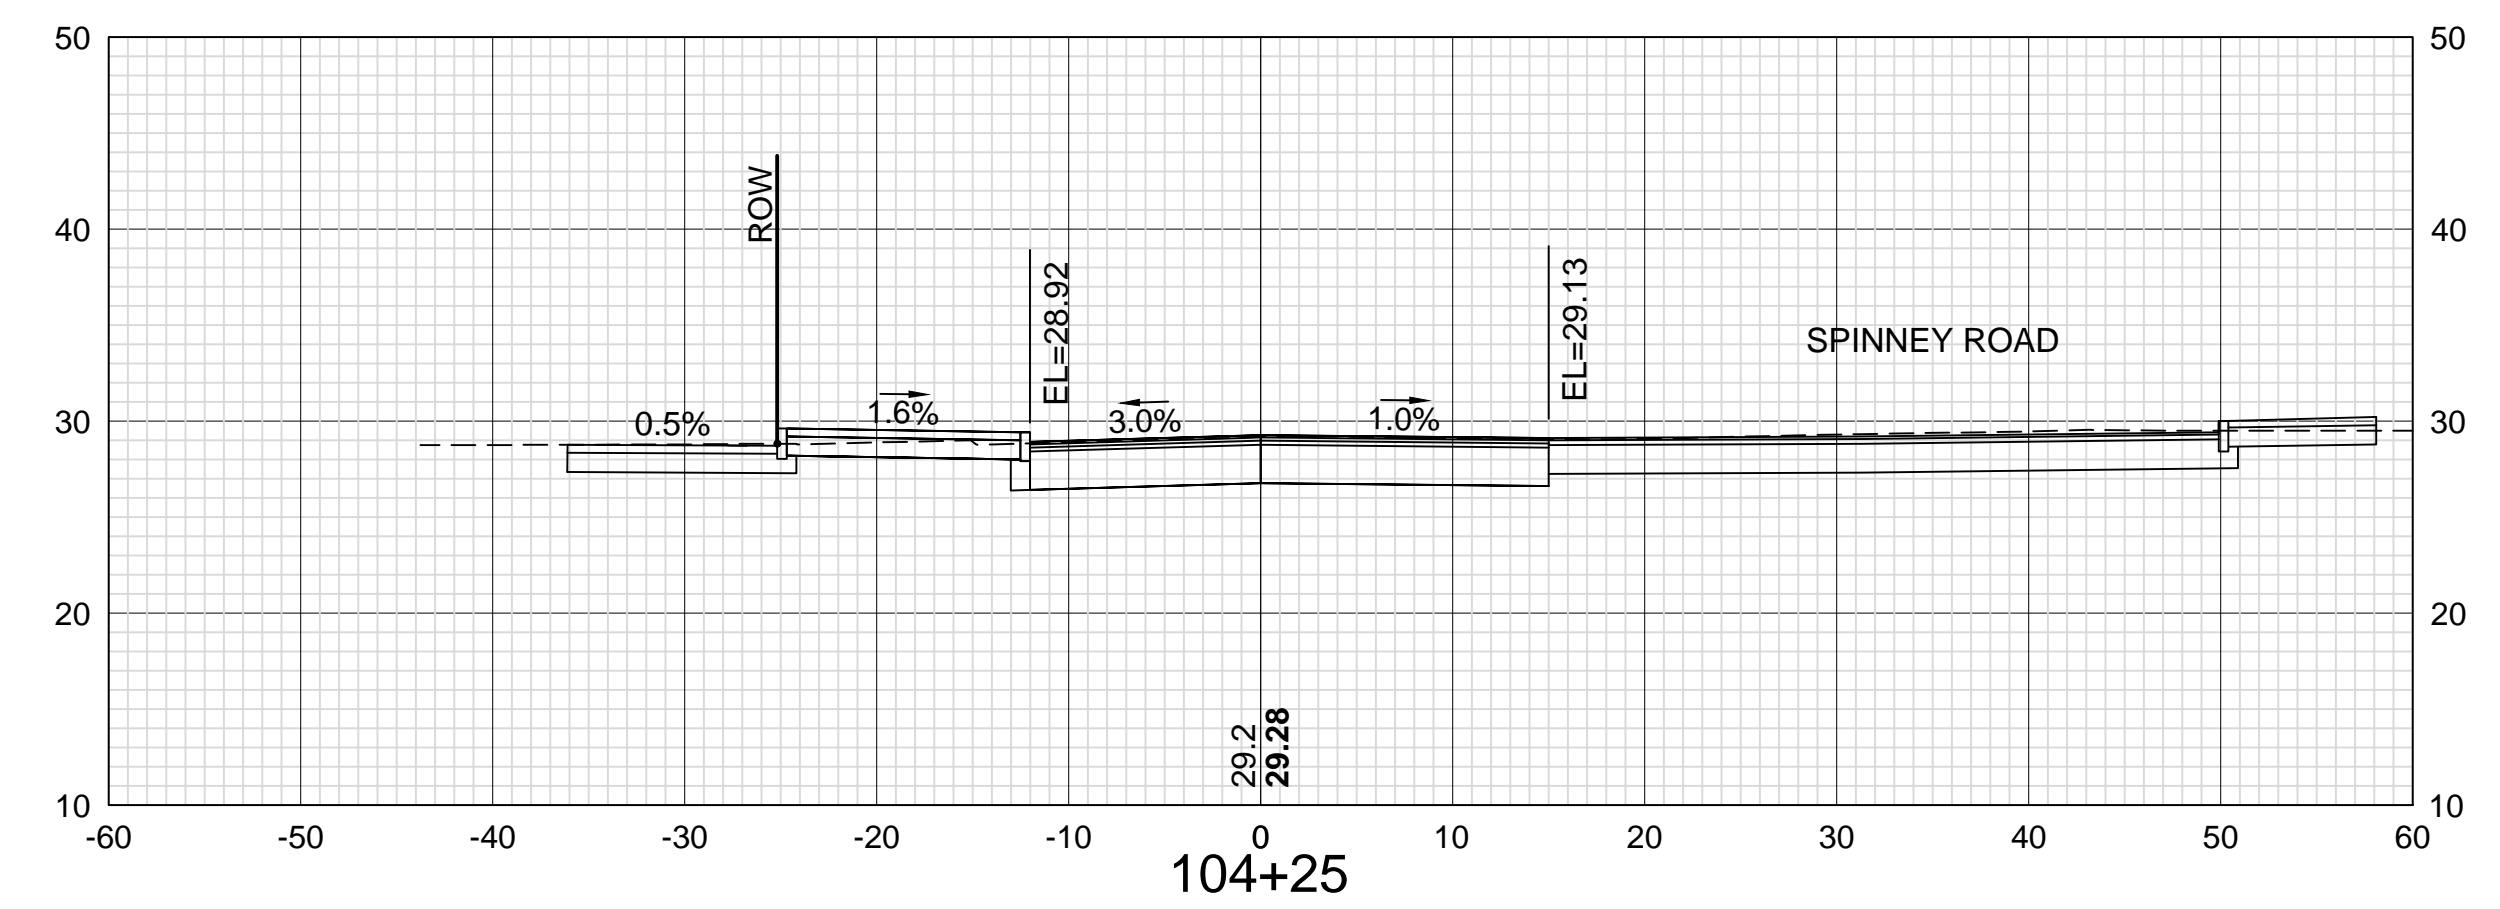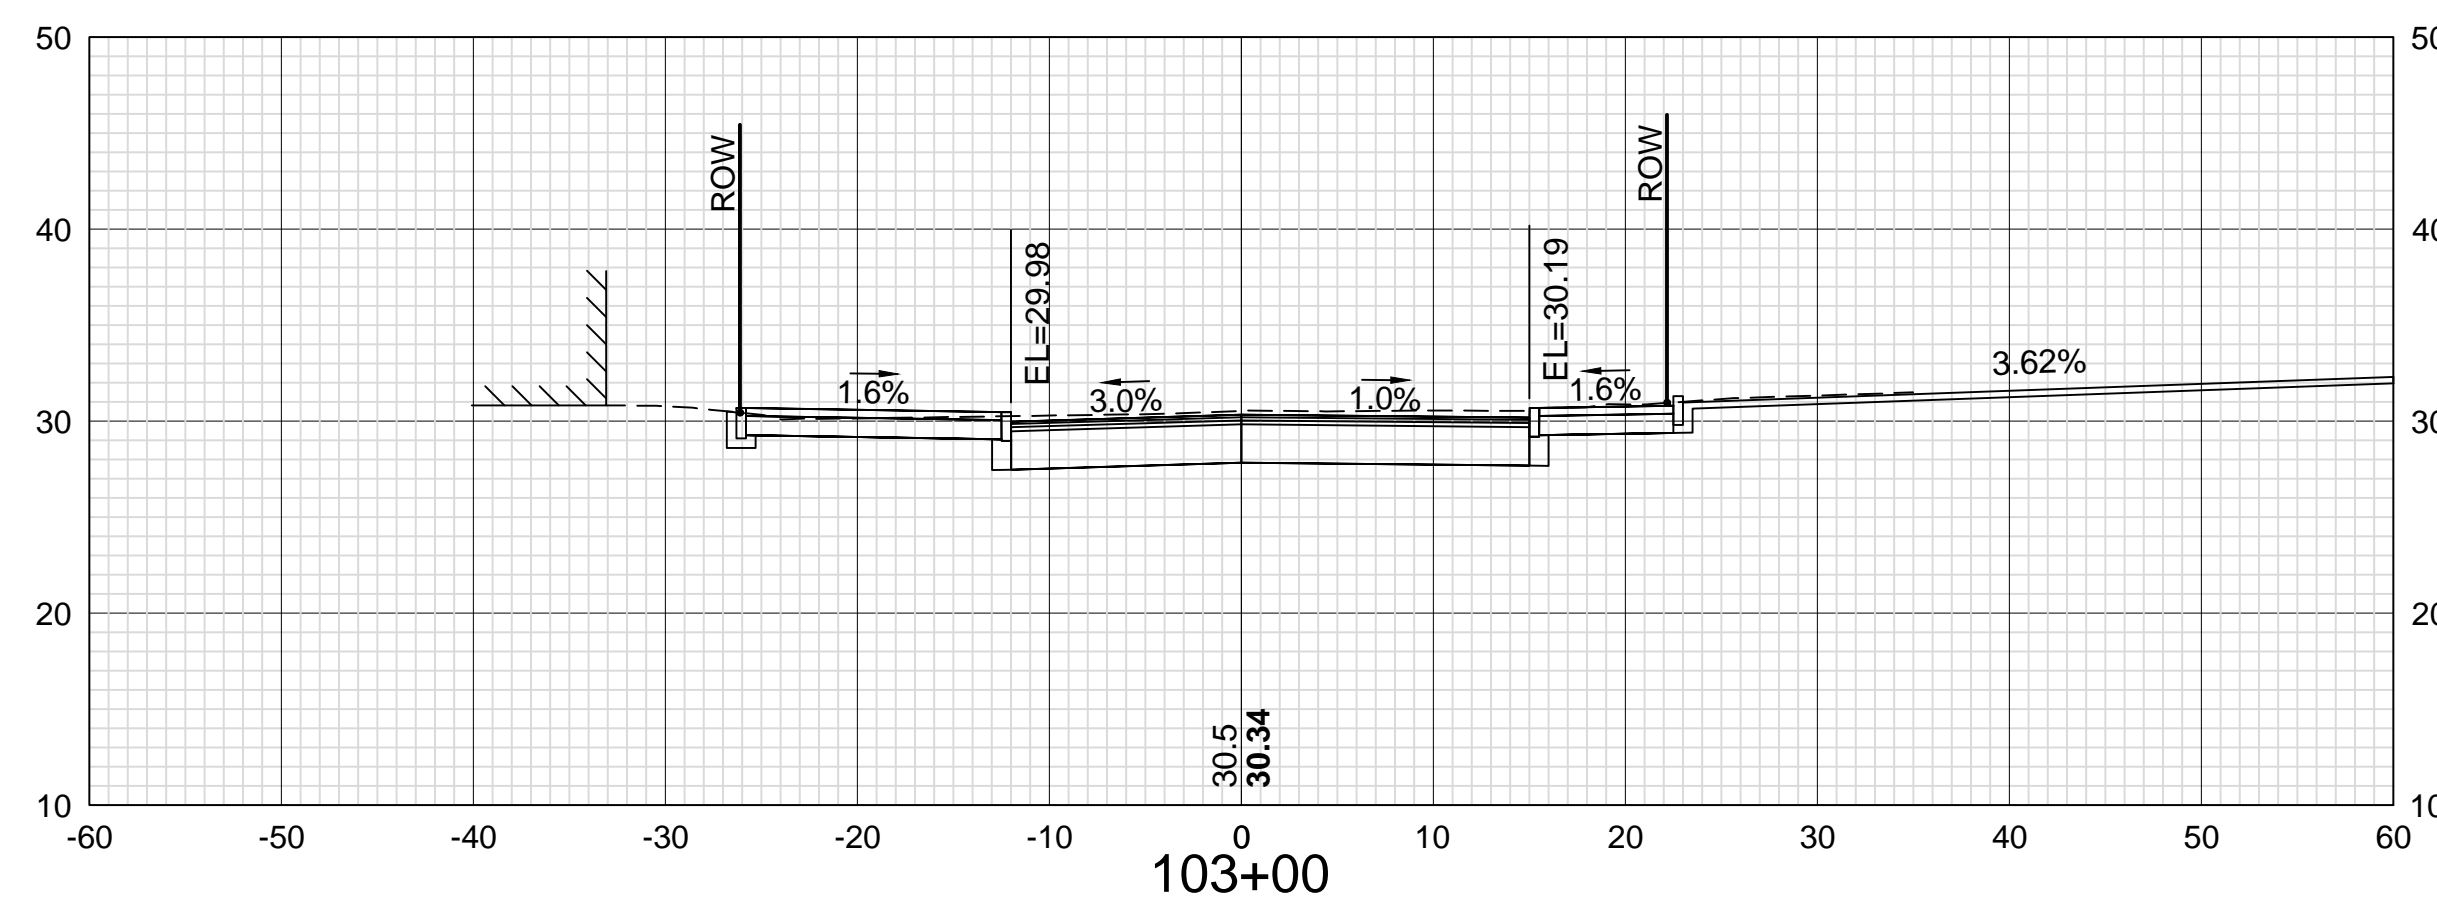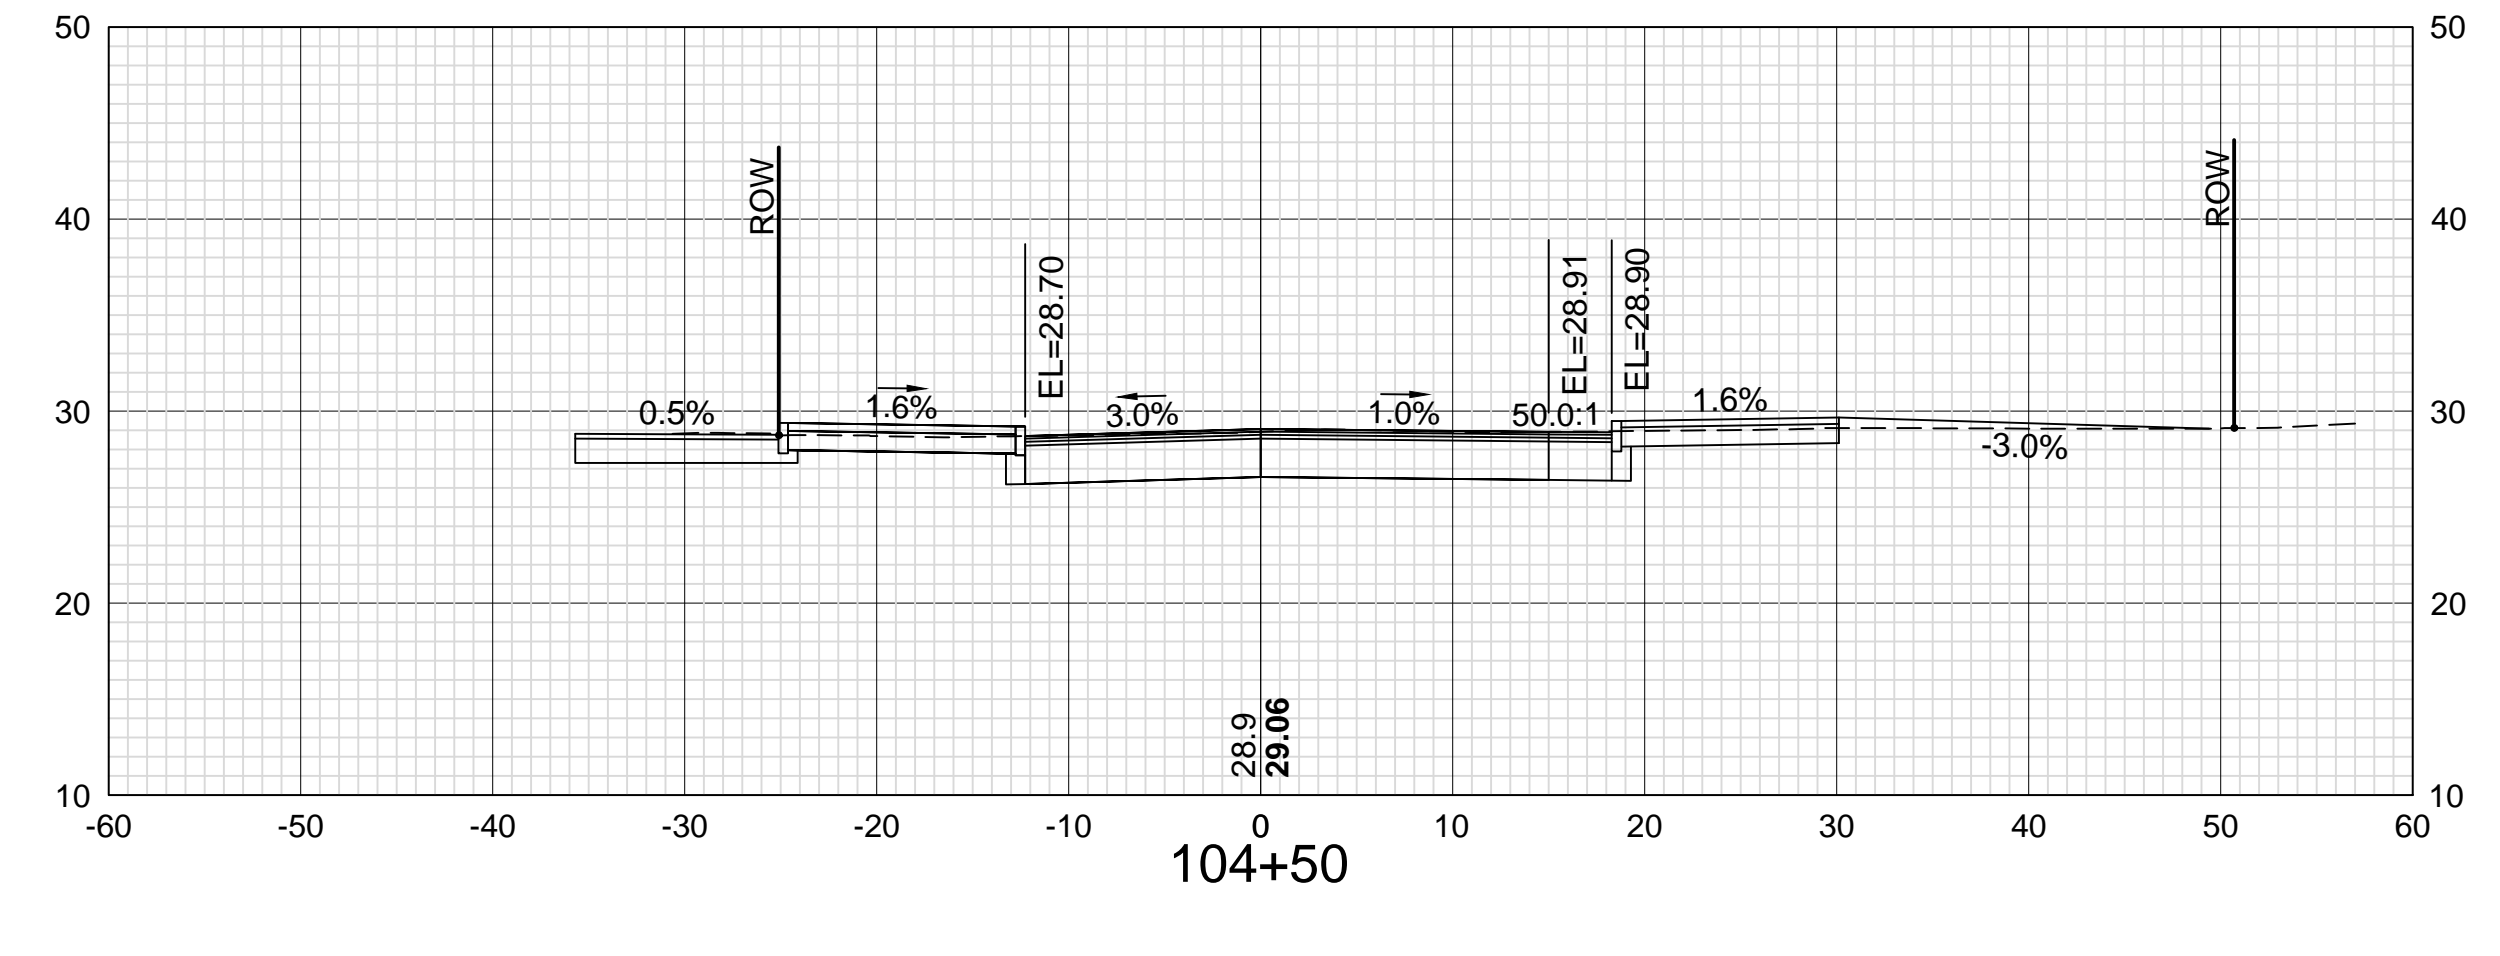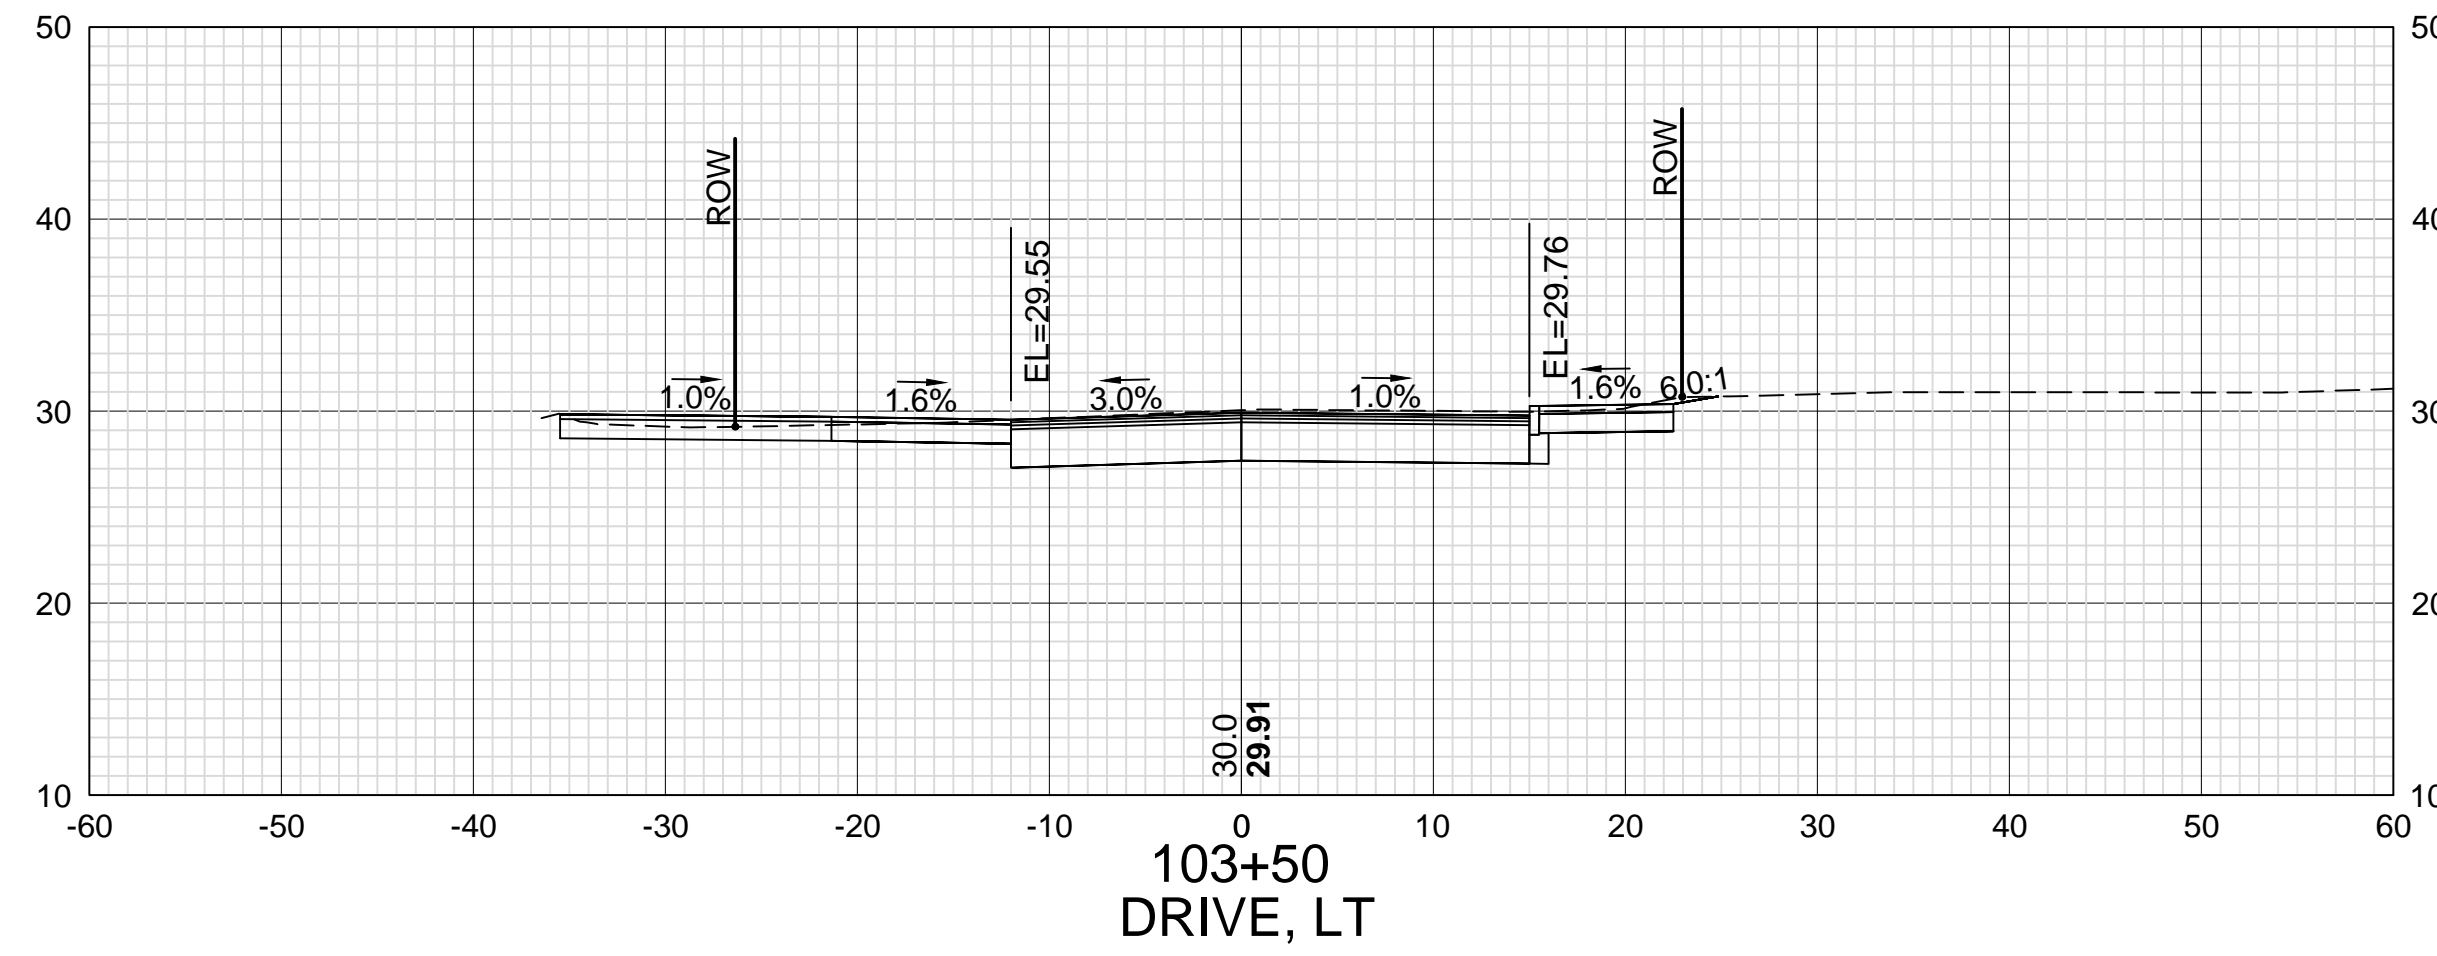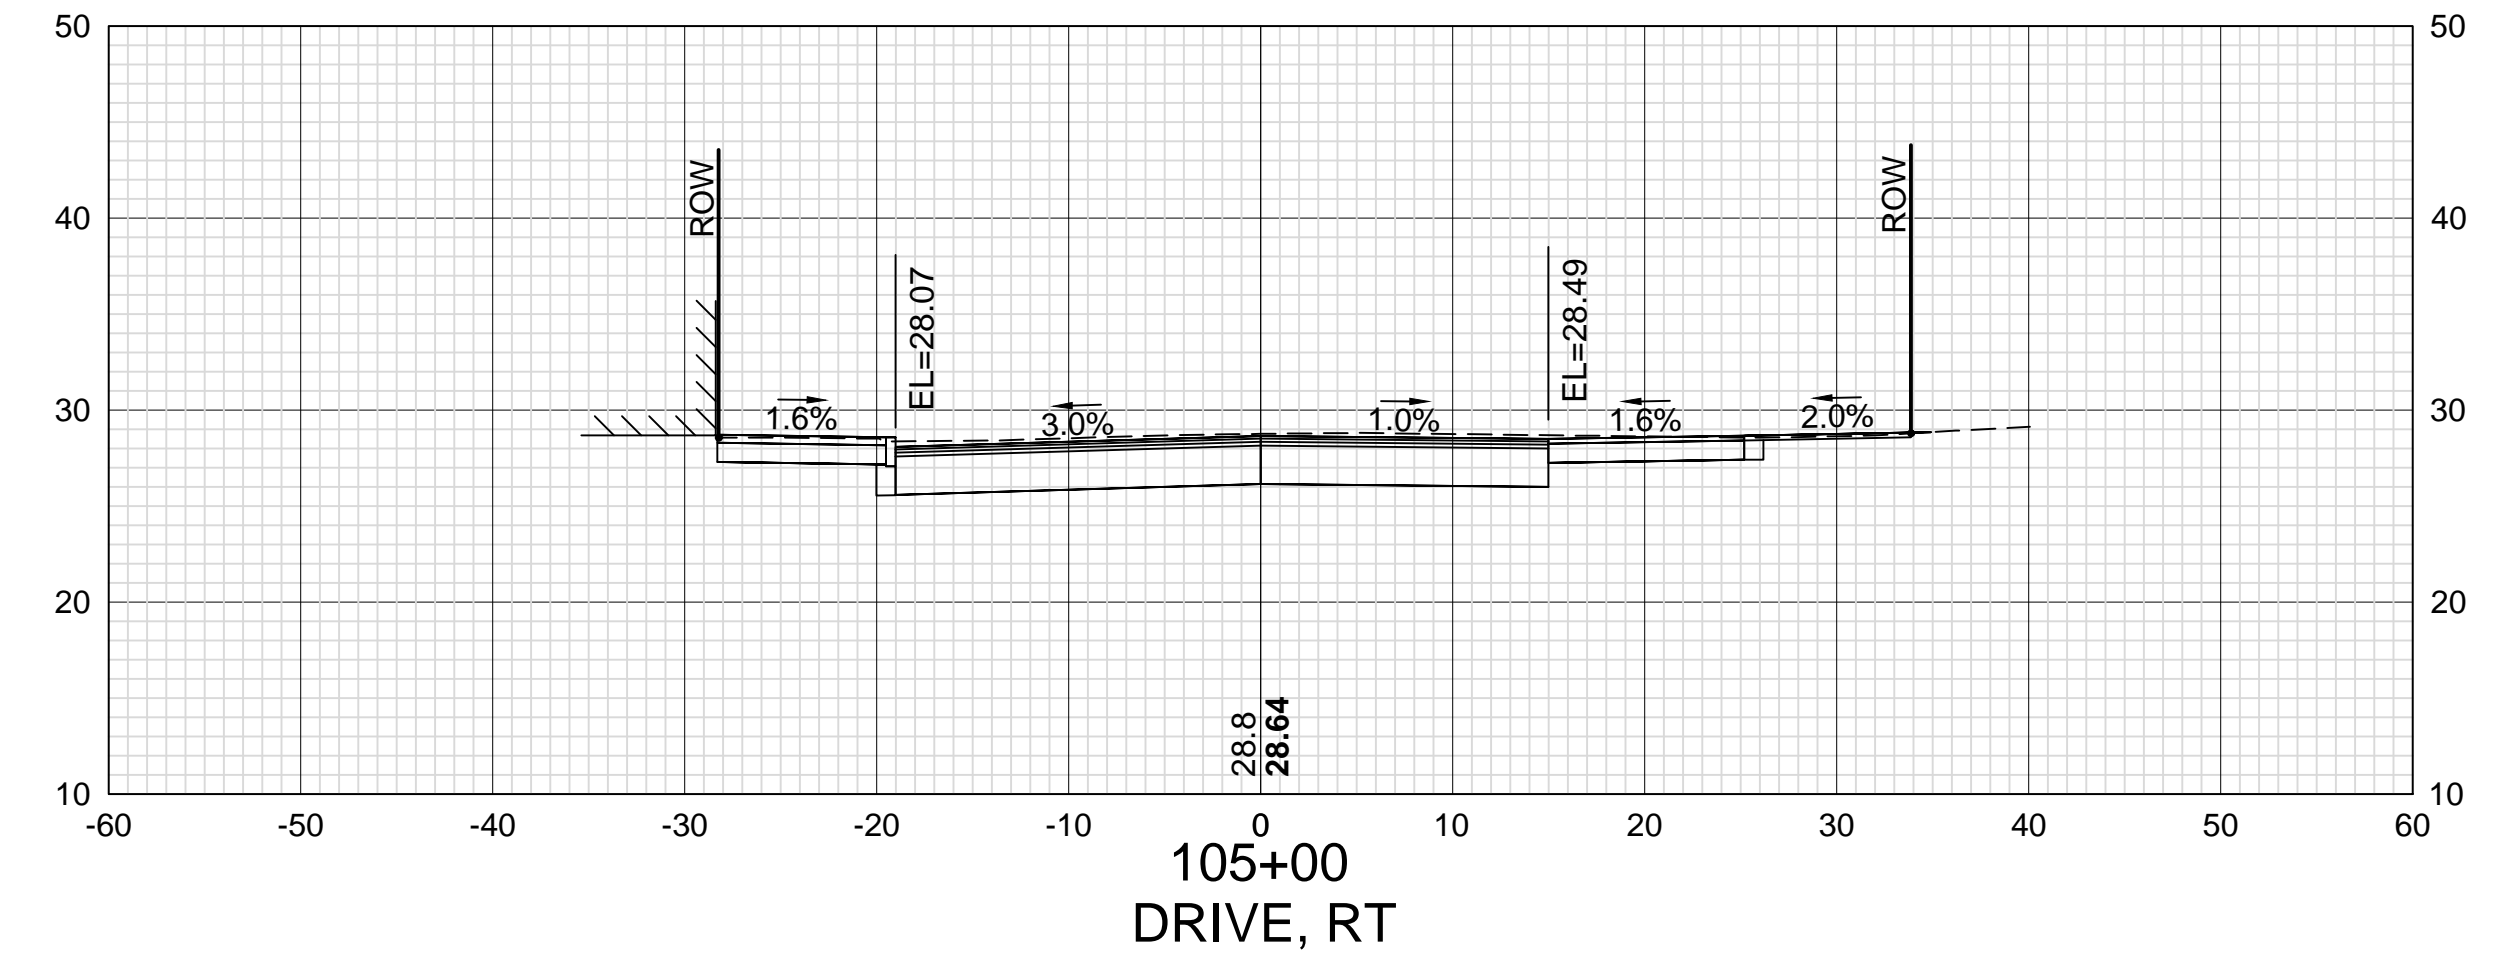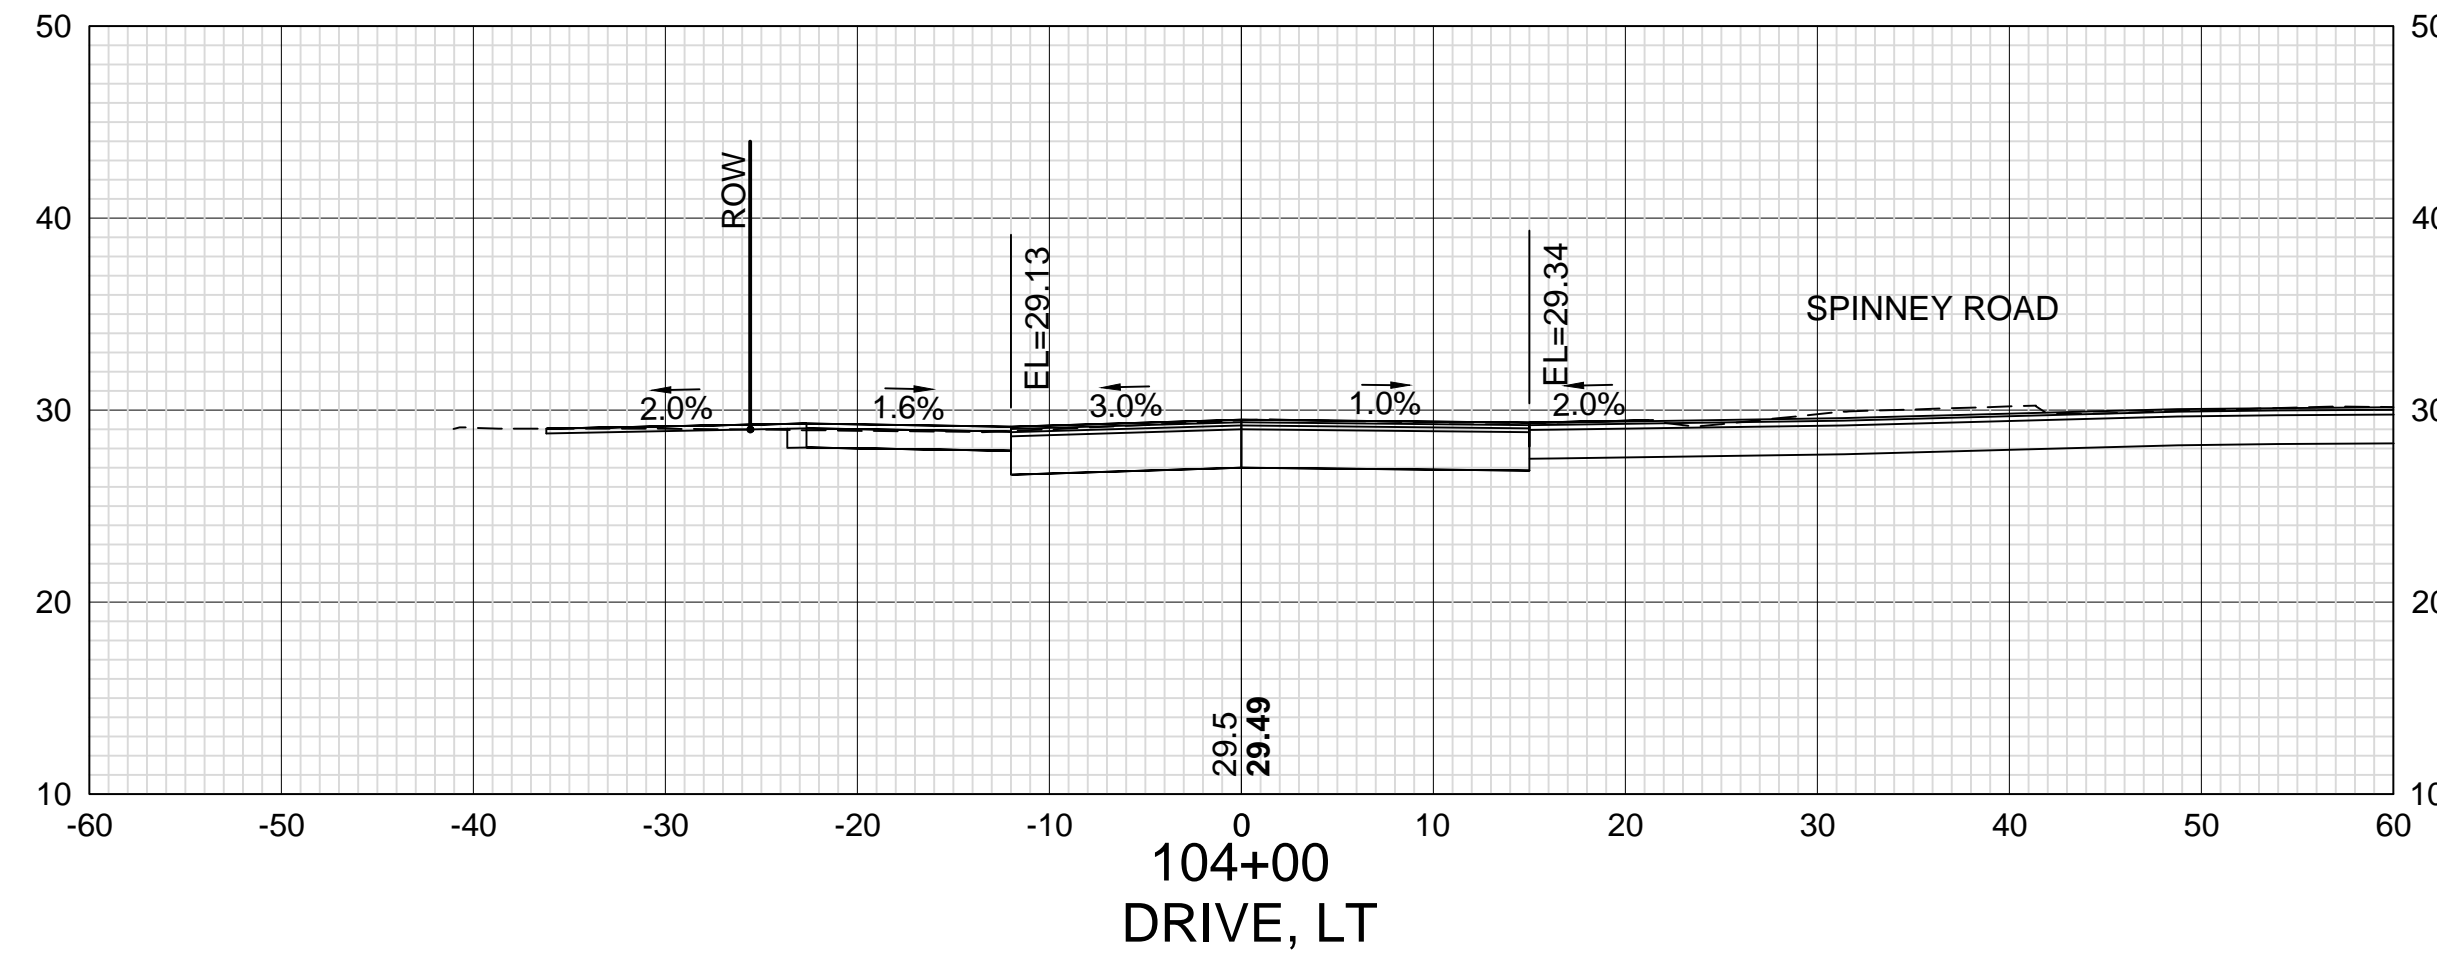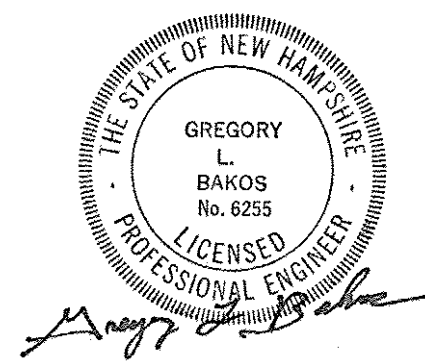

DATE PLOTTED	VHB PROJECT NO.
13-Nov-18	52393.00

ISLINGTON STREET CORRIDOR IMPROVEMENTS - SEGMENT 1			
CITY OF PORTSMOUTH, NEW HAMPSHIRE			
CROSS SECTIONS			
ISLINGTON STREET			
DRAWING	CITY PROJECT NO.	SHEET NO.	TOTAL SHEETS
XS-Seg1	7176	54	88

REVISIONS AFTER PROPOSAL

STATION

STATION

DATE

NUMBER

DATE

DATE

DATE









DATE

SDR PROCESSED VHB

NEW DESIGN KMH

SHEET CHECKED GLB

AS BUILT DETAILS

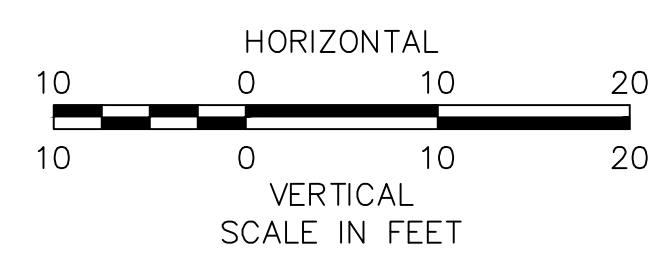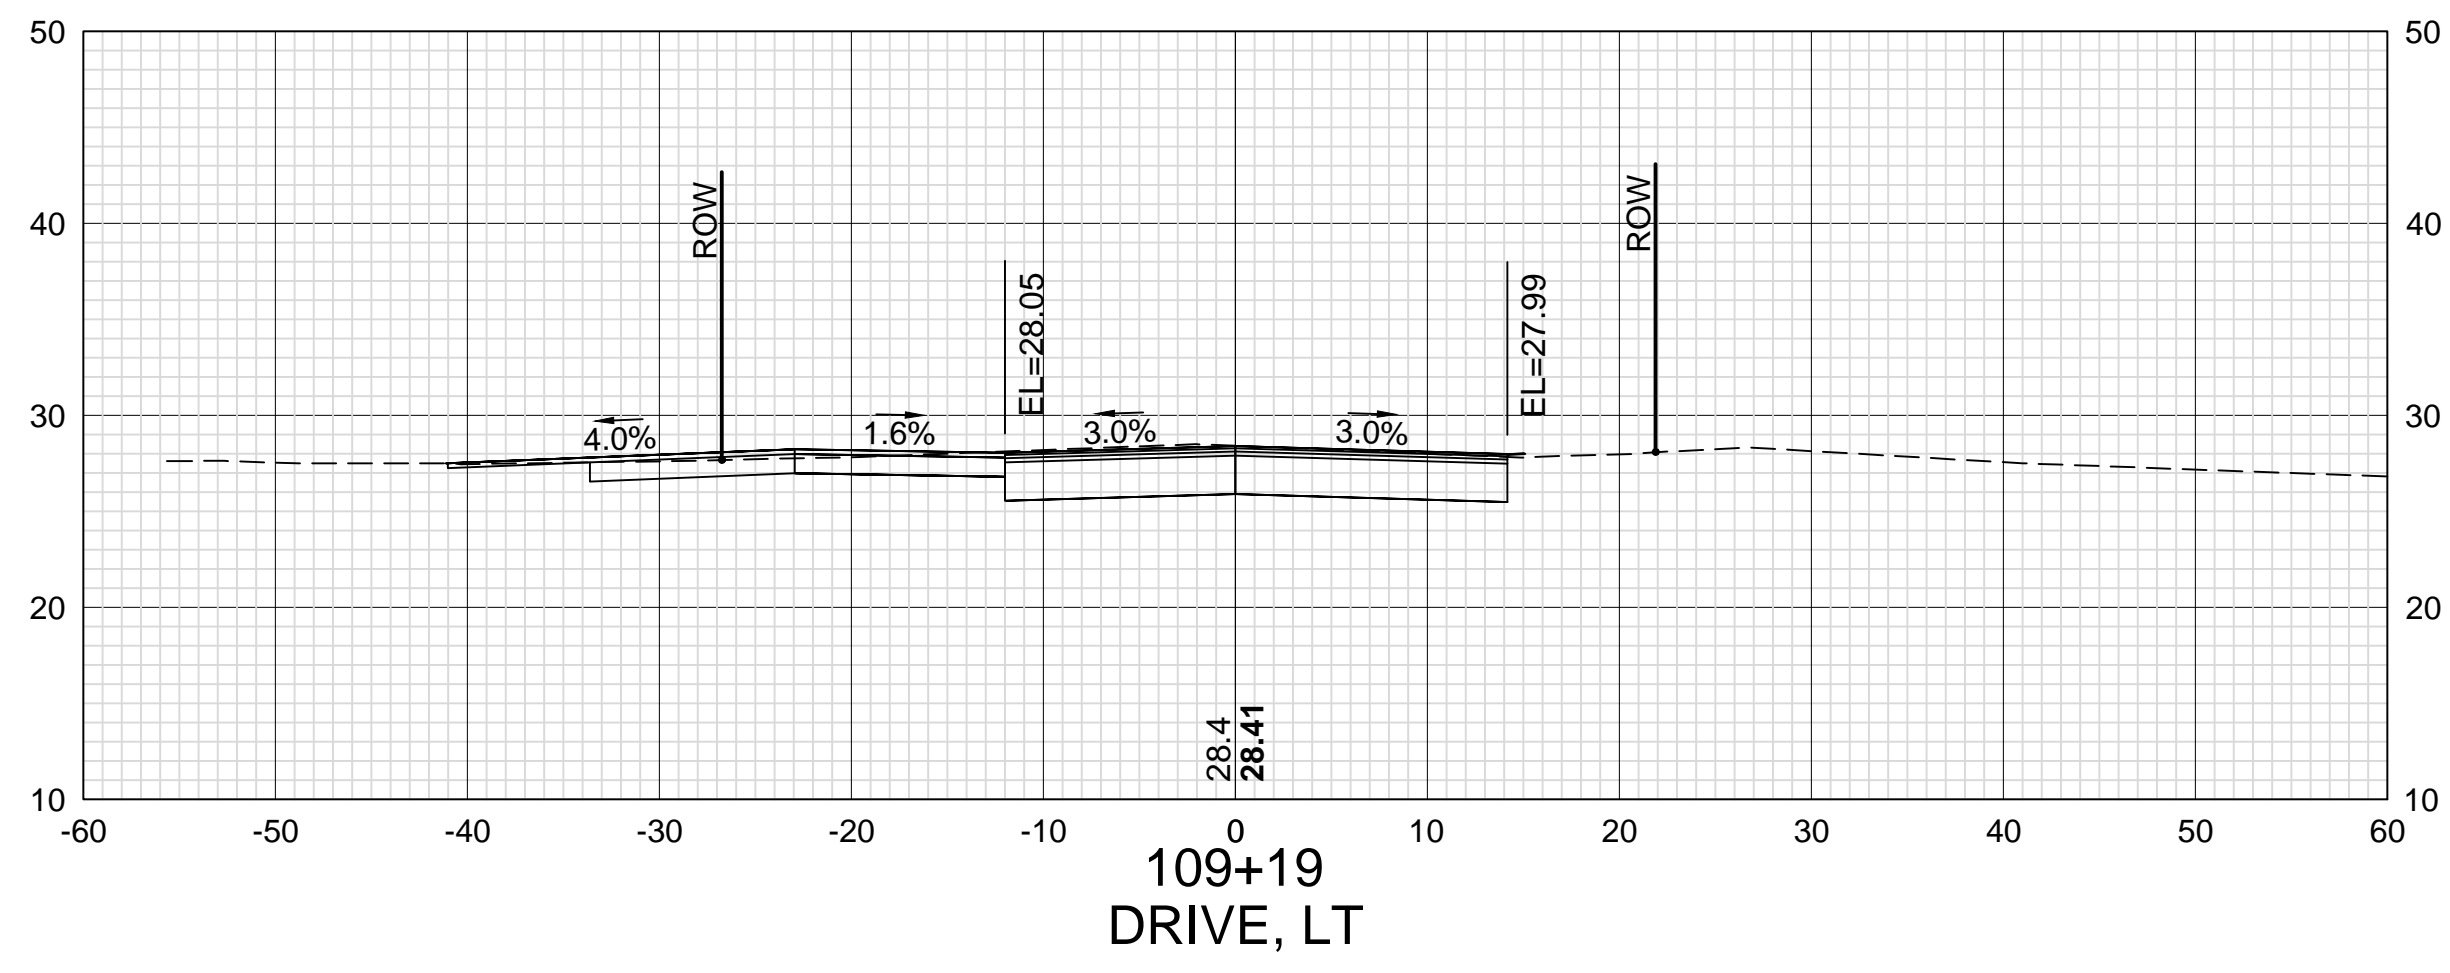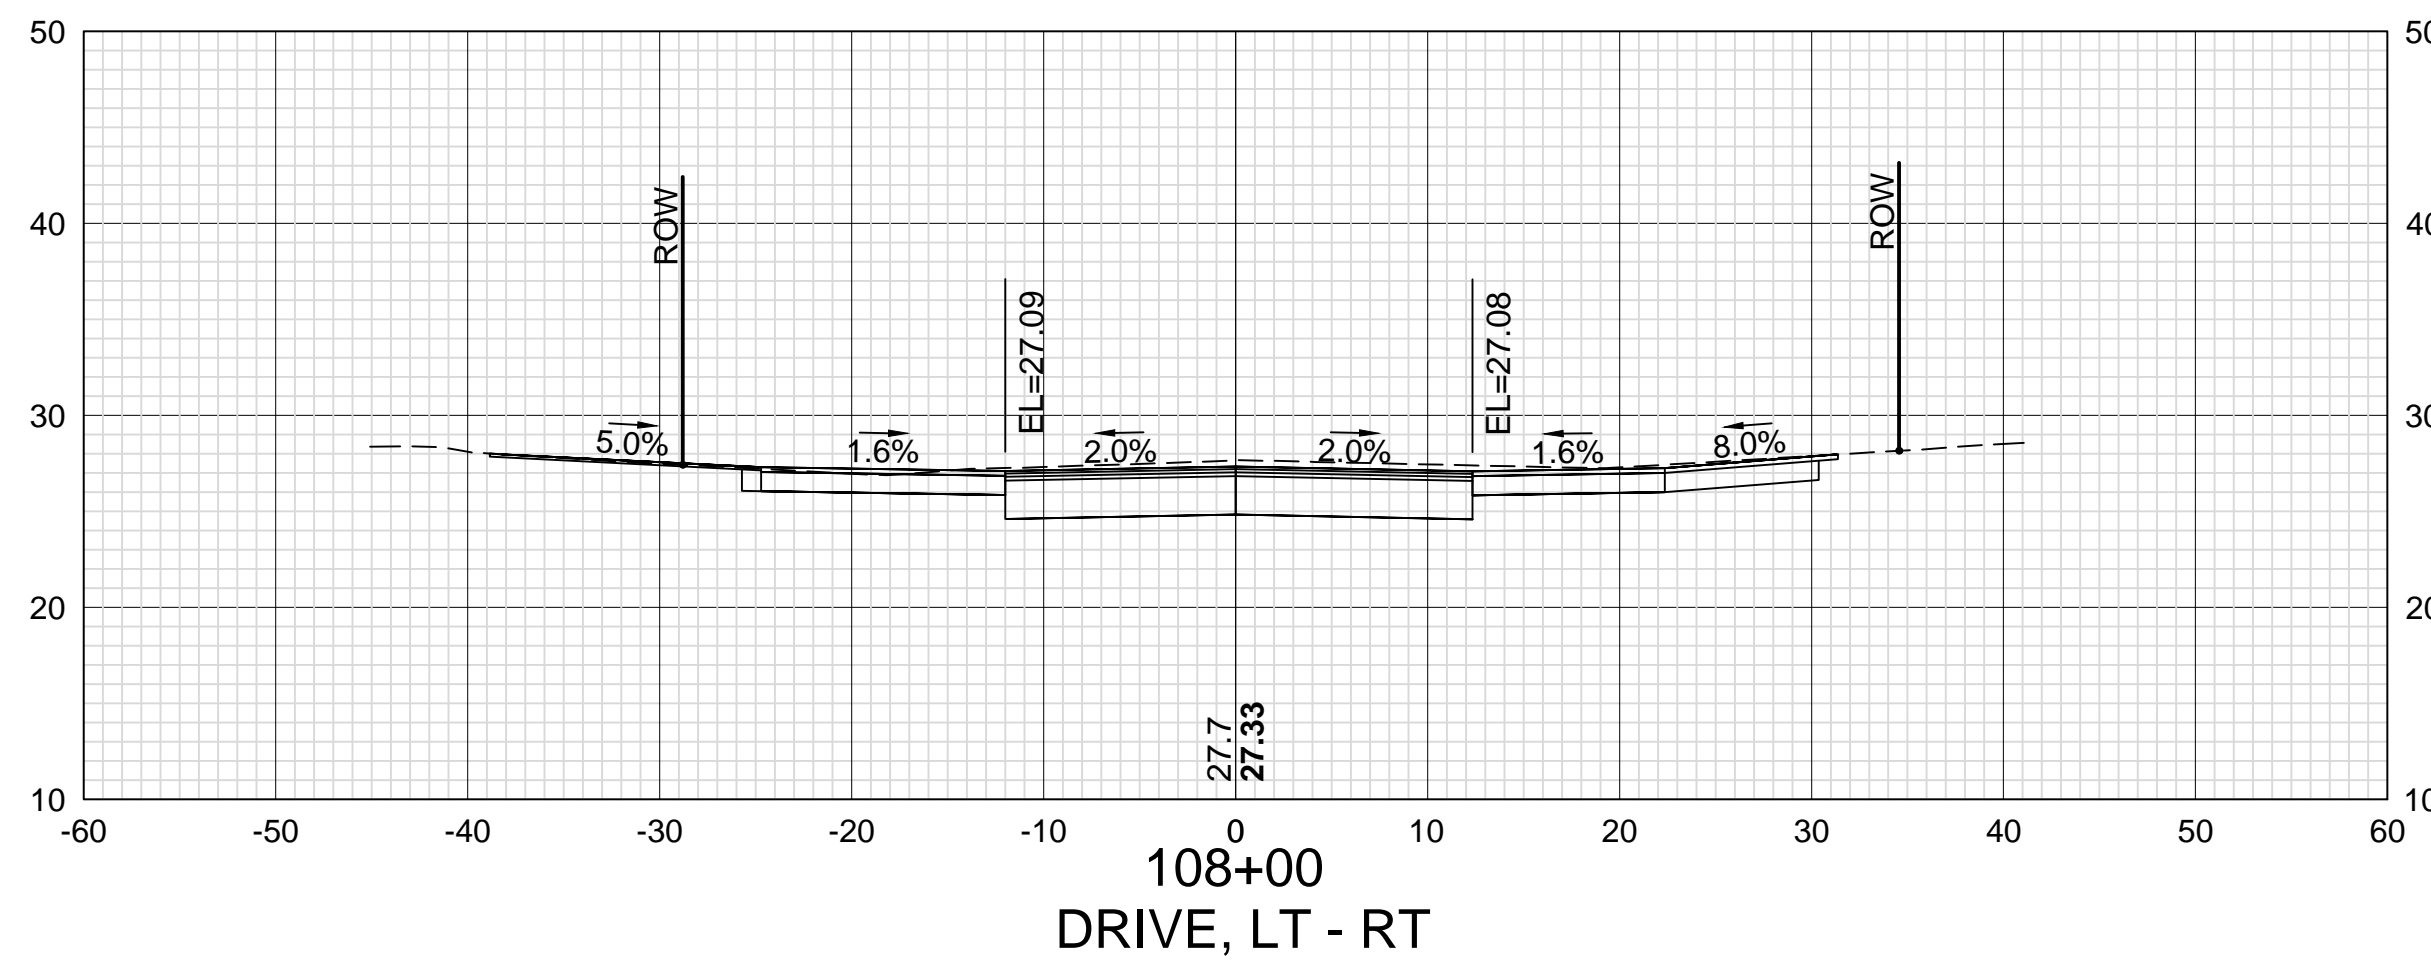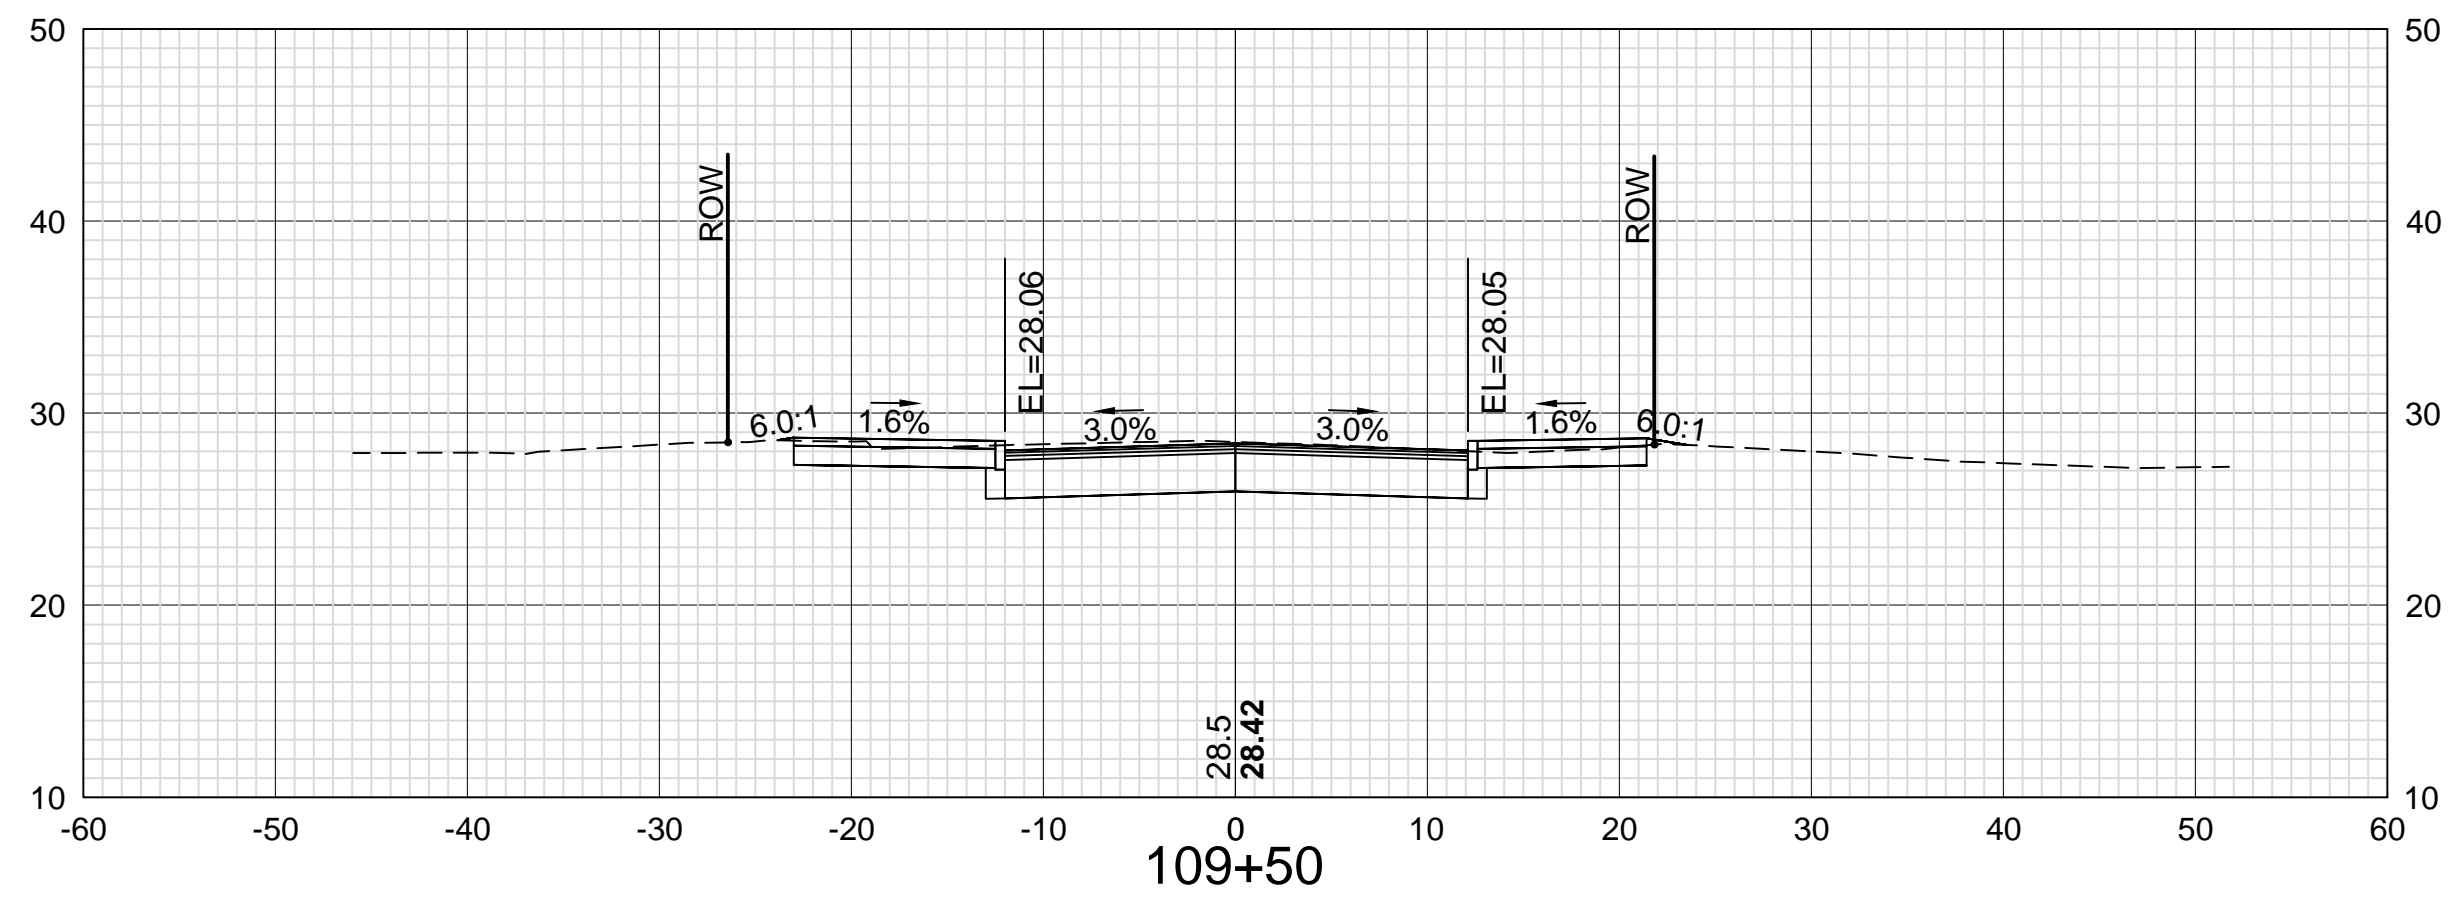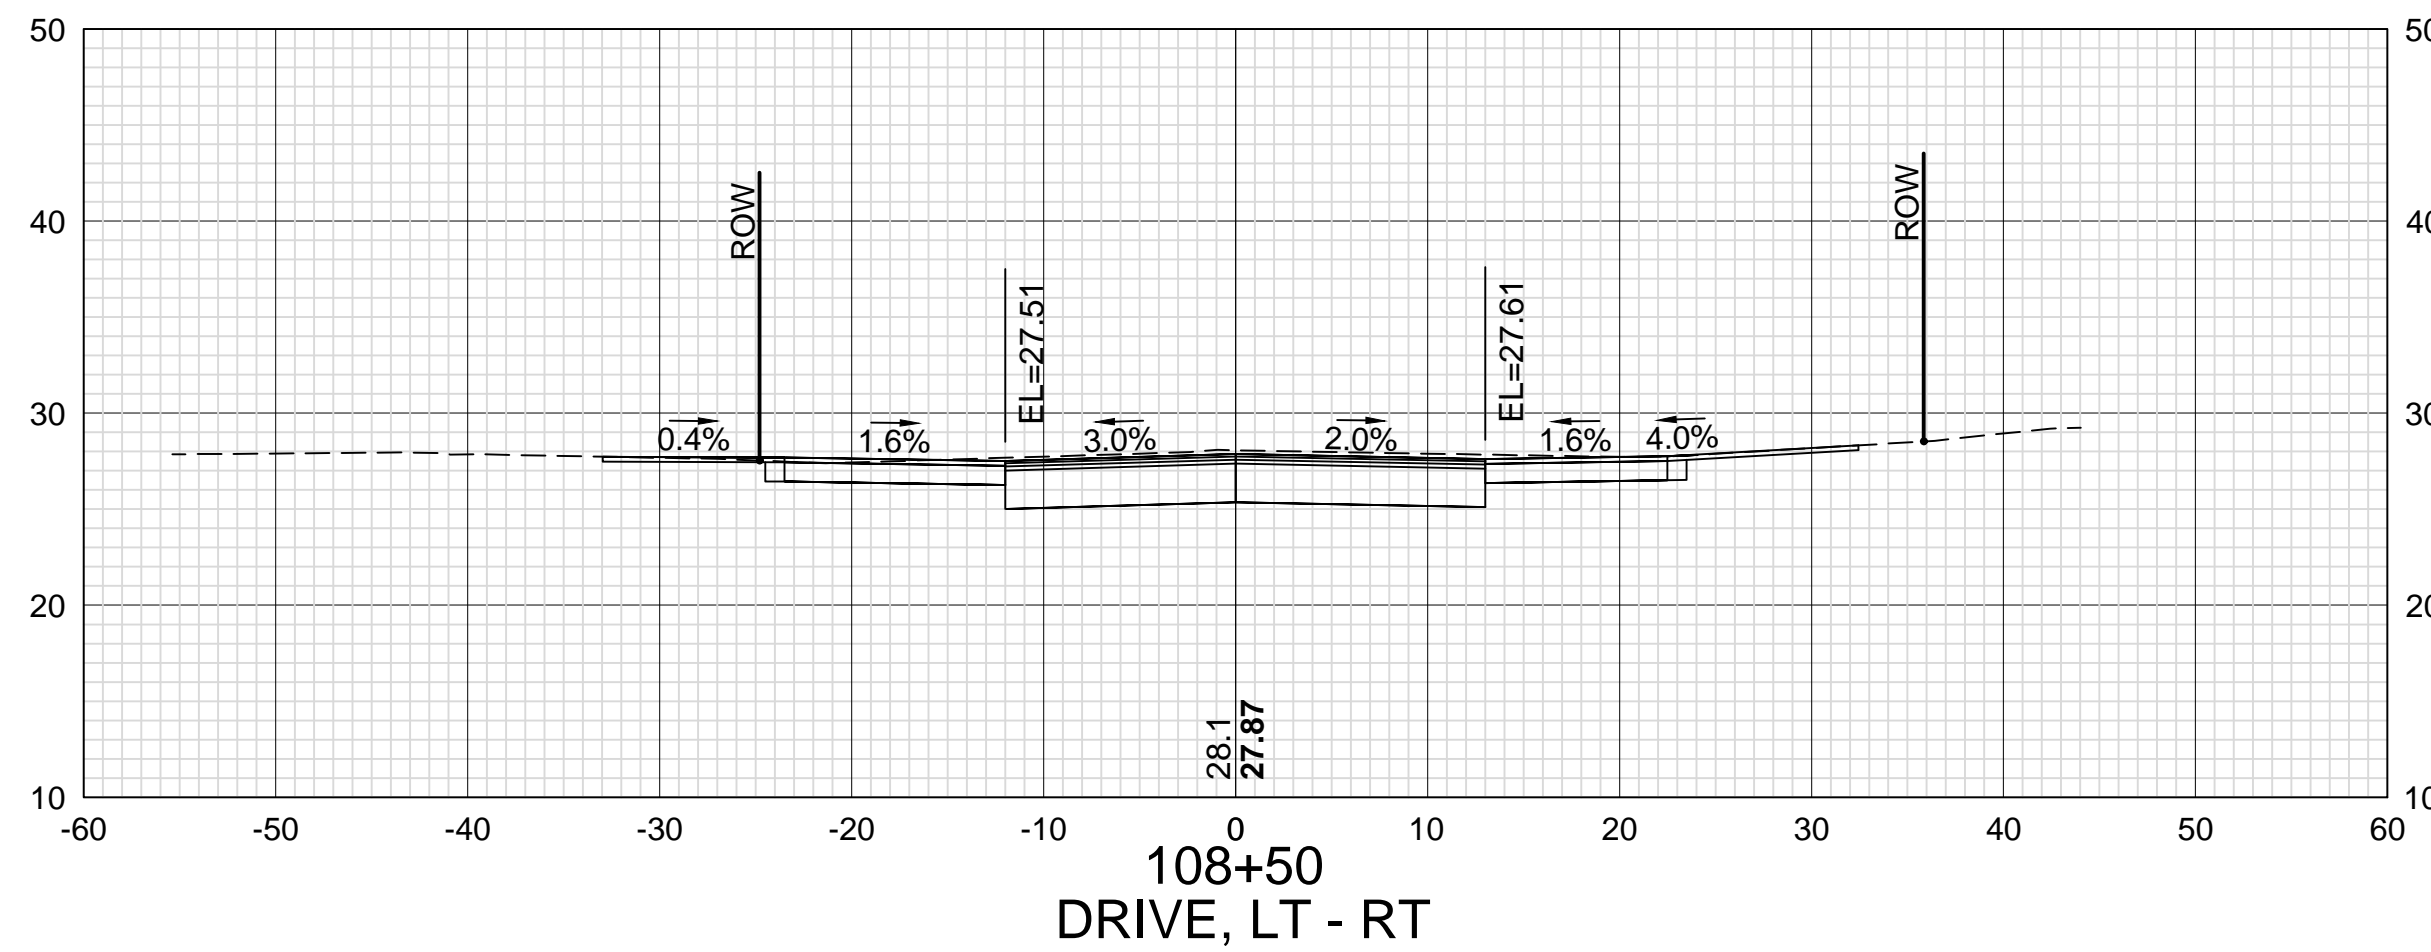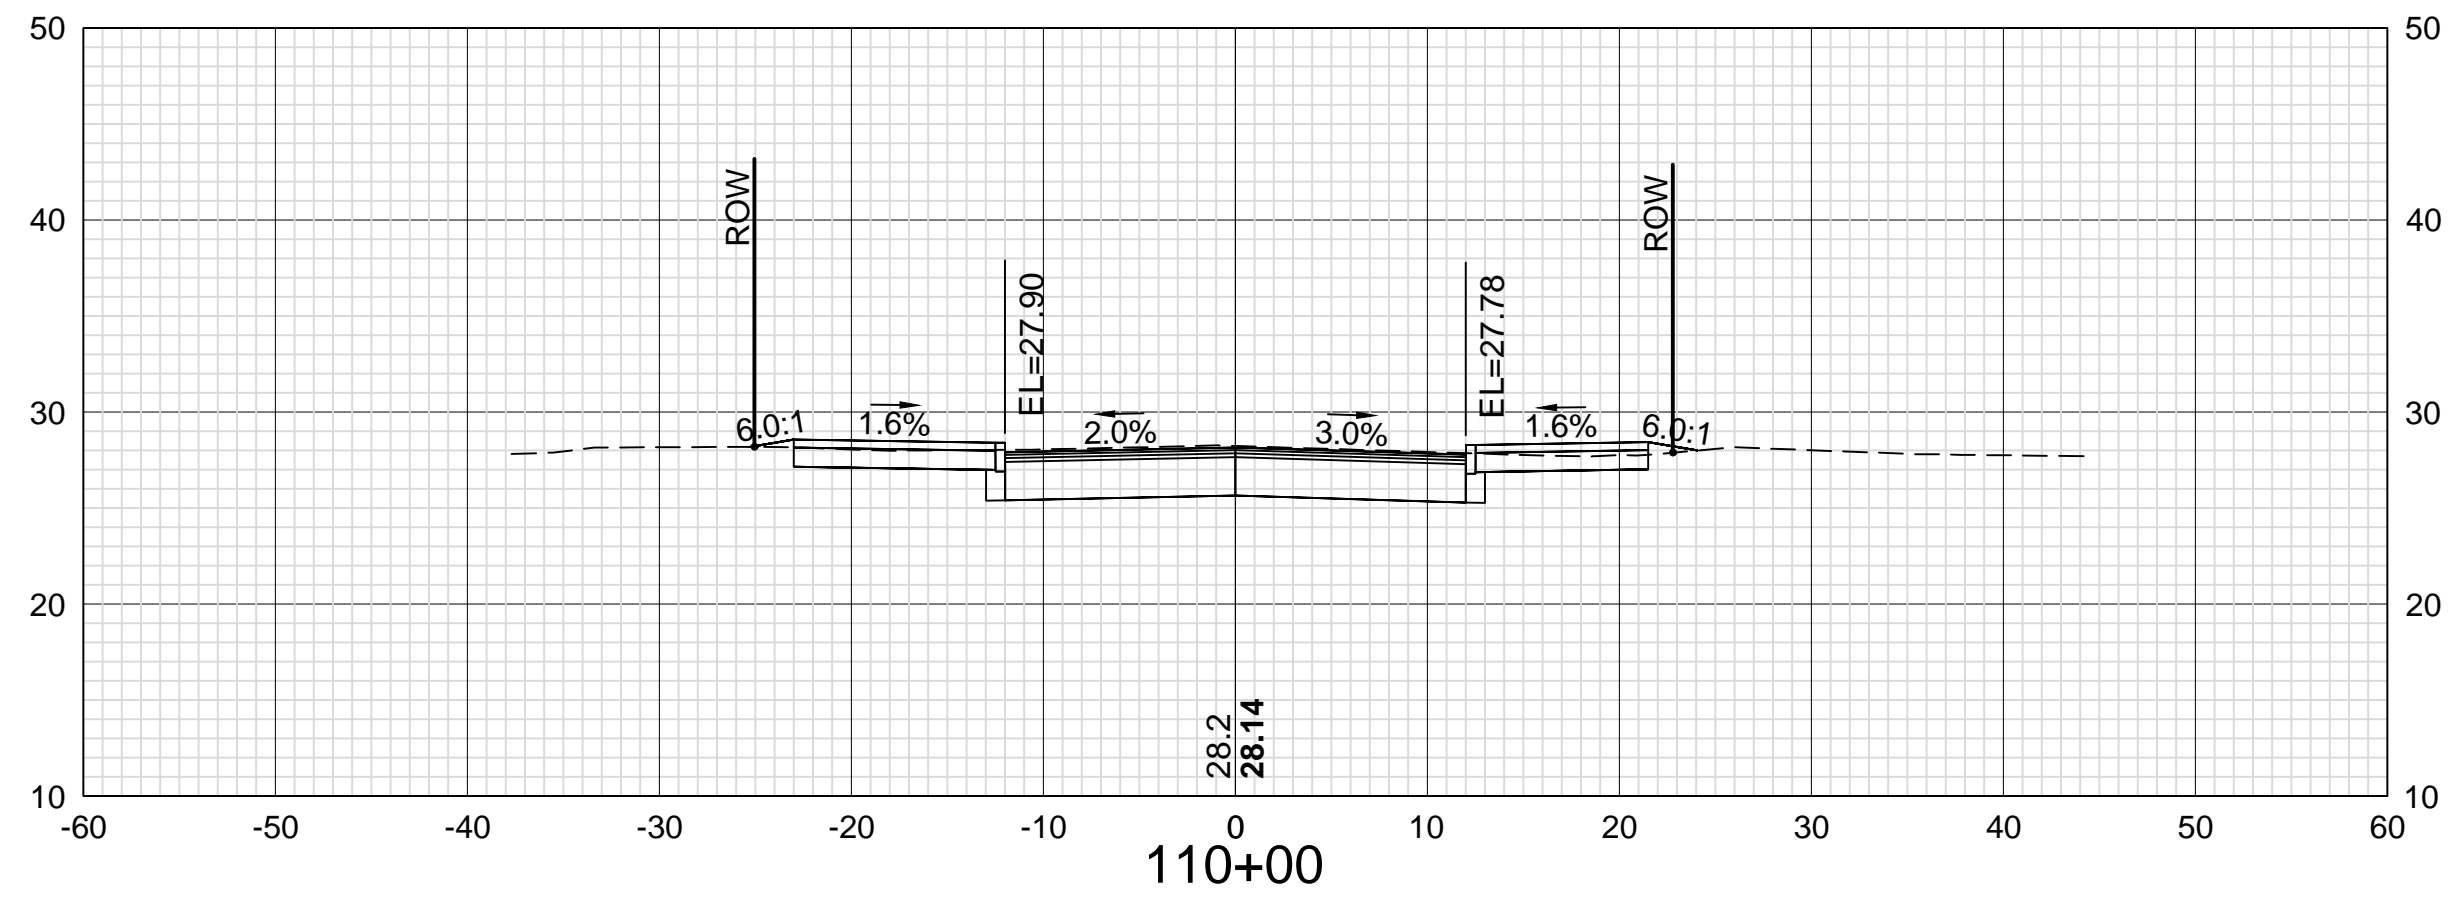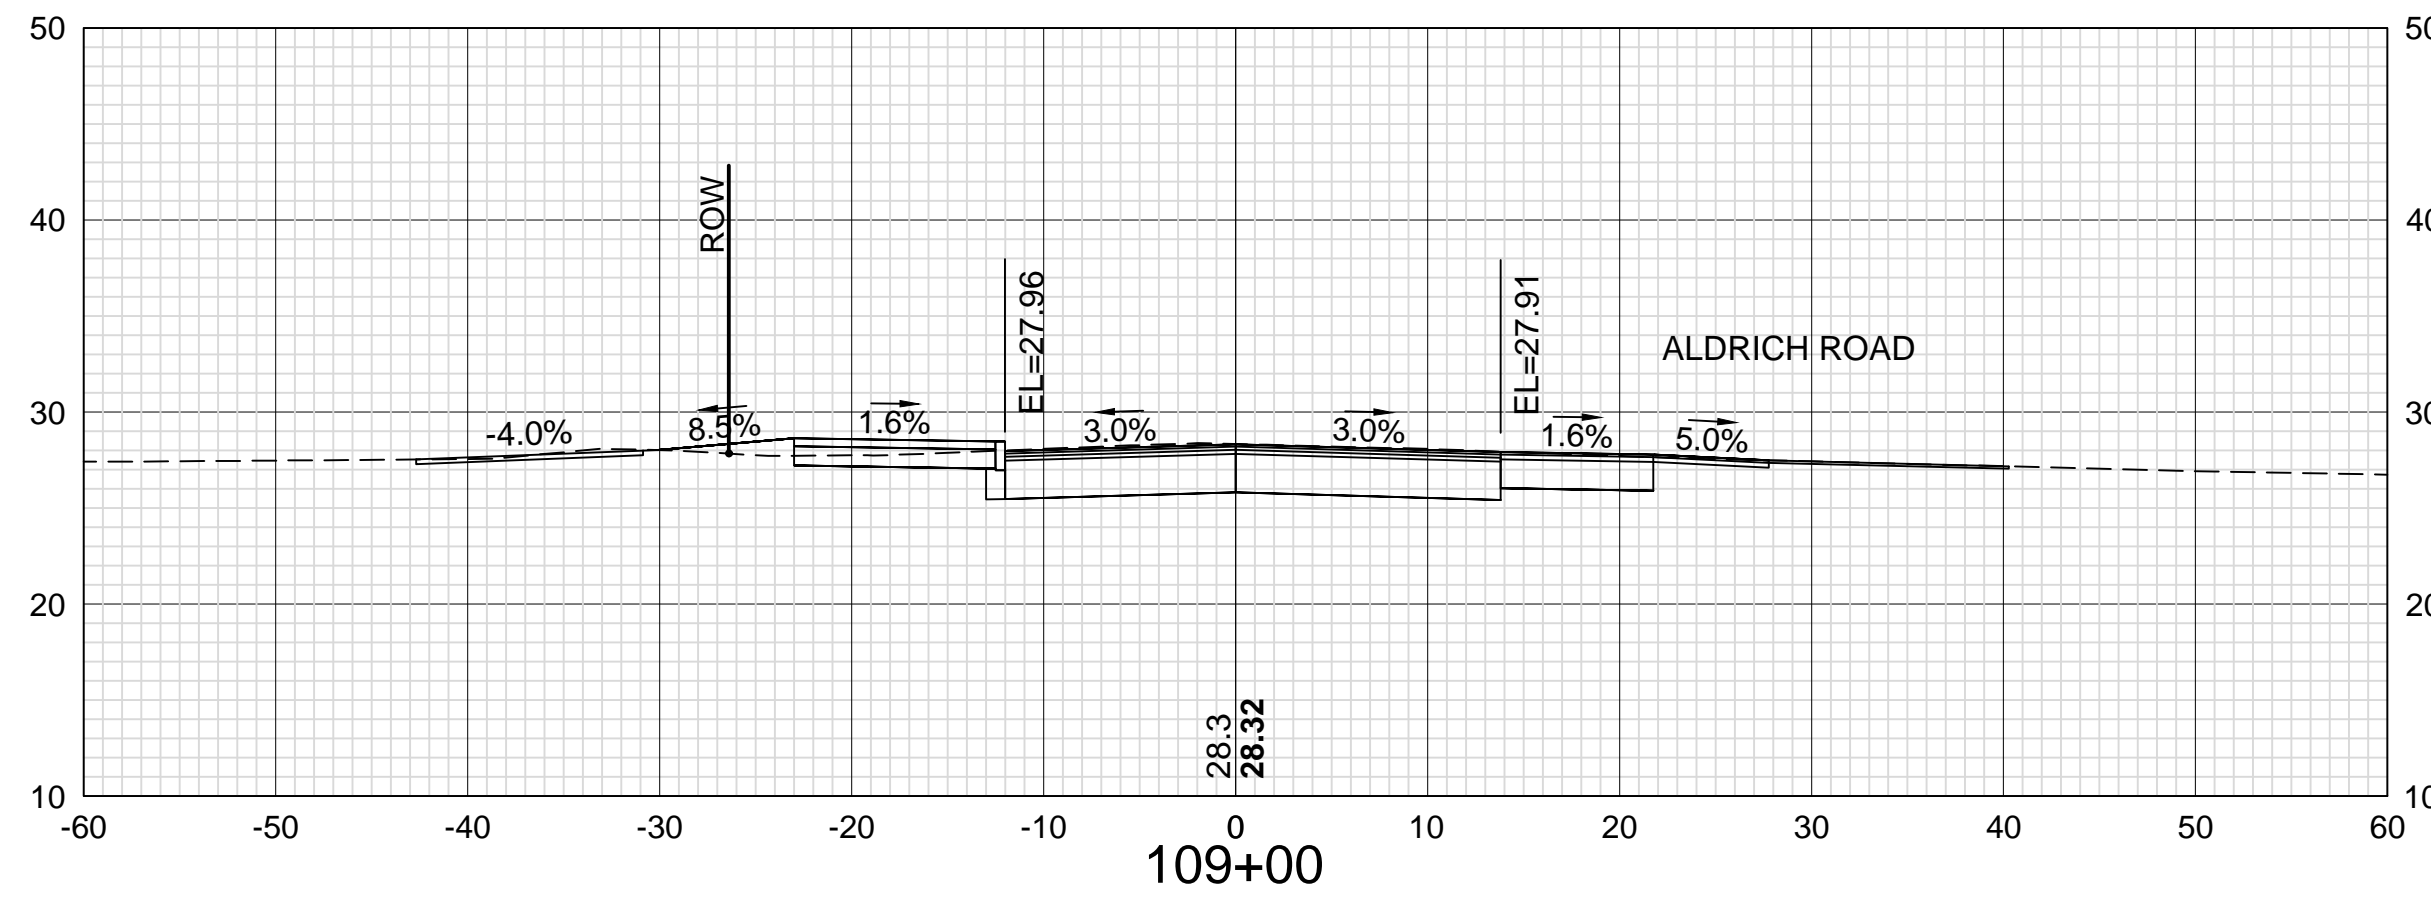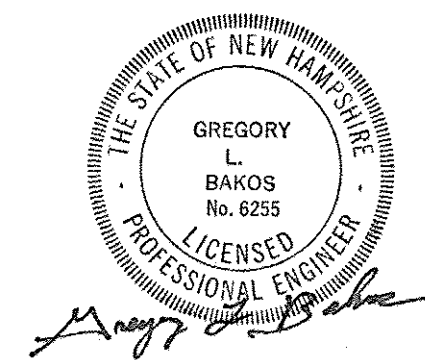

DATE PLOTTED	VHB PROJECT NO.
13-Nov-18	52393.00

ISLINGTON STREET CORRIDOR IMPROVEMENTS - SEGMENT 1			
CITY OF PORTSMOUTH, NEW HAMPSHIRE			
CROSS SECTIONS			
ISLINGTON STREET			
DRAWING	CITY PROJECT NO.	SHEET NO.	TOTAL SHEETS
XS-Seg1	7176	56	88

REVISIONS AFTER PROPOSAL

DESCRIPTION

STATION

STATION

DATE

NUMBER

DATE

DATE

DATE

SDR PROCESSED

VHB

DATE

STATION

STATION

DATE

NUMBER

DATE









DATE

DATE

VHB

DATE


DATE

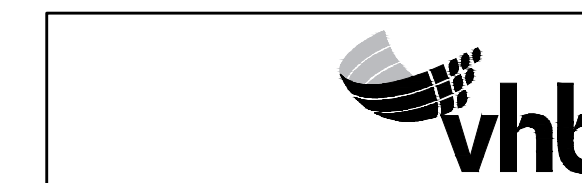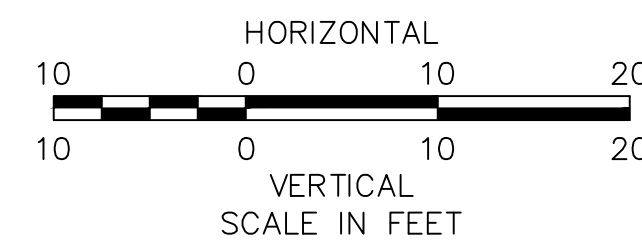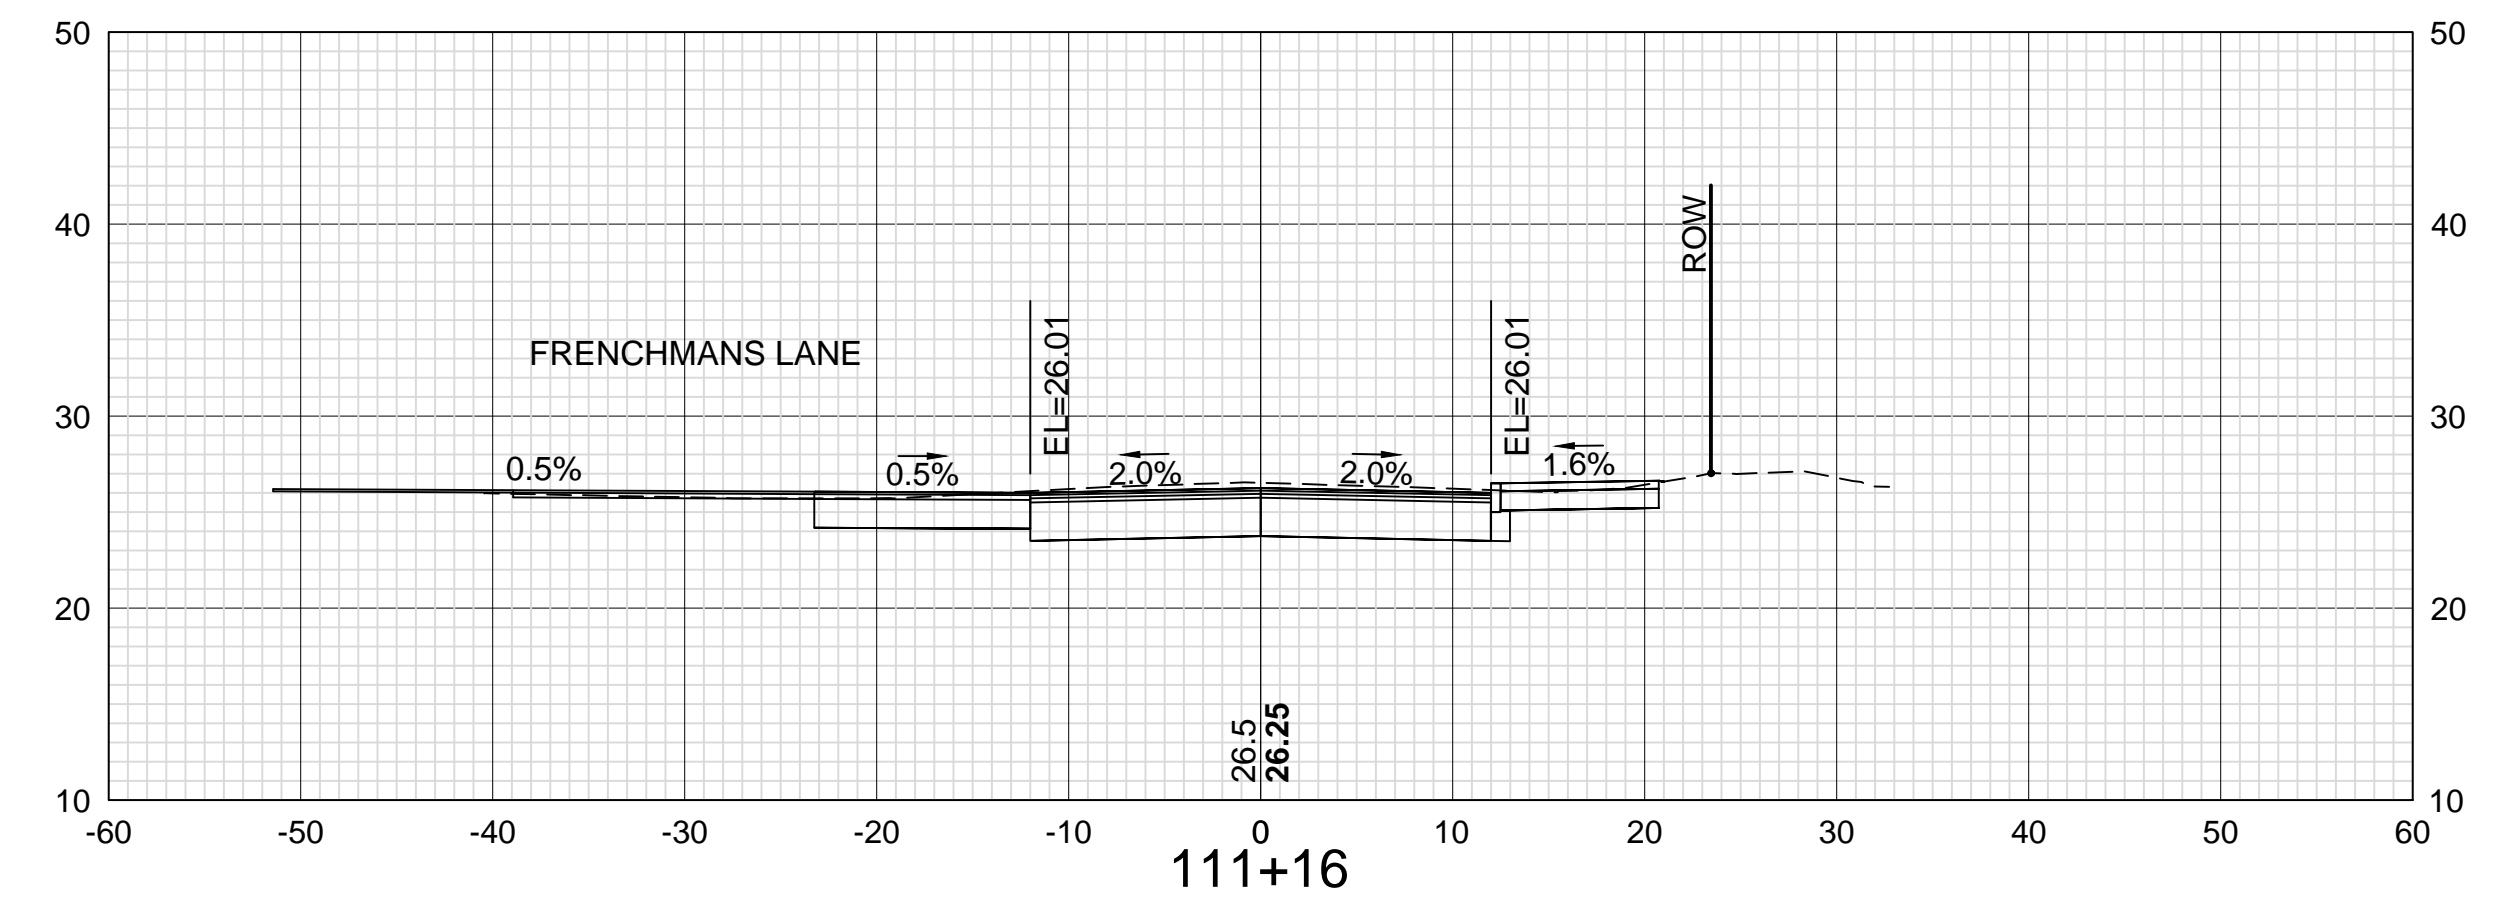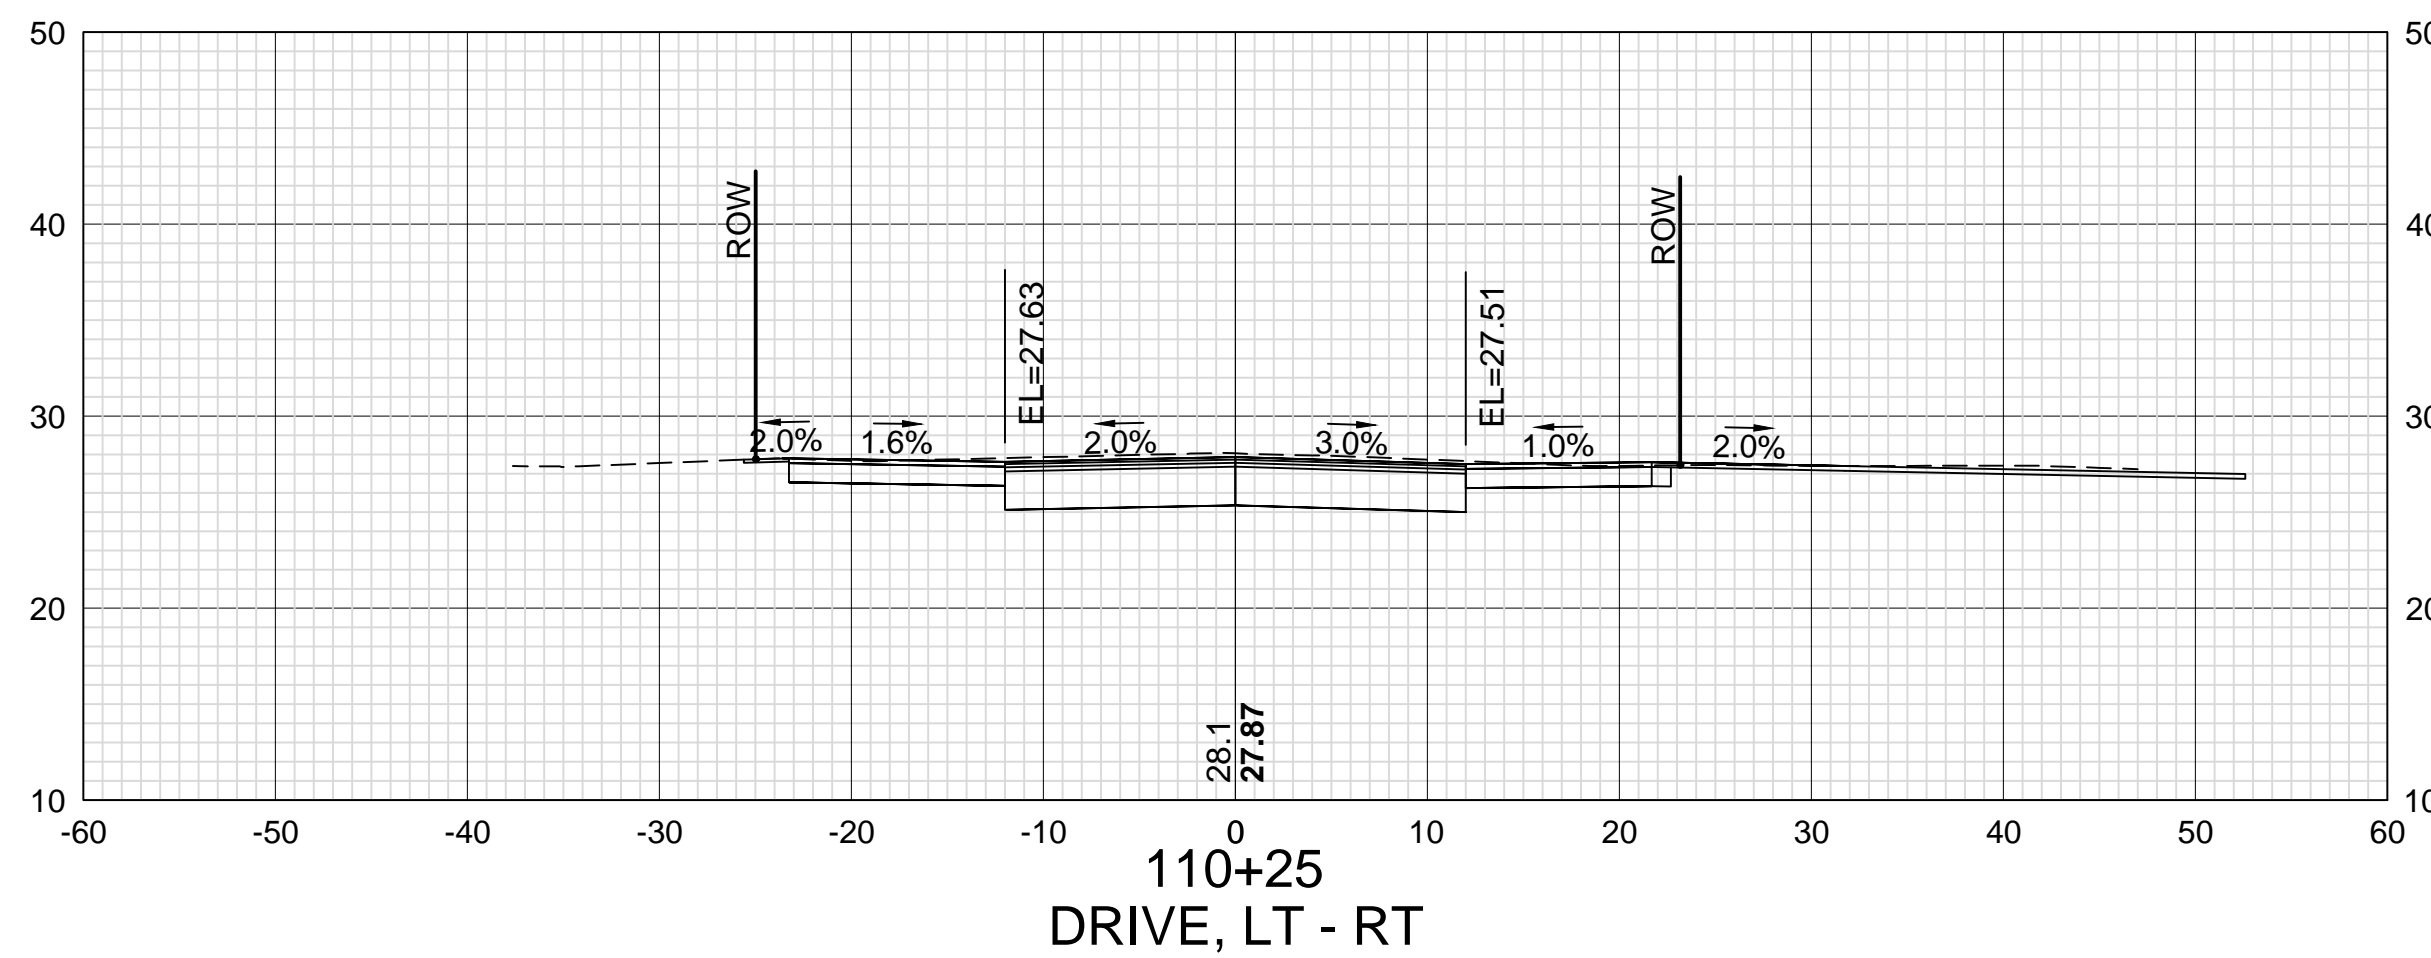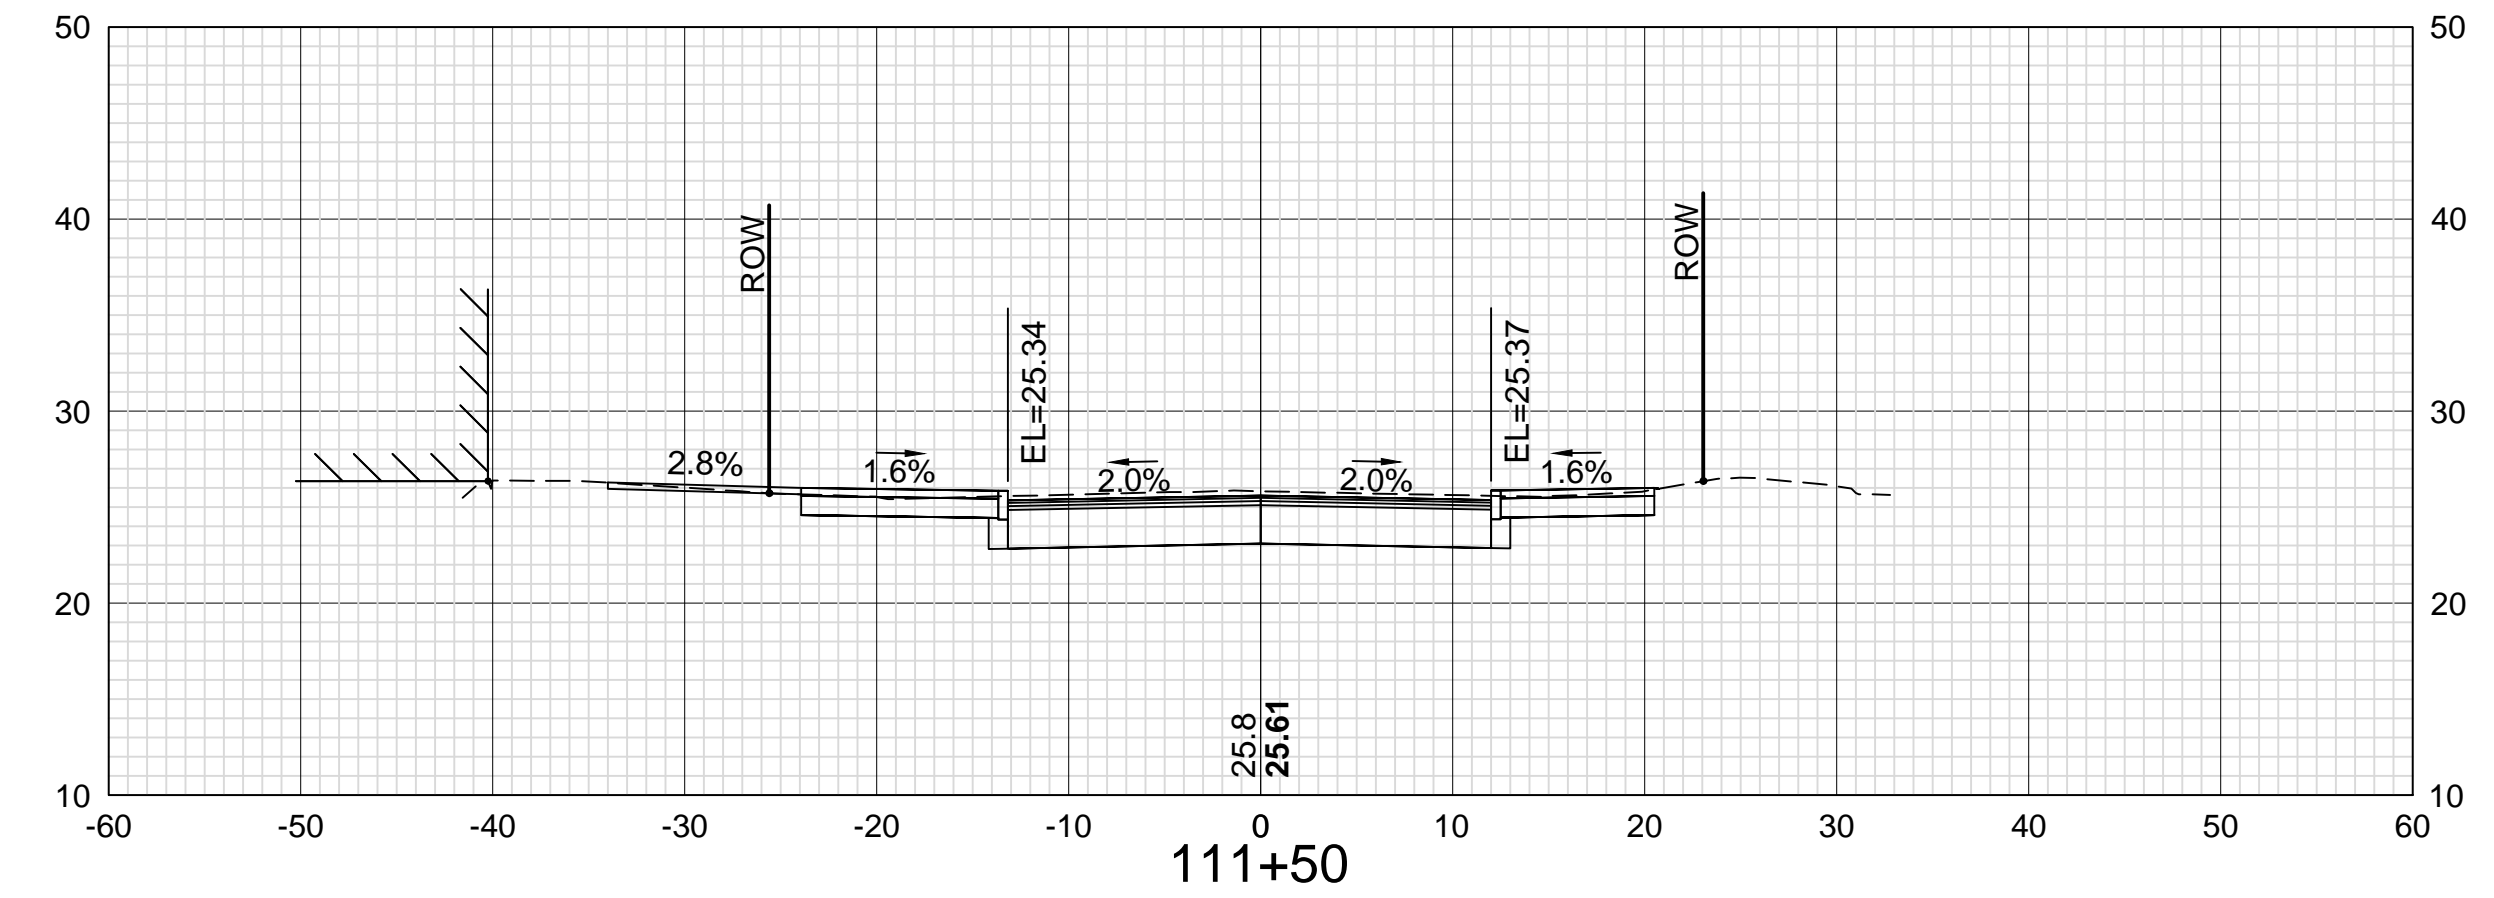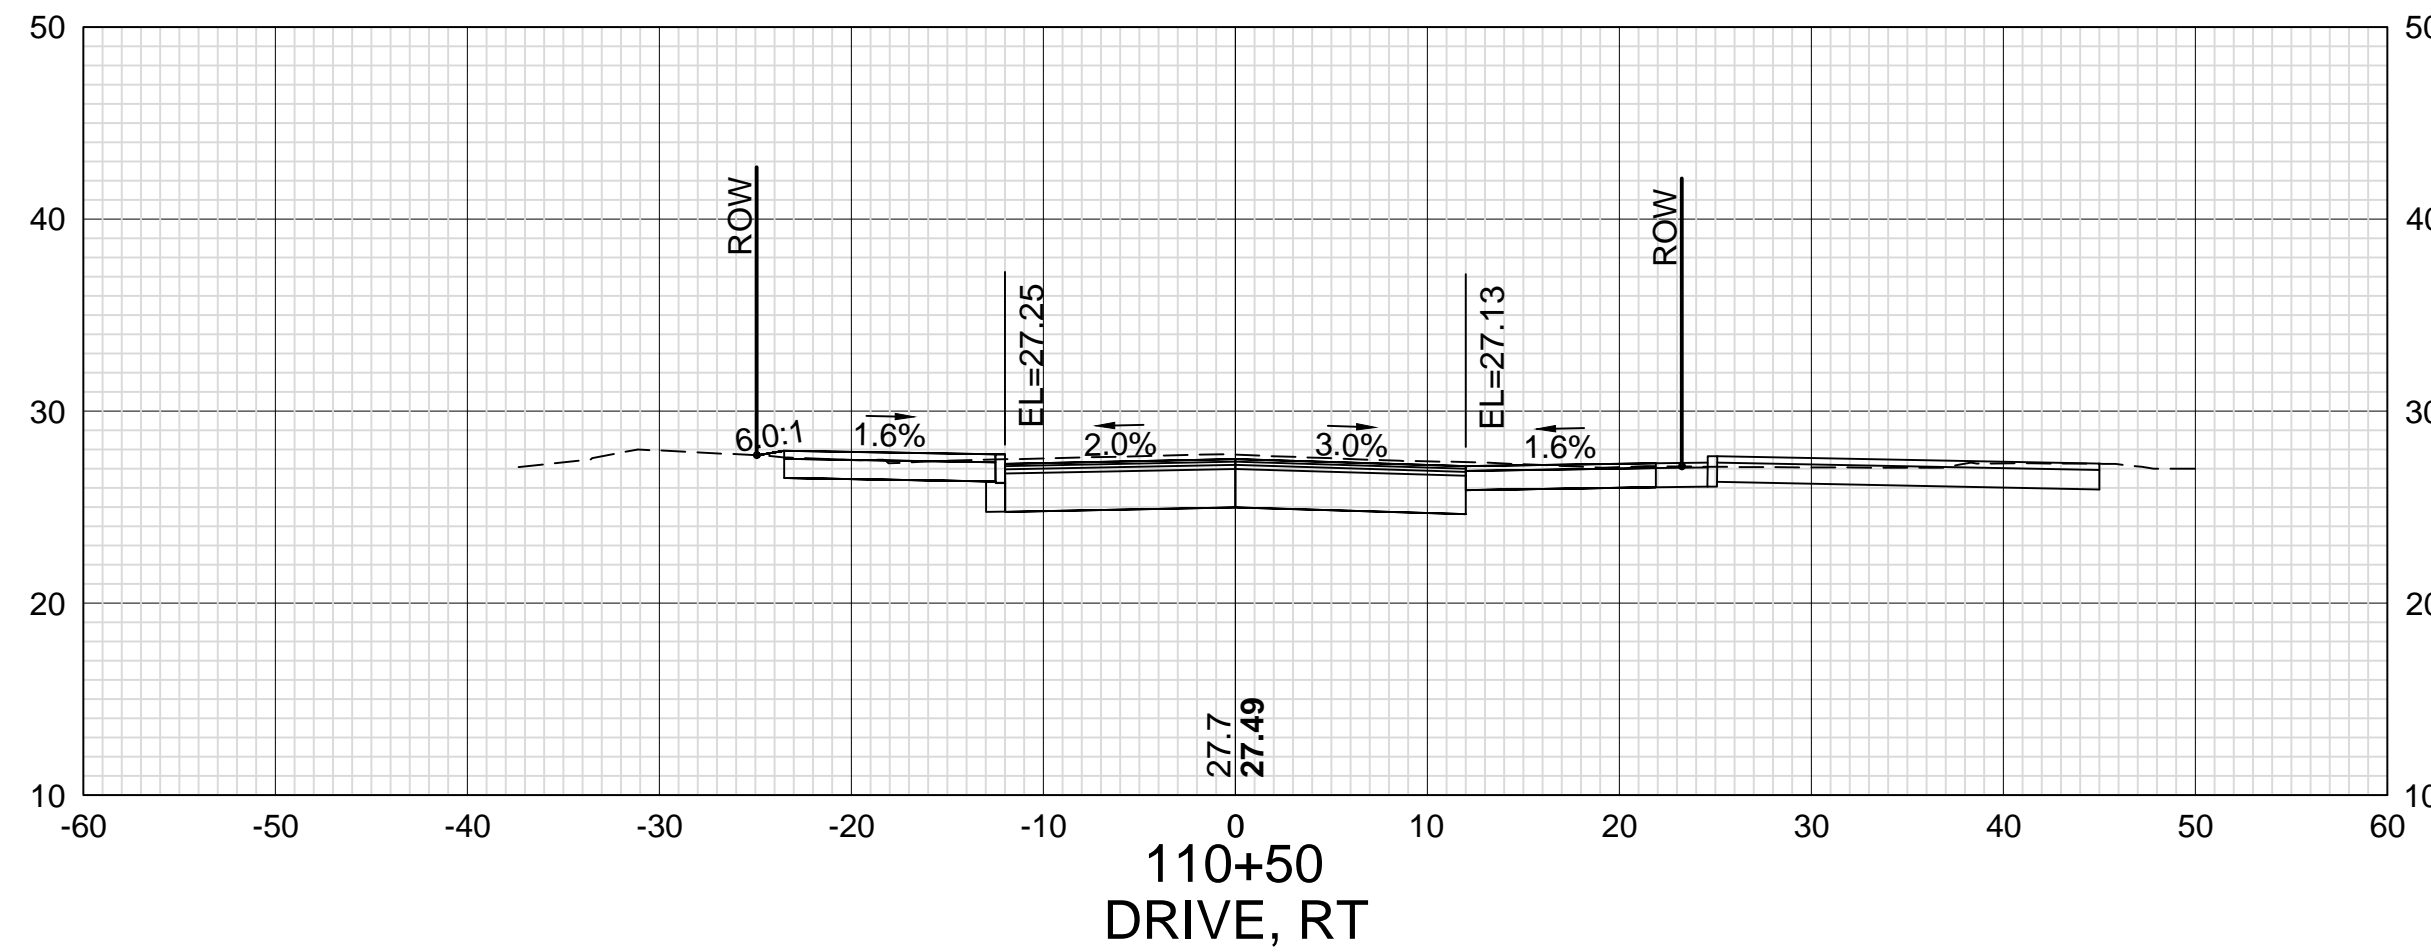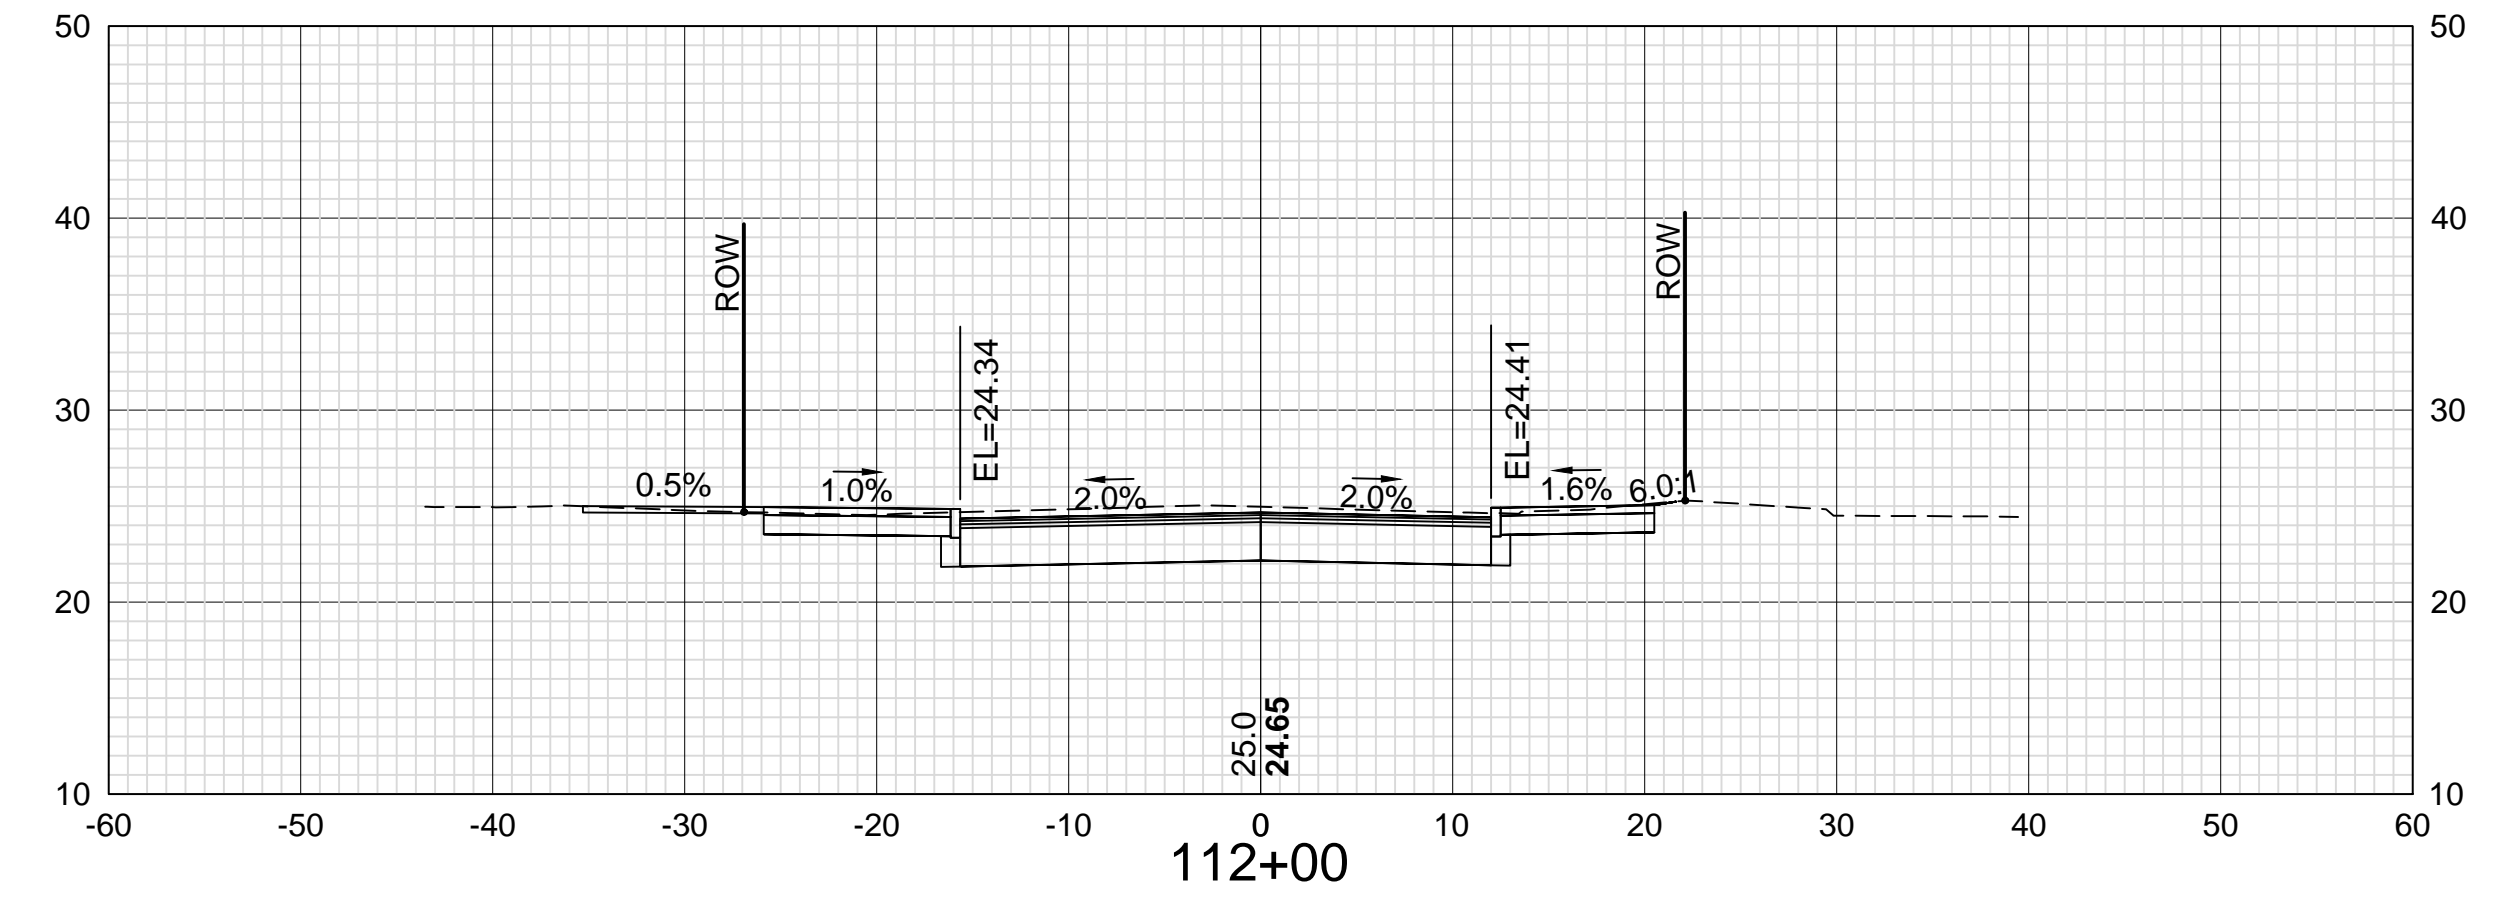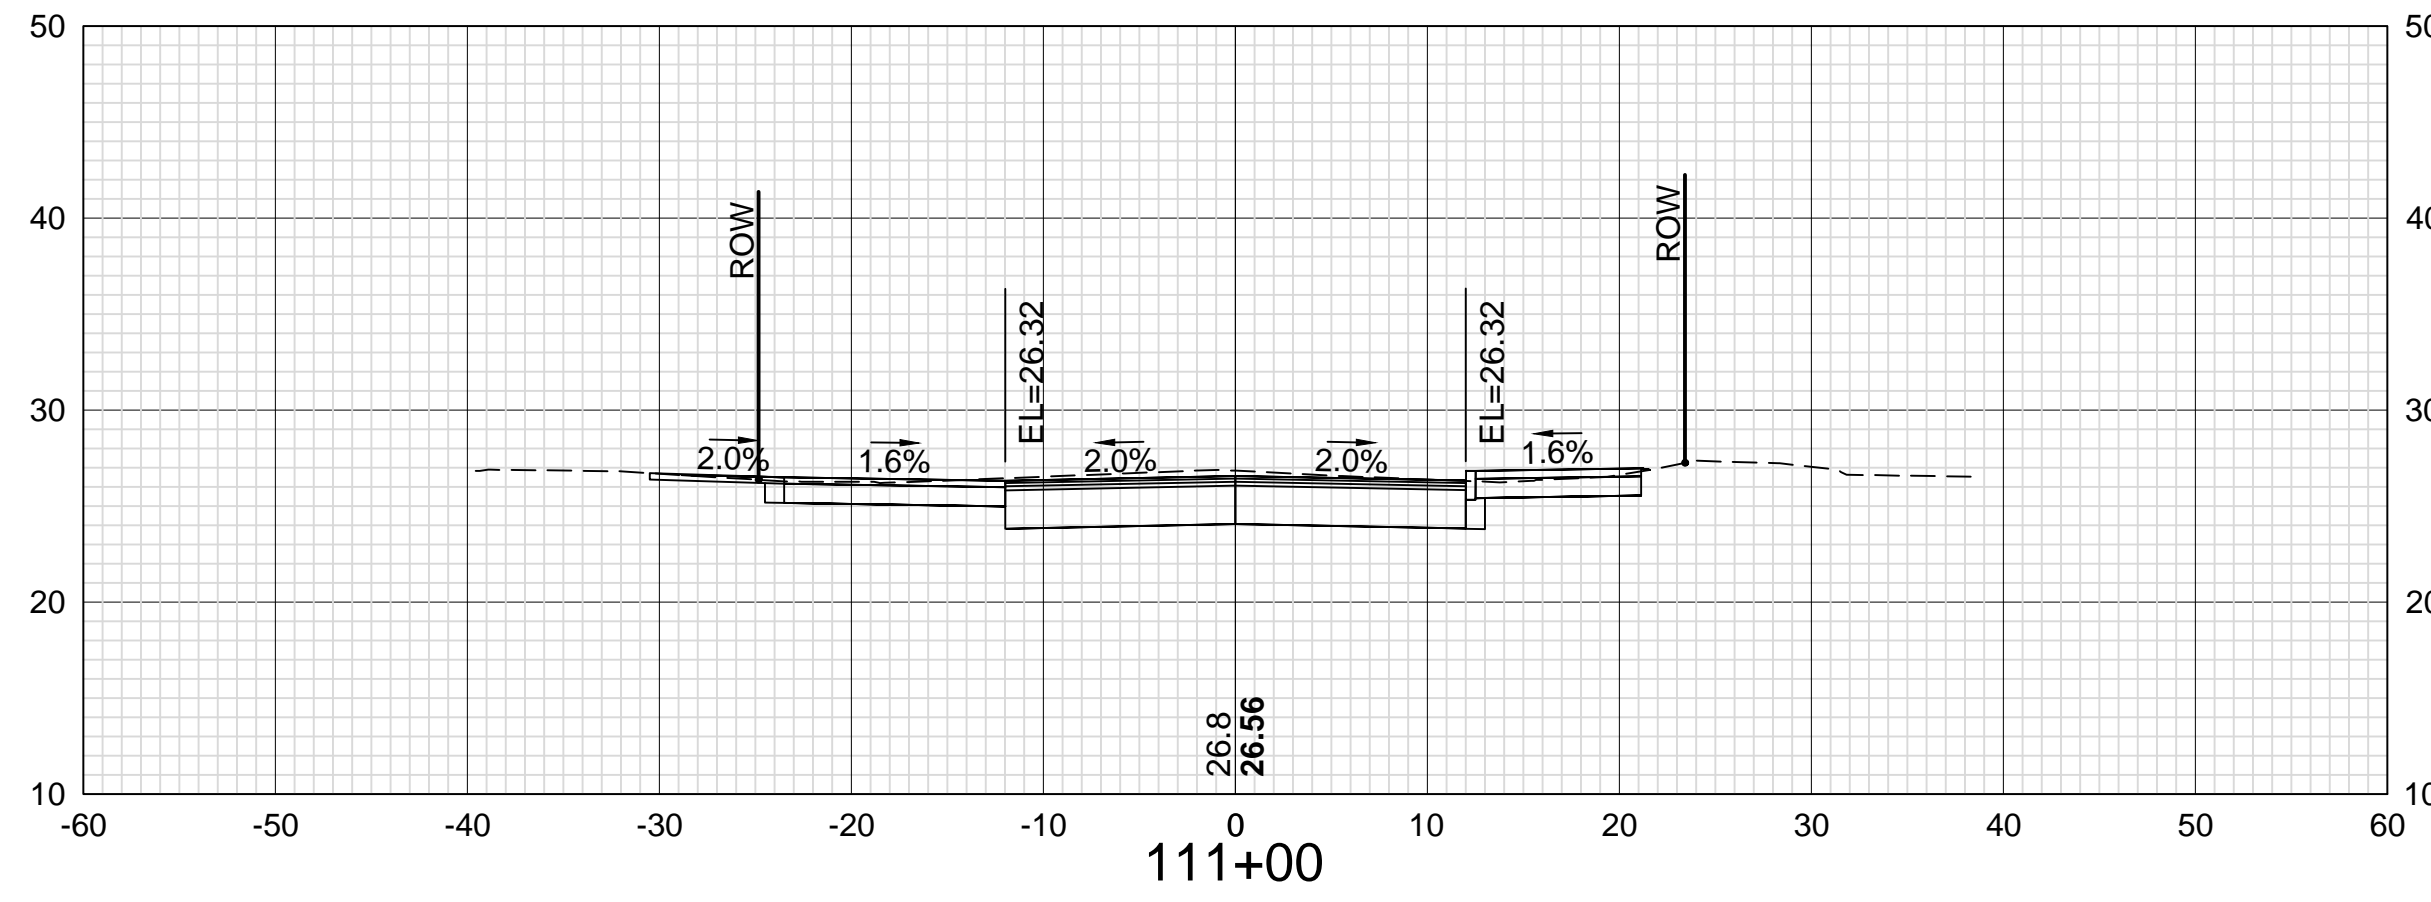

DATE PLOTTED
13-Nov-18

VHB PROJECT NO.
52393.00

ISLINGTON STREET CORRIDOR IMPROVEMENTS - SEGMENT 1				
CITY OF PORTSMOUTH, NEW HAMPSHIRE				
CROSS SECTIONS				
ISLINGTON STREET				
DRAWING	CITY PROJECT NO.	SHEET NO.	TOTAL SHEETS	
XS-Seg1	7176	57	88	

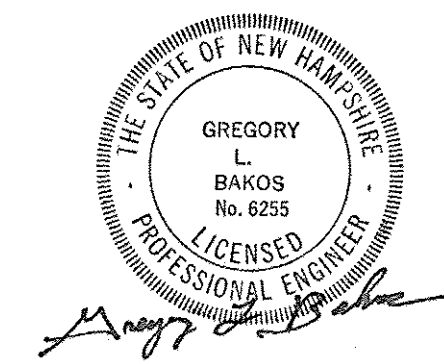

REVISIONS AFTER PROPOSAL

DESCRIPTION

STATION

STATION

DATE








NUMBER

DATE

DATE

DATE

SDR PROCESSED VHB
NEW DESIGN KMH
SHEET CHECKED GLB
AS BUILT DETAILS

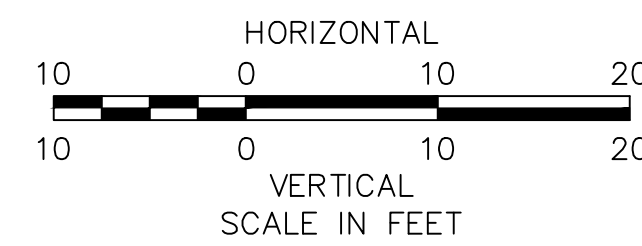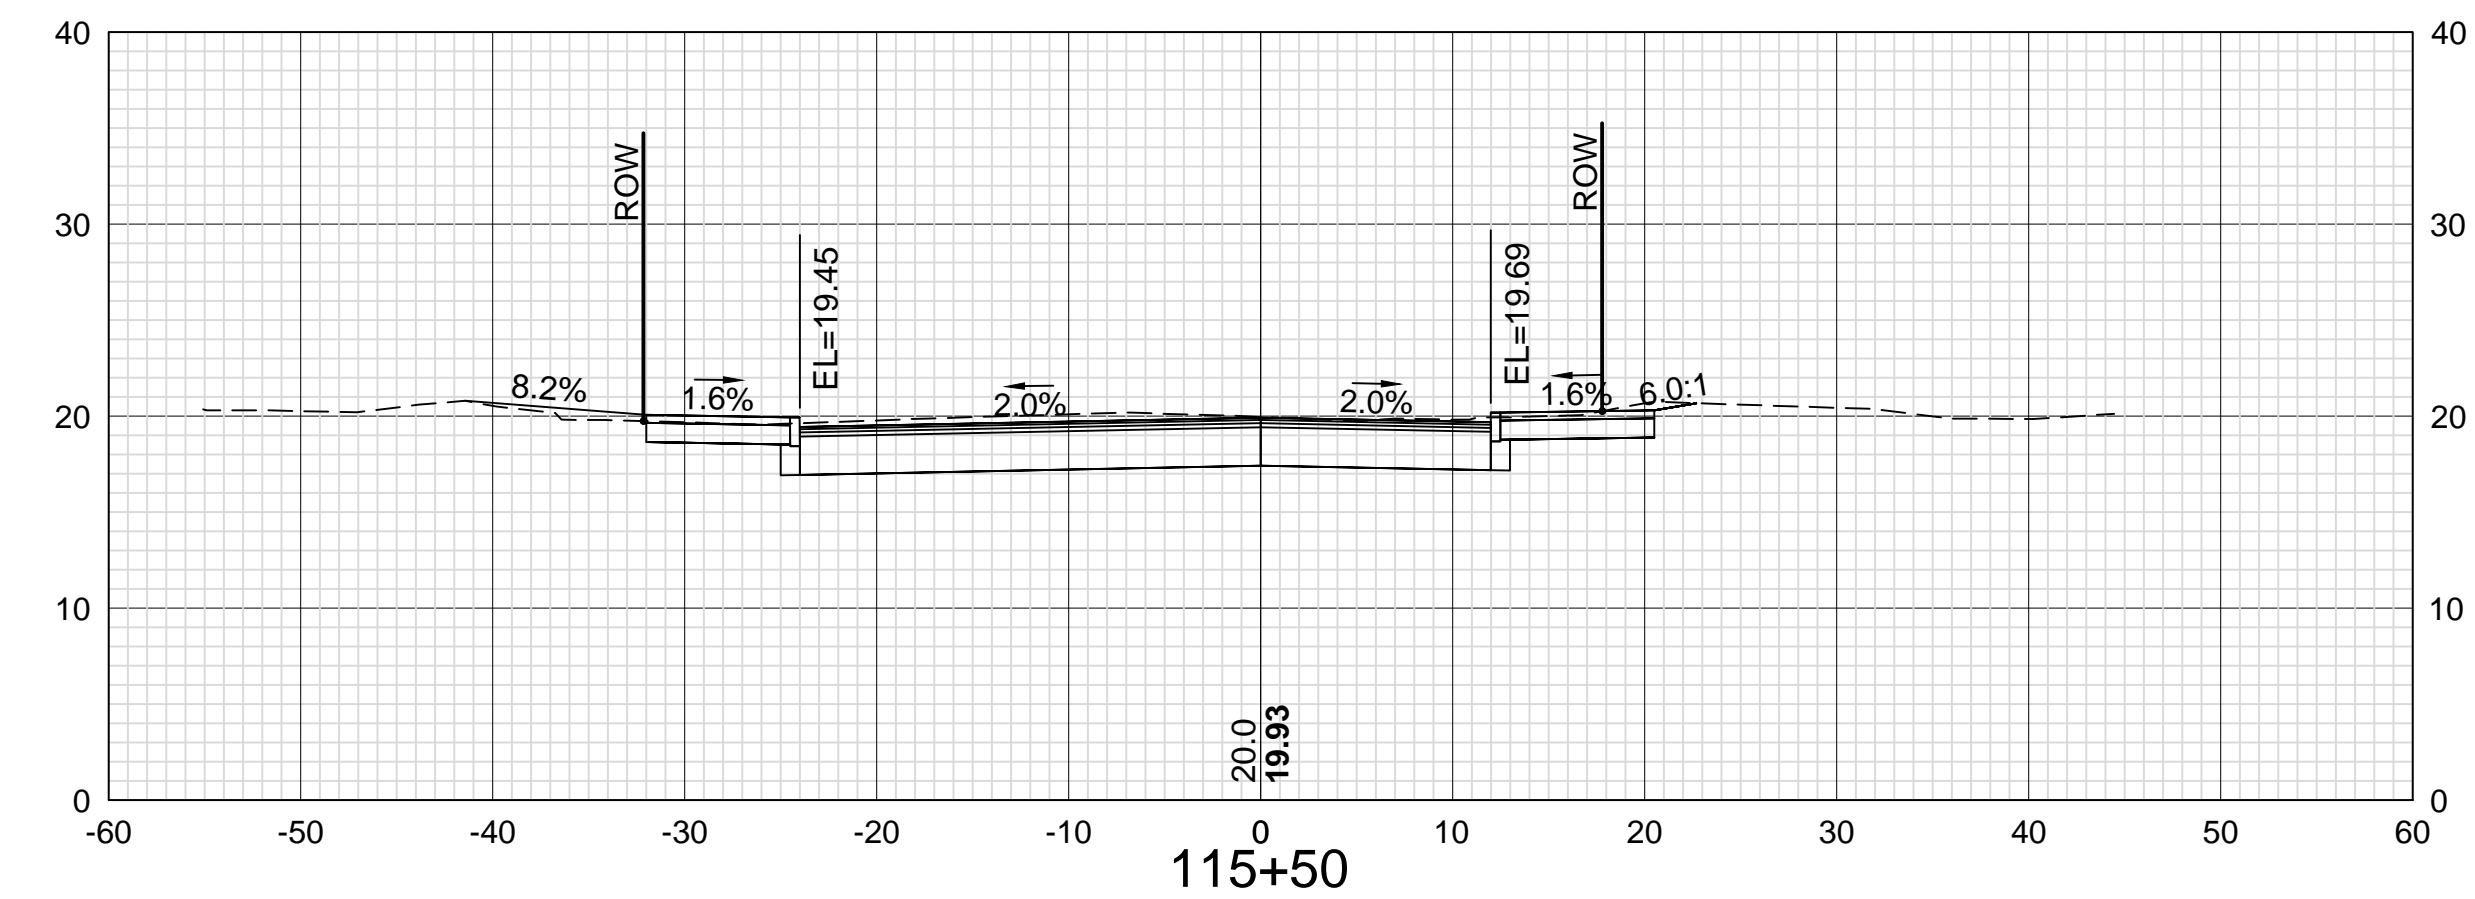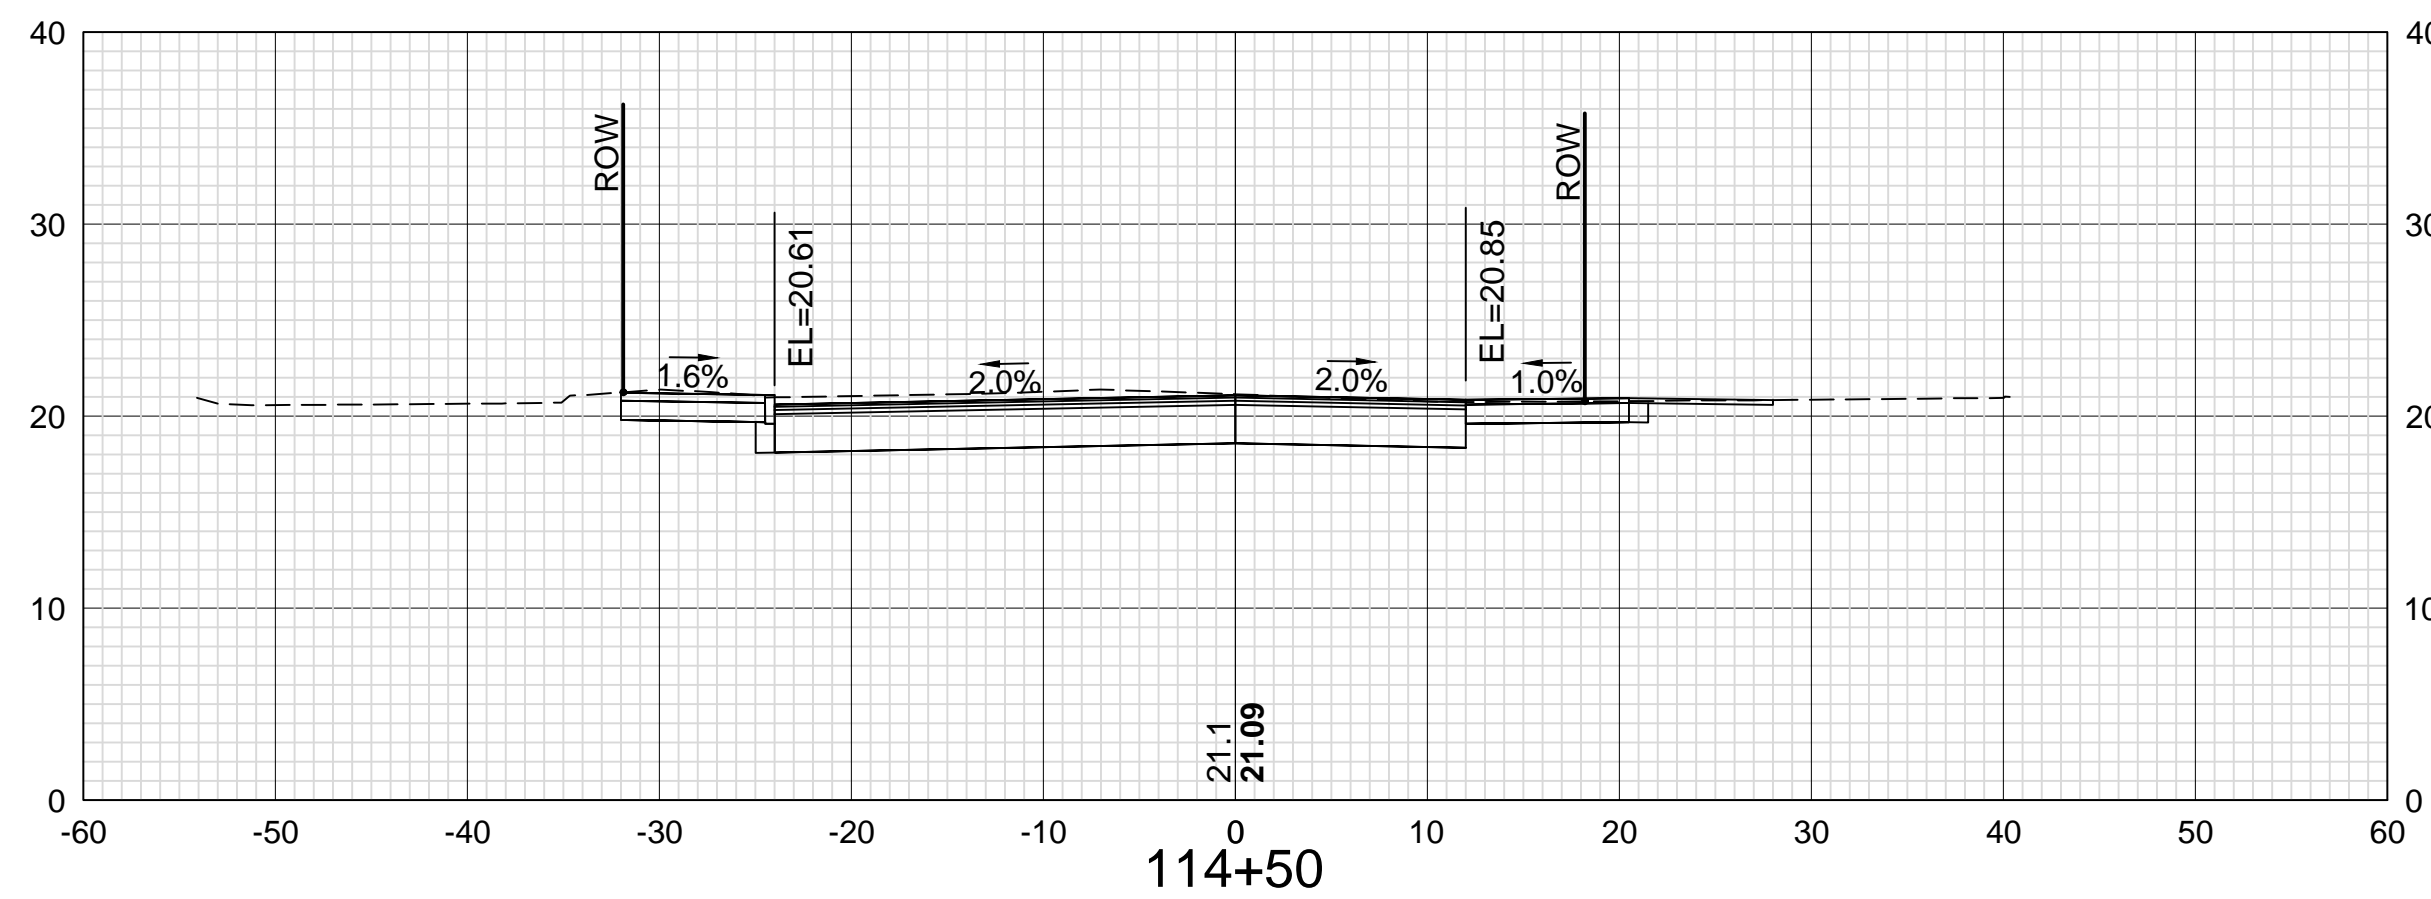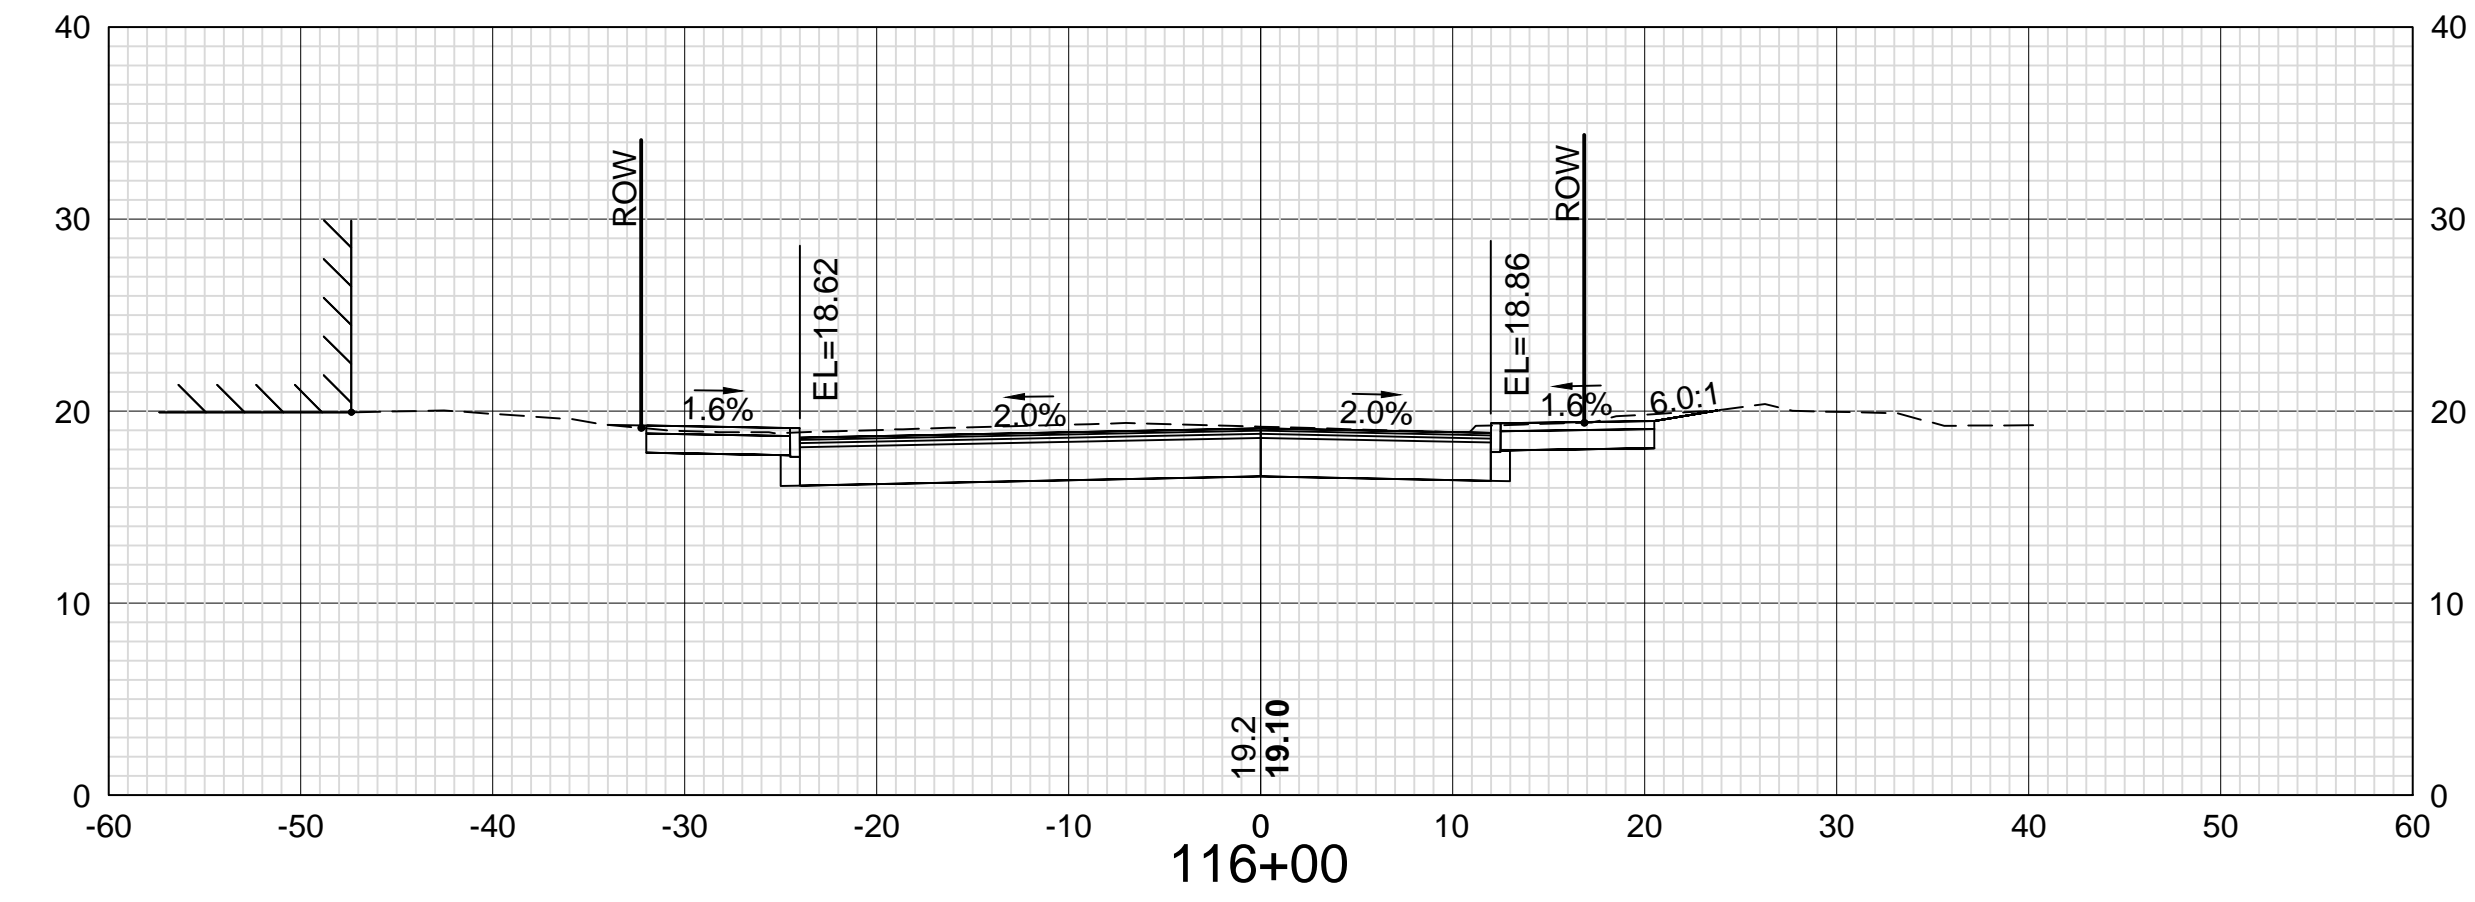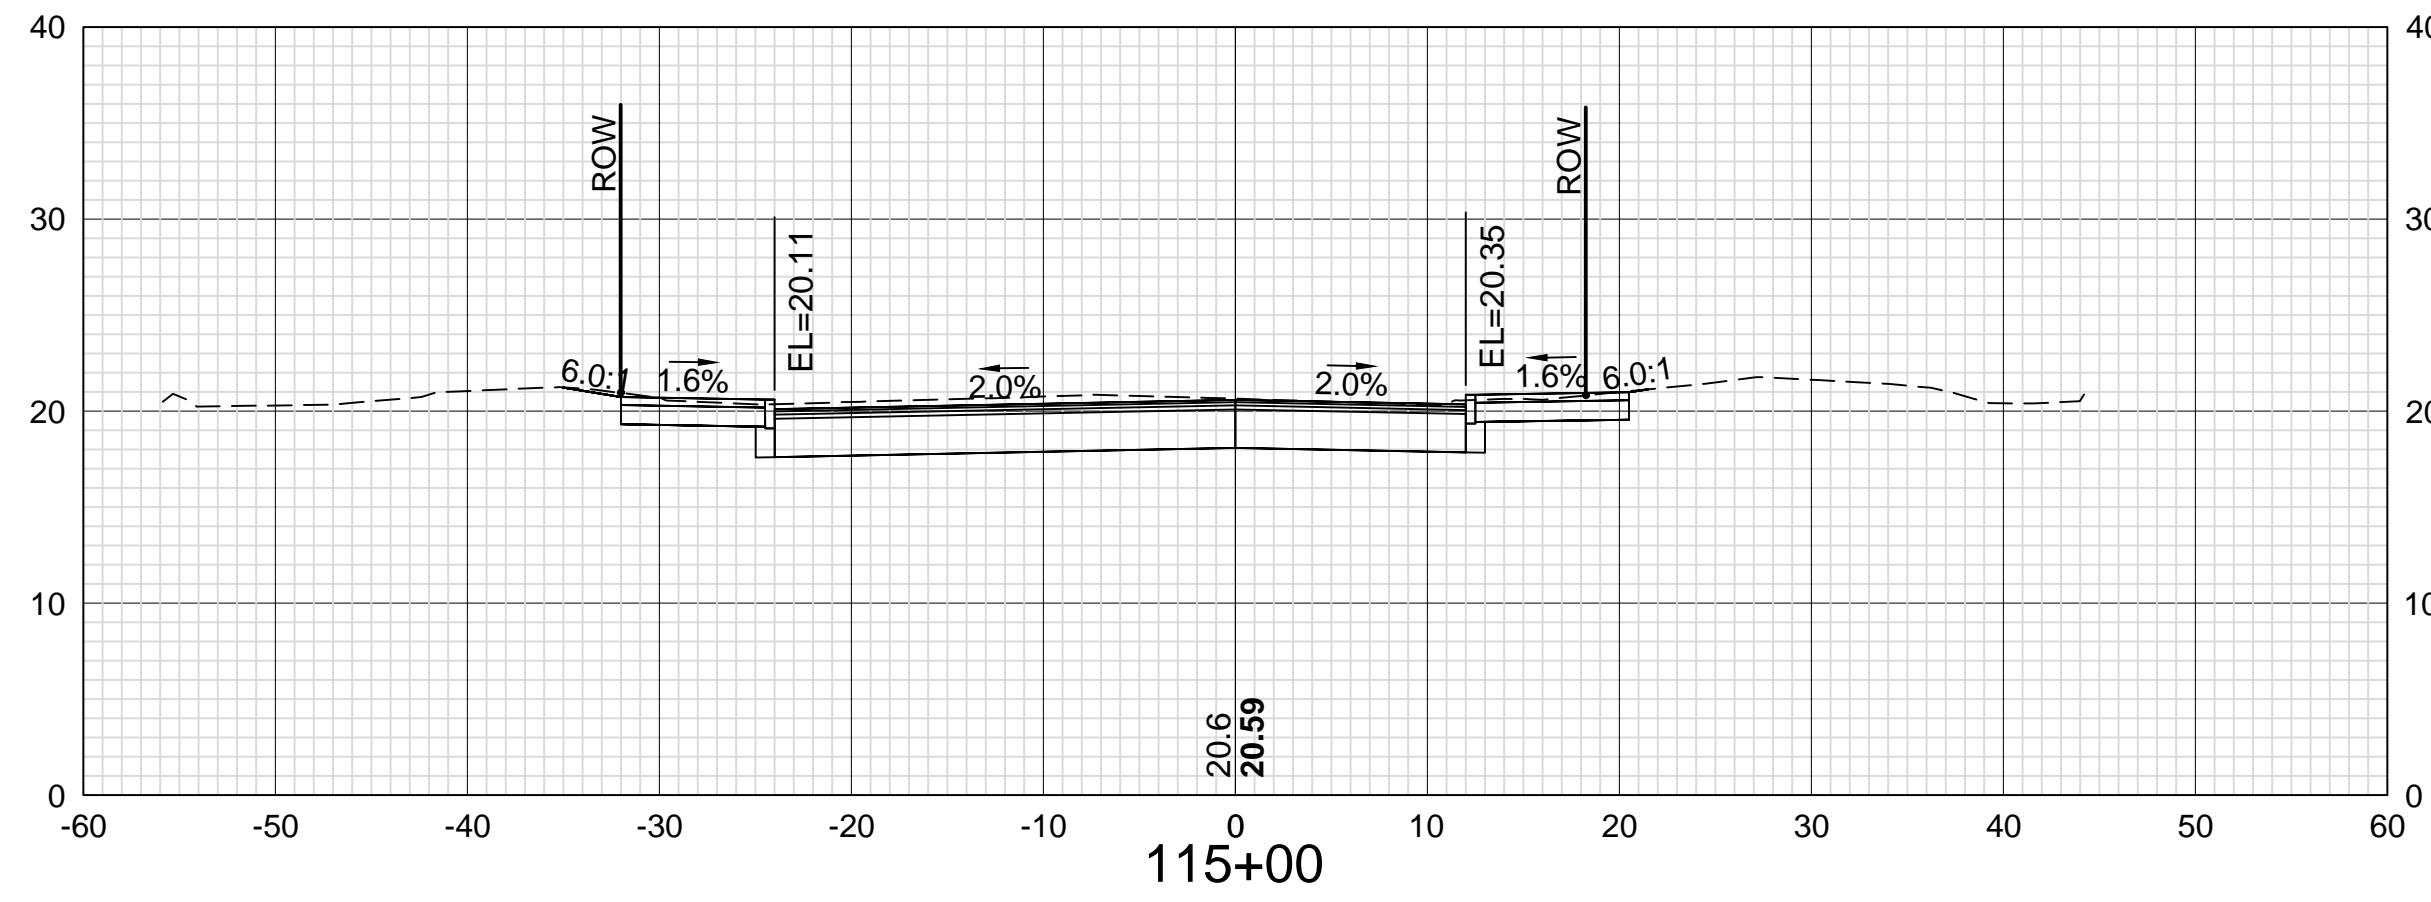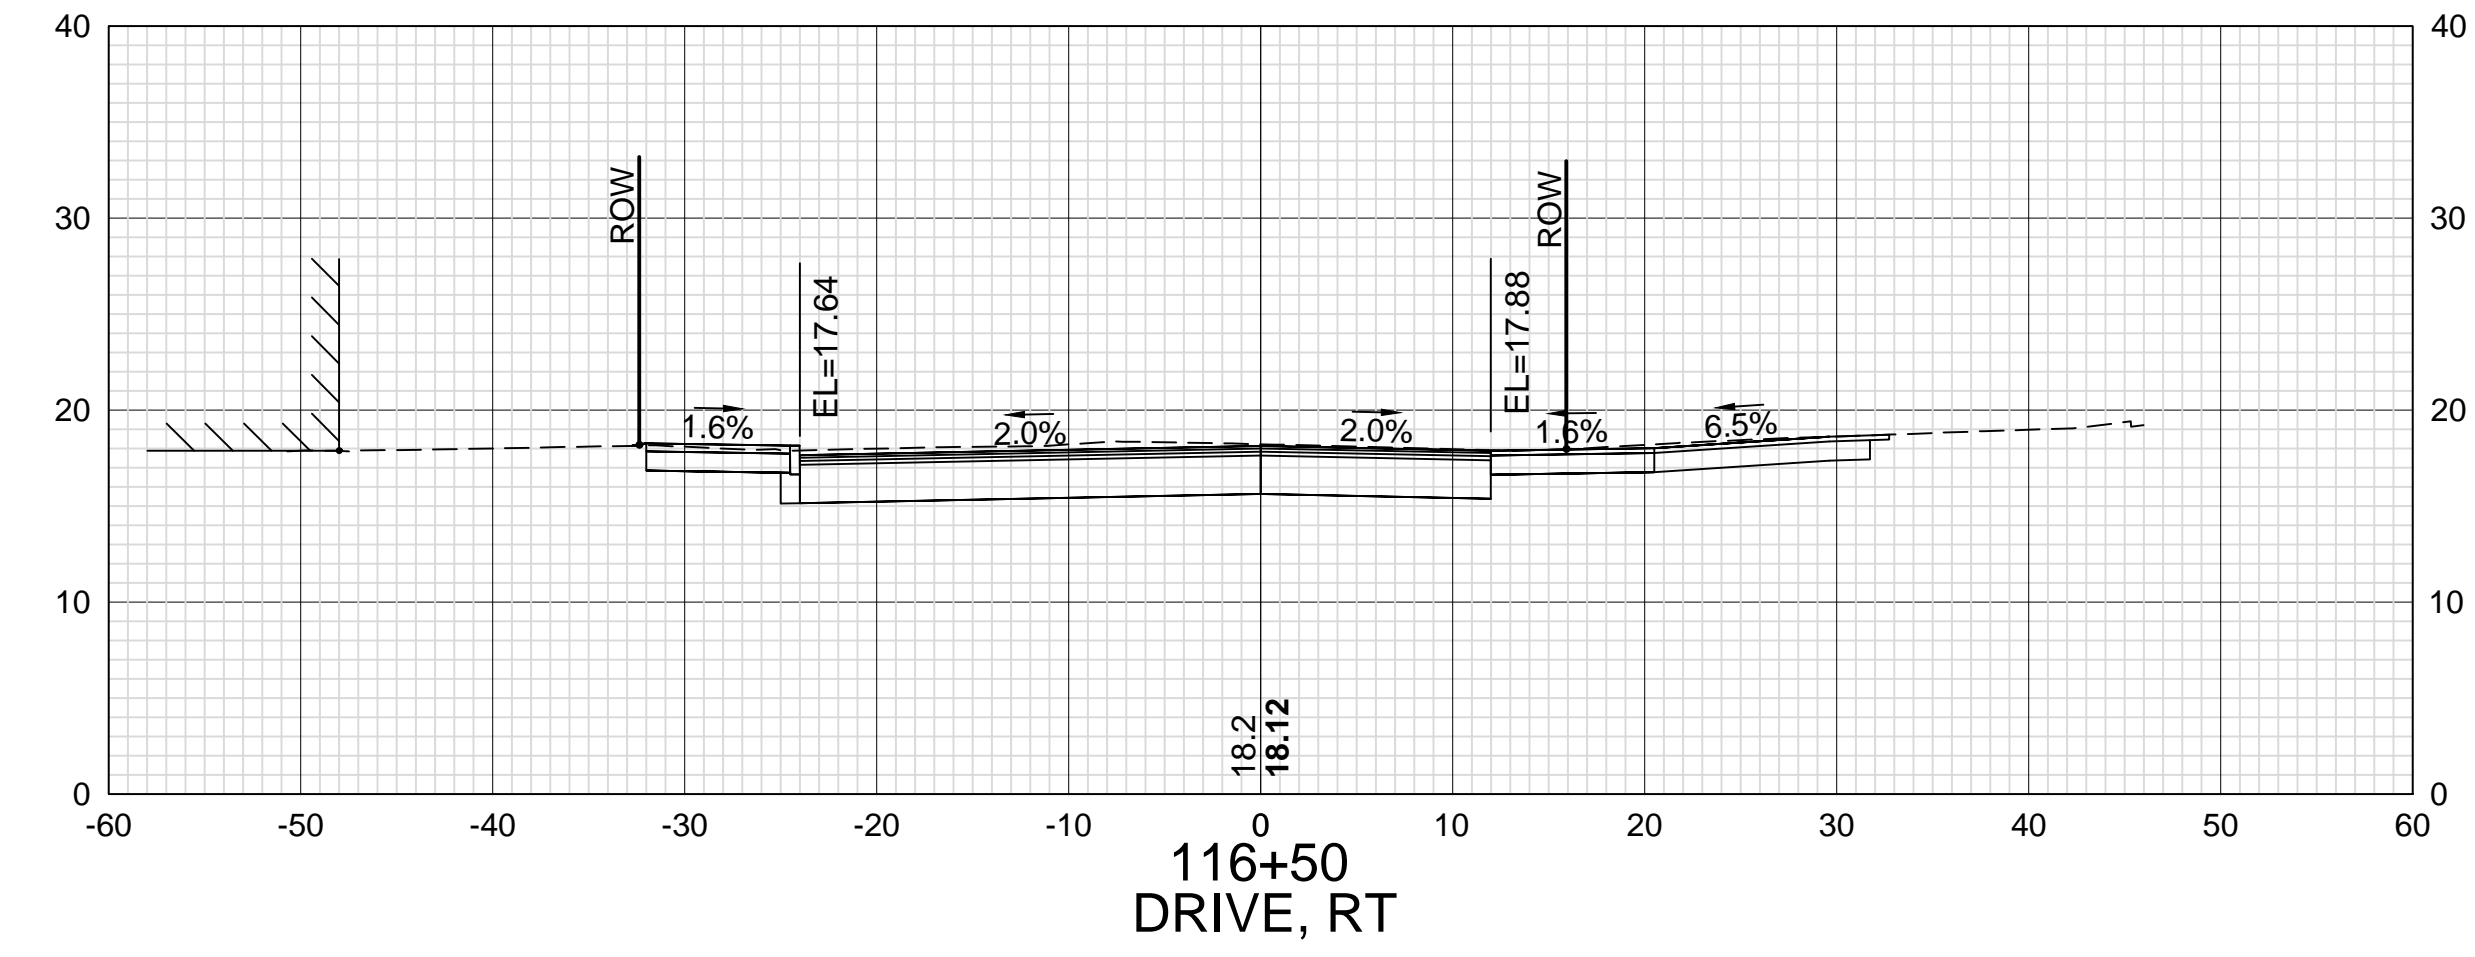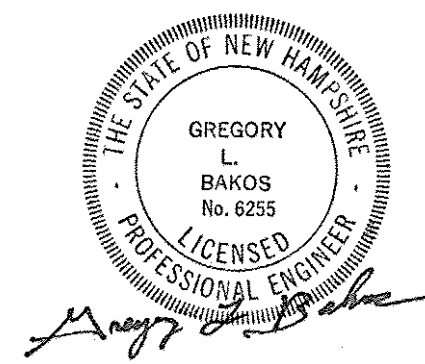

DATE PLOTTED
13-Nov-18

VHB PROJECT NO.
52393.00

ISLINGTON STREET CORRIDOR IMPROVEMENTS - SEGMENT 1				
CITY OF PORTSMOUTH, NEW HAMPSHIRE				
CROSS SECTIONS				
ISLINGTON STREET				
DRAWING	CITY PROJECT NO.	SHEET NO.	TOTAL SHEETS	
XS-Seg1	7176	59	88	

REVISIONS AFTER PROPOSAL

DESCRIPTION

STATION









STATION

DATE

NUMBER

DATE OCT 2017
DATE 11/13/18
DATE 11/13/18
DATE

SDR PROCESSED VHB
NEW DESIGN KMH
SHEET CHECKED GLB
AS BUILT DETAILS

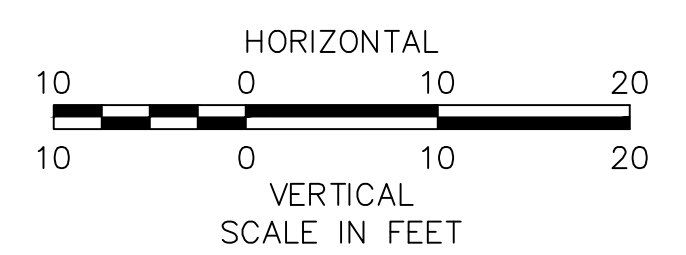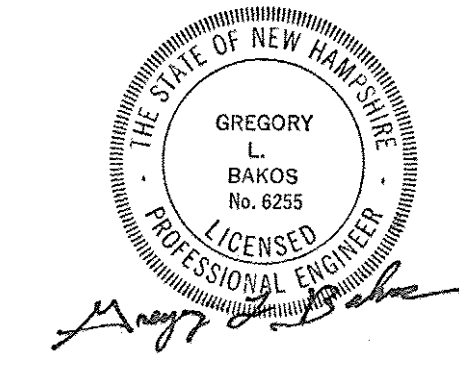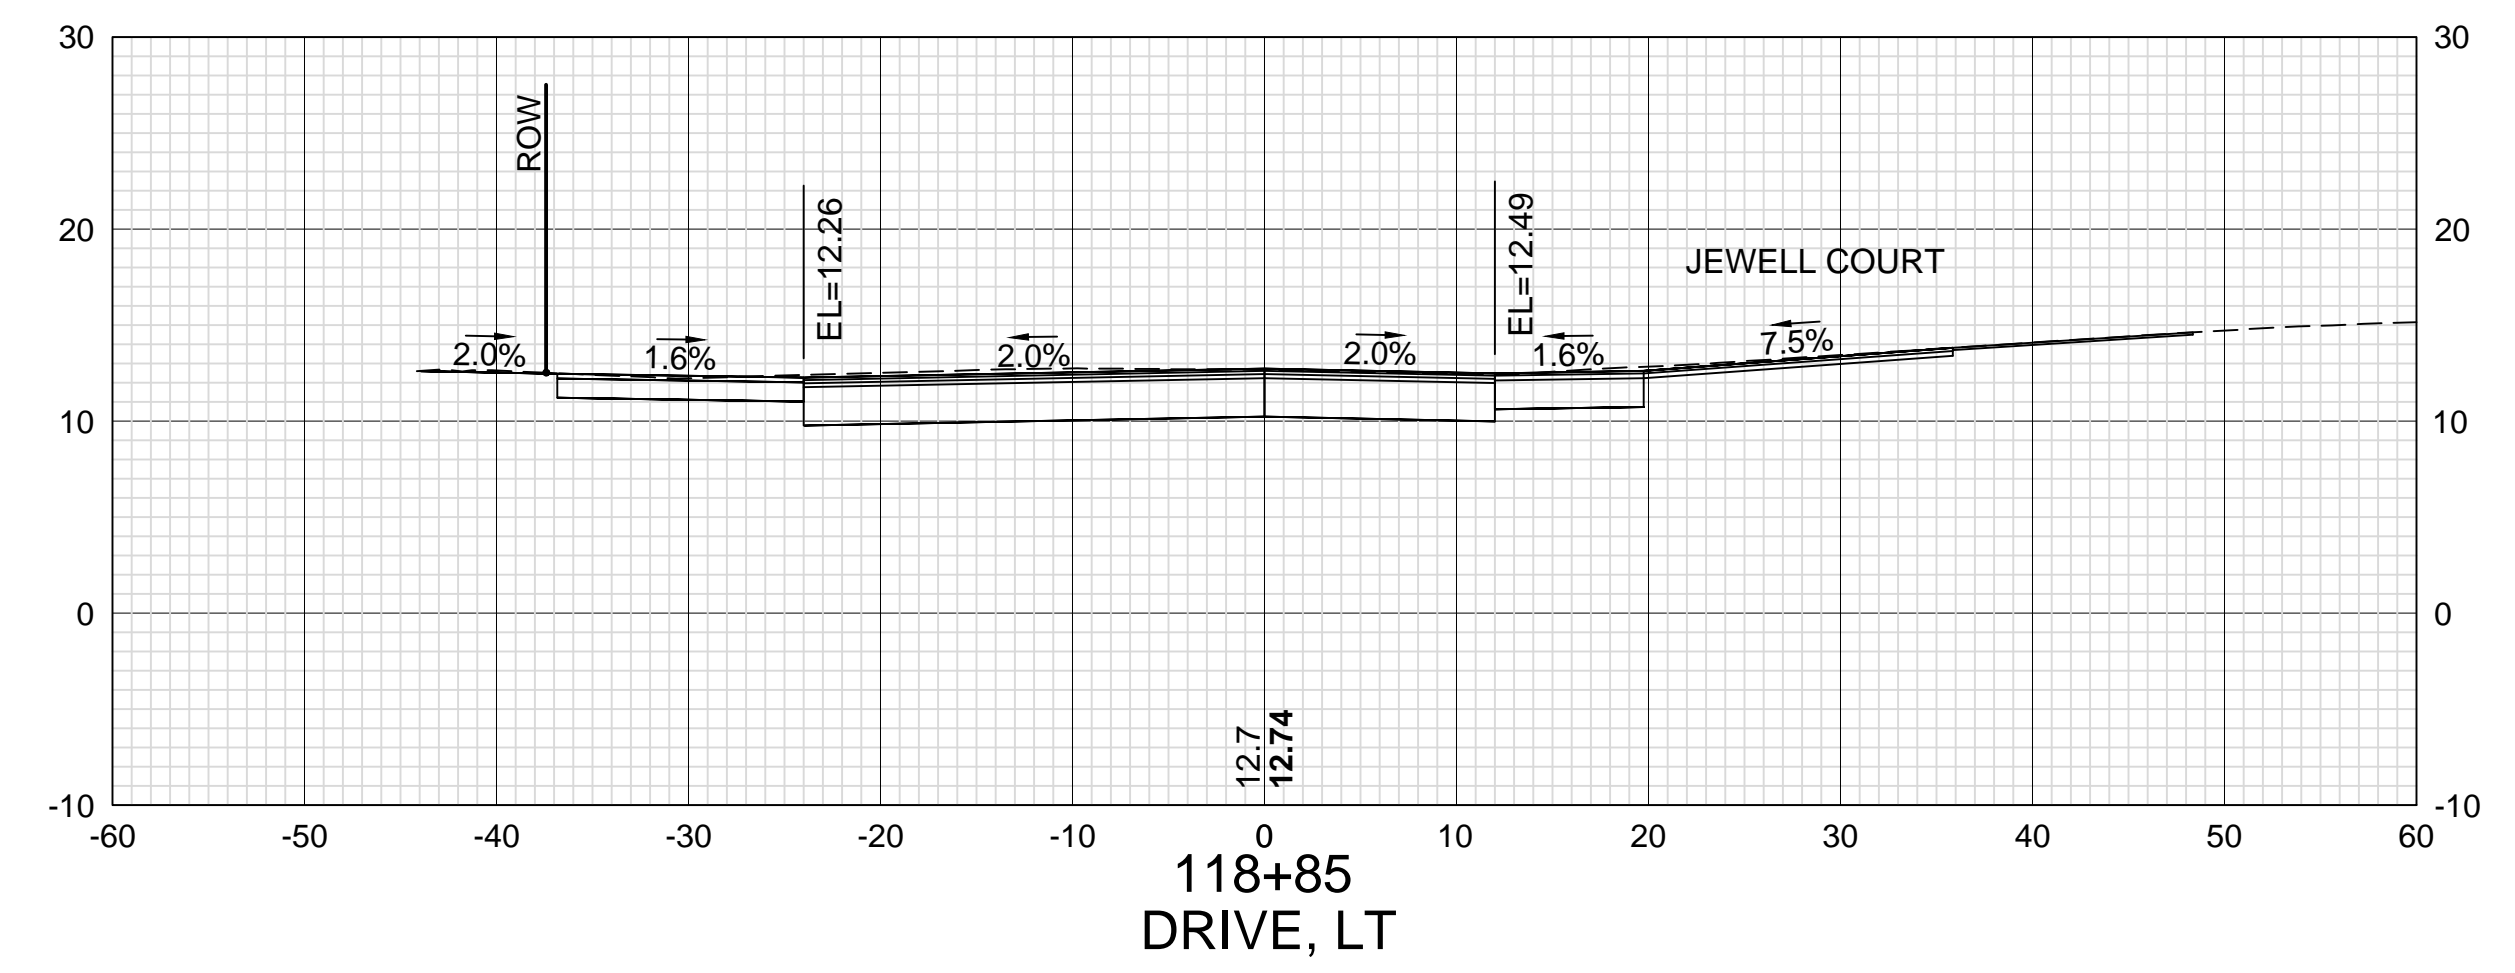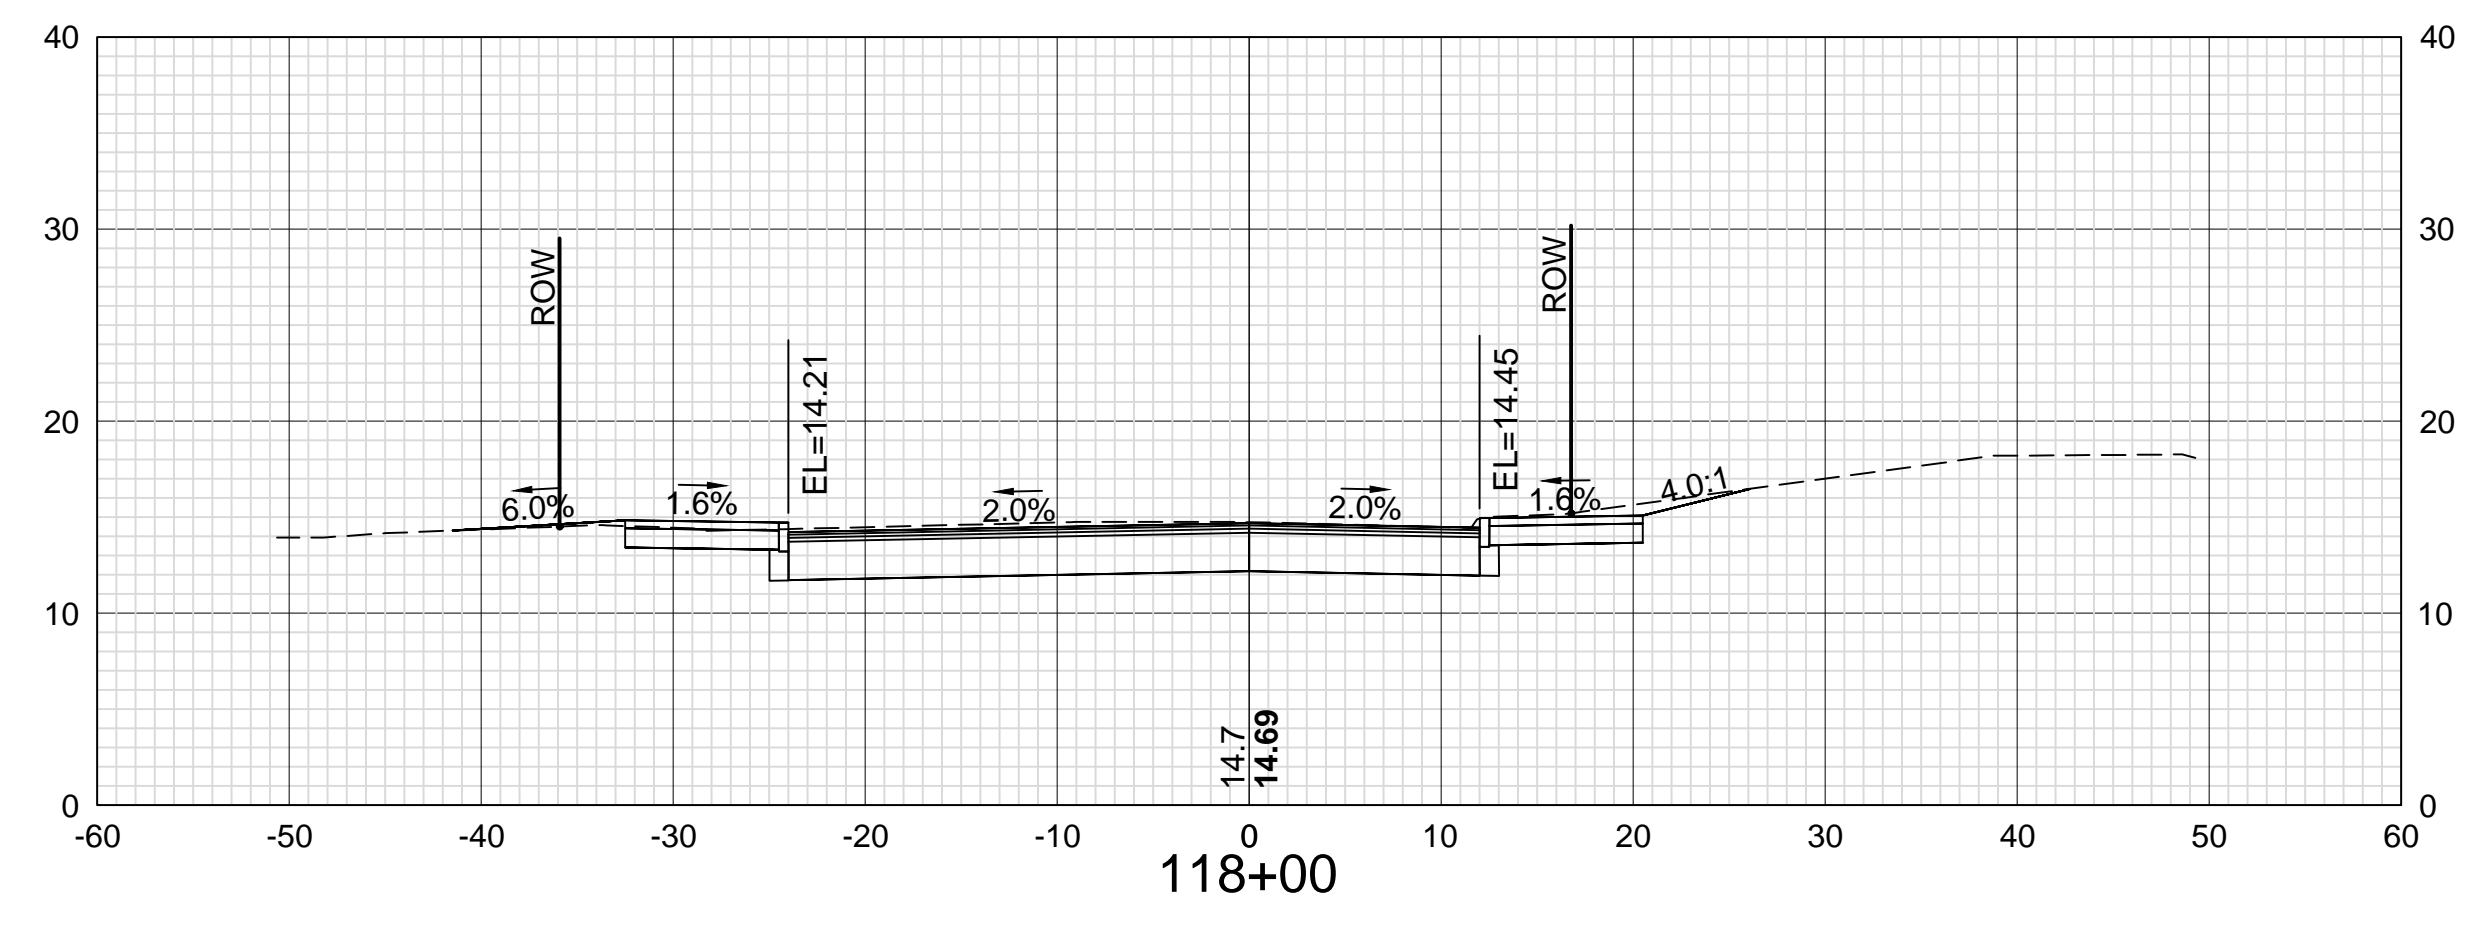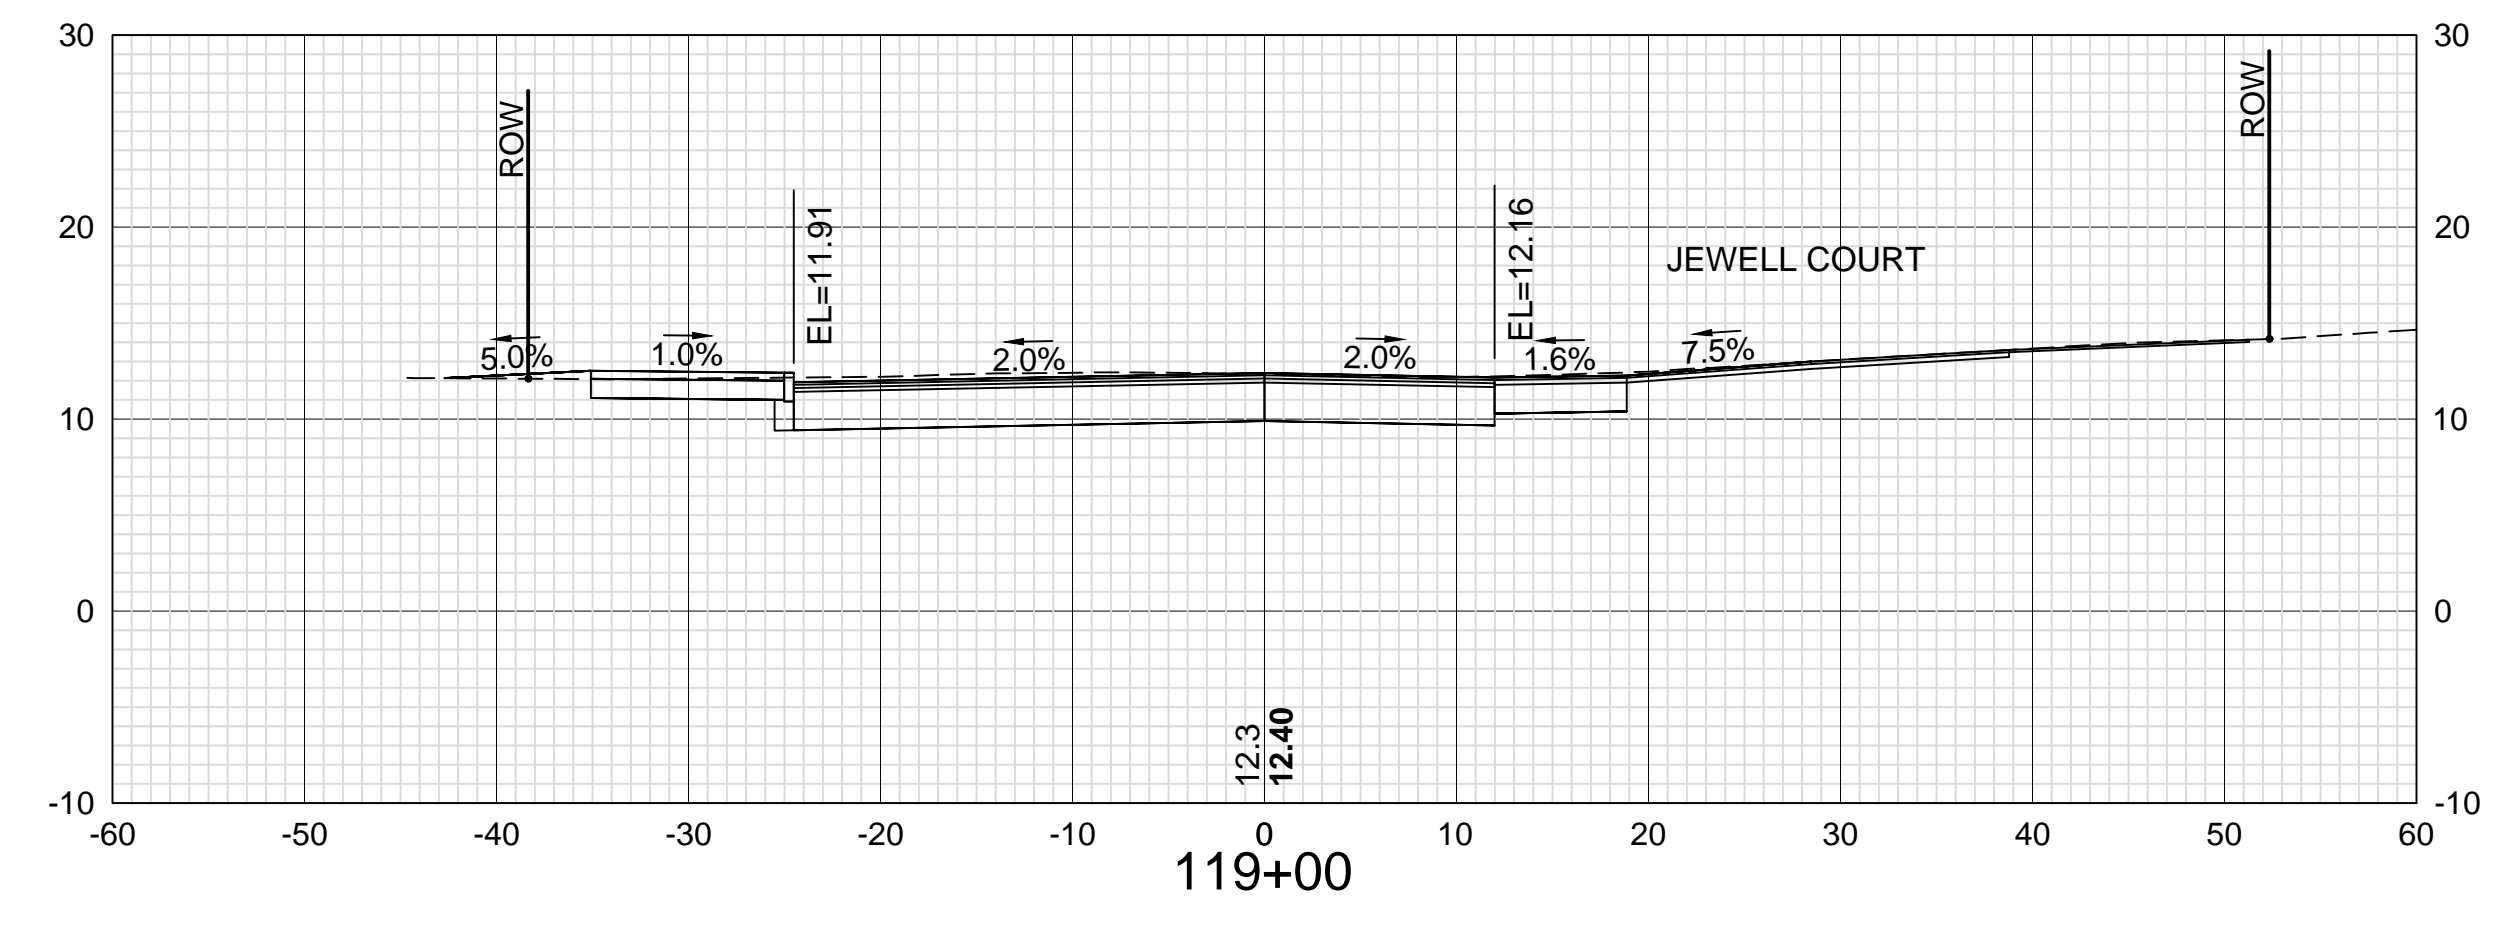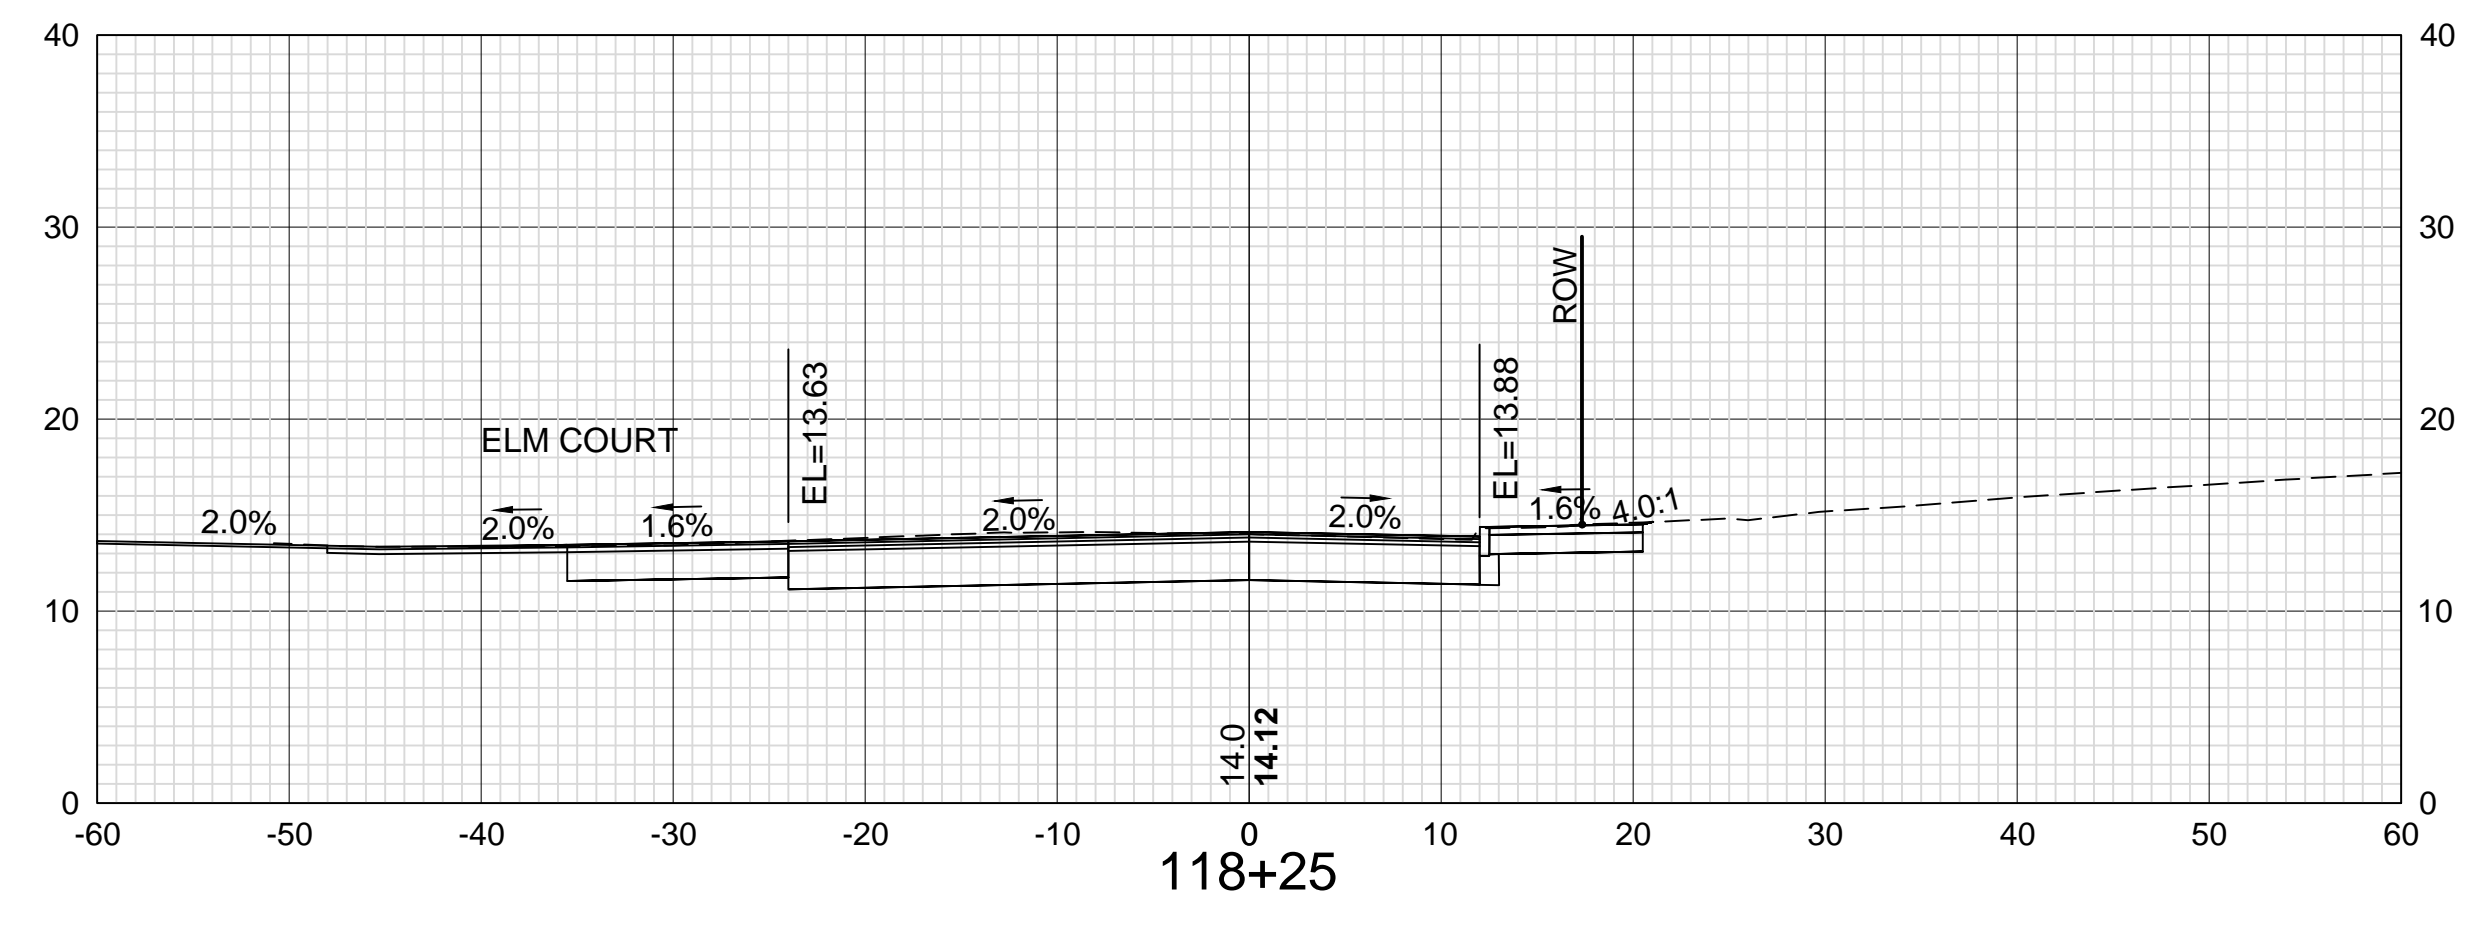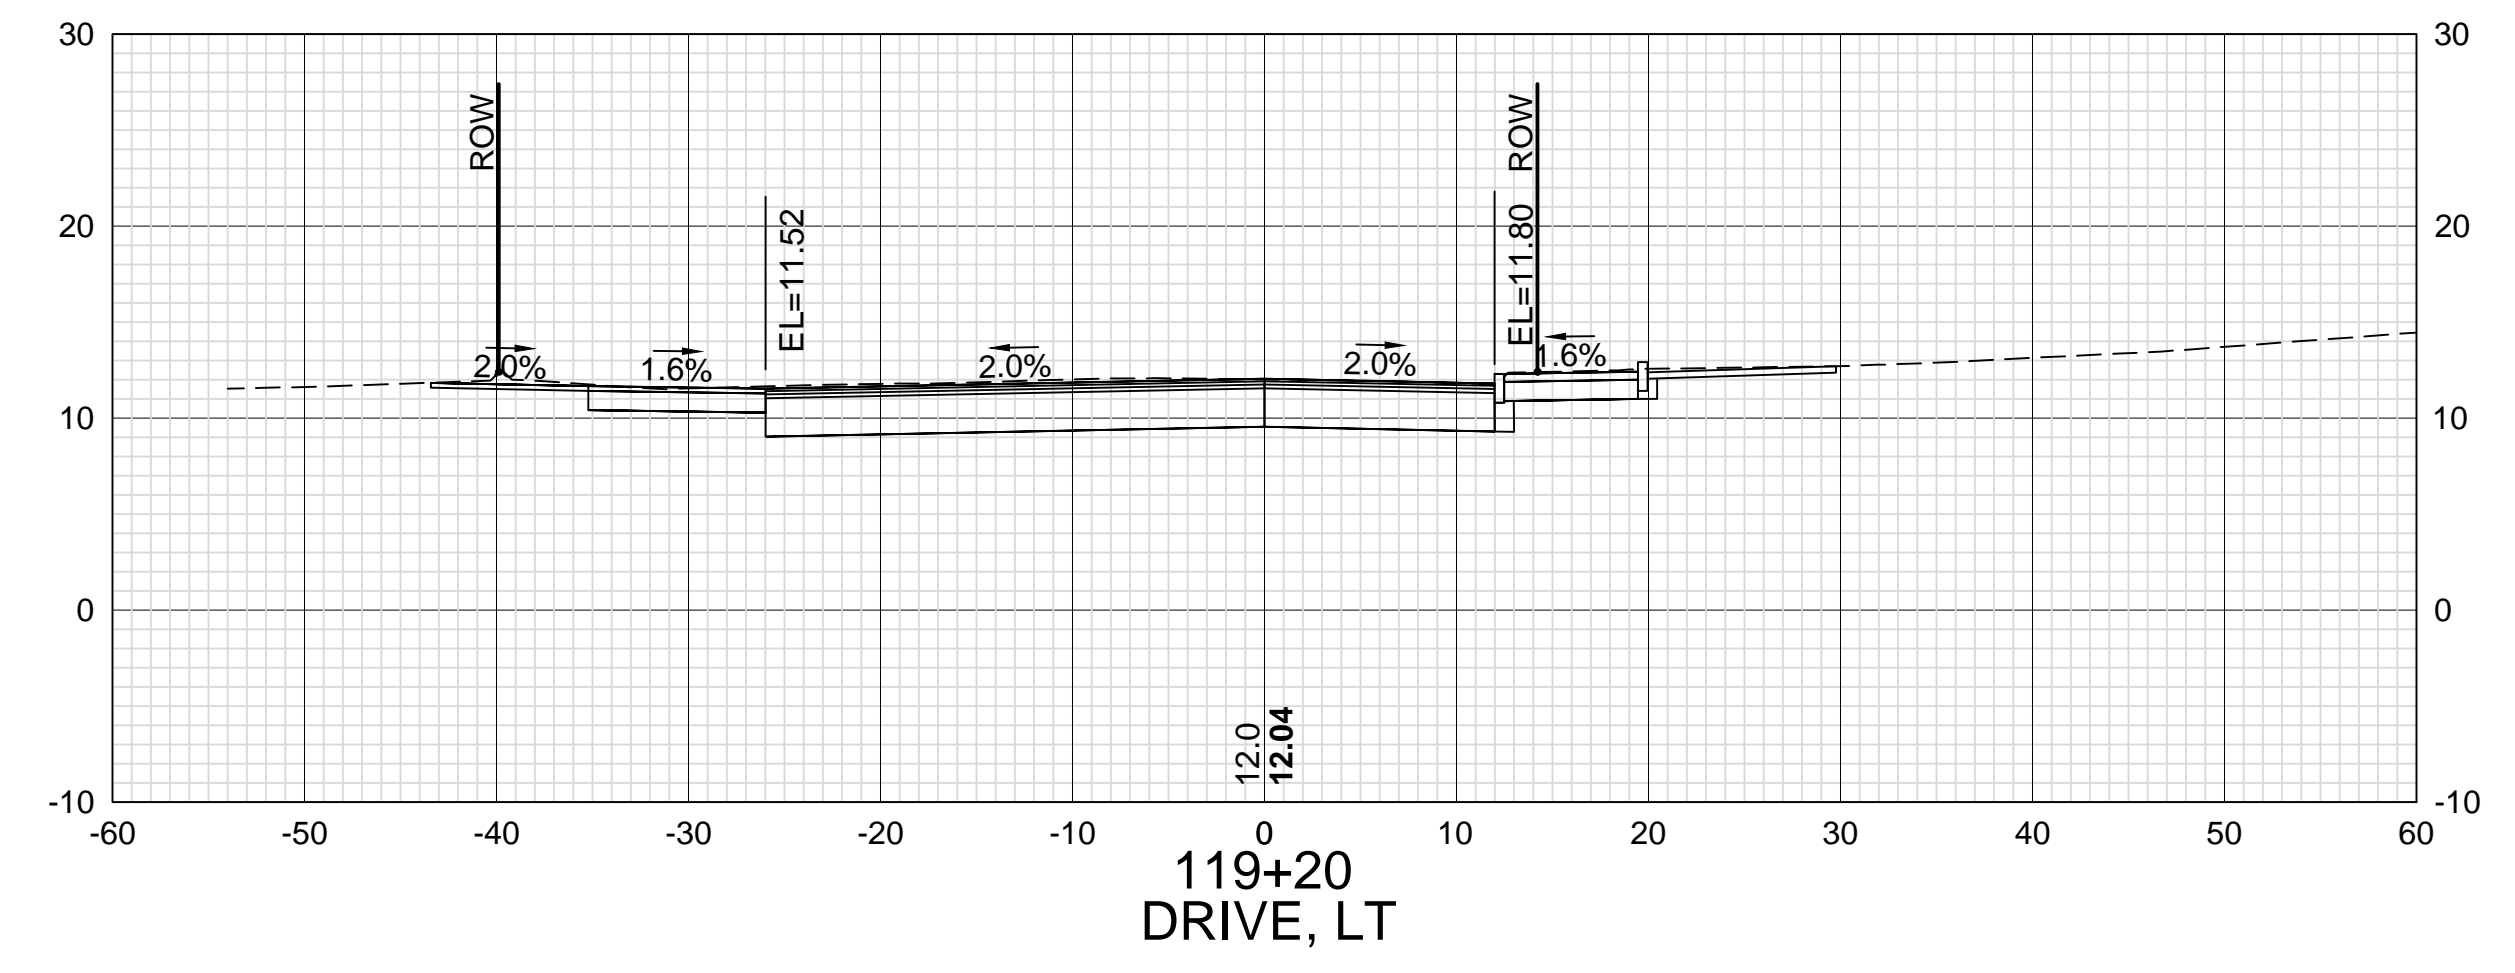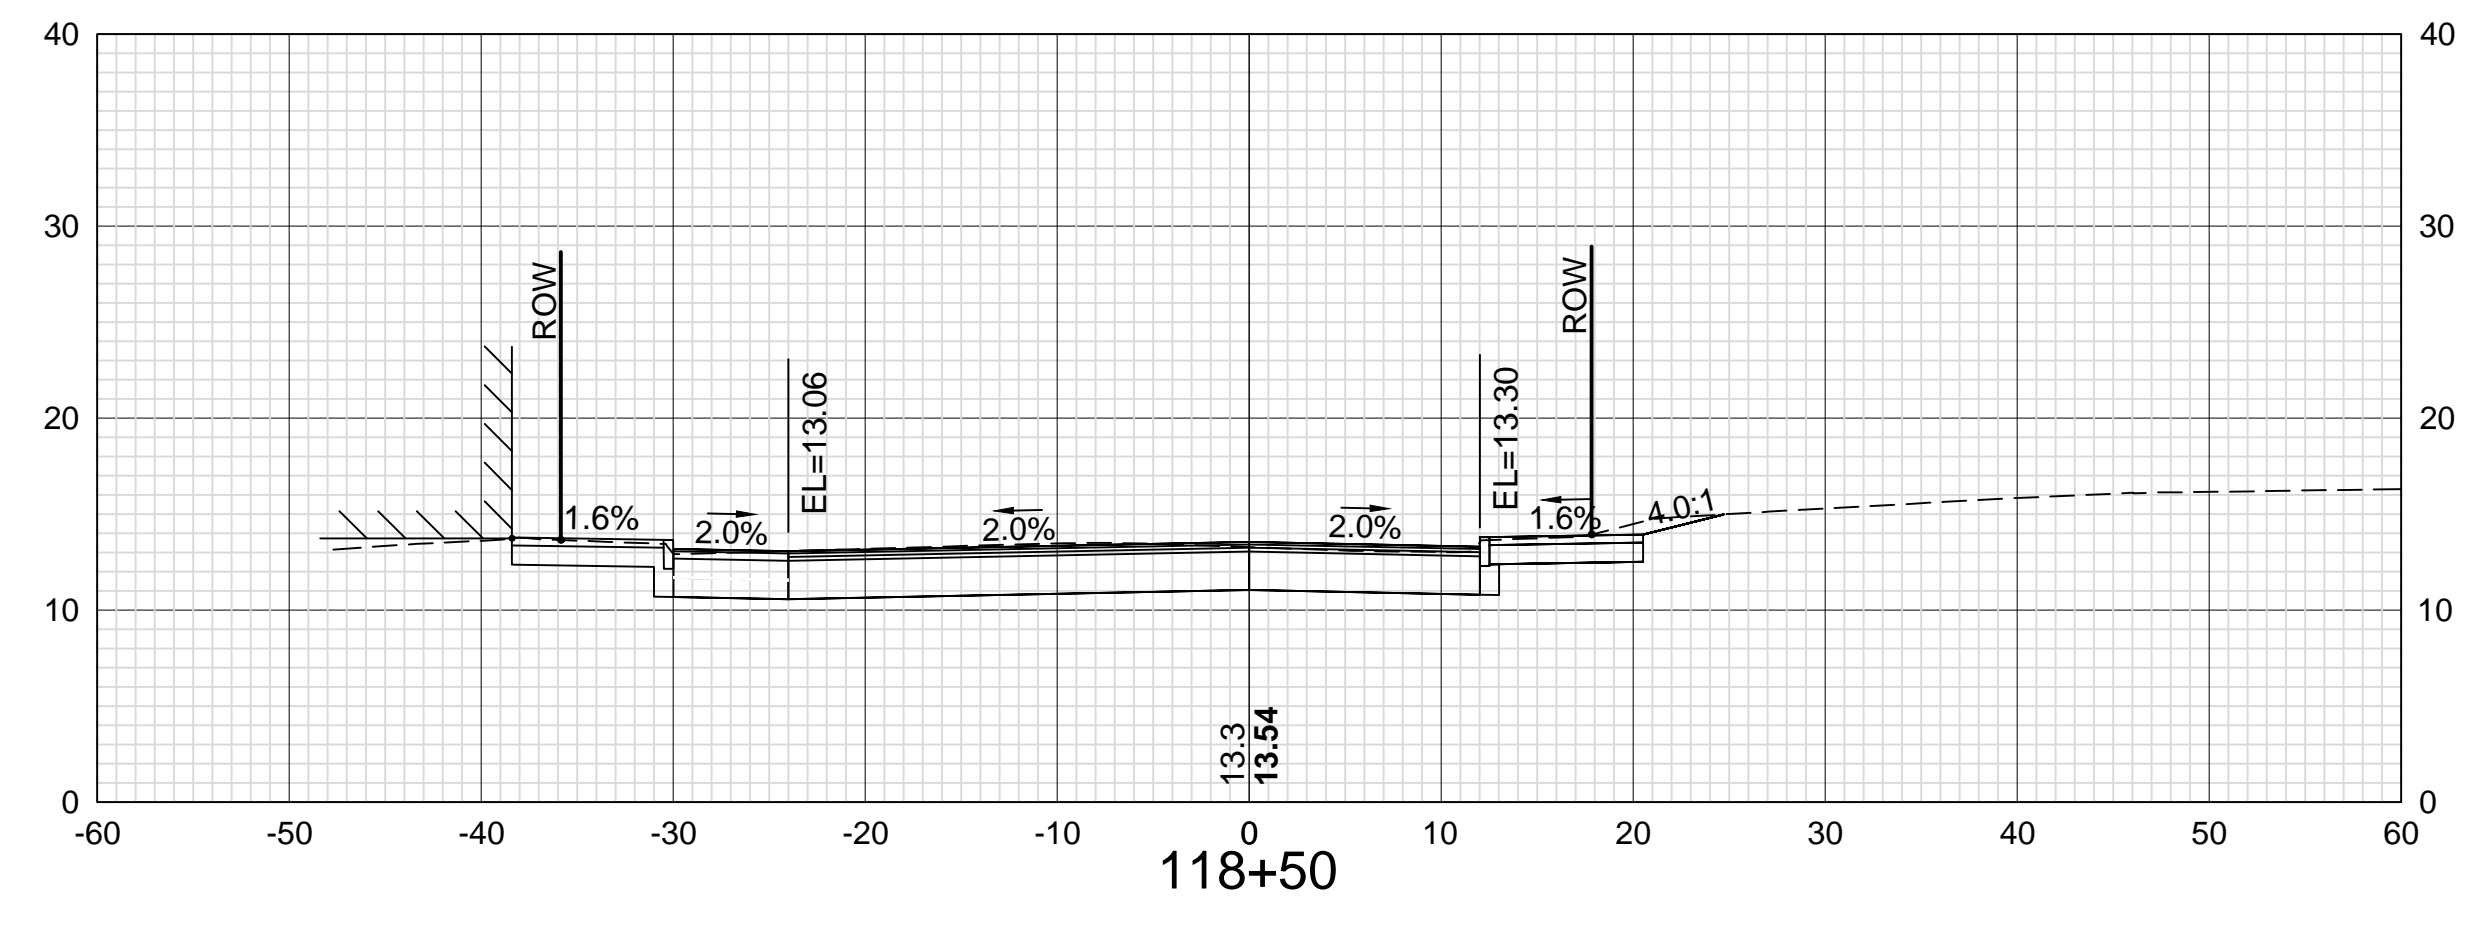

DATE PLOTTED	VHB PROJECT NO.
13-Nov-18	52393.00

ISLINGTON STREET CORRIDOR IMPROVEMENTS - SEGMENT 1			
CITY OF PORTSMOUTH, NEW HAMPSHIRE			
CROSS SECTIONS			
ISLINGTON STREET			
DRAWING	CITY PROJECT NO.	SHEET NO.	TOTAL SHEETS
XS-Seg1	7176	61	88

REVISIONS AFTER PROPOSAL

DESCRIPTION

STATION

STATION

DATE

NUMBER

DATE

SDR PROCESSED VHB
NEW DESIGN KMH
SHEET CHECKED GLB
AS BUILT DETAILS










STATION

DATE

NUMBER

DATE

DATE

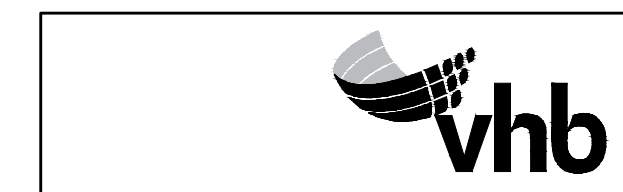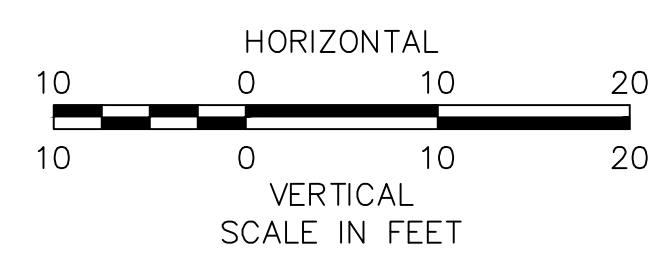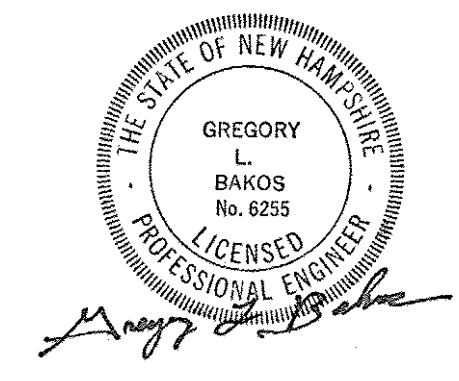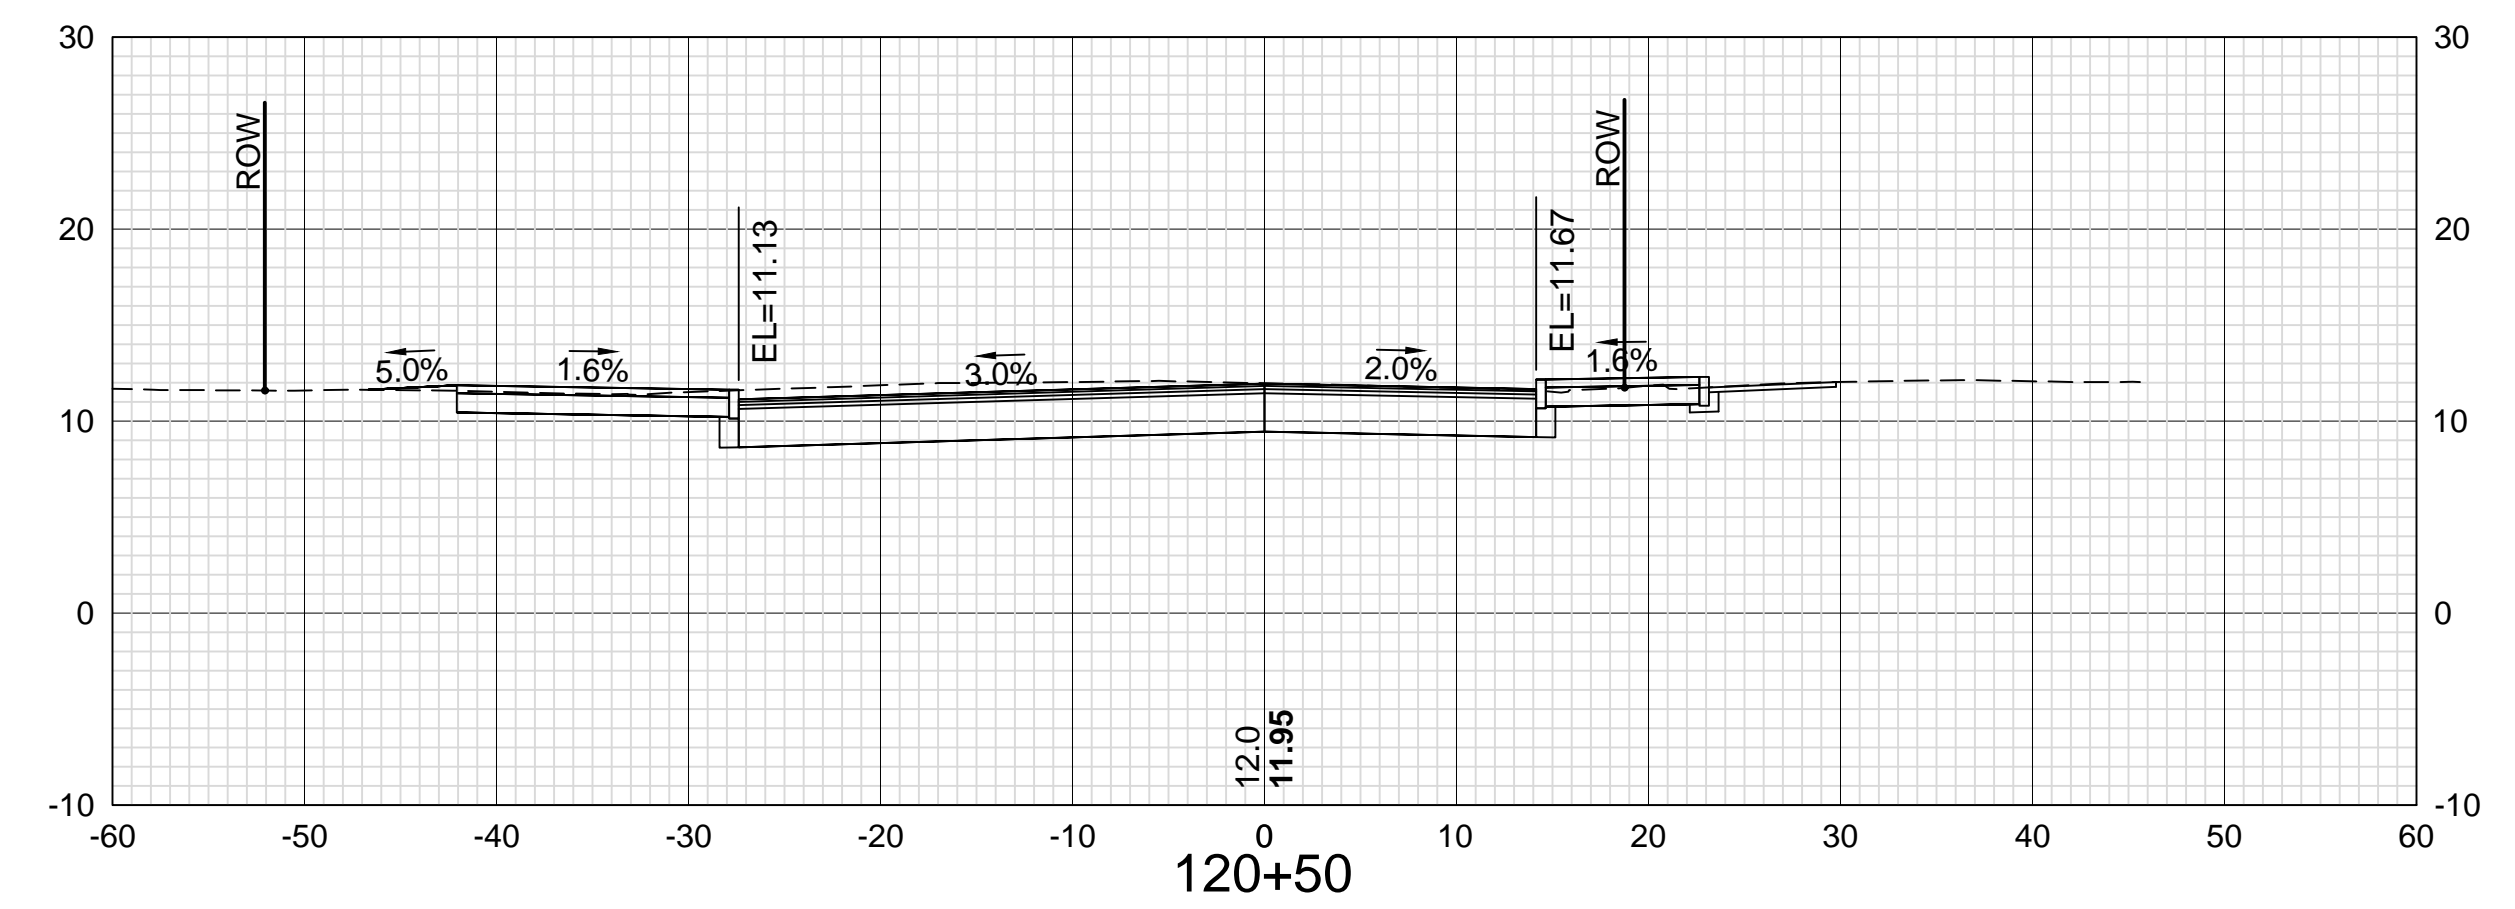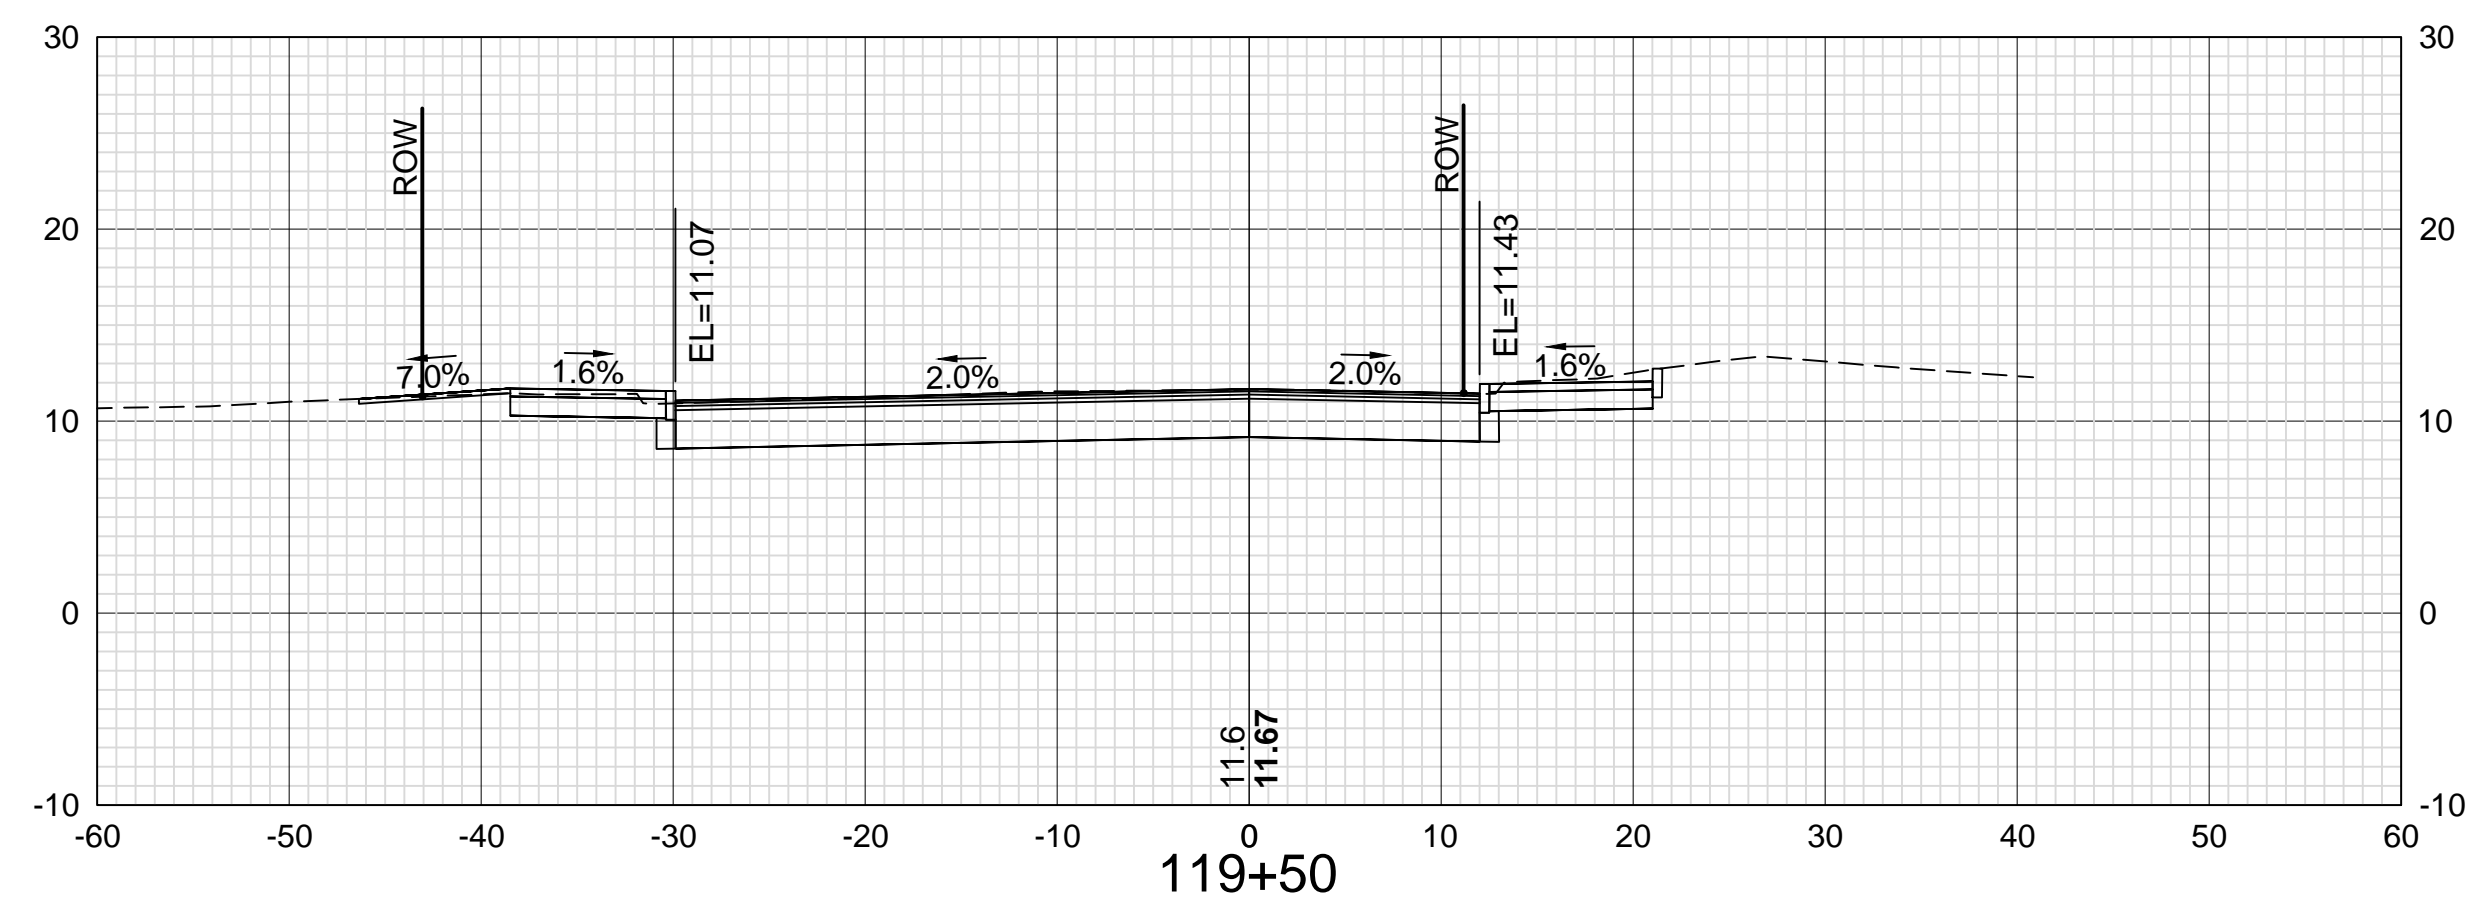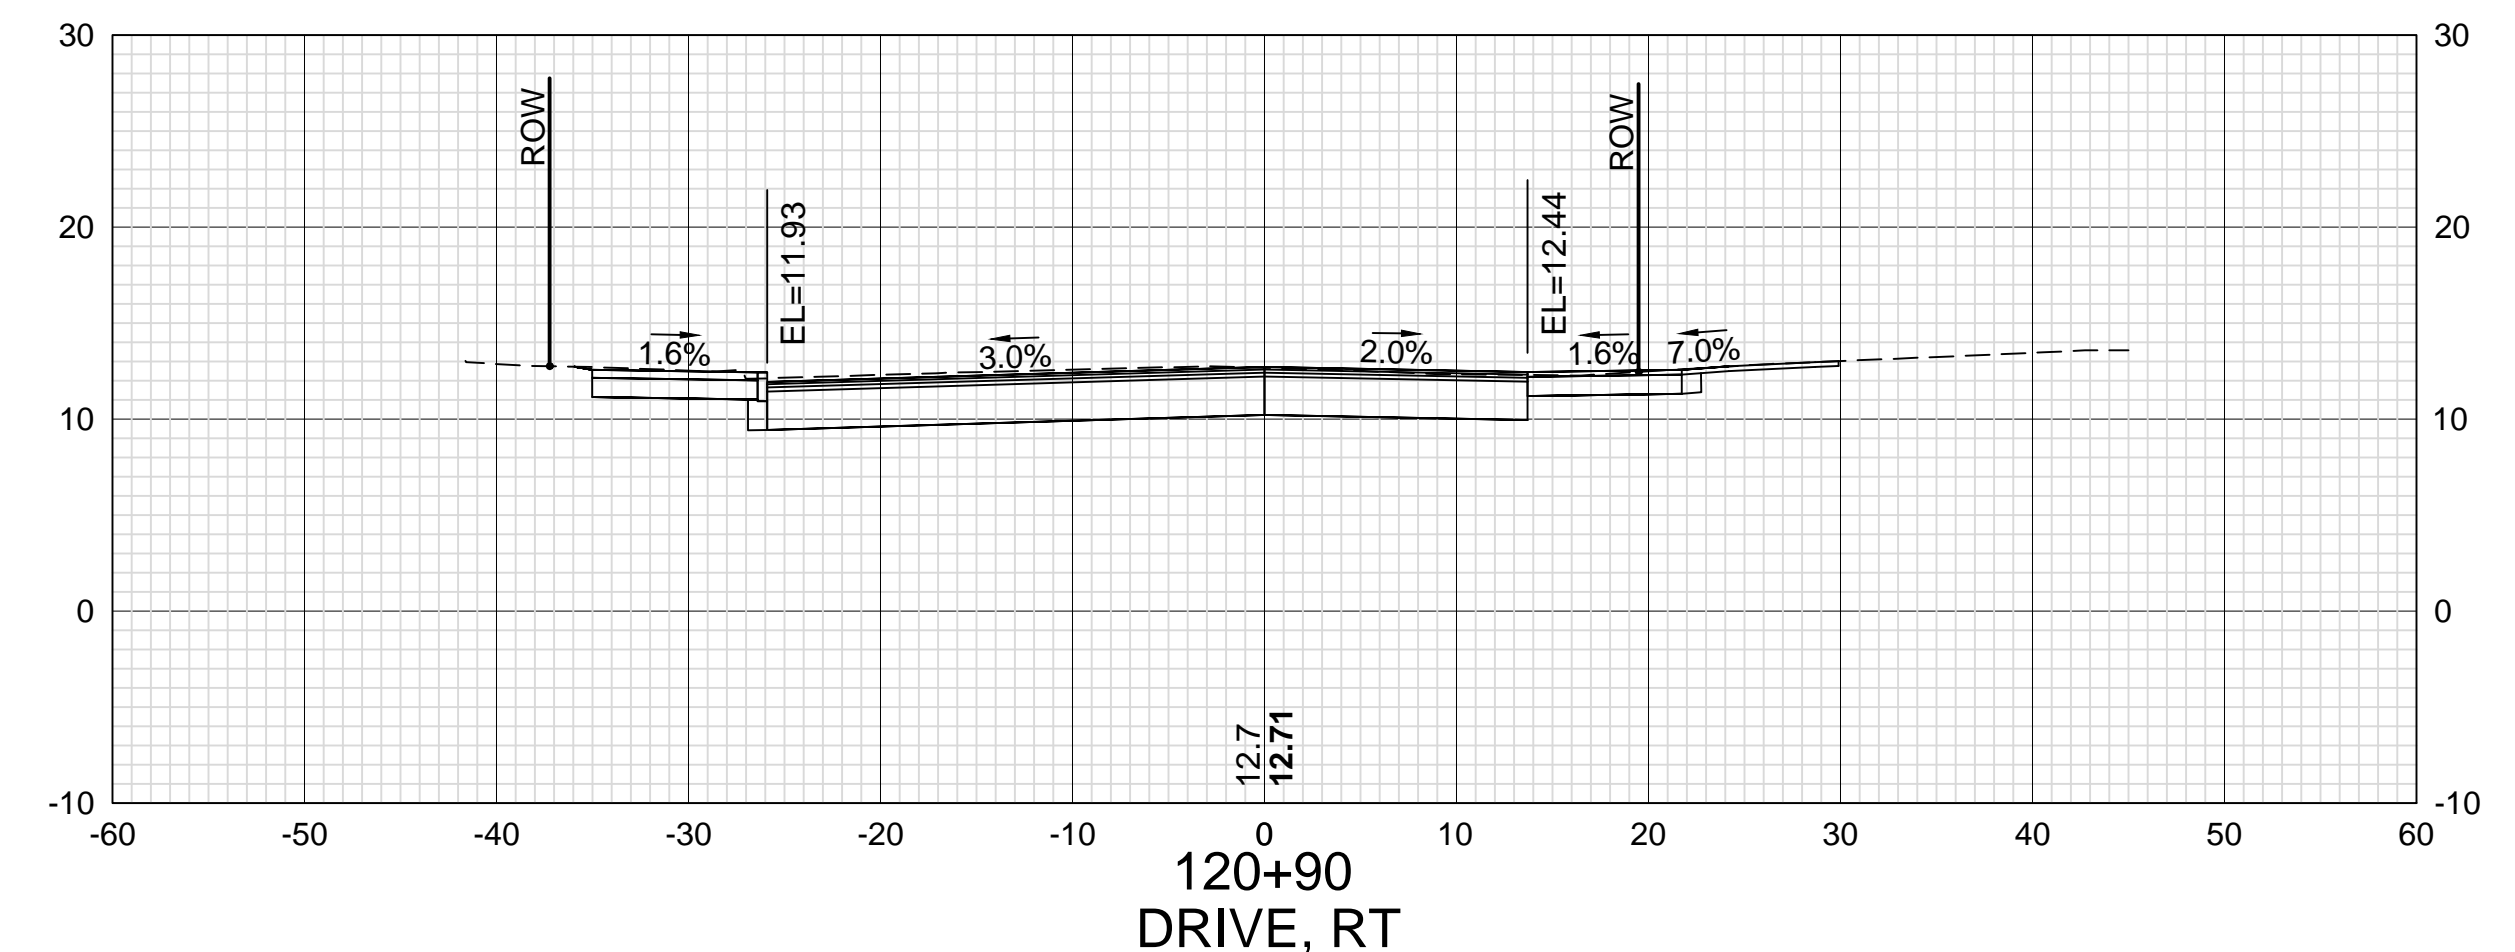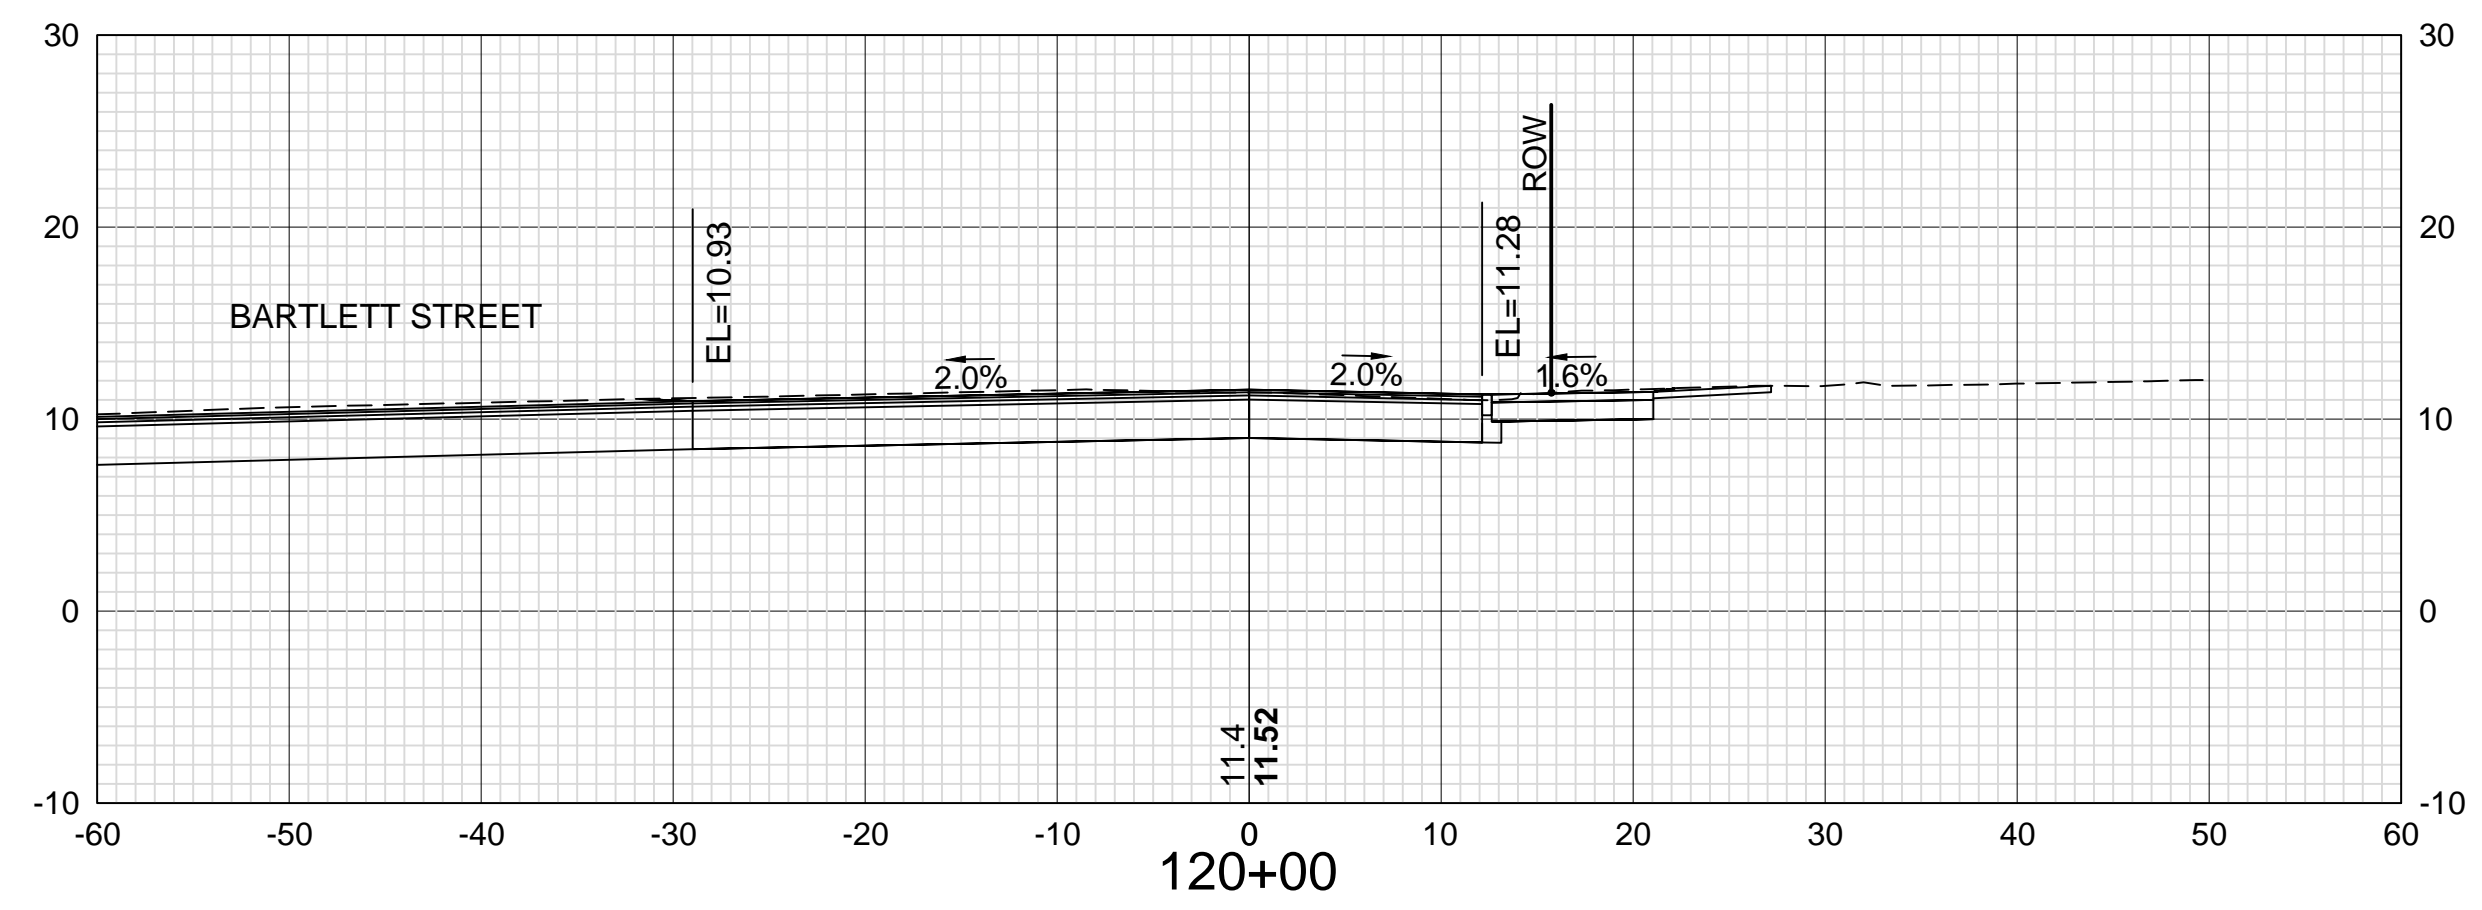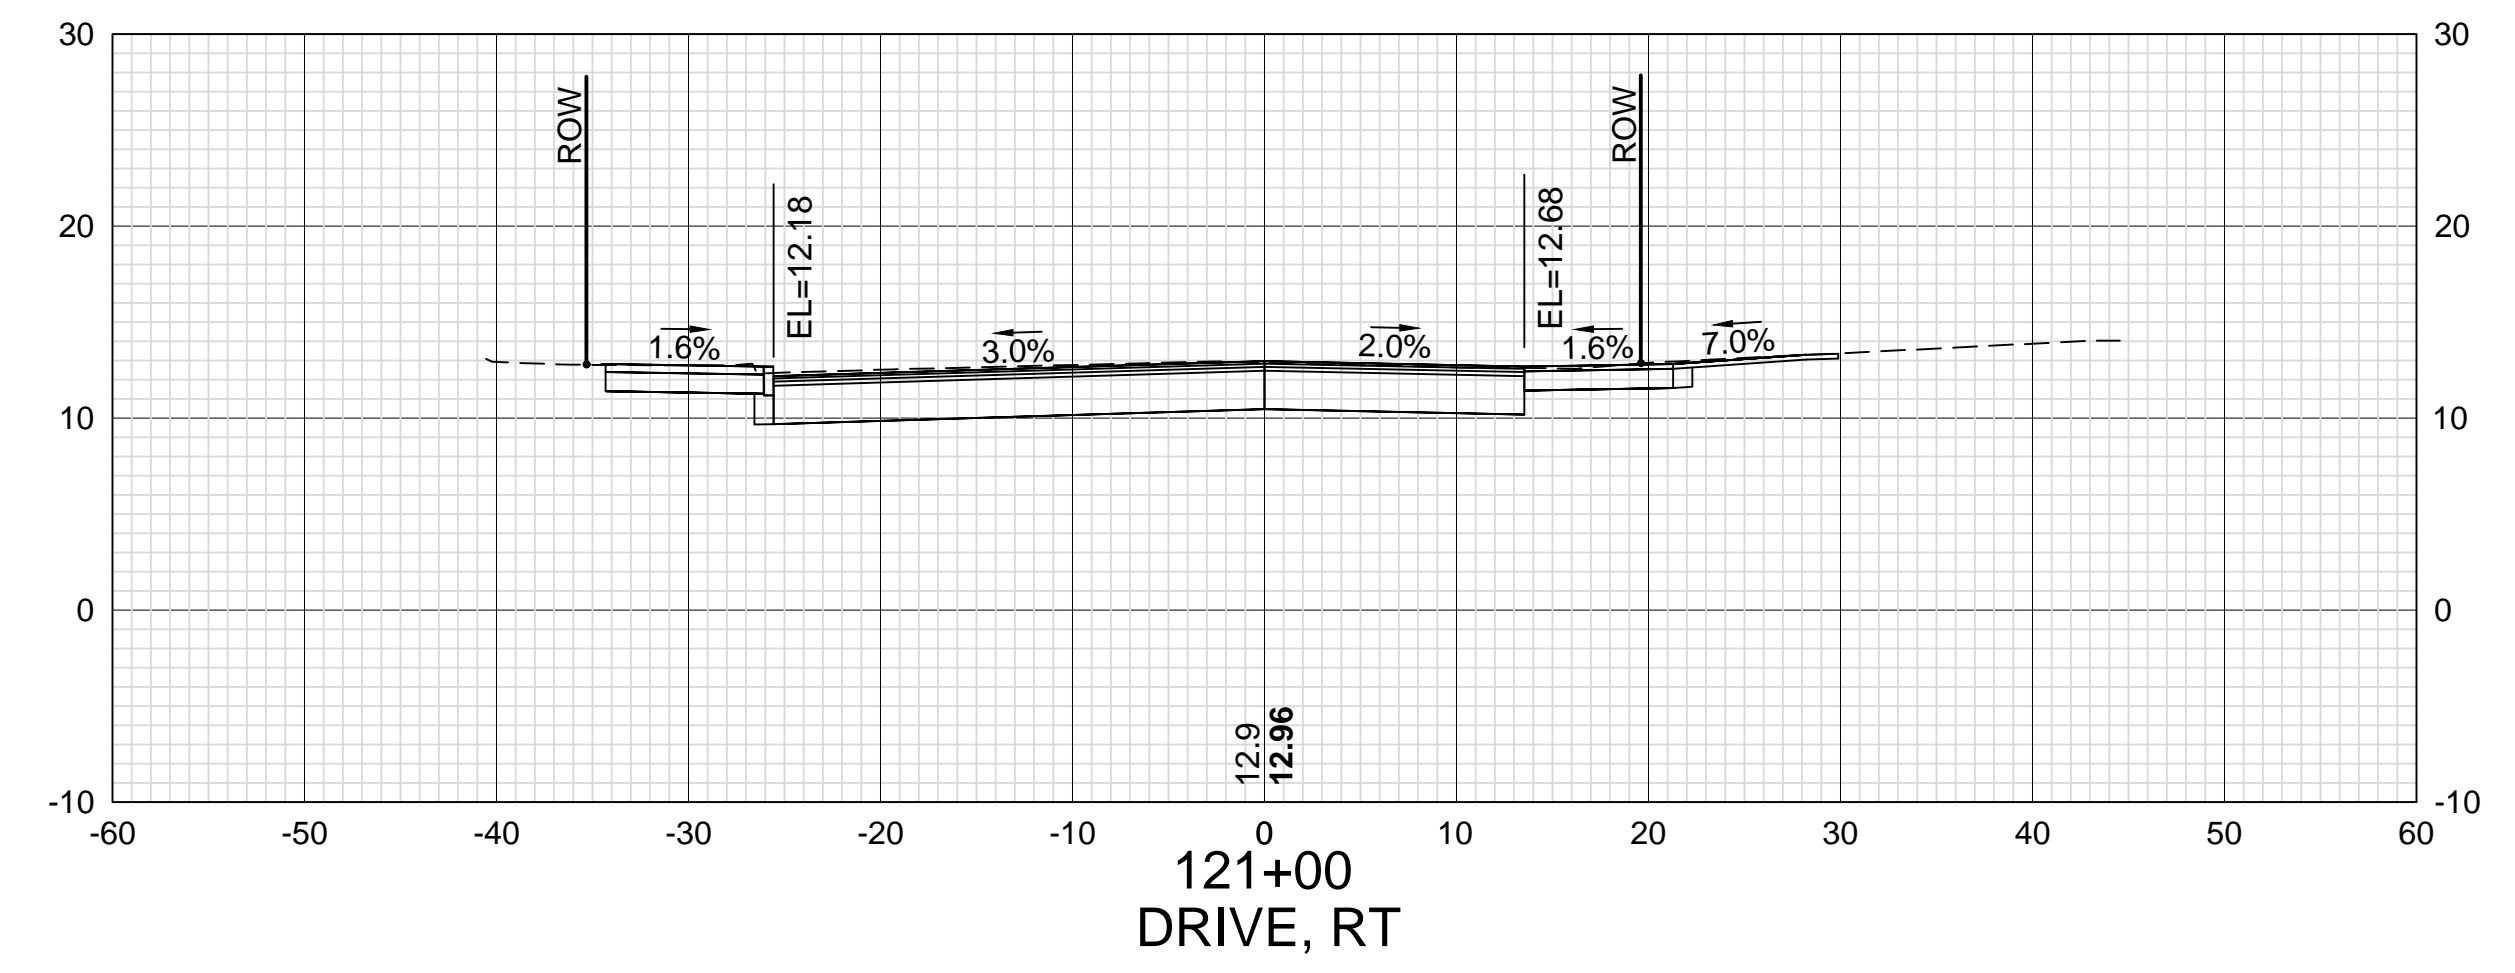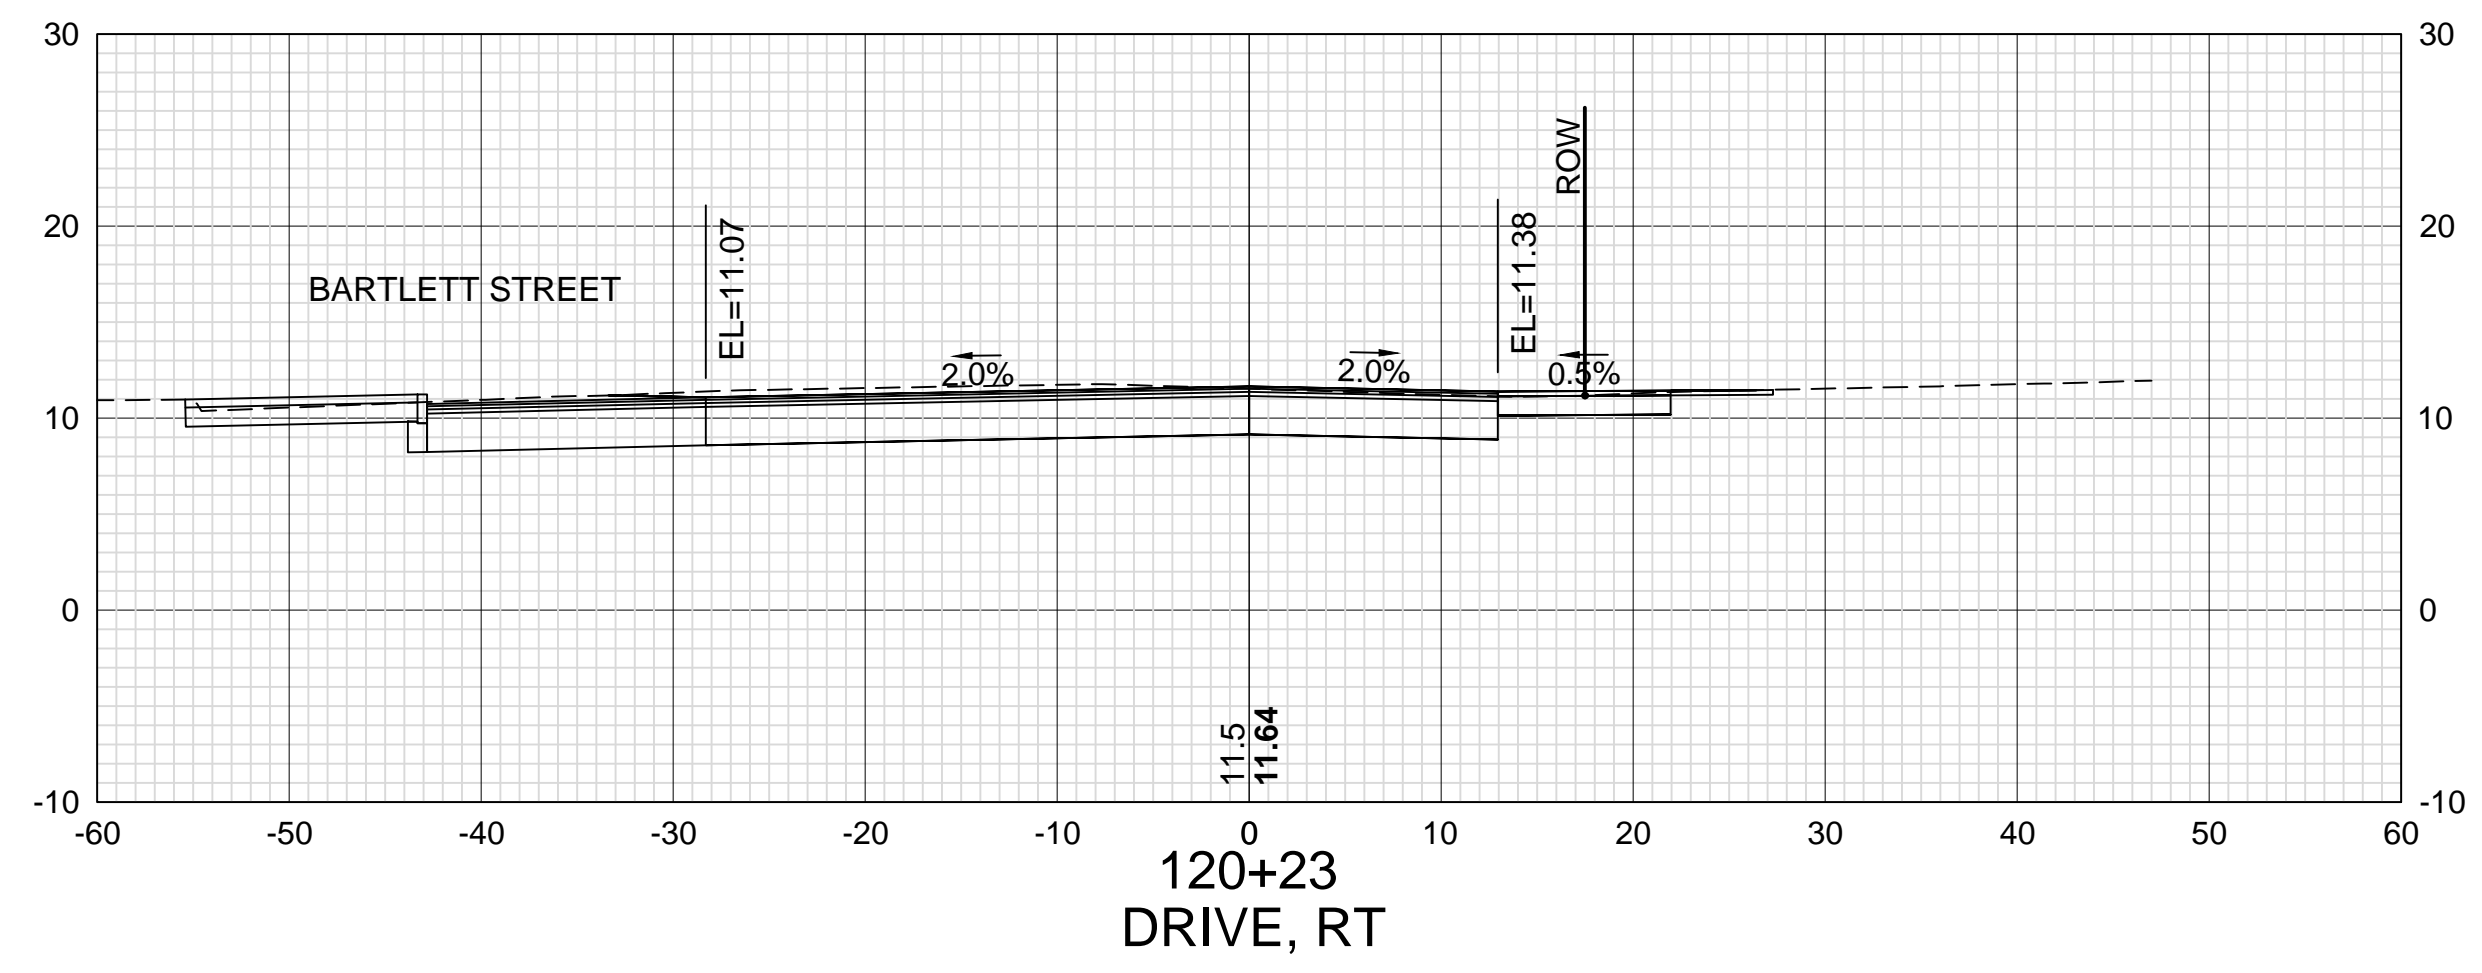

DATE PLOTTED
13-Nov-18

VHB PROJECT NO.
52393.00

DRAWING
XS-Seg1

CITY PROJECT NO.
7176

SHEET NO.
62









TOTAL SHEETS
88

ISLINGTON STREET CORRIDOR IMPROVEMENTS - SEGMENT 1
CITY OF PORTSMOUTH, NEW HAMPSHIRE

CROSS SECTIONS
ISLINGTON STREET

REVISIONS AFTER PROPOSAL	STATION	STATION	DATE	NUMBER

SDR PROCESSED	VHB	DATE	OCT 2017
NEW DESIGN	KMH	DATE	11/13/18
SHEET CHECKED	GLB	DATE	11/13/18
AS BUILT DETAILS		DATE	

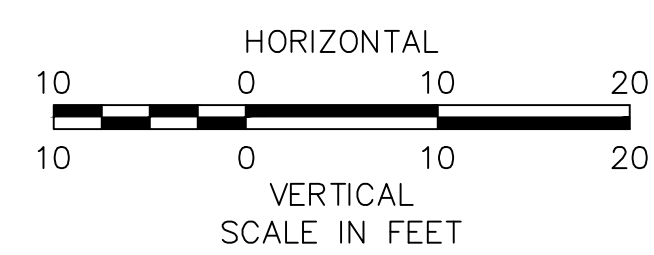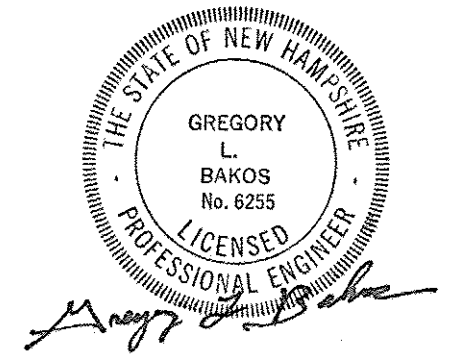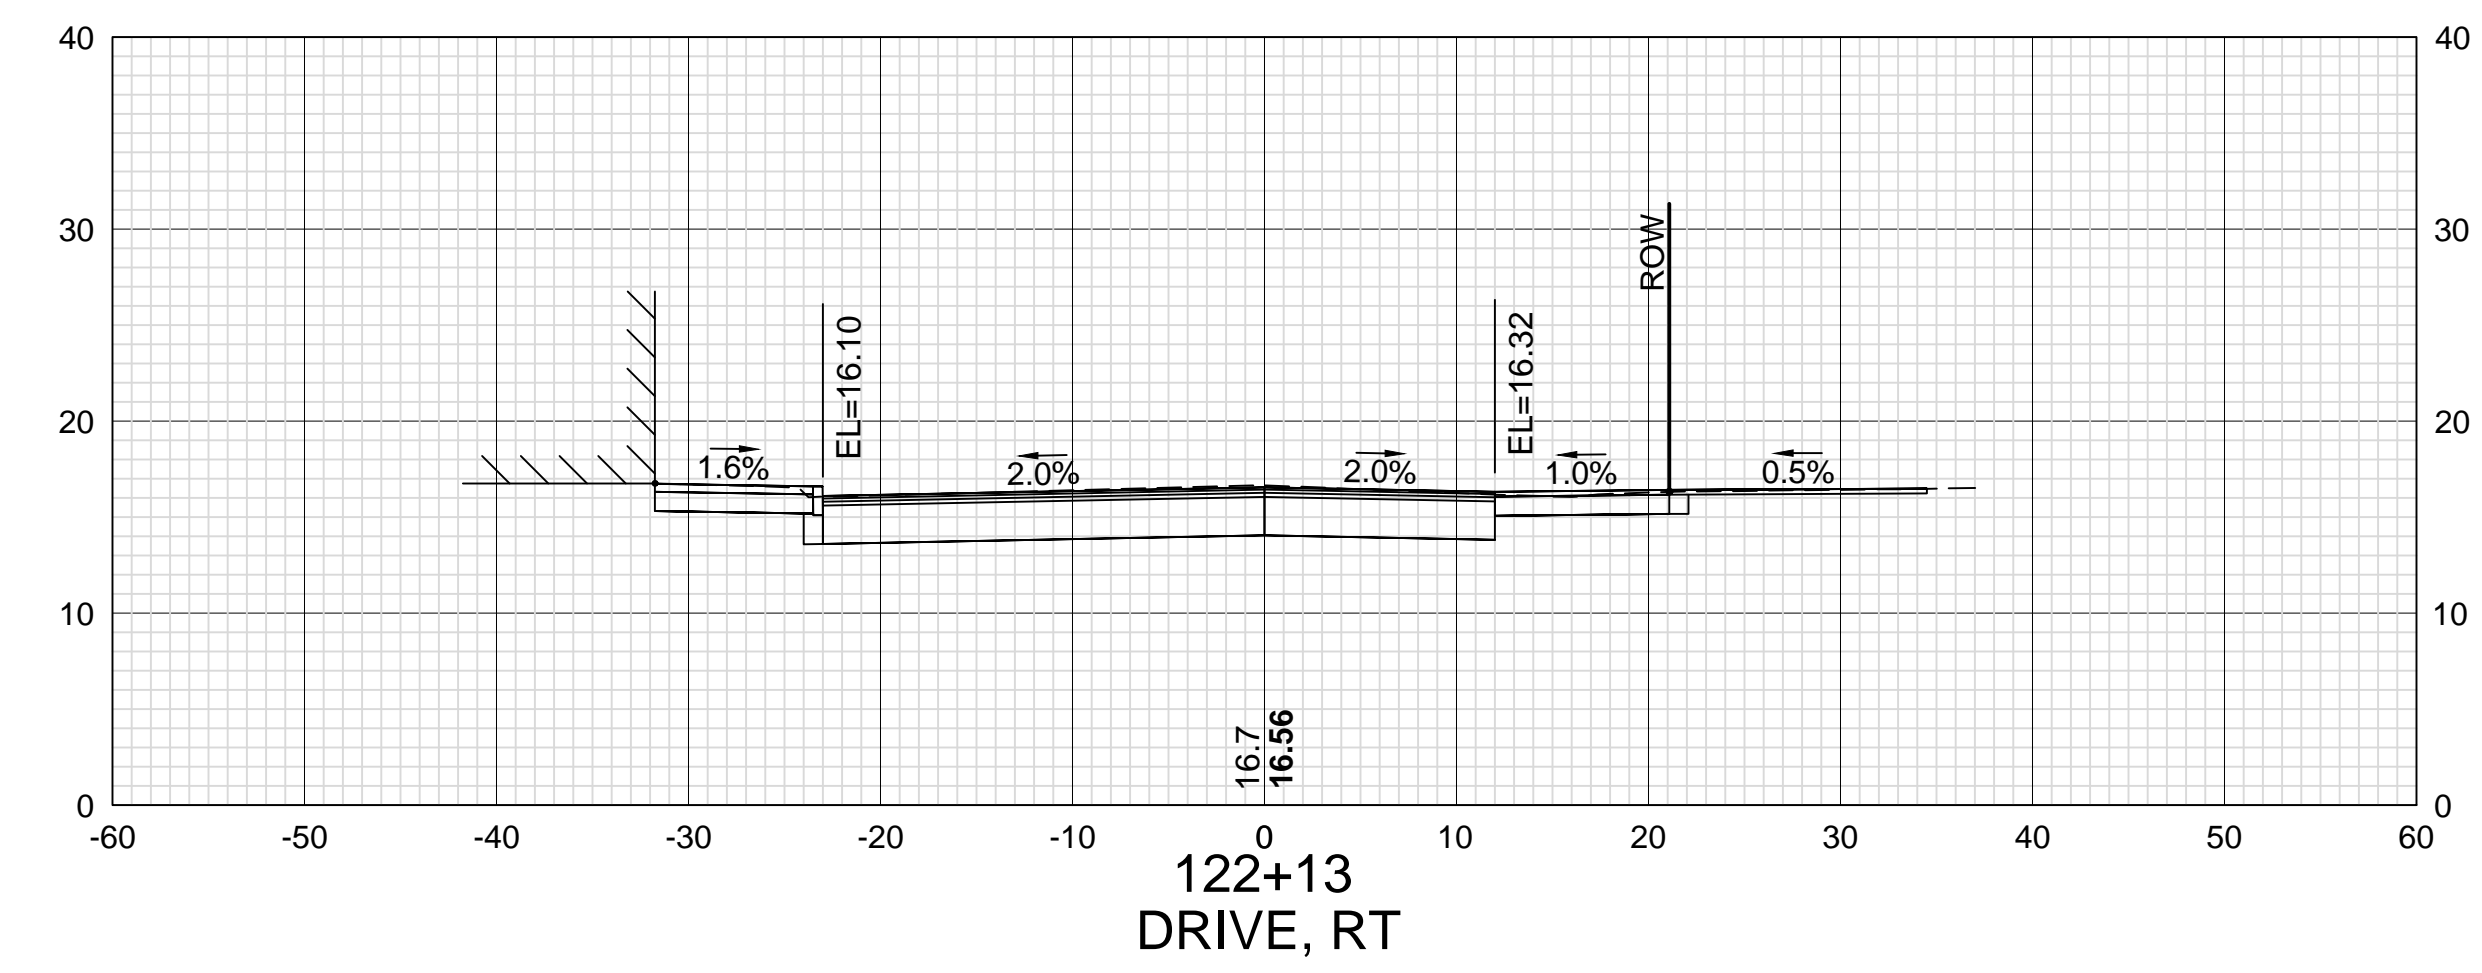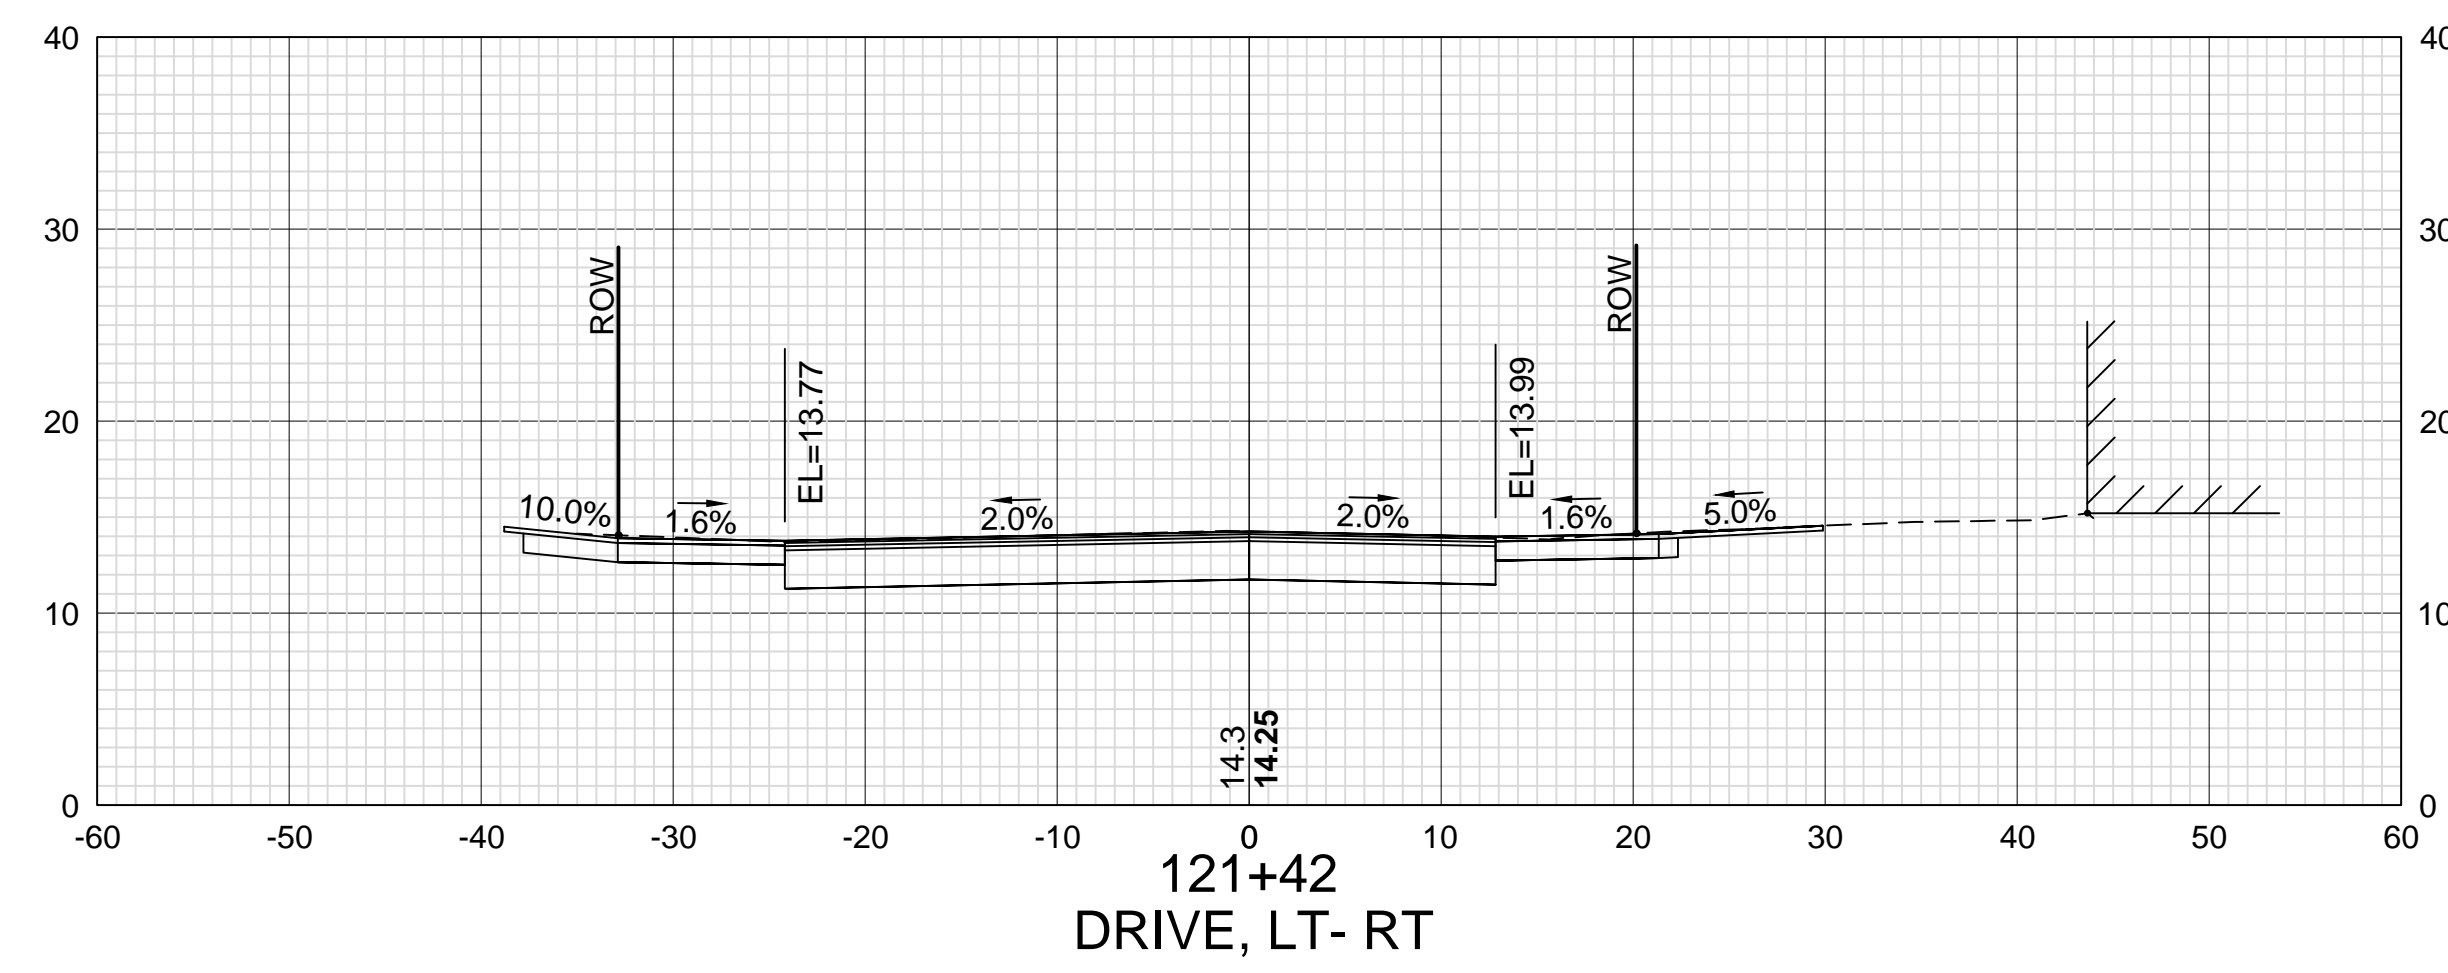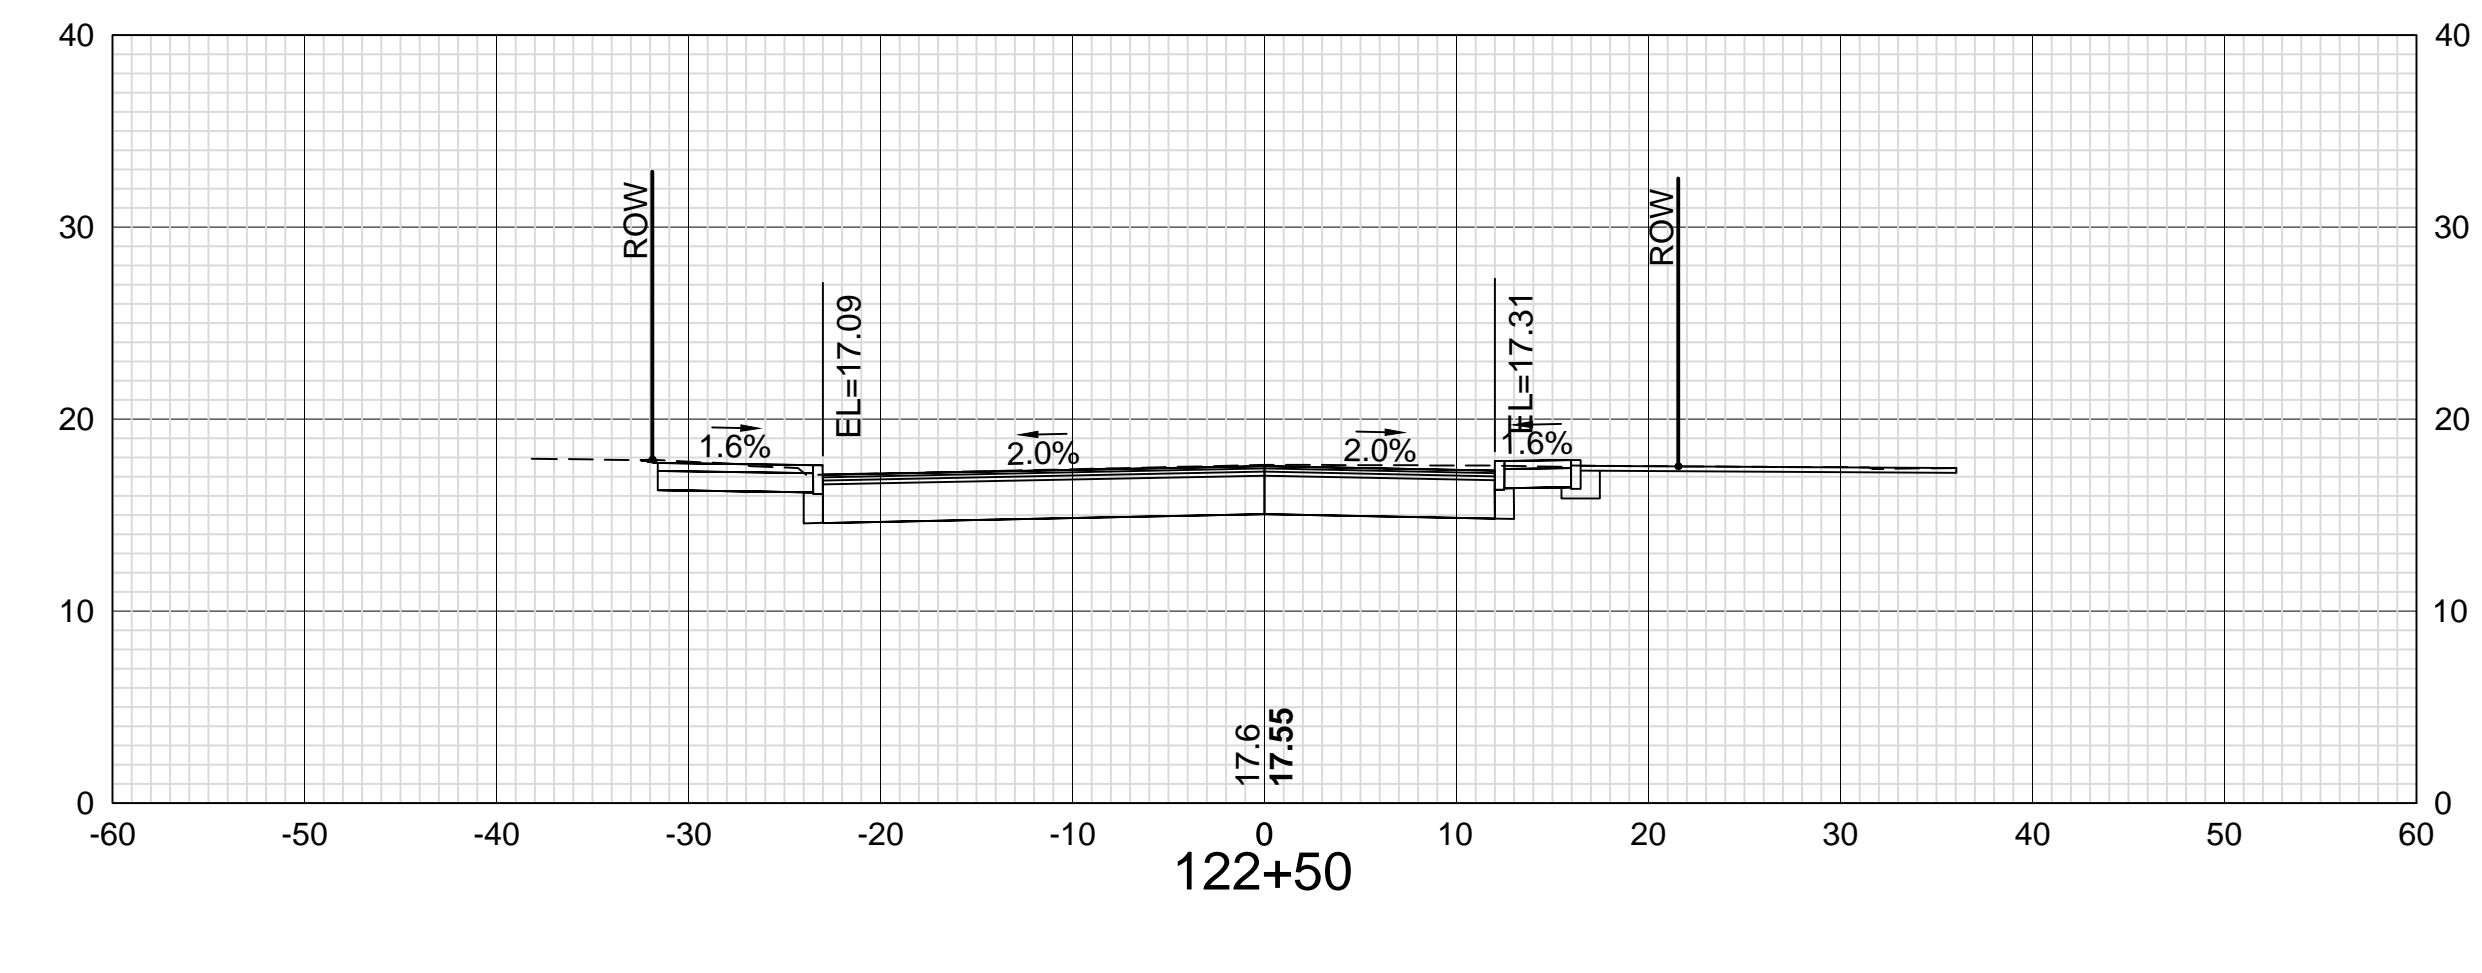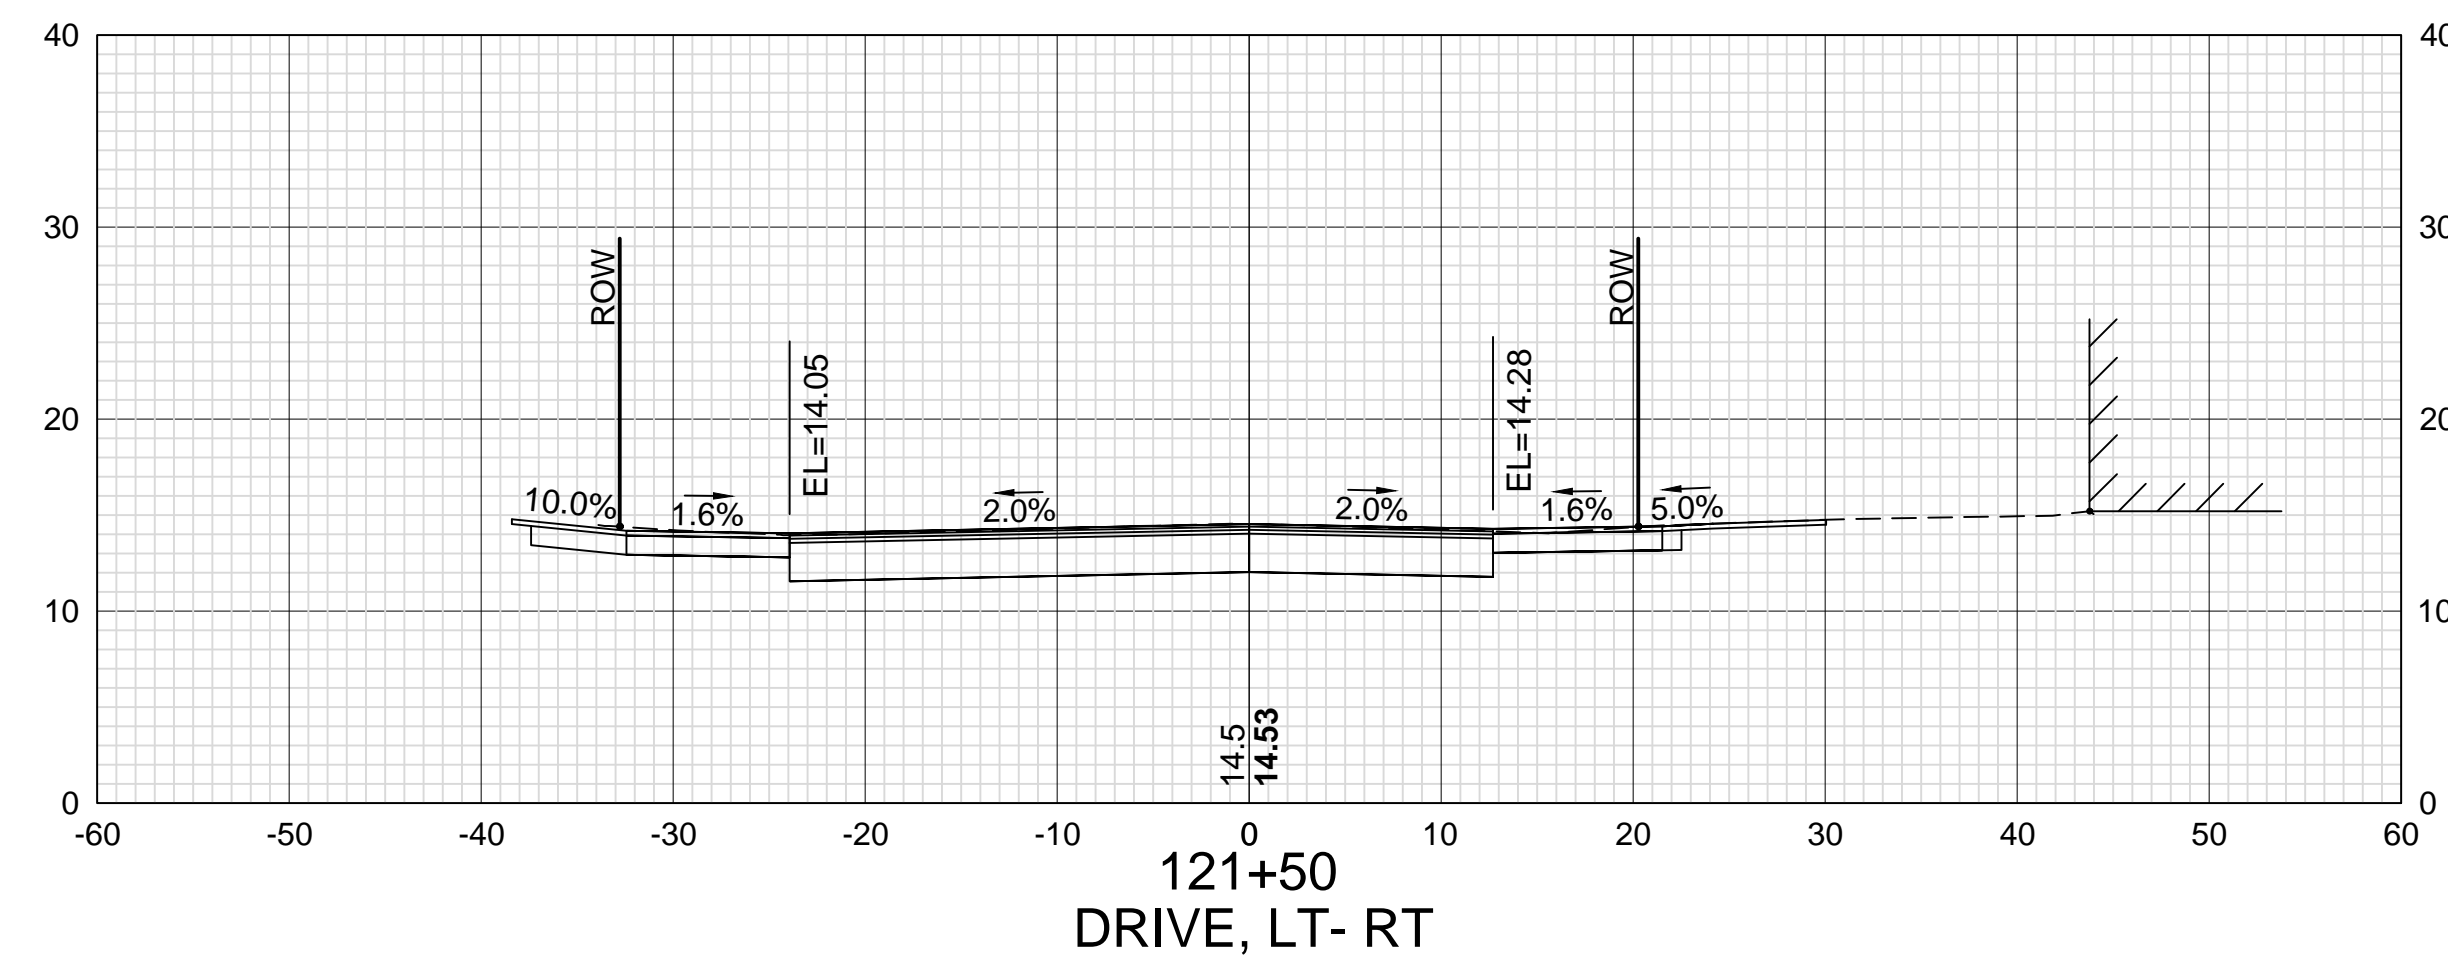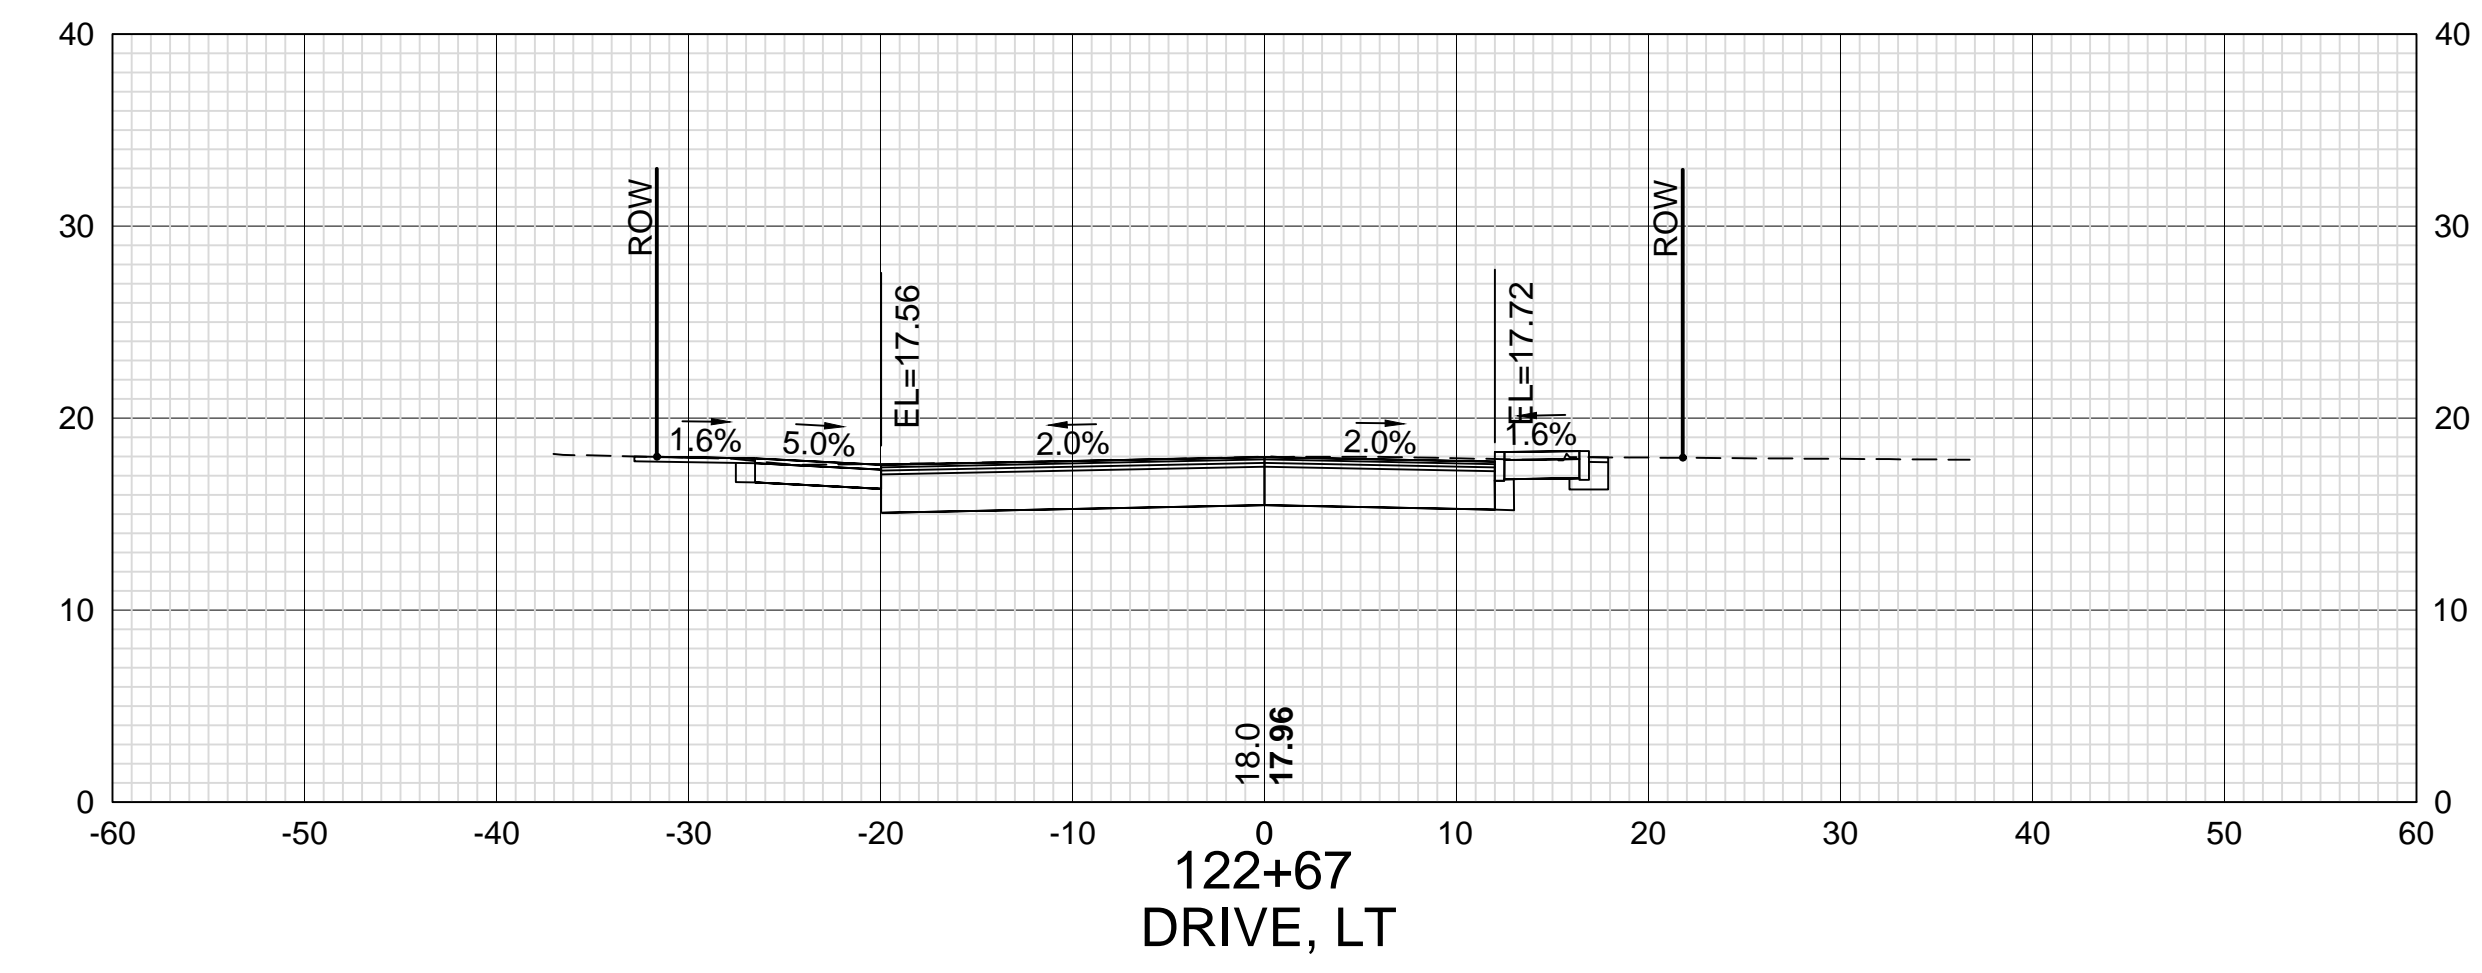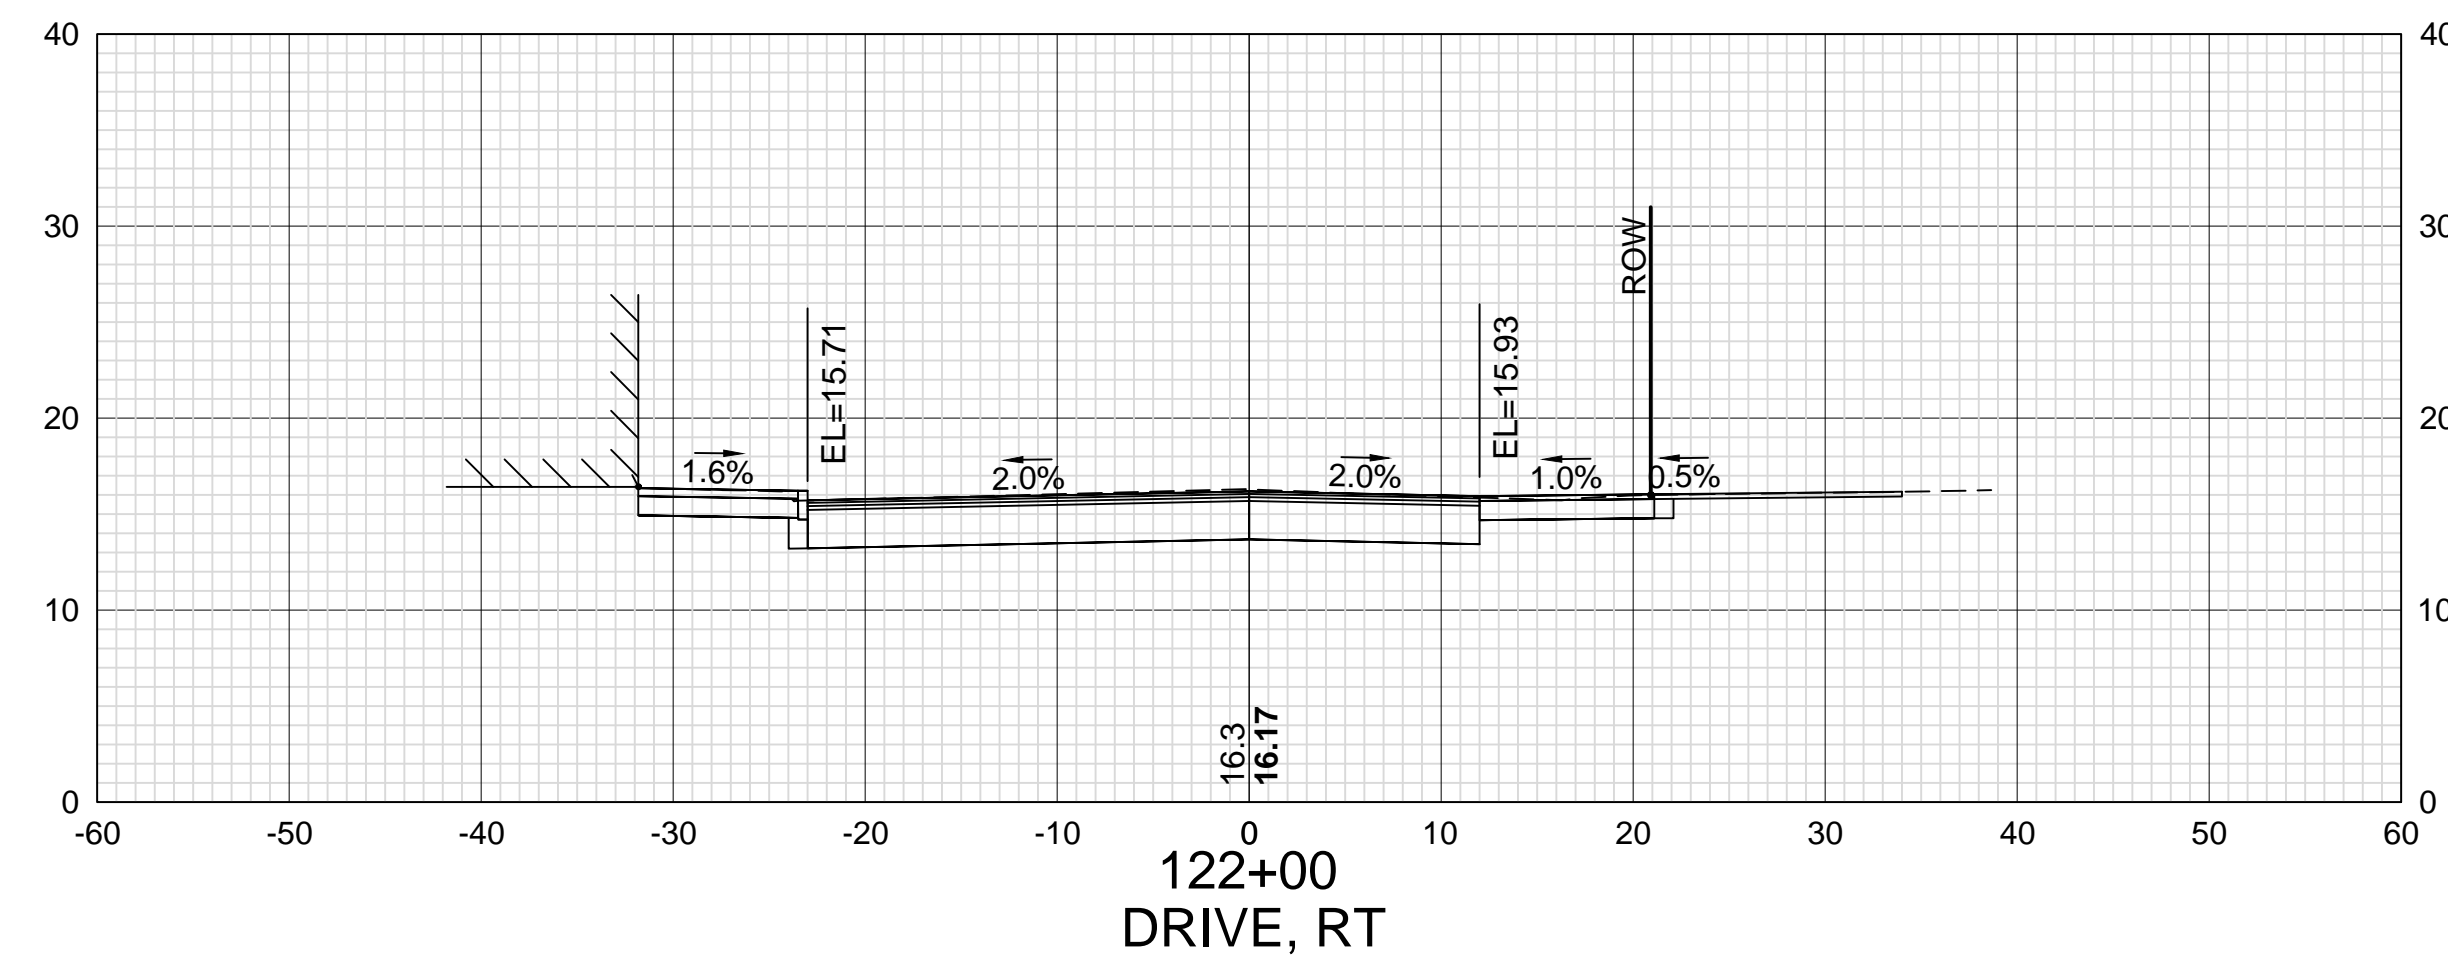








DATE PLOTTED	VHB PROJECT NO.
13-Nov-18	52393.00

ISLINGTON STREET CORRIDOR IMPROVEMENTS - SEGMENT 1			
CITY OF PORTSMOUTH, NEW HAMPSHIRE			
CROSS SECTIONS			
ISLINGTON STREET			
DRAWING	CITY PROJECT NO.	SHEET NO.	TOTAL SHEETS
XS-Seg1	7176	63	88



SDR PROCESSED	VHB	DATE	OCT 2017
	KMH	DATE	11/13/18
	GLB	DATE	11/13/18
NEW DESIGN			
SHEET CHECKED			
AS BUILT DETAILS			

REVISIONS AFTER PROPOSAL	STATION	DATE	NUMBER

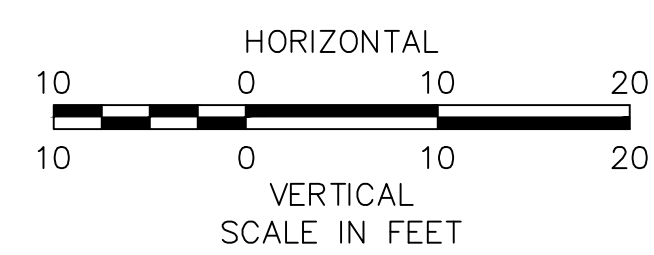
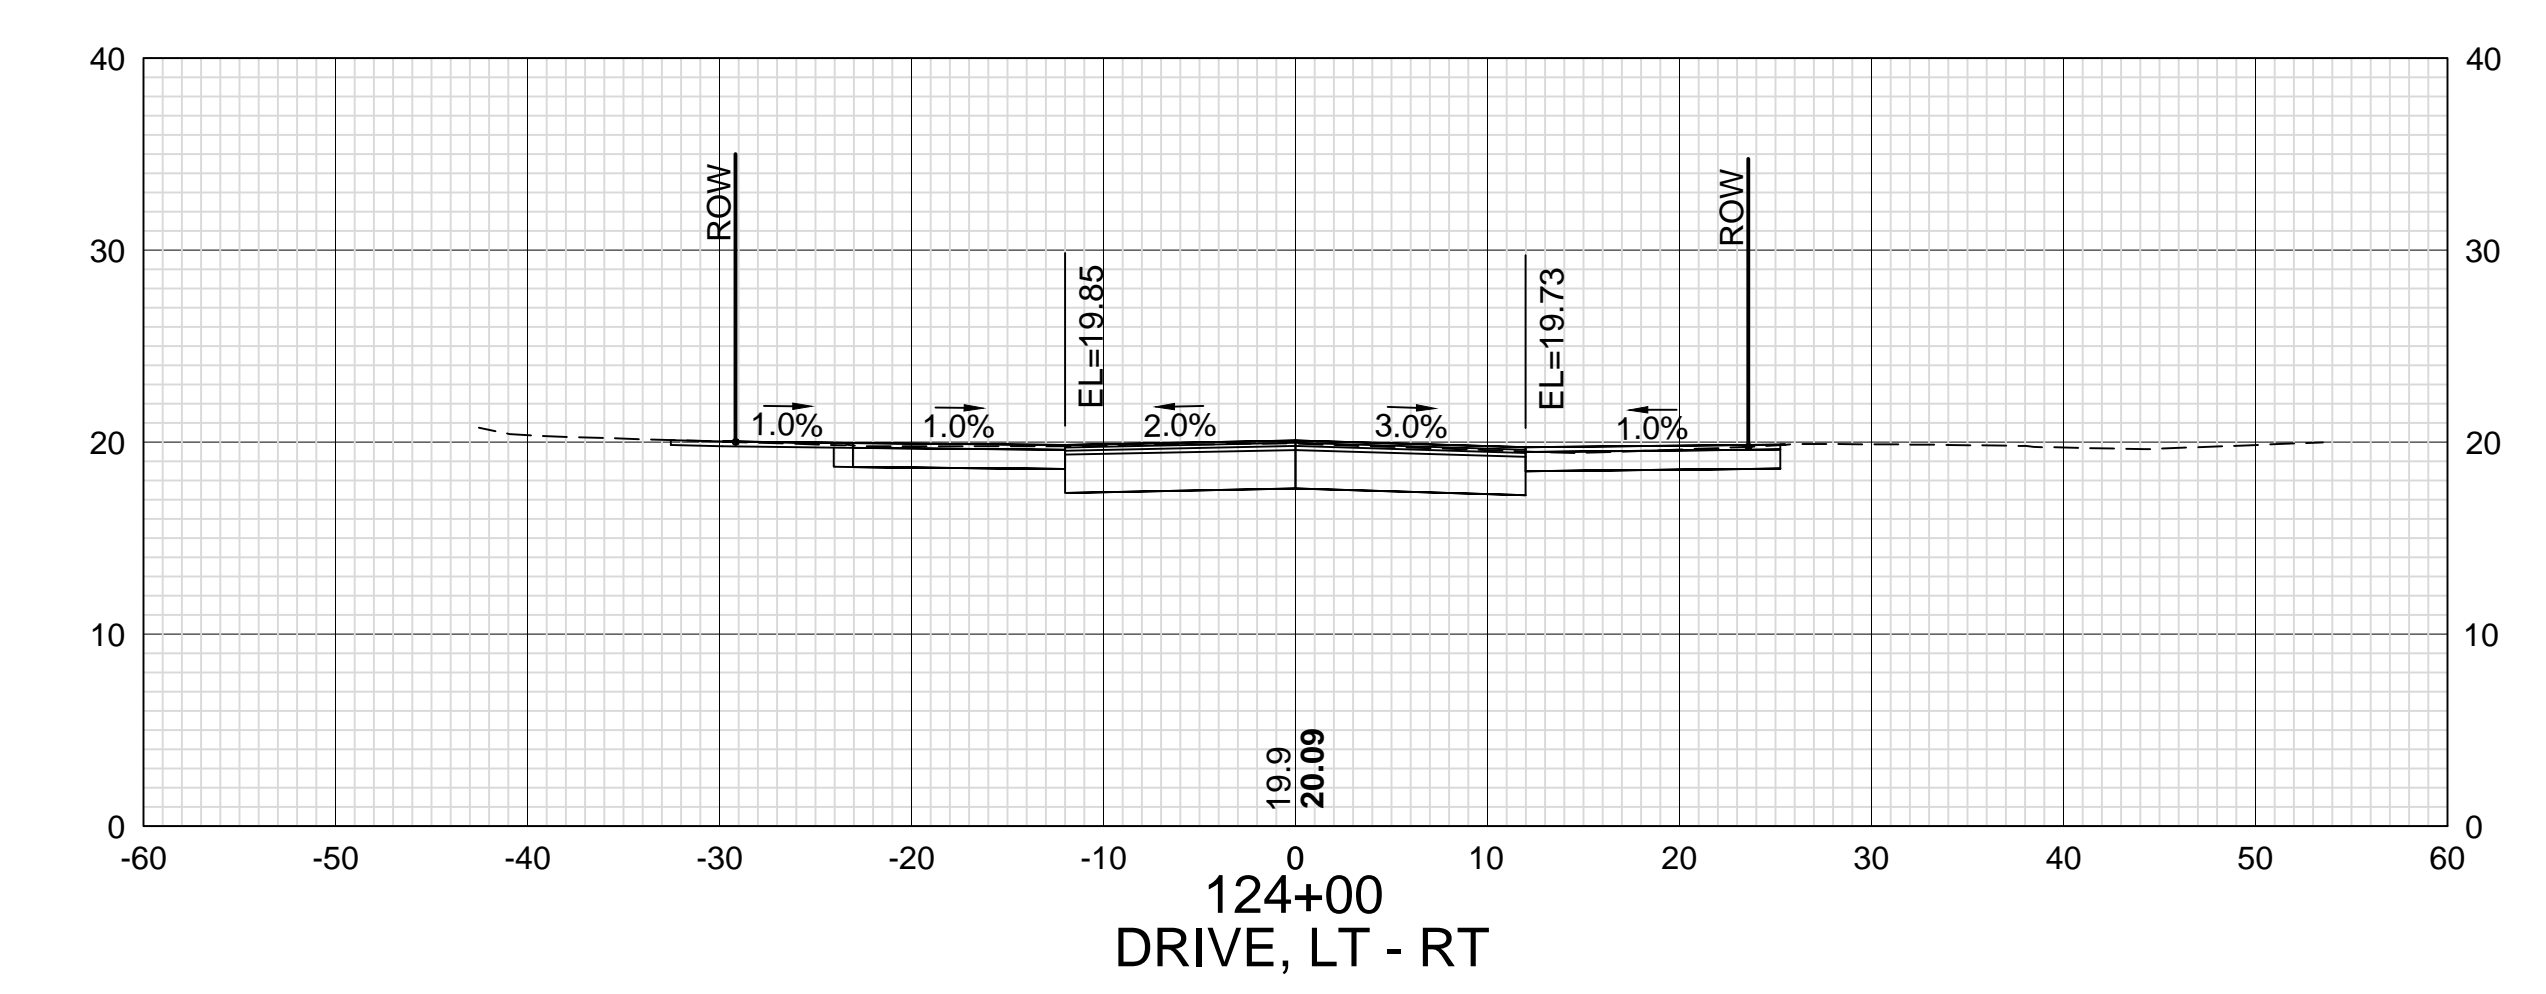
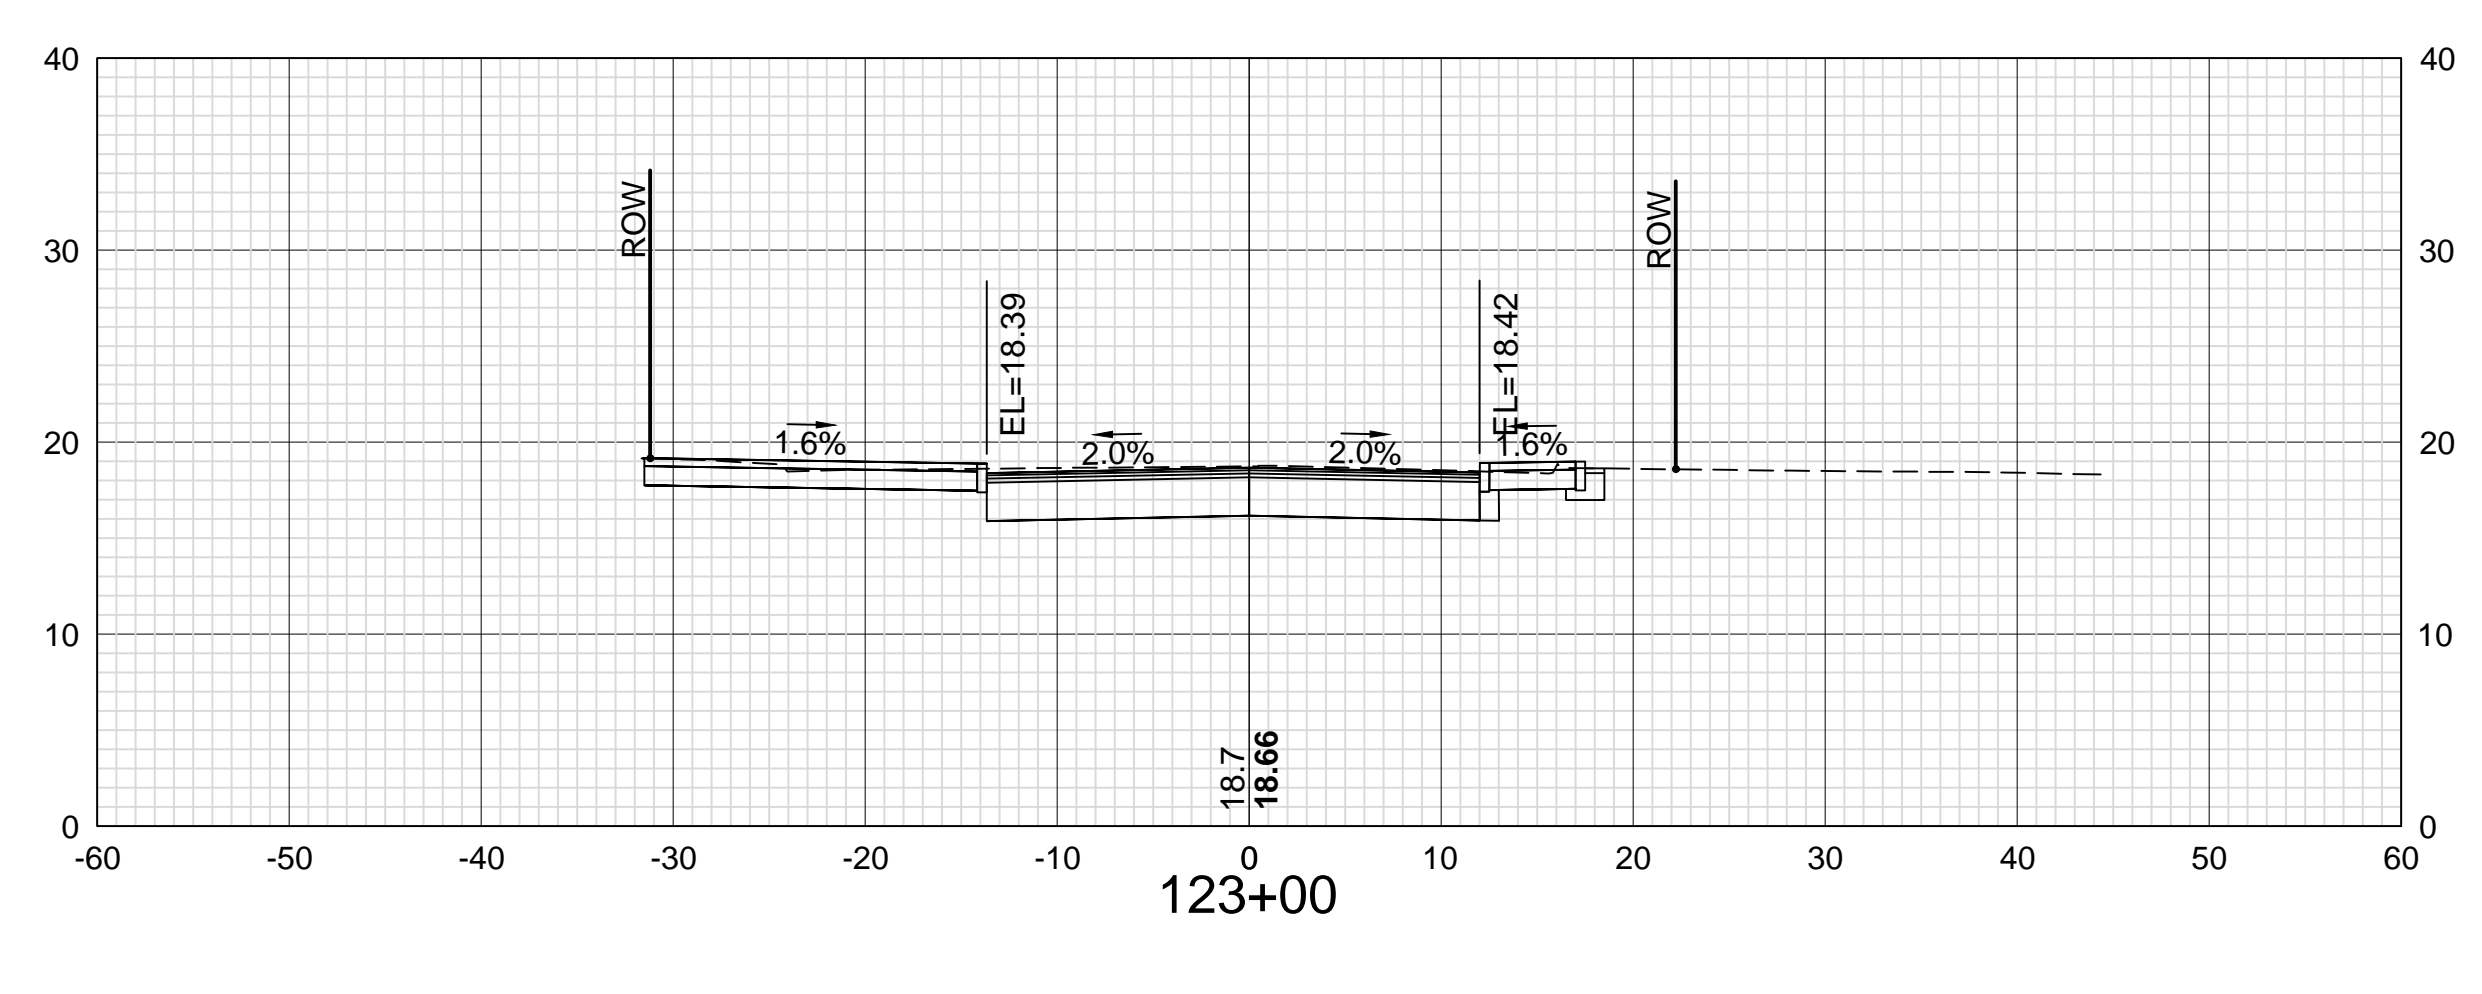
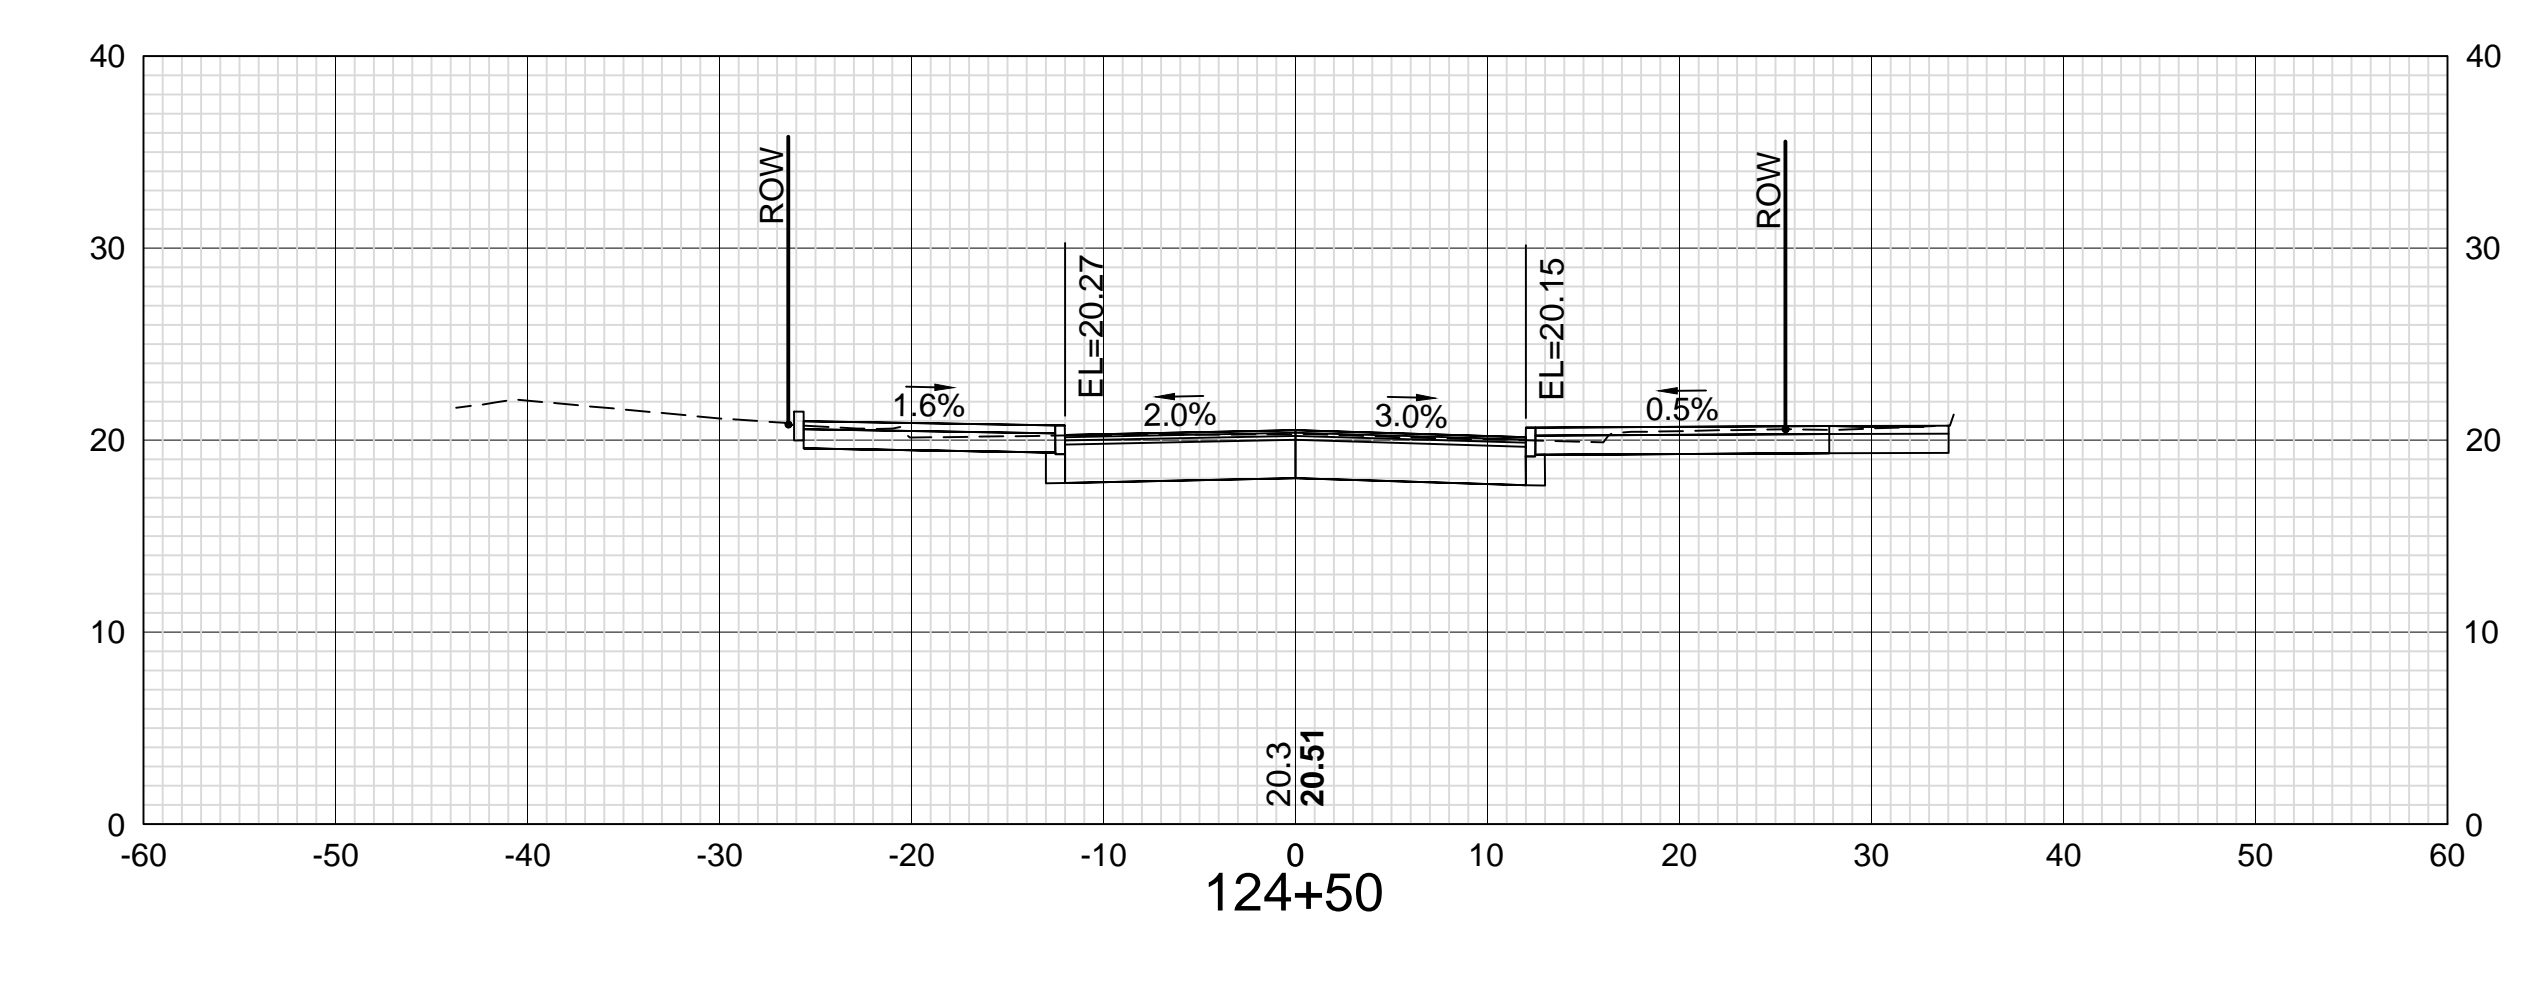
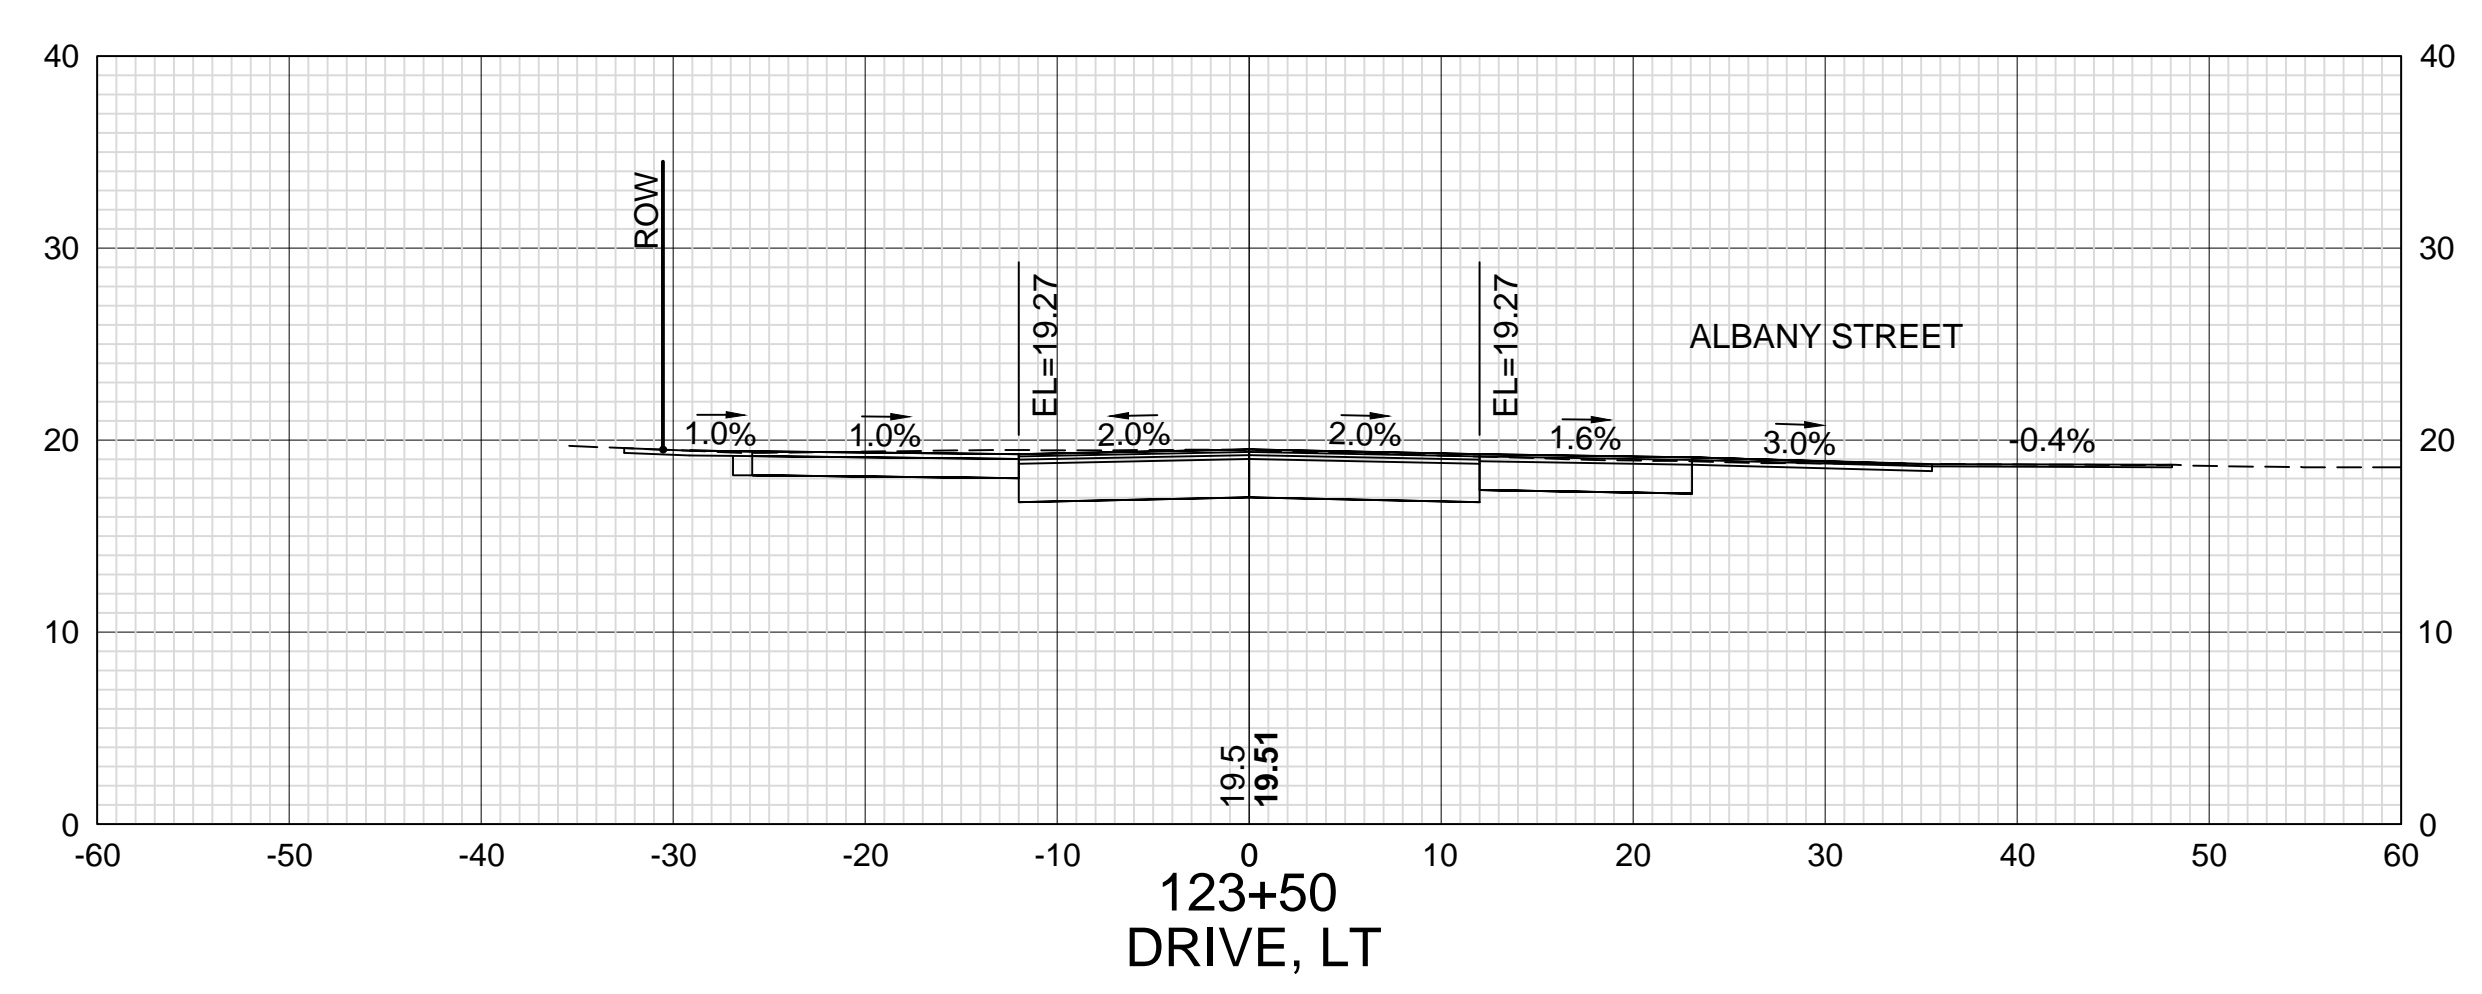
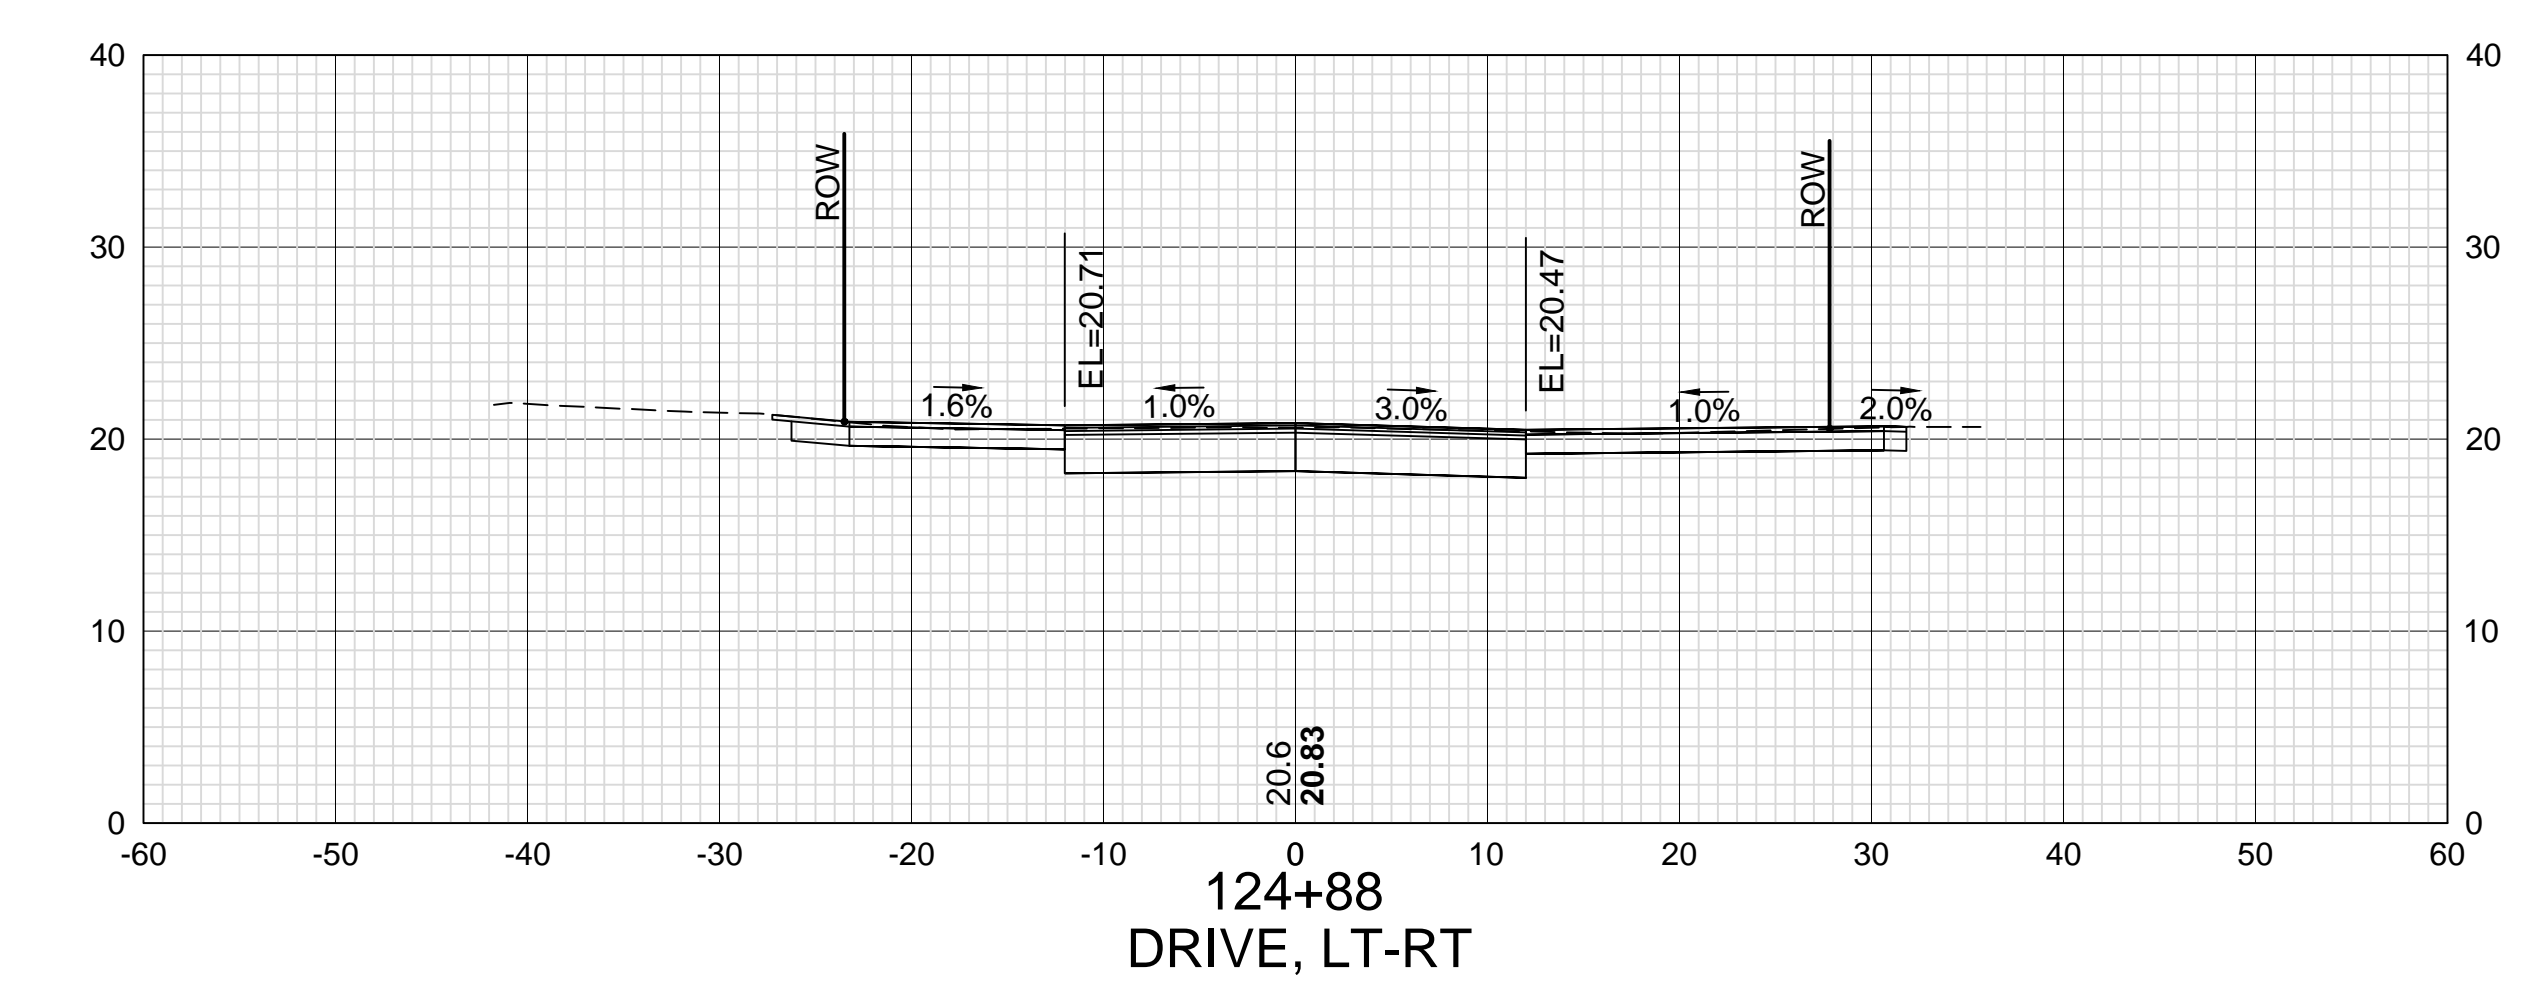
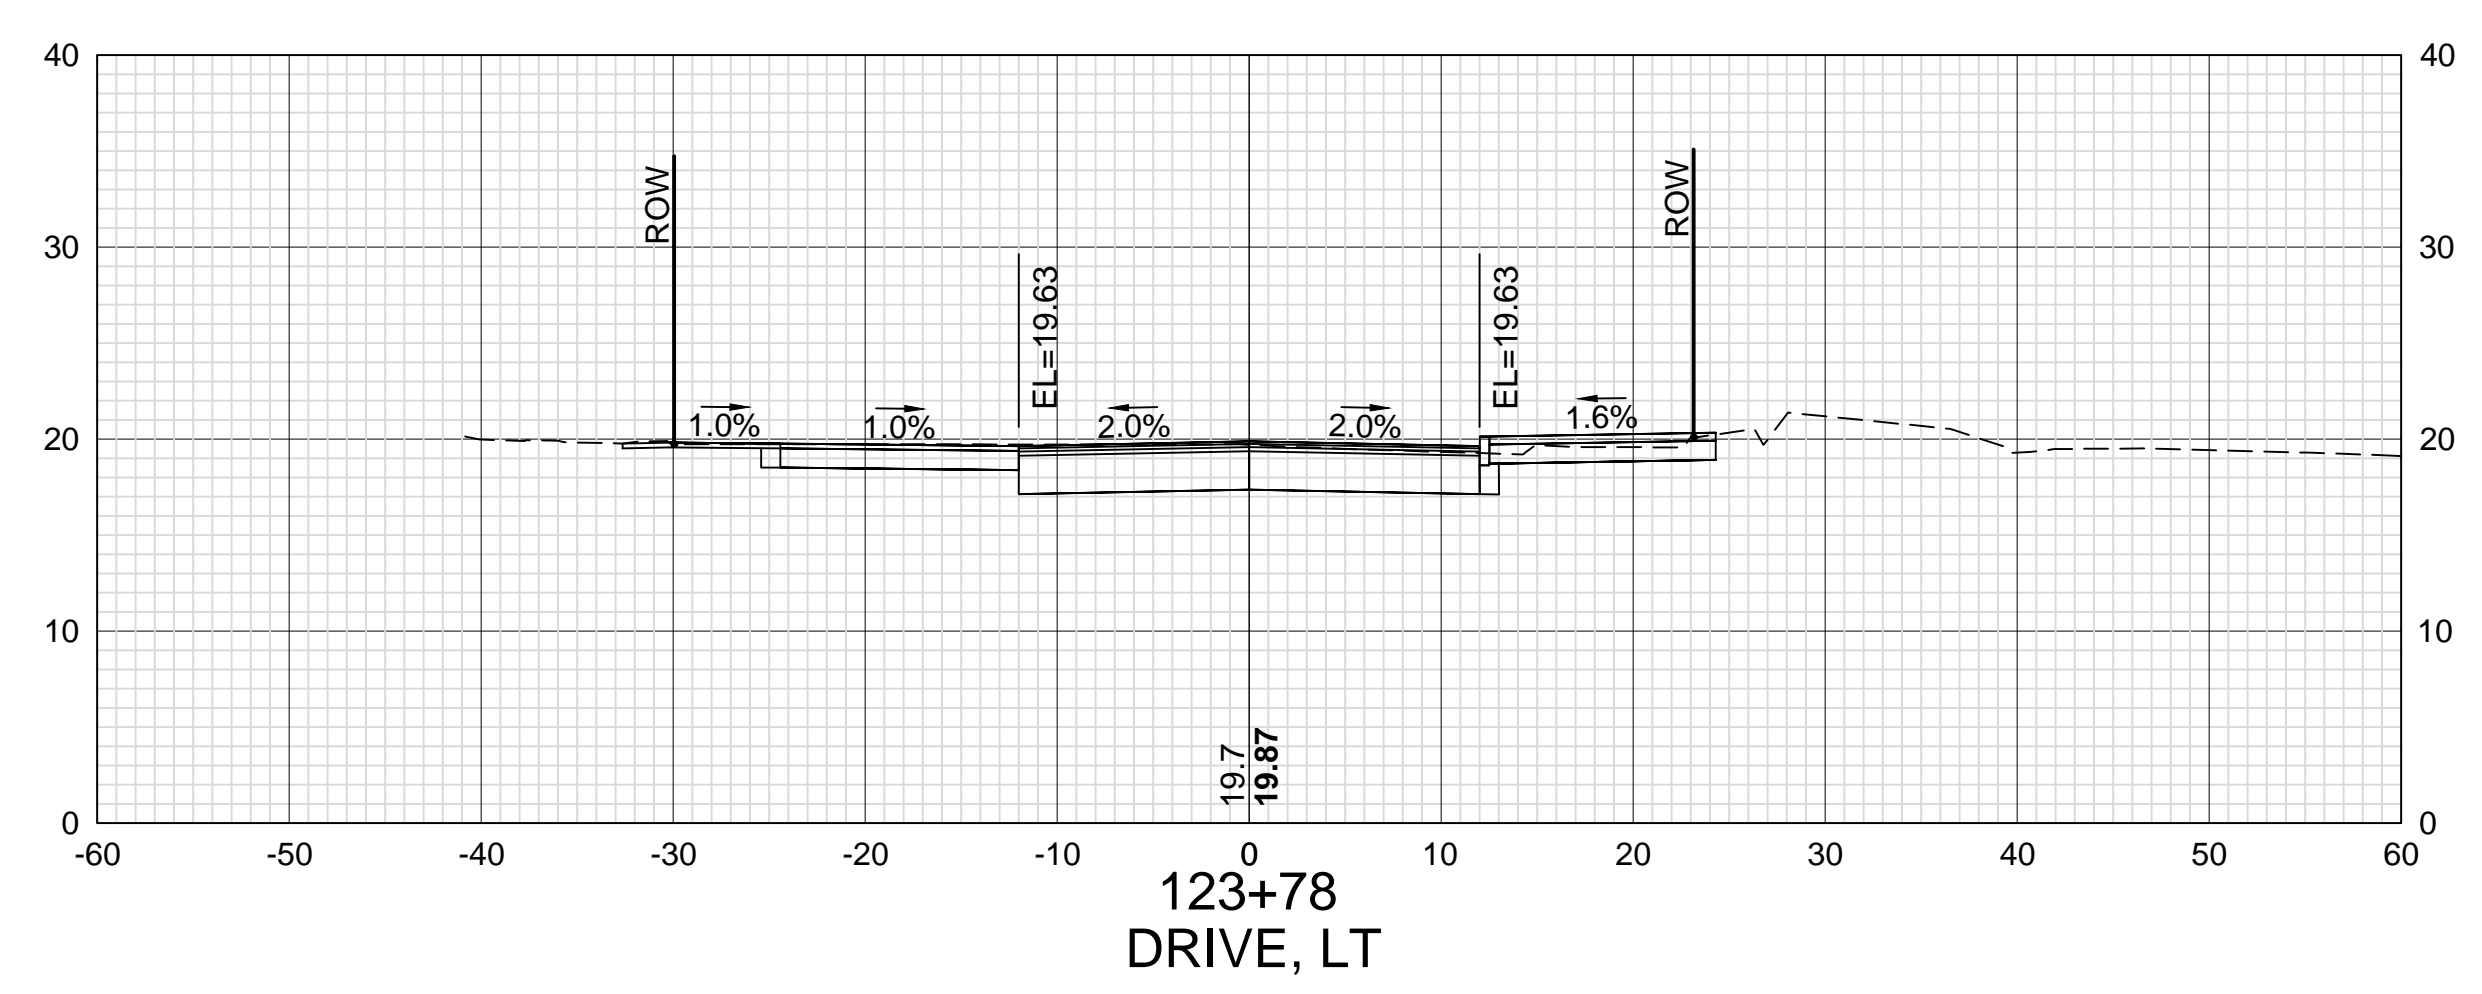


DATE PLOTTED	VHB PROJECT NO.
13-Nov-18	52393.00

ISLINGTON STREET CORRIDOR IMPROVEMENTS - SEGMENT 1			
CITY OF PORTSMOUTH, NEW HAMPSHIRE			
CROSS SECTIONS			
ISLINGTON STREET			
DRAWING	CITY PROJECT NO.	SHEET NO.	TOTAL SHEETS
XS-Seg1	7176	64	88

REVISIONS AFTER PROPOSAL	DESCRIPTION
	STATION
	DATE
NUMBER	

SDR PROCESSED	VHB	DATE	OCT 2017
NEW DESIGN	KMH	DATE	11/13/18
SHEET CHECKED	GLB	DATE	11/13/18
AS BUILT DETAILS		DATE	

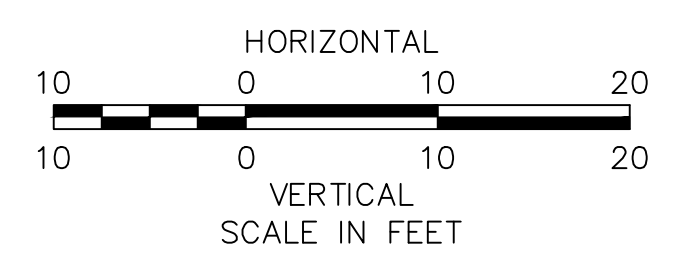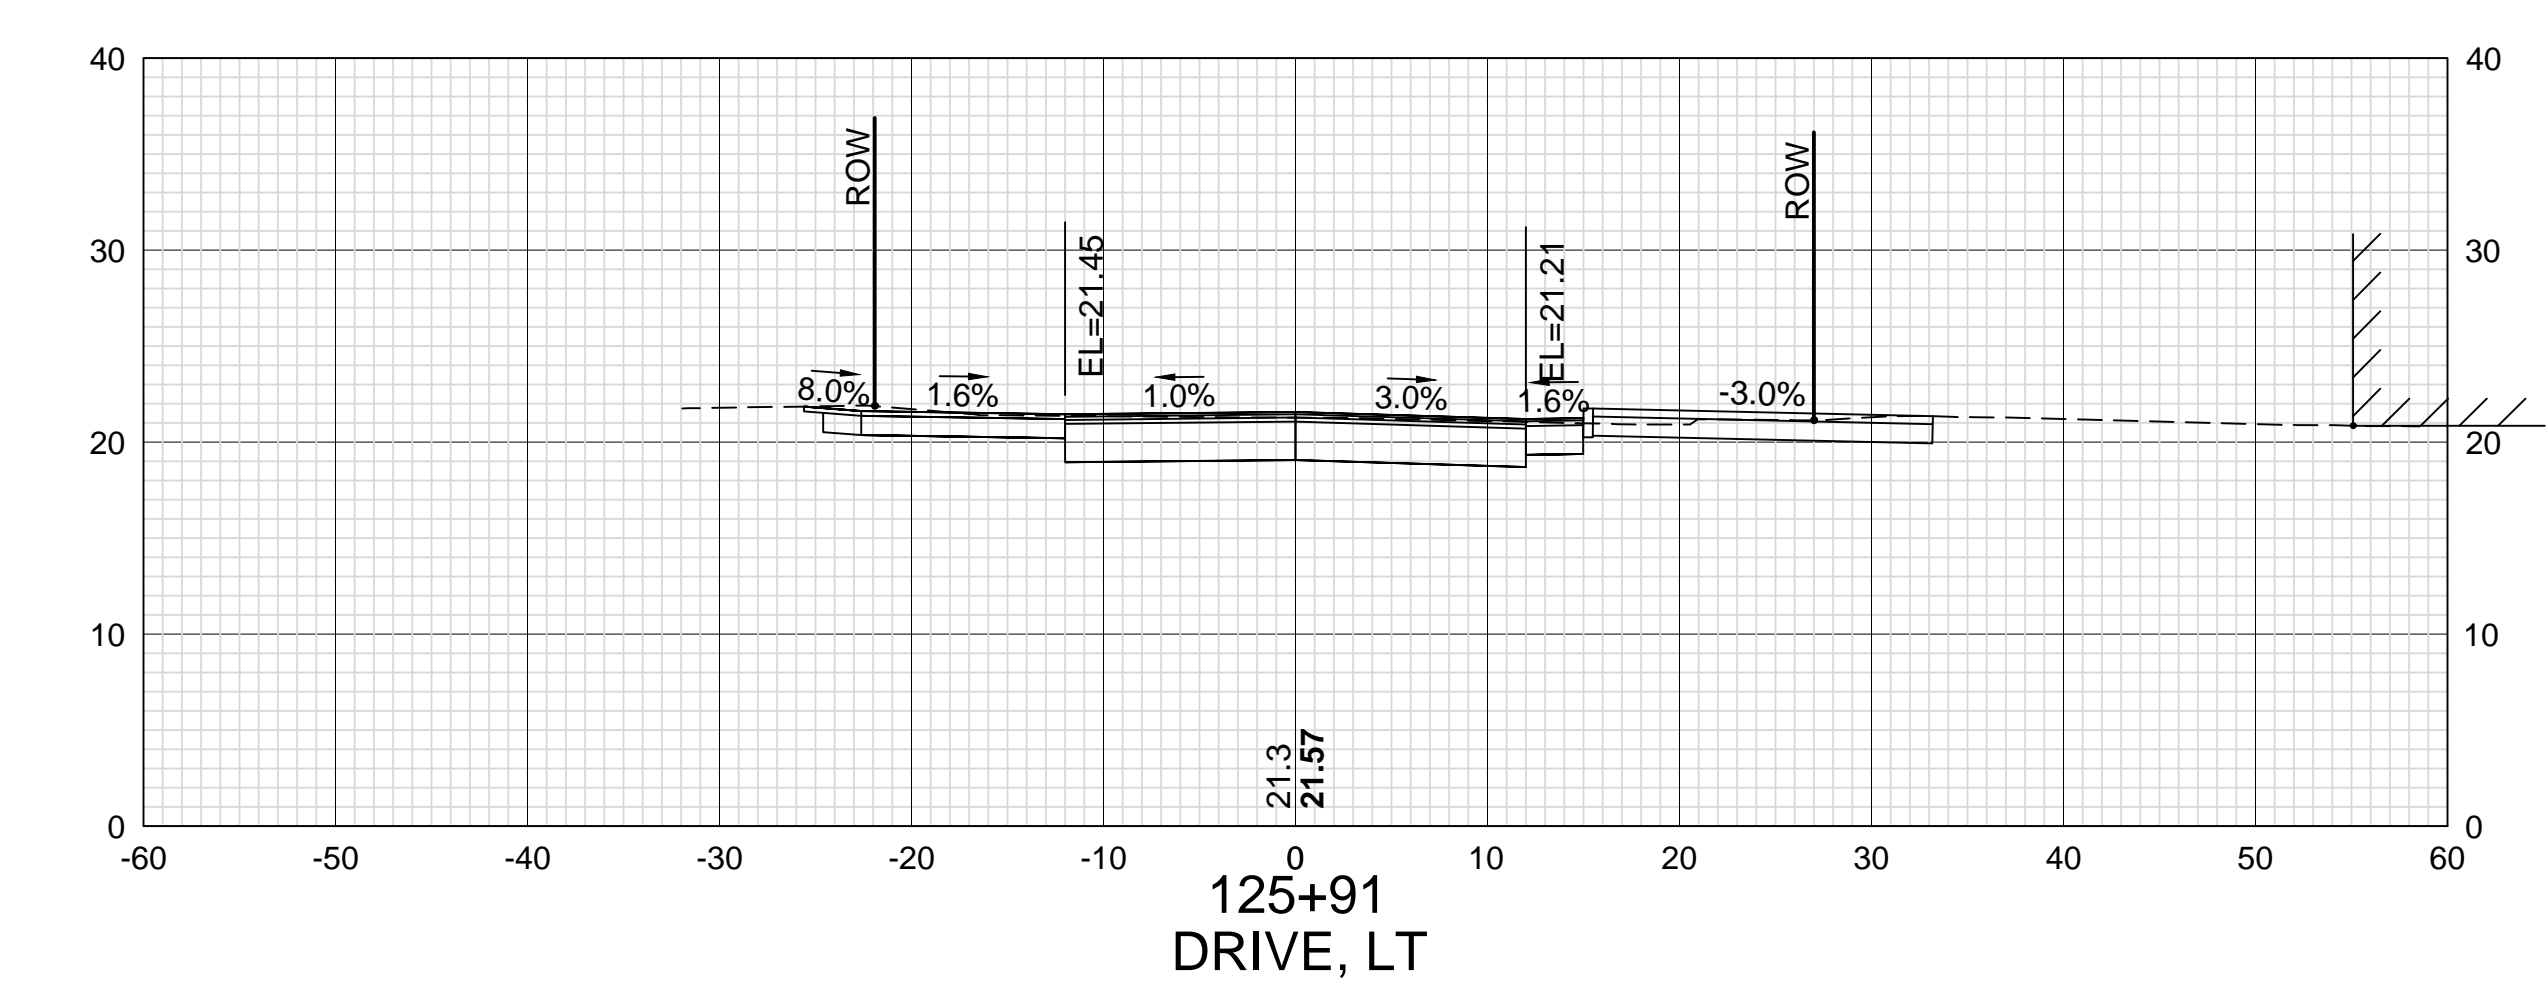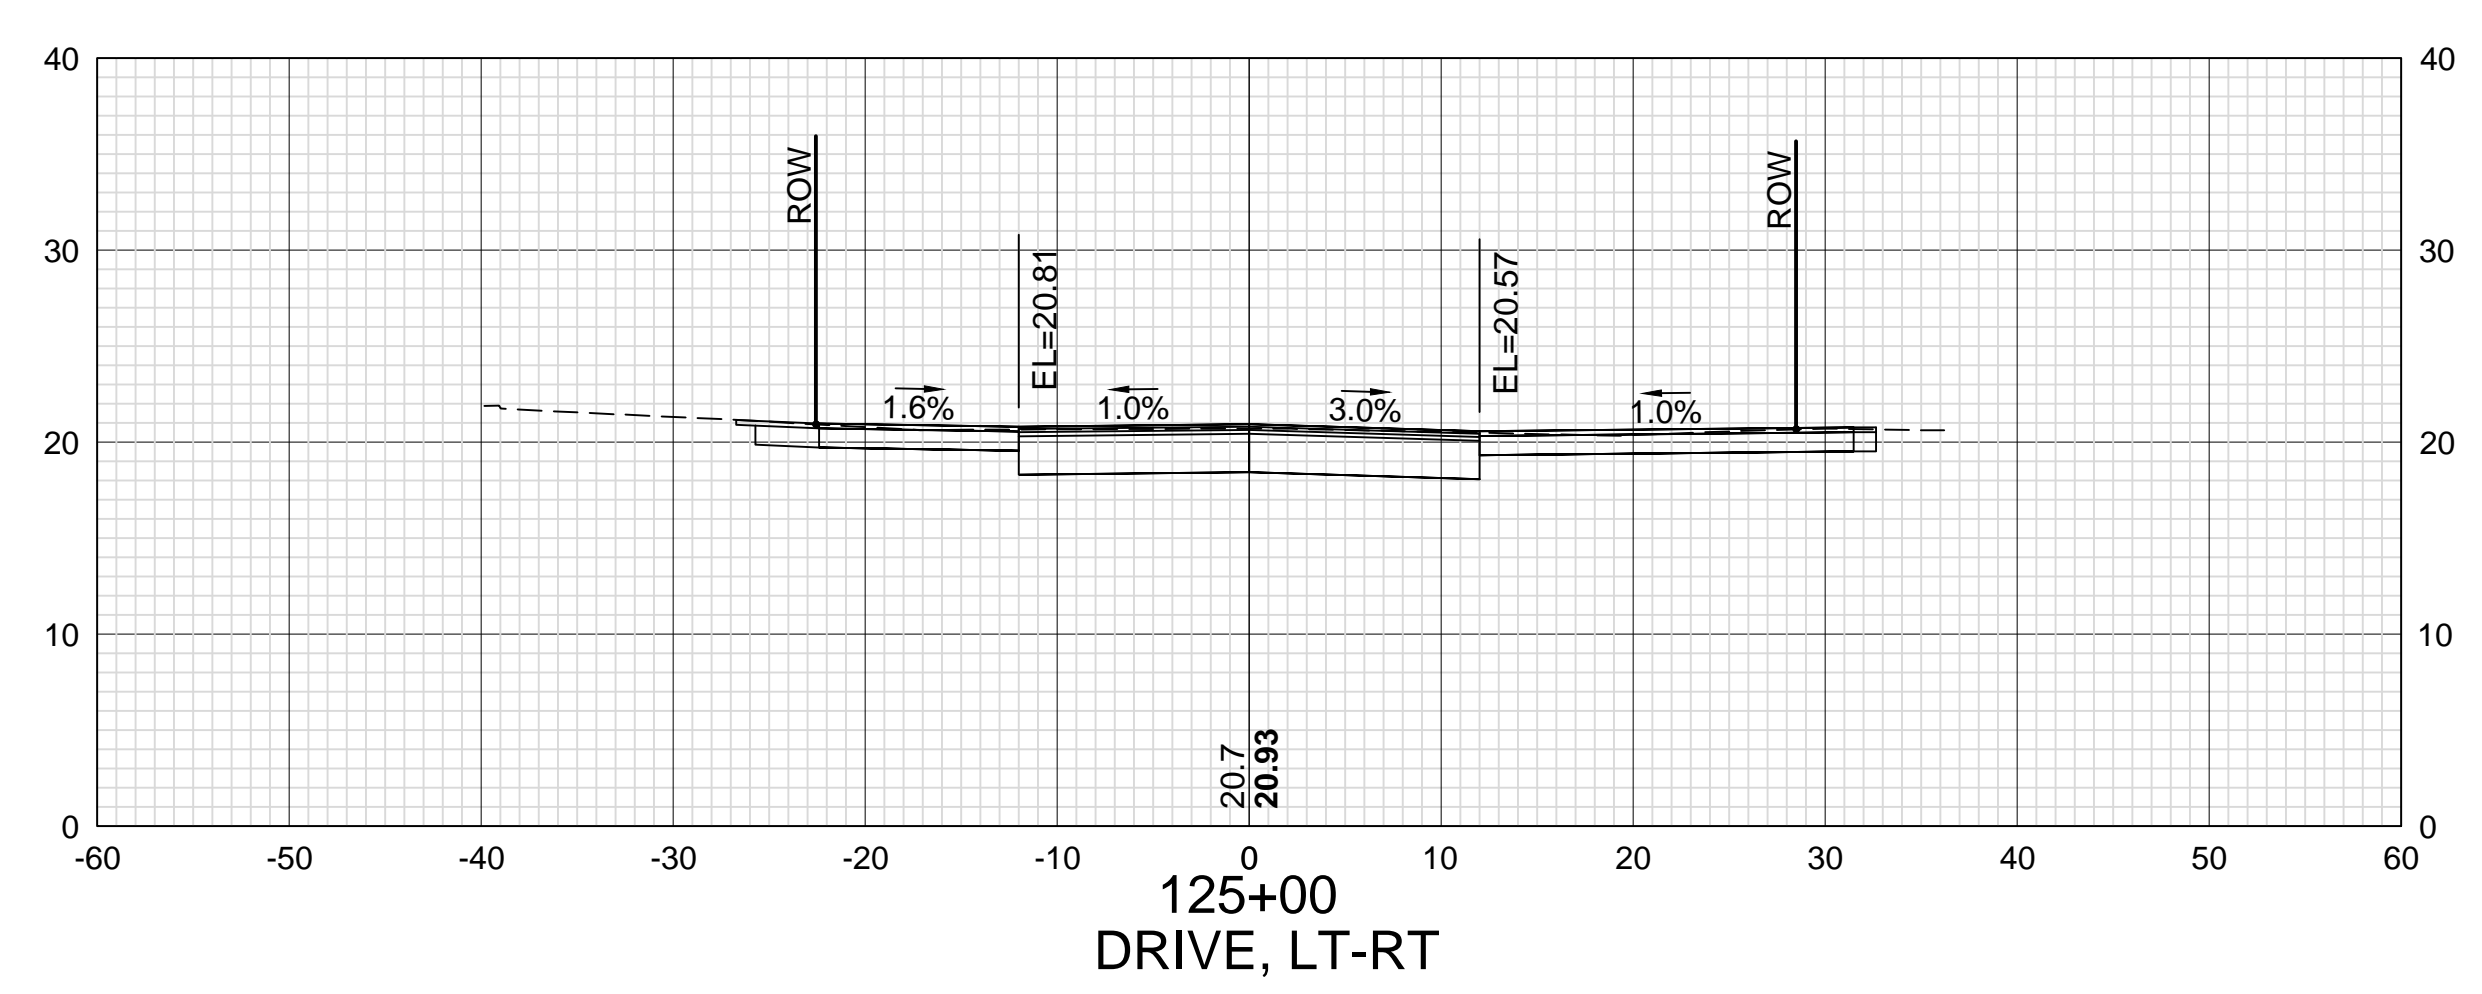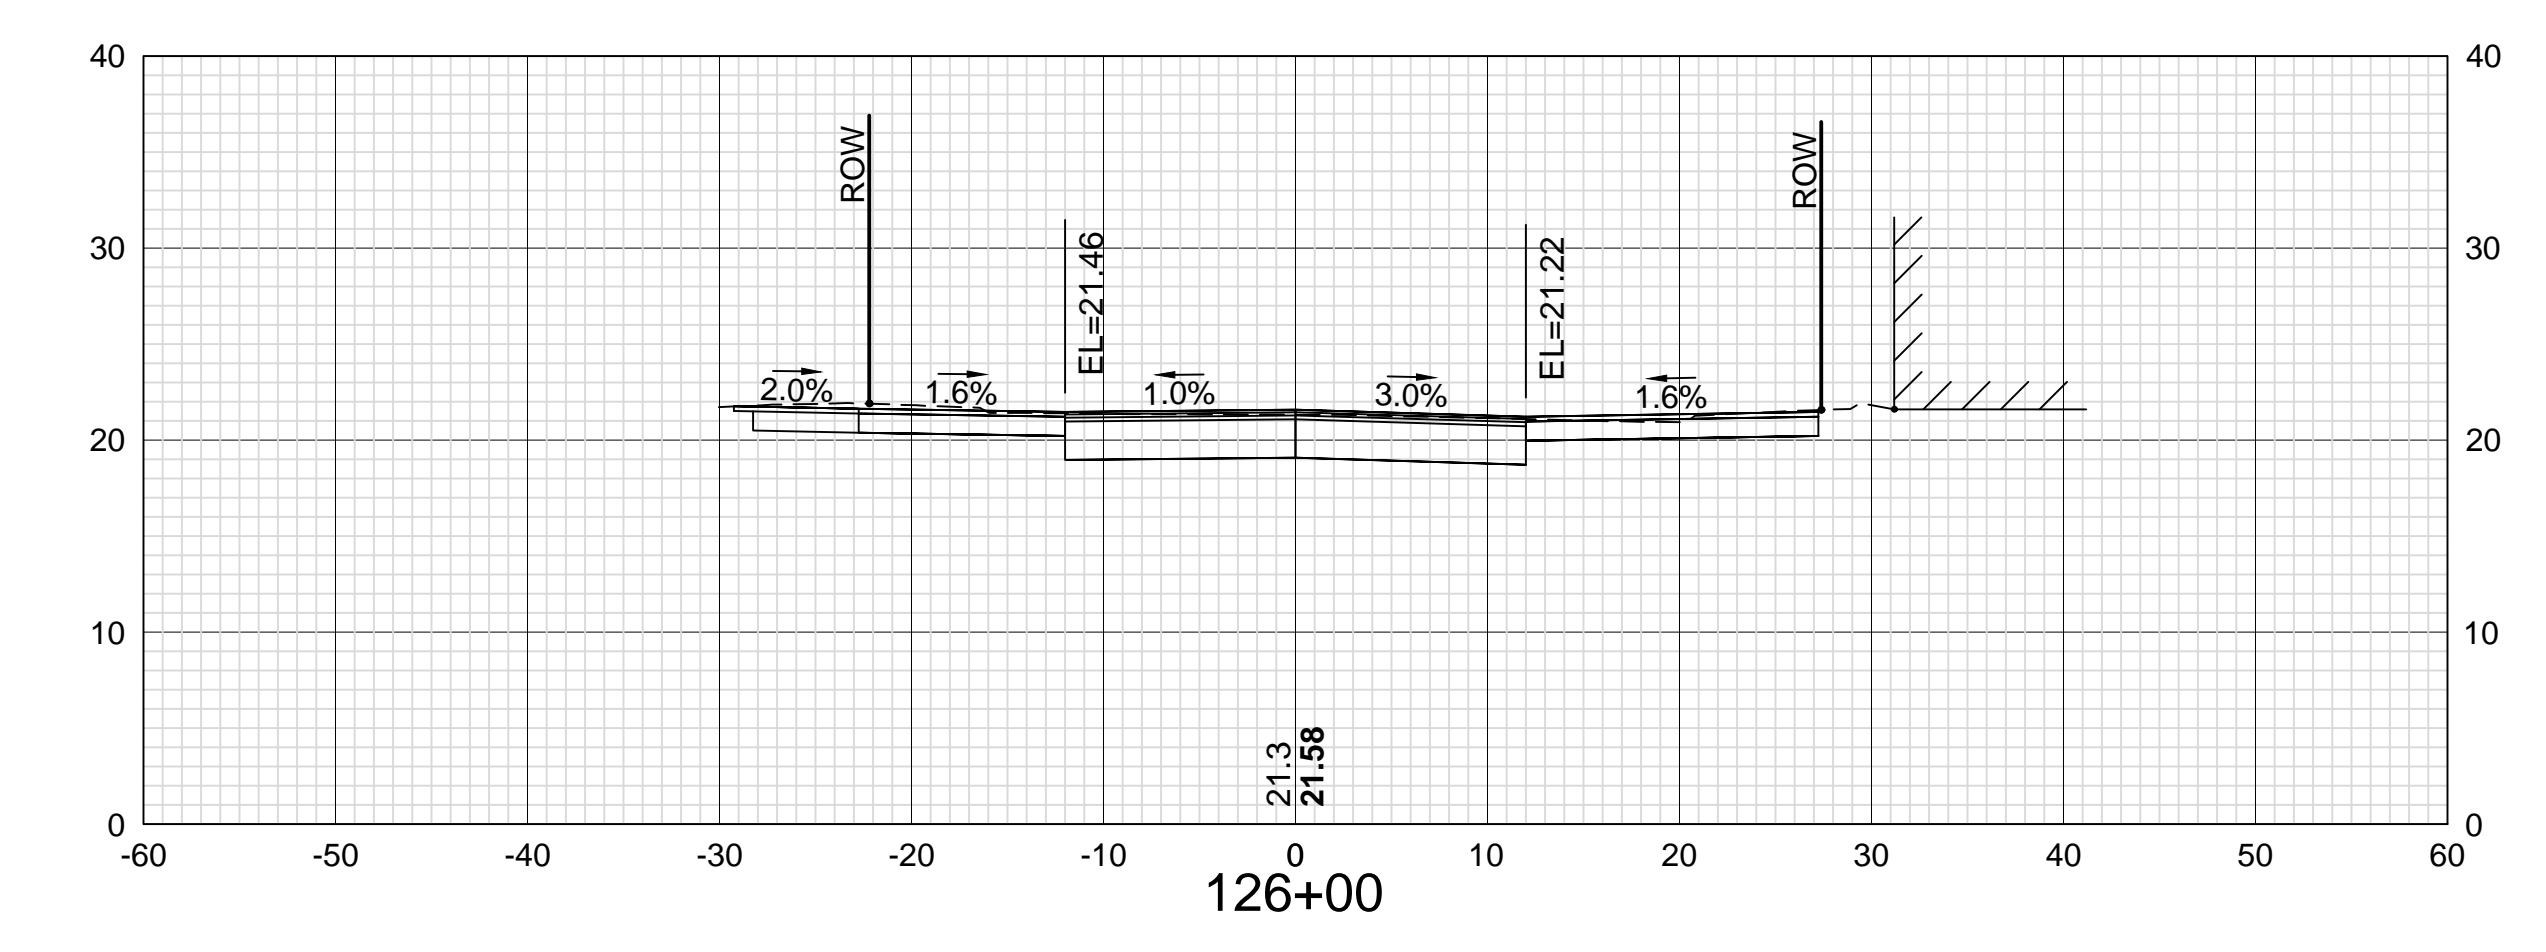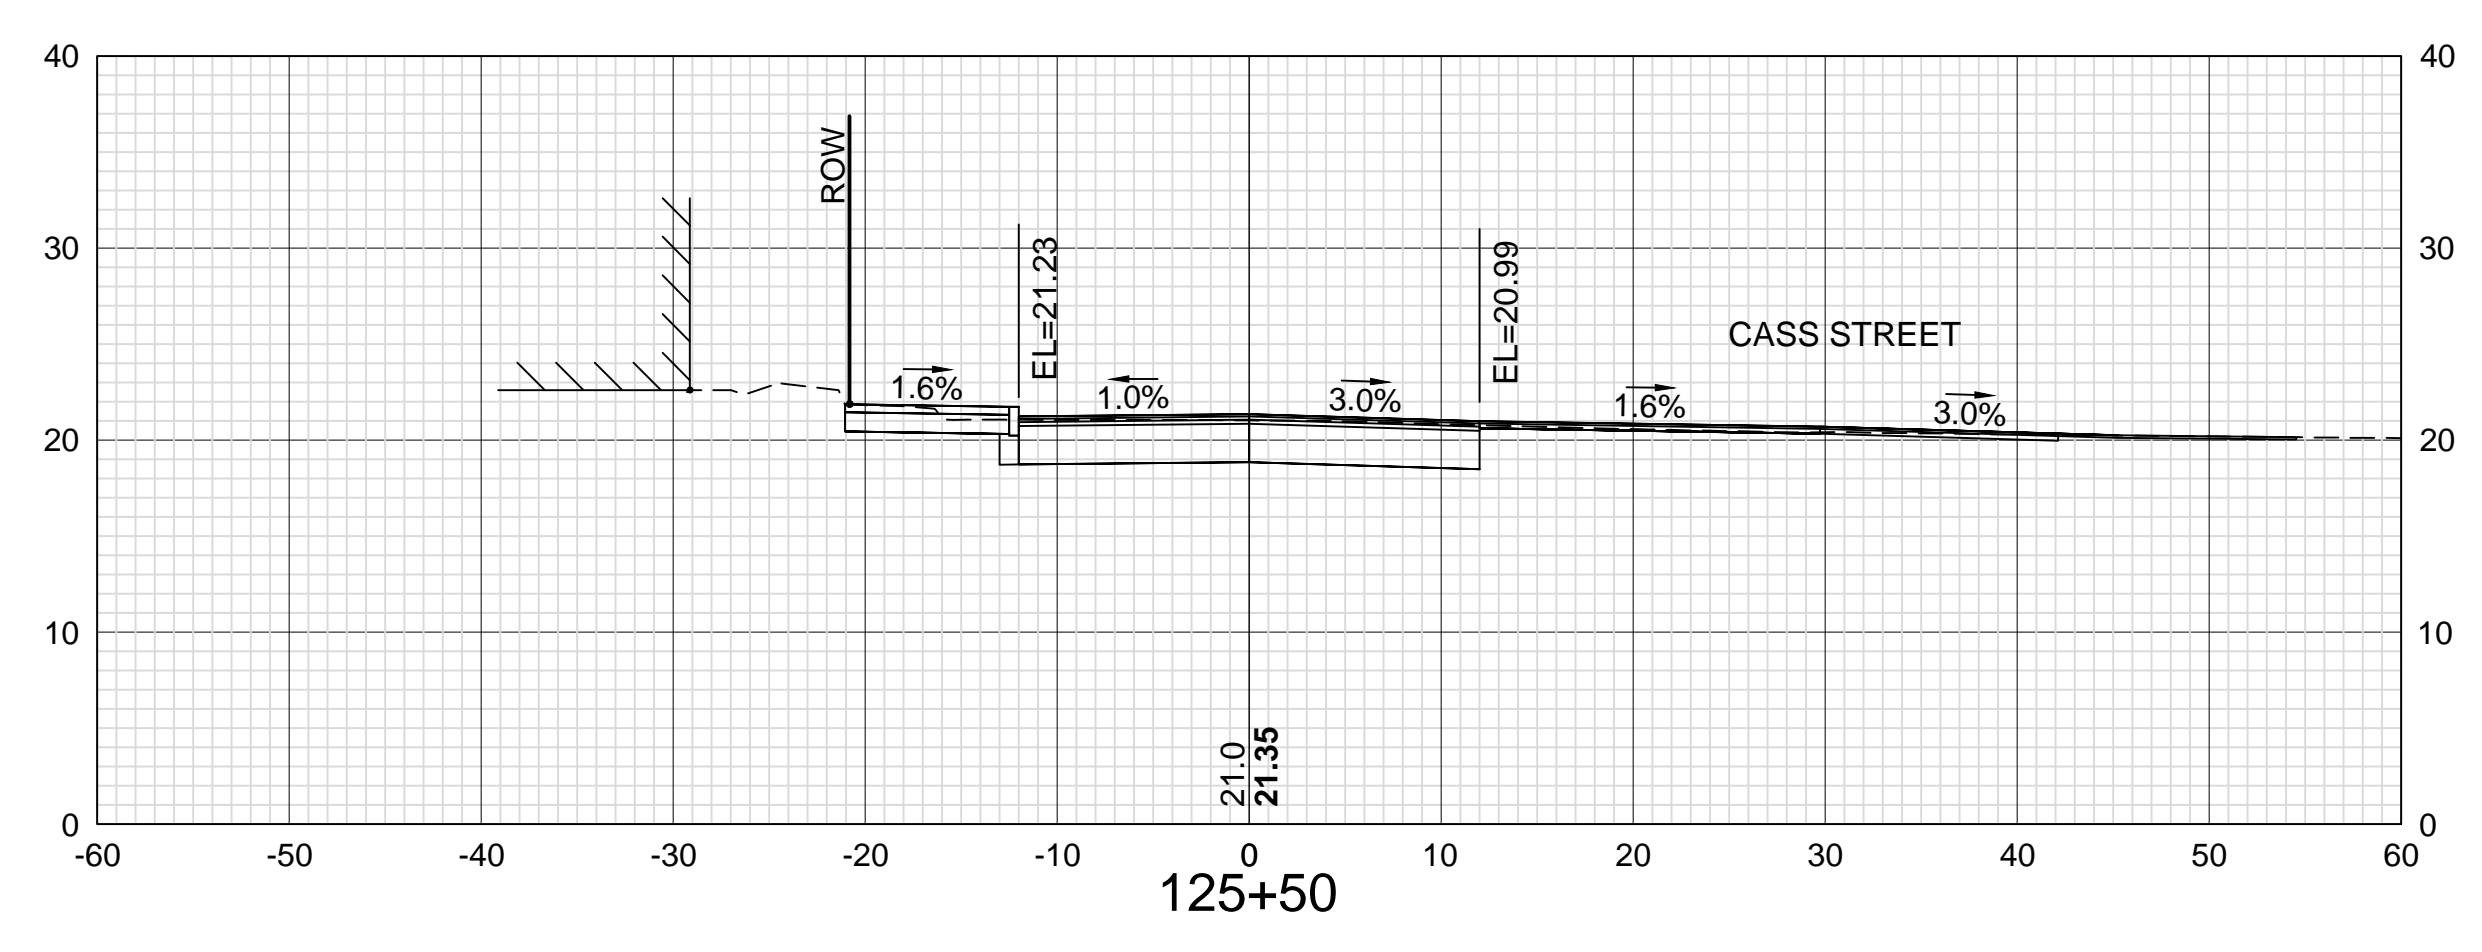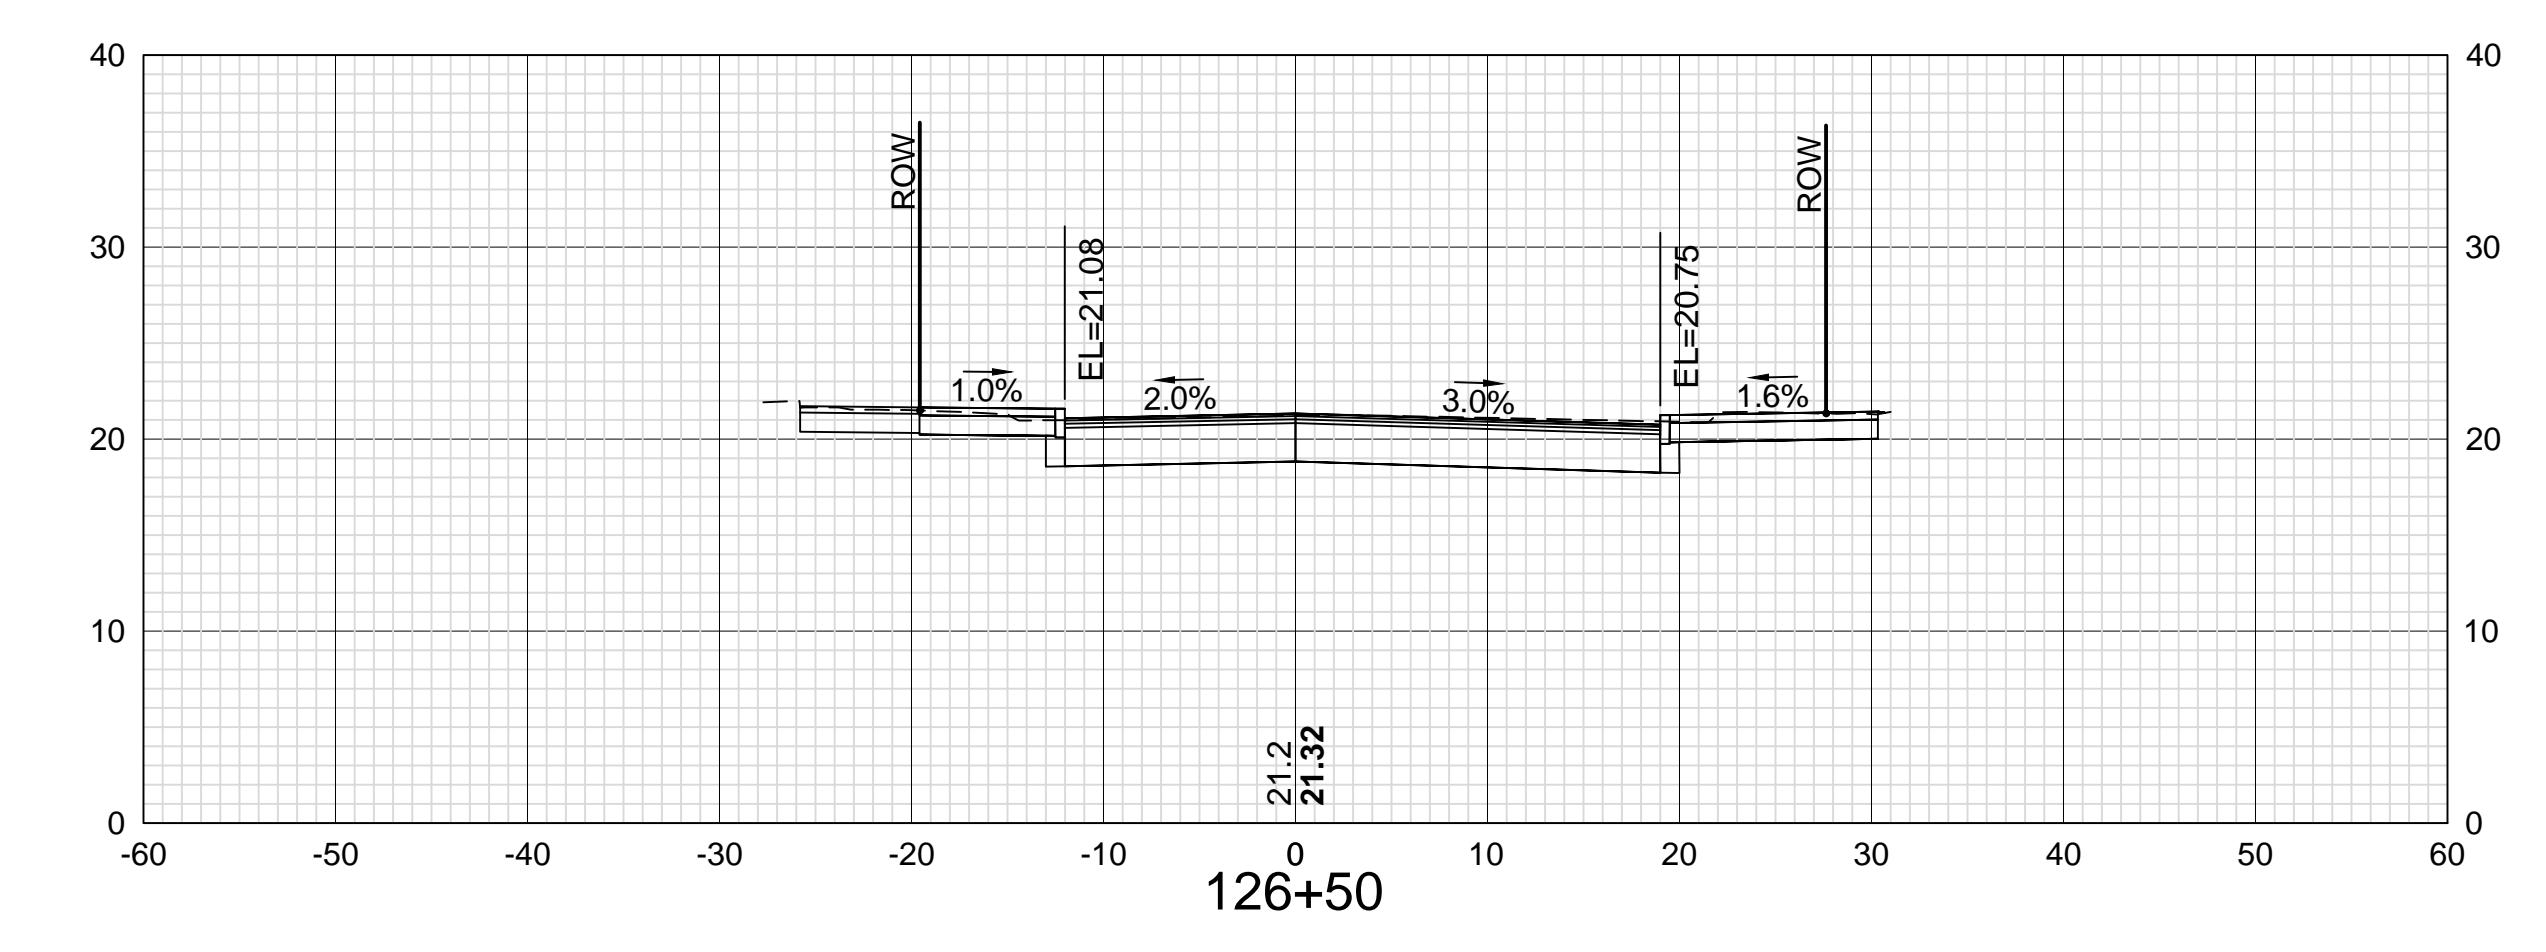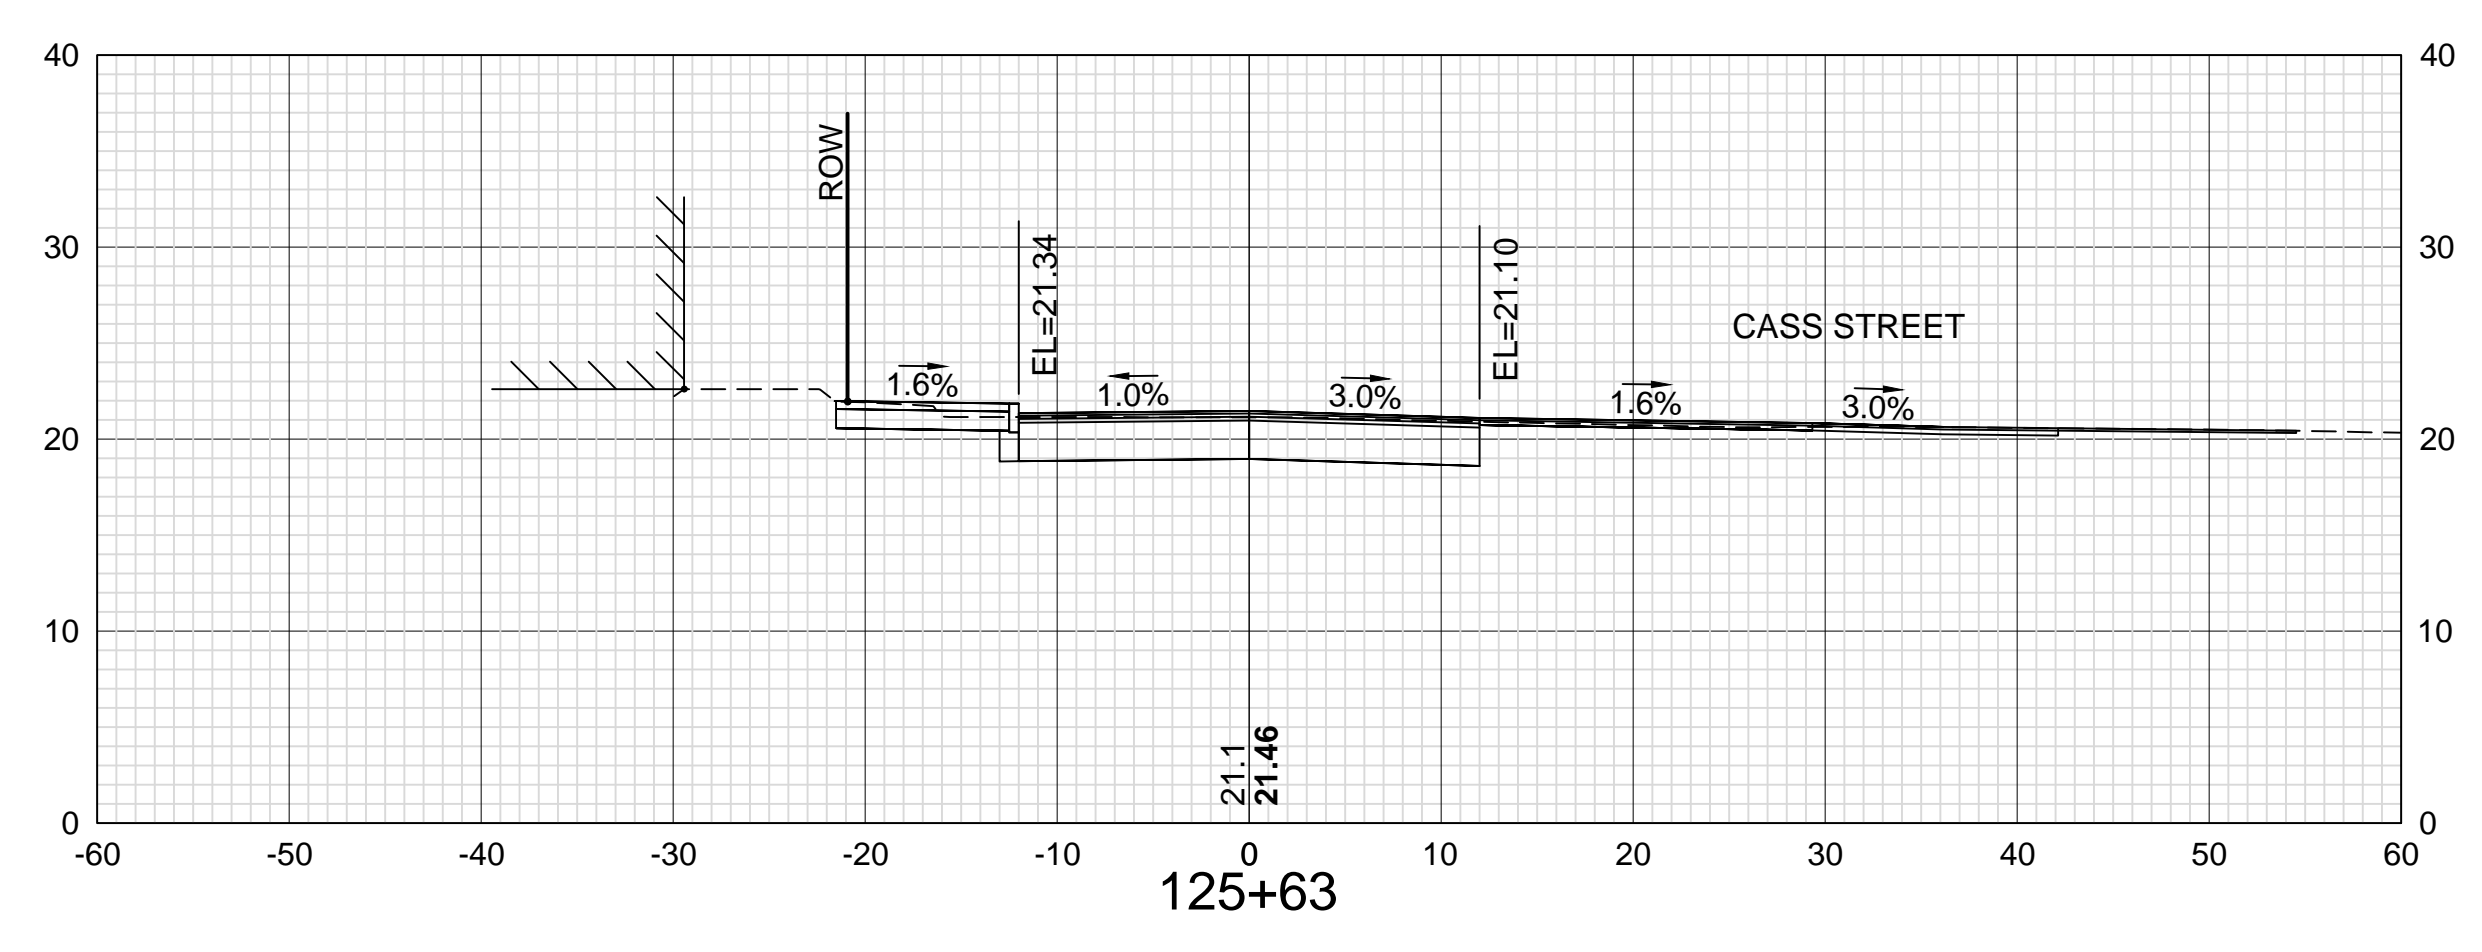










DATE PLOTTED	VHB PROJECT NO.
13-Nov-18	52393.00

ISLINGTON STREET CORRIDOR IMPROVEMENTS - SEGMENT 1			
CITY OF PORTSMOUTH, NEW HAMPSHIRE			
CROSS SECTIONS			
ISLINGTON STREET			
DRAWING	CITY PROJECT NO.	SHEET NO.	TOTAL SHEETS
XS-Seg1	7176	65	88



SDR PROCESSED	VHB	DATE	OCT 2017
	KMH	DATE	11/13/18
	GLB	DATE	11/13/18
AS BUILT DETAILS			

REVISIONS AFTER PROPOSAL	STATION	DATE	NUMBER

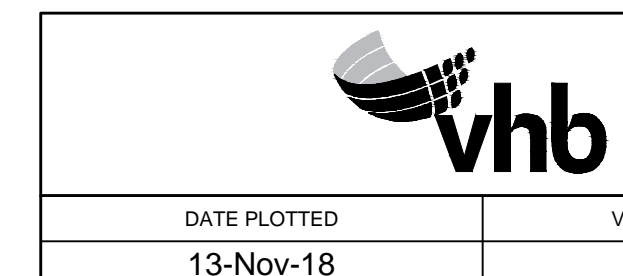
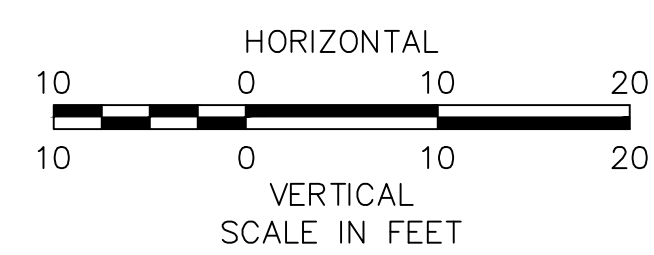
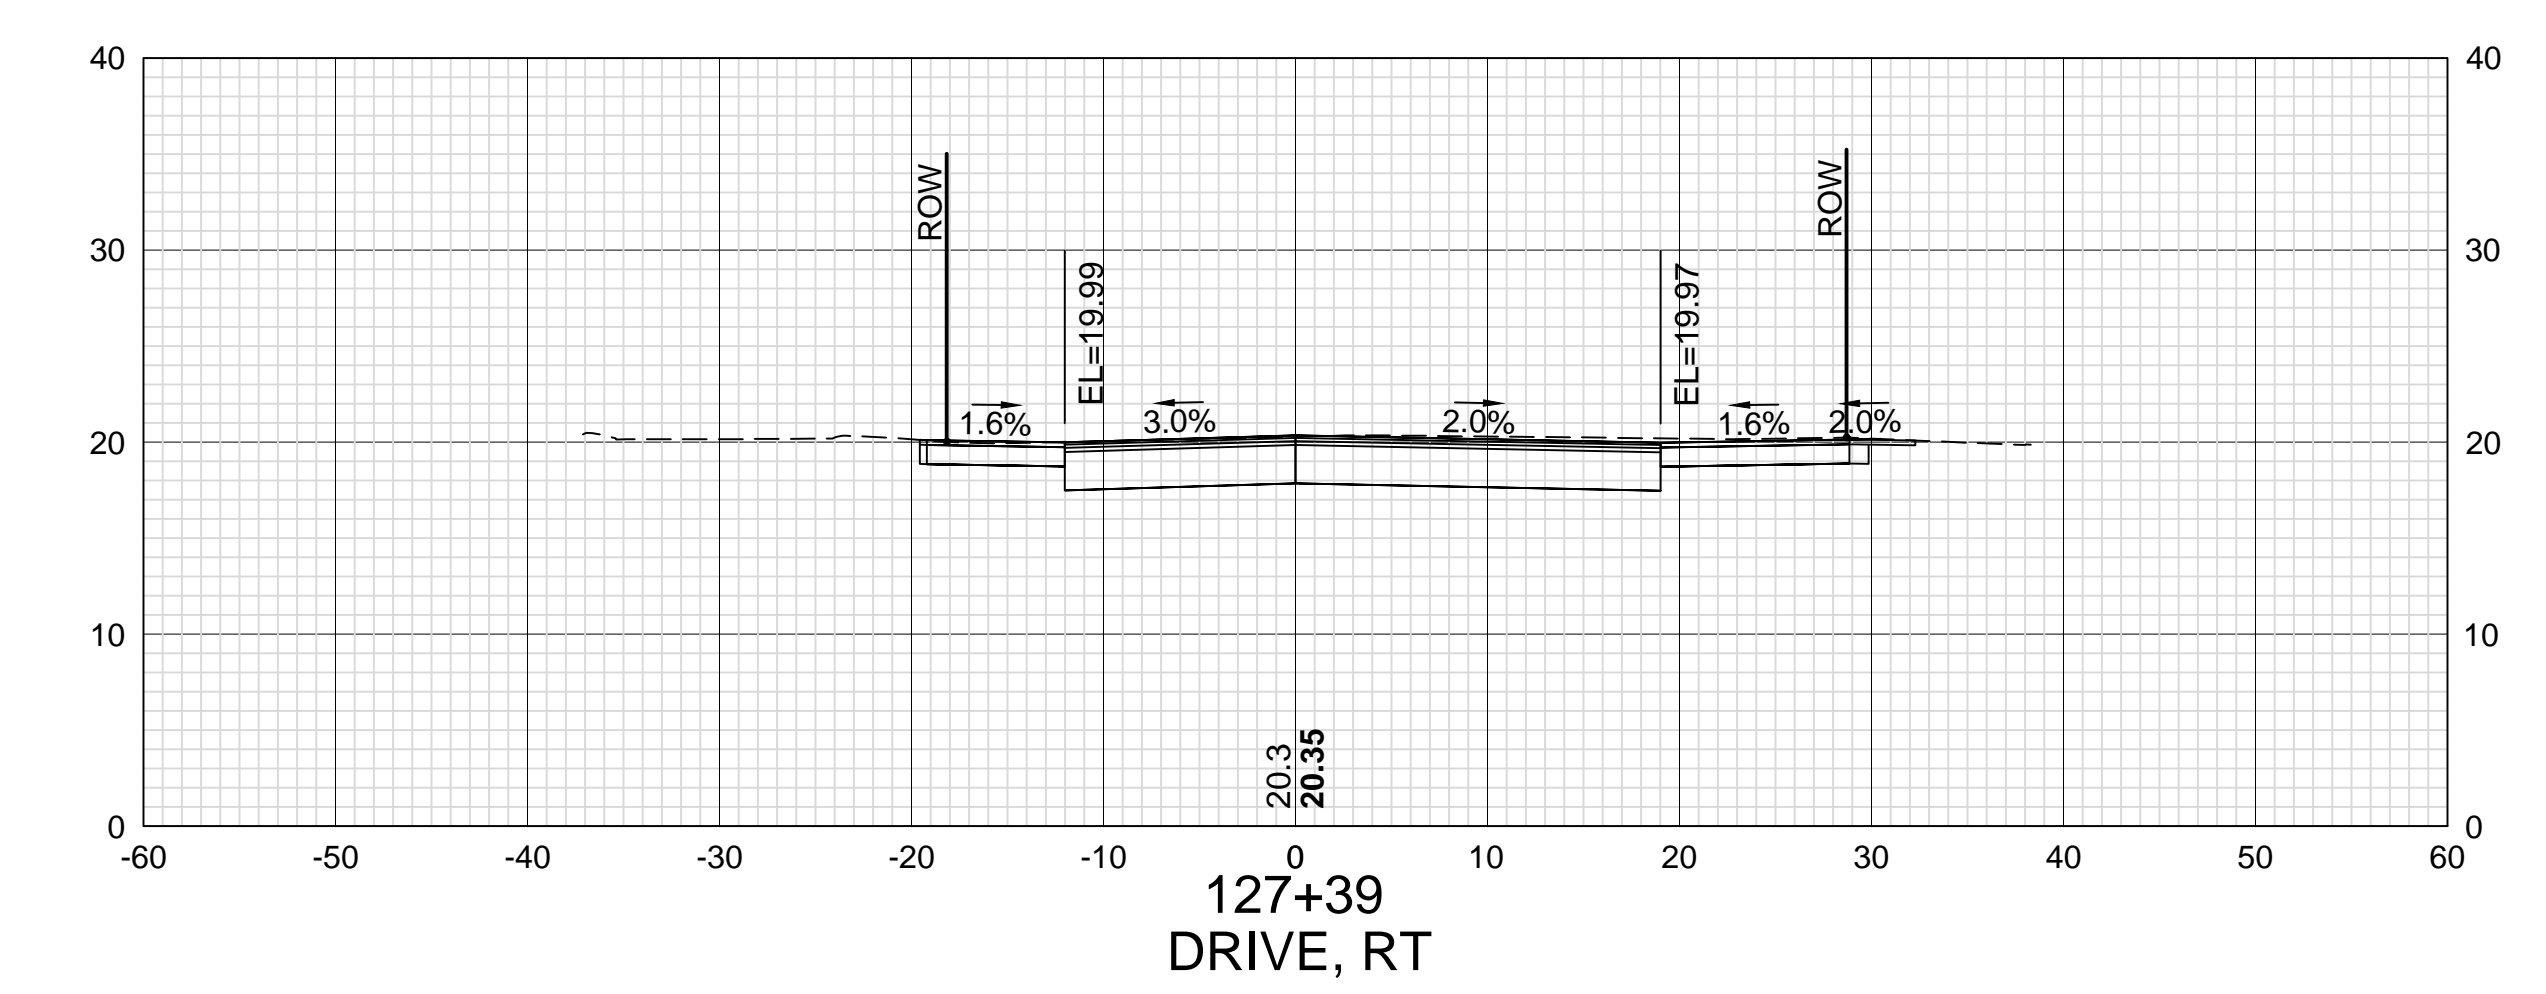
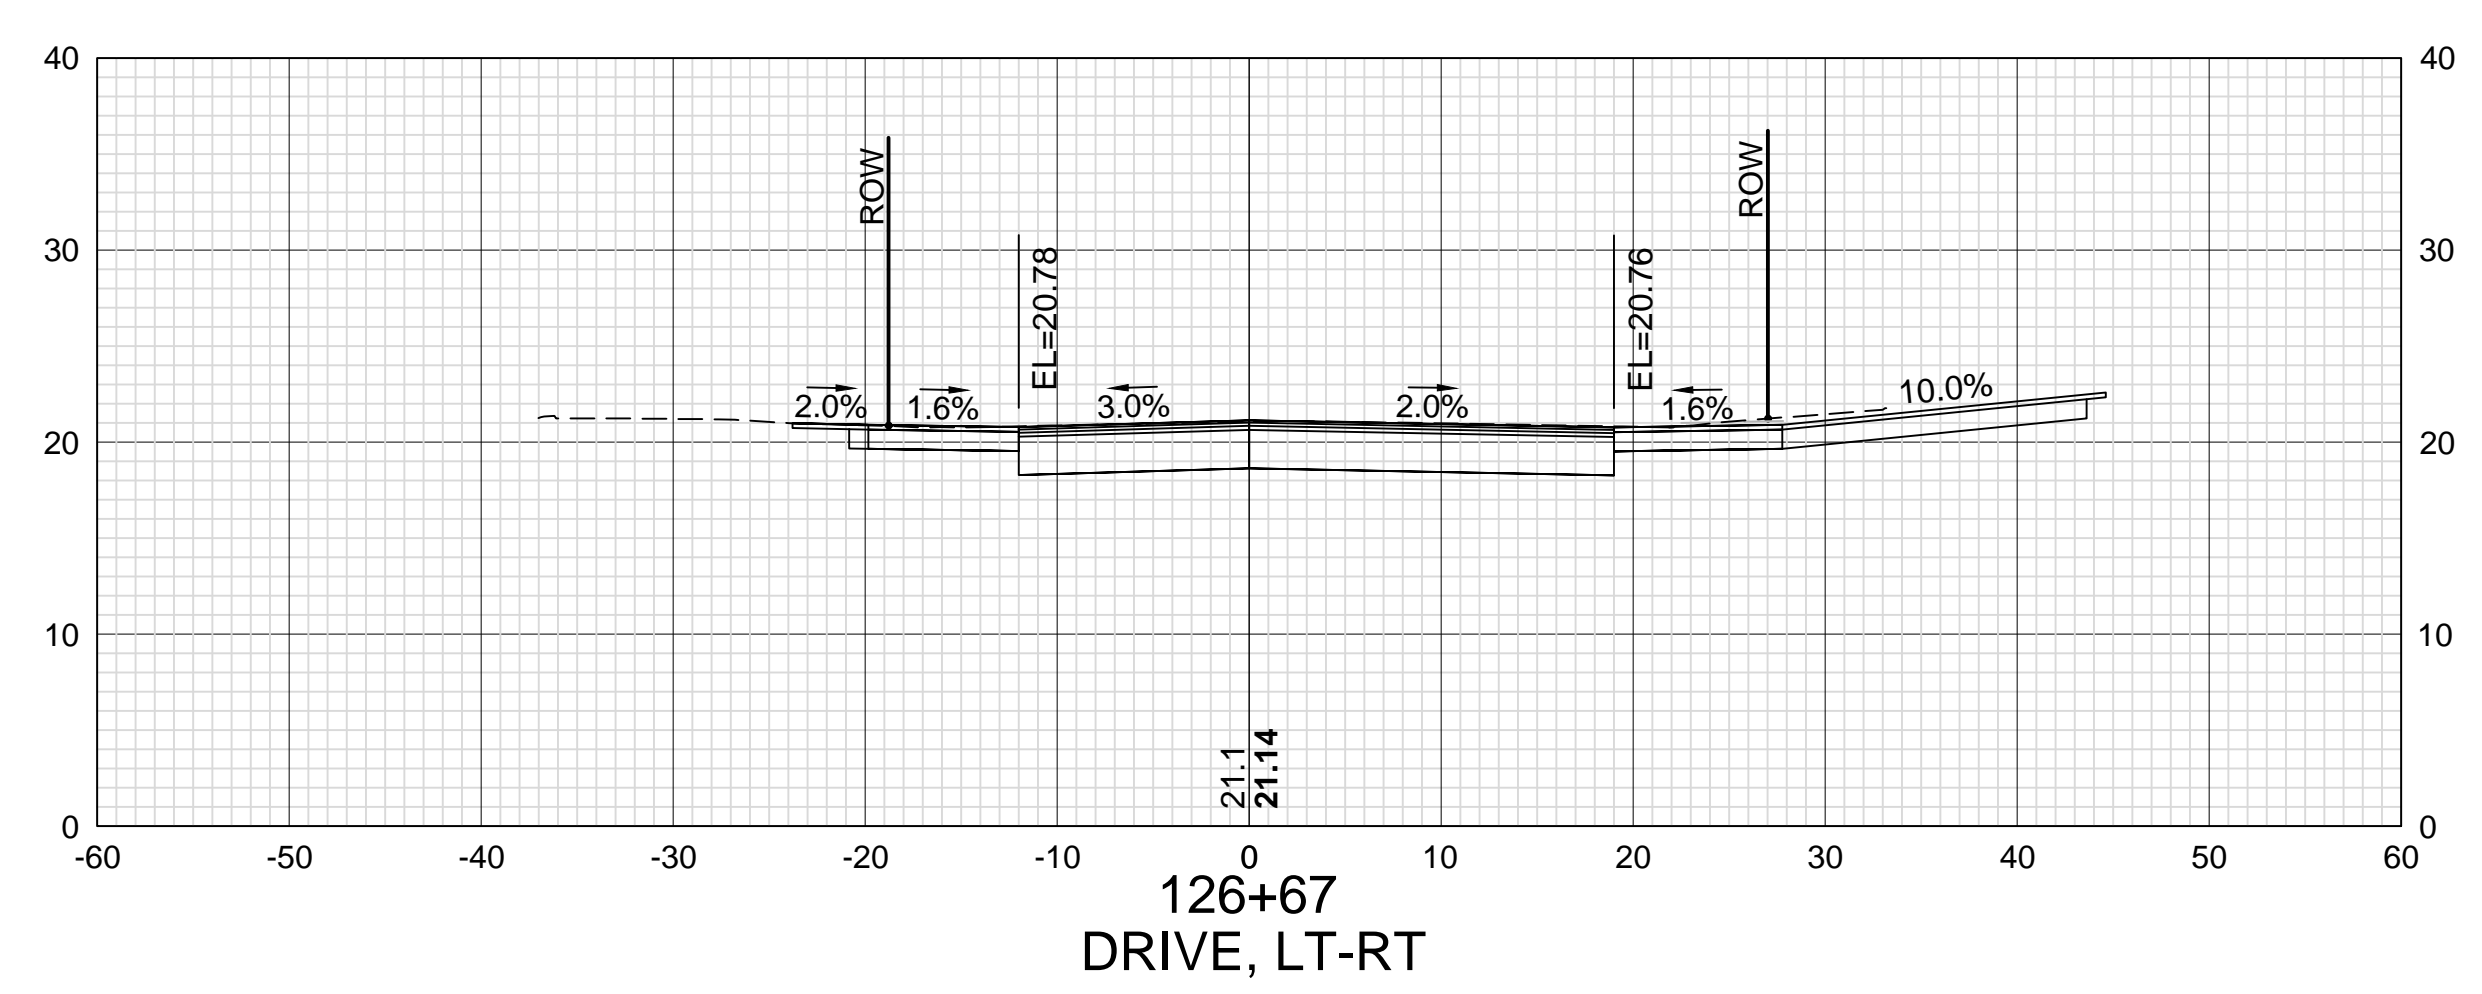
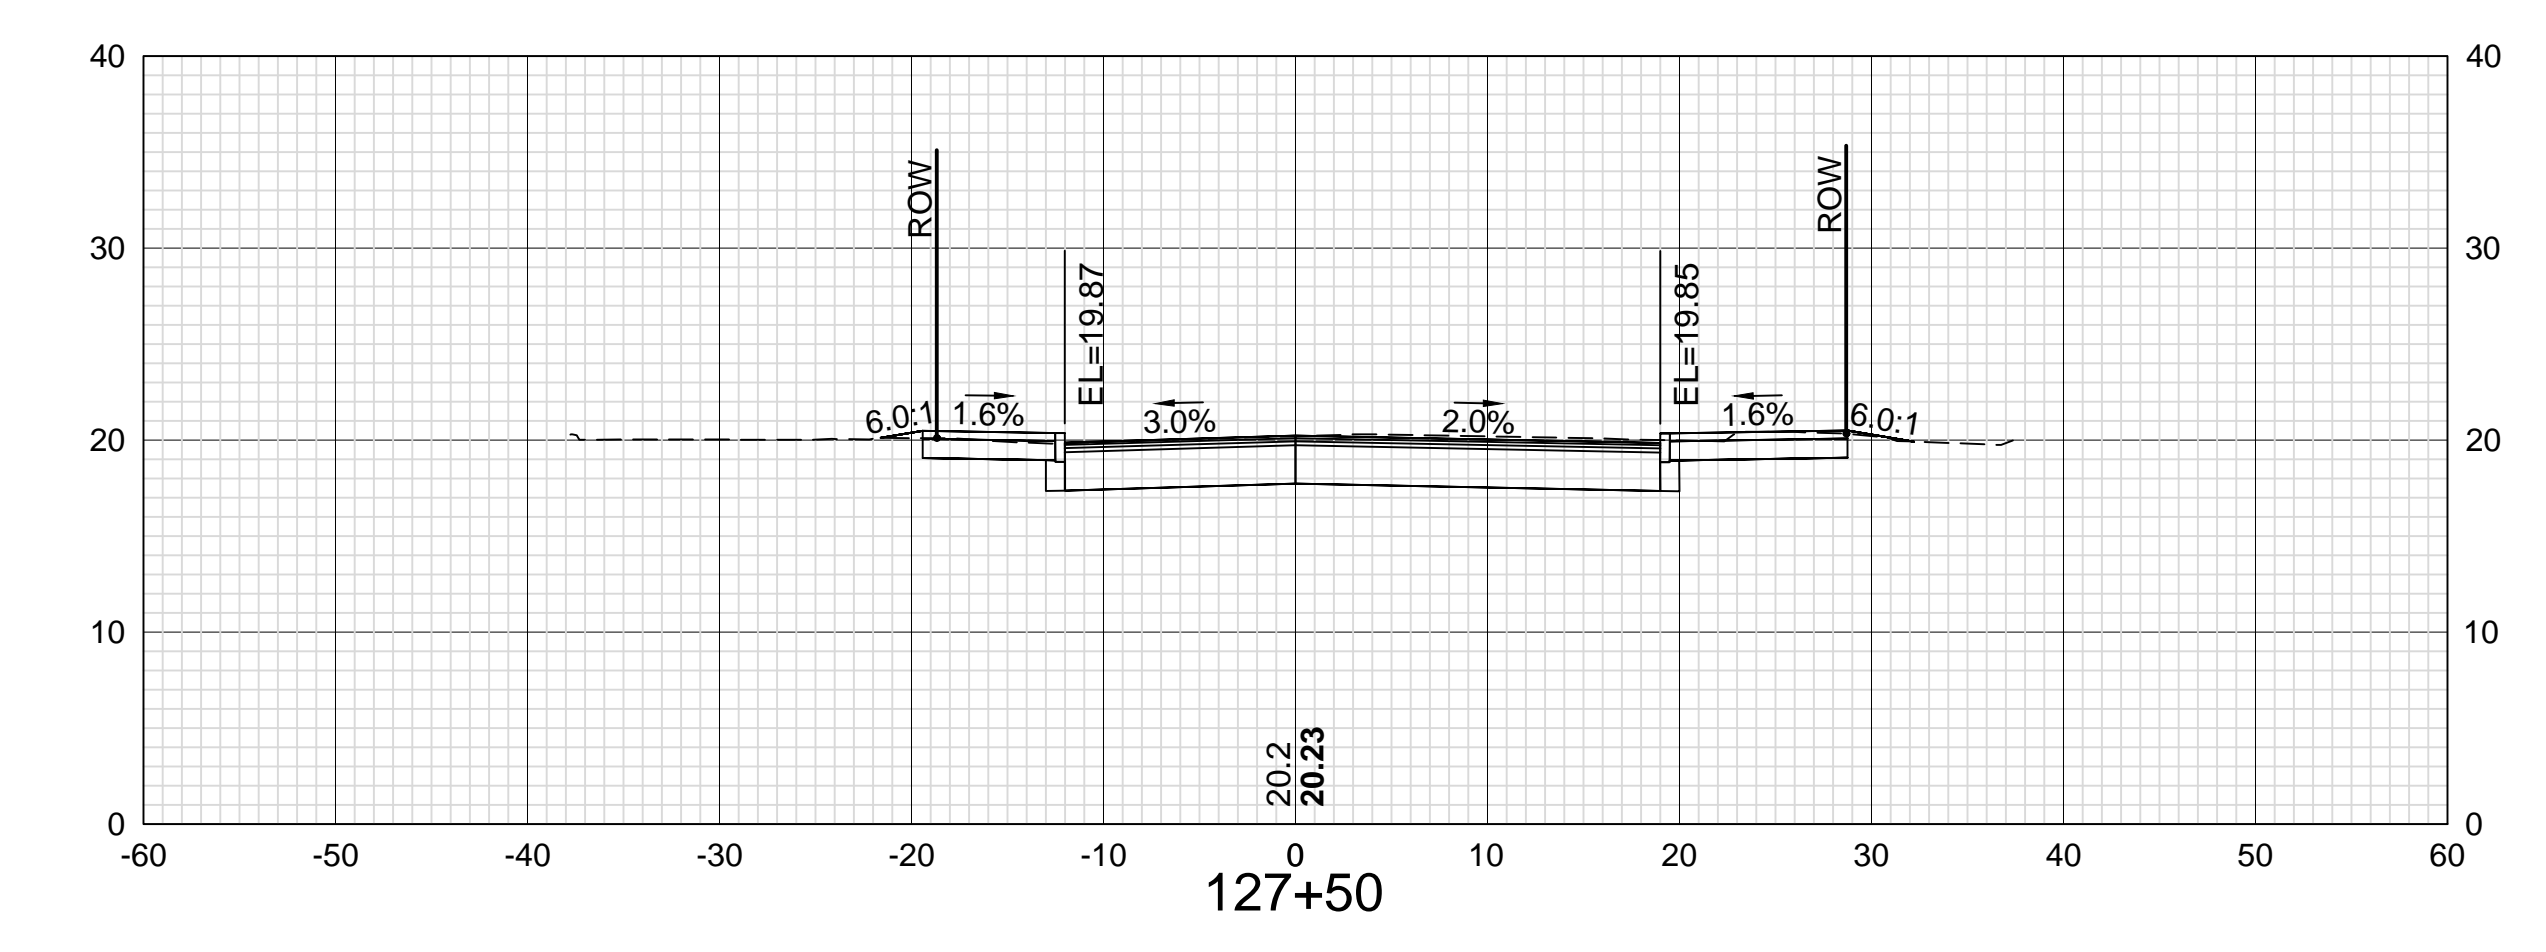
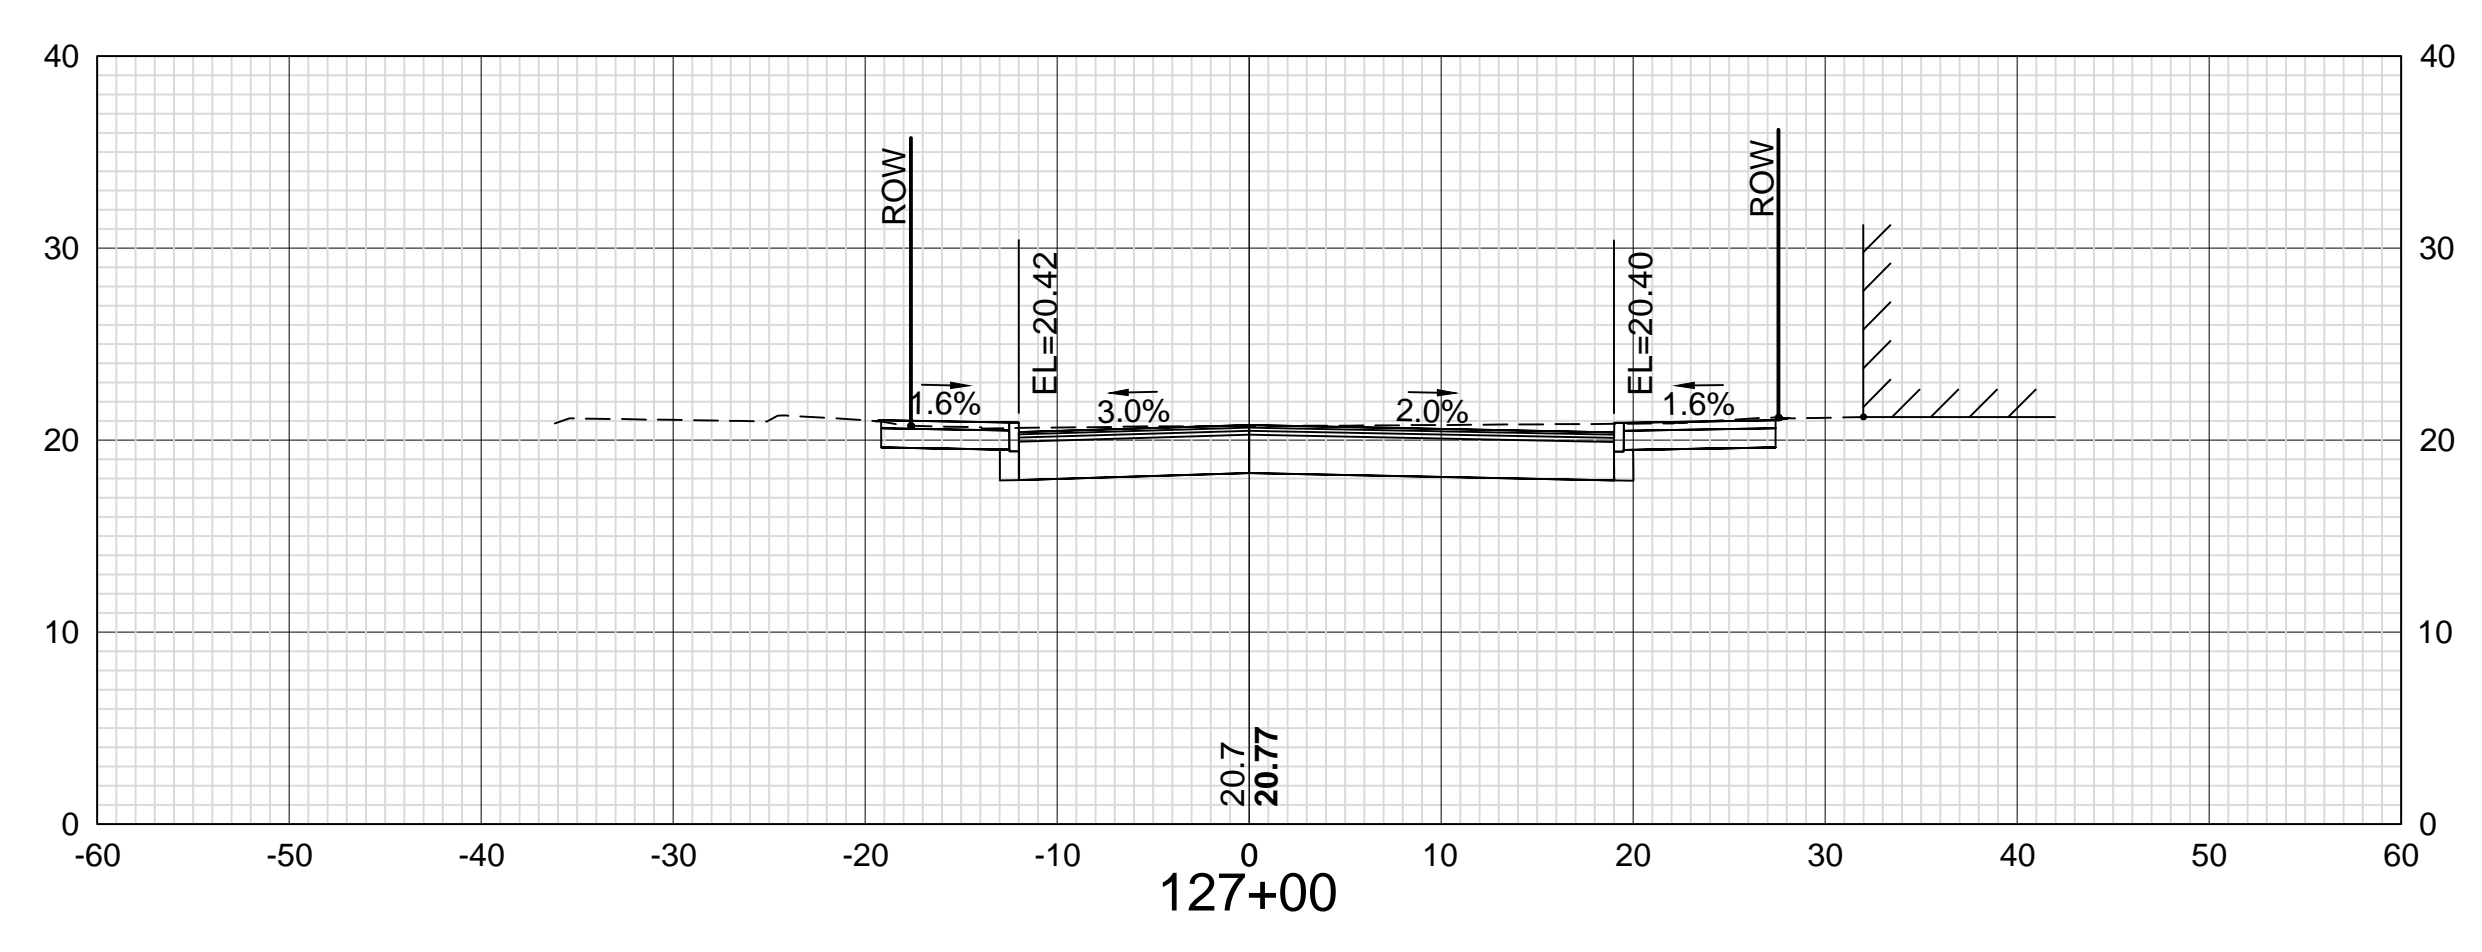
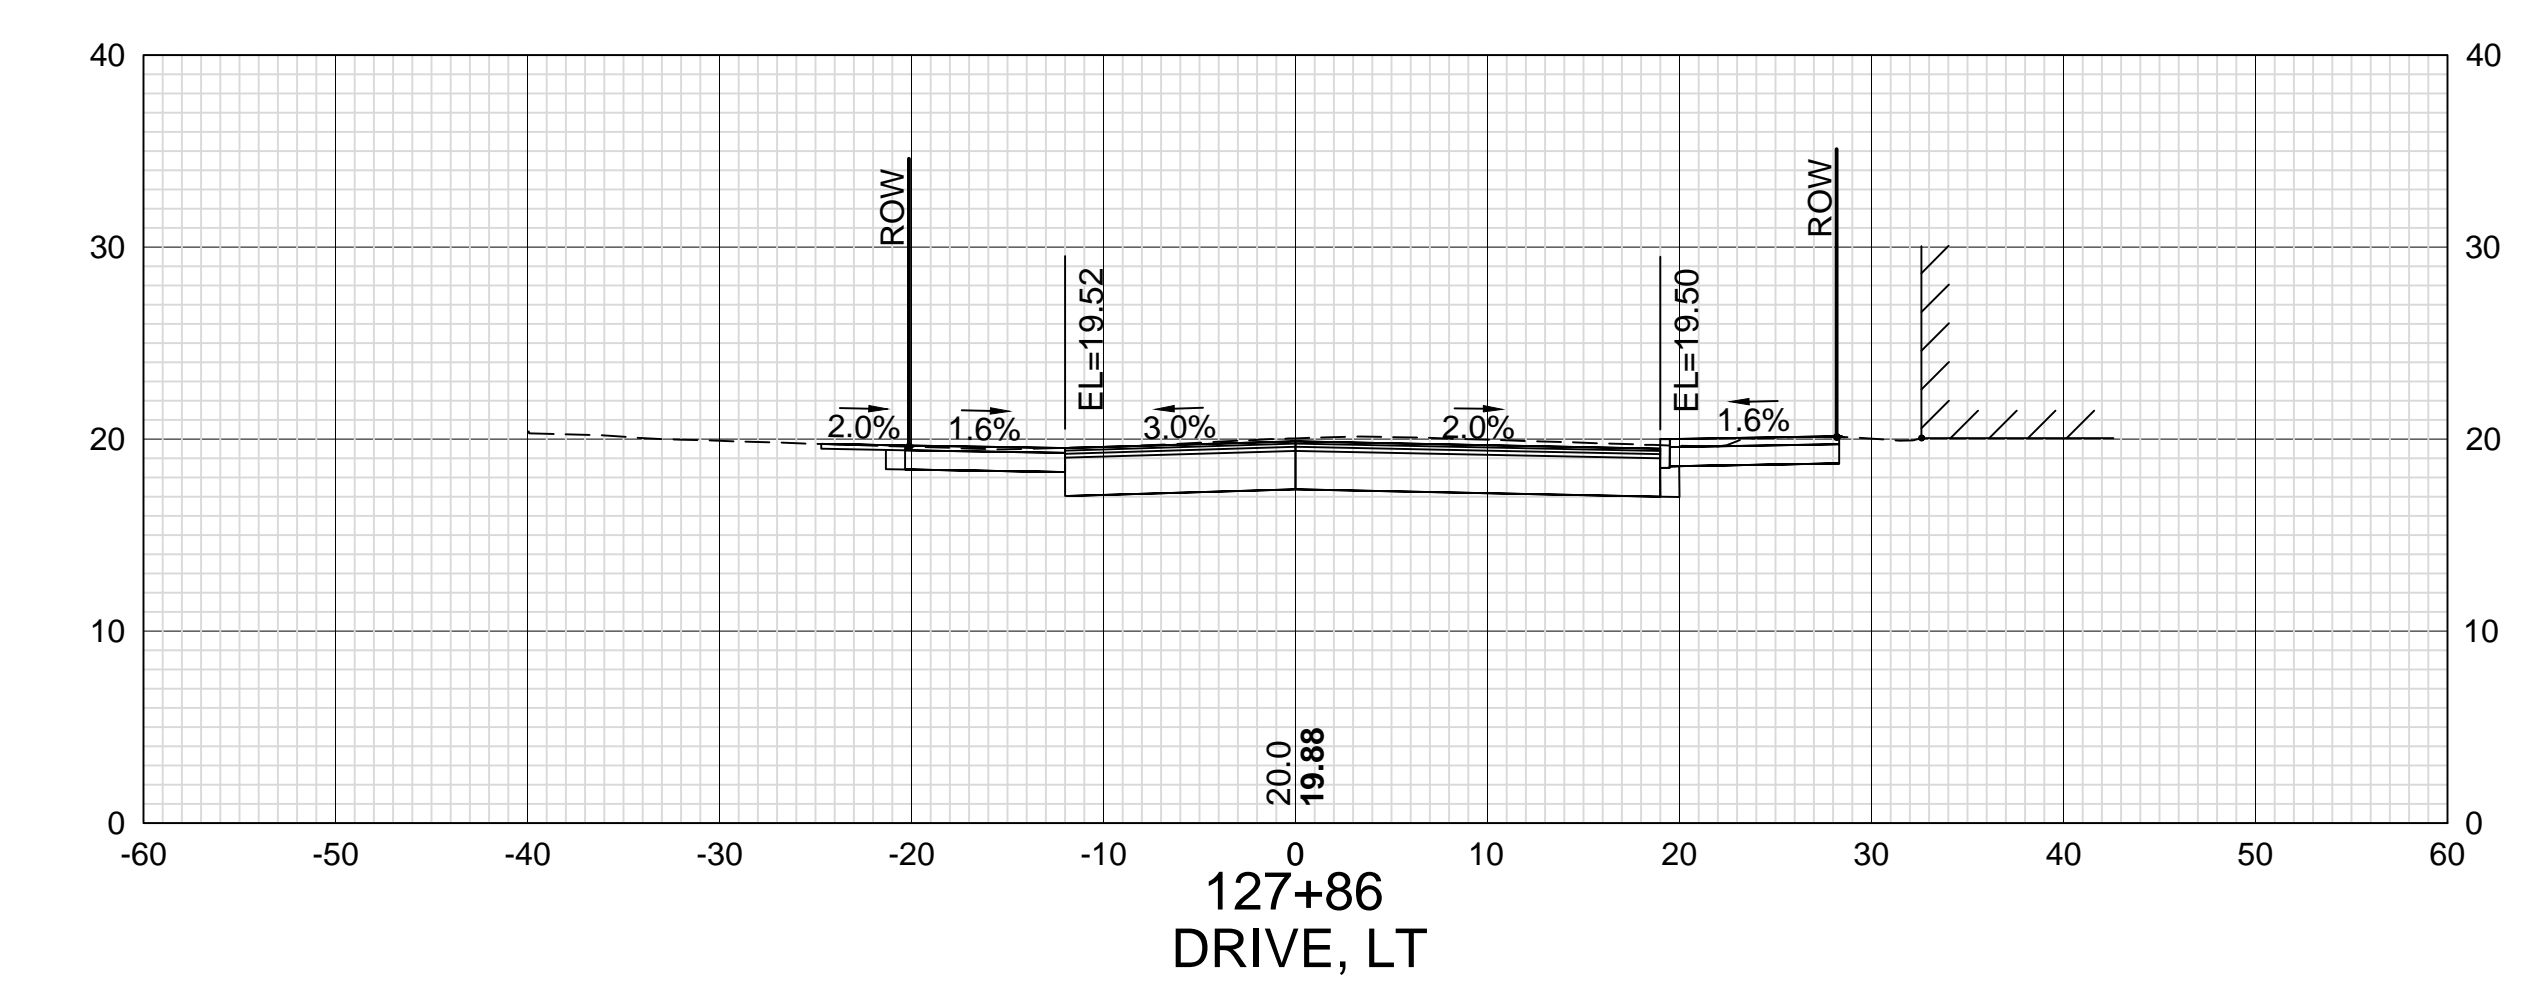
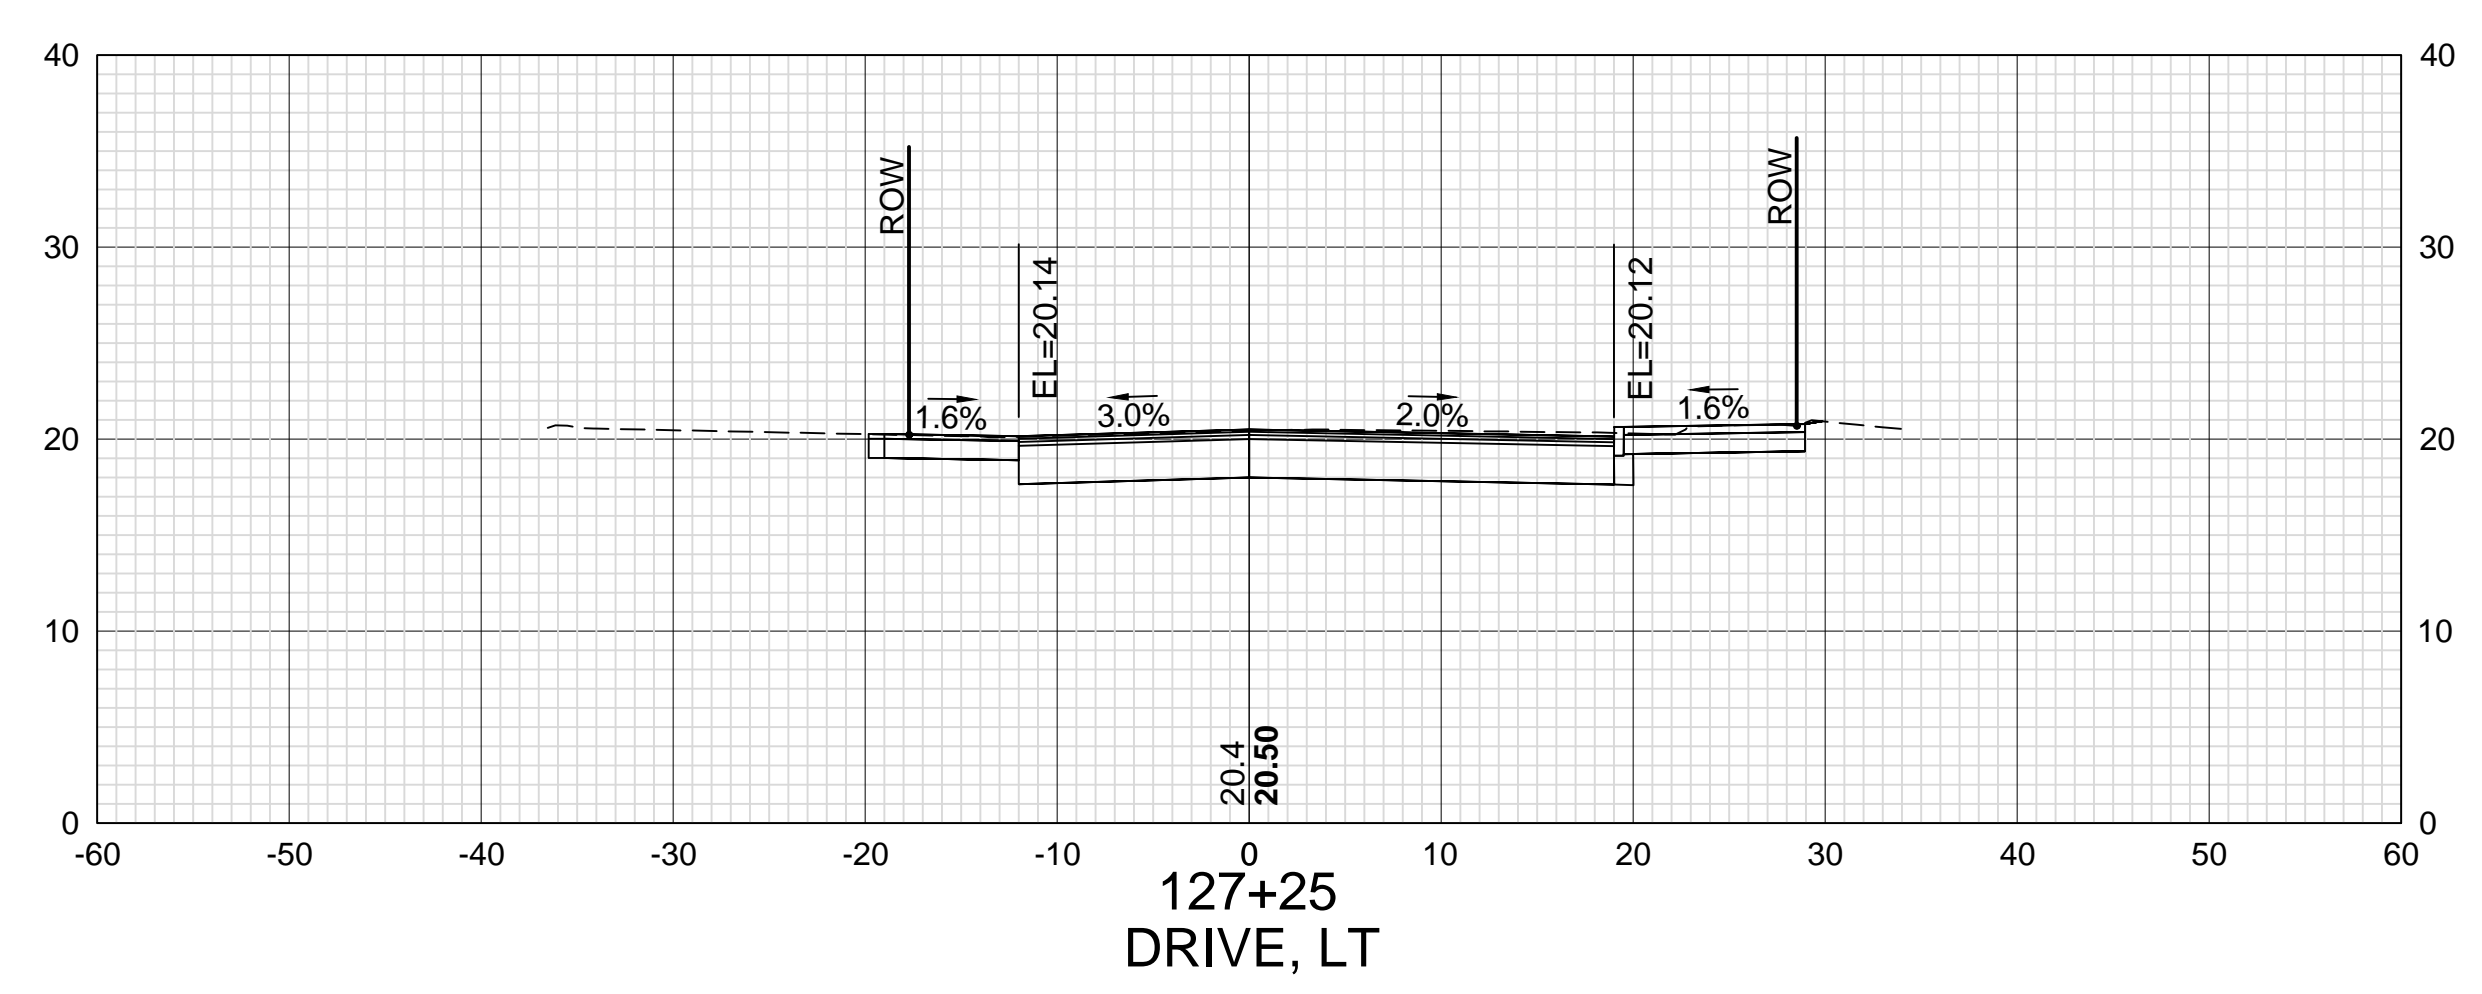
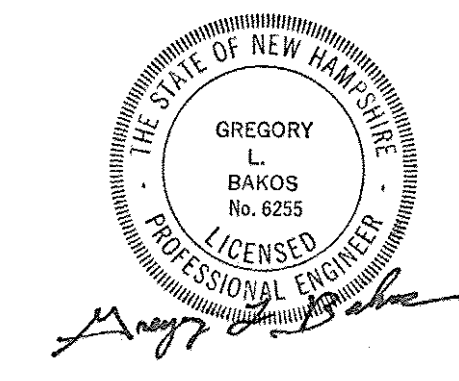


DATE PLOTTED	VHB PROJECT NO.
13-Nov-18	52393.00

ISLINGTON STREET CORRIDOR IMPROVEMENTS - SEGMENT 1			
CITY OF PORTSMOUTH, NEW HAMPSHIRE			
CROSS SECTIONS			
ISLINGTON STREET			
DRAWING	CITY PROJECT NO.	SHEET NO.	TOTAL SHEETS
XS-Seg1	7176	66	88

REVISIONS AFTER PROPOSAL	STATION	DATE	NUMBER

SDR PROCESSED	VHB	DATE	OCT 2017
NEW DESIGN	KMH	DATE	11/13/18
SHEET CHECKED	GLB	DATE	11/13/18
AS BUILT DETAILS		DATE	

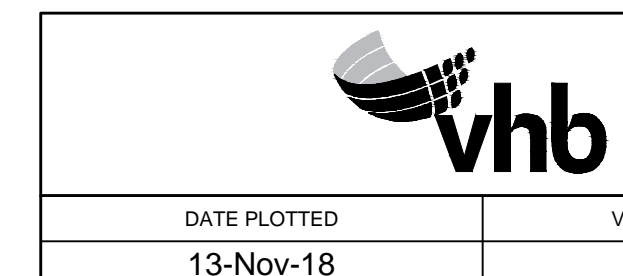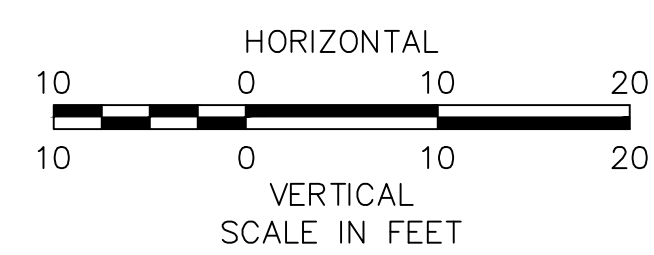
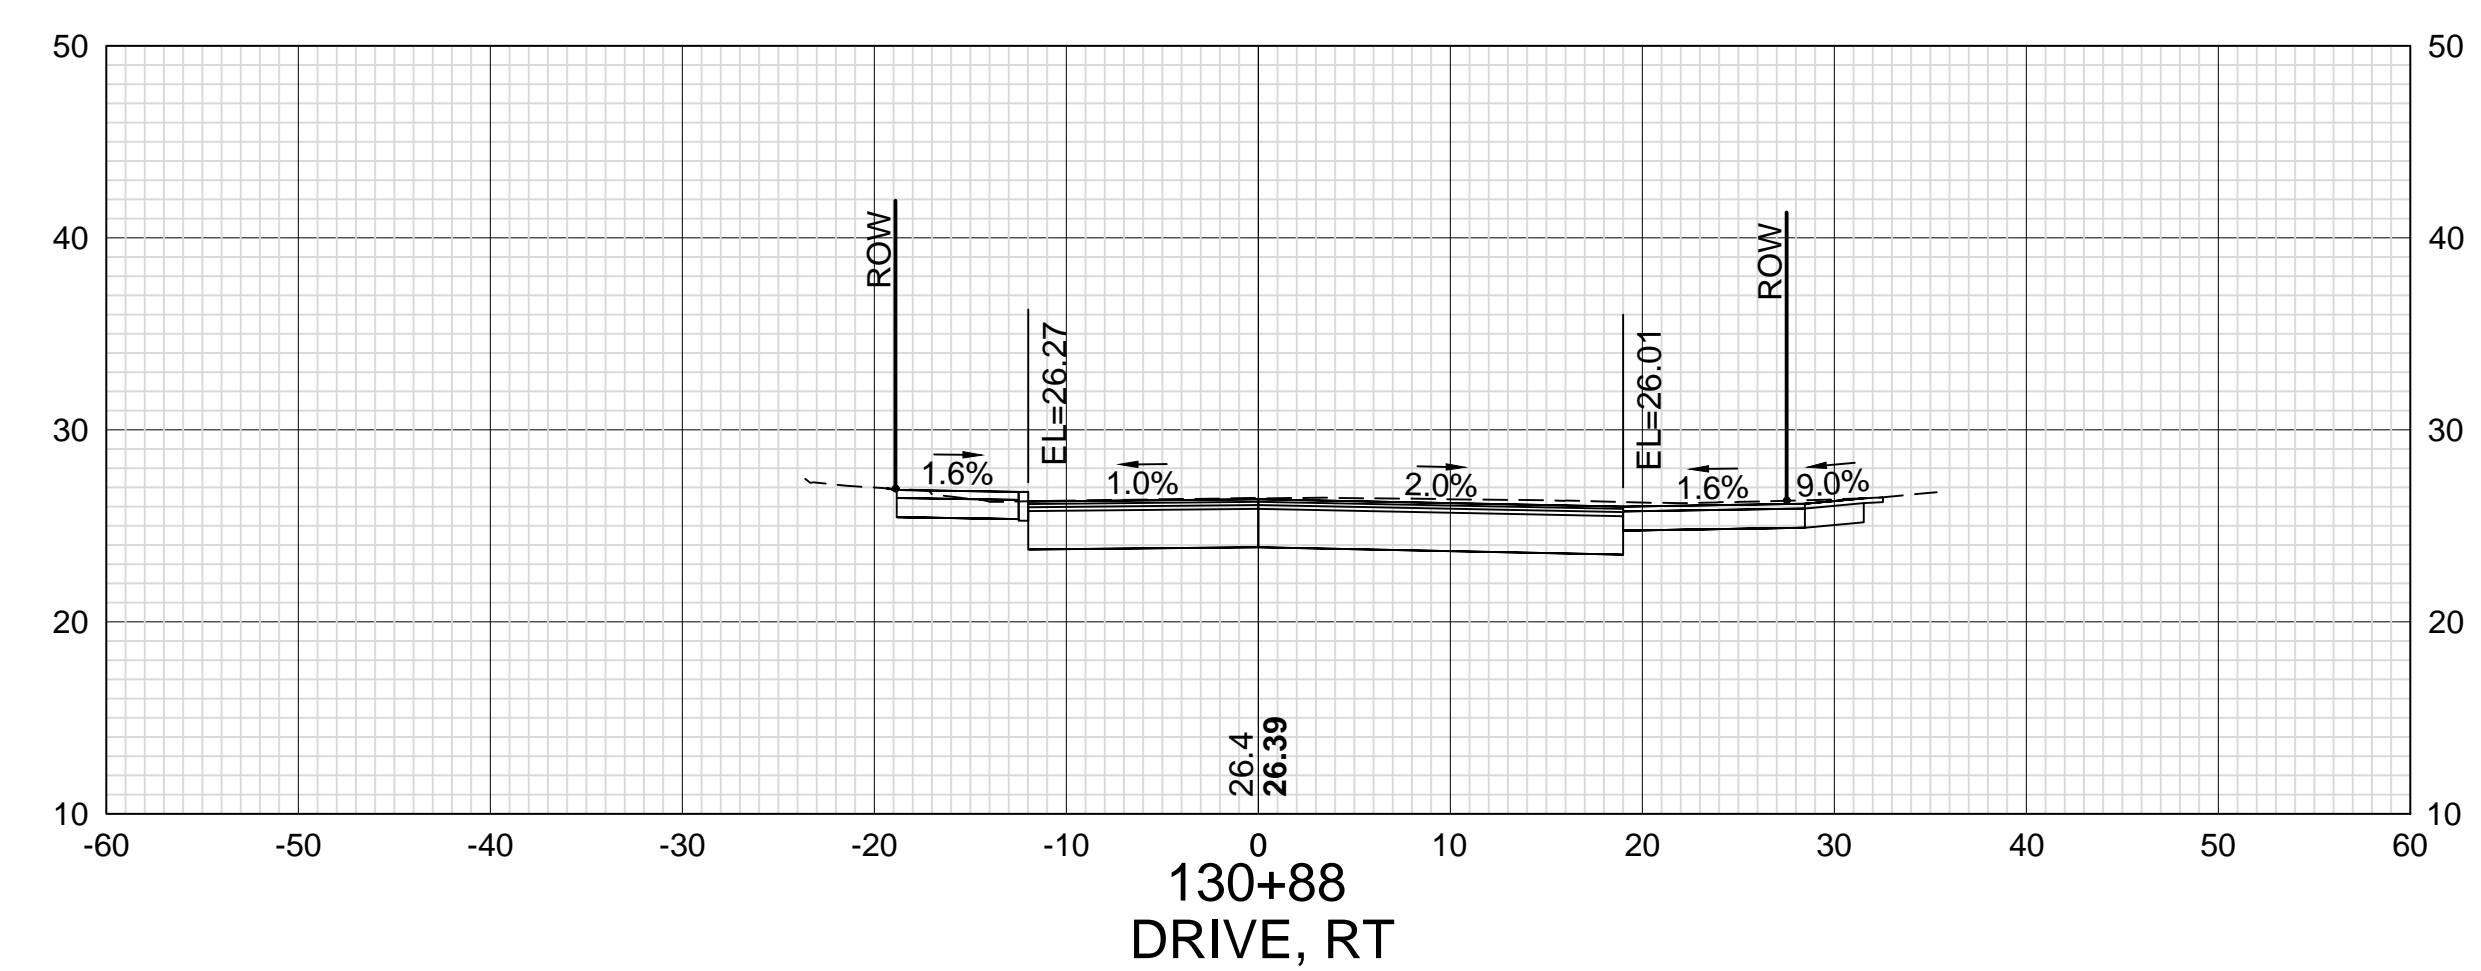
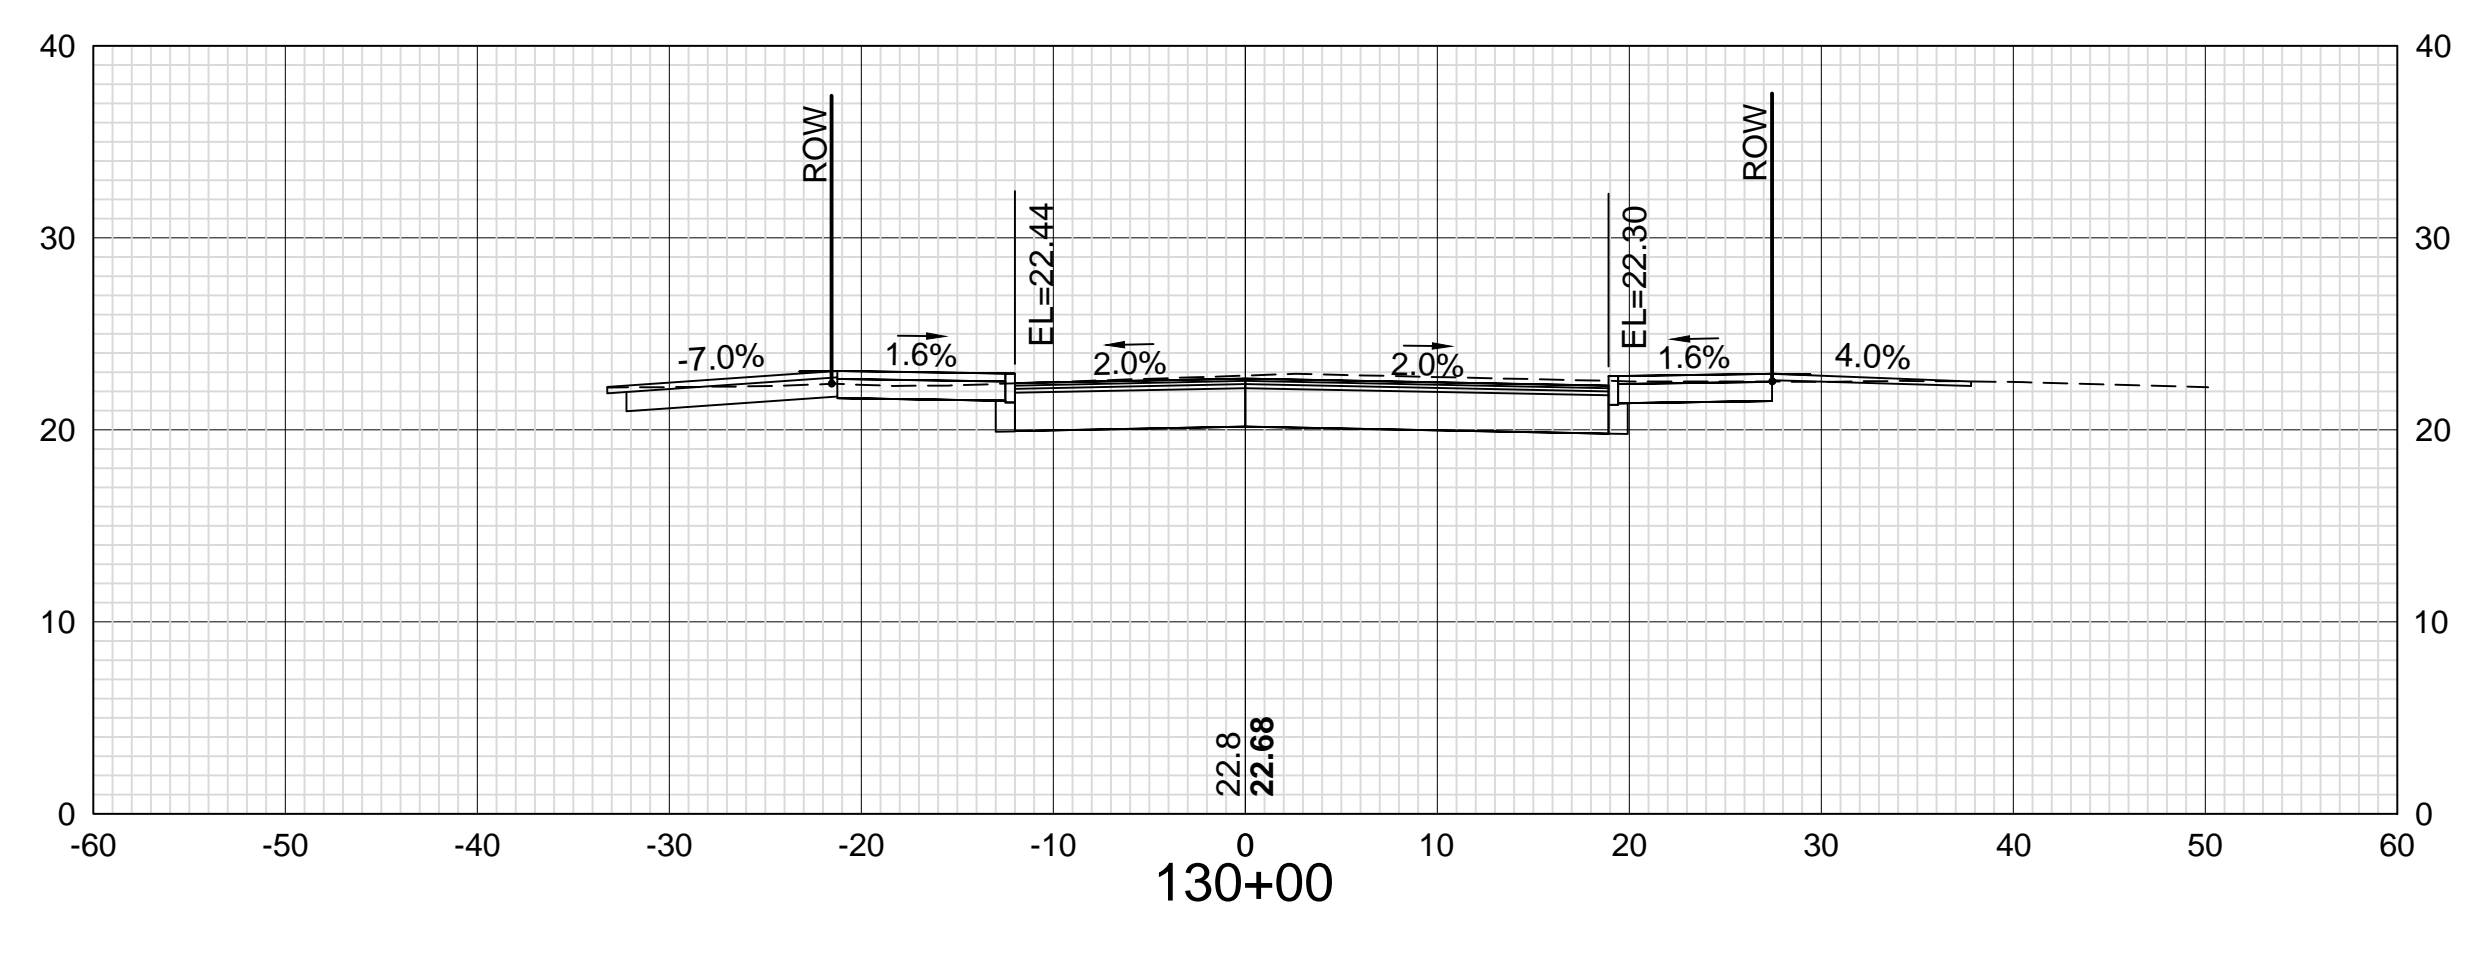
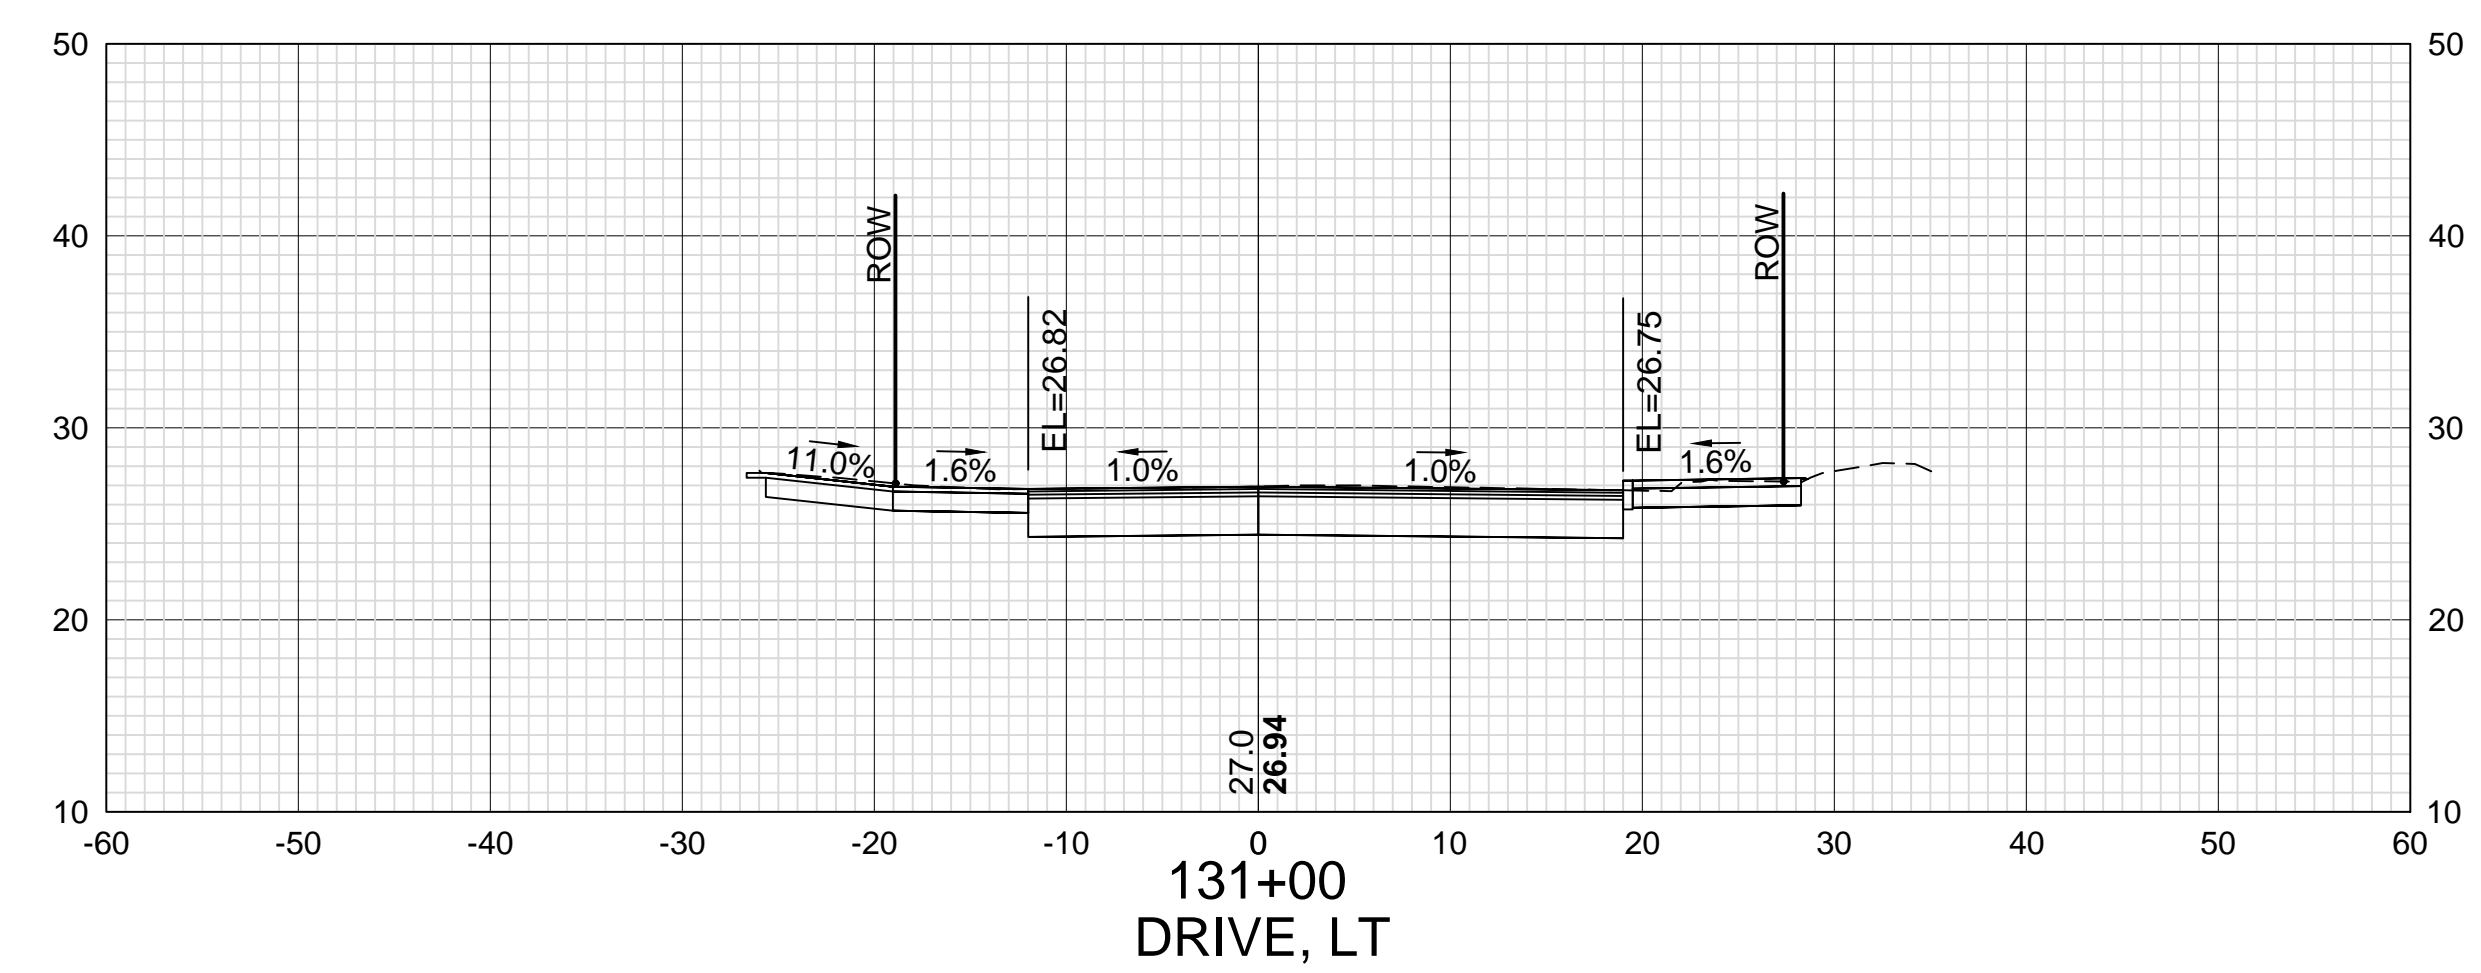
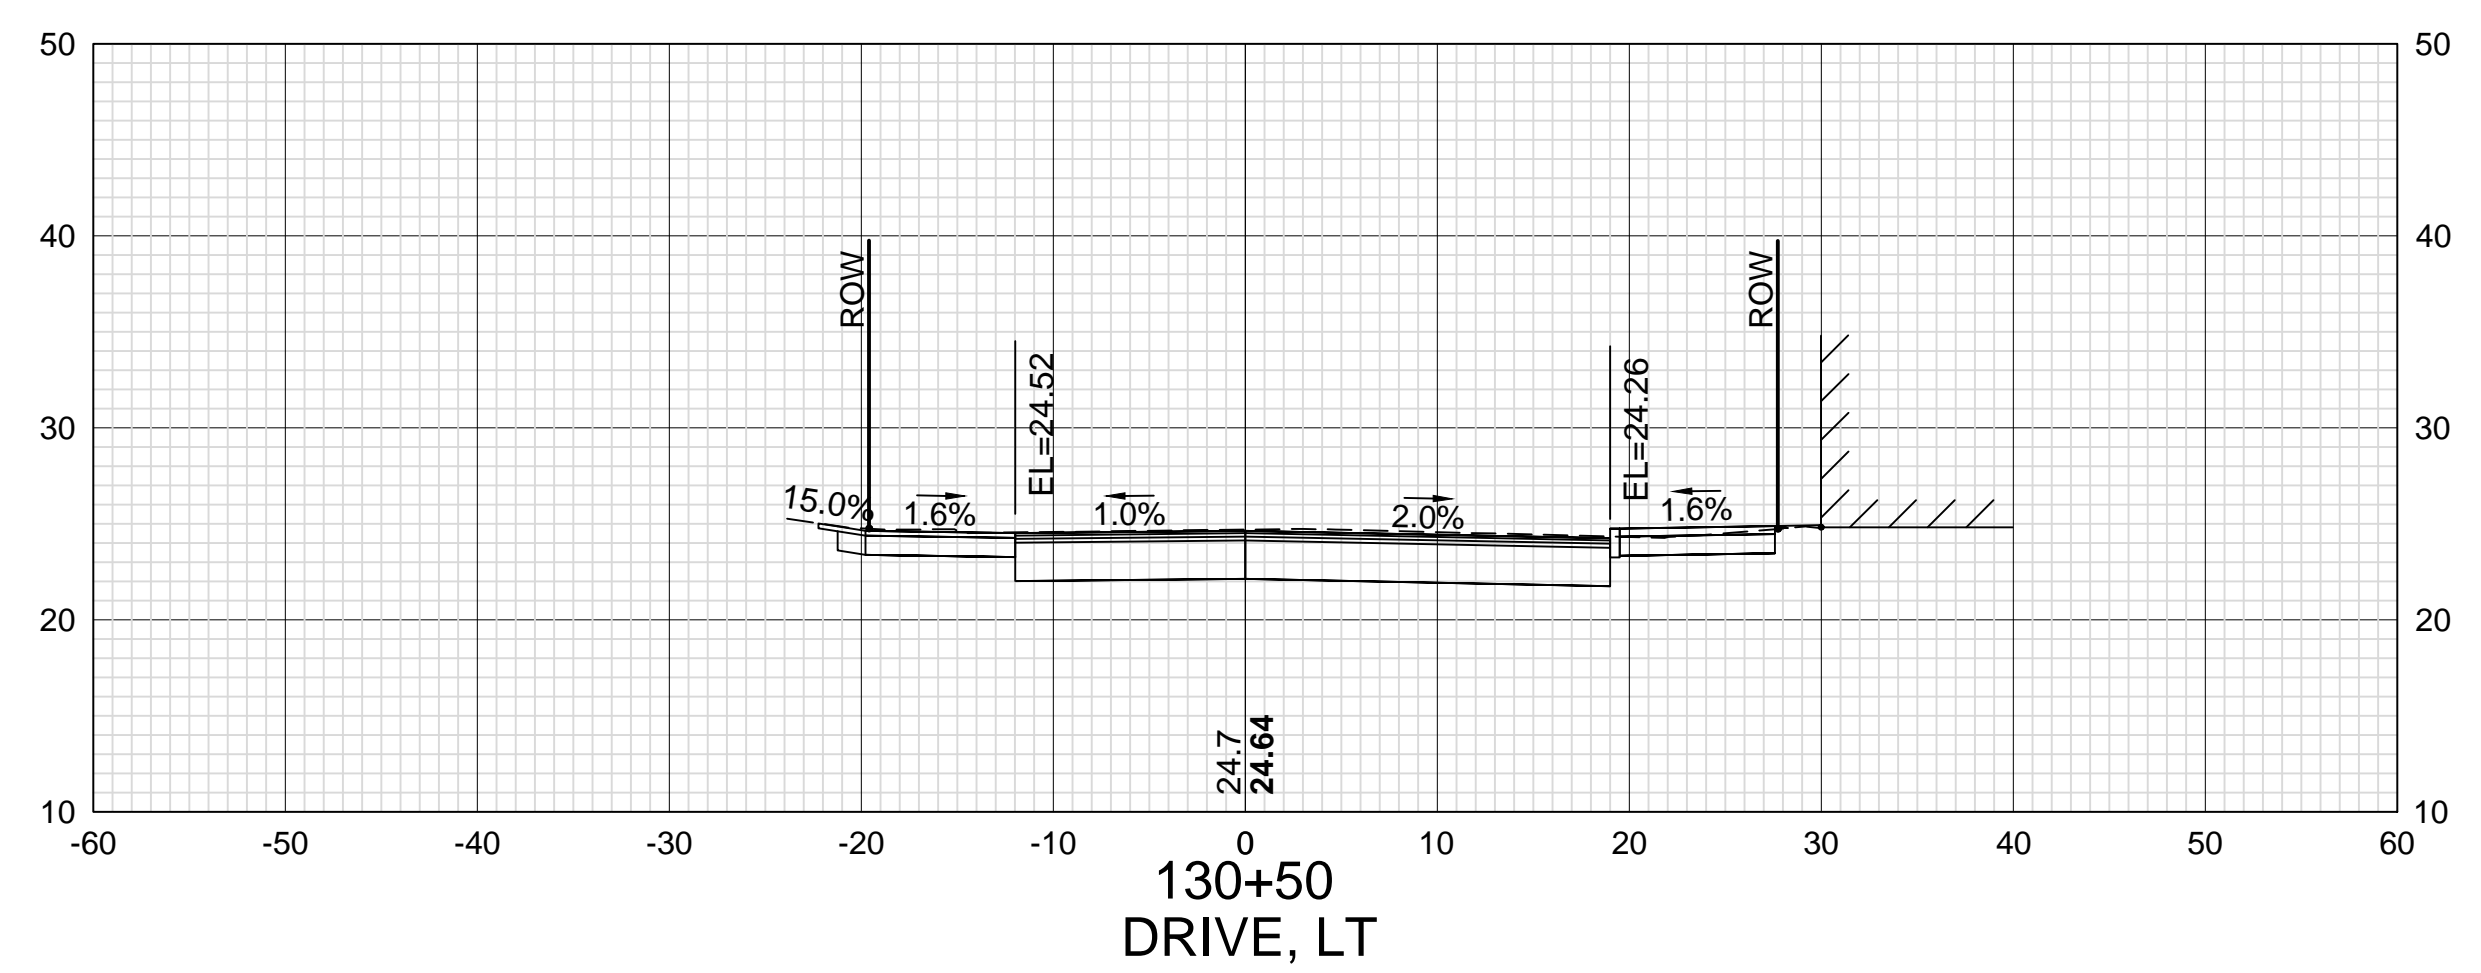
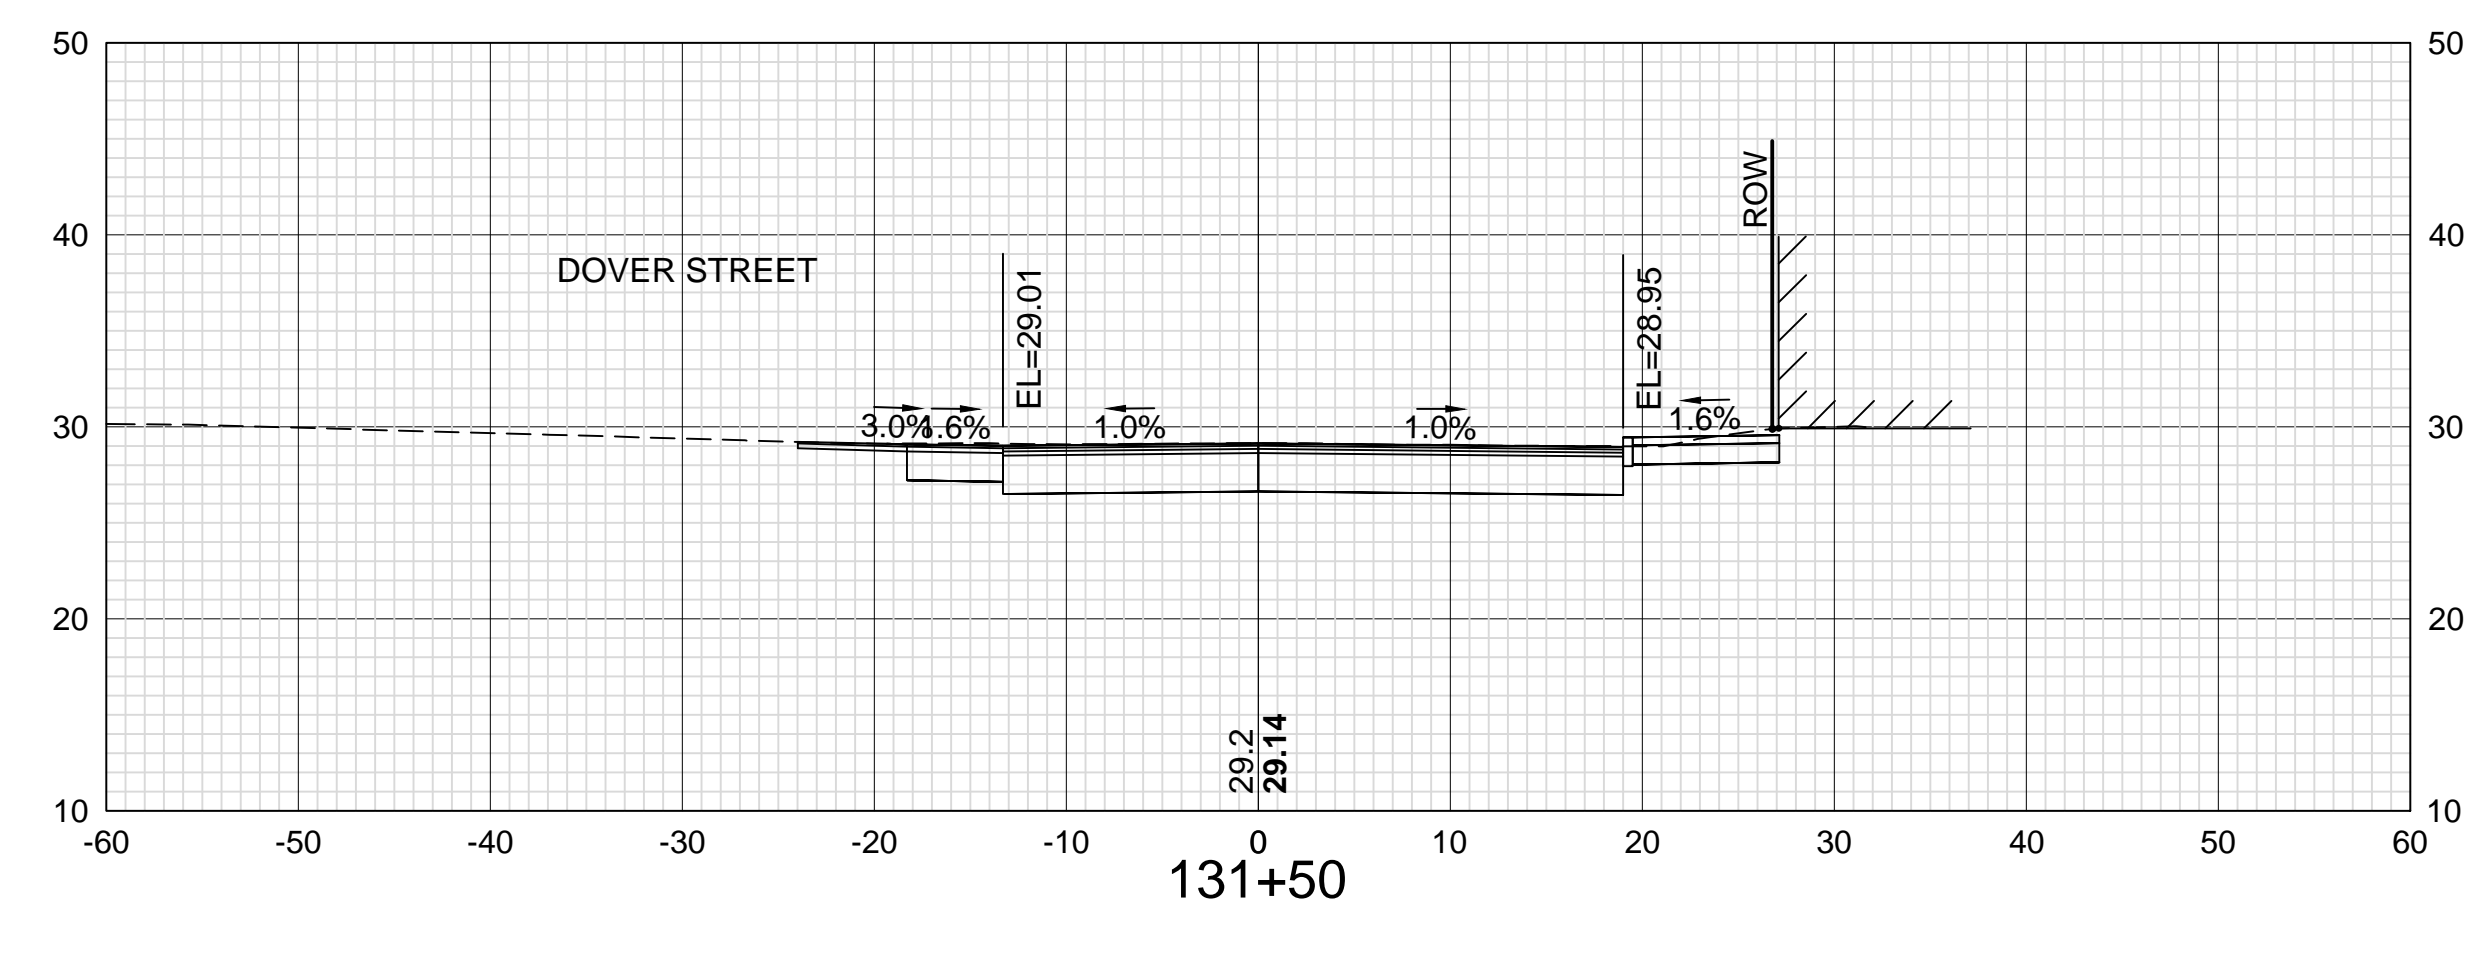
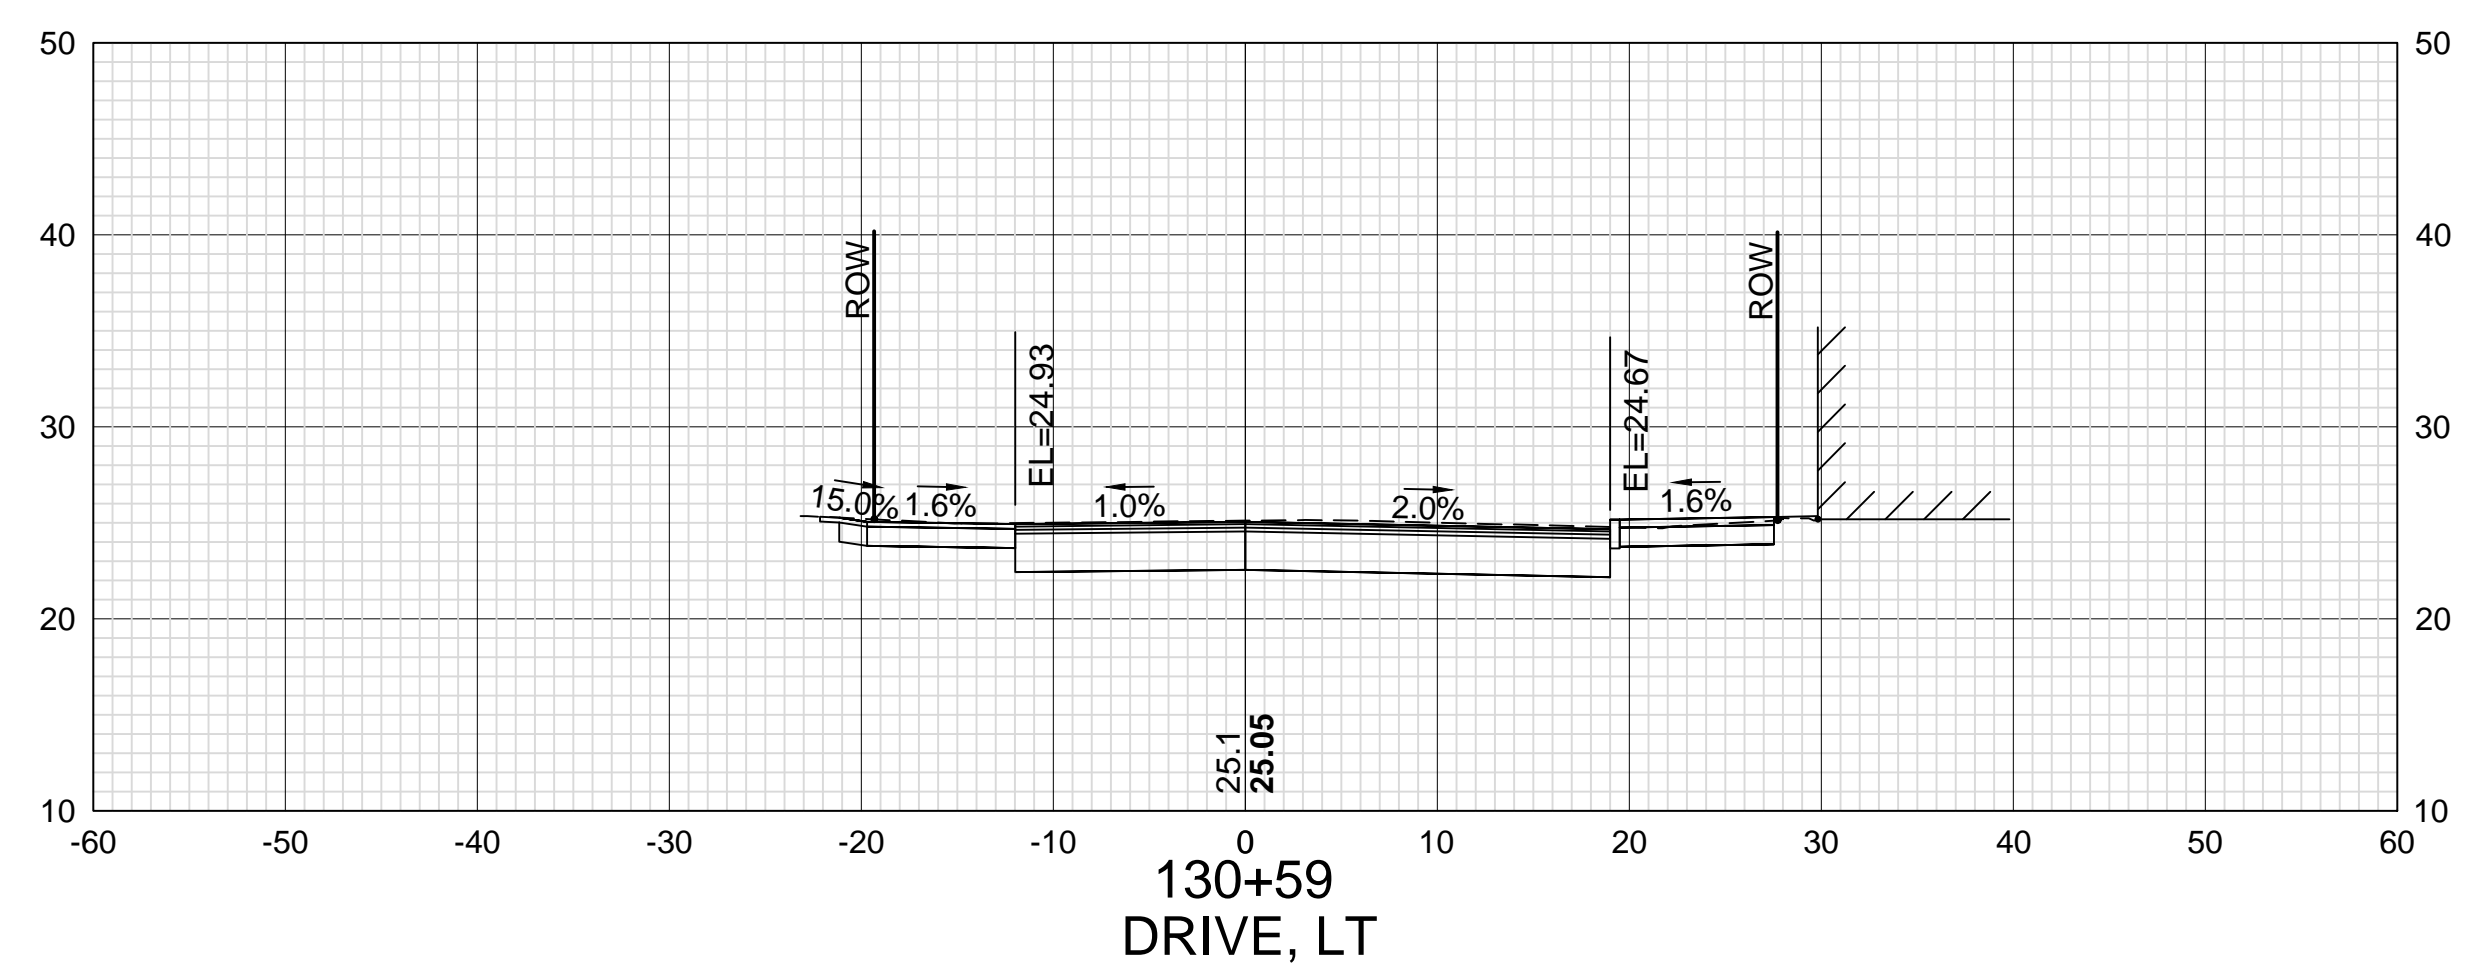
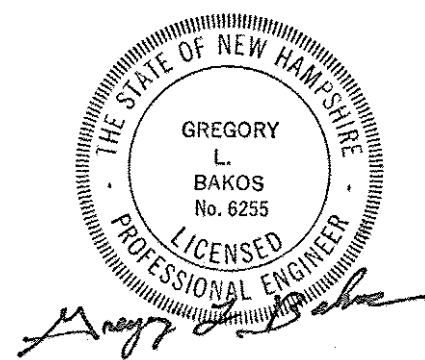


DATE PLOTTED	VHB PROJECT NO.
13-Nov-18	52393.00

ISLINGTON STREET CORRIDOR IMPROVEMENTS - SEGMENT 1			
CITY OF PORTSMOUTH, NEW HAMPSHIRE			
CROSS SECTIONS			
ISLINGTON STREET			
DRAWING	CITY PROJECT NO.	SHEET NO.	TOTAL SHEETS
XS-Seg1	7176	68	88

REVISIONS AFTER PROPOSAL	DESCRIPTION
STATION	
STATION	
DATE	
NUMBER	

SDR PROCESSED	VHB	DATE	OCT 2017
NEW DESIGN	KMH	DATE	11/13/18
SHEET CHECKED	GLB	DATE	11/13/18
AS BUILT DETAILS		DATE	

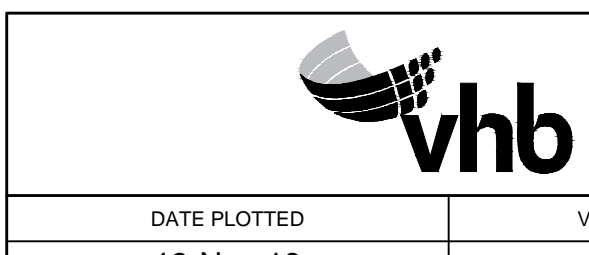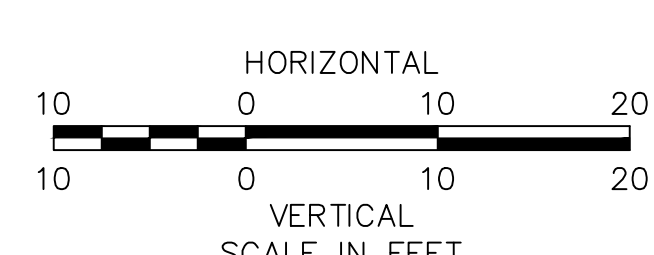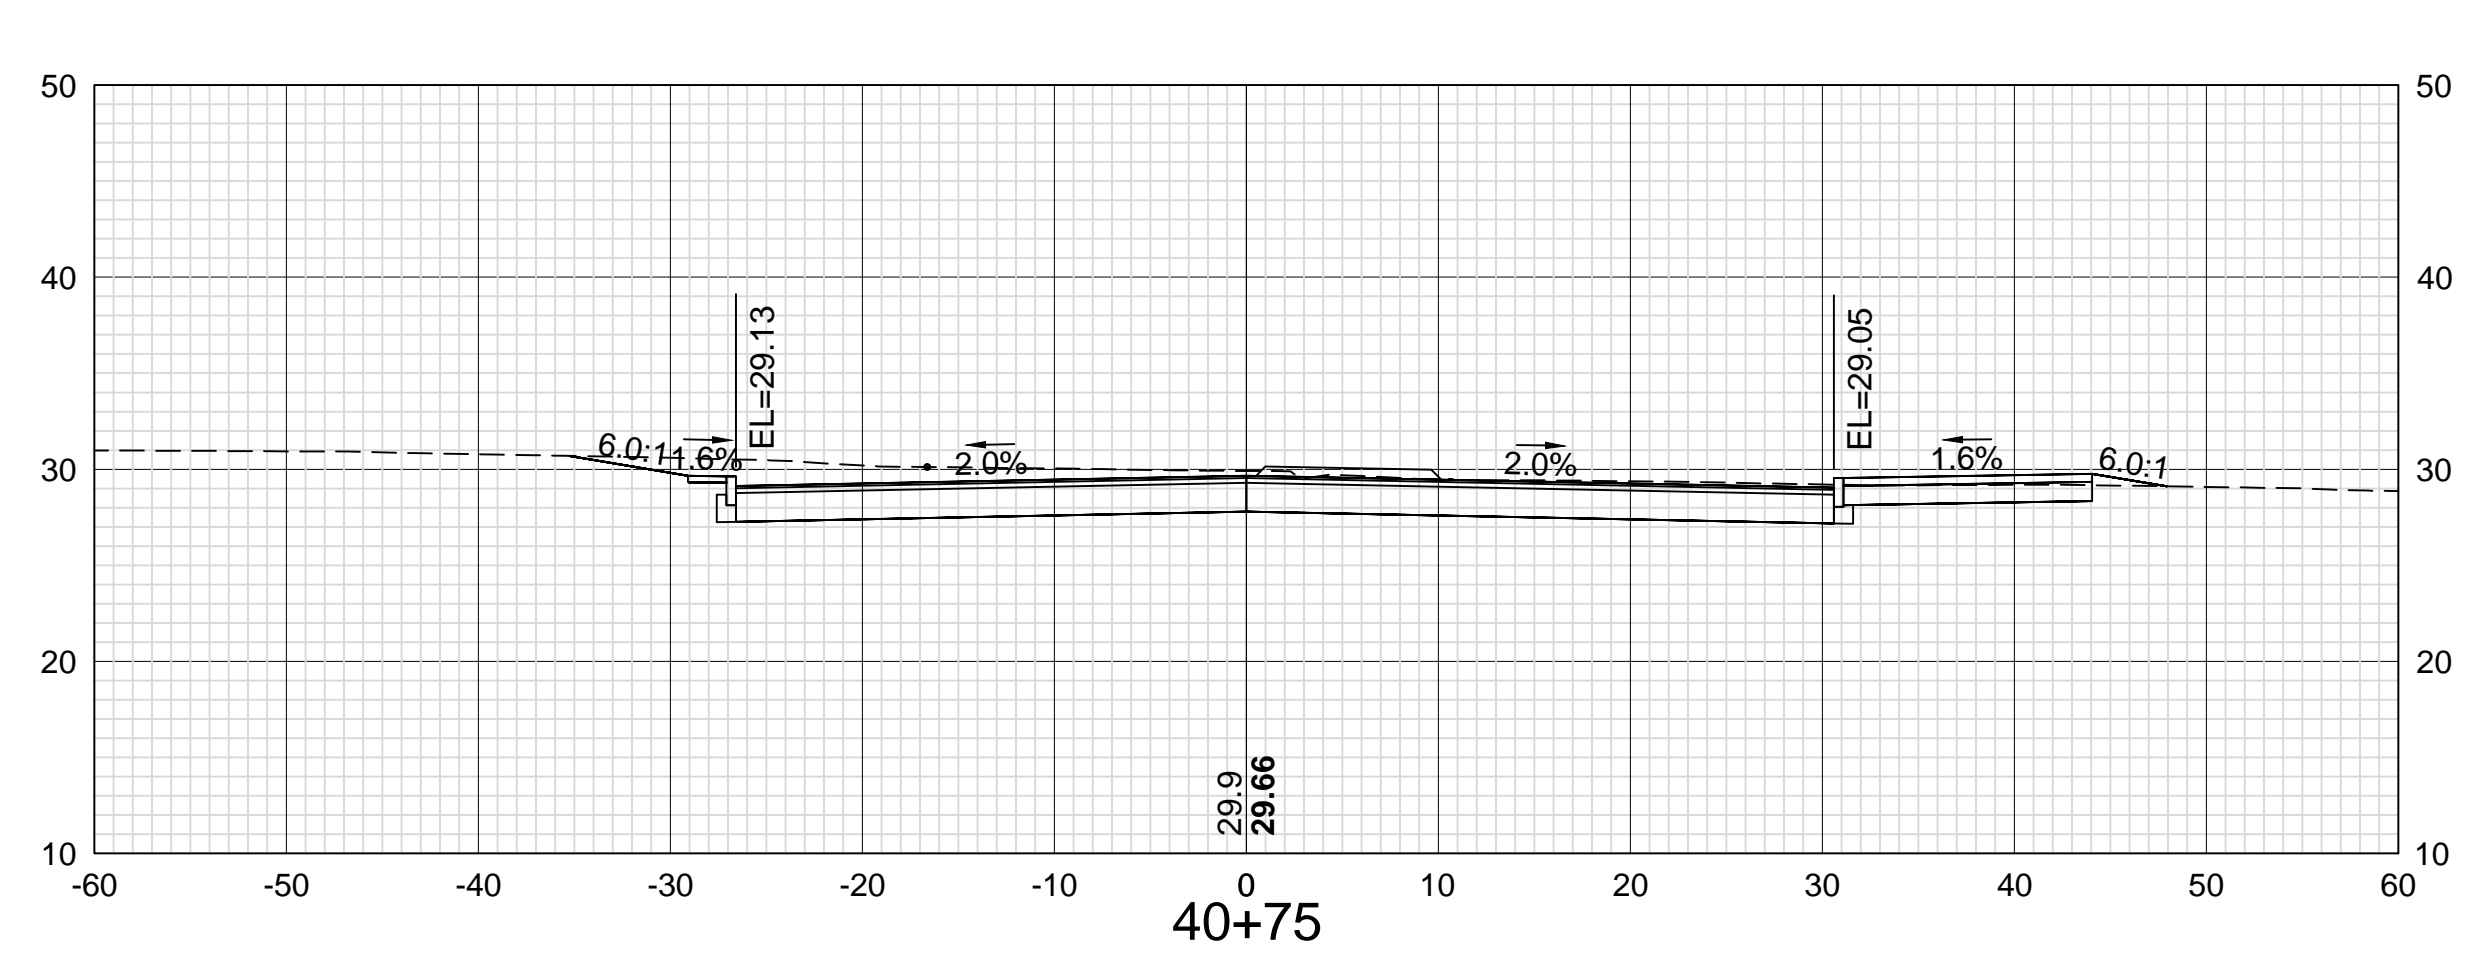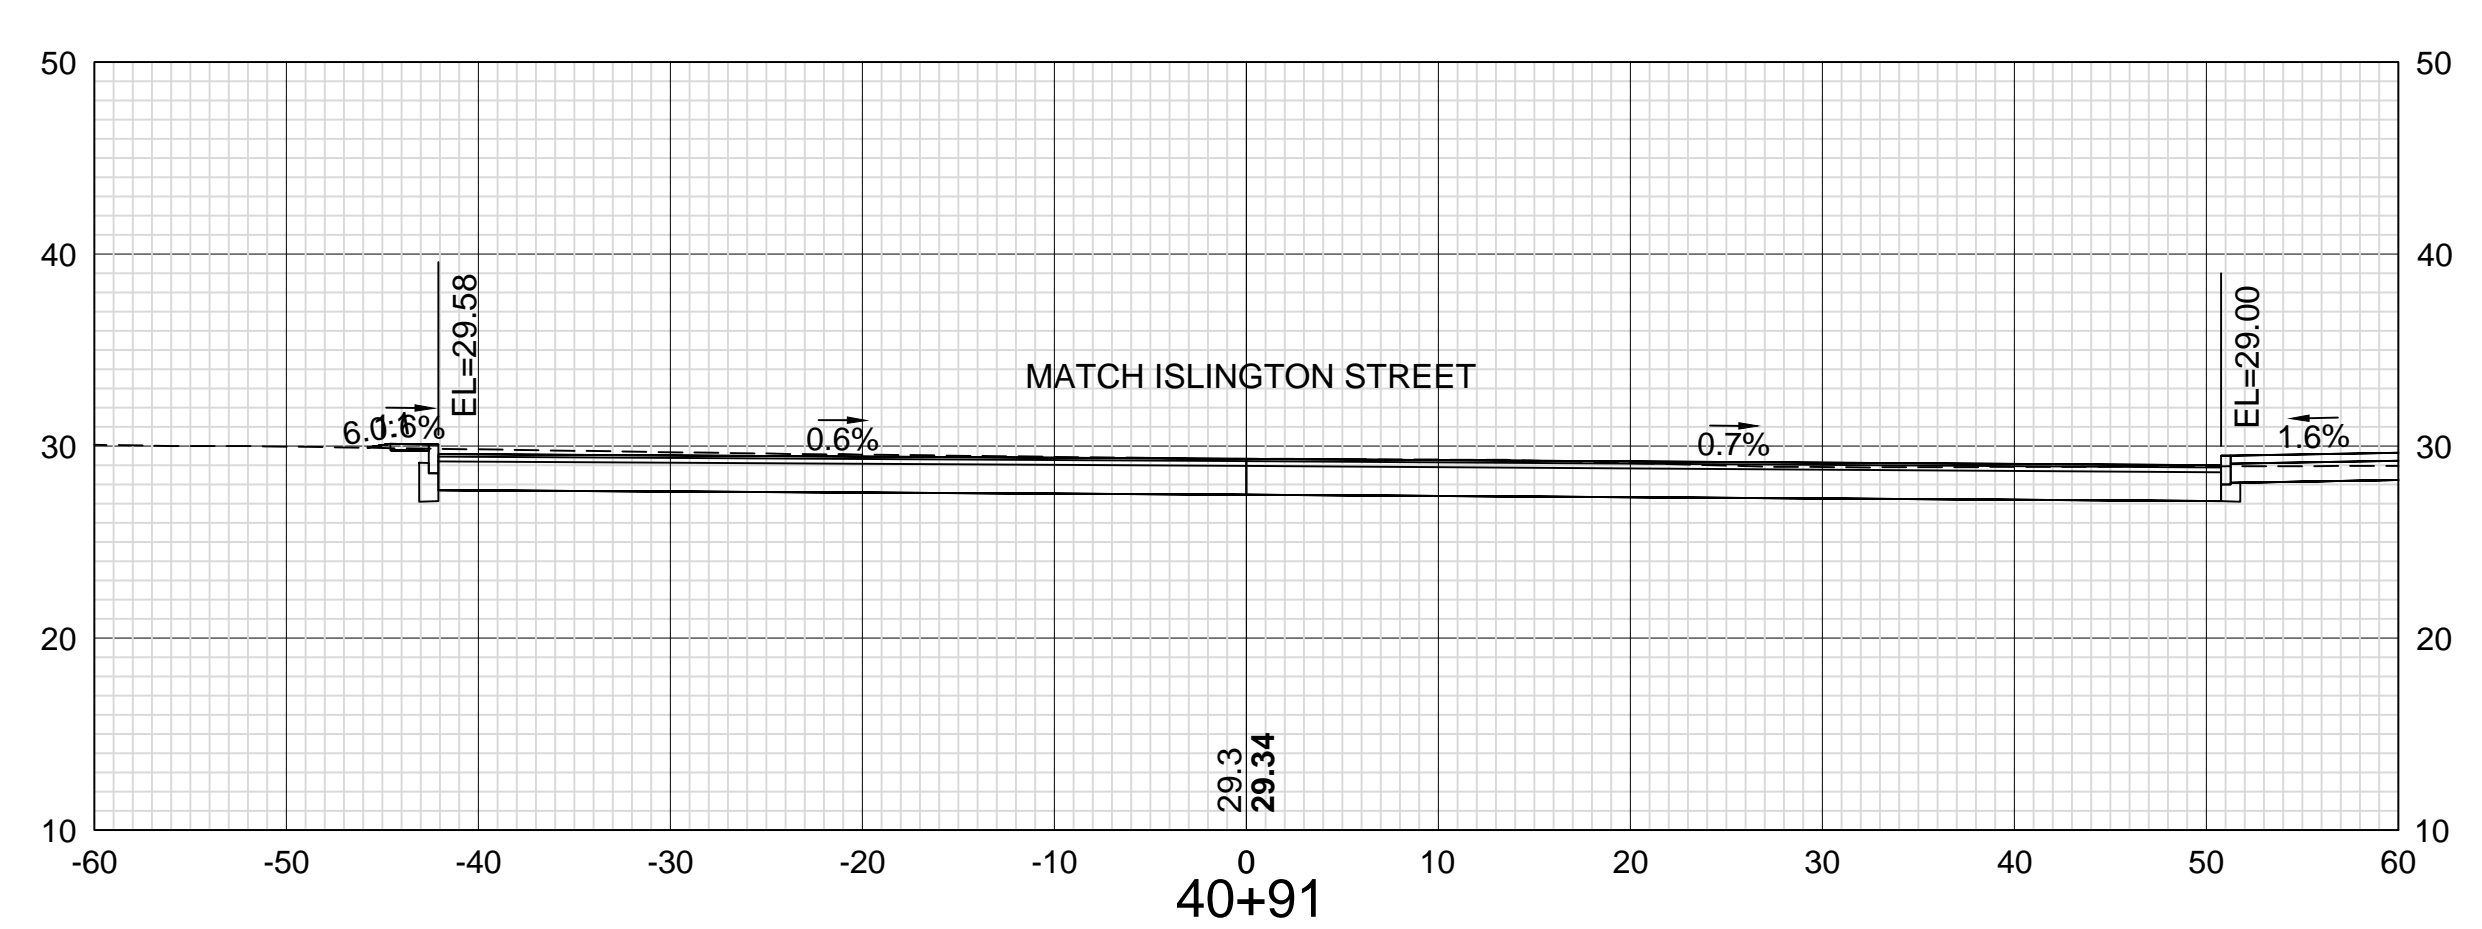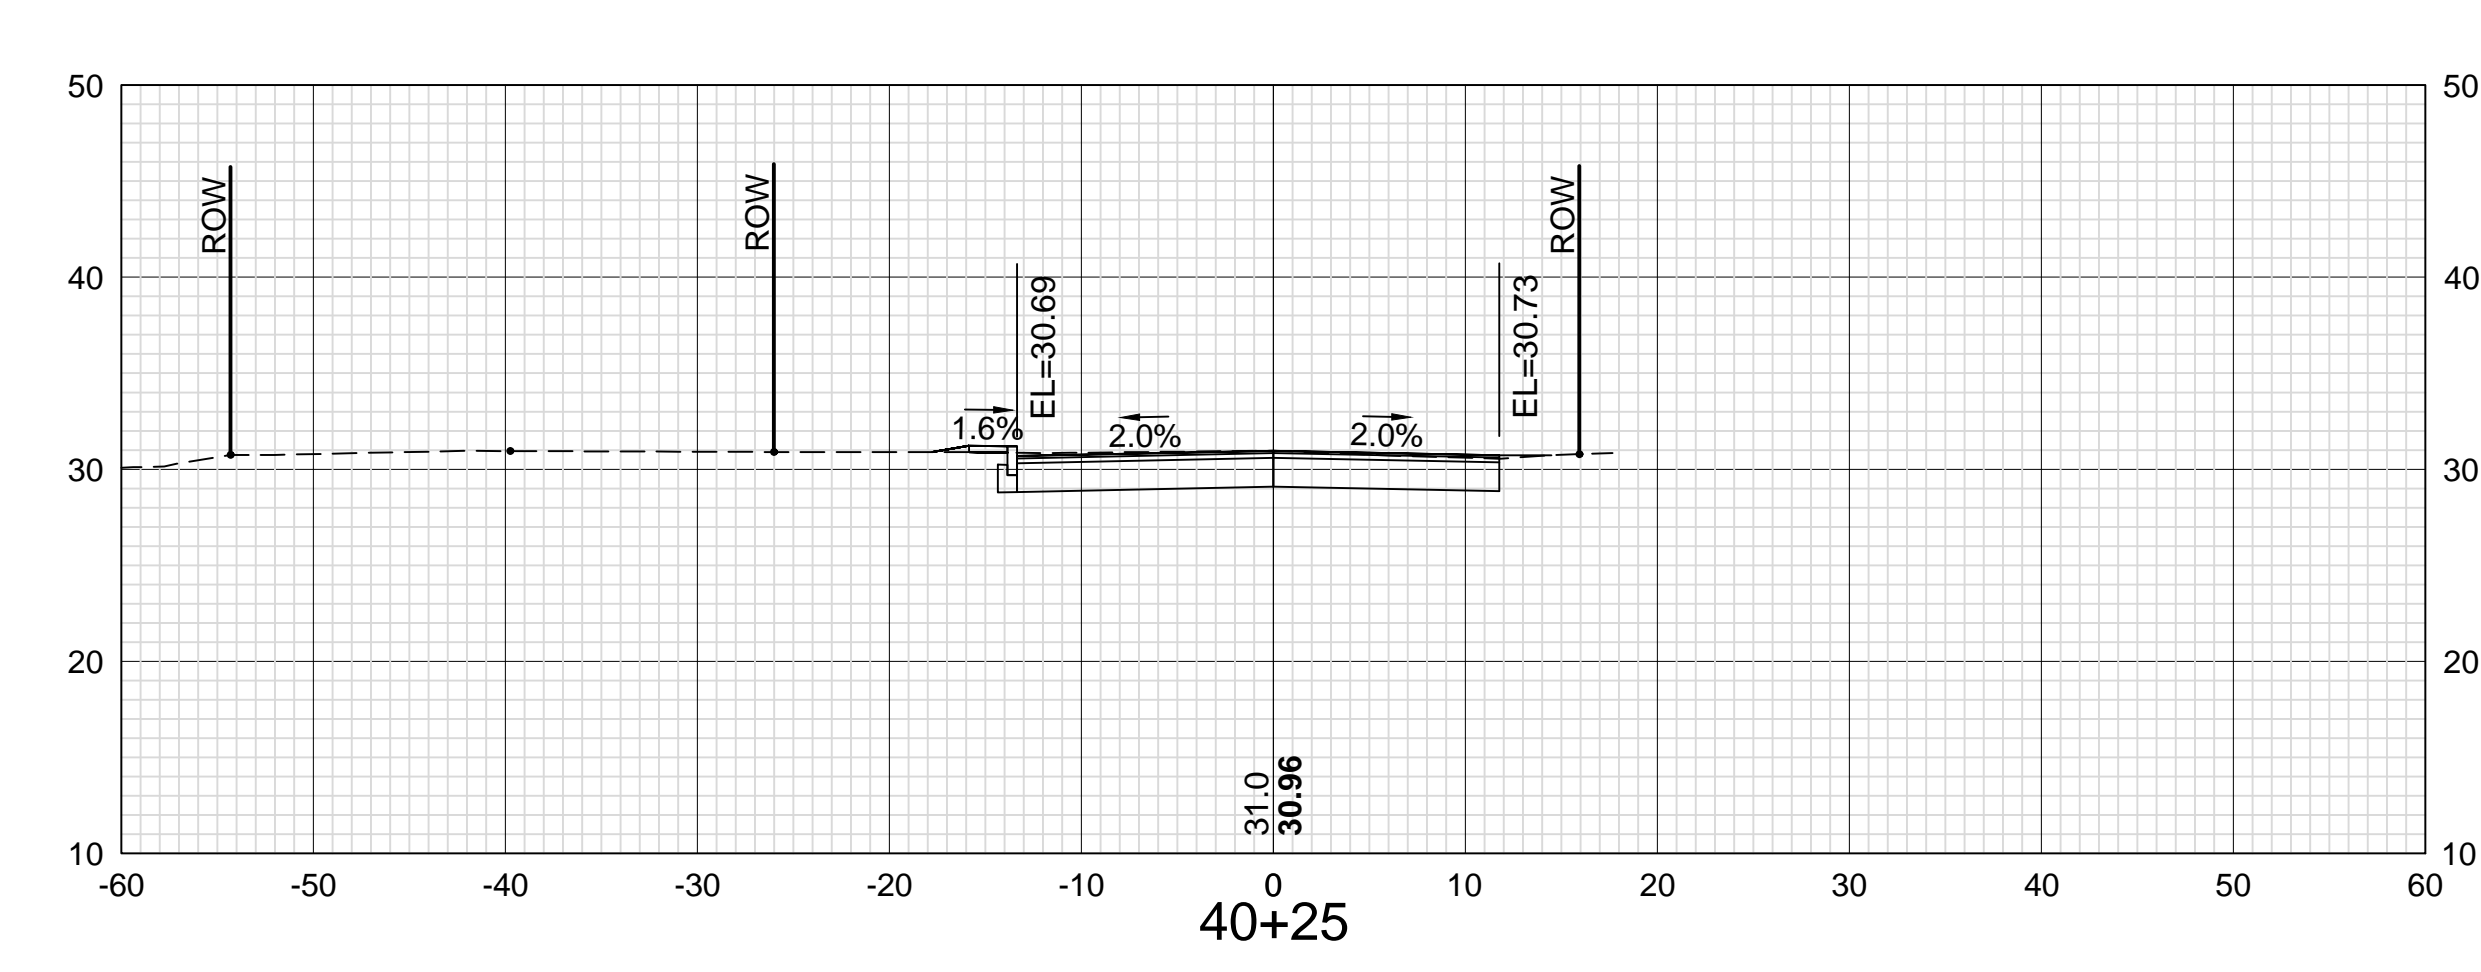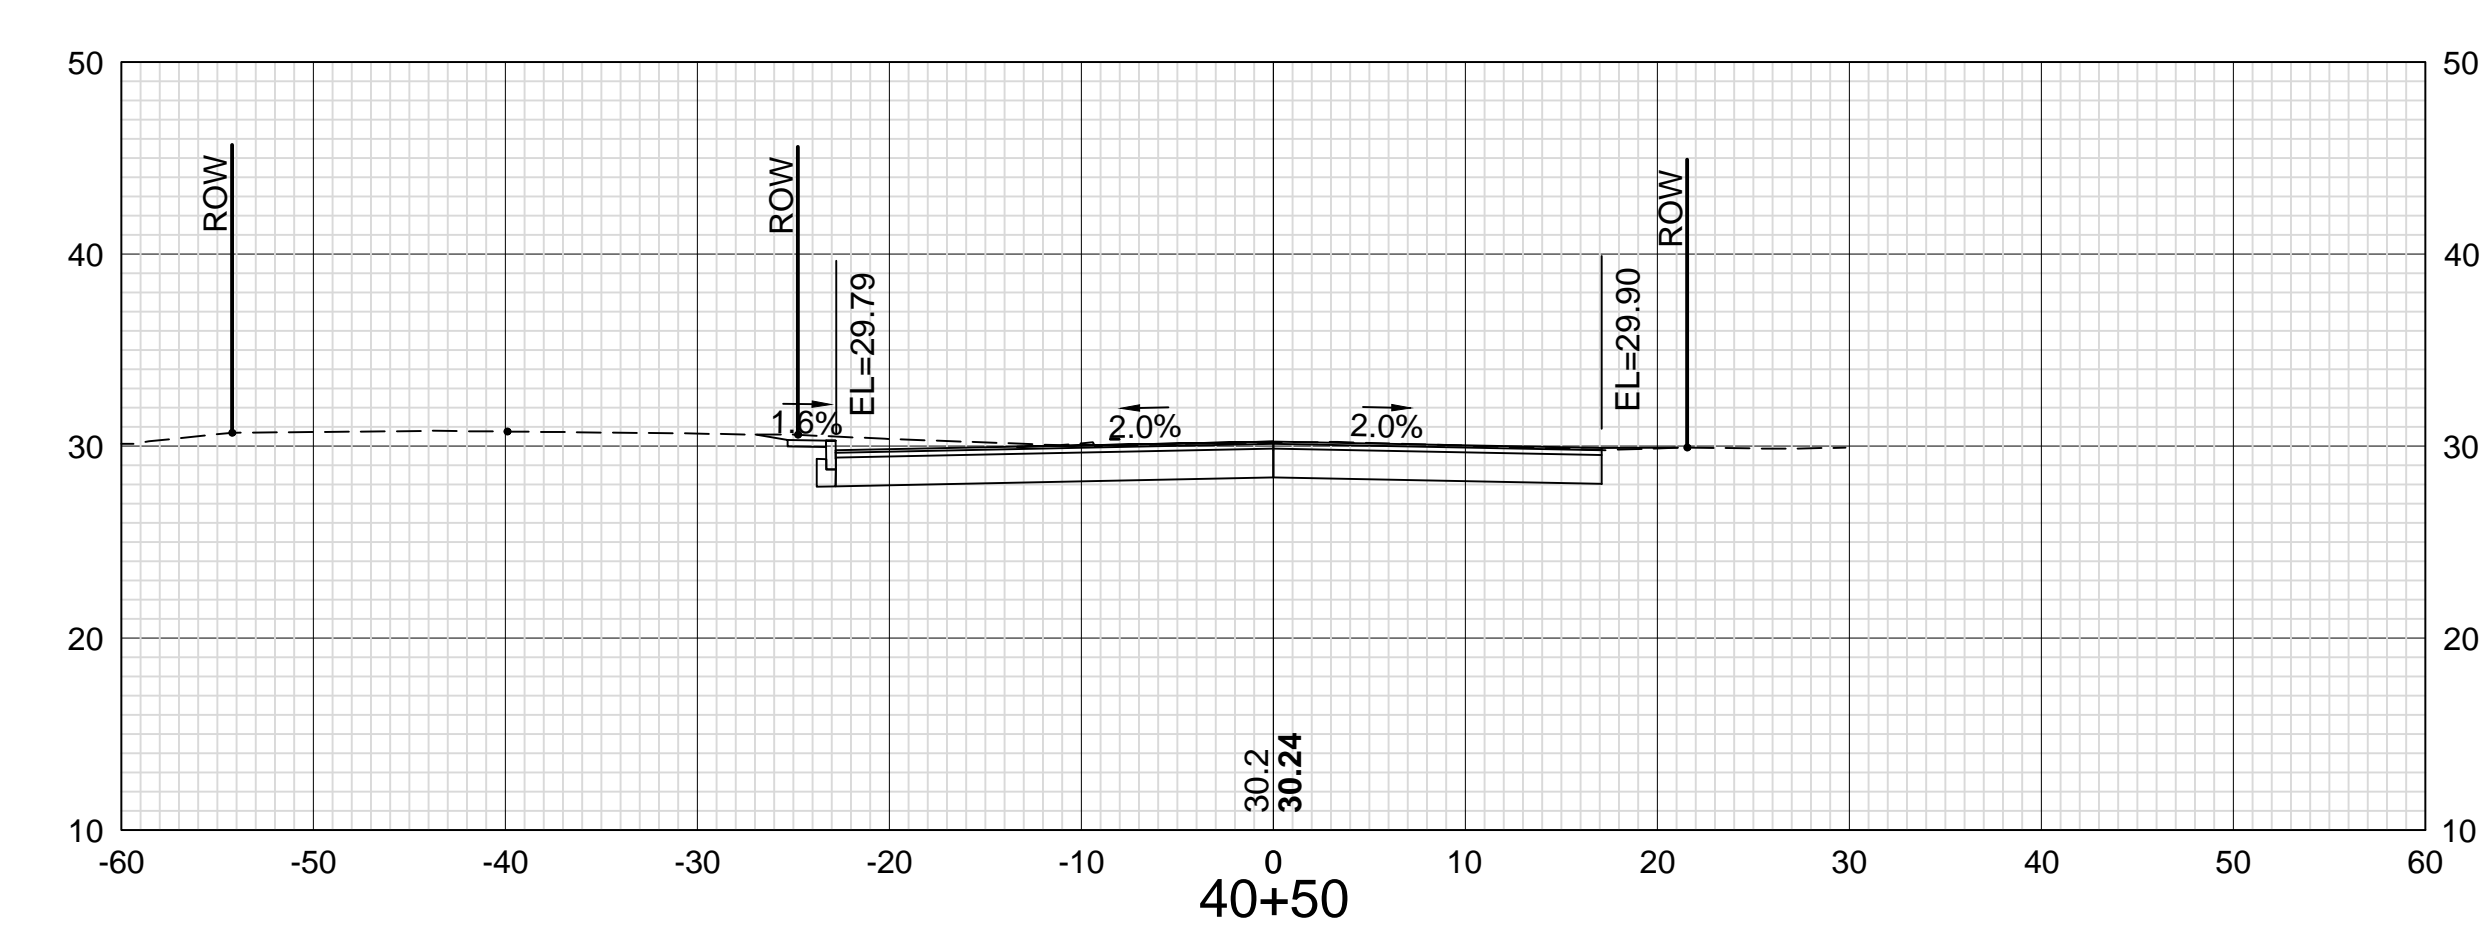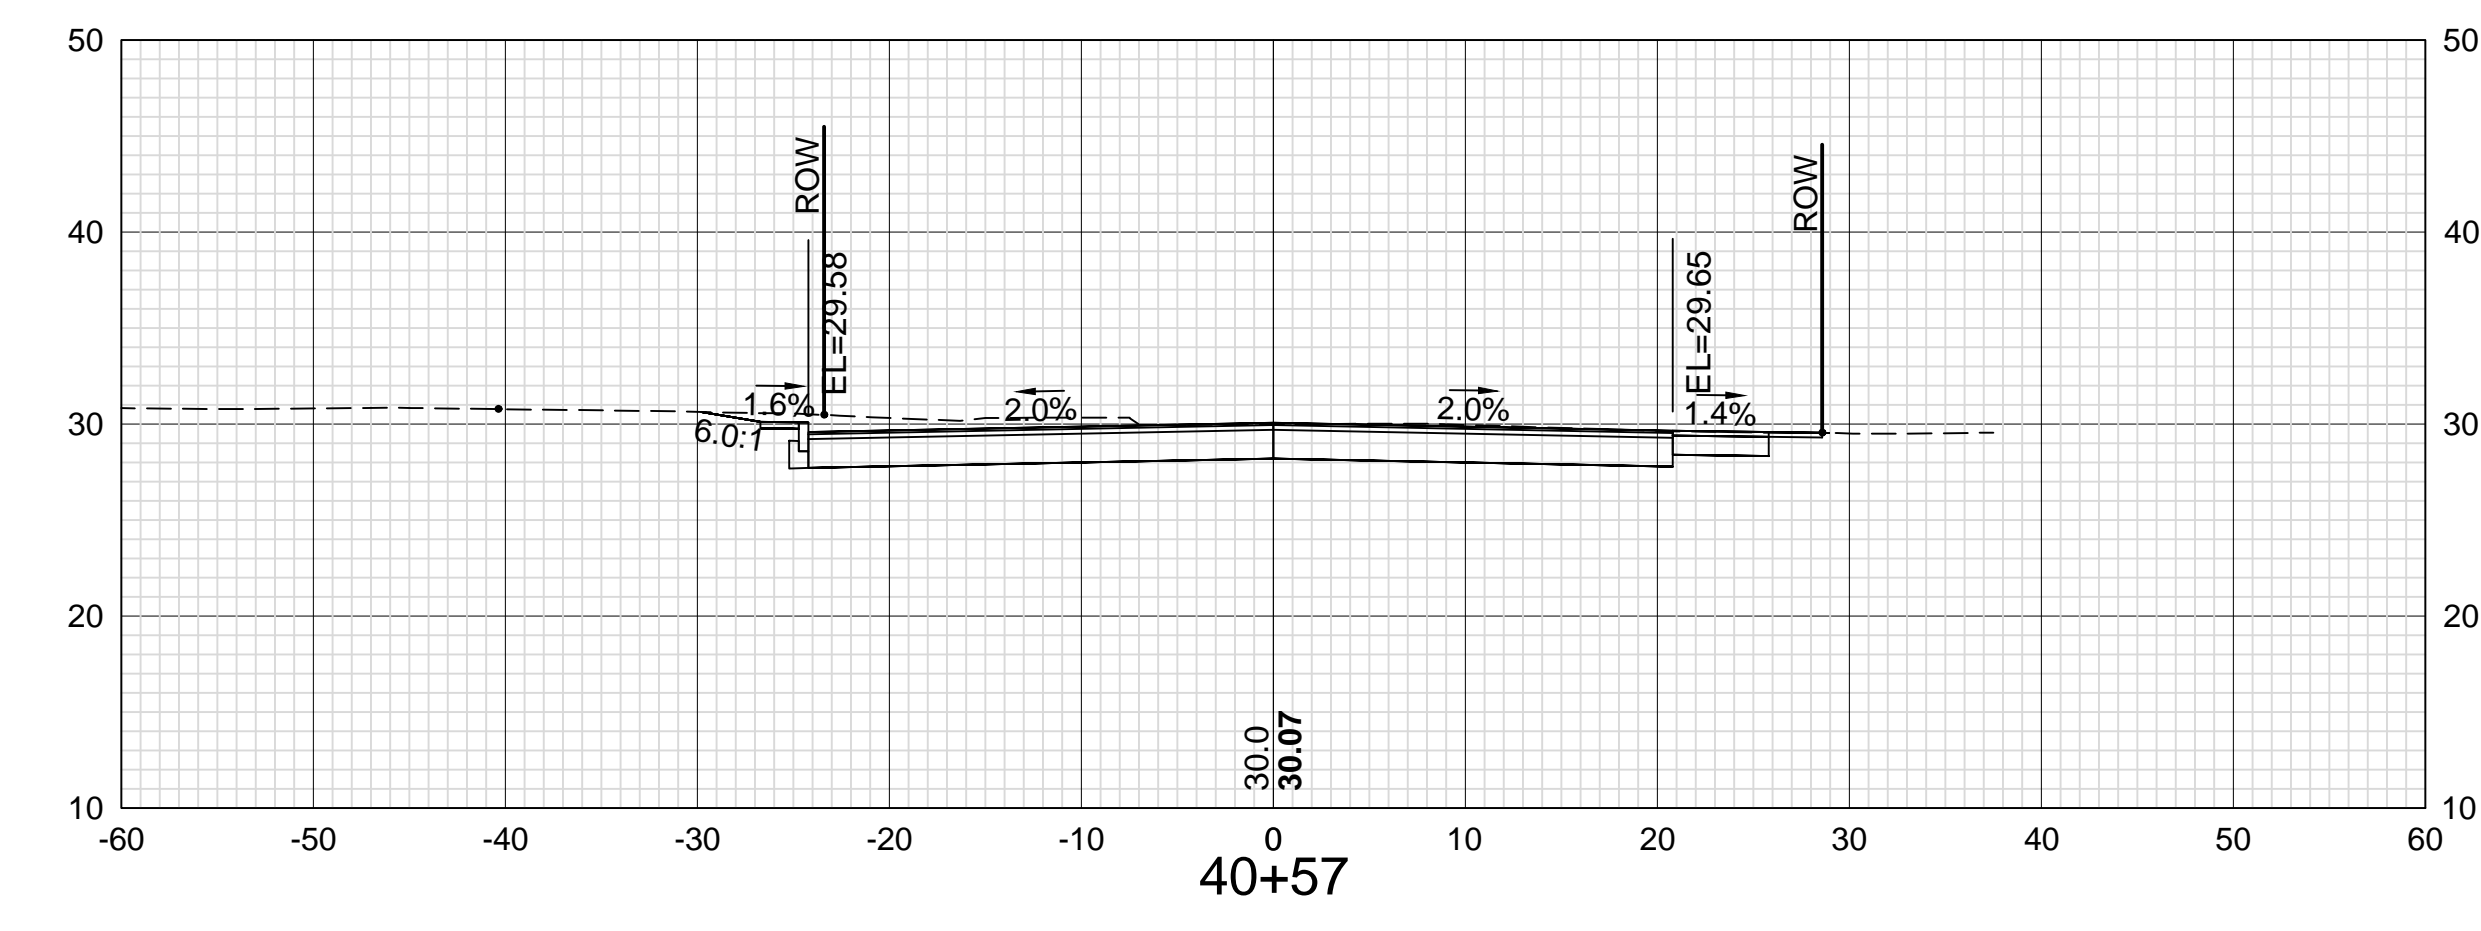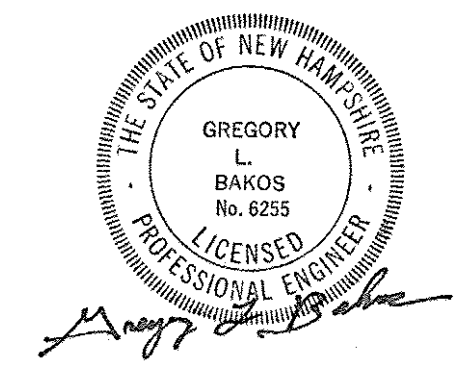













DATE PLOTTED
13-Nov-18

VHB PROJECT NO.
52393.00

ISLINGTON STREET CORRIDOR IMPROVEMENTS - SEGMENT 1				
CITY OF PORTSMOUTH, NEW HAMPSHIRE				
CROSS SECTIONS				
SPINNEY ROAD				
DRAWING	CITY PROJECT NO.	SHEET NO.	TOTAL SHEETS	
XS-Seg1	7176	70	88	

REVISIONS AFTER PROPOSAL	DESCRIPTION
STATION	
STATION	
DATE	
NUMBER	

SDR PROCESSED	VHB	DATE	OCT 2017
NEW DESIGN	KMH	DATE	11/13/18
SHEET CHECKED	GLB	DATE	11/13/18
AS BUILT DETAILS		DATE	

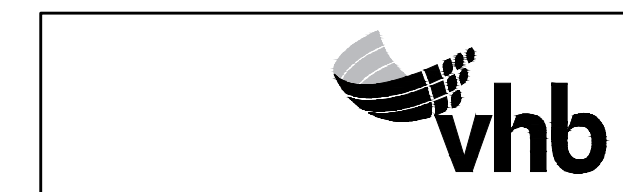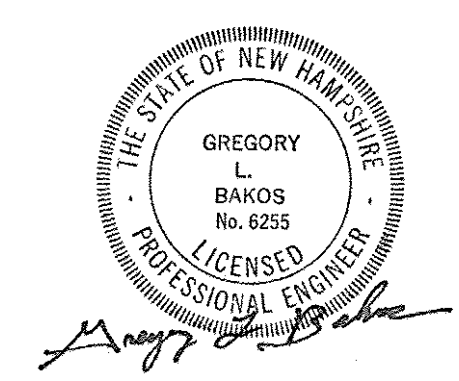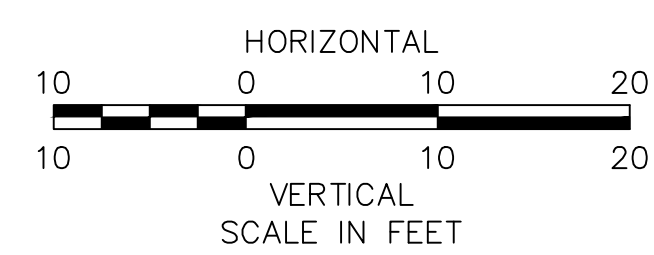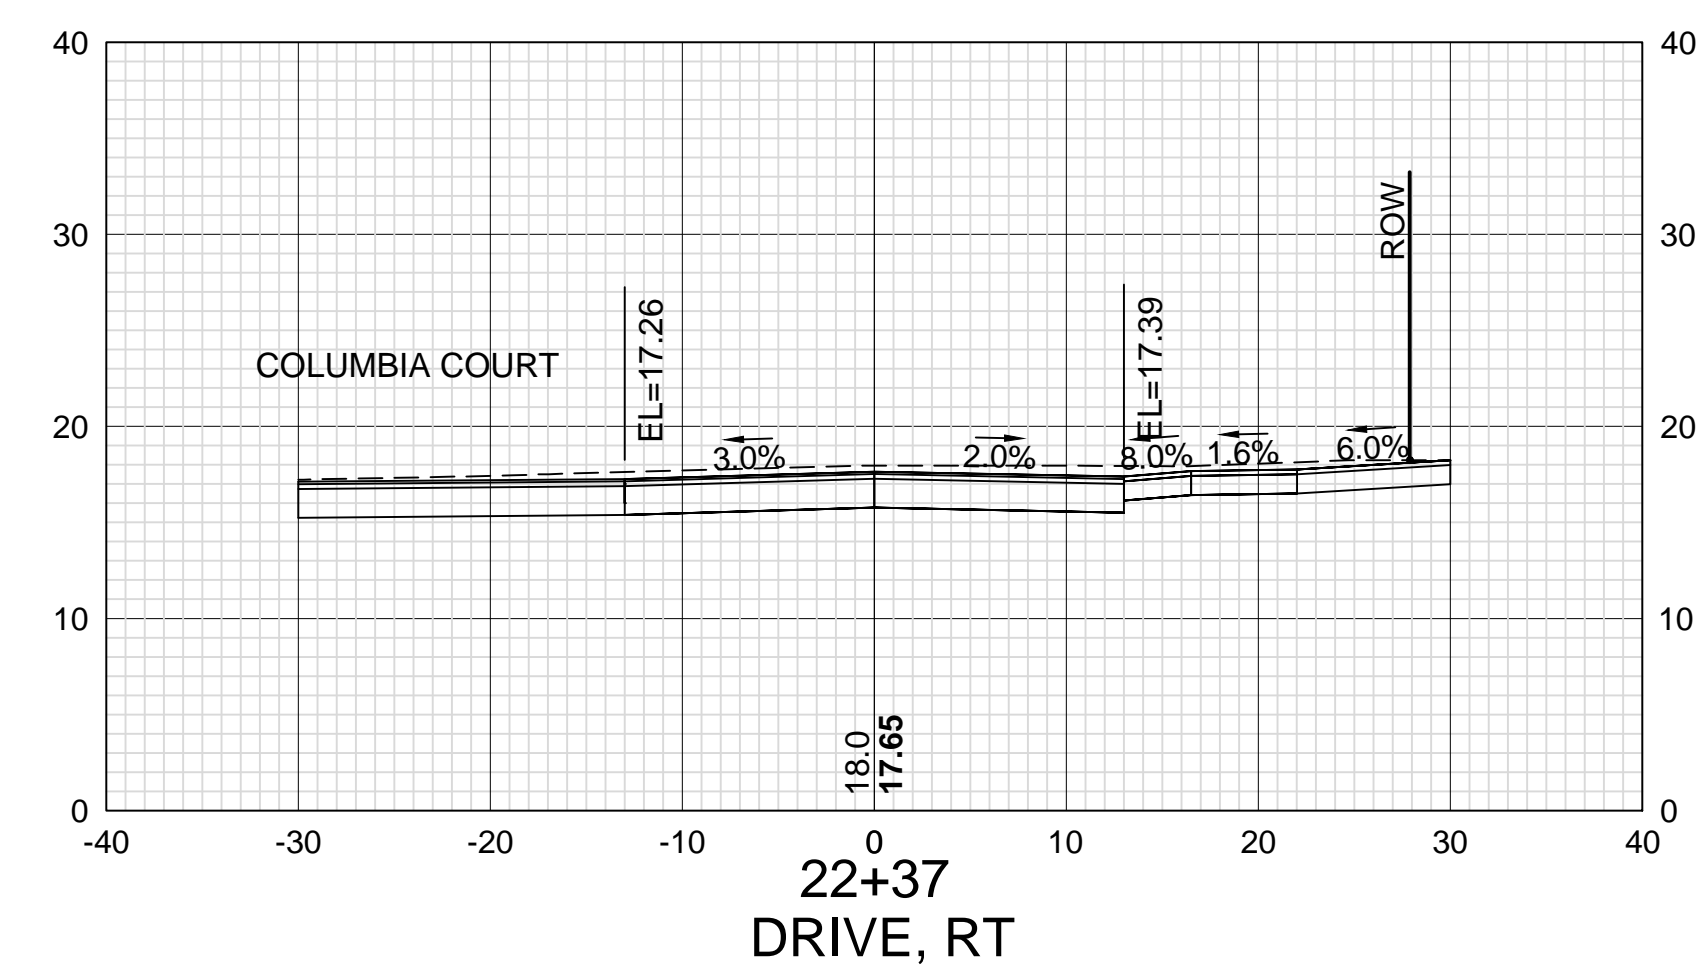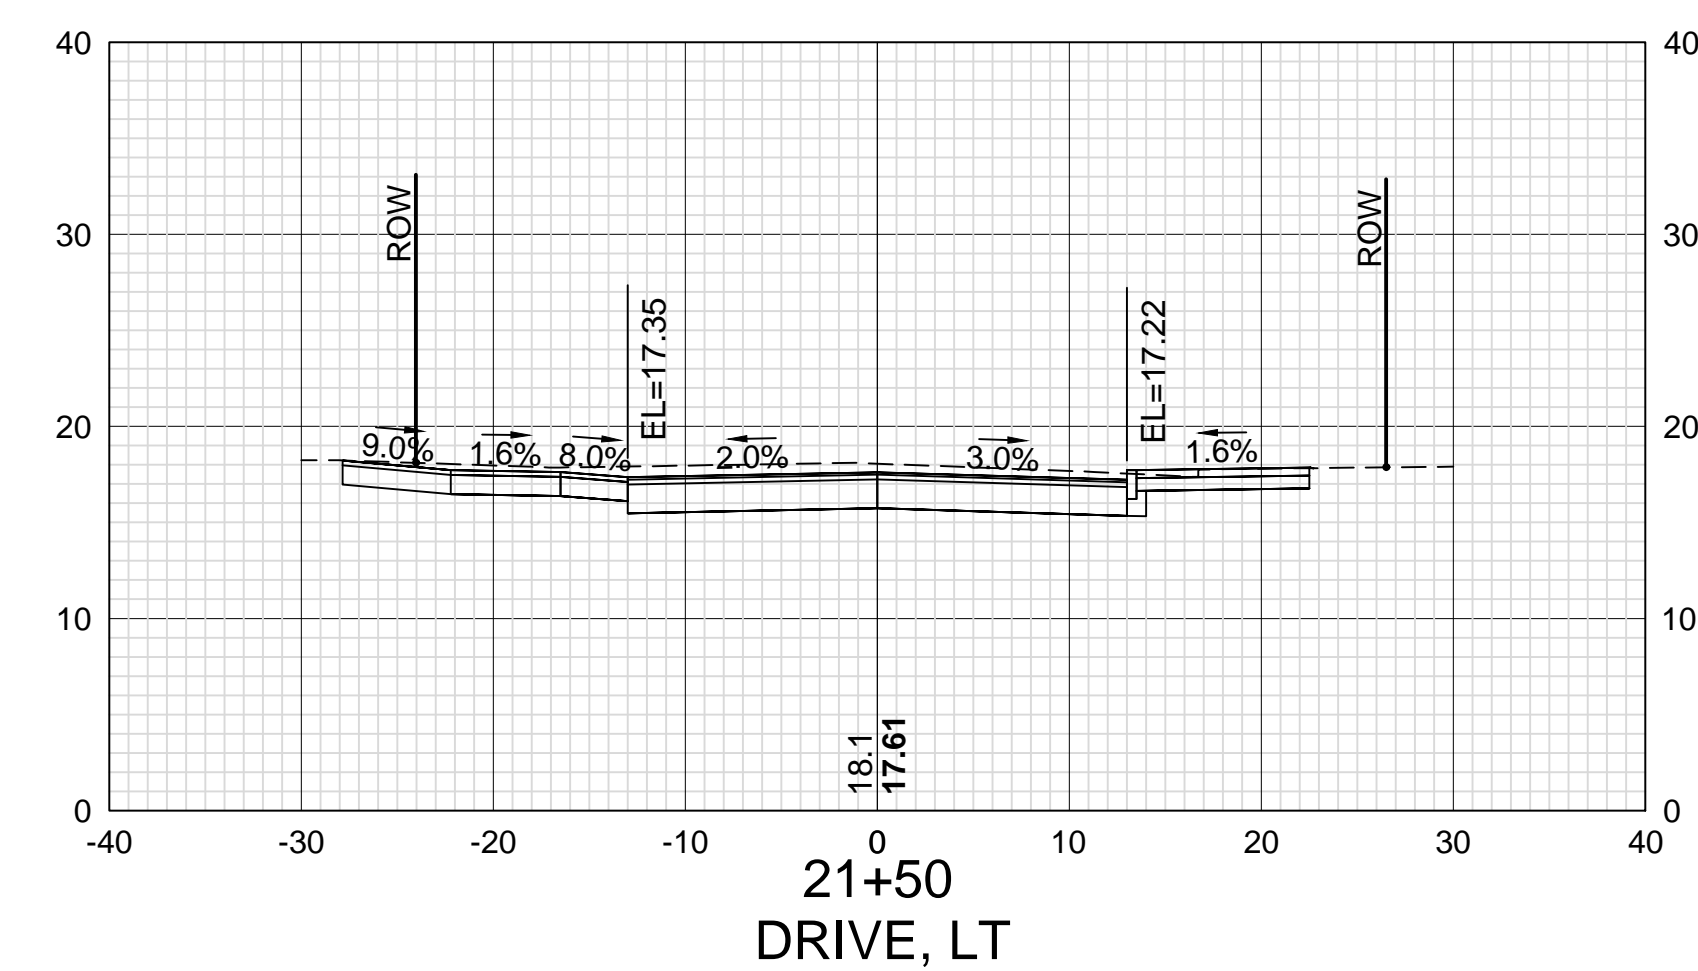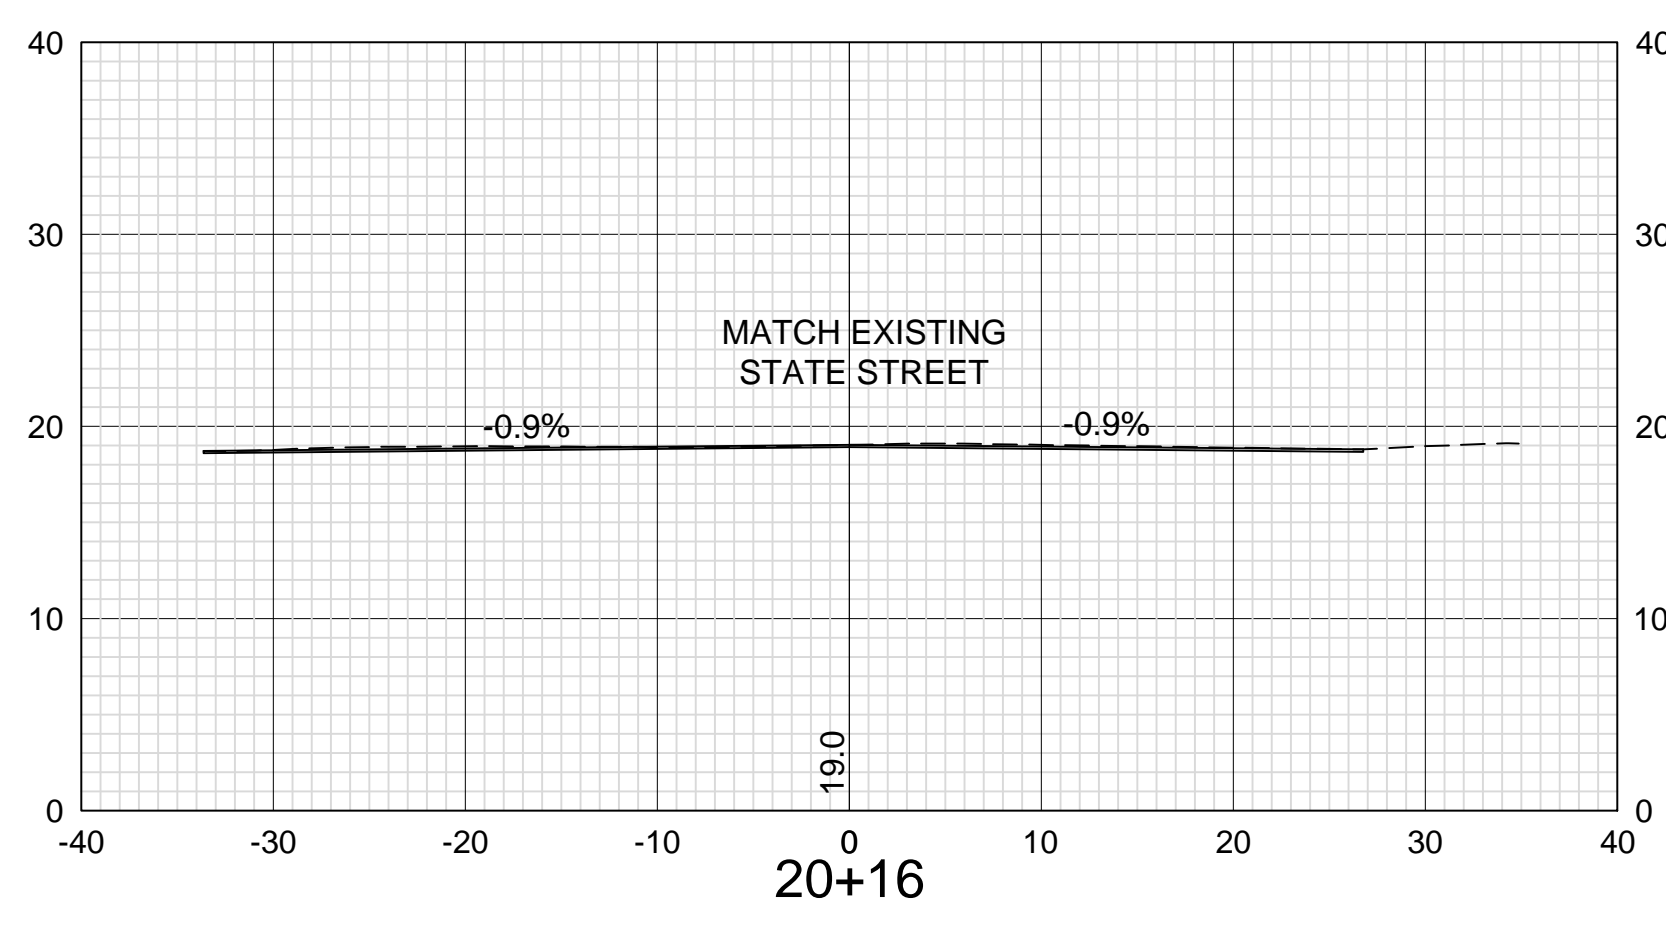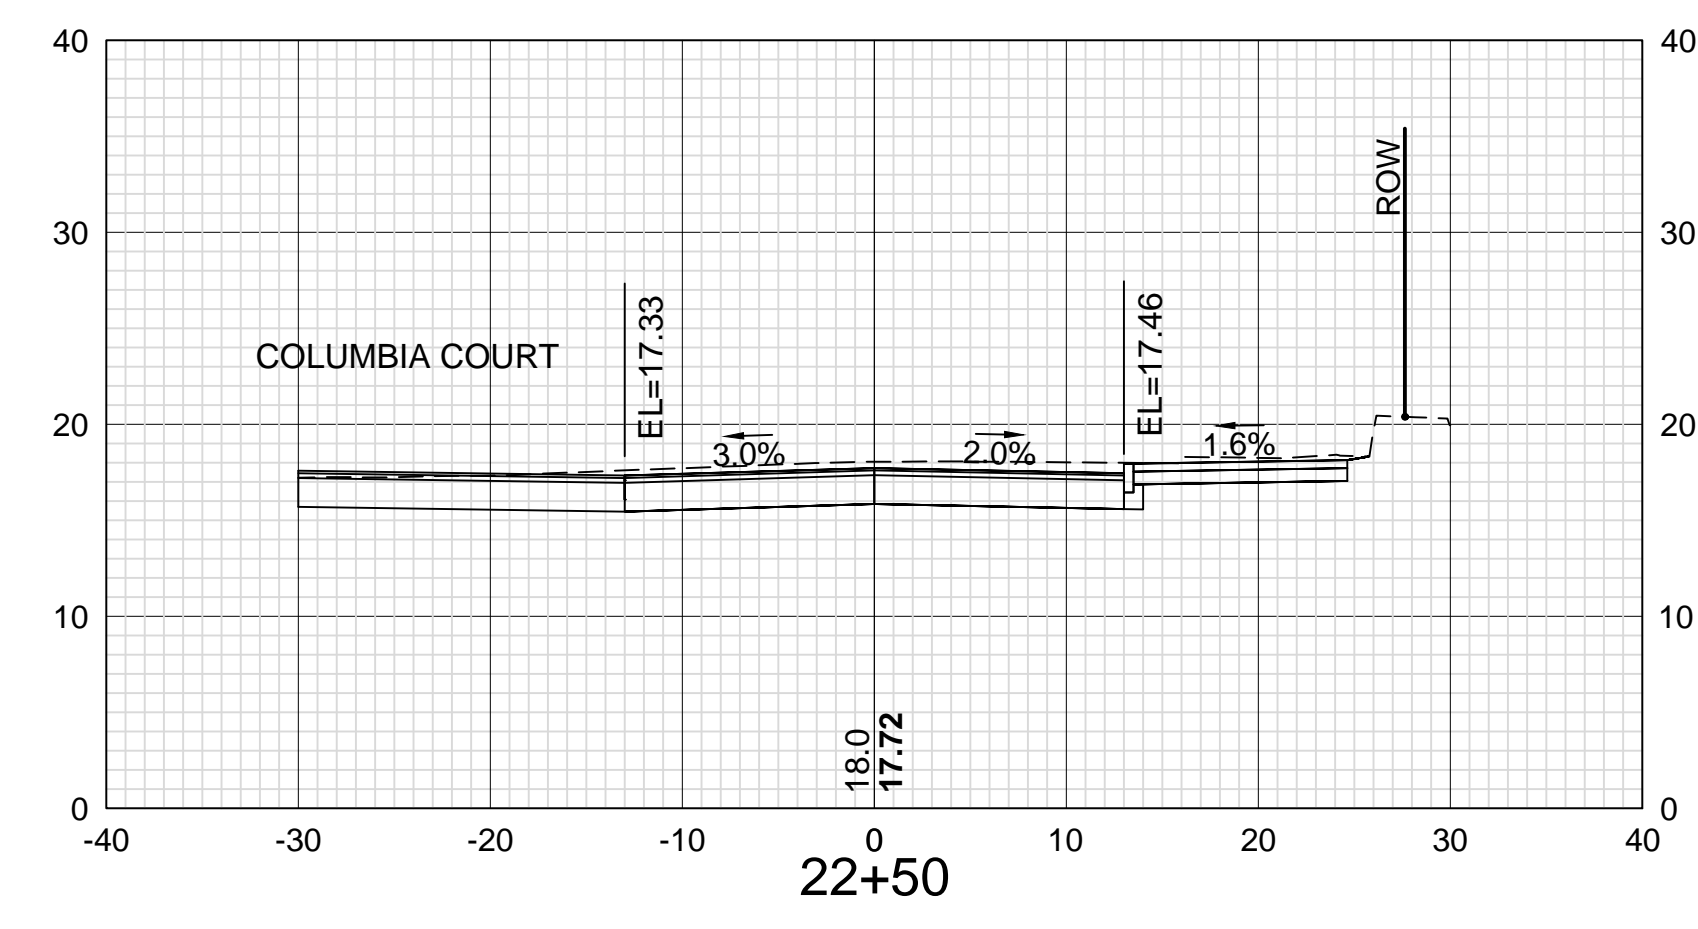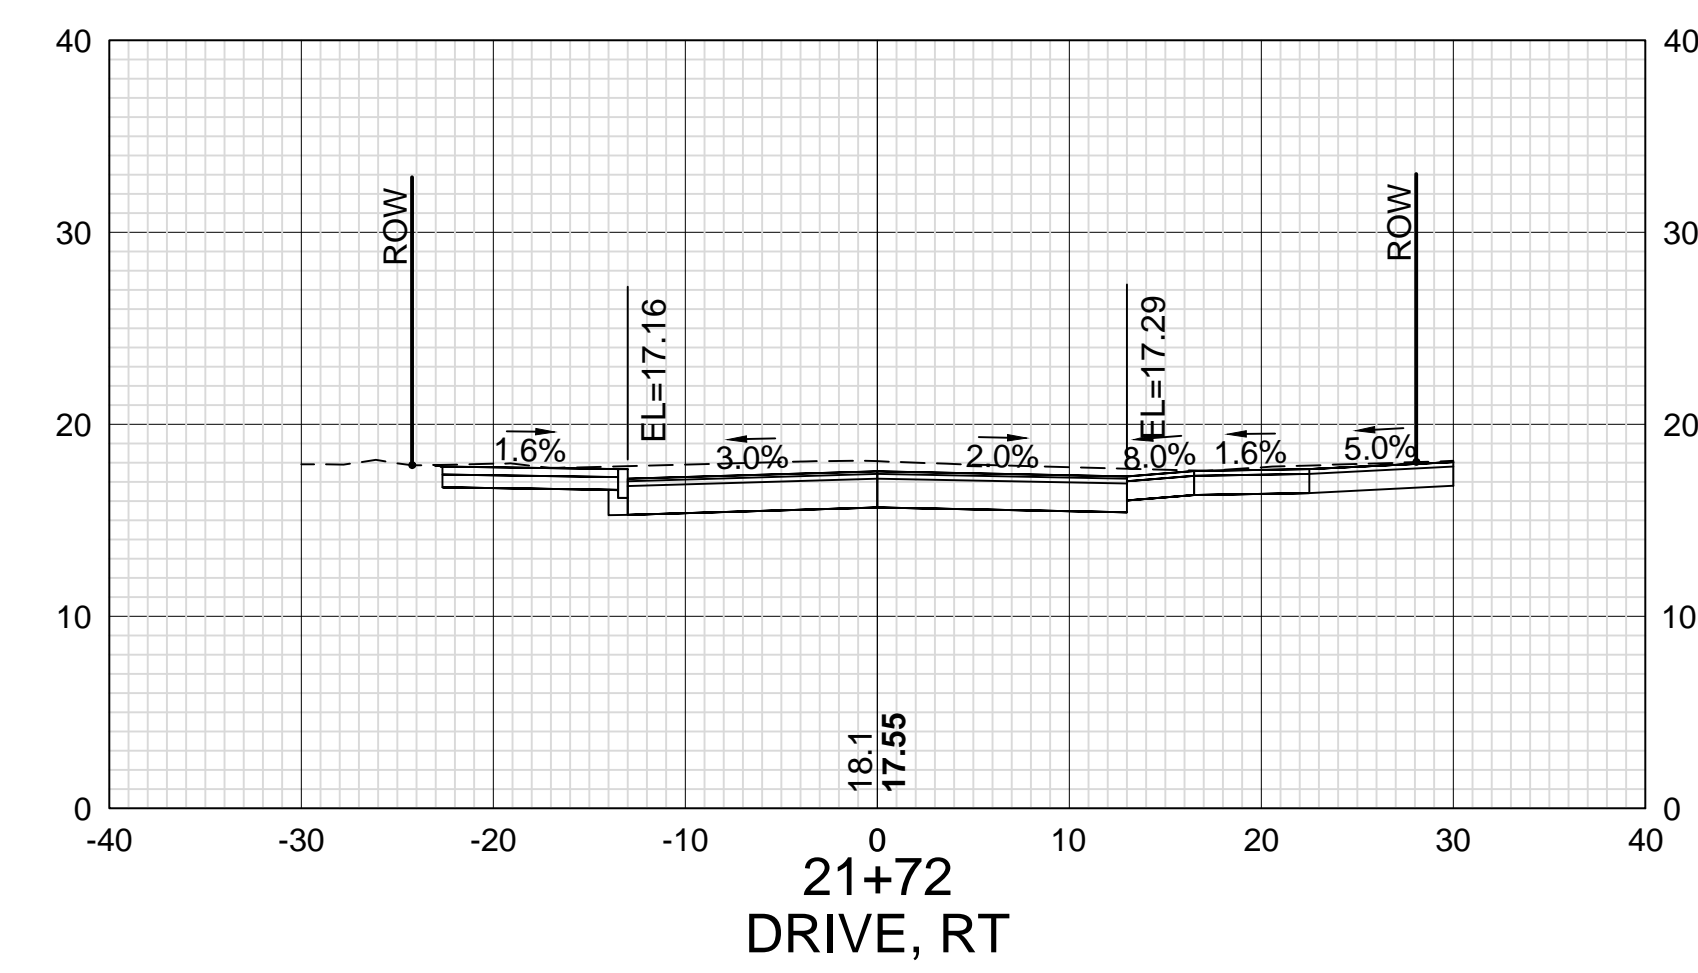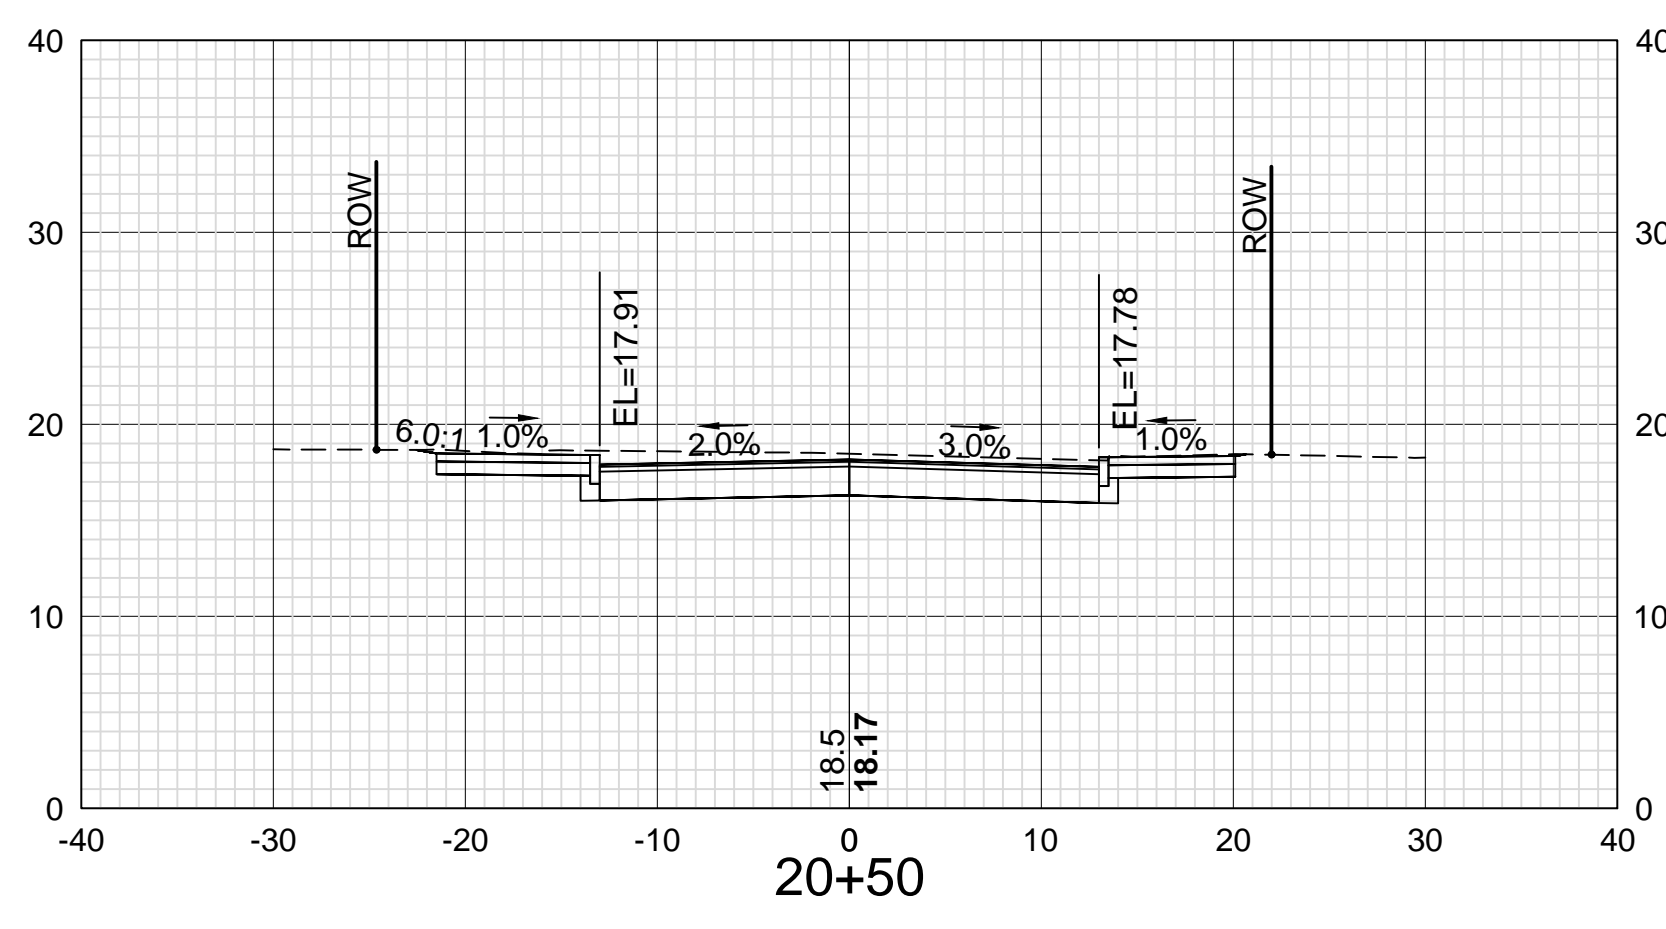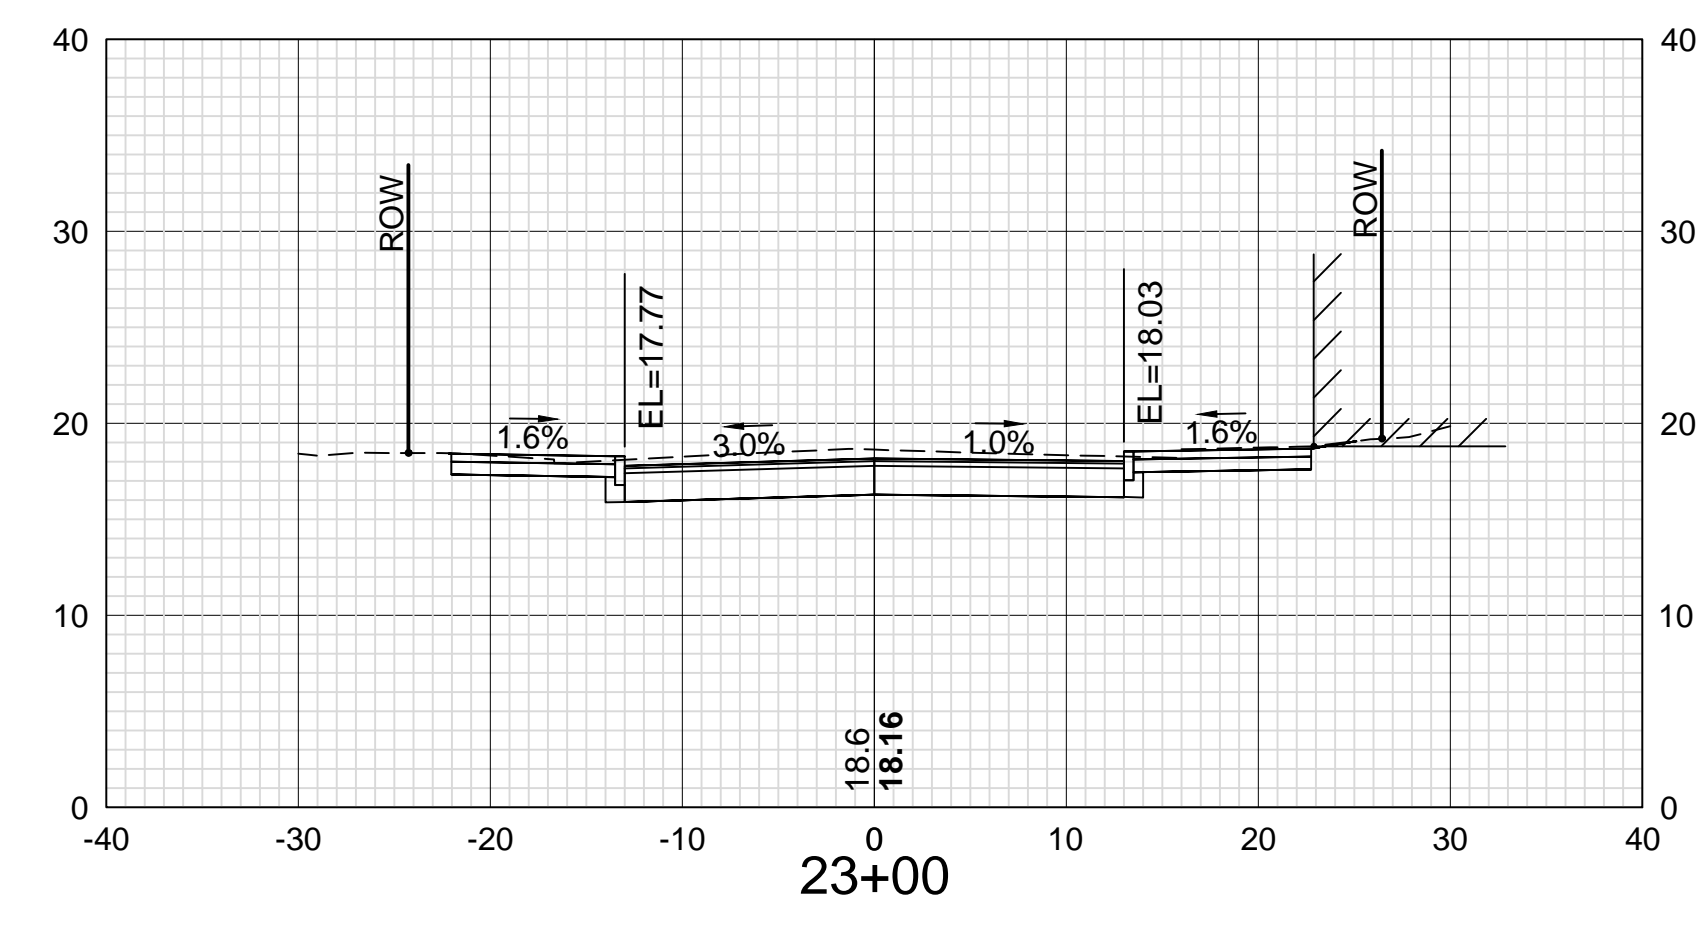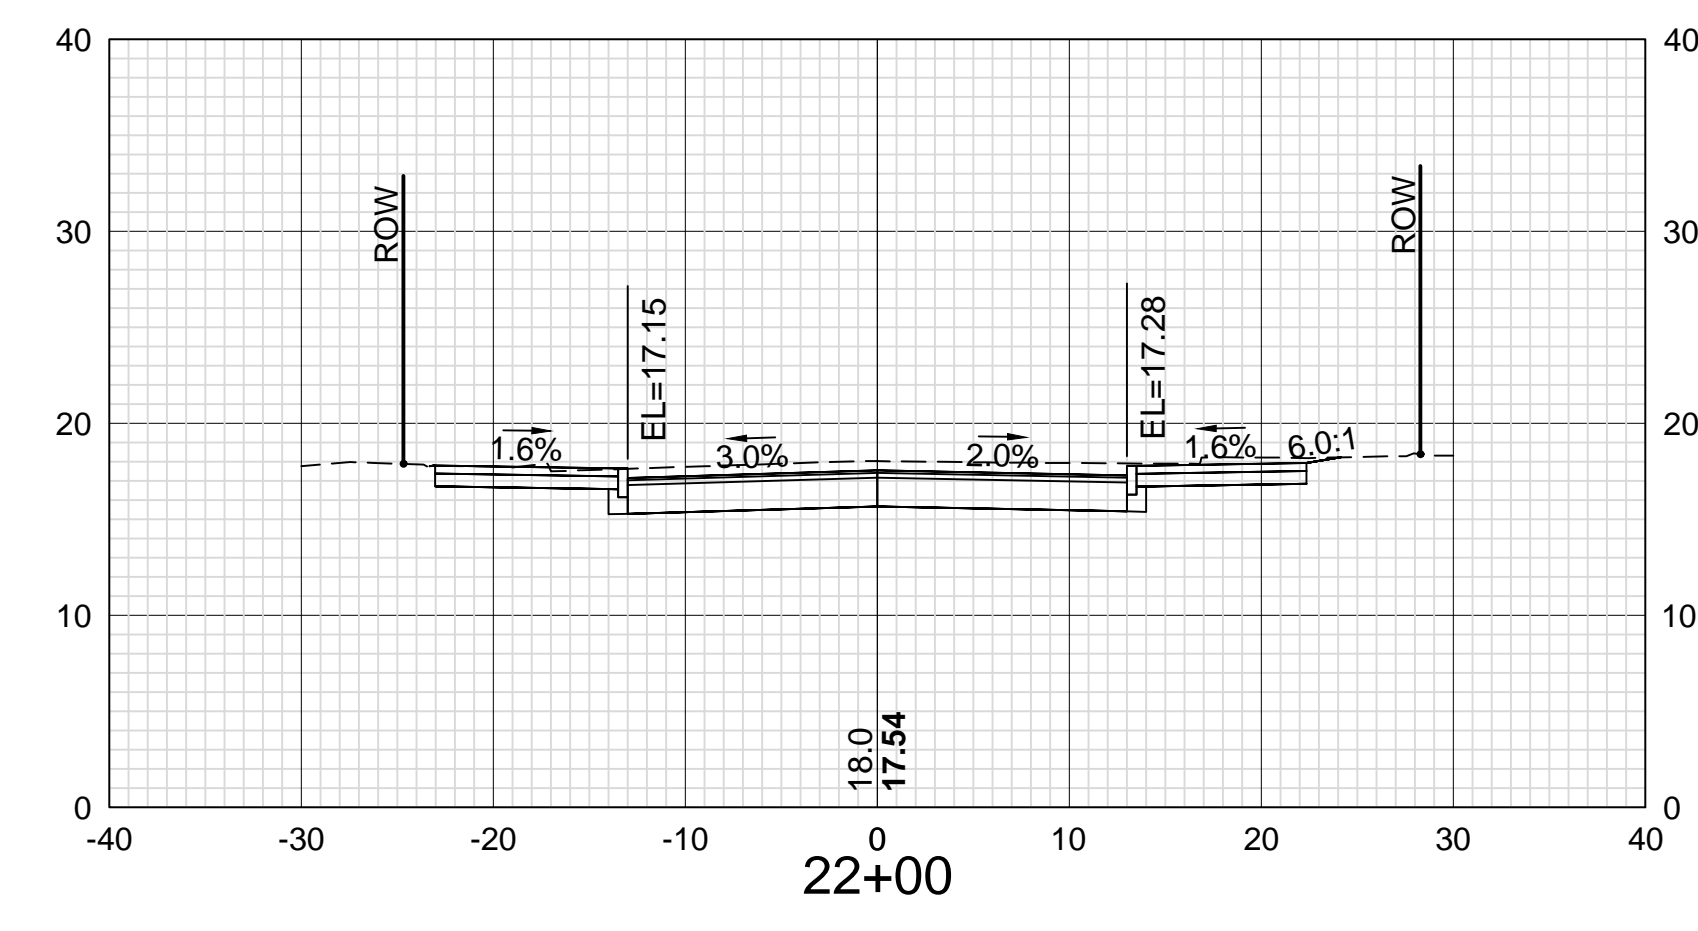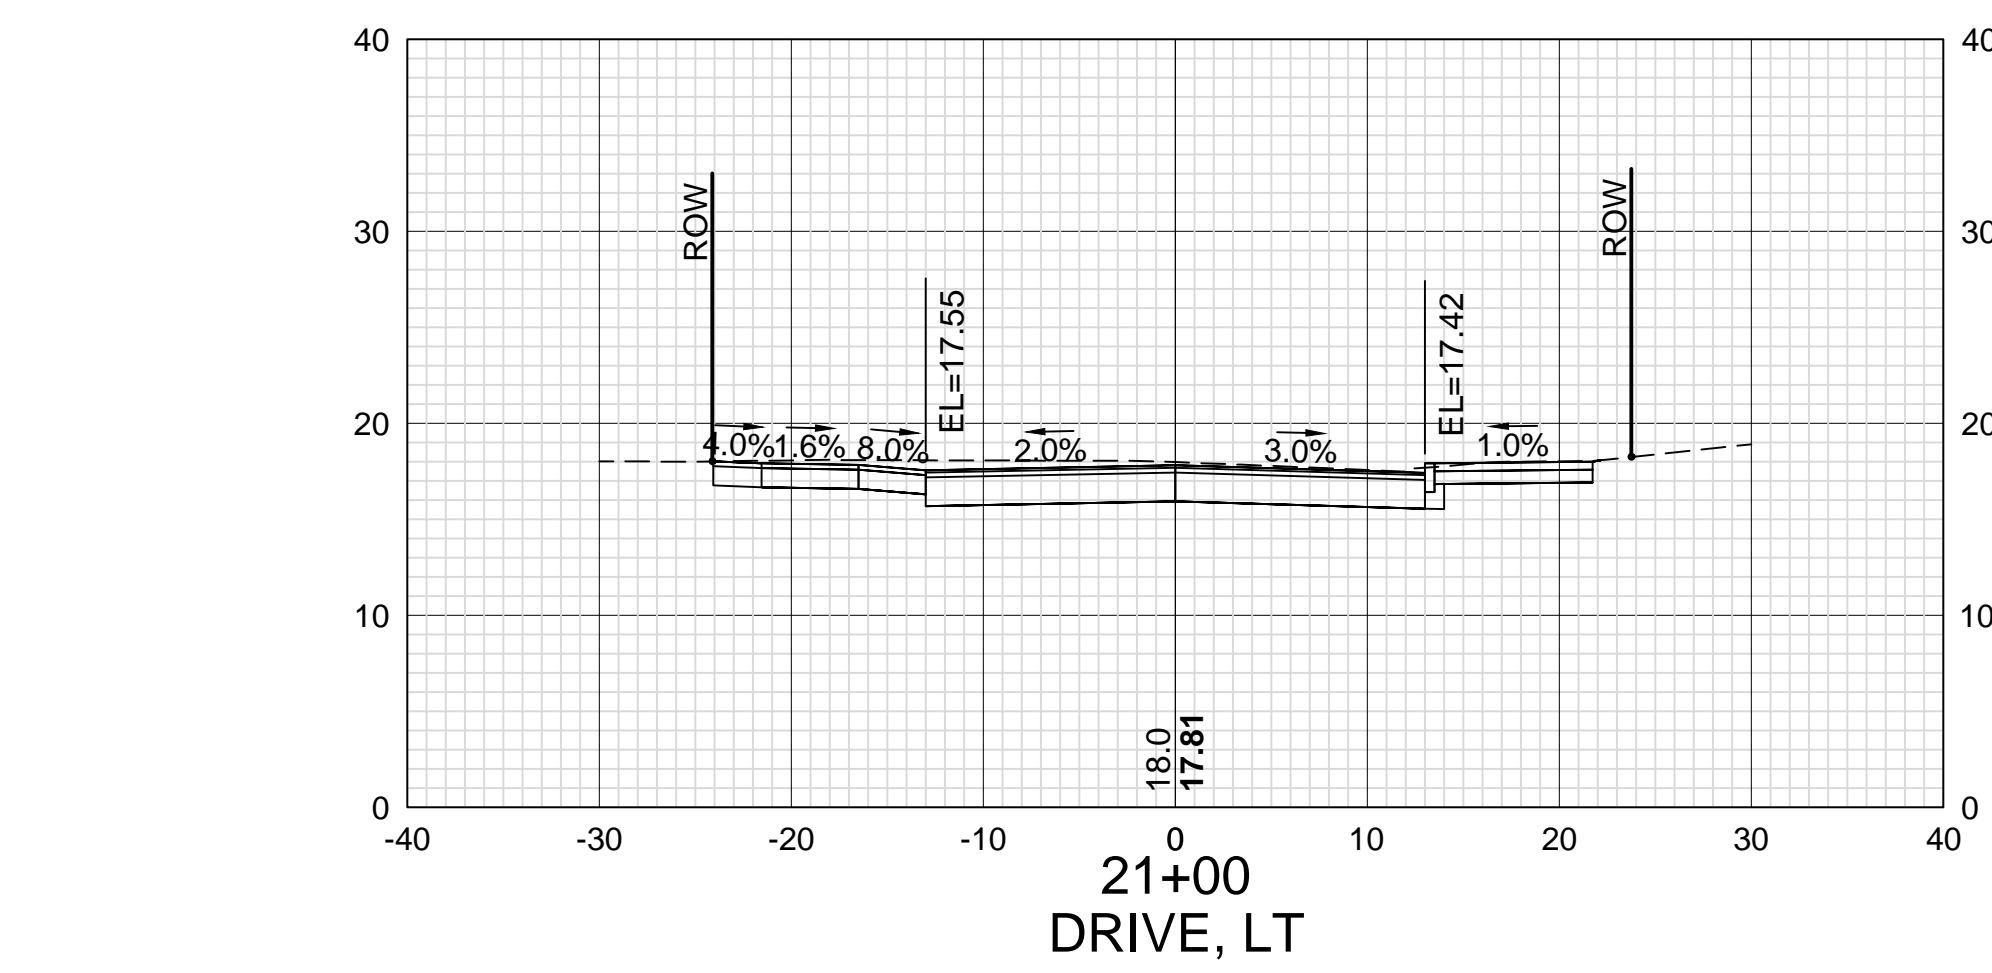

DATE PLOTTED	VHB PROJECT NO.	DRAWING	CITY PROJECT NO.	SHEET NO.	TOTAL SHEETS
13-Nov-18	52393.00	XS-Seg1	7176	71	88

ISLINGTON STREET CORRIDOR IMPROVEMENTS - SEGMENT 1
CITY OF PORTSMOUTH, NEW HAMPSHIRE

CROSS SECTIONS
COLUMBIA STREET

REVISIONS AFTER PROPOSAL

DESCRIPTION

STATION










STATION

DATE

NUMBER

DATE
OCT 2017
DATE
11/13/18
DATE
11/13/18
DATE

SDR PROCESSED VHB
NEW DESIGN KMH
SHEET CHECKED GLB
AS BUILT DETAILS

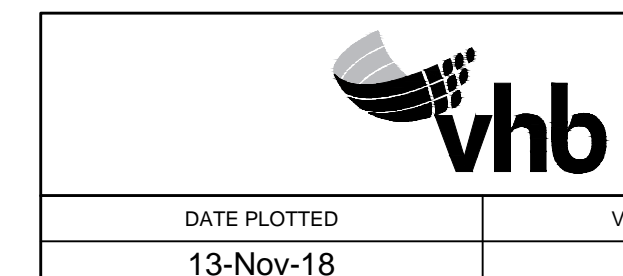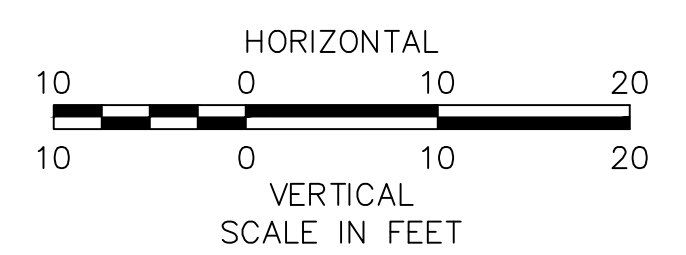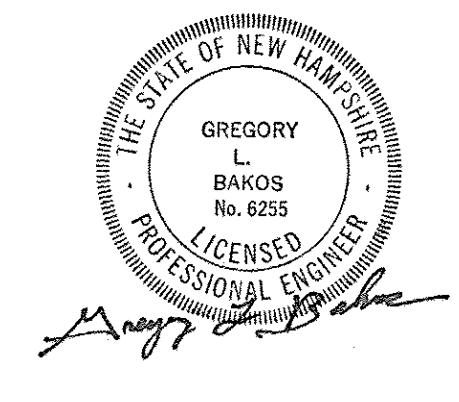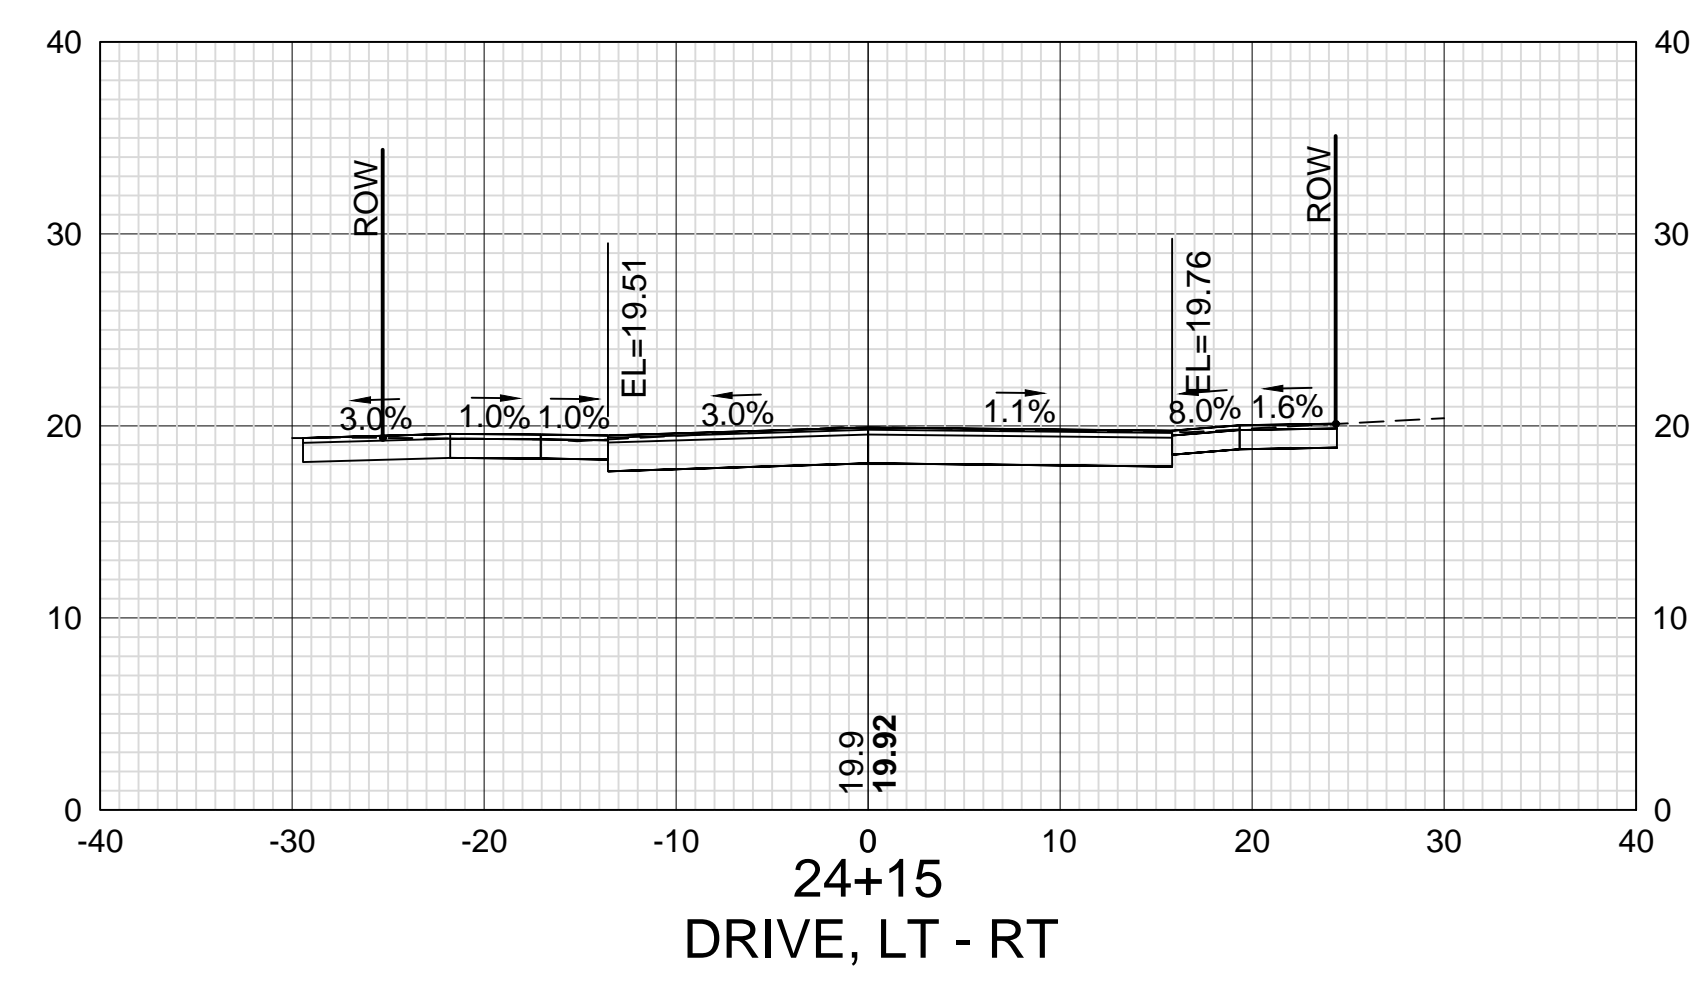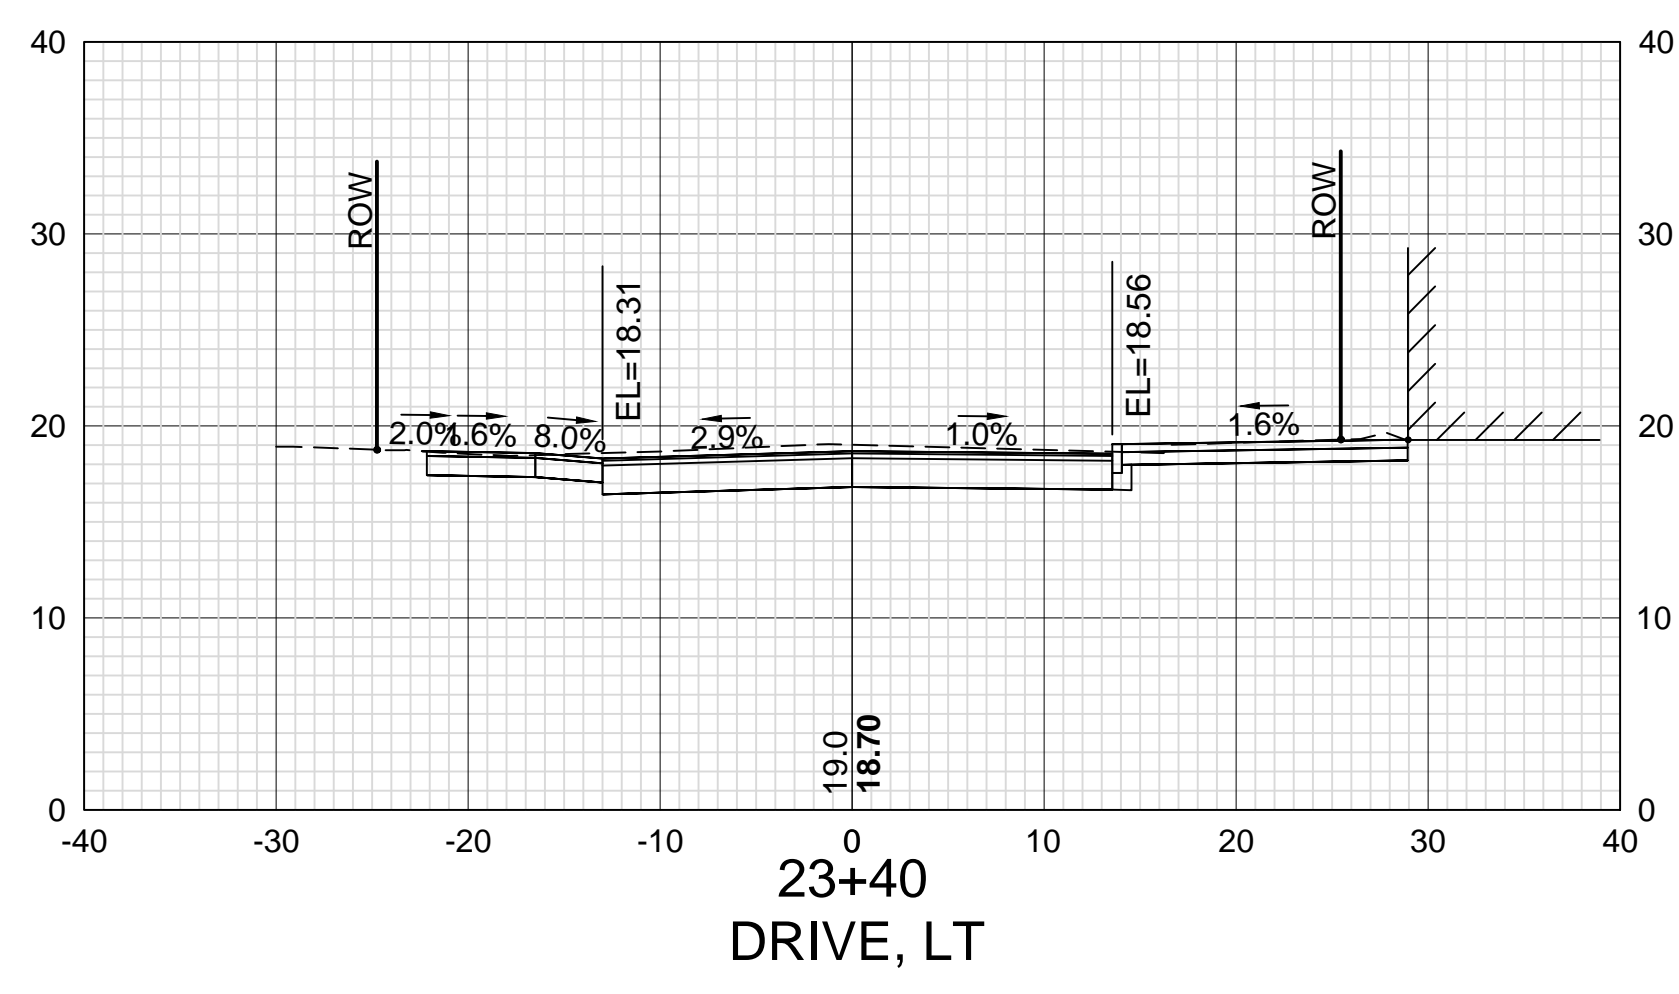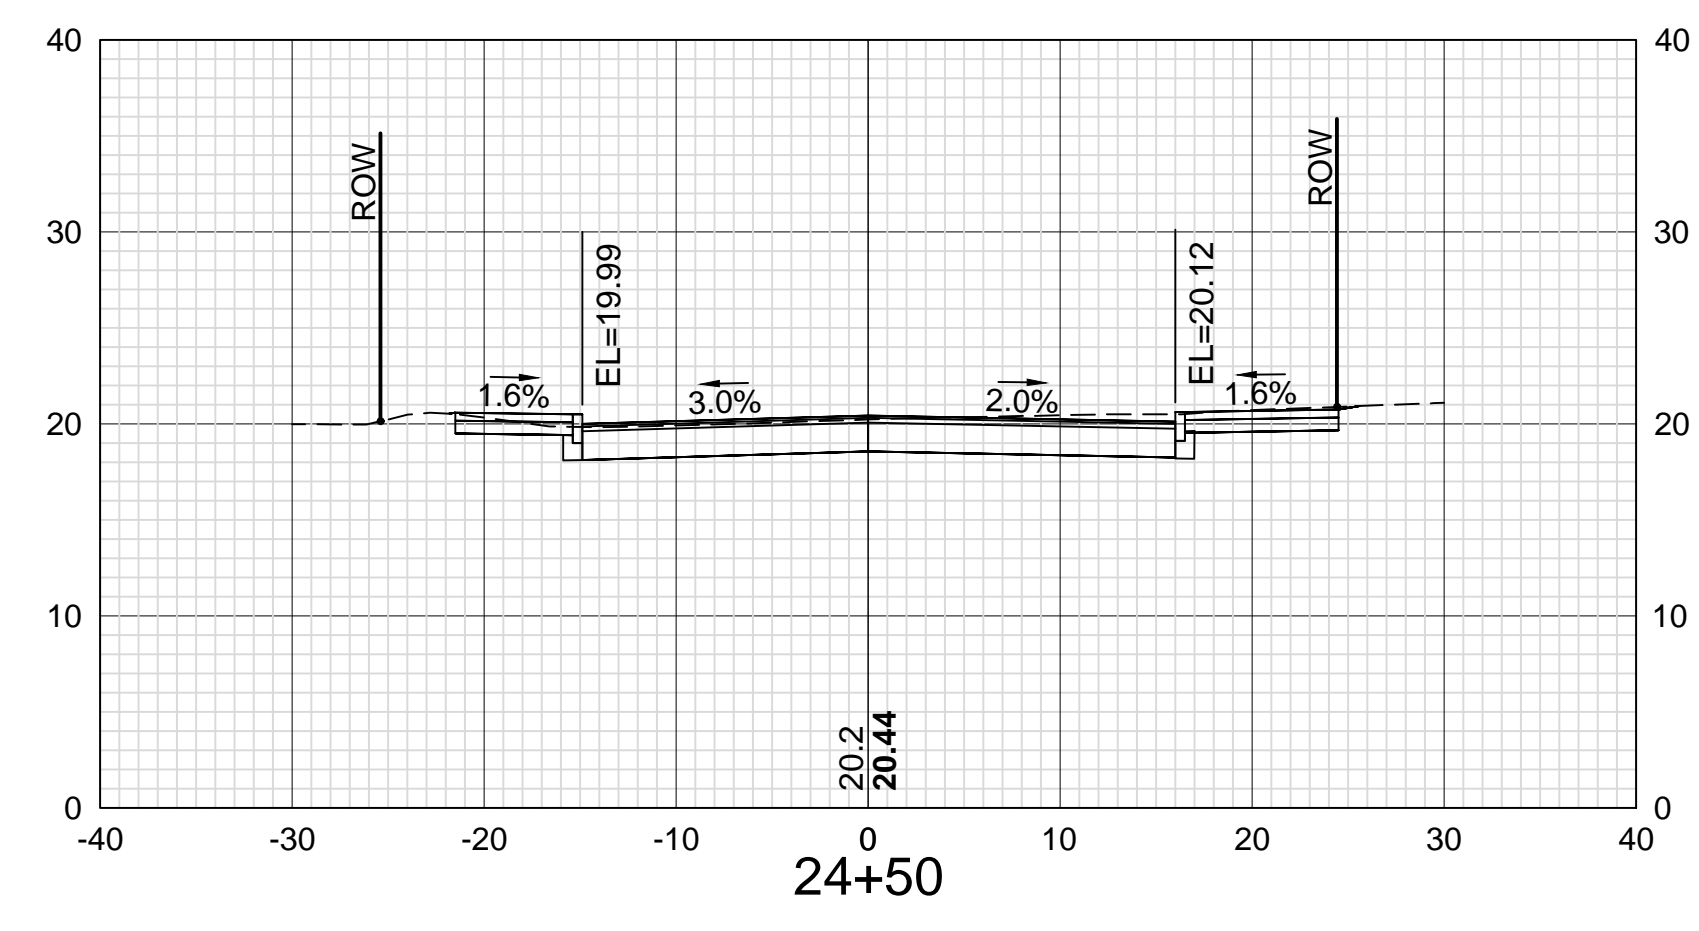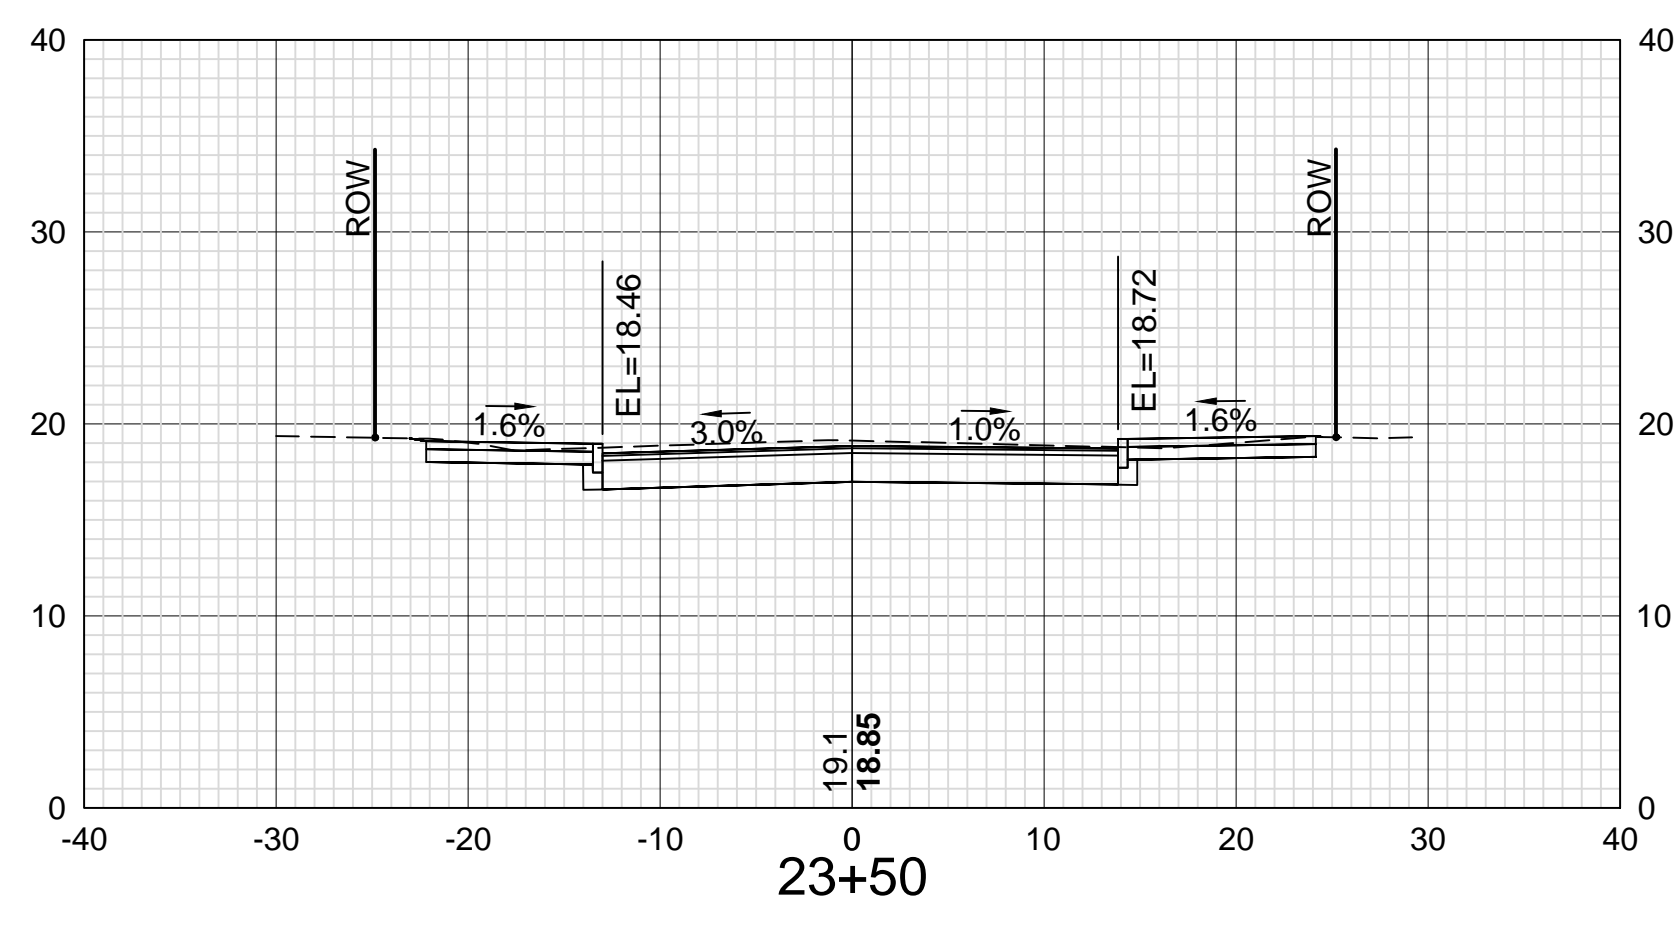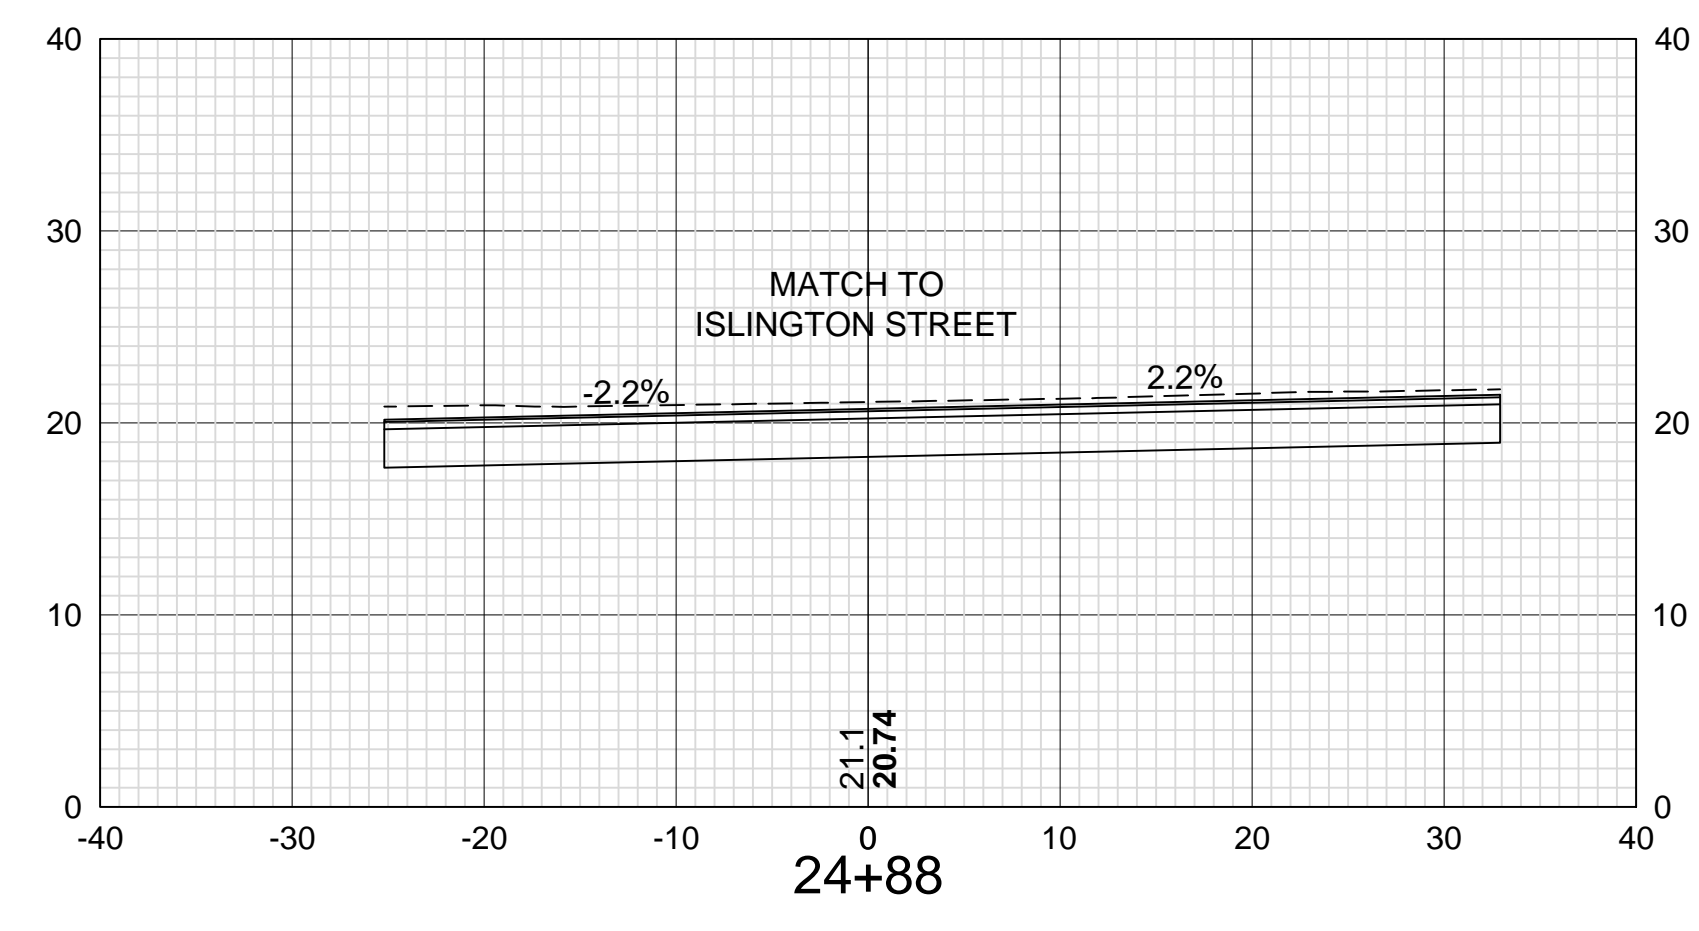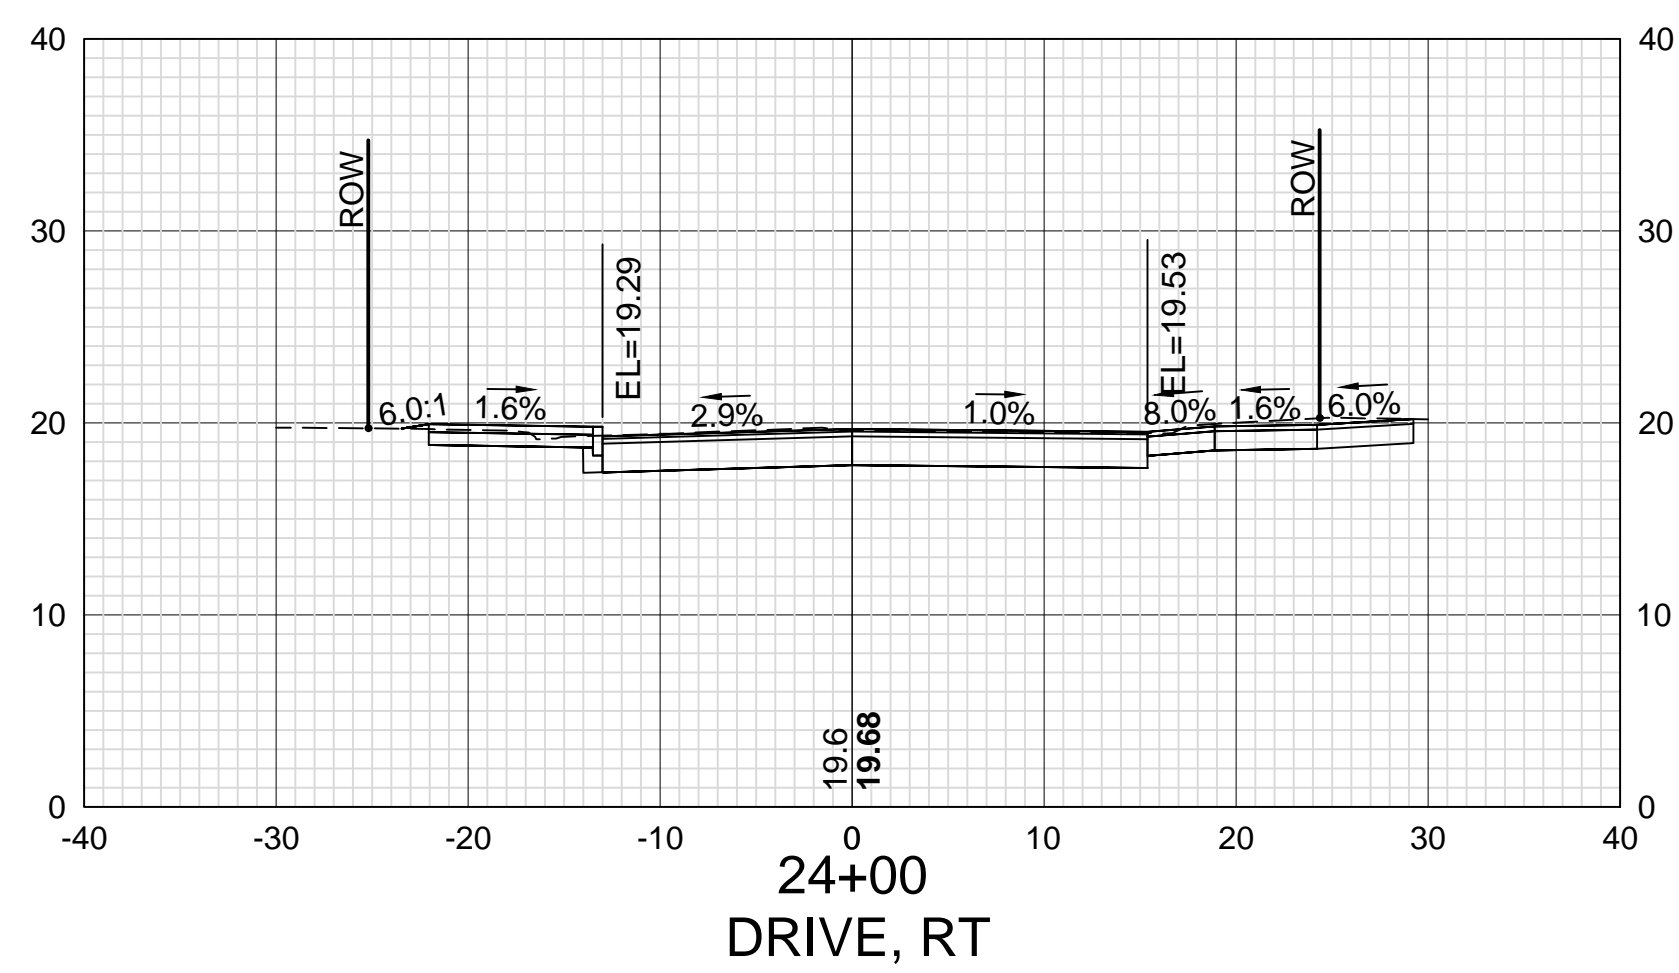












DATE PLOTTED
13-Nov-18

VHB PROJECT NO.
52393.00

ISLINGTON STREET CORRIDOR IMPROVEMENTS - SEGMENT 1				
CITY OF PORTSMOUTH, NEW HAMPSHIRE				
CROSS SECTIONS				
COLUMBIA STREET				
DRAWING	CITY PROJECT NO.	SHEET NO.	TOTAL SHEETS	
XS-Seg1	7176	72	88	

REVISIONS AFTER PROPOSAL	STATION	DATE	NUMBER

SDR PROCESSED	VHB	DATE	OCT 2017
NEW DESIGN	KMH	DATE	11/13/18
SHEET CHECKED	GLB	DATE	11/13/18
AS BUILT DETAILS		DATE	

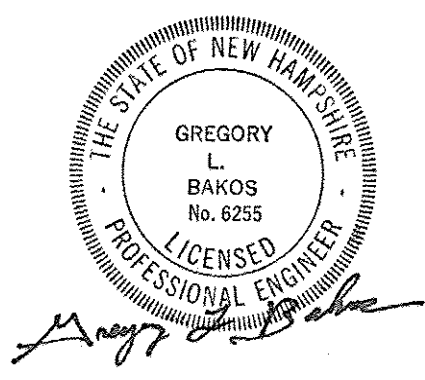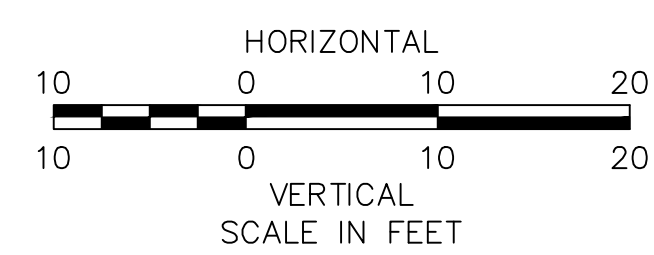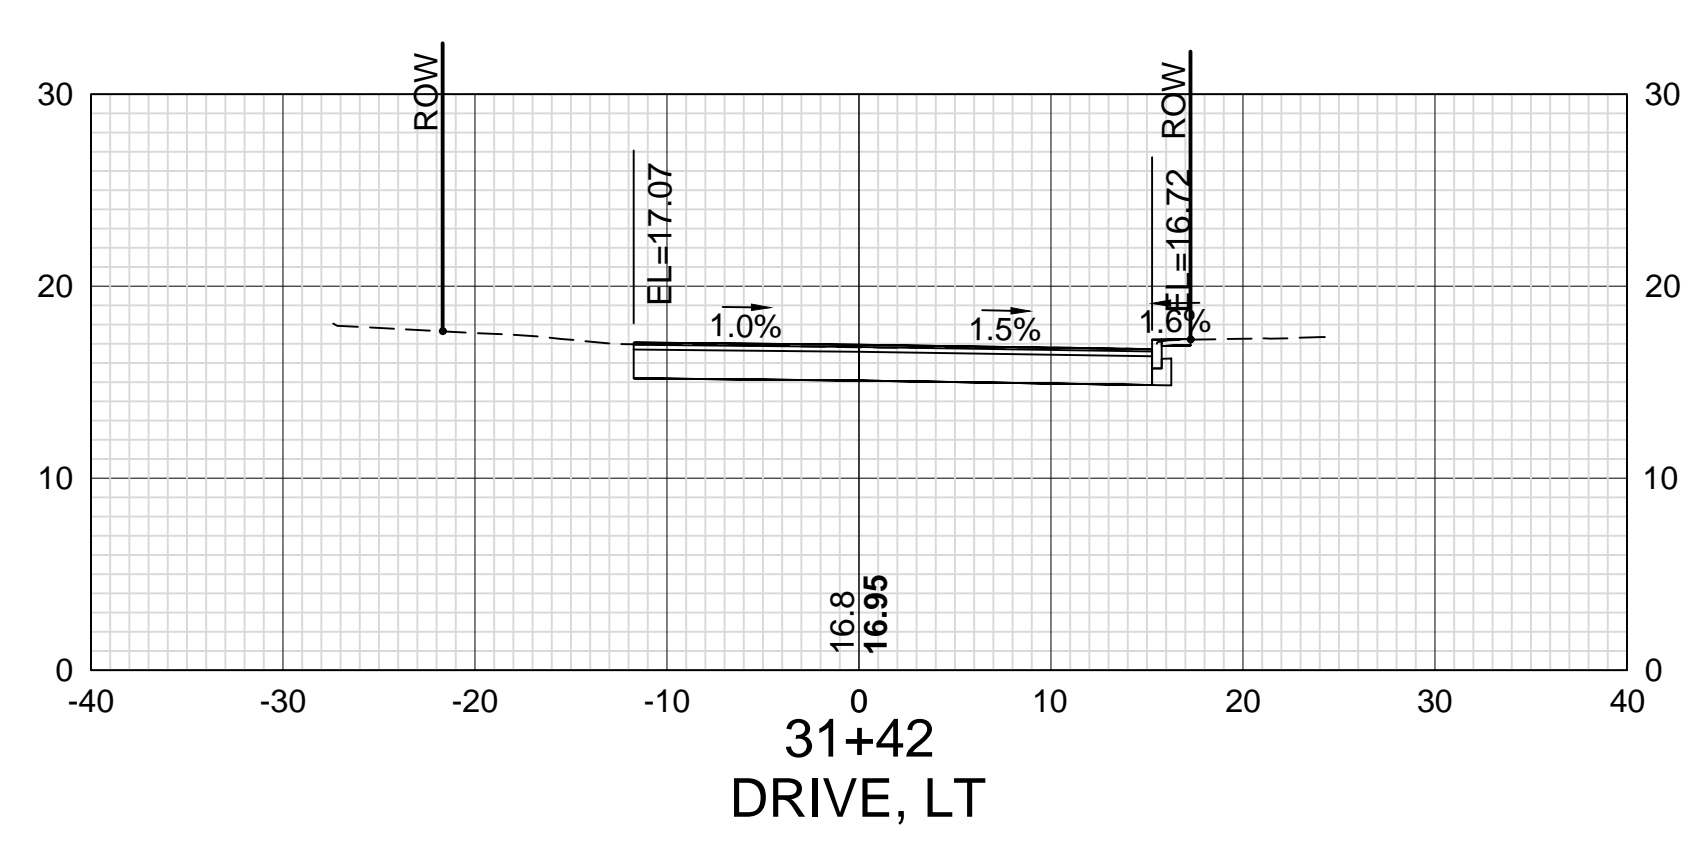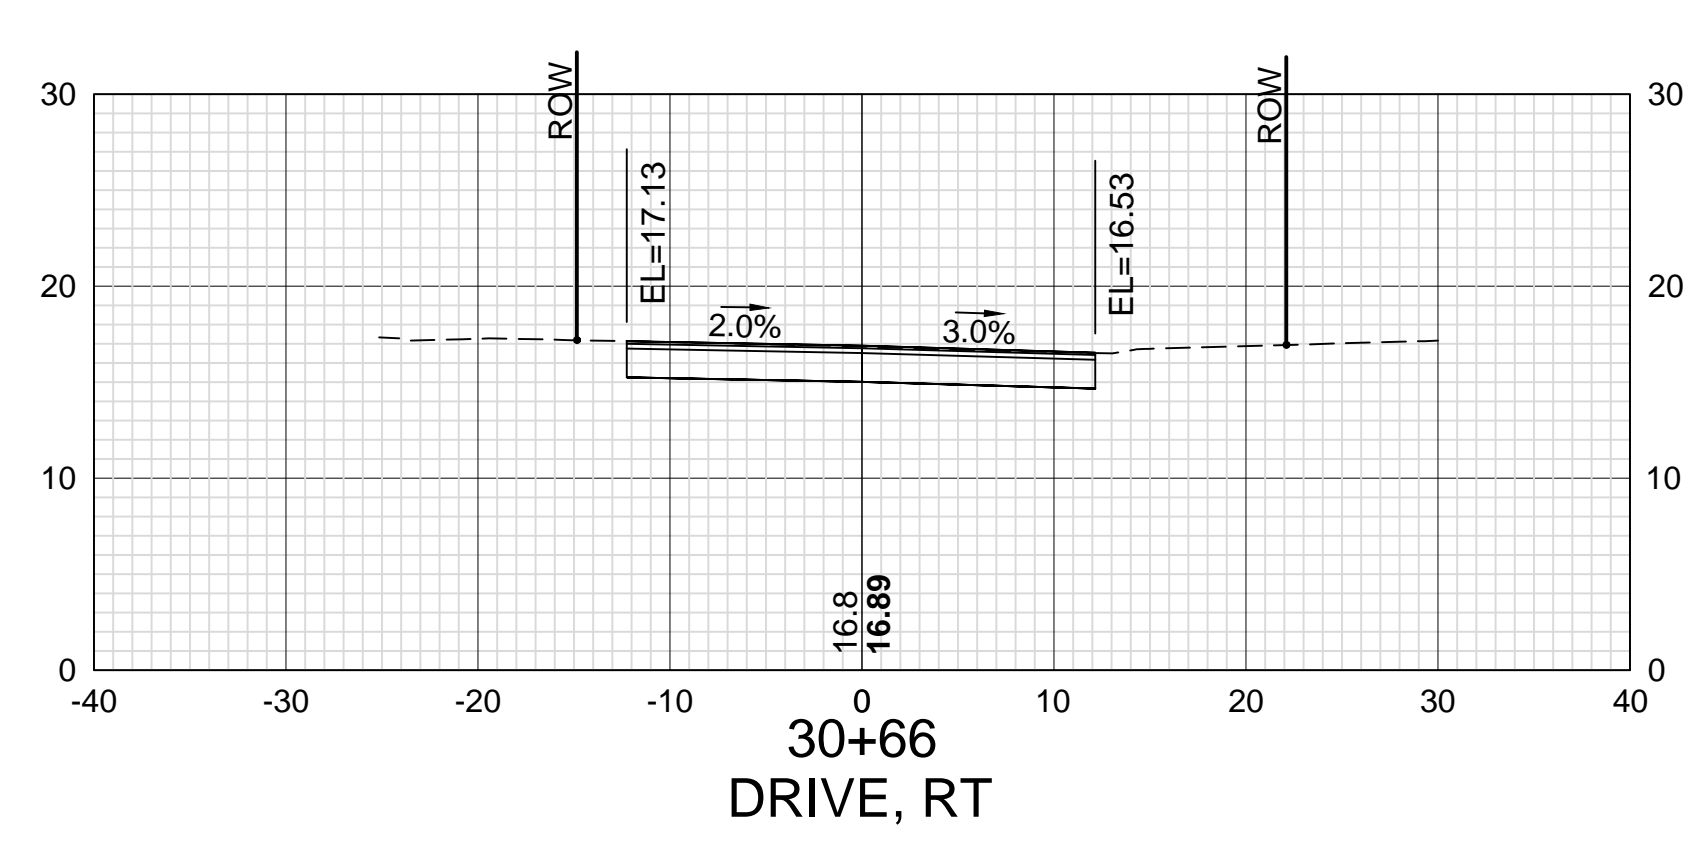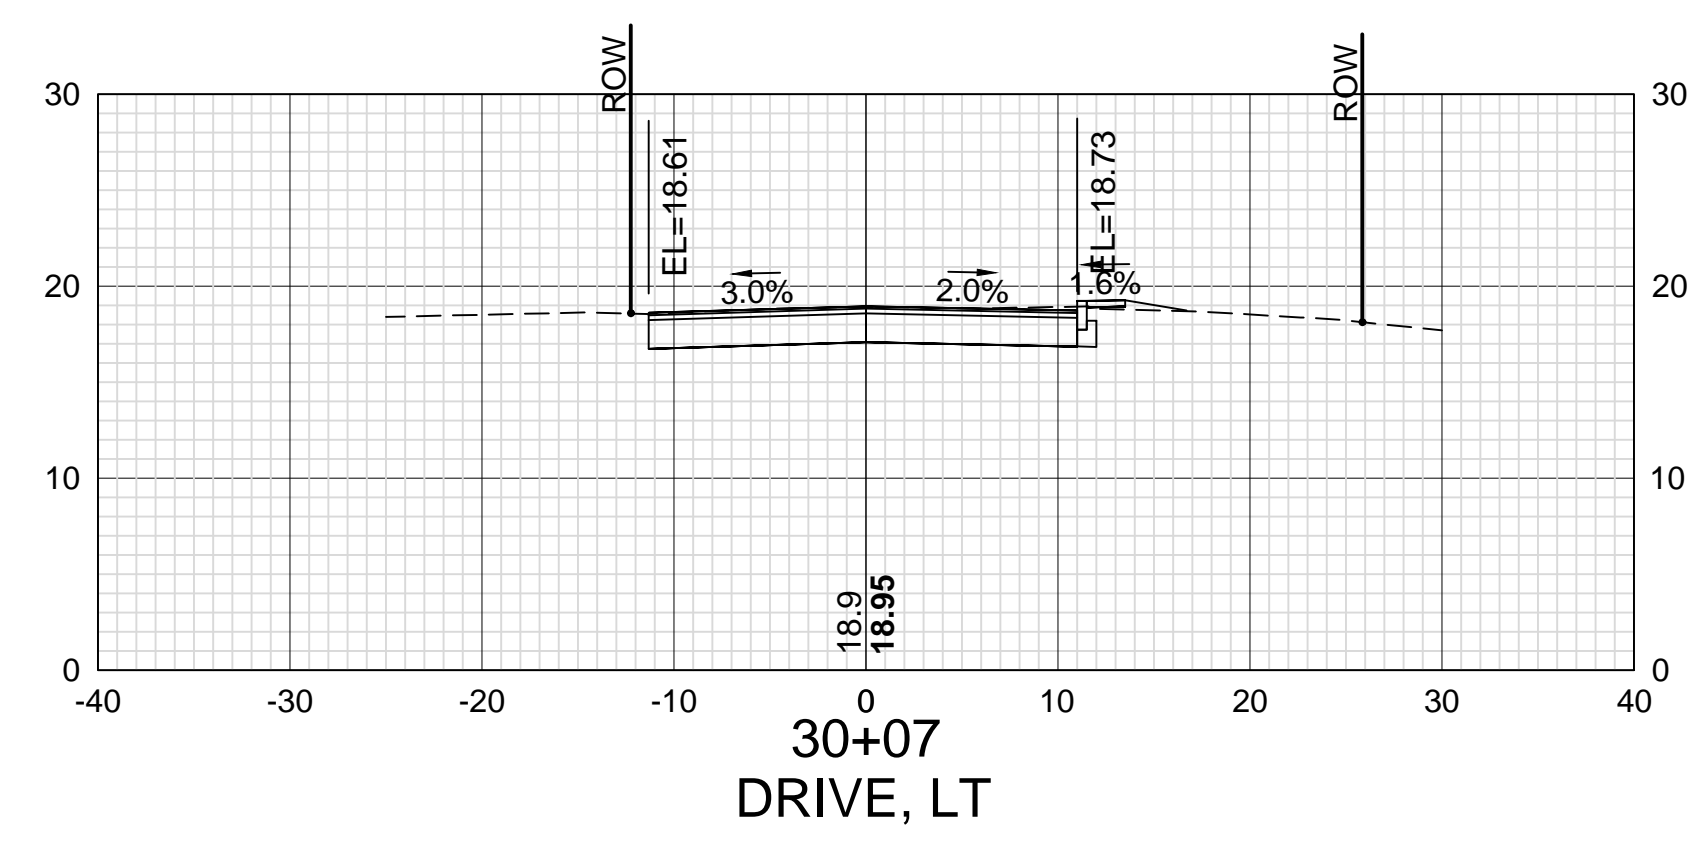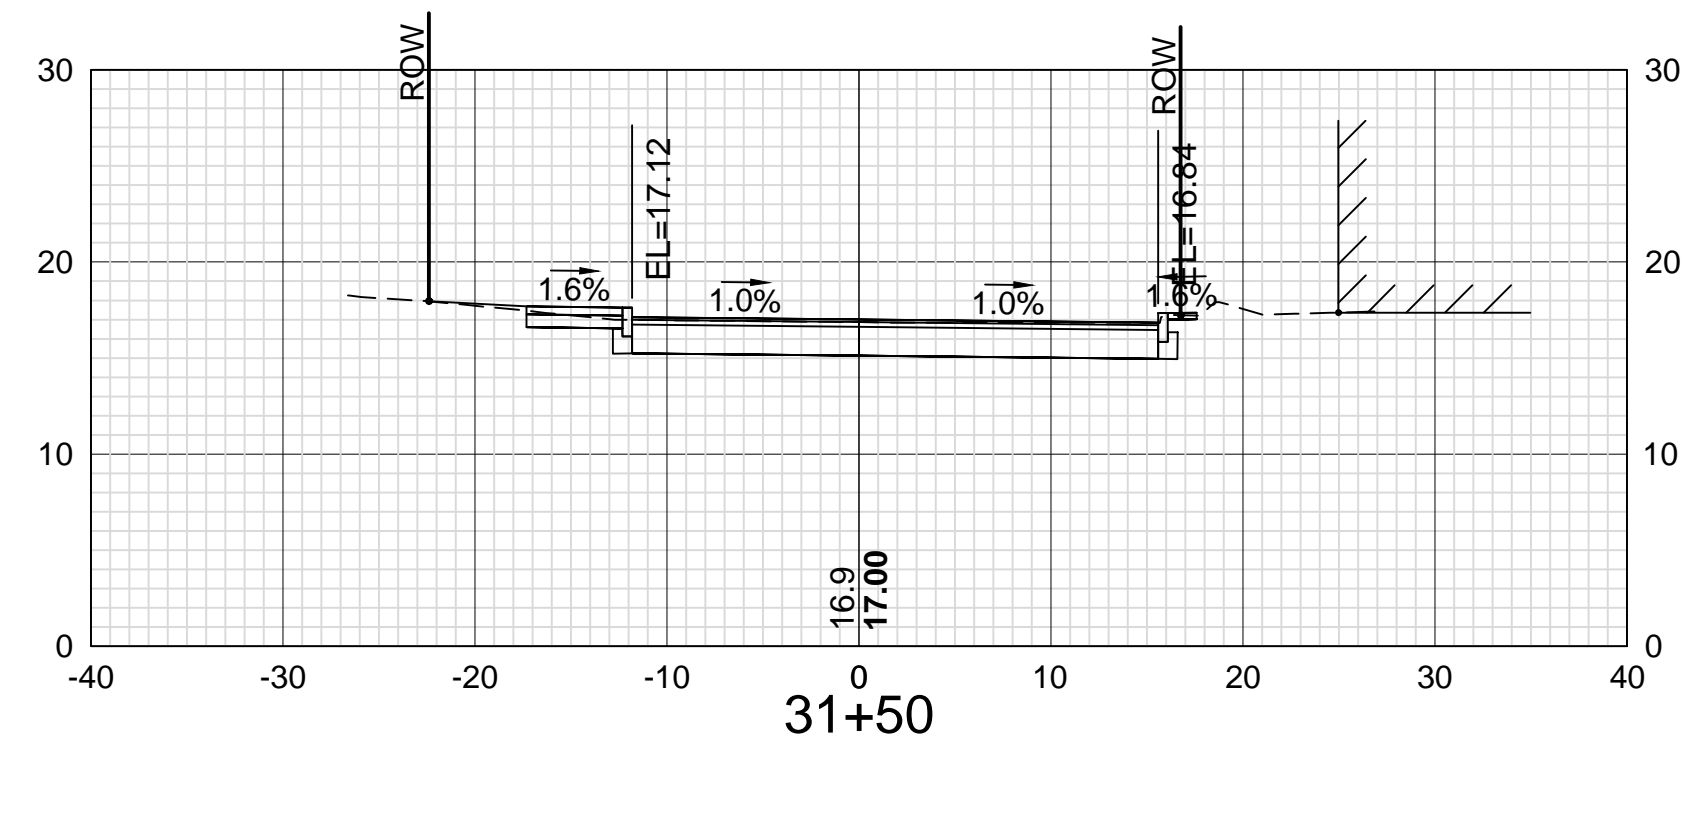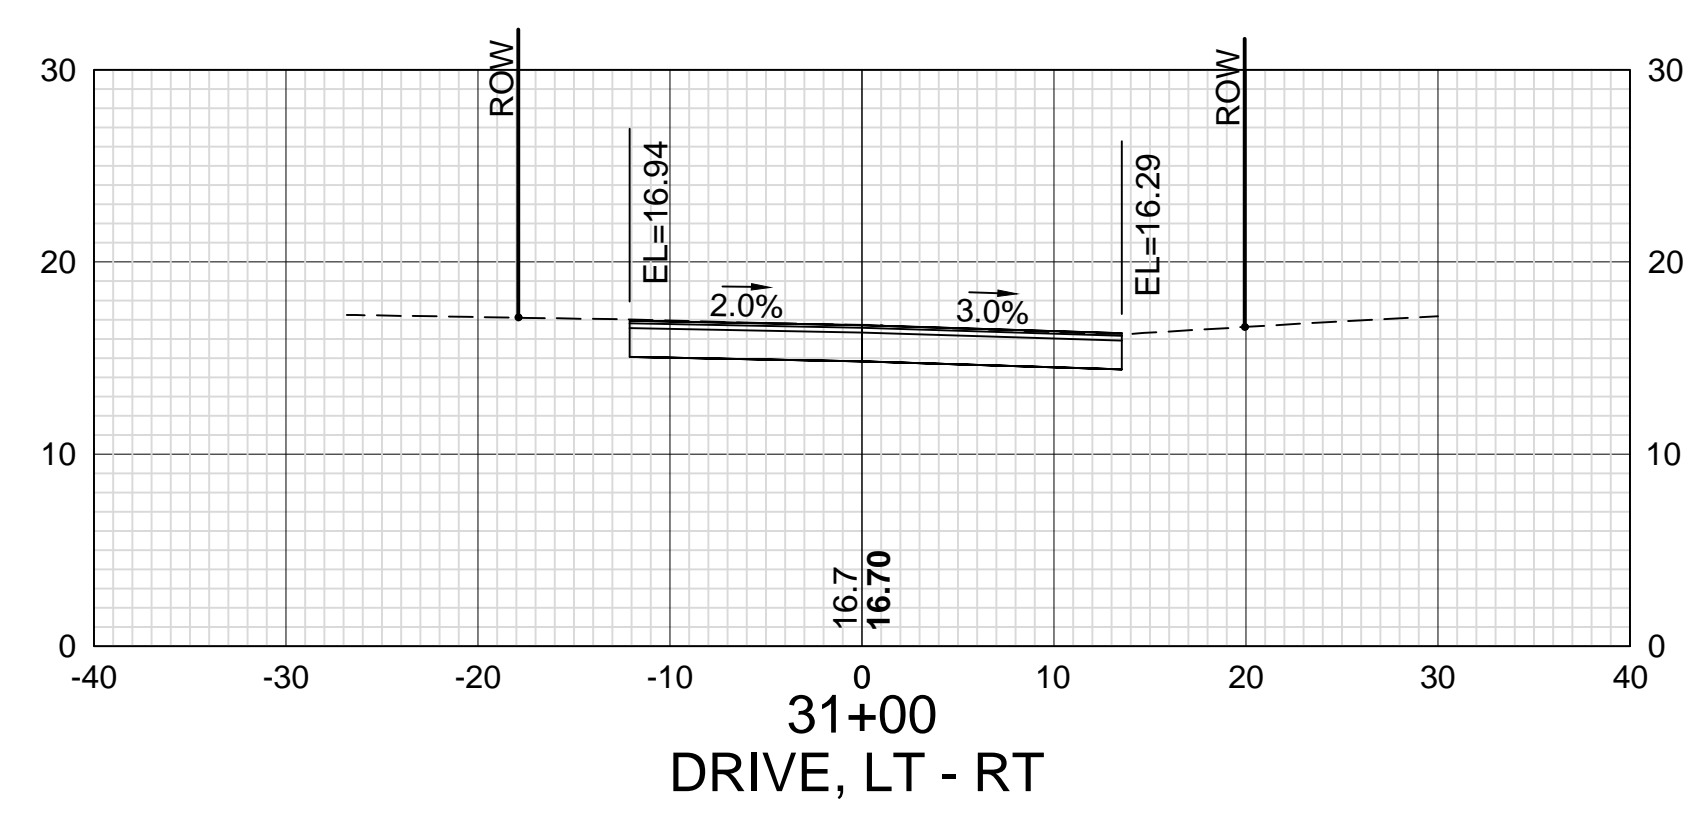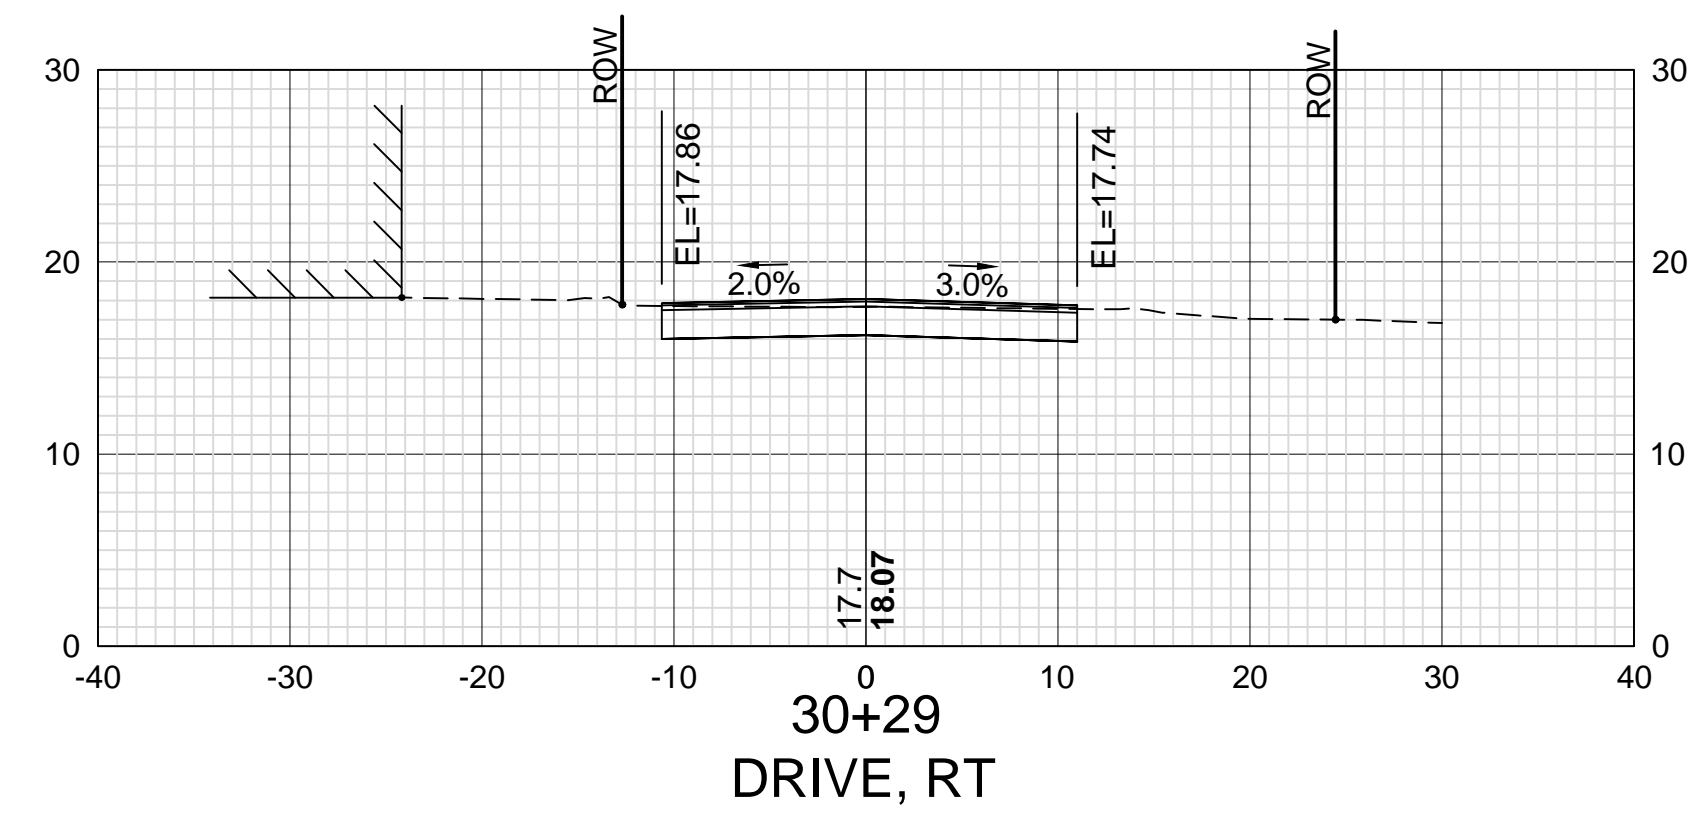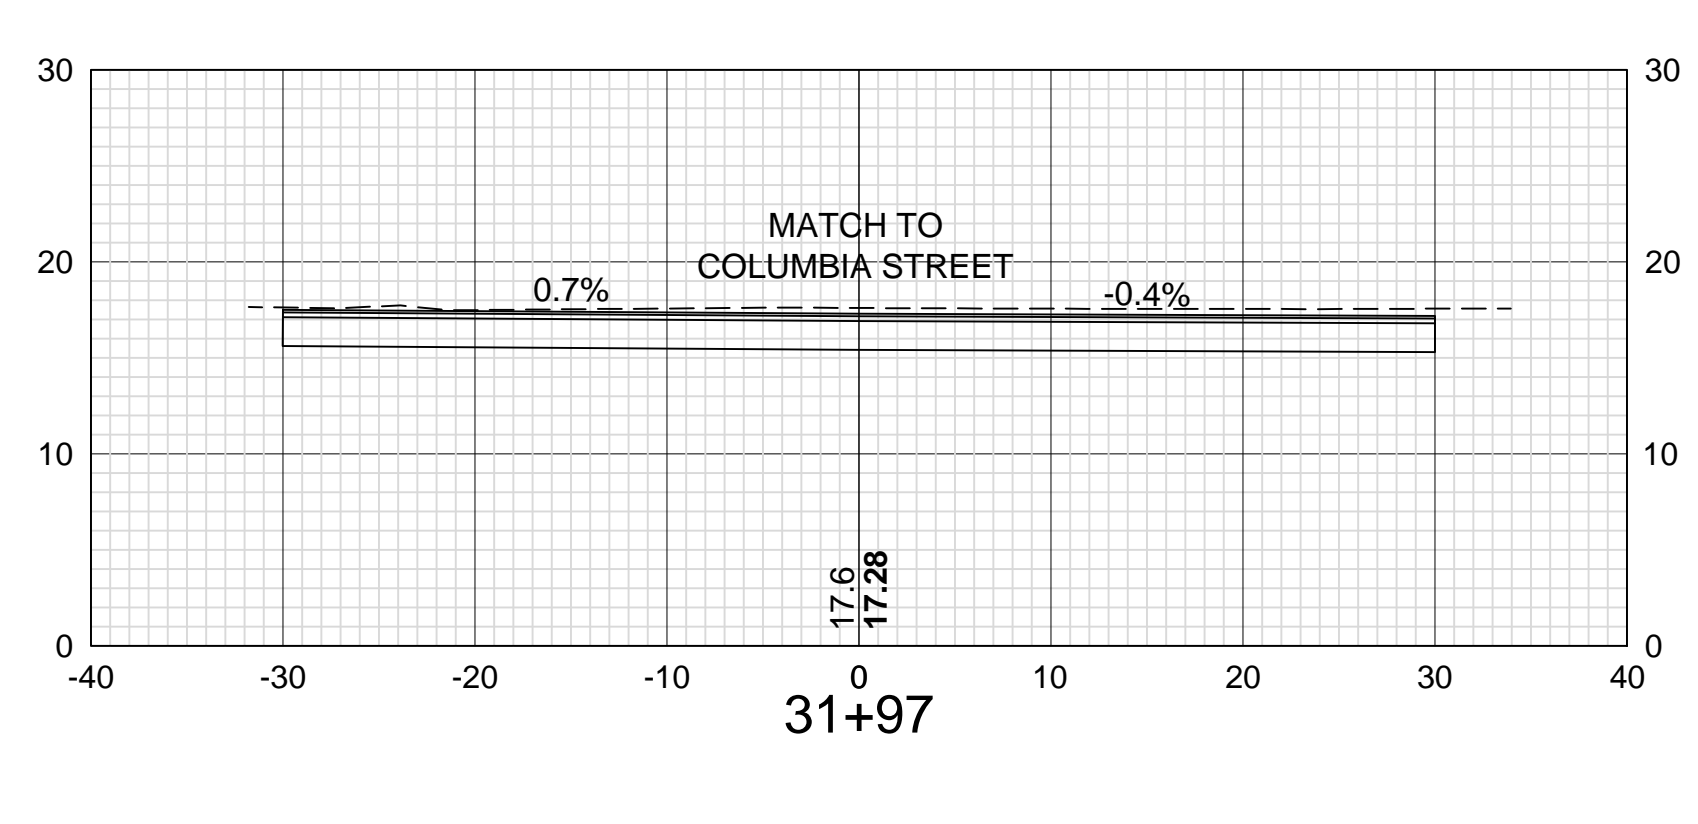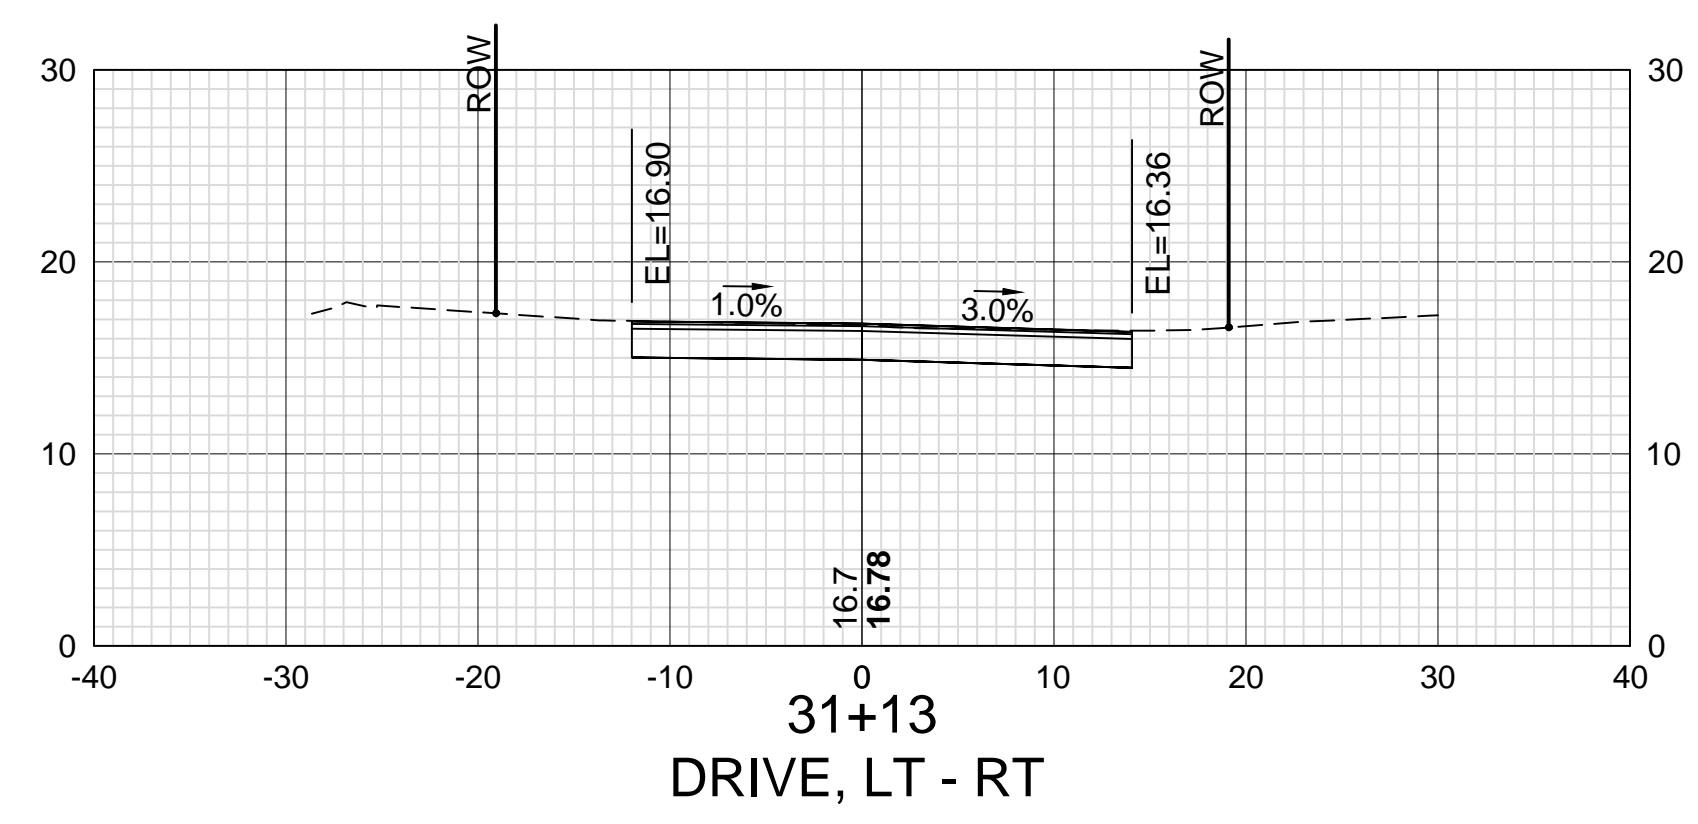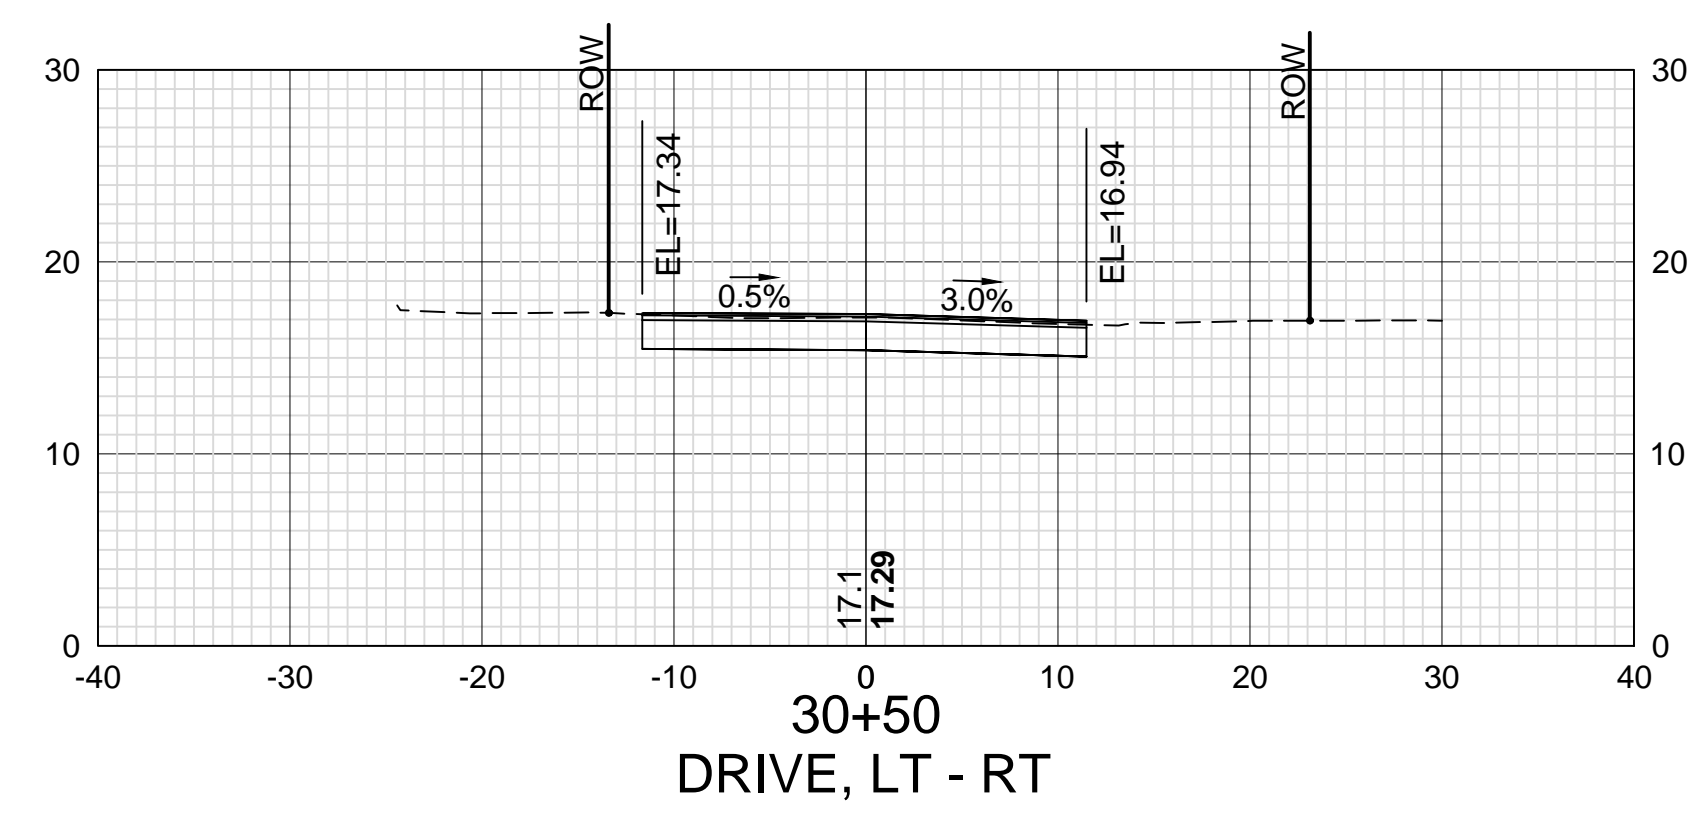

ISLINGTON STREET CORRIDOR IMPROVEMENTS - SEGMENT 1					
CITY OF PORTSMOUTH, NEW HAMPSHIRE					
CROSS SECTIONS					
COLUMBIA COURT					
DATE PLOTTED	VHB PROJECT NO.	DRAWING	CITY PROJECT NO.	SHEET NO.	TOTAL SHEETS
13-Nov-18	52393.00	XS-Seg1	7176	73	88



UTILITY LEGEND:


EXISTING	PROPOSED	
		SEWER LINE
		DRAIN LINE
		WATER LINE
		METER PIT
		WATER GATE
		WATER SHUTOFF
		DRAIN MANHOLE
		CATCH BASIN
		SEWER MANHOLE
		CLEANOUT
		SEWER/DRAIN LINE
		WATER LATERAL APPROX. LOC
		SEWER LATERAL APPROX. LOC
		HYDRANT
		GAS VALVE/GAS SHUTOFF
		GAS LINE
		RECORD GAS LINE (UNITIL JAN 2018)
		REDUCER
		TEE
		COUPLING
		TELEPHONE MANHOLE
		UNDERGROUND TELEPHONE LINE
		OVERHEAD WIRE
		PIPE LABEL
		ROOF DRAIN

UTILITY ABBREVIATIONS

AC/ACP	ASPHALT CONCRETE PIPE
bs	BUILDING SURVEY
CB	CATCH BASIN
CI/CIP	CAST IRON PIPE
CL 52	CLASS 52 PIPE
CMP	CORRUGATED METAL PIPE
CU	COPPER PIPE
DI	DUCTILE IRON PIPE
DMH	DRAIN MANHOLE
gis	CITY OF PORTSMOUTH GIS SYSTEM
HDPE	HIGH DENSITY POLYETHYLENE PIPE
I	INVERT ELEVATION
INV	INVERT ELEVATION
NIC	NOT IN CONTRACT
PE	POLYETHYLENE PIPE
PVC	POLYVINYL CHLORIDE PIPE
R	RIM ELEVATION
RCP	REINFORCED CONCRETE PIPE
ref.	REFERENCE PLAN
S	SLOPE (PIPE)
SMH	SEWER MANHOLE
TBD	TO BE DETERMINED
tie	CITY OF PORTSMOUTH TIE SHEETS
UP	UTILITY POLE

UTILITY PLAN INDEX

SHEET TITLE	DWG. NO.	SHT. NO.
UTILITY PLAN INDEX	U-1	74
QUANTITY SUMMARY – UTILITIES	U-2	75
UTILITY PLAN NOTES	U-3	76
ISLINGTON ST. UTILITIES PLAN & PROFILE (PHASE 1)	U-4 to U-9	77-82
COLUMBIA ST. UTILITIES PLAN & PROFILE (PHASE 1)	U-10	83
COLUMBIA CT. UTILITIES PLAN & PROFILE (PHASE 1)	U-11	84
STANDARD SEWER DETAILS	U-12	85
DRAINAGE DETAILS	U-13	86
STANDARD WATER DETAILS	U-14	87
STANDARD MISC DETAILS	U-15	88

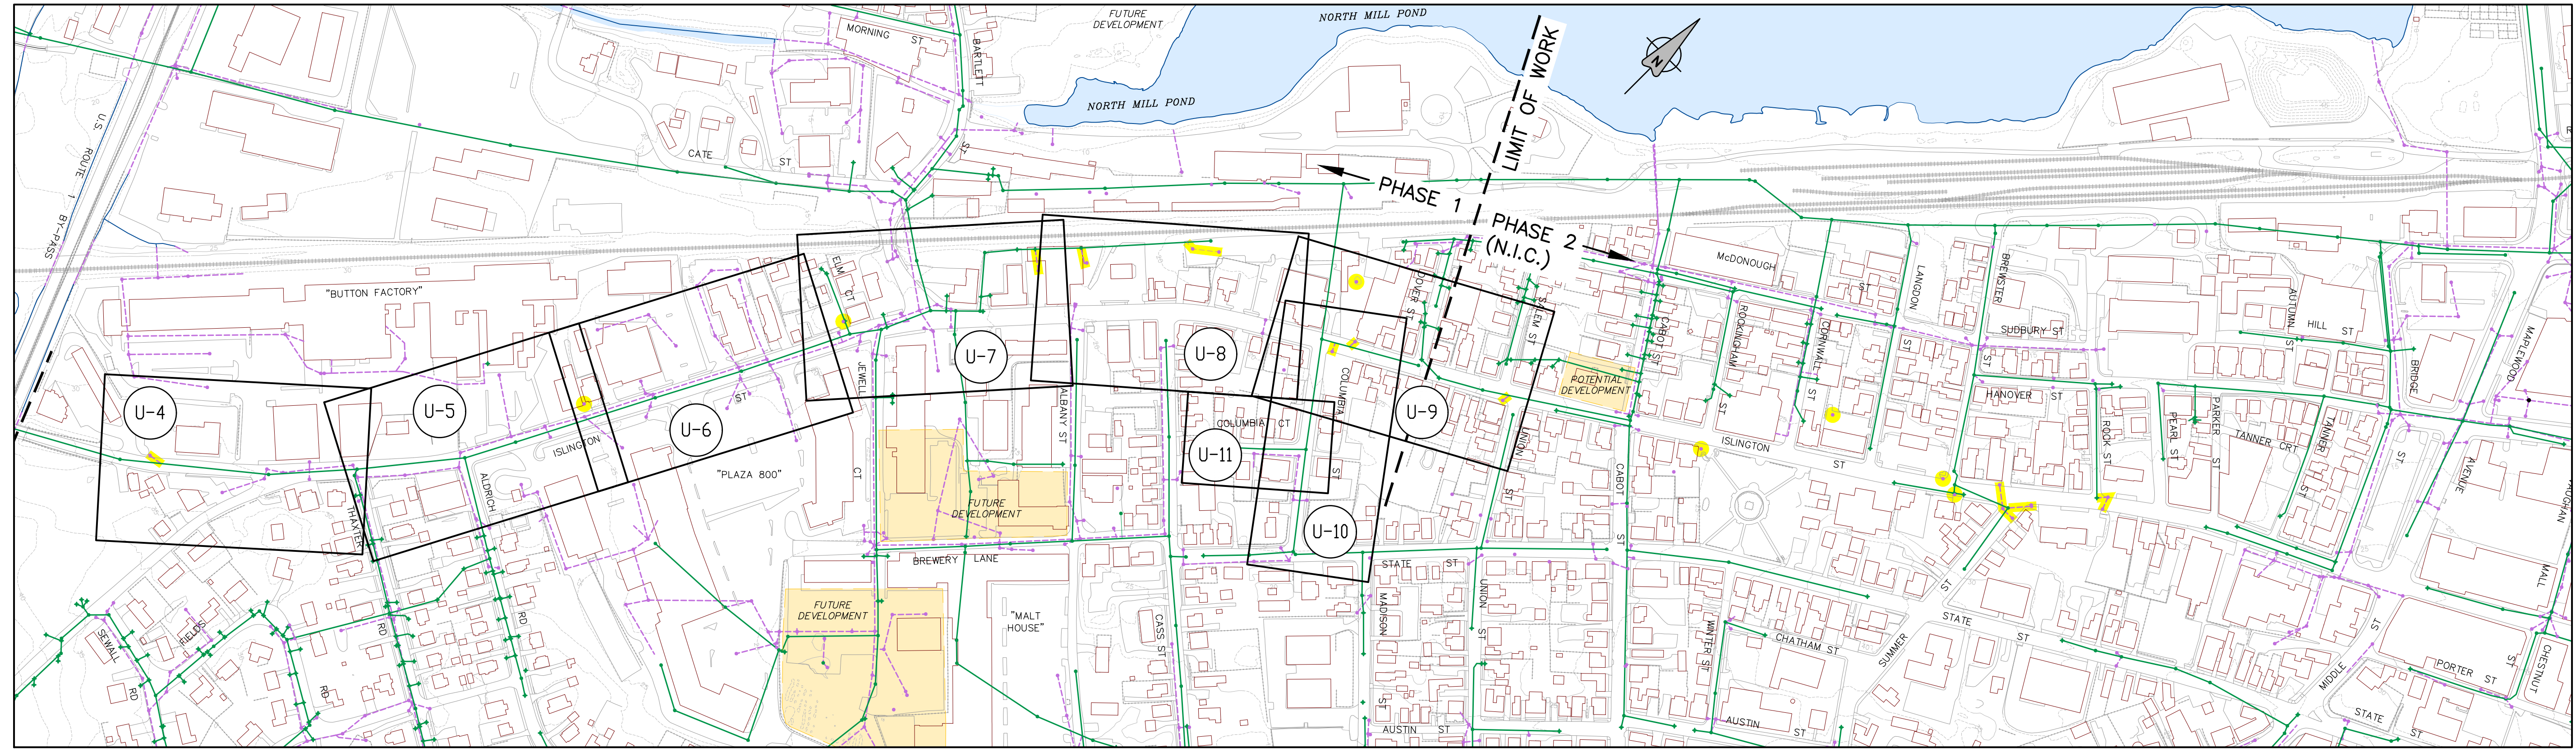

LEGEND:

	CB/STRUCTURE & DRAIN LINE
	MH/CONNECTION & SEWER LINE
	SUSPECTED DRAINAGE CONNECTION TO SEWER

UTILITY PLAN INDEX MAP
SCALE: 1 INCH = 200 FT.

ISSUE FOR	APPROVAL	DATE	BY
CONSTRUCTION		5/9/18	DAW
RECORD DWG		1/11/19	DAW
NO.	REVISIONS		
1	APPD		

Drawn/Chk	RMG	DAW
Designed	DAW	
Checked	PDM	
Approved		
Date	1/7/2019	
Book No.	2029	
Project No.	2029	
Dwg. ID	AS_SHOWN	
Scale		

JAMES P. PRATT
PROFESSIONAL ENGINEER
NO. 8831

JAMES P. PRATTE
PROFESSIONAL ENGINEER
NO. 18457

UNDERWOOD
engineers

25 Vaughan Mall, Portsmouth, N.H. 03801
Tel. 603-436-6192 Fax. 603-431-4733

<p>UTILITY PLAN INDEX</p> <p>ISLINGTON STREET CORRIDOR IMPROVEMENTS</p> <p>CITY OF PORTSMOUTH</p> <p>PORTSMOUTH, NEW HAMPSHIRE</p>	<p>DWG NO U-1</p> <p>SHEET 74 OF 88</p>
---	---

SEWER PIPE QUANTITY SCHEDULE

Dwg. No.	Location	Item No./Item (Lin. Ft.)				
		1.1.08 8" PVC	1.1.10 10" PVC	1.1.12 12" PVC	1.1.15 15" PVC	
U4	100+95 to 106+35					
	104+00 LT (Note 1)		22			492
	104+00 RT	51				
	104+32 LT (Note 1)		5			
	106+35 RT					8
U5	106+37 to 112+00					552
	108+95 RT	23				
U6	112+00 to 117+50					540
	114+15 LT (Note 2)					
	116+50 RT (Note 3)	26				
U7	117+50 to 118+95					141
	120+82 to 123+00					218
	118+31 LT		40			
	118+57 LT	15				
U8	123+00 to 128+50					535
U9	128+50 to 129+20					70
	129+26 to 131+59	253				
	130+05 LT (Note 4)	100				
U10	24+95 to 20+00					500
	20+00 RT					35
	20+00 LT	104				
U11	30+36 to 32+04	168				
	Subtotal:	740	67			3091
	Rounding:	40	13	50	59	
	Total Est. Quantity:	780	80	50	3150	

- Notes
- Services old Button Factory area.
 - Services 801 Islington St.
 - Services Plaza 800.
 - Service for 459 Islington St. Still under review.

WATER PIPE QUANTITY SCHEDULE

Dwg. No.	Location	Item No./Item (Lin. Ft.)					
		3.1.04 4" DI	3.1.06 6" DI	3.1.08 8" DI	3.1.10 10" DI	3.1.12 12" DI	3.1.16 16" DI
U4	101+20 to 106+50						592
U5	106+50 to 112+00						550
	106+60 RT			30			
	109+05 RT			25			
U6	112+00 to 117+50						550
	112+50 RT						
U7	117+50 to 118+45						95
	118+20						
	120+98 to 123+00						202
	123+00 to 128+50						550
U8	123+60 RT			16			
	125+50 RT			20			
	125+97 LT		35				
U9	128+50 to 131+85						335
	131+55 LT		55				
U10	20+10 to 24+95			514			
U11	30+00 to 30+25						
	30+26 to 32+20		194				
	Water Services (Private)	184	160	121			
	Subtotal:	184	444	726			2874
	Rounding:	16	36	54	50	50	96
	Total Est. Quantity:	200	480	780	50	50	2970

DRAINAGE PIPE QUANTITY SCHEDULE

Dwg. No.	Location	Item No./Item (Lin. Ft.)				
		603.822 12" PE	603.822 15" PE	603.822 18" PE	603.822 24" PE	603.00330 30" PVC SDR35
U4	102+75 to 103+70	163				
	103+73 to 106+41		180			
	104+52 LT	12				
	106+19 to 106+42	21				
	106+38 LT	5				
	106+42			26		
U5	106+44 to 108+83			235		
	107+28	18				
	108+86 to 110+04			118		
	108+86 to 112+00				311	
	111+30 LT	14				
U6	112+00 to 116+30			426		
	113+30 RT	29				
	116+32 to 117+50					118
U7	117+50 to 118+96					140
	118+20 LT	23				
	118+35 RT	18				
	118+45	24				
	120+20 to 121+45			115		
	121+45 to 122+47	167				
U8	125+42 to 128+16	367				
	128+21 to 128+50		30			
U9	128+50 to 129+09		58			
	129+14 to 129+70	75				
U10	22+30 to 25+10			278		
	19+86 to 22+25			231		
	21+88	20				
	21+50 LT	15				
	20+13 LT	17				
U11	30+45 to 32+00	150				
	Subtotal:	1138	661	610	737	258
	Rounding:	102	29	30	23	12
	Total Est. Quantity:	1240	690	640	760	270

SERVICE PIPE QUANTITY SCHEDULE (INDIVIDUAL PROPERTIES)

Dwg. No.	Address	Item No./Item								Comments/Instructions	
		1.1.06A 6" PVC (in R-O-W)	1.1.06B 6" PVC (on Private Property)	603.8221 6" PE Drain	3.2.10 1" Copper	3.2.15 1-1/2" Copper	3.2.20 2" Copper	3.240 4" DI	3.106 6" DI		3.108 8" DI
U4	1046 Islington	18									
	1036 Islington	18									
	1001 Islington	25						40			
	1000 Islington	19									
	999 Islington	22						38			
	996 Islington	31									Water assumed to be serviced from Spiny Road. Field verify.
	951 Islington	20									
	966 Islington	37						35	40		
	964/962 Islington	30									
	933 Islington								42		
	954 Islington							18			Existing sewer service to Thaxter to remain.
	933 Islington	20						15	30		
	17 Thaxter							7			Field verify locations of sewer/water services.
	921 Islington	20						15	40		
	880 Islington	30							15		
	865 Islington	20									(Note 1) 40
	874 Islington										
	875 Islington										(Note 1) 45
	869 Islington								32	33	Shares sewer service with #865 ROW between #865 AND #921
	871 Islington	20									(Note 1)
	848 Islington	22								34	(Note 2)
	833 Islington	23									
	821 Islington	25									35
U6	801 Islington									40	(Note 3)
	800 Islington									15	(Note 2)
	767 Islington	25								45	(Note 2)
	737 Islington	25									5
	725 Islington	22								33	
	738 Islington	27								15	(Note 2)
U7	Elm Court									35	(Note 3) N/A
	695 Islington										(Note 3)
	685 Islington										
	653 Islington										
	642 Islington									15	Existing water/sewer services to remain. Sewer service to Bartlett (Ref. "E").
	621 Islington									30	Existing sewer service to remain
	610 Islington										65
	601 Islington	20								31	(Note 2)
	601 Islington									12	
	566 Islington									25	
	565 Islington	20								25	Existing sewer service to Albany (Ref. "H") to remain.
	564/562/560 Islington									10	
	553 Islington	22								42	36
	559 Islington	15								28	
	544/540 Islington									16	
	539/537 Islington	25								32	33
	536 Islington	30								43	16
	531 Islington	18								73	10
	526/524 Islington									85	30
	508 Islington	32								24	20
	501 Islington										(Note 1)
U9	501 Islington	15								75	30
	460 Islington	30								50	16
	490 Islington	20								22	22
	459 Islington									(Note 3)	(Note 3)
	452/450 Islington	30								80	20
	449 Islington	22								25	28
	442 Islington	34								28	17
	439 Islington									65	
	432/430 Islington	30								55	
	469 Islington									40	
	23/25 Columbia	30								83	15
	33/35 Columbia	28								65	14
	STA 22+45 Columbia	33								40	20
	53/55 Columbia	27								60	14
	46 Columbia	13								10	30
	34/38 Columbia	19								64	32
	18/24 Columbia	20								12	45
	STA 20+40 Columbia										24
U10	15/17 Columbia	26								40	16
	21/23 Columbia	21								23	10
	33 Columbia	20								36	7
	24/26 Columbia	15								10	20
	953 State St	25								15	25
	Subtotal:	1139	428	1780	1033	114	210	184	160	121	
	Rounding:	41	42	60	37	36	40				
	Total:	1180	470	1840	1070	150	250				



- Notes
- No drainage provided. Property has existing private drainage system.
 - Drain service quantified in Drainage Pipe Quantity Schedule.
 - Sewer service quantified in Sewer Pipe Quantity Schedule.

DRAIN STRUCTURES

Dwg. No.	Structure No.	STA	Unit Items						
			604.124 4' Dia. CB (Type B)	604.184 4' Dia. CB (Curb Inlet)	604.125 5' Dia. CB	604.324 4' Dia. DMH	604.325 5' Dia. DMH	604.2 2' Dia. DI	
U4	CB 1	102+74	6.7						
	CB 2	102+75	7.1						
	CB 3	103+53	7.1						
	CB 4	103+73	7.1						
	CB 5	104+40	10.0						
	CB 6	104+52	9.9						
	CB 8	105+85		7.8					
	DI 1	103+21							3.9
	DI 2	104+50							9.4
	DMH 1	106+41				6.3			
U5	CB 10	107+27	9.0						
	CB 11	110+98	10.3						
	CB 12	111+25	9.0						
	CB 13	111+36	9.2						
	CB 9	107+27	6.4						
	DMH 2	108+84				7.8			
	DMH 3	110+07				8.2			
	DMH 4	111+90				5.4			
U6	CB 14	113+23	7.7						
	CB 15	113+36	8.0						
	CB 18	116+15	7.8						

ISSUE FOR	APPROVAL	DATE
REVISIONS	NO	
AS SHOWN	NO	
RECORD DWG	NO	
CONSTRUCTION	NO	
DATE	1/11/19	DJR
BY		
DATE	5/9/18	DJR
BY		
DATE	5/9/18	DJR
BY		


Drawn/Chk	RMG	DJR
Designed		
Checked		
Approved		
Date	1/7/2019	
Book No.	2029	
Project No.	2029bas-uti-2	
Dwg. ID	2029bas-uti-2	
Scale	AS SHOWN	

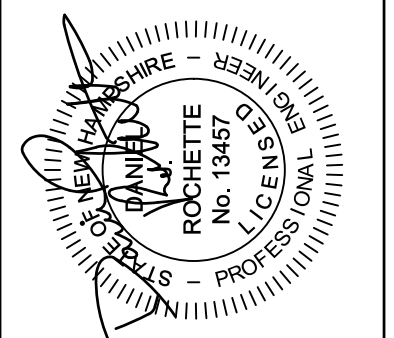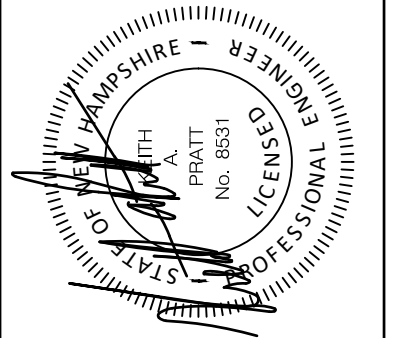


UNDERWOOD
engineers

25 Vaughan Mall, Portsmouth, N.H. 03801
Tel. 603-436-6192 Fax. 603-431-4733

UTILITIES PLAN & PROFILE
ISLINGTON STREET CORRIDOR IMPROVEMENTS
CITY OF PORTSMOUTH
PORTSMOUTH, NEW HAMPSHIRE

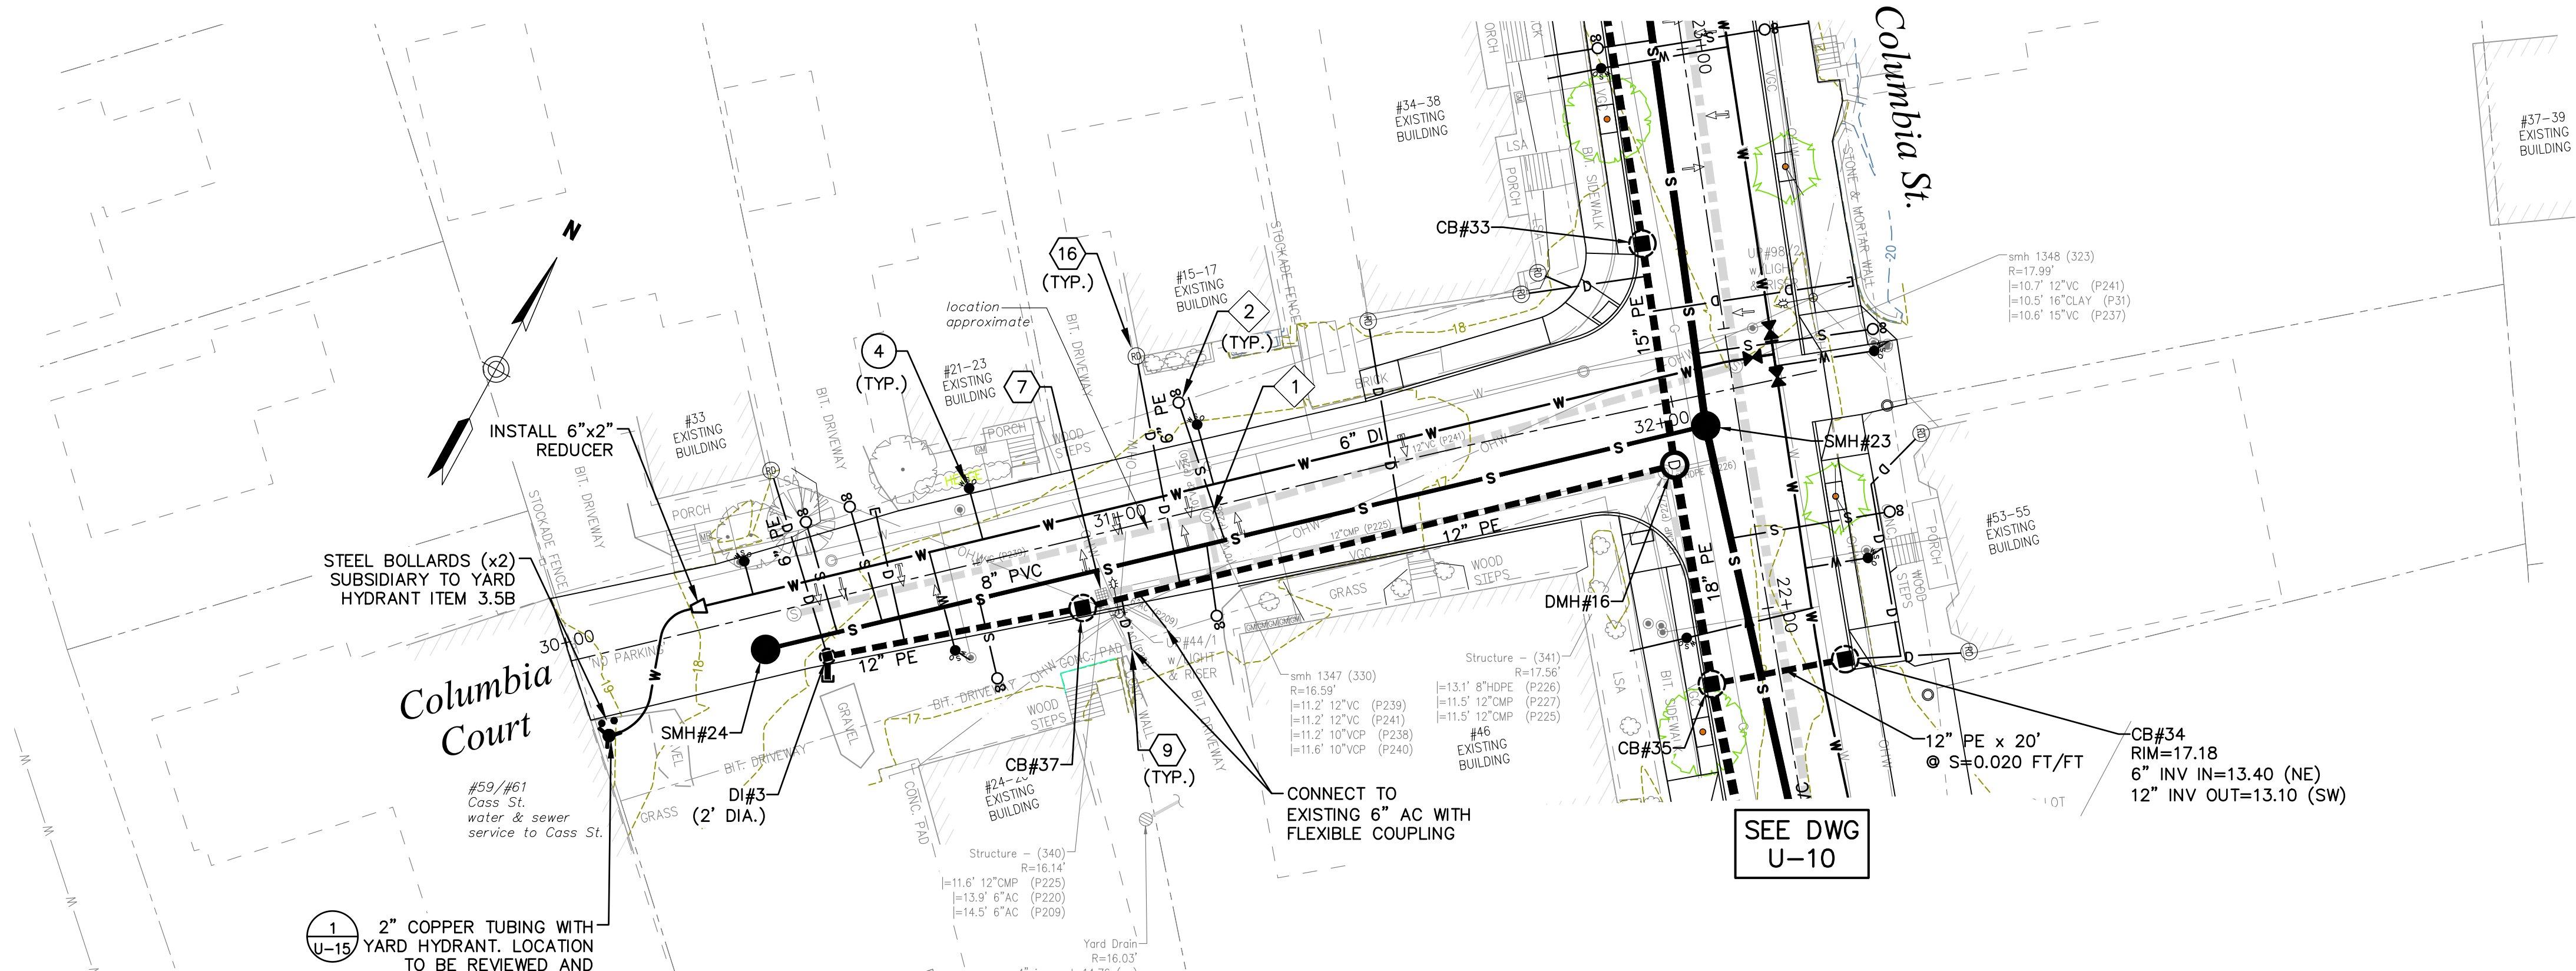


COLUMBIA COURT PLAN VIEW

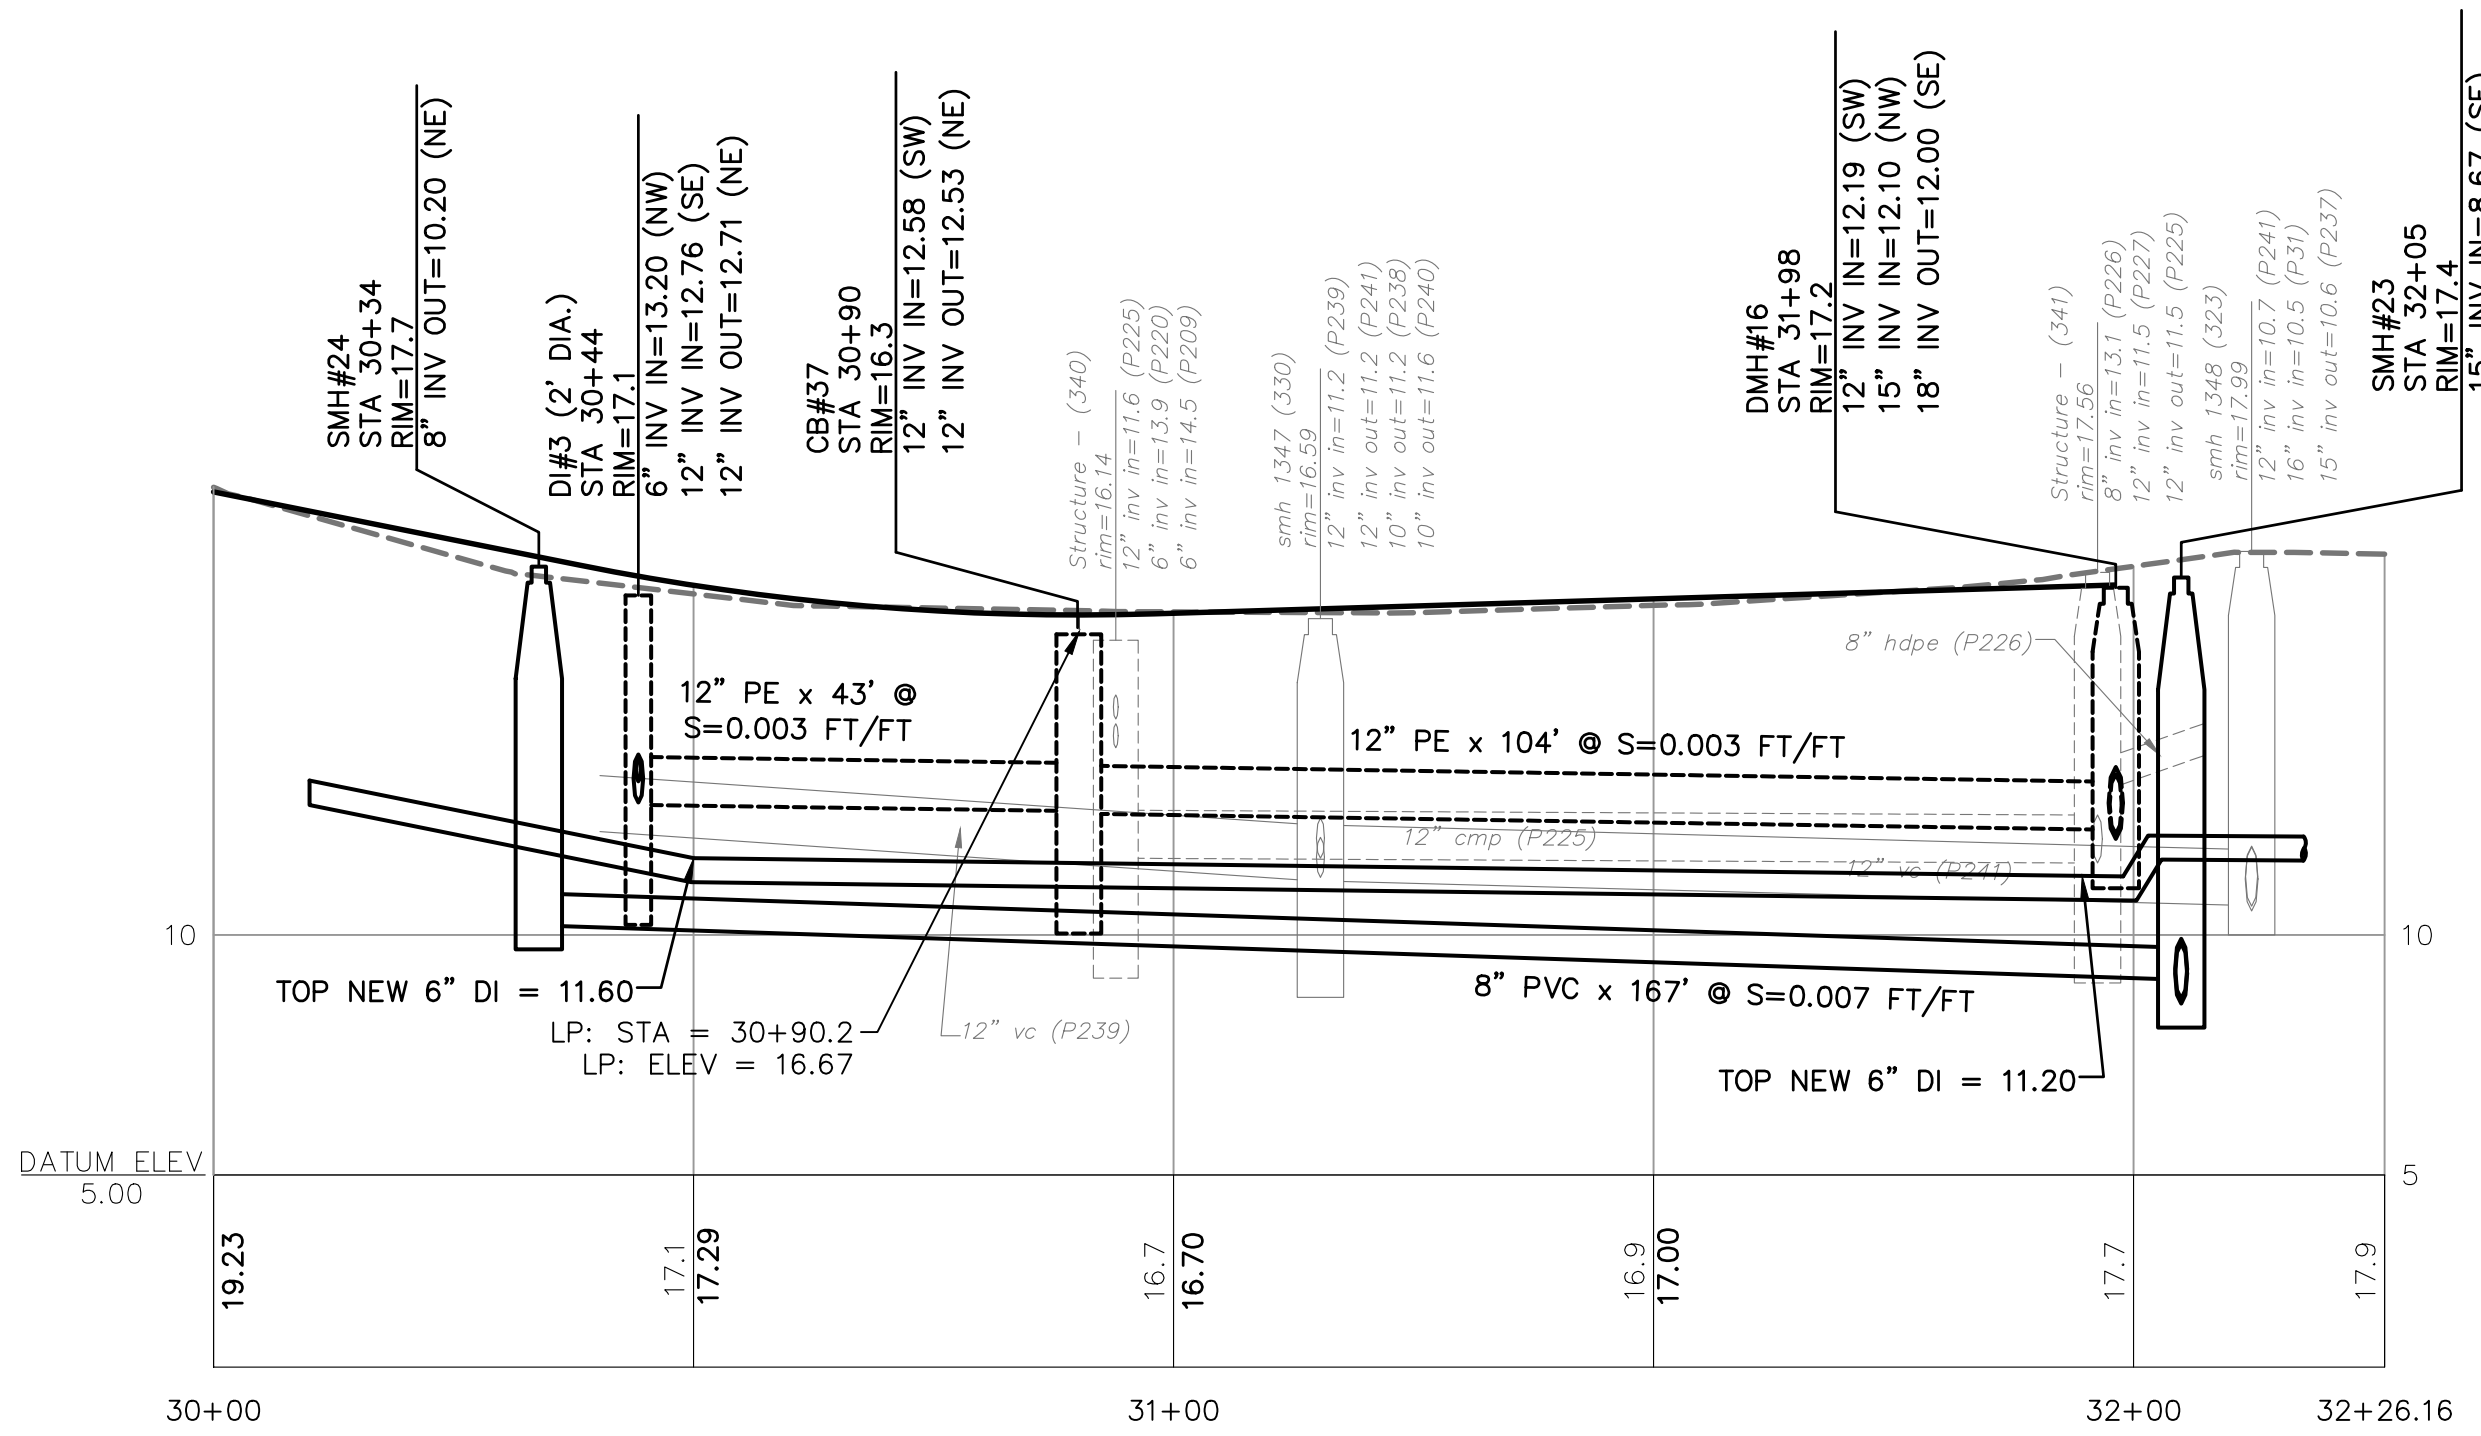

COLUMBIA COURT PROFILE VIEW



H:\Real Numbers\Portsmouth\2029\Islington Street Improvements\Drawings\2029bas_uti-2.dwg, L11, 11/20/19 12:02:52 PM.rvt

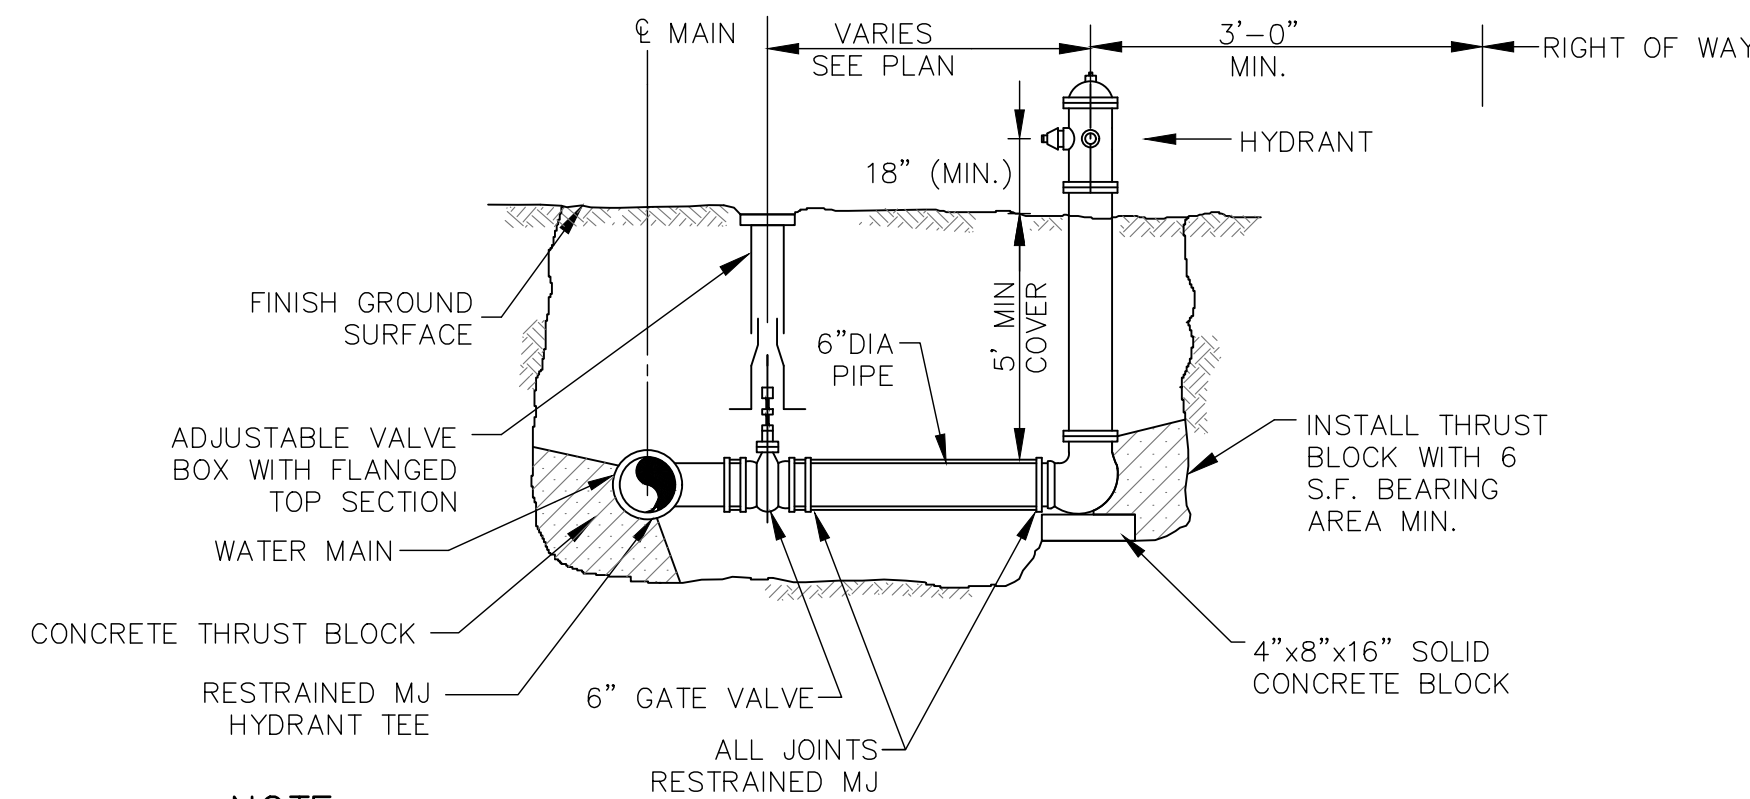


NOTE:

- HYDRANTS SHALL BE DELIVERED FROM FACTORY W/O DRAIN HOLES.
- HYDRANT ASSEMBLY INCLUDES MJ HYDRANT TEE.
- HYDRANT SHALL BE KENNEDY K-81A GUARDIAN, PER CITY OF PORTSMOUTH STANDARDS.
- LOCATE HYDRANTS A MINIMUM OF 18" BEHIND CURBING UNLESS OTHERWISE DIRECTED. REVIEW HYDRANT LOCATIONS WITH PROJECT REPRESENTATIVE PRIOR TO WATER MAIN INSTALLATIONS.

1 TYPICAL HYDRANT ASSEMBLY SECTION

U-14 NOT TO SCALE

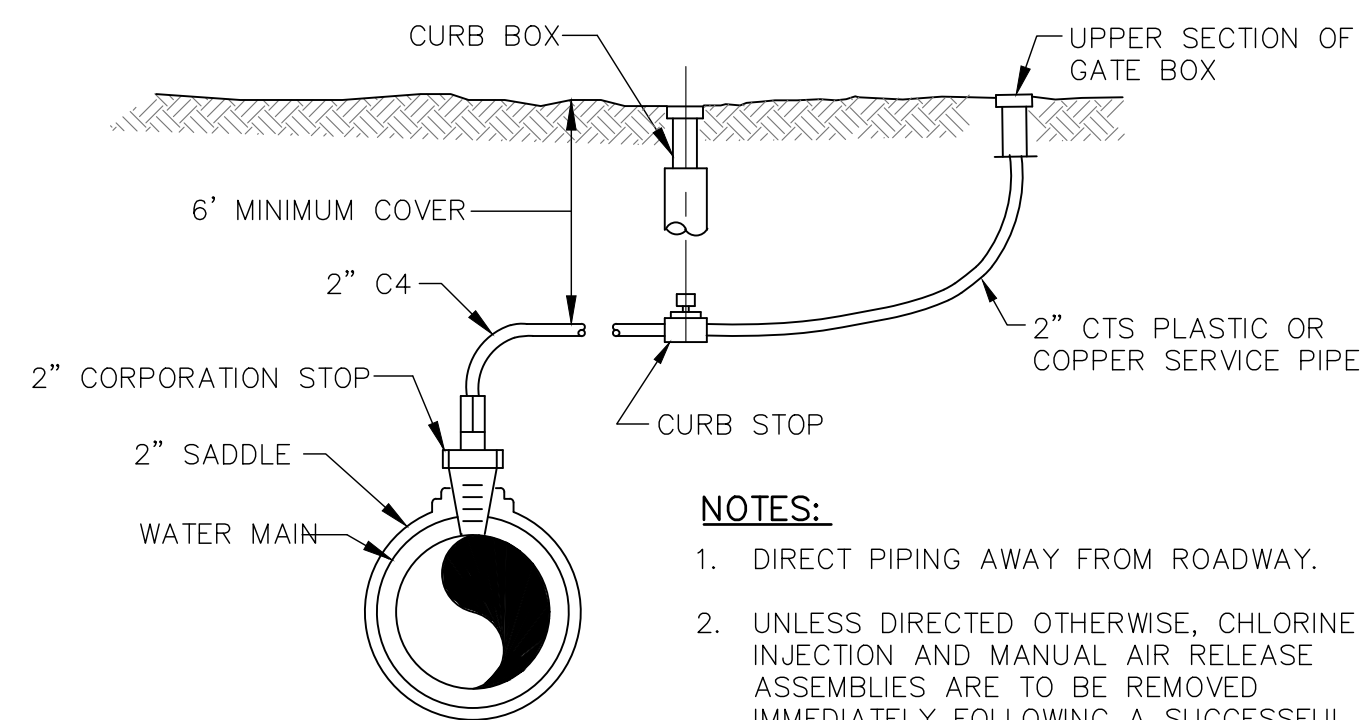


NOTES:

- DIRECT PIPING AWAY FROM ROADWAY.
- UNLESS DIRECTED OTHERWISE, CHLORINE INJECTION AND MANUAL AIR RELEASE ASSEMBLIES ARE TO BE REMOVED IMMEDIATELY FOLLOWING A SUCCESSFUL BACTERIA TEST. LEAVE THE CORPORATION STOP AND 12" LENGTH OF TUBING (WITH A CRIMPED END) IN PLACE.

2 TEMPORARY BLOW-OFF TAP ASSEMBLY

U-14 NOT TO SCALE

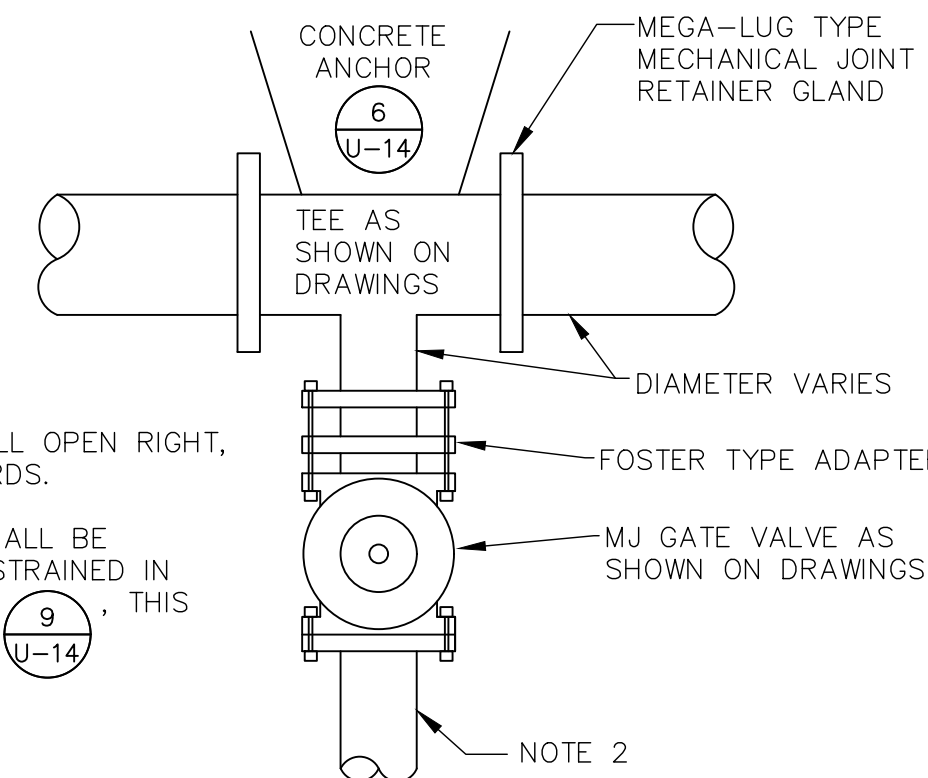


NOTE:

- GATE VALVES SHALL OPEN RIGHT, PER CITY STANDARDS.
- BRANCH PIPING SHALL BE MECHANICALLY RESTRAINED IN ACCORDANCE WITH THIS SHEET

3 TEE & GATE VALVE ASSEMBLY DETAIL (TYP.)

U-14 NOT TO SCALE

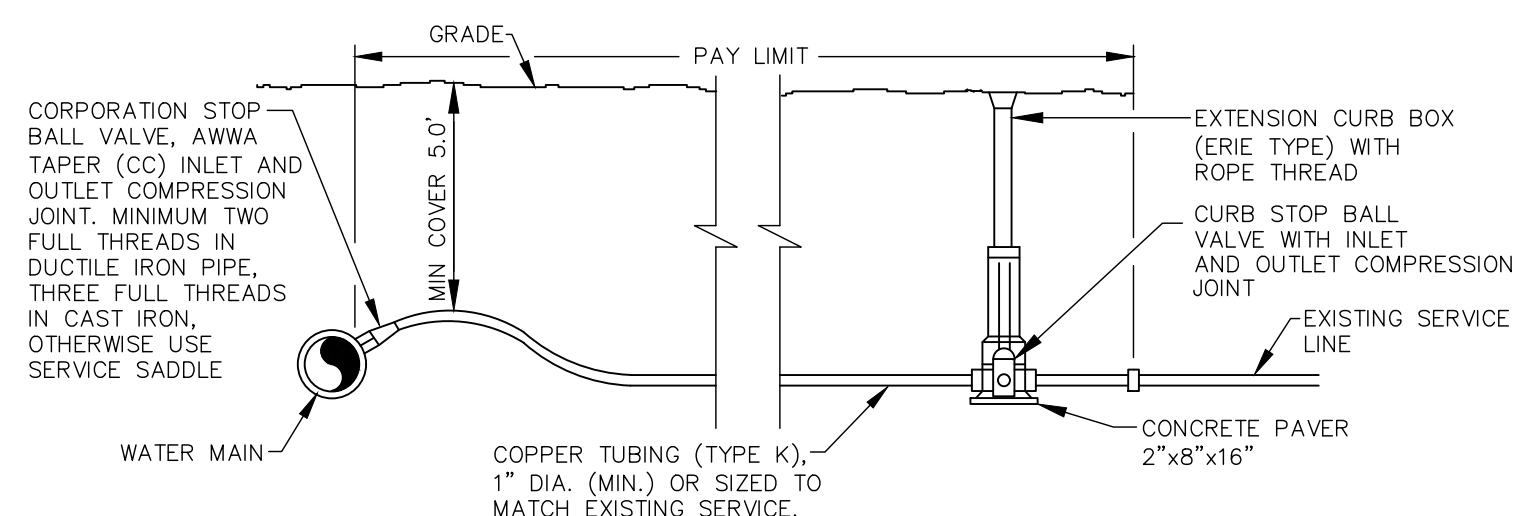


NOTES:

- PROVIDE NEW LINE USING CONTINUOUS LENGTHS OF COPPER. NO COUPLING ALLOWED IN ROADWAY WITHOUT APPROVAL OF ENGINEER.
- TAPS TO BE MADE AT APPROX. 2:00 AND 10:00.
- PROVIDE FOR SERVICE LINE CONTRACTION AND EXPANSION BY INSTALLING "S" IN SERVICE LINE NEAR MAIN.
- IF SERVICE IS INSTALLED WITH LESS THAN 5' COVER, INSULATE OVER LINE.
- REMOVE EXISTING CURB STOP (SALVAGE AS IDENTIFIED IN SECT. 01611).
- CONNECT CURB STOP TO EXISTING SERVICE LINE AT PROPERTY LINE OR AT LOCATION APPROVED BY THE ENGINEER (NO COUPLING WITHOUT APPROVAL OF ENGINEER) AFTER PRESSURE TESTING AND DISINFECTION.
- SHUT OFF EXISTING CORPORATION AND REMOVE OR ABANDON EXISTING SERVICE LINE.
- CURB BOX SHALL BE SET IN THE GRASS AREA BETWEEN CURB AND SIDEWALK UNLESS DIRECTED OTHERWISE.
- 2" SERVICE CONNECTIONS SHALL USE A STAINLESS STEEL SERVICE SADDLE.
- MAINTAIN 18" SEPARATION BETWEEN THE NEW WATER SERVICE AND THE NEW OR EXISTING SEWER MAIN (WATER SHALL BE OVER SEWER).

4 TYPICAL SERVICE CONNECTION

U-14 NOT TO SCALE

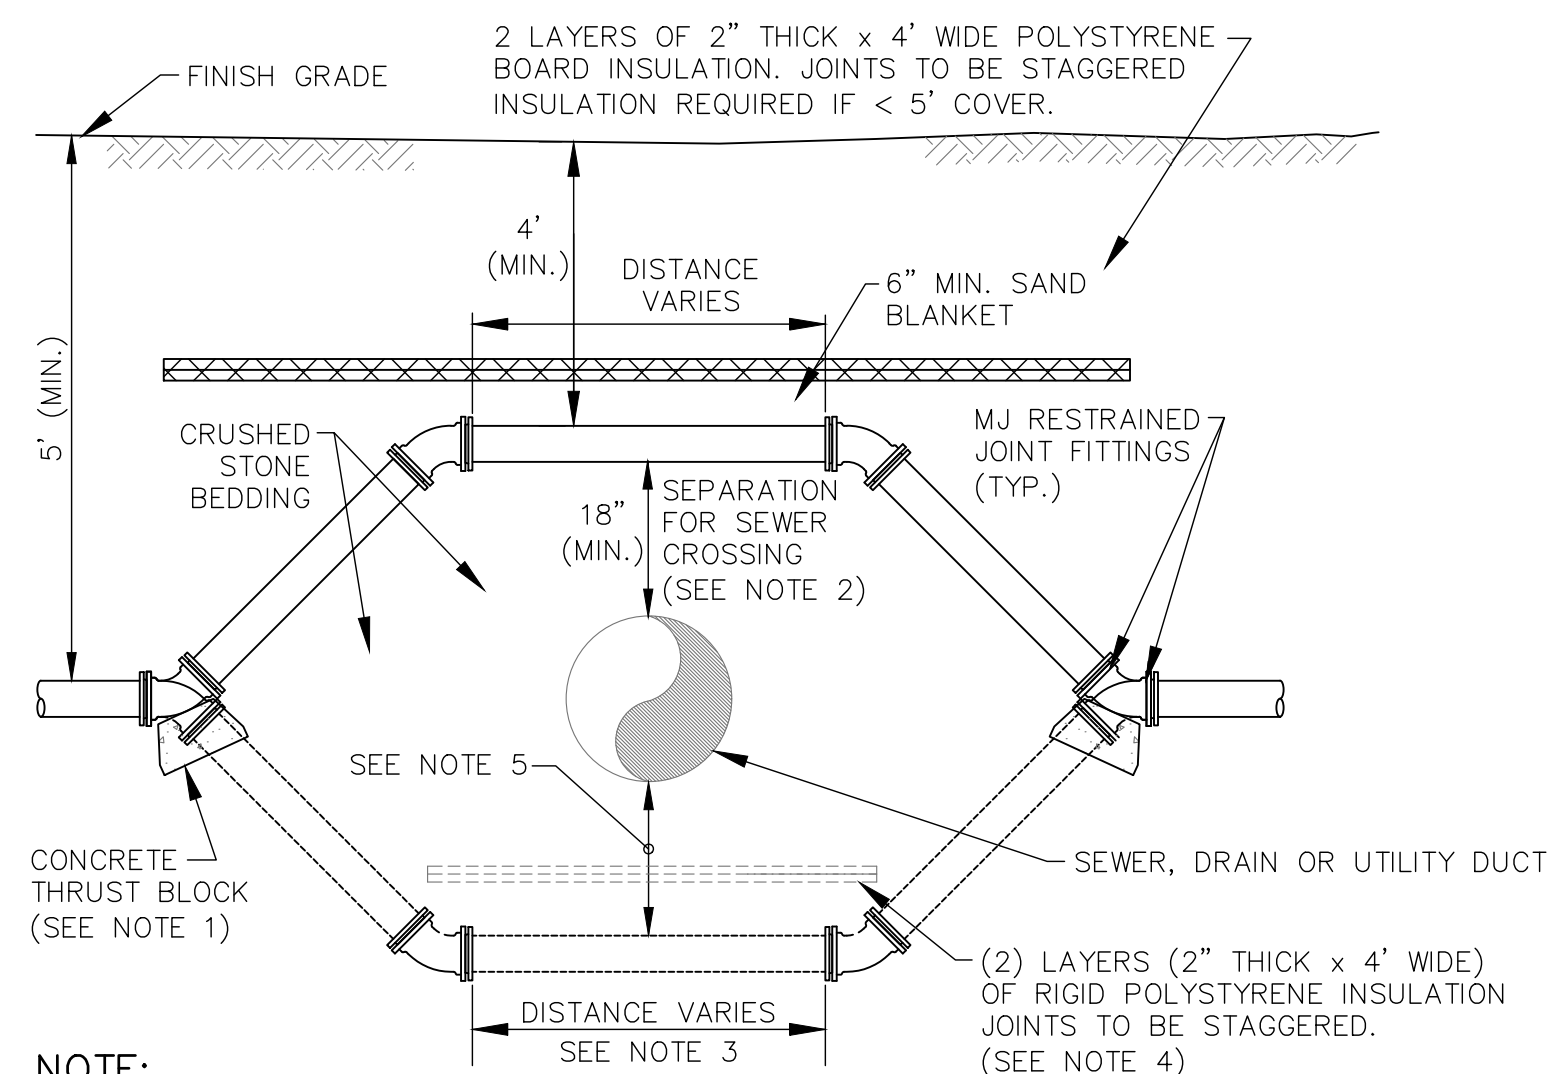



NOTE:

- INSTALL (4) FOUR 45° MJ BENDS WITH RESTRAINED JOINT FITTINGS.
- VERTICAL SEPARATION DEPTH BETWEEN WATER AND SEWER SHALL BE AT LEAST 18", WITH WATER ABOVE SEWER, PER NHDES ENV-Wq 704.12. VERTICAL SEPARATION OF LESS THAN 18" ALLOWED ONLY WITH WAIVER FROM NHDES.
- CENTER CROSSING PIPE BETWEEN BELLS. SEWER PIPE JOINT SHALL BE A MINIMUM OF 6 FT. HORIZONTALLY FROM THE WATER MAIN.
- PROVIDE INSULATION IF DRAIN CROSSES OVER WATER MAIN.
- PROVIDE 6" SEPARATION FOR DRAIN OR OTHER UTILITY CROSSINGS. IF ADDITIONAL DEPTH IS 1' OR LESS FROM NORMAL DEPTH, ADDITIONAL DEPTH MAY BE ACHIEVED BY USING PIPE JOINT DEFLECTIONS PER CONTRACTOR RECOMMENDATION. IF ADDITIONAL DEPTH FROM NORMAL EXCEEDS 1', ADDITIONAL DEPTH WILL BE ACHIEVED USING BENDS AS SHOWN.
- IF CONSTRUCTION OF WATER MAIN UNDER SEWER MAIN IS UNAVOIDABLE, SEWER MAIN SHALL BE CONSTRUCTED OF C900 PVC PIPE FROM MANHOLE TO MANHOLE.

5 WATER MAIN CONFLICT - CROSSING DETAIL

U-14 NOT TO SCALE

MINIMUM CONCRETE ANCHOR DIMENSIONS								
BENDS, TEES AND LINE VALVES AT 250 PSI								
PIPE SIZE INCHES	TEE OR PLUG FT.		ALL BENDS FT.		ALL LINE VALVES FT.			PIPE SIZE INCHES
	H	L	H	L	H	L	B	
6	1.5	3.0	2.0	3.5	1.5	3.0	2.5	6
8	2.0	4.0	2.5	5.0	2.0	4.0	3.0	8
10	2.5	5.0	3.0	6.0	3.0	4.0	3.0	10
12	3.0	6.0	3.0	8.0	3.0	5.0	4.0	12
16	3.0	6.5	3.0	10.0	3.0	4.5	4.0	16

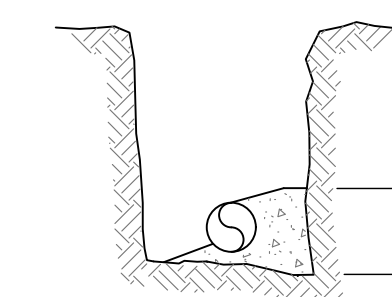
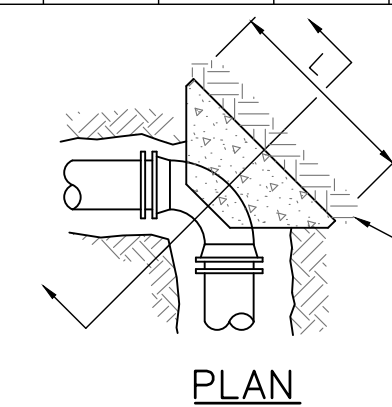


6 CONCRETE ANCHORS

U-14 NOT TO SCALE

7 TEE OR TAPPING SLEEVE

U-14 NOT TO SCALE

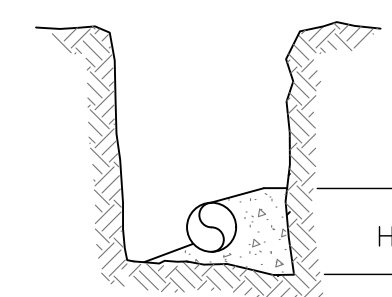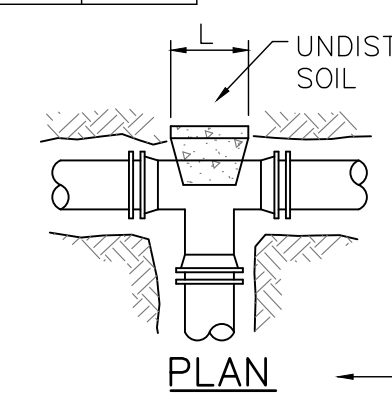


8 TYPICAL TRENCH DETAIL

U-14 NOT TO SCALE

STANDARD TRENCH NOTES

- ORDERED EXCAVATION OF UNSUITABLE MATERIAL BELOW GRADE. BACKFILL AS STATED IN THE TECHNICAL SPECIFICATIONS OR AS SHOWN ON THE DRAWINGS.
- BEDDING AND BLANKET: CLEAN SAND FREE FROM ORGANIC MATTER (SECTION 02228). BLANKET MAY BE OMITTED FOR DUCTILE IRON AND REINFORCED CONCRETE PIPE, PROVIDED HOWEVER, THAT NO STONE LARGER THAN 2" IS IN CONTACT WITH THE PIPE.
- BACKFILL MATERIAL: IN ROADS, ROAD SHOULDERS, WALKWAYS AND TRAVELED WAYS, SUITABLE MATERIAL FOR TRENCH BACKFILL SHALL BE THE NATURAL MATERIAL EXCAVATED DURING THE COURSE OF CONSTRUCTION, BUT SHALL EXCLUDE DEBRIS; PIECES OF PAVEMENT; ORGANIC MATTER; TOP SOIL; ALL WET OR SOFT MUCK, PEAT, OR CLAY; ALL EXCAVATED LEDGE MATERIAL; ALL ROCKS OVER 6 INCHES IN LARGEST DIMENSION; AND ANY MATERIAL WHICH, AS DETERMINED BY THE ENGINEER, WILL NOT PROVIDE SUFFICIENT SUPPORT OR MAINTAIN THE COMPLETED CONSTRUCTION IN A STABLE CONDITION.
- IN CROSS-COUNTRY CONSTRUCTION, SUITABLE MATERIAL SHALL BE AS DESCRIBED ABOVE, EXCEPT THAT THE ENGINEER MAY PERMIT THE USE OF TOP SOIL, LOAM, MUCK, OR PEAT, IF ENGINEER IS SATISFIED THAT THE COMPLETED CONSTRUCTION WILL BE ENTIRELY STABLE AND PROVIDED THAT EASY ACCESS TO THE PIPE LINE, FOR MAINTENANCE AND POSSIBLY RECONSTRUCTION, WILL BE PRESERVED.
- MINIMUM COVER: NOT LESS THAN 5.5 FEET, 7 MAX, EXCEPT TO AVOID SUBSURFACE STRUCTURES.
- FOR CROSS-COUNTRY CONSTRUCTION, BACKFILL OR FILL SHALL BE MOUND TO A HEIGHT OF 6 INCHES ABOVE THE ORIGINAL GROUND SURFACE.
- DRIVEWAYS: CRUSHED GRAVEL IN DRIVEWAYS SHALL MATCH EXISTING WITH A MINIMUM OF 6". EXISTING GRAVEL SHALL BE REMOVED AND REPLACED AND SHALL NOT BE MEASURED FOR PAYMENT.

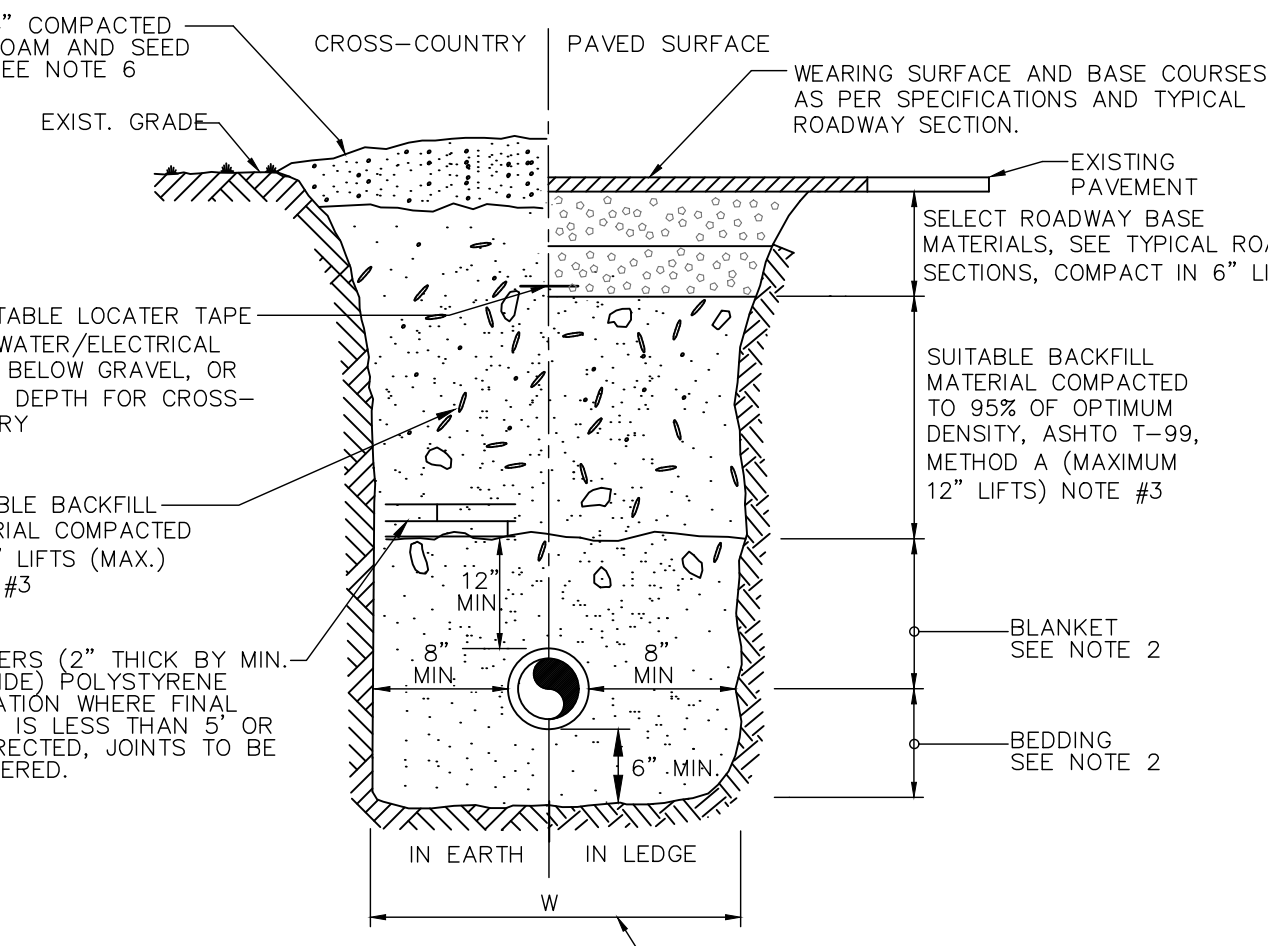

9 HORIZONTAL BENDS:

Nominal Pipe Diameter	Bend Angle			
	90°	45°	22.5°	11.25°
4"	6'	3'	2'	1'
6"	9'	4'	2'	2'
8"	11'	5'	3'	2'
10"	13'	6'	3'	2'
12"	16'	7'	3'	2'
16"	20'	9'	4'	2'

REDUCERS:

Nom. Diameter of Large Pipe	Nominal Diameter of Small Pipe (Note 4)			
	4"	6"	8"	10"
8"	17'	10'	-	-
10"	23'	17'	10'	-
12"	29'	24'	18'	10'
16"	39'	36'	31'	28'

DEAD ENDS:

Nom. Pipe Diameter	Restrained Length (ft)
4"	13'
6"	18'
8"	23'
10"	28'
12"	33'
16"	43'

10 MECHANICAL JOINT RESTRAINT

U-14 NOT TO SCALE

ISSUE FOR	APPROVAL	DATE	BY
CONSTRUCTION	5/9/18	DR	
RECORD DWG	1/11/19	DR	
REVISIONS			
NO.			
BY			
DATE			
SCALE	AS SHOWN		
DWG. ID	202946011		
BOOK NO.	2029		
APPROVED DATE	1/7/2019		
CHECKED	DR		
DESIGNED	DR		
DRAWN/CHK	DR		

UNDERWOOD
engineers

25 Vaughan Mall, Portsmouth, N.H. 03801
Tel. 603-436-6192 Fax. 603-431-4733

STANDARD WATER DETAILS	ISLINGTON STREET CORRIDOR IMPROVEMENTS	CITY OF PORTSMOUTH	PORTSMOUTH, NEW HAMPSHIRE
------------------------	--	--------------------	---------------------------

DWG NO	SHEET
U-14	87 OF 88

